


LOCATION MAP
N.T.S.

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LEGEND

- ⊙ POWER POLE
- ⊕ BORE HOLE
- ⊙ SITE BM
- ⊕ SITE BENCH MARK
- + 2.308 EXISTING ELEVATIONS
- + -1.775 SOUNDINGS



revisions	date
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A	A detail no. no. du detail	A
C	B location drawing no. sur dessin no.	B C
	C drawing no. dessin no.	

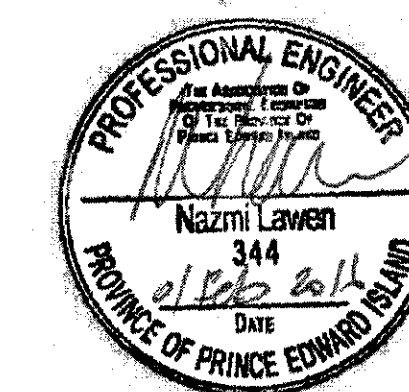project	project
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**WHARF 410P
CONSTRUCTION
ANNANDALE HARBOUR
KINGS COUNTY, PEI**

drawing	dessin
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**EXISTING SITE PLAN,
BOREHOLE DATA
AND SECTIONS**

designed N.L. P.Eng. concu

date 26 January 2016

drawn S.P.M. desine

date 26 January 2016

approved *[Signature]* approuve

tender *[Signature]* soumission


PWGSC Project Manager Administrateur de projets TPSCC

project number no. du projet

R.077227.001

drawing no. no. du dessin


M2 OF 6

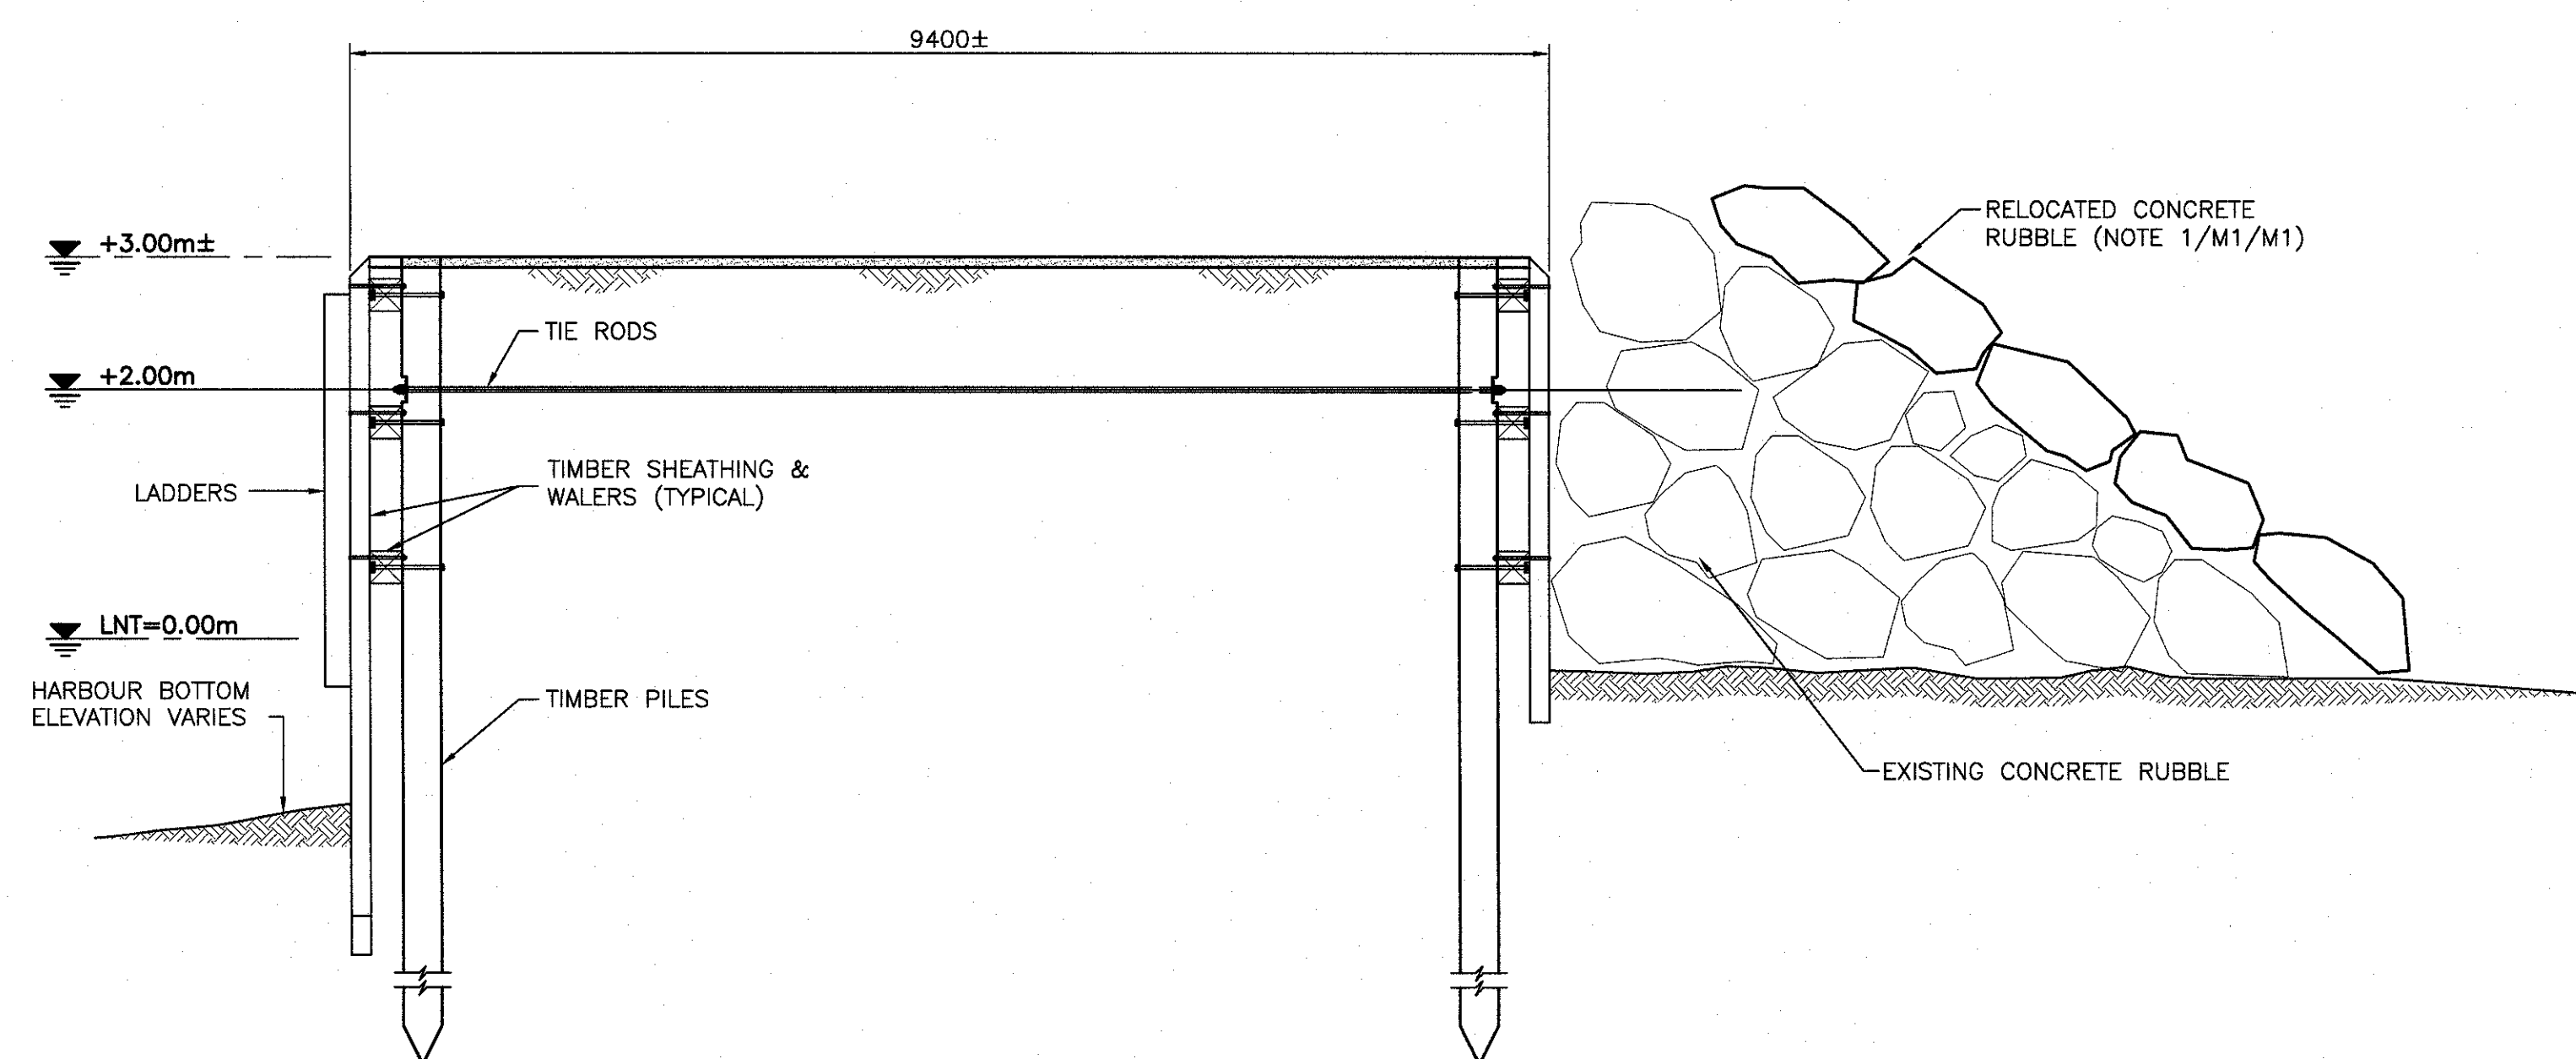

SECTION - EXISTING WHARF 402

1
M1/M2

SCALE: 1:50
0m 1m 2m 3m 4m 5m

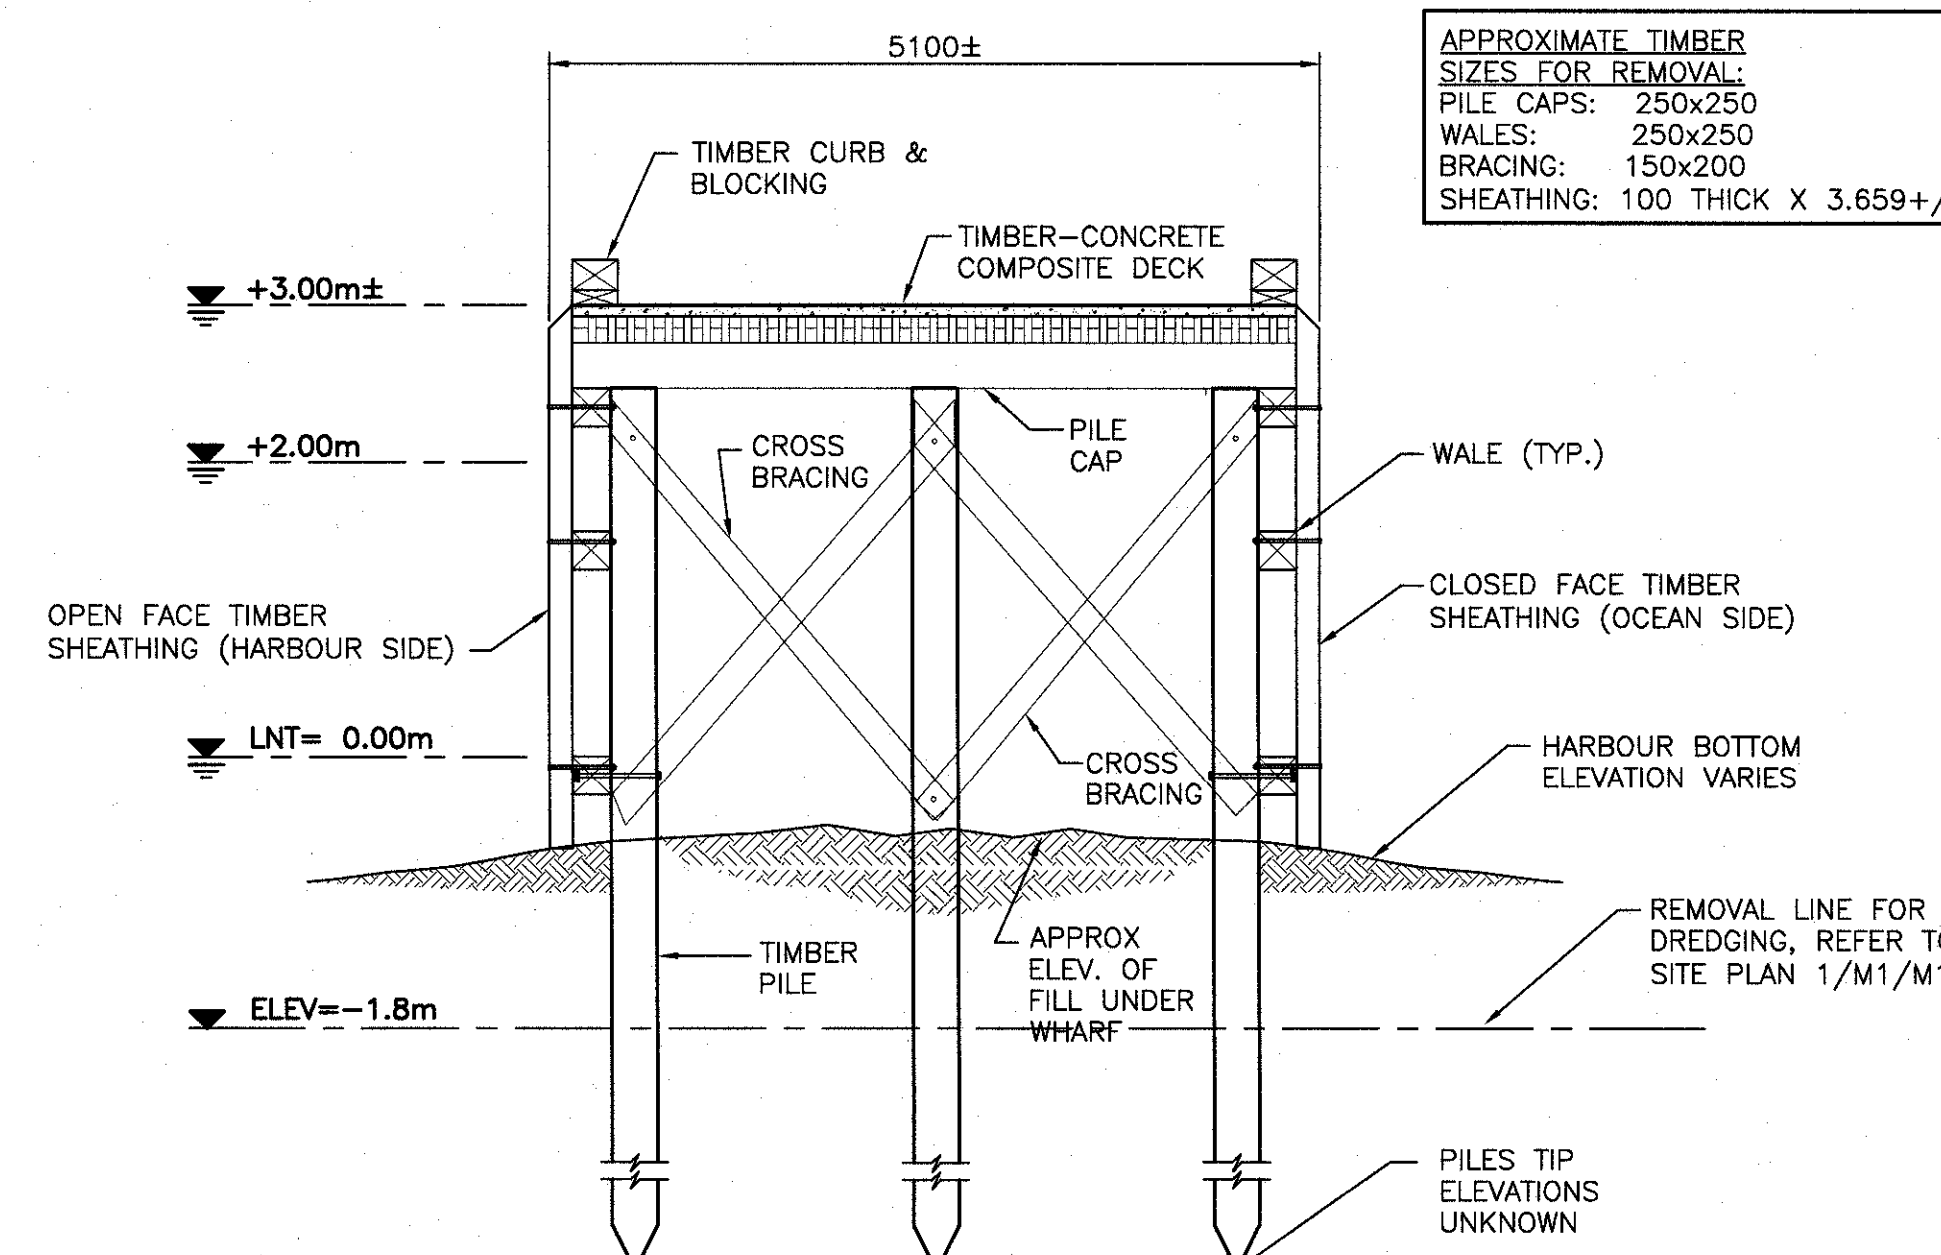

SECTION - EXISTING WHARF 401

2
M1/M2


SCALE: 1:50
0m 1m 2m 3m 4m 5m

DEMOLITION NOTES:

- EXISTING WHARF 401 DECK & ALL MATERIAL WITHIN WHARF FOOTPRINT INCLUDING PILES TO BE REMOVED & DISPOSED OFF SITE AT APPROVED DISPOSAL SITE.
- DO NOT UNDERMINE ADJACENT EXISTING WHARF 402 STRUCTURE WHEN DEMOLISHING WHARF 401 STRUCTURE.
- PREVENT MOVEMENT OR SETTLEMENT & SAFEGUARD & MAINTAIN INTEGRITY OF EXISTING & ADJACENT STRUCTURES, SERVICES & GRADES.
- CONTRACTOR TO SUBMIT A CONSTRUCTION SEQUENCE FOR REVIEW BY THE DEPARTMENTAL REPRESENTATIVE PRIOR TO CONSTRUCTION.
- REGRADE AREAS DAMAGED & AREAS NEAR THE NEW WORK WITH GRAVEL AS REQUIRED TO ENSURE PROPER DRAINAGE AND NO SURFACE PONDING OCCURS.

GENERAL NOTES:

- THE WORK UNDER THIS CONTRACT CONSISTS OF THE REMOVAL OF EXISTING FINGER WHARF STRUCTURE 401 & CONSTRUCTION OF NEW WHARF STRUCTURE 410P.
- CONTRACTORS MUST EXAMINE SITE & REPORT IN WRITING ANY DISCREPANCIES TO DEPARTMENTAL REPRESENTATIVE BEFORE PROCEEDING WITH WORK.
- LOCATIONS & DIMENSIONS OF ALL EXISTING STRUCTURAL ELEMENTS ARE APPROXIMATE ONLY. CONTRACTOR SHALL VERIFY EXISTING & NEW STRUCTURES BEFORE ORDERING ANY MATERIAL & COMMENCING WORK.
- ALL DIMENSIONS & ELEVATIONS ARE IN MILLIMETERS U.N.O. ALL SOUNDINGS ARE IN METER U.N.O.
- SITE PLAN & ELEVATIONS BASED ON SURVEY CONDUCTED BY PWGSC ON FEB. 1, 2010 REFERENCED TO CHS BENCHMARK 91P9368, ELEVATION +3.283m. SOUNDINGS ARE BASED ON SURVEY CONDUCTED BY PWGSC ON MAY 6, 2015 REFERENCED TO LNT, WHICH IS 2.74m BELOW TOP OF DECK AT BM.
- BOREHOLES WERE EXTRACTED FROM A GEOTECHNICAL INVESTIGATION REPORT BY STANTEC CONSULTING LTD NO. 121618191 DATED AUGUST 6, 2015. FOR OTHER PERTINENT INFORMATION REGARDING THE BOREHOLES, THE CONTRACTOR MUST REVIEW THE COMPLETE GEOTECHNICAL REPORT AVAILABLE UPON REQUEST. BOREHOLE DATA IS NOT TO BE INTERPRETED AS DESCRIPTIVE OF CONDITIONS AT LOCATIONS OTHER THAN THOSE DESCRIBED BY THE BOREHOLES THEMSELVES.
- CHART DATUM IS, BY INTERNATIONAL AGREEMENT, A PLANE BELOW WHICH THE TIDE WILL SELDOM FALL. THE CANADIAN HYDROGRAPHIC SERVICE HAS ADOPTED THE PLANE OF LOWEST NORMAL TIDE (L.N.T.) AS CHART DATUM AS THE RISE & FALL OF TIDES VARIES DAILY. THE CANADIAN TIDE & CURRENT TABLES, AS ISSUED BY THE CANADIAN HYDROGRAPHIC SERVICE SHOULD BE CONSULTED FOR TIDAL PREDICTIONS & OTHER TIDAL INFORMATION RELATING TO THE WORK.

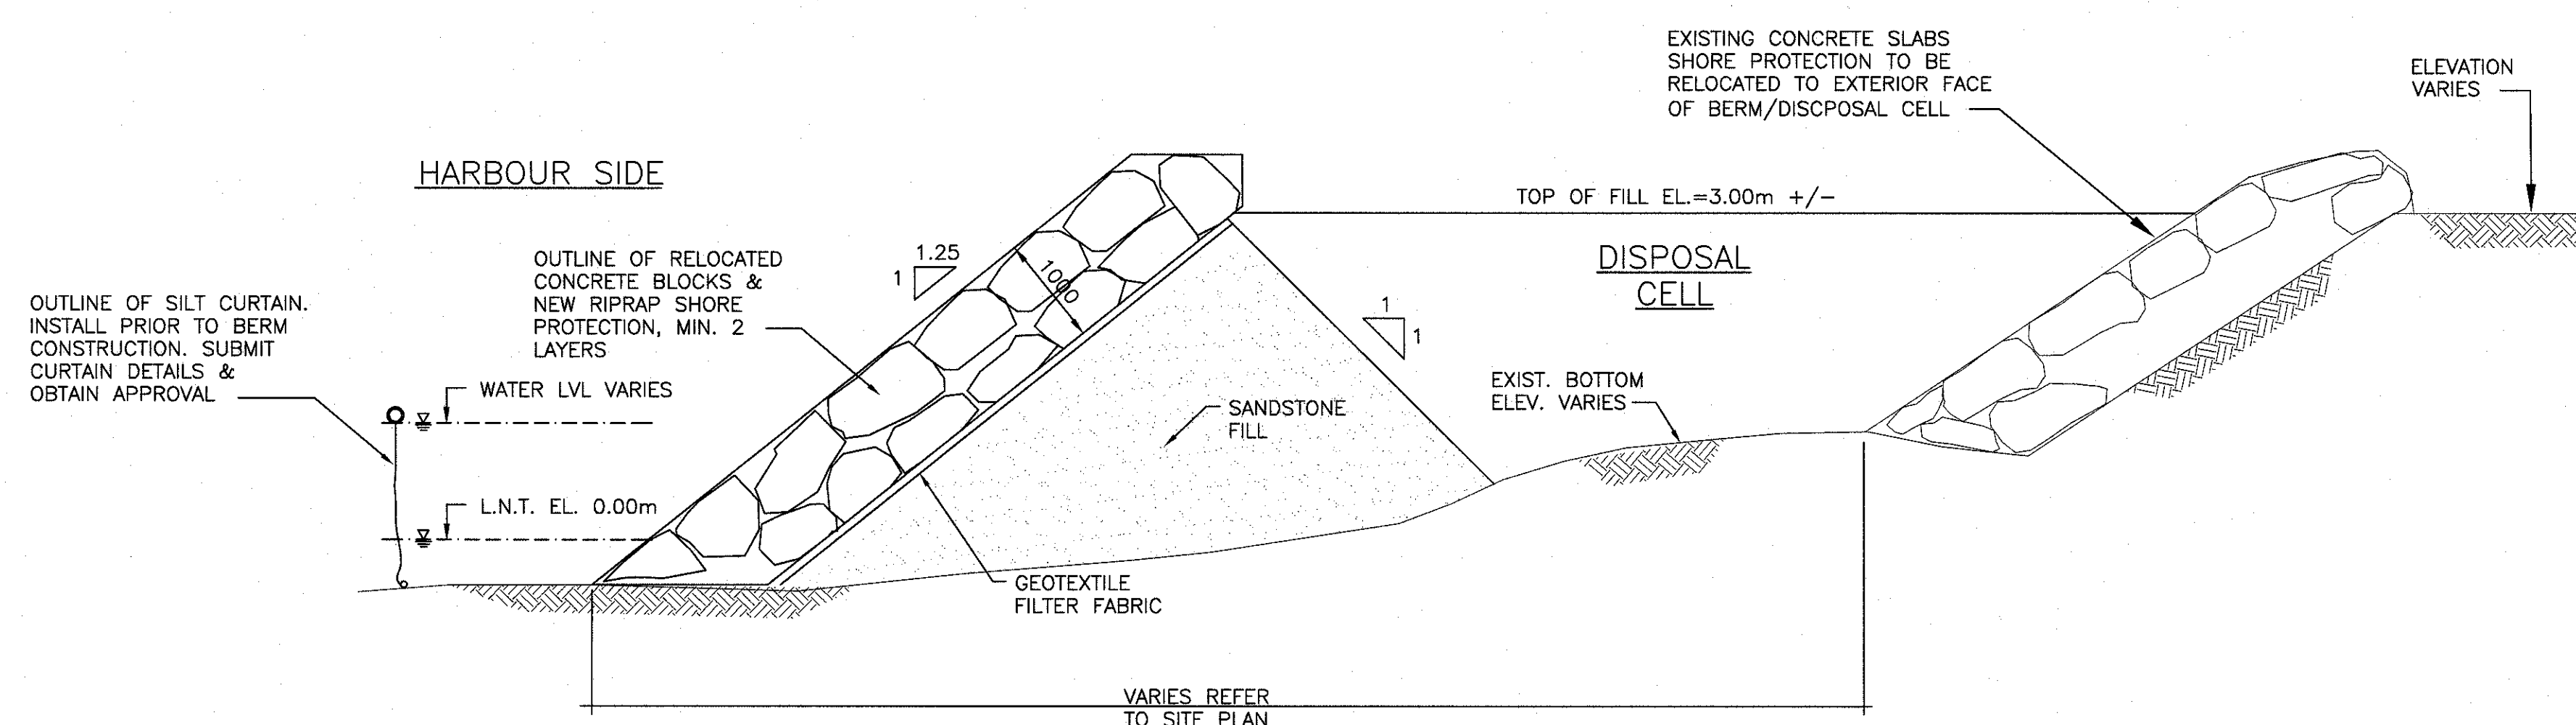

SECTION- CONTAINMENT CELL

3
M1/M2

SCALE: 1:50
0m 1m 2m 3m 4m 5m