



PHOTO\_1: VIEW OF METAL ROOF DECK (SOUTH)



PHOTO\_3: TYPICAL EXHAUST STACK (QTY 8)



PHOTO\_5: TYPICAL END LAP WITH ASPHALT MASTIC



PHOTO\_7: TYPICAL EXHAUST HOOD (QTY 4)



PHOTO\_9: TYPICAL STONE PILE ON ROOF DECK (4 LOCATIONS)



PHOTO\_2: TYPICAL METAL ROOF DECK AT END LAP LAYOUT



PHOTO\_4: TYPICAL END LAP WITH ALUMINUM PAINT




PHOTO\_6: TYPICAL EXHAUST STACK (QTY 8)



PHOTO\_8: VIEW OF ROOF DECK AND ROOF TOP EQUIPMENT

NOTES:  
1. PHOTOS ARE INTENDED TO CONVEY SCOPE AND TYPICAL CONDITIONS ON SITE. CONDITIONS WILL VARY AT INDIVIDUAL END LAP AND ROOF PENETRATIONS (MECHANICAL EQUIPMENT) LOCATIONS.

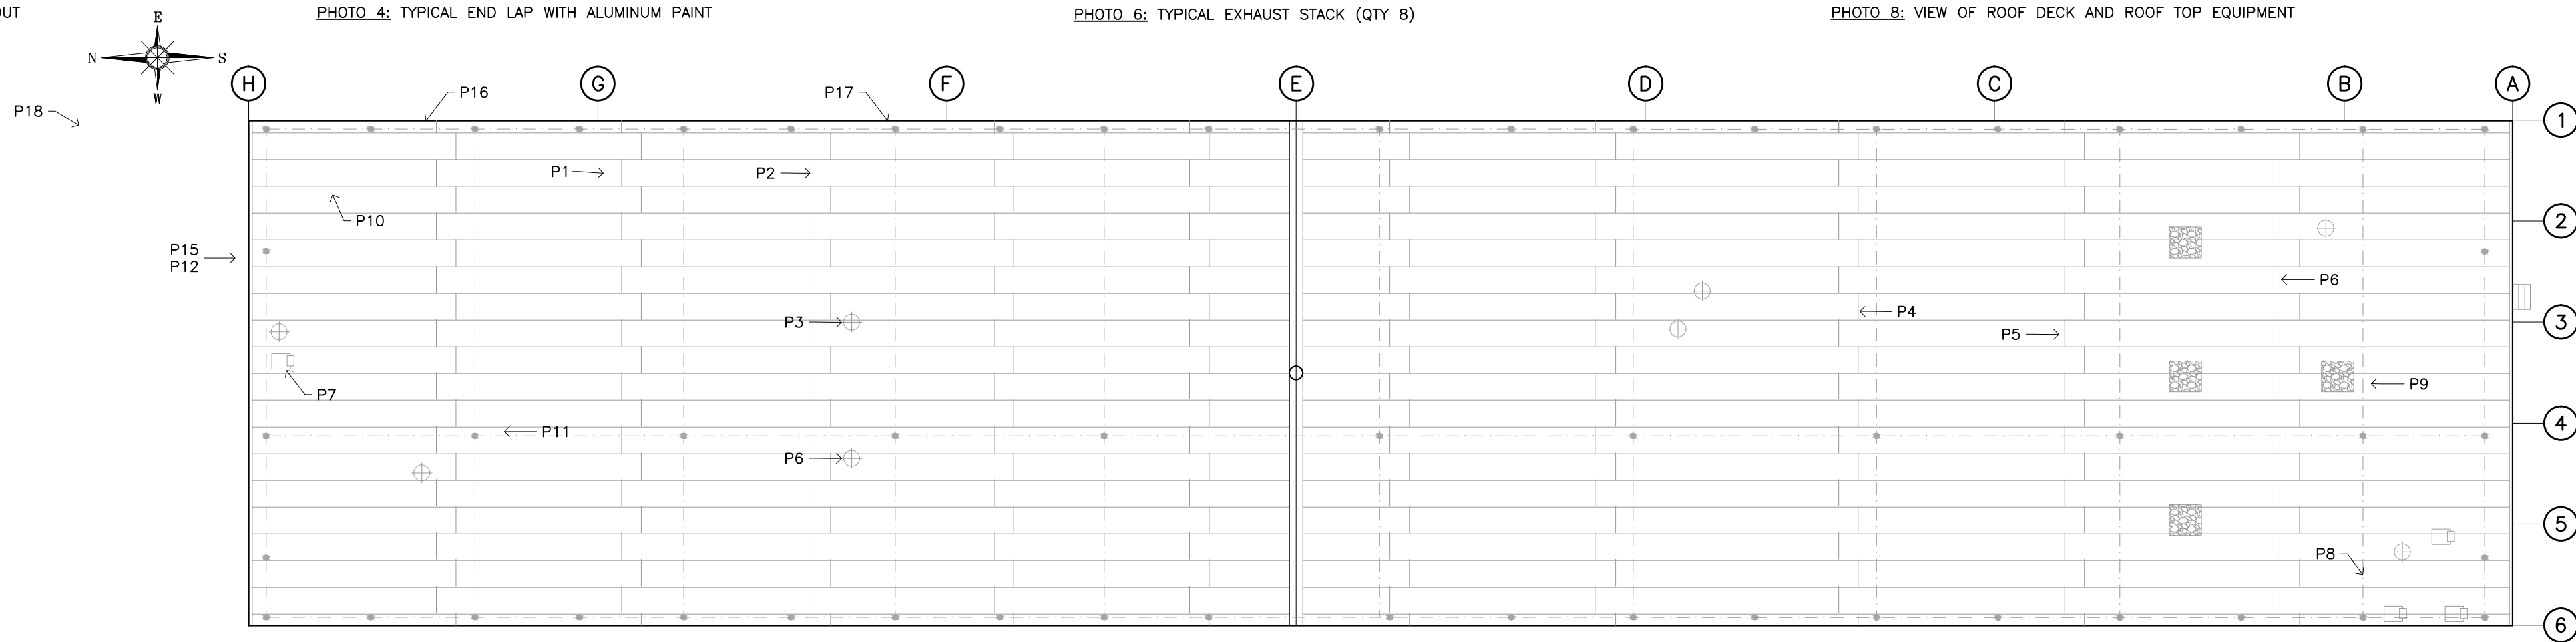

PHOTO\_10: AREA OF DAMAGED ROOF DECK, NORTH EAST CORNER OF ROOF DECK



PHOTO\_12: TYPICAL RAIN GUTTER SUPPORT BRACKET, NOTE DAMAGE AT TOP OF STANDING SEAM



PHOTO\_15: VIEW OF DAMAGED GUTTER TEMPORARY REPAIR



PHOTO\_17: TYPICAL ROOF INSTALLATION AT (EAST/WEST SIDE) PERIMETER OF ROOF DECK. SEE DETAIL 2/R1



PHOTO\_19: UNDERSIDE OF DAMAGED CORNER OF ROOF DECK AT NORTH/EAST CORNER OF ROOF SYSTEM



PHOTO\_11: TYPICAL LIGHTNING ARREST SYSTEM



PHOTO\_13: TYPICAL ROOF DECK CORROSION



PHOTO\_14: VIEW OF EXISTING PANEL CUT FROM THE UNDERSIDE OF THE ROOF SYSTEM



PHOTO\_16: TYPICAL ROOF INSTALLATION AT (SIDE) PERIMETER OF ROOF DECK. SEE 3/R1.



PHOTO\_18: VIEW OF NORTH ELEVATION OF BUILDING




PHOTO\_20: TYPICAL VIEW OF ROOF SYSTEM UNDERSIDE

NO.	REVISION	DATE
1	ISSUED FOR TENDER	NOV. 27, 2015
2		
3		
4		
5		
6		
7		

NOTES:  
CONTRACTOR SHALL CHECK AND VERIFY ALL DIMENSIONS AND BE RESPONSIBLE FOR REPORTING ALL DISCREPANCIES TO OWNER AND/OR CONSULTANT PRIOR TO TENDER CLOSING.  
LATEST APPROVED DRAWINGS ONLY TO BE USED FOR CONSTRUCTION.

PRINTS ARE NOT TO BE SCALED.  
ALL DIMENSIONS INDICATED ARE IN MILLIMETRES (mm) UNLESS OTHER WISE NOTED.

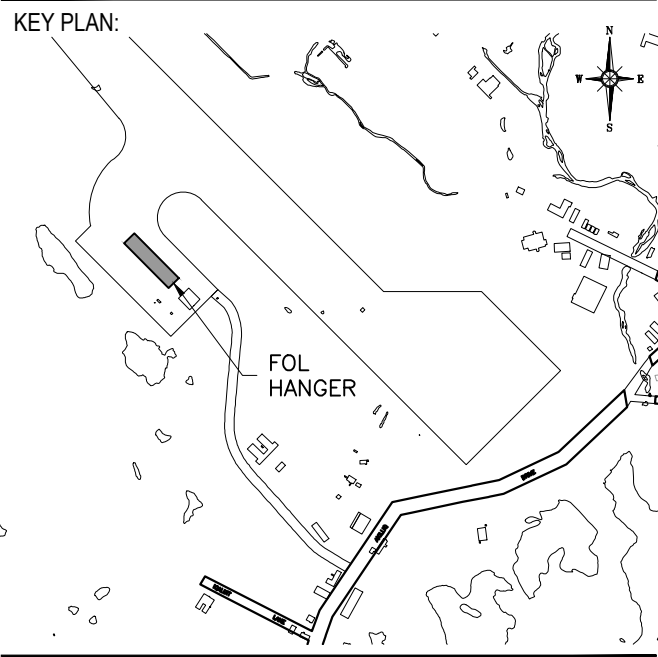

- LEGEND:
- EXHAUST STACK
  - EXHAUST VENT
  - LIGHTNING ARREST SYSTEM (CABLE AND RODS)
  - GRAVEL PILE
  - END LAP, STANDING SEAM METAL ROOF DECK
  - PHOTOGRAPH REFERENCE

PERMIT TO PRACTICE  
Concentric Associates International Inc.  
Signature: *[Signature]*  
Date: NOV/27/15  
PERMIT NUMBER: P 492  
The Association of Professional Engineers, Geologists and Geophysicists of the NWT / NU



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CLIENT NAME:  
PUBLIC WORKS AND GOVERNMENT SERVICES CANADA

PROJECT ADDRESS:  
HANGAR 6M- FORWARD OPERATION LOCATION, IQALUIT NUNAVUT

PROJECT NAME:  
ROOF REPAIR, FOL HANGER IQALUIT

DRAWING TITLE:  
PHOTOS OF EXISTING CONDITIONS

DESIGN: WRS  
DRAWN: STM  
APPVD: STP

SCALE: AS SHOWN  
DATE: NOV/2015  
FILE No: 14-5911-B

SHEET No.  
**R2**