



ROOF PLAN - MAIN LEVEL

SCALE : 1:100

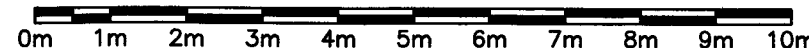


PWGSB B1 (2004)

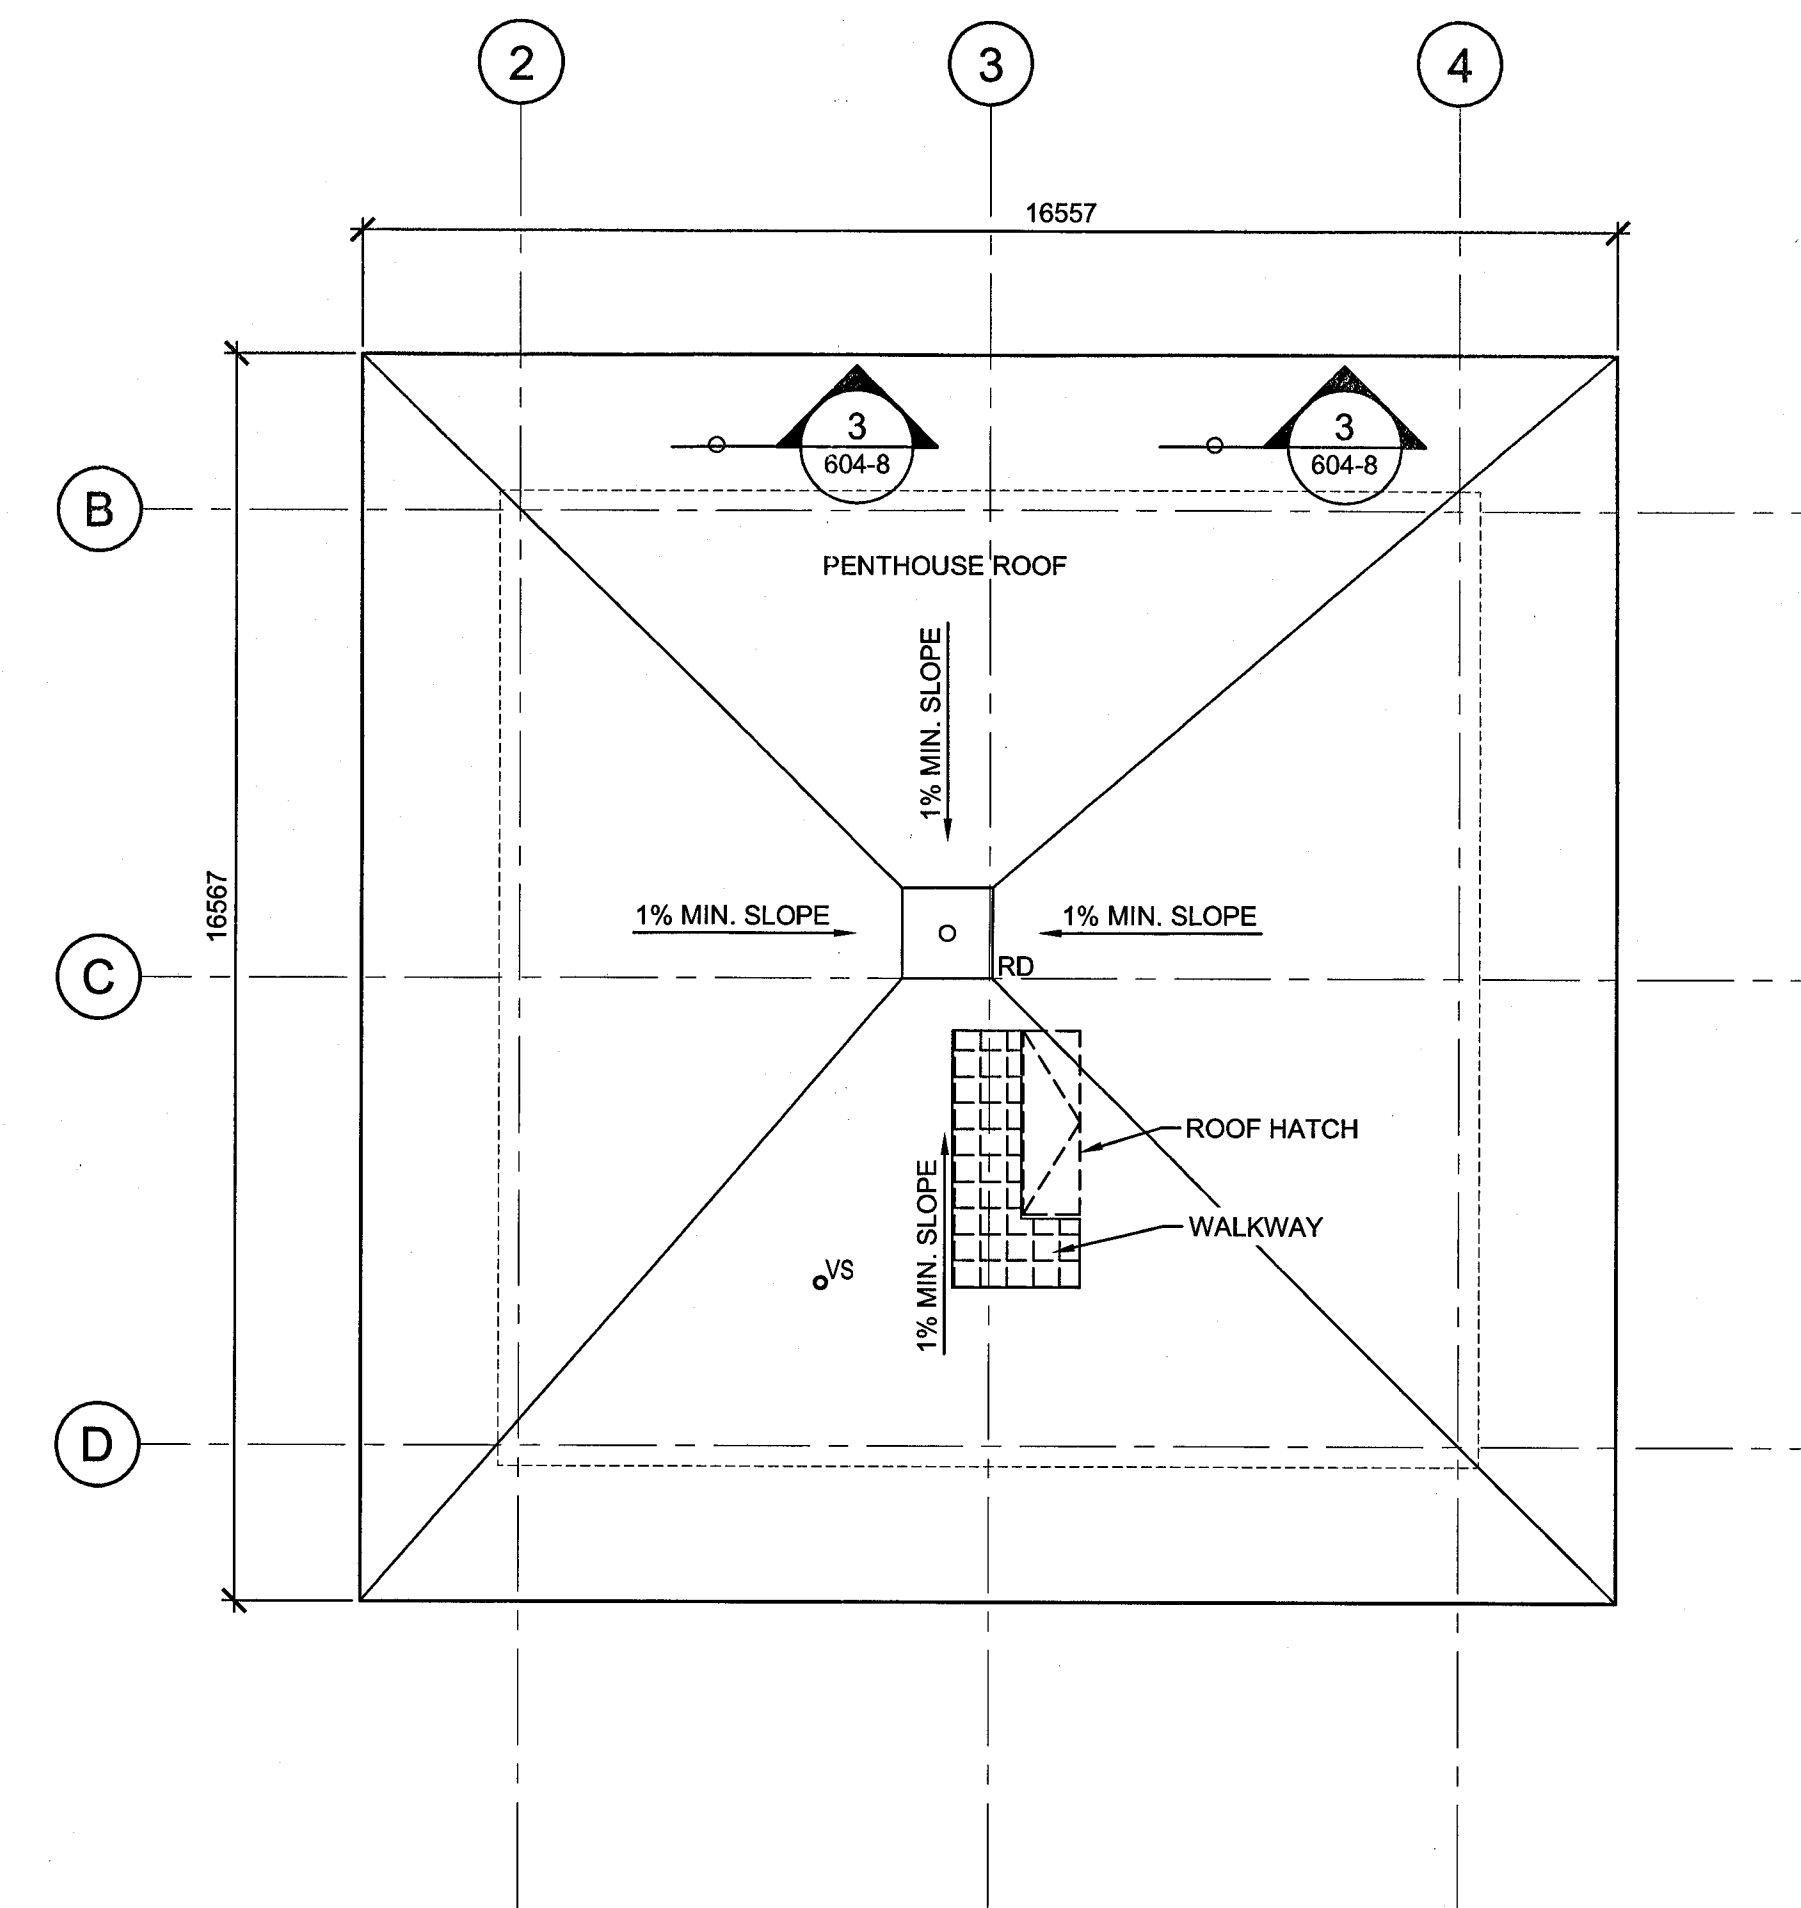

ROOF PLAN - PENTHOUSE

SCALE : 1:100

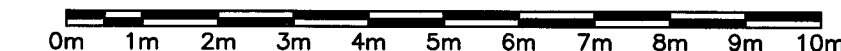

TYPICAL R1 ROOF CONSTRUCTION


- 2 PLY MODIFIED BITUMEN ROOF ASSEMBLY
- 2 - LAYERS 12.7mm FIBRE BOARD
- 135mm POLYSTYRENE INSULATION (PLUS TAPERED WHERE INDICATED)
- VAPOUR RETARDER
- 12.7mm EXTERIOR GRADE GYPSUM BOARD
- METAL DECK, REFER TO STRUCTURAL DRAWINGS

LEGEND

- SUMP RECEIVER (TYPICAL 1000 x 1000)
- RD ROOF DRAIN
- VS VENT STACK
- ROOF WALKWAY
- DIRECTION OF SLOPE
- TAPERED INSULATION
- ANTENNA


GENERAL NOTES

1. SEE DRAWING 604-5 FOR TYPICAL PARAPET DETAILS.
2. COORDINATE SIZE, QUANTITY AND LOCATION OF ROOF VENT STACKS AND ROOF DRAINS WITH MECHANICAL DRAWINGS AND SPECS.
3. SEE DRAWING 604-8 FOR TYPICAL ROOF DETAILS.
4. PROVIDE AN ADDITIONAL LAYER OF ROOFING MEMBRANE AT ROOF WALKWAYS LOCATED AT AREA OF DOORS AND ROOF HATCH.

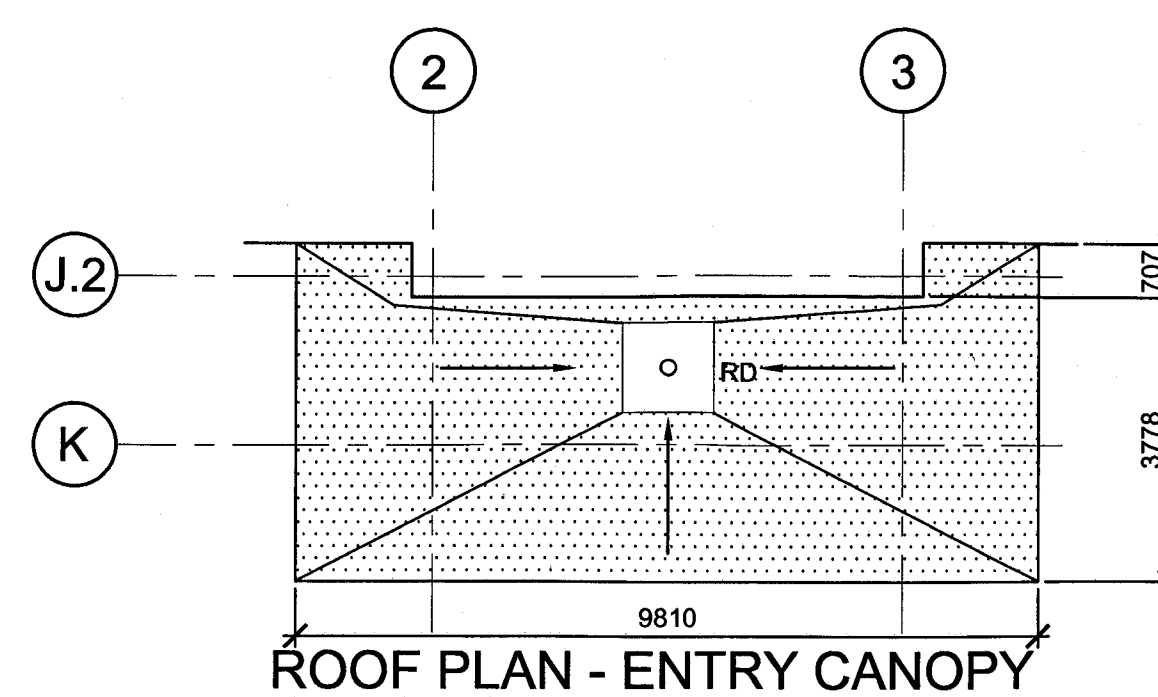

ROOF PLAN - ENTRY CANOPY

SCALE : 1:100

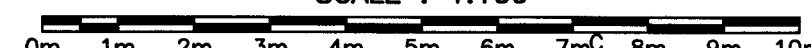

KEY PLAN

SCALE - NTS



| | | |
|-----------|---------------------------|------------|
| 0 | RELEASED FOR CONSTRUCTION | 01/29/2016 |
| revisions | | date |

project
**NEW
G.O.C.B
SAINT-LÉONARD
NEW BRUNSWICK**

drawing
dessin

ROOF PLANS

designed SJO/GAR/CET
date JANUARY 29, 2016
drawn GB
date JANUARY 29, 2016
approved DAG
date FEBRUARY 17, 2016
Tender
Project Manager
Administrateur de projets TPSC
project number
no. du projet
R.069499.001

drawing no.
no. du dessin
601-5