



DRY STORAGE FOUNDATION PLAN

SCALE : 1:100  
0m 1m 2m 3m 4m 5m 6m 7m 8m 9m 10m

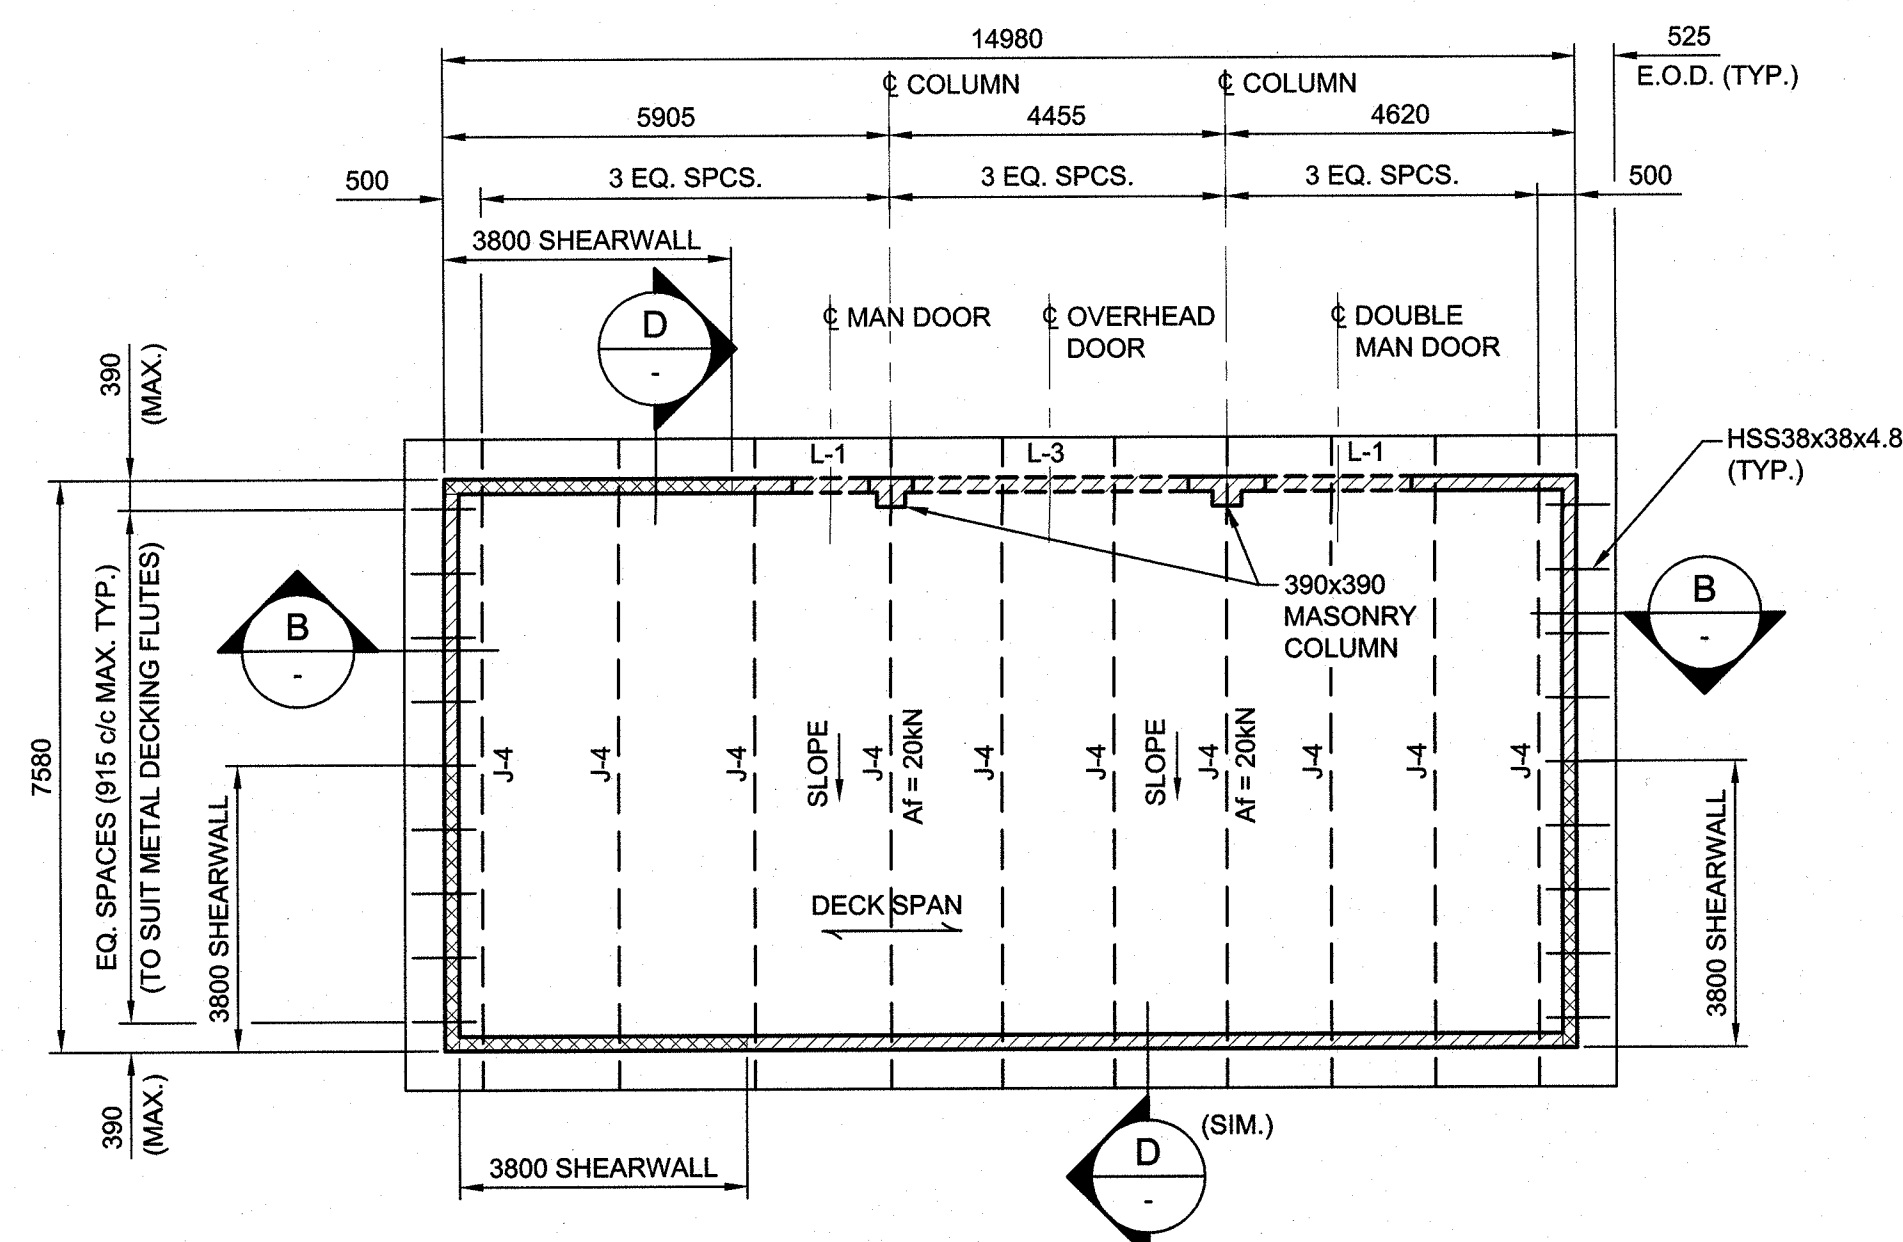


DRY STORAGE FRAMING PLAN

SCALE : 1:100  
0m 1m 2m 3m 4m 5m 6m 7m 8m 9m 10m

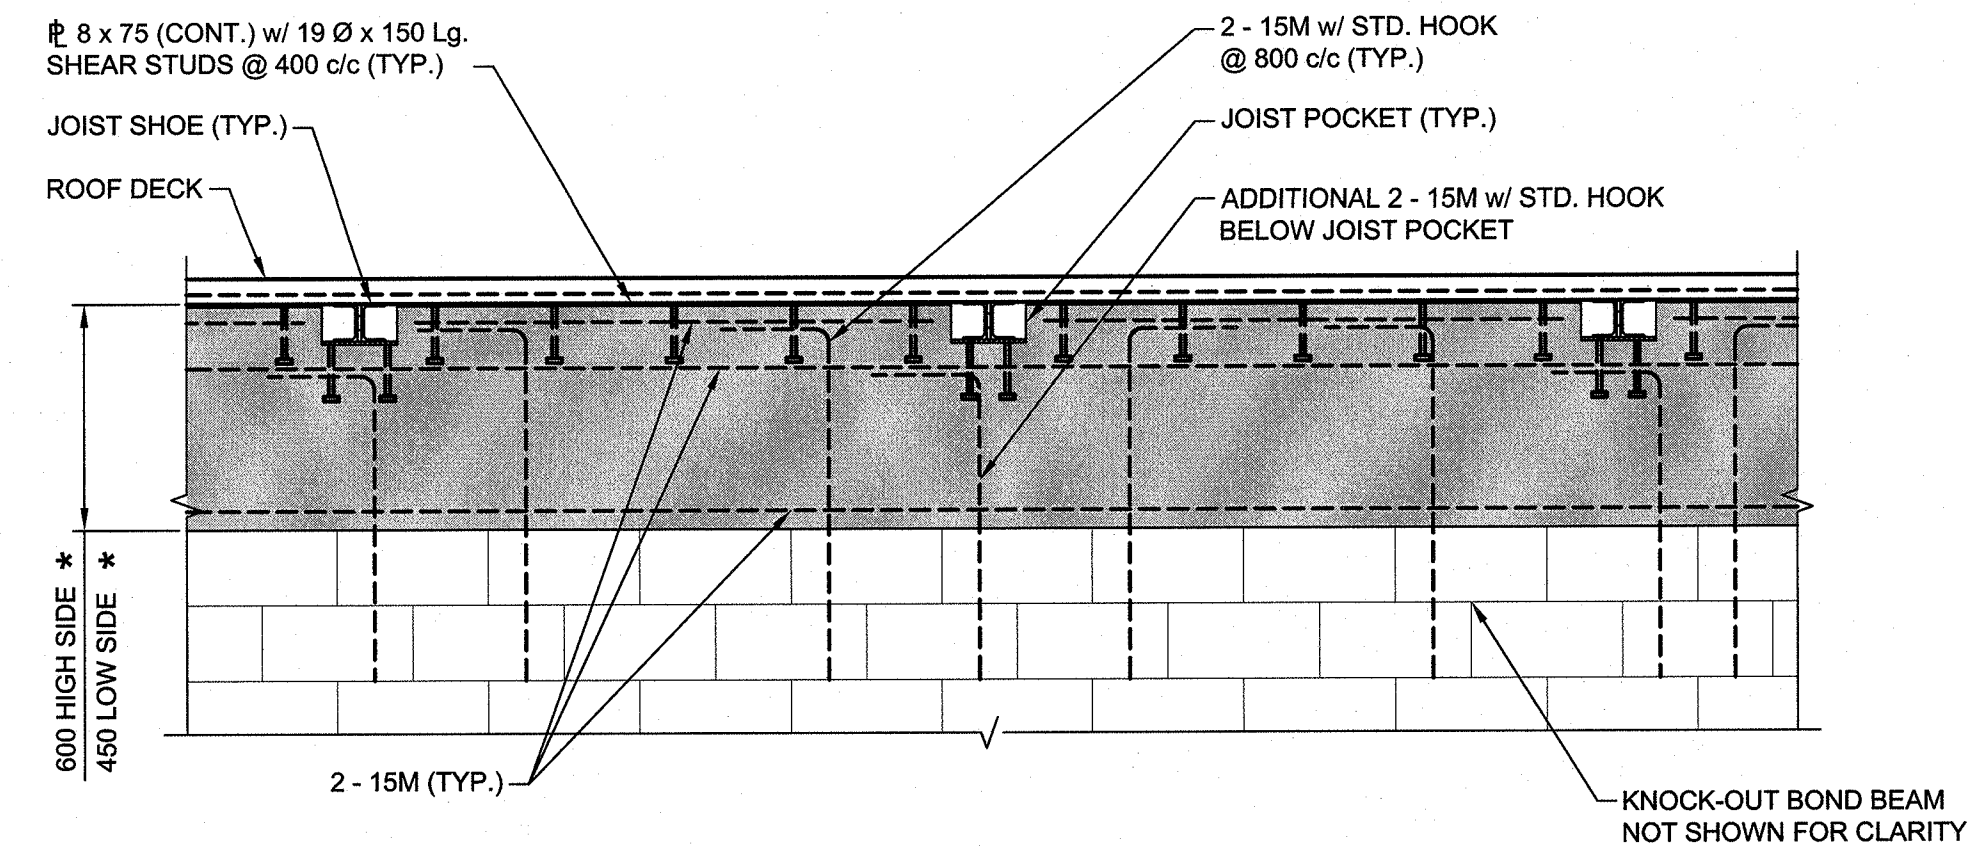


TYPICAL CONCRETE PERIMETER BEAM ELEVATION

NOT TO SCALE

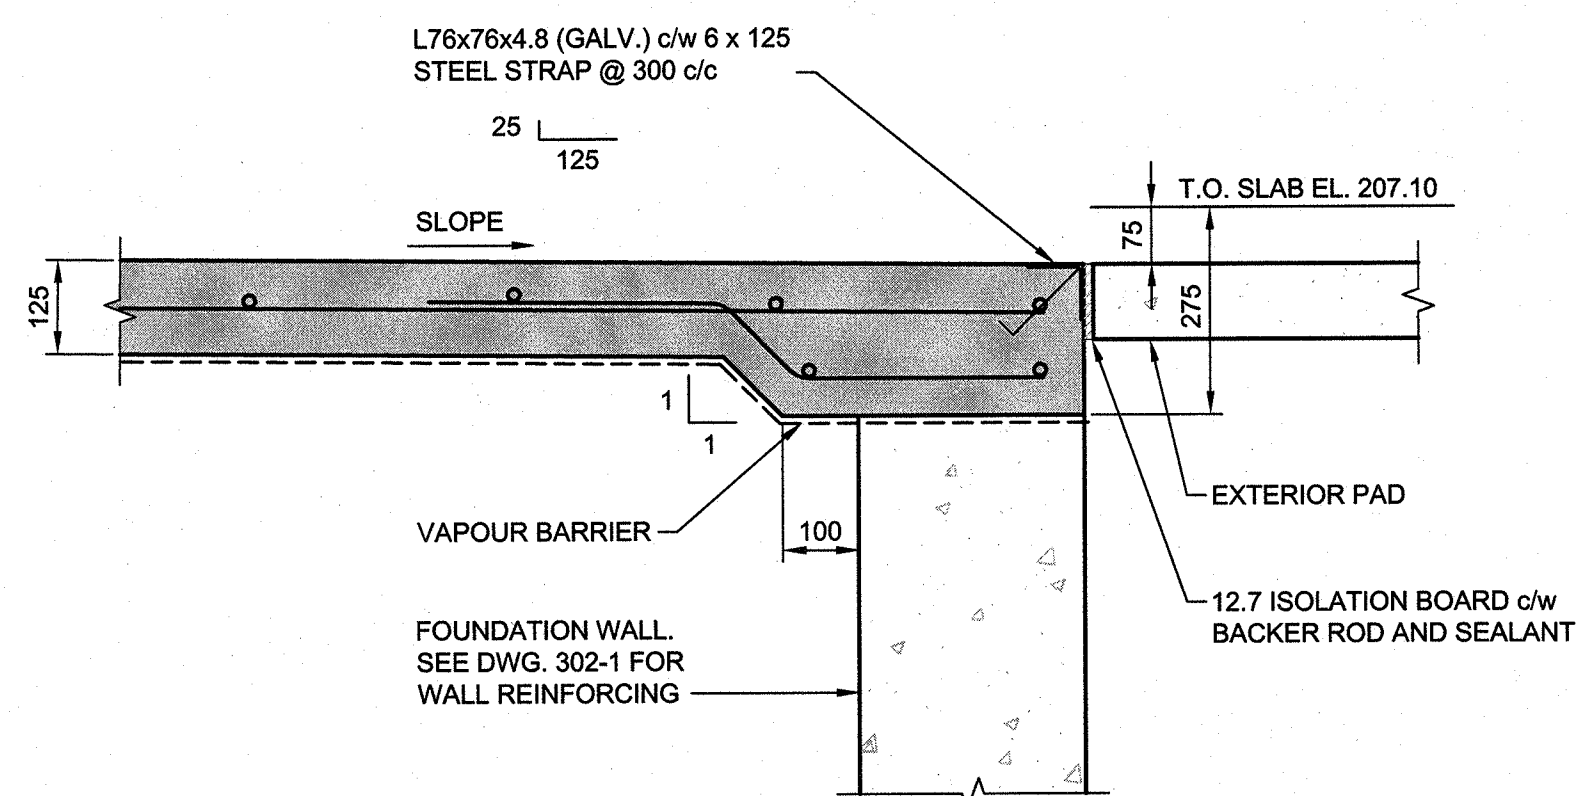


SECTION A

SCALE : 1:10  
0mm 100 200 300 400 500 600 700 800 900 1000mm

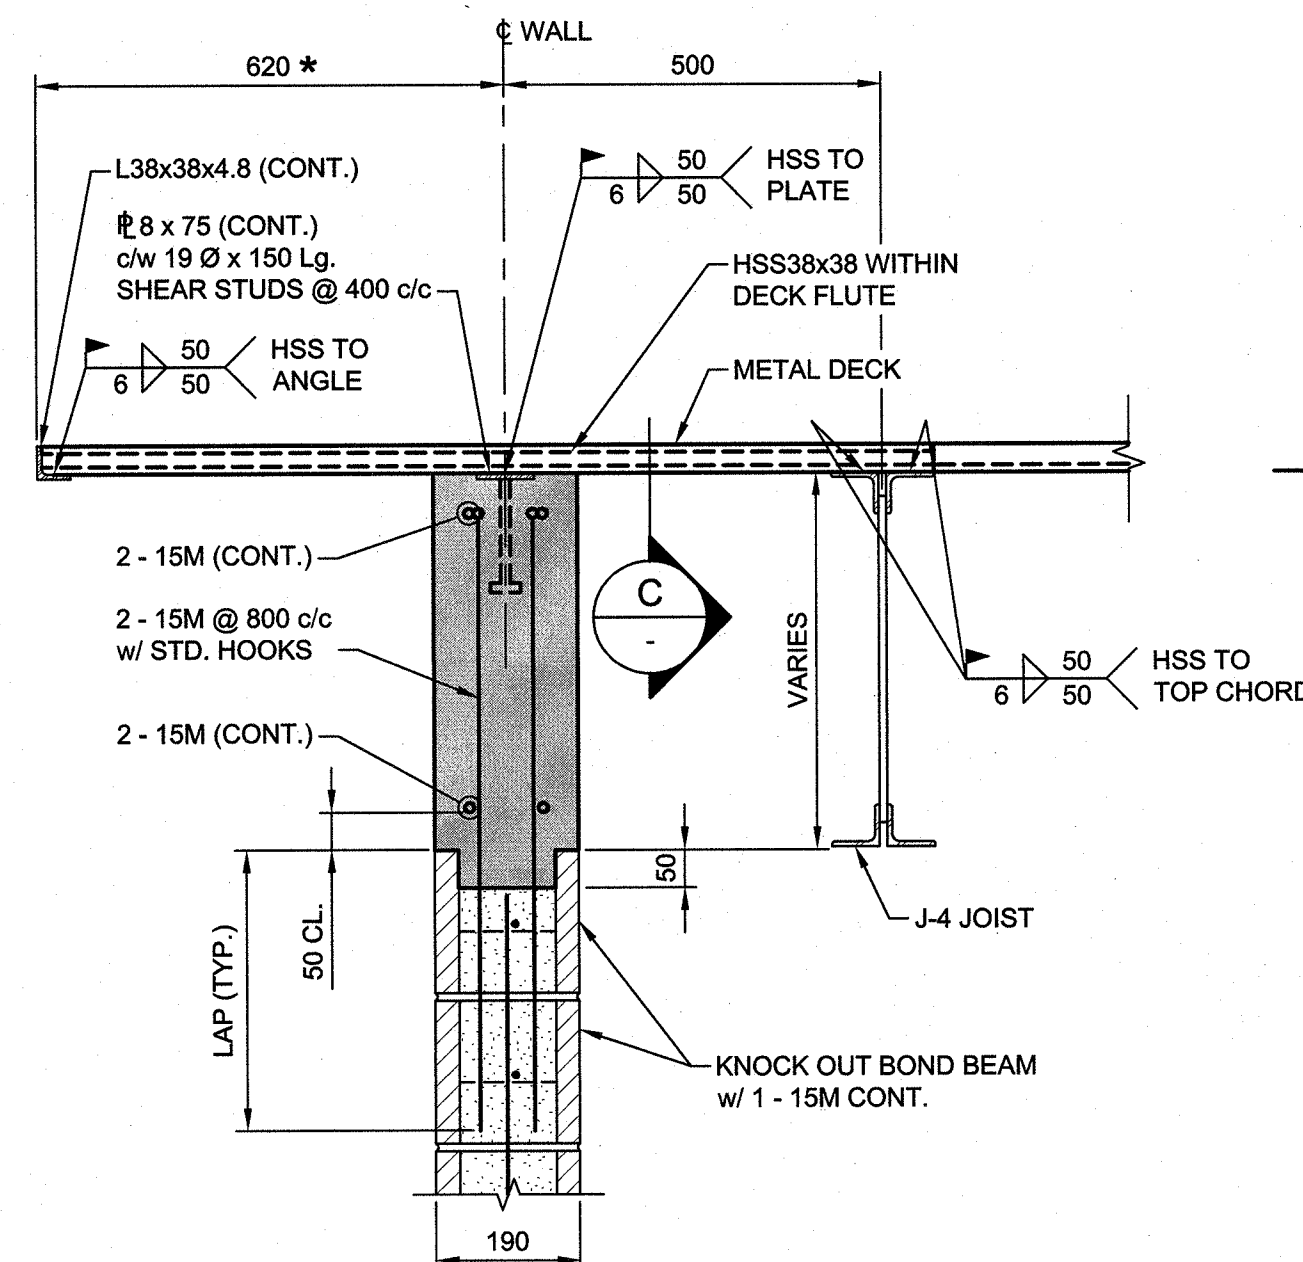


SECTION B

SCALE : 1:10  
0mm 100 200 300 400 500 600 700 800 900 1000mm

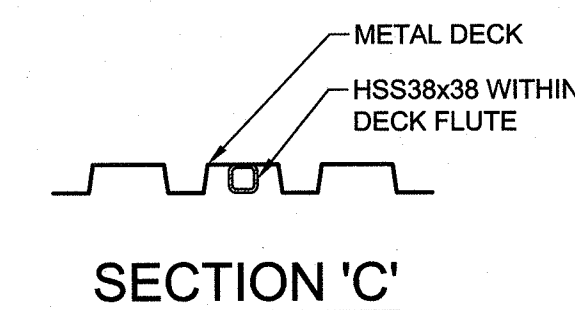


SECTION C

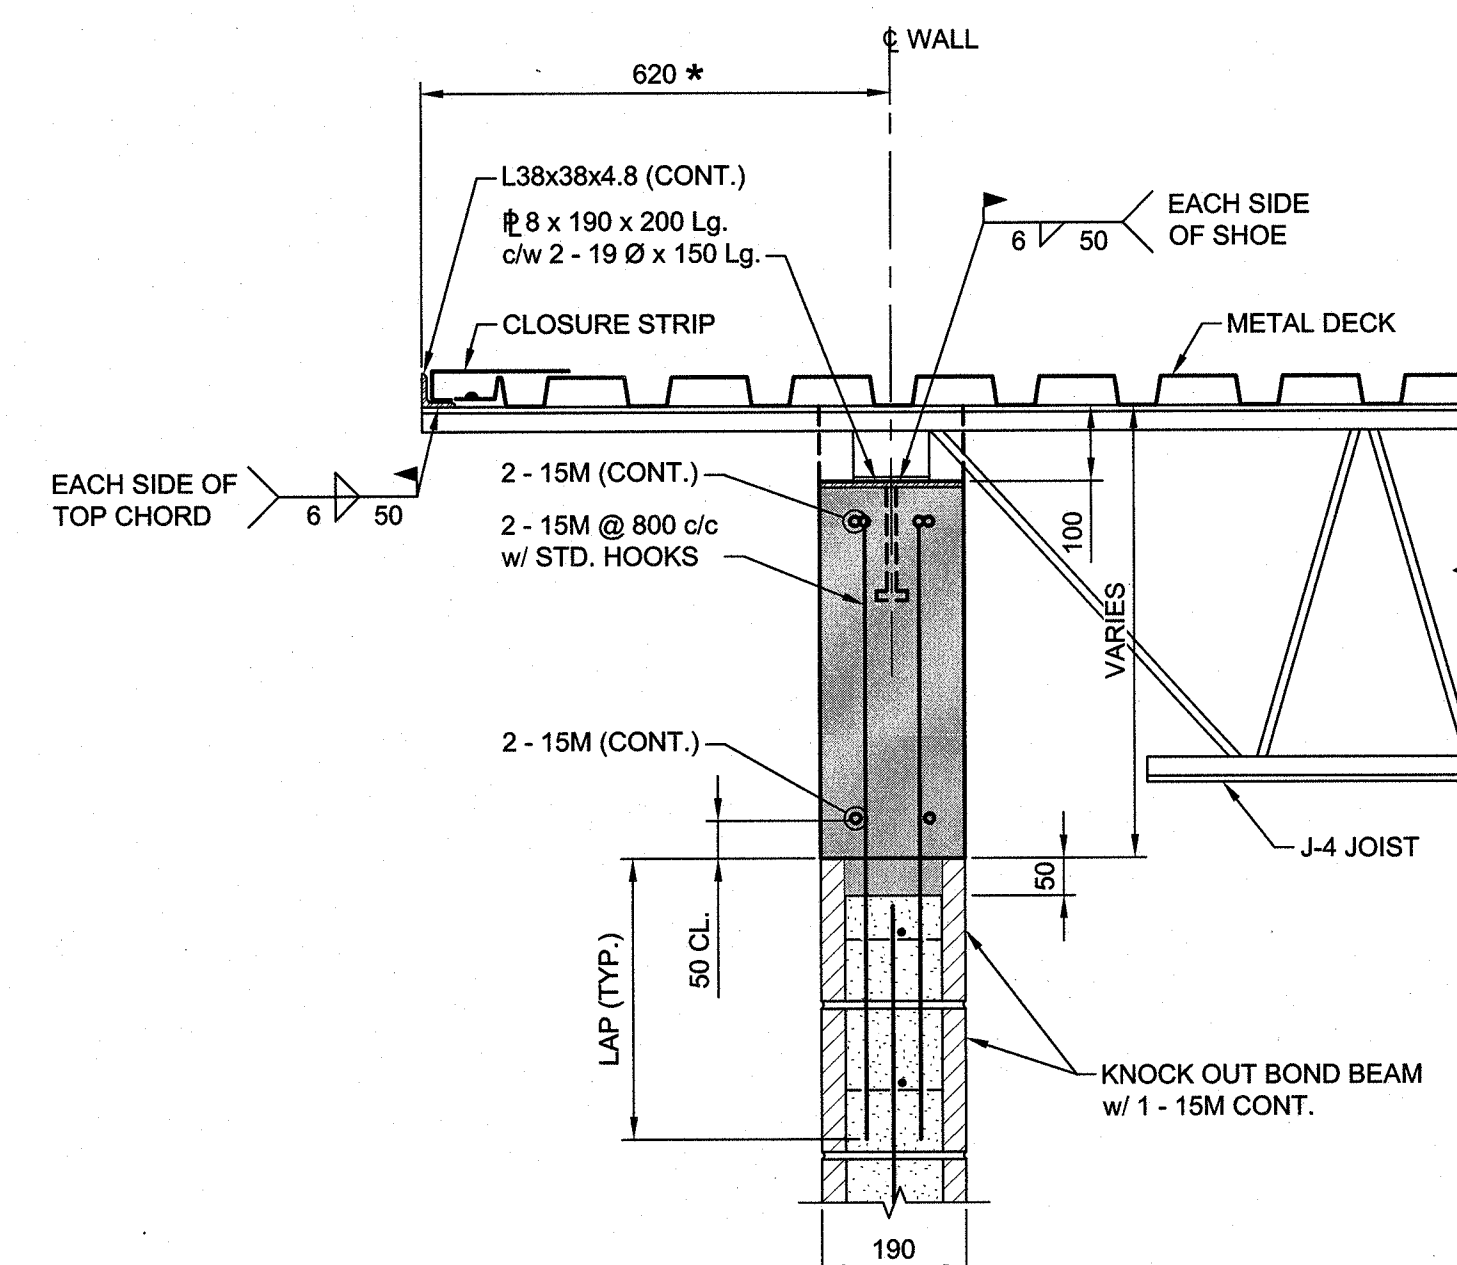

(SHOWN AT JOIST POCKET)


SECTION D

SCALE : 1:10  
0mm 100 200 300 400 500 600 700 800 900 1000mm

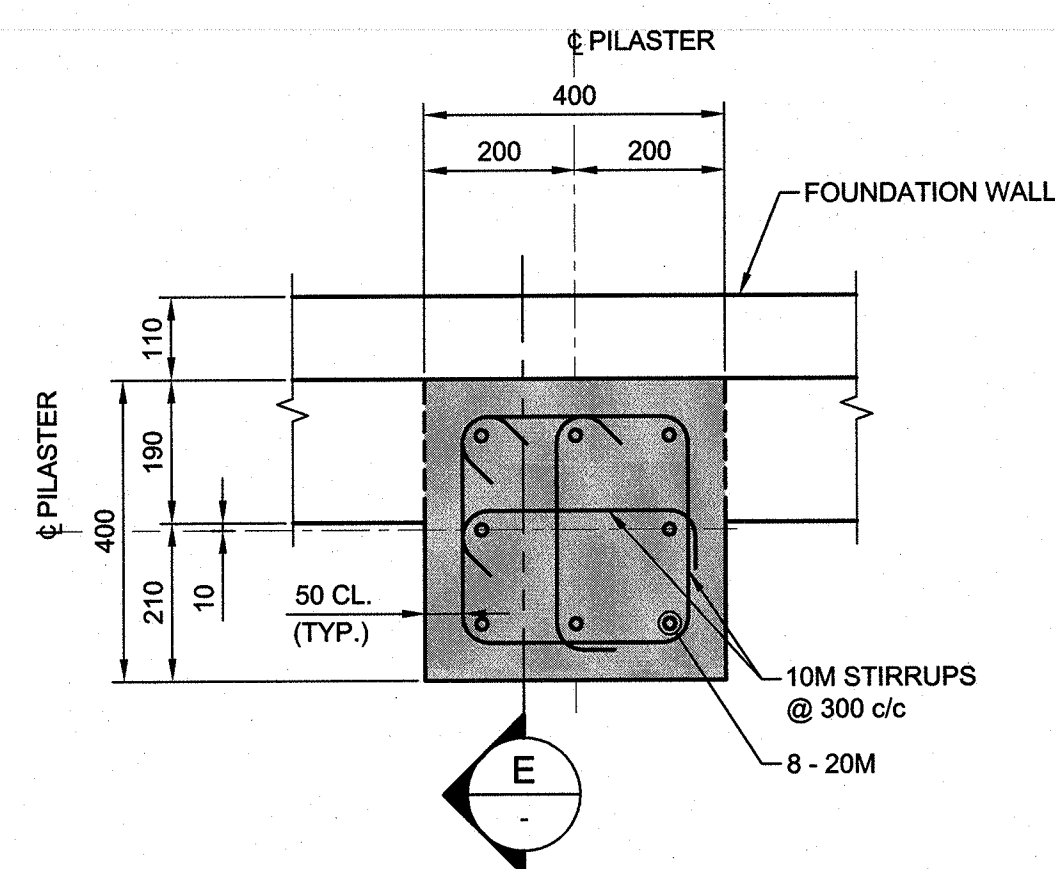

TYPICAL DRY STORAGE PILASTER


SCALE : 1:10  
0mm 100 200 300 400 500 600 700 800 900 1000mm

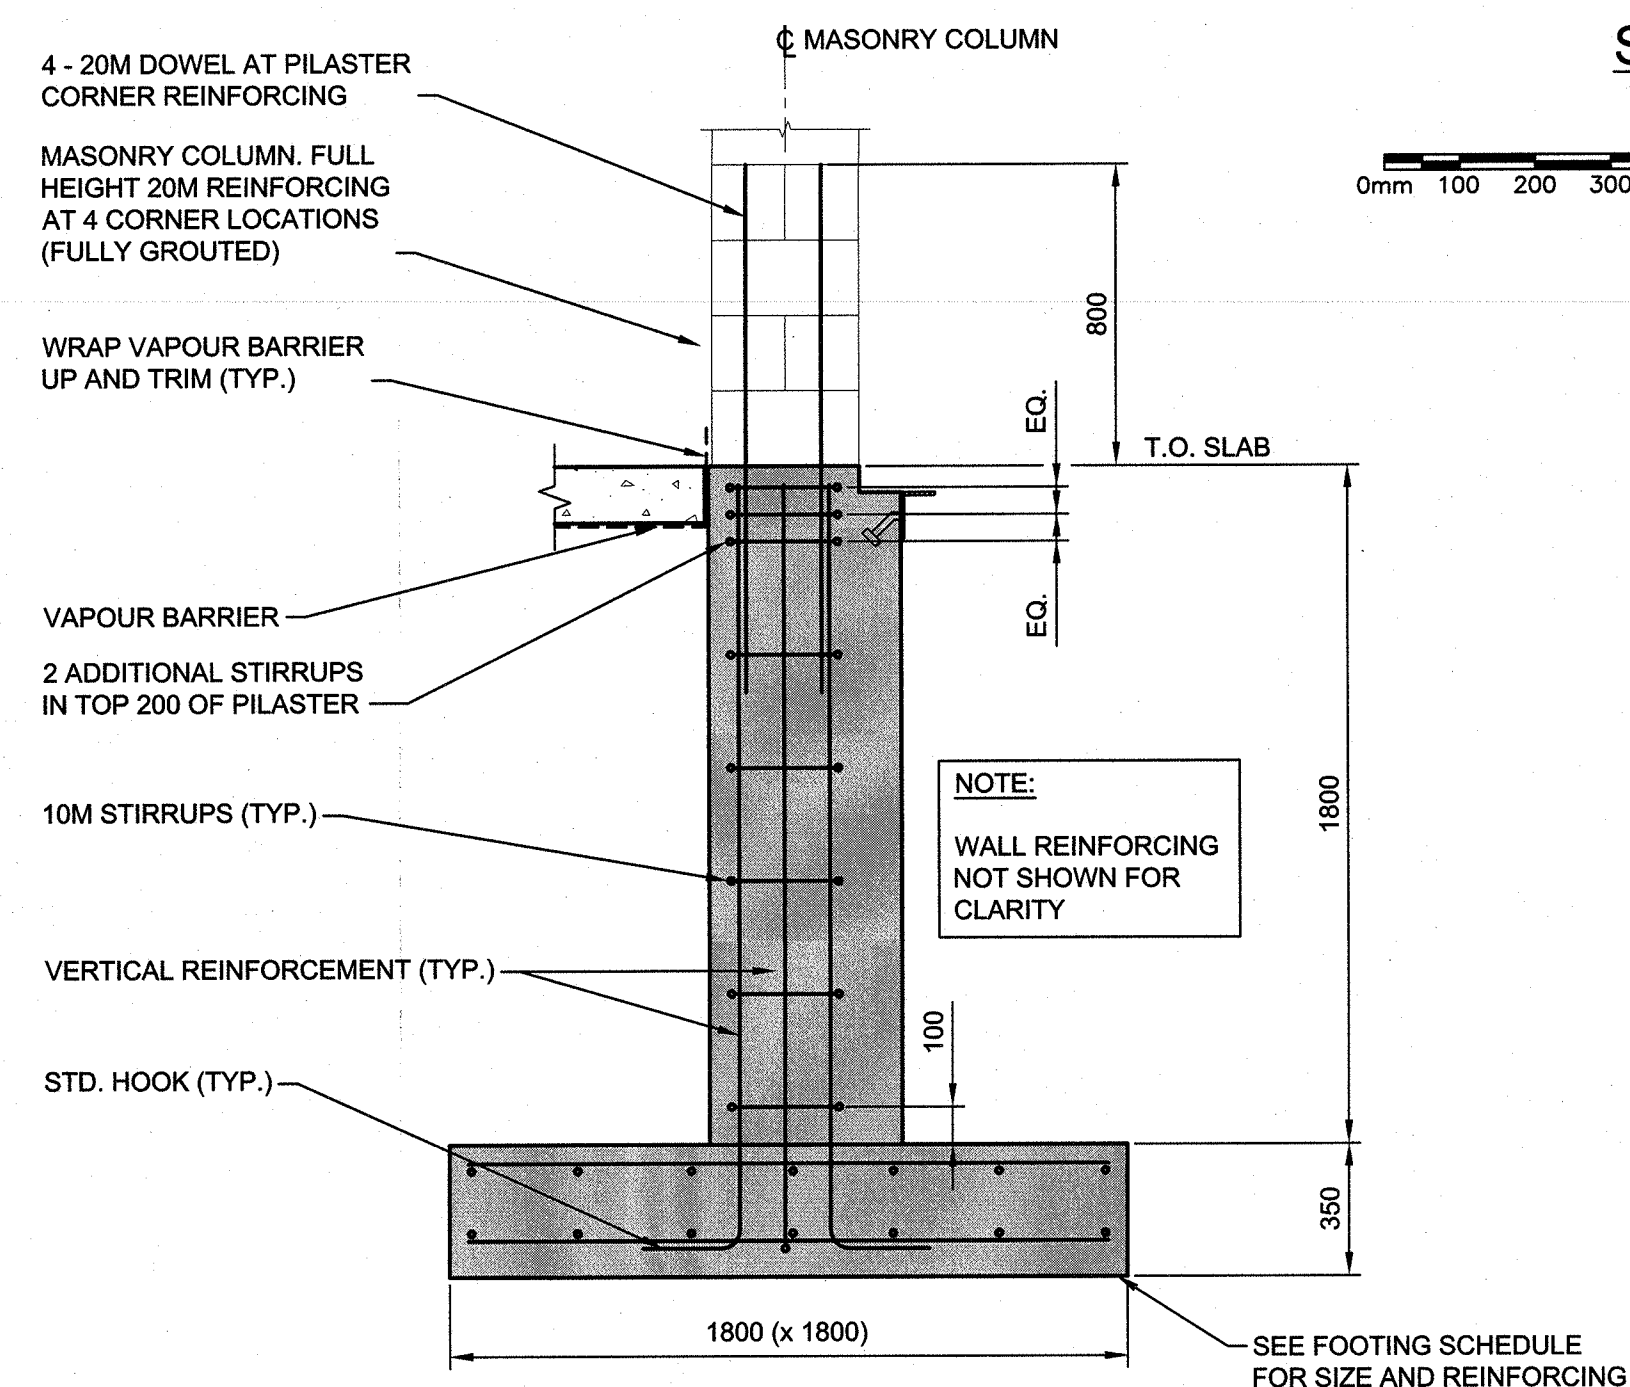

SECTION E

SCALE : 1:20  
0mm 500mm 1000mm 1500mm 2000mm 2500mm

- PILASTER NOTES:**
1. EQUALLY SPACE LONGITUDINAL BARS SHOWN ALONG EACH FACE OF PILASTER (TYP.).
  2. ALTERNATE LOCATION OF PILASTER STIRRUP HOOKS.
  3. CONTINUE HORIZONTAL FOUNDATION WALL REINFORCING THROUGH PILASTERS.
  4. CONTINUE FOUNDATION WALL FOOTING HORIZONTAL REINFORCING THROUGH PILASTER FOOTINGS.

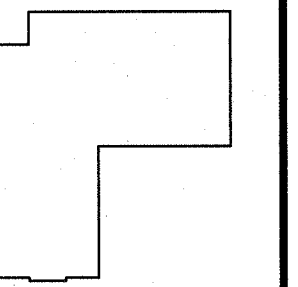


KEY PLAN

SCALE - NTS

## NOTES

1. SEE DRAWING 301-1 FOR FOUNDATION GENERAL NOTES, LEGEND AND 300 SERIES DWGS. FOR CONCRETE DETAILS.
2. SEE DRAWING 501-1 FOR STEEL GENERAL NOTES, LEGEND AND 500 SERIES DWGS. FOR STEEL FRAMING DETAILS.
3. SEE 400 SERIES DWGS. FOR MASONRY REINFORCING SCHEDULE AND DETAILS.

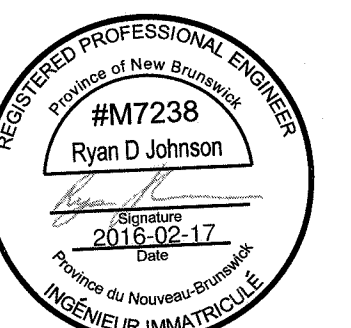

0	RELEASED FOR CONSTRUCTION	01/29/2016
revisions		date
project		project

NEW  
G.O.C.B  
SAINT-LÉONARD  
NEW BRUNSWICK

## DRY STORAGE BUILDING FOUNDATION PLAN, FRAMING PLAN, SECTIONS AND DETAILS

designed	RDJ	conçu
date	JANUARY 29, 2016	
drawn	ECM	dessiné
date	JANUARY 29, 2016	
approved	DAG	approuvé
date	FEBRUARY 17, 2016	
tender		Submission
PM/SC Project Manager	Administrateur de projets IPSC	
project number		no. du projet
	R.069499.001	
drawing no.		no. du dessin
	301-4	