

Contractor to verify all dimensions & conditions on site and immediately notify the engineer of all discrepancies.

GENERAL NOTES


- SEE SPECIFICATION FOR INSULATION MATERIAL AND INSTALLATION.
- PROVIDE SLEEPERS FOR ALL REFRIGERATION PIPING ON THE ROOF. SEE SPECIFICATIONS FOR DETAIL.

DRAWING NOTES

- REFRIGERATION LINES FROM EV-5 TO CU-5. SEE SPECIFICATIONS FOR INSULATION AND INSTALLATION DETAILS. REFER TO 2/M102 FOR PENETRATION DETAIL.
- NEW ROOF MOUNTED CONDENSERS (LOWER "GREEN" ROOF), SEE SCHEDULE ON DRAWING M101 AND INSTALLATION DETAIL 3/M102. FOR FURTHER DETAILS SEE SPECIFICATIONS. AS SITE DIRECTED, RELOCATE 2.0 METER RADIUS.
- REFRIGERATION LINES FROM EV-3A, EV-3B TO CU-3. SEE SPECIFICATIONS FOR INSULATION AND INSTALLATION DETAILS. REFER TO 2/M102 FOR PENETRATION DETAIL.
- REFRIGERATION LINES FROM EV-1 TO CU-1. SEE SPECIFICATIONS FOR INSULATION AND INSTALLATION DETAIL. REFER TO 2/M102 FOR PENETRATION DETAIL.
- REFRIGERATION LINES FROM EV-2A, EV-2B TO CU-2. SEE SPECIFICATIONS FOR INSULATION AND INSTALLATION DETAILS. REFER TO 2/M102 FOR PENETRATION DETAIL.
- REFRIGERATION LINES FROM EV-4 TO CU-4. SEE SPECIFICATIONS FOR INSULATION AND INSTALLATION DETAIL. REFER TO 2/M102 FOR PENETRATION DETAILS.


NOTES:

- PREFINISHED METAL CAP, CROSS BROKEN FOR WATER RUNOFF AND STRENGTH.
- PROVIDE 25mm CLEARANCE TO PIPE AND SILICON CAULK WEATHERTIGHT.
- 250mm HIGH ROOF CURB, FLASHING AND STRIPS PRIME AND PAINT FLASHING TO MATCH CAP.
- PROVIDE FLEXIBLE INSULATION IN VOID AROUND PIPES.
- EXTEND ROOFING UP UNDER FLASHING.
- FILL VOID IN DECK WITH FLEXIBLE INSULATION SECURED IN PLACE.
- PIPING.
- GREEN ROOF - REINSTATE APPROPRIATE PERMEABLE PROTECTION MEMBRANE, DRAINAGE CELL PANEL, GEOTEXTILE MEMBRANE, SOIL AND PLANTING.

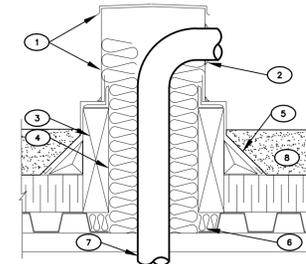

2 ROOF PLAN - PIPE PENETRATION DETAIL

SCALE: NTS

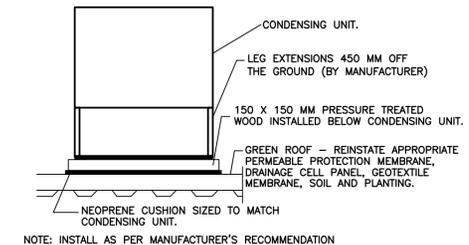

NOTE: INSTALL AS PER MANUFACTURER'S RECOMMENDATION


3 ROOF PLAN - CONDENSER MOUNTING DETAIL

SCALE: NTS



4 ROOF VIEW

SCALE: NTS

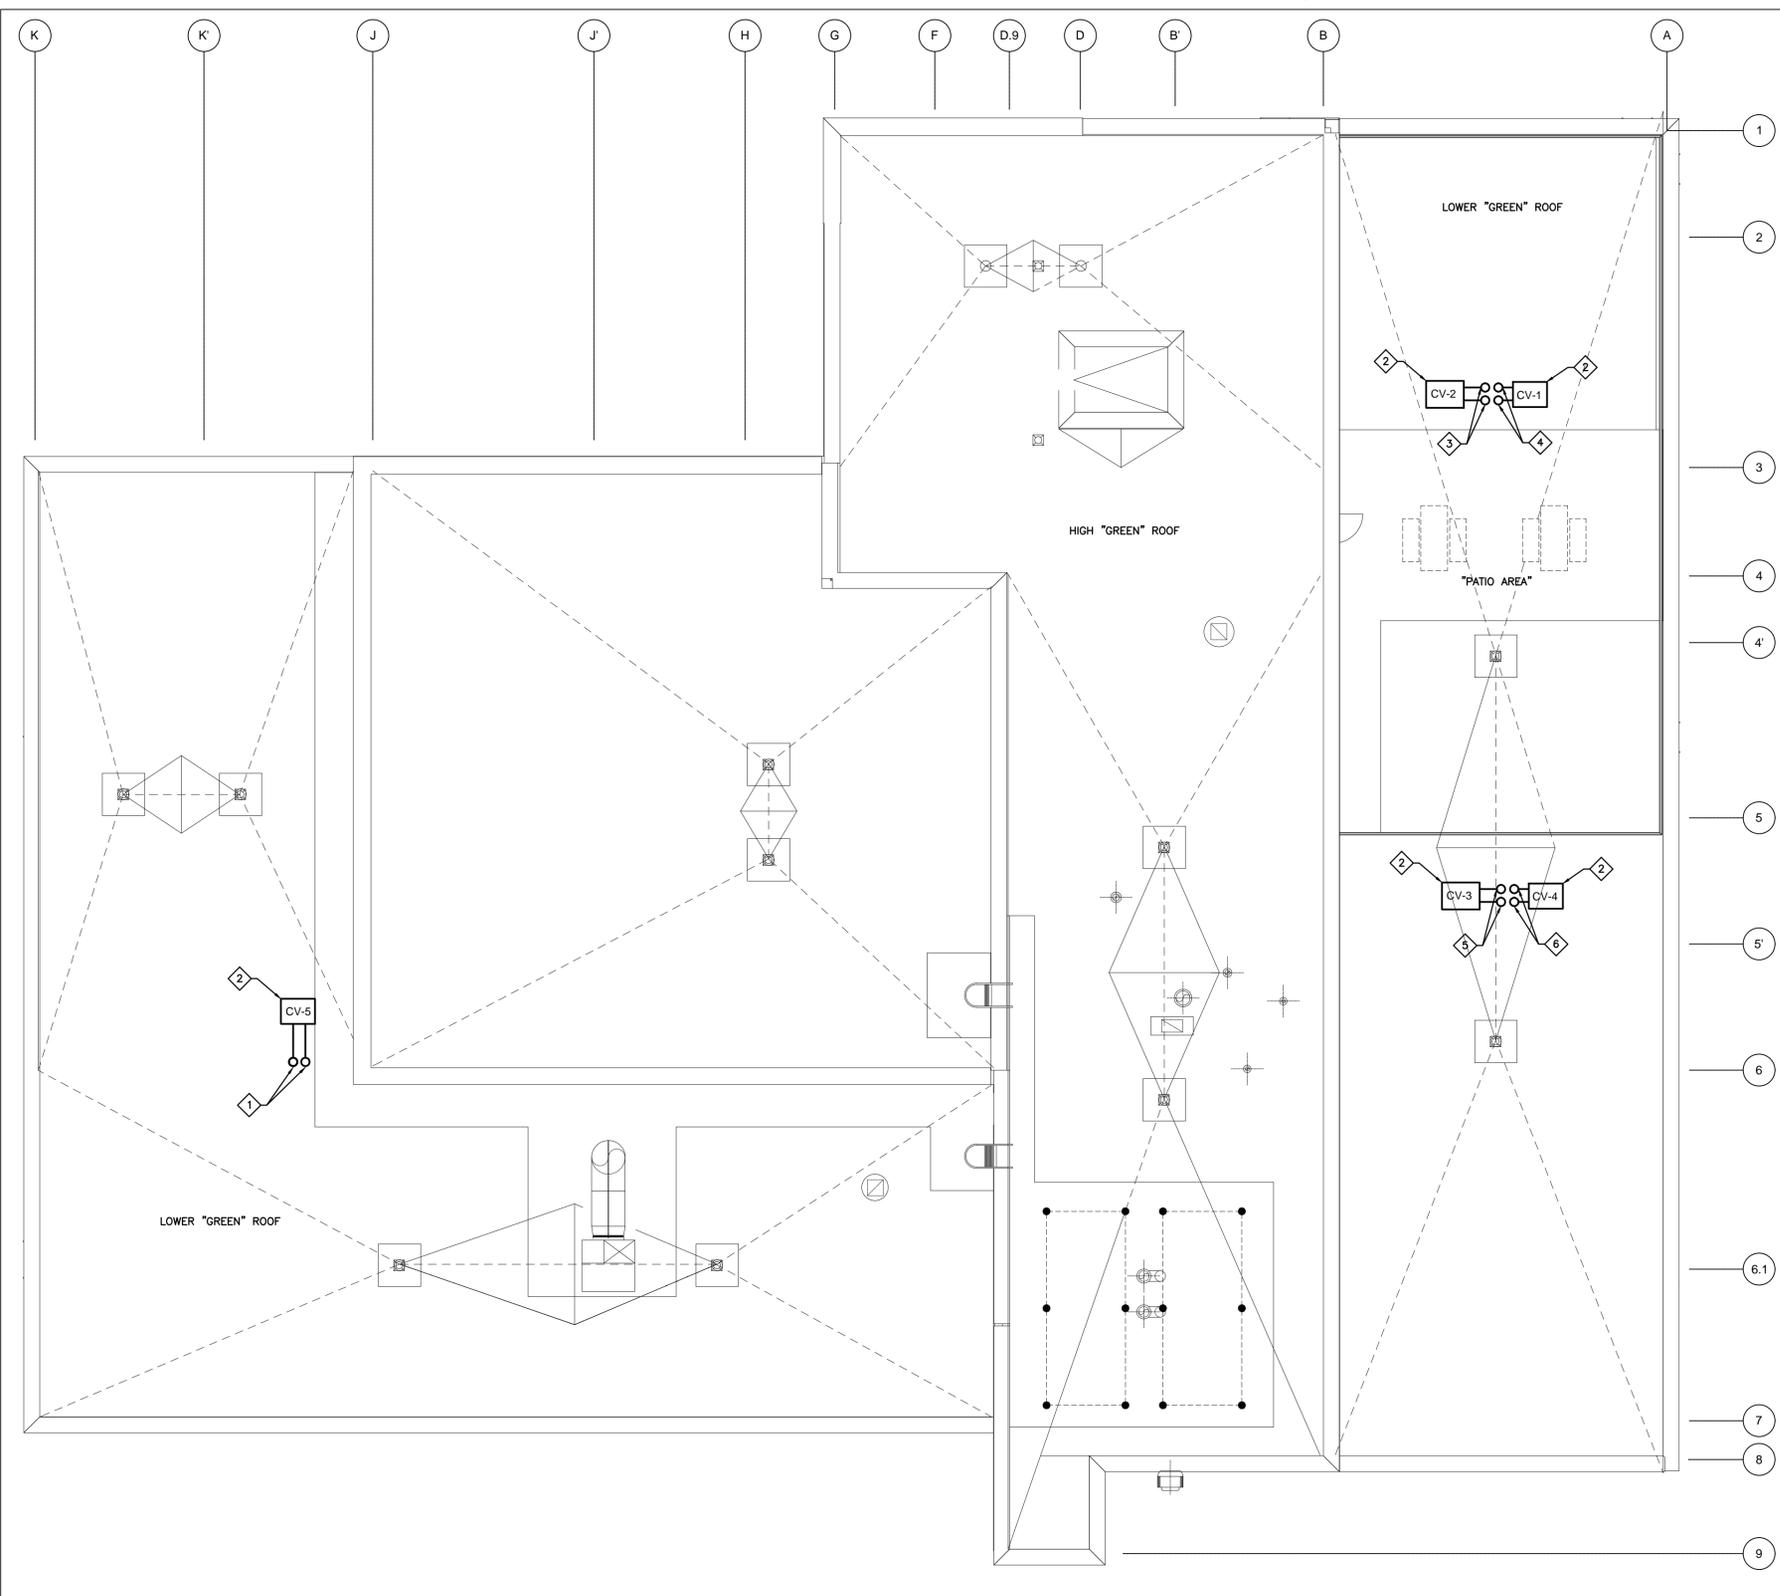

1 ROOF PLAN - NEW EQUIPMENT

SCALE: 1:100

revisions	description	date
1	ISSUED FOR TENDER	Feb 22, 2016

A	A detail no. n° du détail	A
C	B location drawing no. sur dessin n°	B
	C drawing no. dessin n°	C

project projet

REFRIGERATION SYSTEM BYPASS, HoC FOOD PRODUCTION FACILITY

1170 ALGOMA ROAD, OTTAWA, ONT

drawing dessin

ROOF PLAN NEW EQUIPMENT

Designed By C. Modrak Conçu par
Date October, 2015 (yyyy/mm/dd)

Drawn By G. Tremblay Dessiné par
Date October 2015 (yyyy/mm/dd)

Reviewed By C. Modrak Examiné par
Date October 2015 (yyyy/mm/dd)

Approved By G. Santyr Approuvé par
Date October 2015 (yyyy/mm/dd)

Tender Jordan Cook Soumission

Project Manager Administrateur de projets

Project no. n° du projet

R.034088.027

Drawing no. n° du dessin

M102