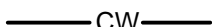

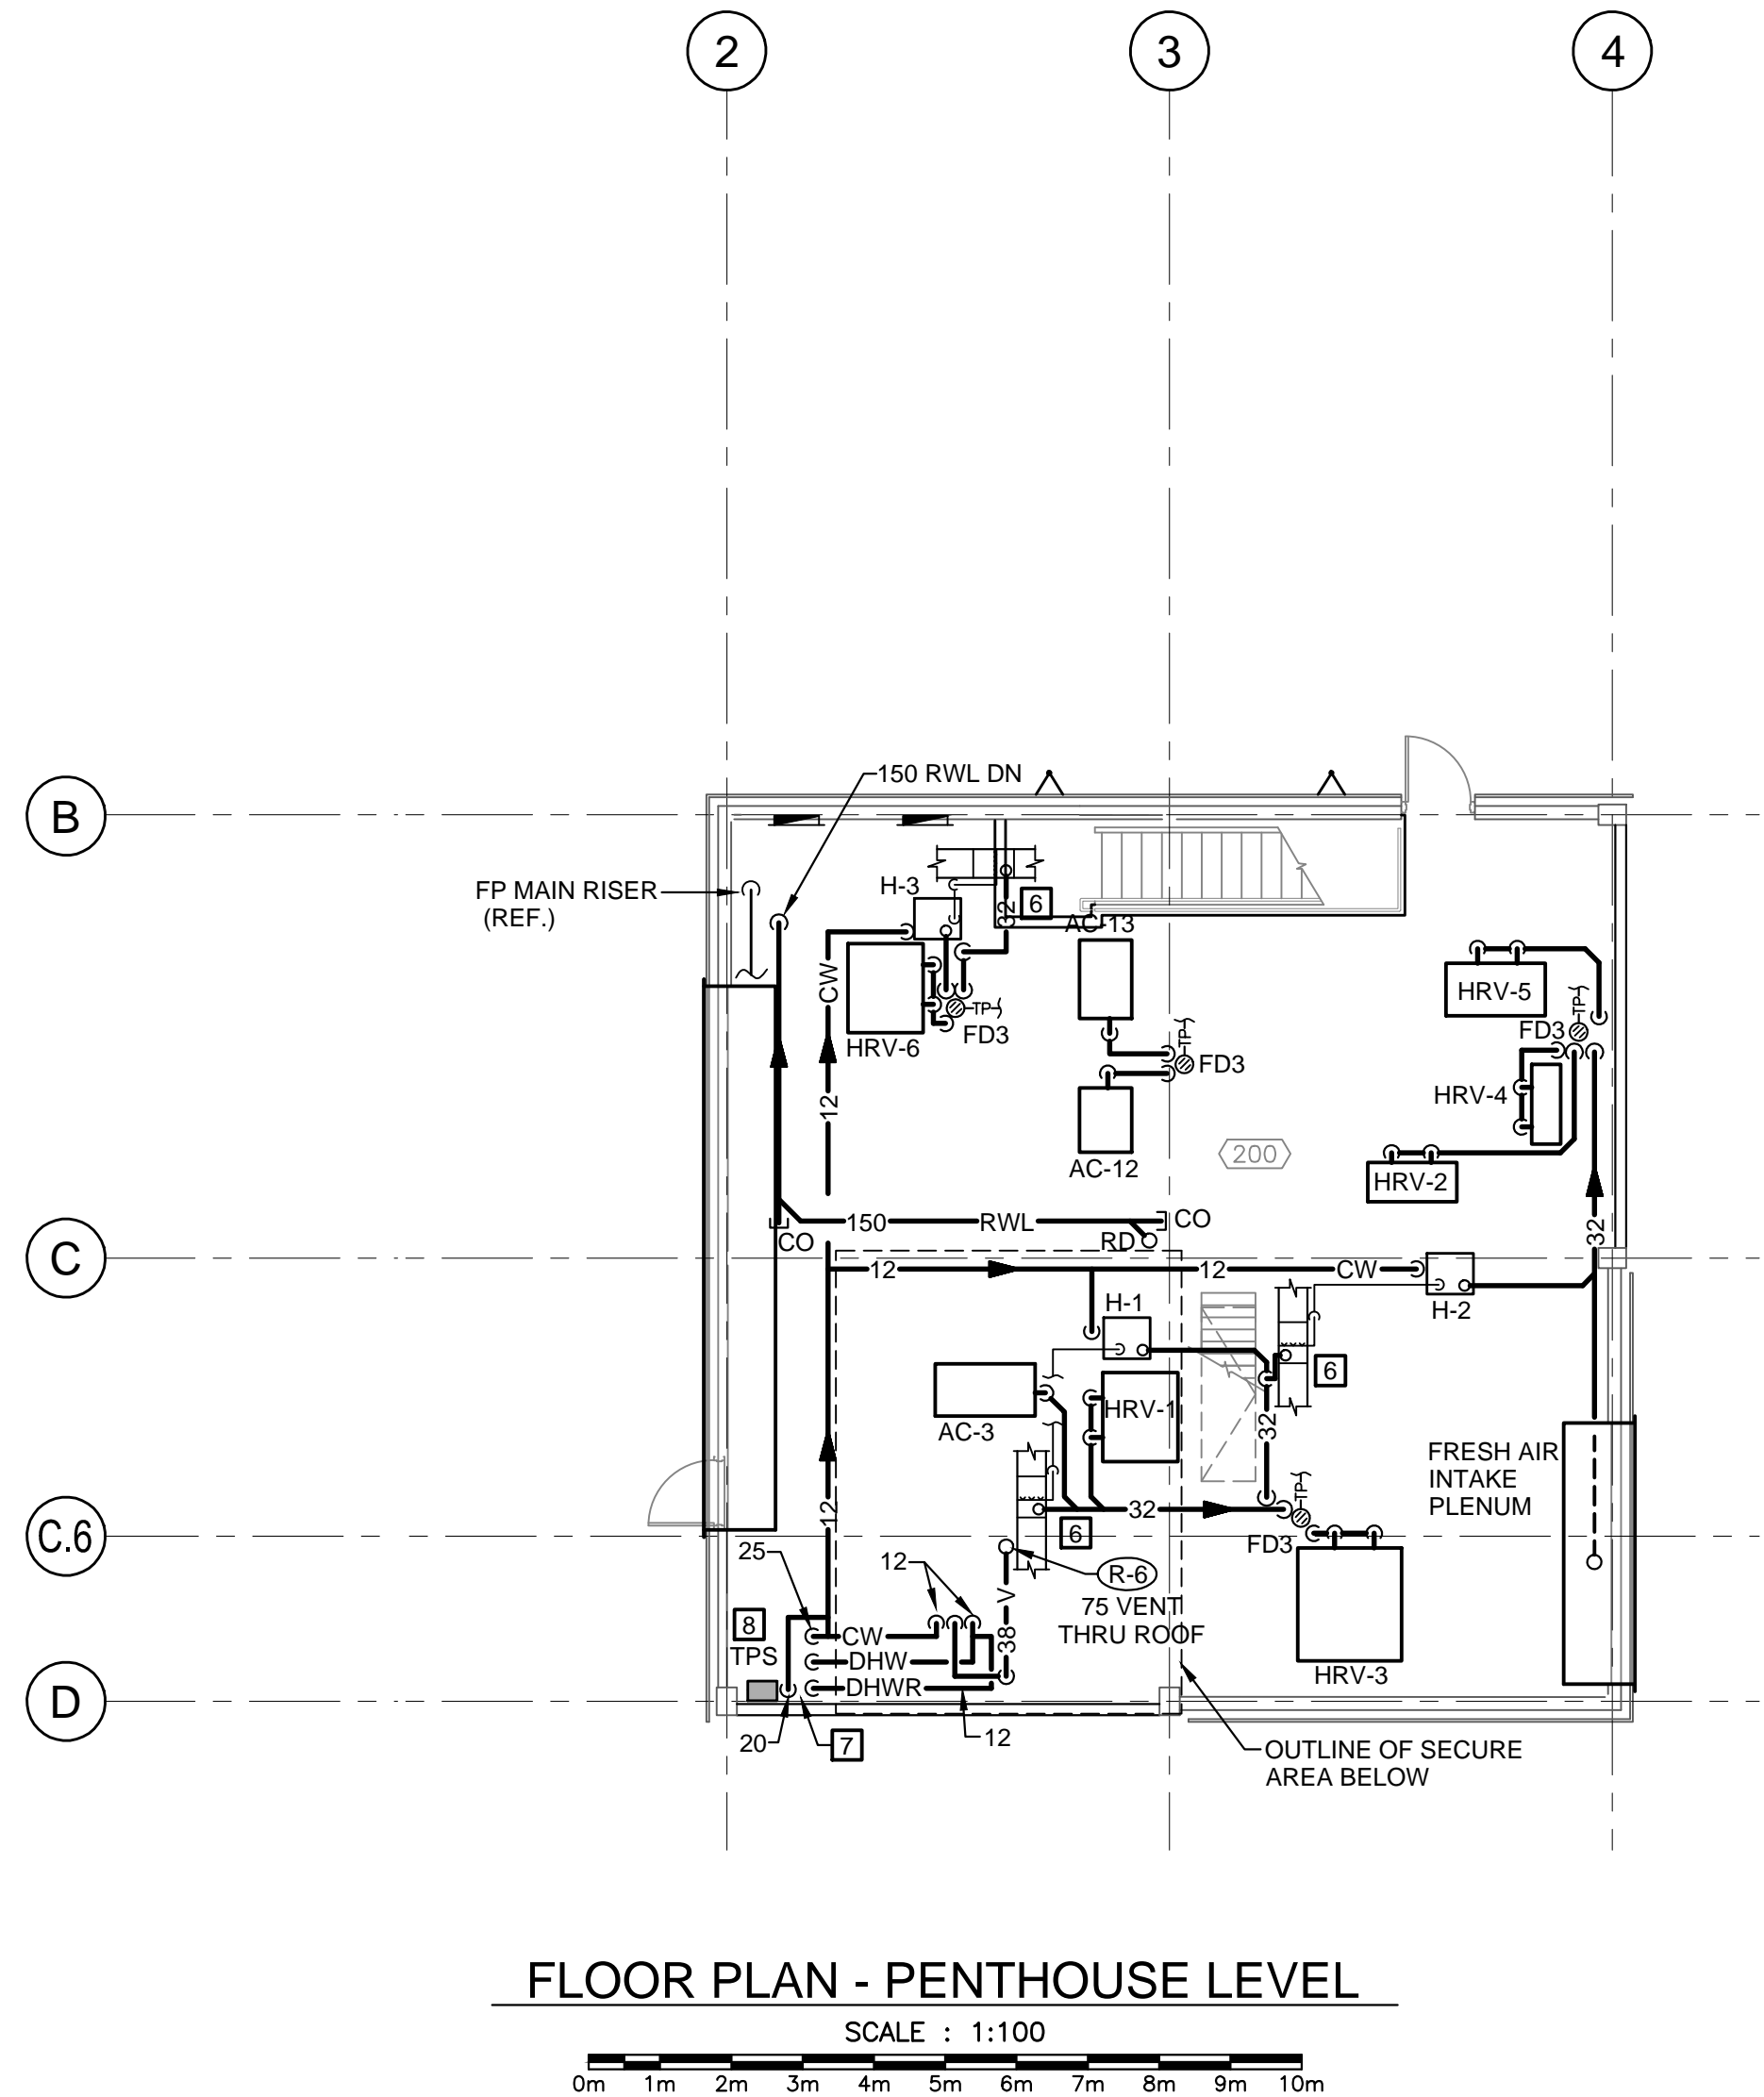


FLOOR PLAN - MAIN LEVEL  
SCALE : 1:100

LEGEND			
	NEW PIPING BELOW FLOOR	SH	SHOWER
	NEW PIPING ABOVE FLOOR	SH1	SHOWER (BARRIER FREE)
	SANITARY WASTE	SH2	SHOWER (PENAL)
	TRAP PRIMER	CS1	COUNTER SINK (TYPE 1)
	VENT	CL1	COUNTER LAVATORY (TYPE 1)
	DOMESTIC COLD WATER	HV	HOSE VALVE
	DOMESTIC HOT WATER	HD	HUB DRAIN
	DOMESTIC HOT WATER RETURN	FD1	FLOOR DRAIN (TYPE 1)
	HIGH TEMP. DOMESTIC HOT WATER	PRV	PRESSURE REDUCING VALVE
	RAIN WATER LEADER	EEW	EMERGENCY EYEWASH
	STORM	TWU	TEMPERED WATER UNIT
	CONDENSATE DRAIN	RV	RELIEF VALVE
	PIPE SIZE (38mm DIA.)	HB	NON FREEZE WALL HYDRANT
	GATE VALVE	WF	WATER FILTER
	BALL VALVE	A/D	ACCESS DOOR
	GLOBE VALVE	BFP	BACKFLOW PREVENTER (RP TYPE)
	STRAINER	WB	WASHER BOX
	CHECK VALVE	BWV	BACKWATER VALVE
	DHWR FLOW BALANCING VALVE	RD	ROOF DRAIN
	UNION	WM	WASHING MACHINE (N.I.C.)
	DIRECTION OF FLOW		SHOCK ABSORBER
	PIPE CAPPED OFF		THERMOMETER
	FIRE PROTECTION	VB	VACUUM BREAKER
	CLEANOUT (IN FLOOR)		WIRING BY DIV. 25
	CLEANOUT (ABOVE FLOOR)		WIRING BY DIV. 26
	PIPE UP		NEW FIXTURE
	PIPE DOWN		ROOM/STATION NUMBER
WC	WATER CLOSET	CS	CURRENT SENSOR
WC1	WATER CLOSET (BARRIER FREE)	TMV	THERMOSTATIC MIXING VALVE
JS	JANITOR'S SINK		EQUIPMENT BY OTHERS
L	LAVATORY	PS	PRESSURE SENSOR
WCL	WATER CLOSET/LAVATORY (PENAL)		VENT STACK RISER #1

- GENERAL PLUMBING NOTES
- CONTRACTOR SHALL REVIEW PROPOSED WASTE AND VENT PIPING ARRANGEMENT WITH LOCAL PLUMBING INSPECTOR PRIOR TO INSTALLATION.
  - ALL U/G DRAIN PIPING BELOW FLOOR SLAB TO BE MIN. 50 DIA.
  - FIXTURE CLEANOUTS TO BE INSTALLED AS PER PLUMBING CODE.
  - REFER TO ARCHITECTURAL DRAWINGS FOR ALL TYPES OF WALLS AND ROOM NUMBERS.
  - EACH FIXTURE TO BE c/w INDIVIDUAL ISOLATION VALVES.
  - PROPOSED WASTE AND VENT PIPING SYSTEM IS PRESENTED ON THE DRAWINGS AS A GENERAL ARRANGEMENT. PLUMBING CONTRACTOR IS RESPONSIBLE FOR INSTALLATION OF ADDITIONAL DRAINS, VENTS, TRAPS, CLEANOUTS, ETC. AS REQUIRED TO CONFORM WITH THE LATEST EDITION OF THE CANADIAN PLUMBING CODE.
  - CORE DRILLING REQUIRED SHALL BE PROVIDED BY THE GENERAL CONTRACTOR. ALL HOLES THRU FLOOR SLAB TO BE SEALED WATER TIGHT WITH FIRE RATED CAULKING (BY GENERAL CONTRACTOR).
  - CONTRACTOR TO PERFORM BALL TEST ON ALL UNDERSLAB DRAIN LINES.

- KEYNOTES
- REFER TO DRAWING 201-3 FOR CONTINUATION OF SITE SERVICES.
  - ROUTE PIPING THRU CEILING SPACE. COORDINATE ROUTING ON SITE WITH LIGHTING, SPRINKLERS, DUCTWORK, ETC. AS REQUIRED.
  - NEW SANITARY AND STORM PIPING LOCATED UNDER FLOOR SLAB. COORDINATE ROUTING ON SITE TO AVOID INTERIOR CONCRETE FOOTINGS, ETC. AS REQUIRED. MINIMUM 1% SLOPE FOR NPS 75 AND LARGER. MINIMUM 2% SLOPE FOR NPS 50.
  - 1200 x 1200 x 200 RADON GAS SUCTION PIT - REFER TO STRUCTURAL DRAWINGS FOR ARRANGEMENT.
  - 150 DIA. PVC UNDERSLAB RADON GAS PIPING TO BE SLOPED TOWARDS SUCTION PIT. ROUTE PVC PIPING UP IN CHASE AS SHOWN TO CEILING SPACE AND THRU ROOF. PROVIDE GOOSENECK FITTING 900mm ABOVE FINISHED ROOF LEVEL.
  - ROUTE 32 DRAIN FROM HUMIDIFIER DRAIN PAN TO NEAREST FLOOR DRAIN AS SHOWN. MAINTAIN MAXIMUM HEIGHT THRU ROOM. REFER TO DETAIL ON DRAWING 2200-3 FOR PIPING ARRANGEMENT.
  - REFER TO DRAWING 2200-2 FOR PIPING CONTINUATION.
  - REFER TO DRAWING 2200-3 FOR TRAP PRIMER STATION PIPING DETAIL.
  - 100 UNDERSLAB SANITARY LINE CAPPED FOR FUTURE EXTENSION.
  - ROUTE 25 DRAIN FROM AC-14 THRU WALL AND CONNECT TO RWL PIPING.



FLOOR PLAN - PENTHOUSE LEVEL  
SCALE : 1:100

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CONST. NORTH

KEY PLAN  
SCALE - NTS

0 RELEASED FOR CONSTRUCTION 01/29/2016

revisions

project

NEW  
G.O.C.B  
SAINT-LEONARD  
NEW BRUNSWICK

drawing

desain

MAIN FLOOR PLAN  
SANITARY WASTE,  
VENT AND STORM PIPING

designed RDD conçu

date JANUARY 29, 2016

drawn RDD dessiné

date JANUARY 29, 2016

approved DAG approuvé

date FEBRUARY 17, 2016

Tender

Submission

PWSSC Project Manager Administrateur de projets TPSSC

project number no. du projet

R.069499.001

drawing no. no. du dessin

2200-1

E-DRM/GDD-E: 527793