


LIGHTING FLOOR PLAN - PENTHOUSE LEVEL

SCALE : 1:100

PWGSC B1 (2004)

KEYNOTES	
①	MOUNT LIGHT FIXTURES IN ROOM 200 AT 3048mm ABOVE FINISHED FLOOR. COORDINATE FINAL LOCATION AND HEIGHTS WITH MECHANICAL EQUIPMENT DUCTWORK AND PIPING INSTALLATION.
②	INSTALL WALL PACK AT 2500mm ABOVE FINISHED ROOF.
③	INSTALL WALL PACK AT 3300mm ABOVE FINISHED GRADE.

RELAY SCHEDULE						
RELAY	CIRCUIT	AREA	BREAKER	WATTS	TYPE	NOTES
R1	PA-1	SITE POLES (SW)	15A, 120V	800	LED	RELAY PANEL RP ROOM 124. CONTROL SEQUENCE: DUSK TO DAWN VIA BMS.
R2	PA-2	SITE POLES (SE)	15A, 120V	900	LED	RELAY PANEL RP ROOM 124. CONTROL SEQUENCE: DUSK TO DAWN VIA BMS.
R3	PA-3	SITE POLES (PARKING)	15A, 120V	1300	LED	RELAY PANEL RP ROOM 124. CONTROL SEQUENCE: DUSK TO DAWN VIA BMS.
R4	PA-4	SITE POLES (PARKING)	15A, 120V	1000	LED	RELAY PANEL RP ROOM 124. CONTROL SEQUENCE: DUSK TO DAWN VIA BMS.
R5	PA-5	SITE POLES (NW)	15A, 120V	800	LED	RELAY PANEL RP ROOM 124. CONTROL SEQUENCE: DUSK TO DAWN VIA BMS.
R6	PA-6	EXTERIOR (N)	15A, 120V	250	LED	RELAY PANEL RP ROOM 124. CONTROL SEQUENCE: DUSK TO DAWN VIA BMS.
R7	PA-8	EXTERIOR (S)	15A, 120V	250	LED	RELAY PANEL RP ROOM 124. CONTROL SEQUENCE: DUSK TO DAWN VIA BMS.
R8						SPARE 15A
R9						SPARE 15A
R10						
R11						
R12						
R13						
R14						
R15						
R16						

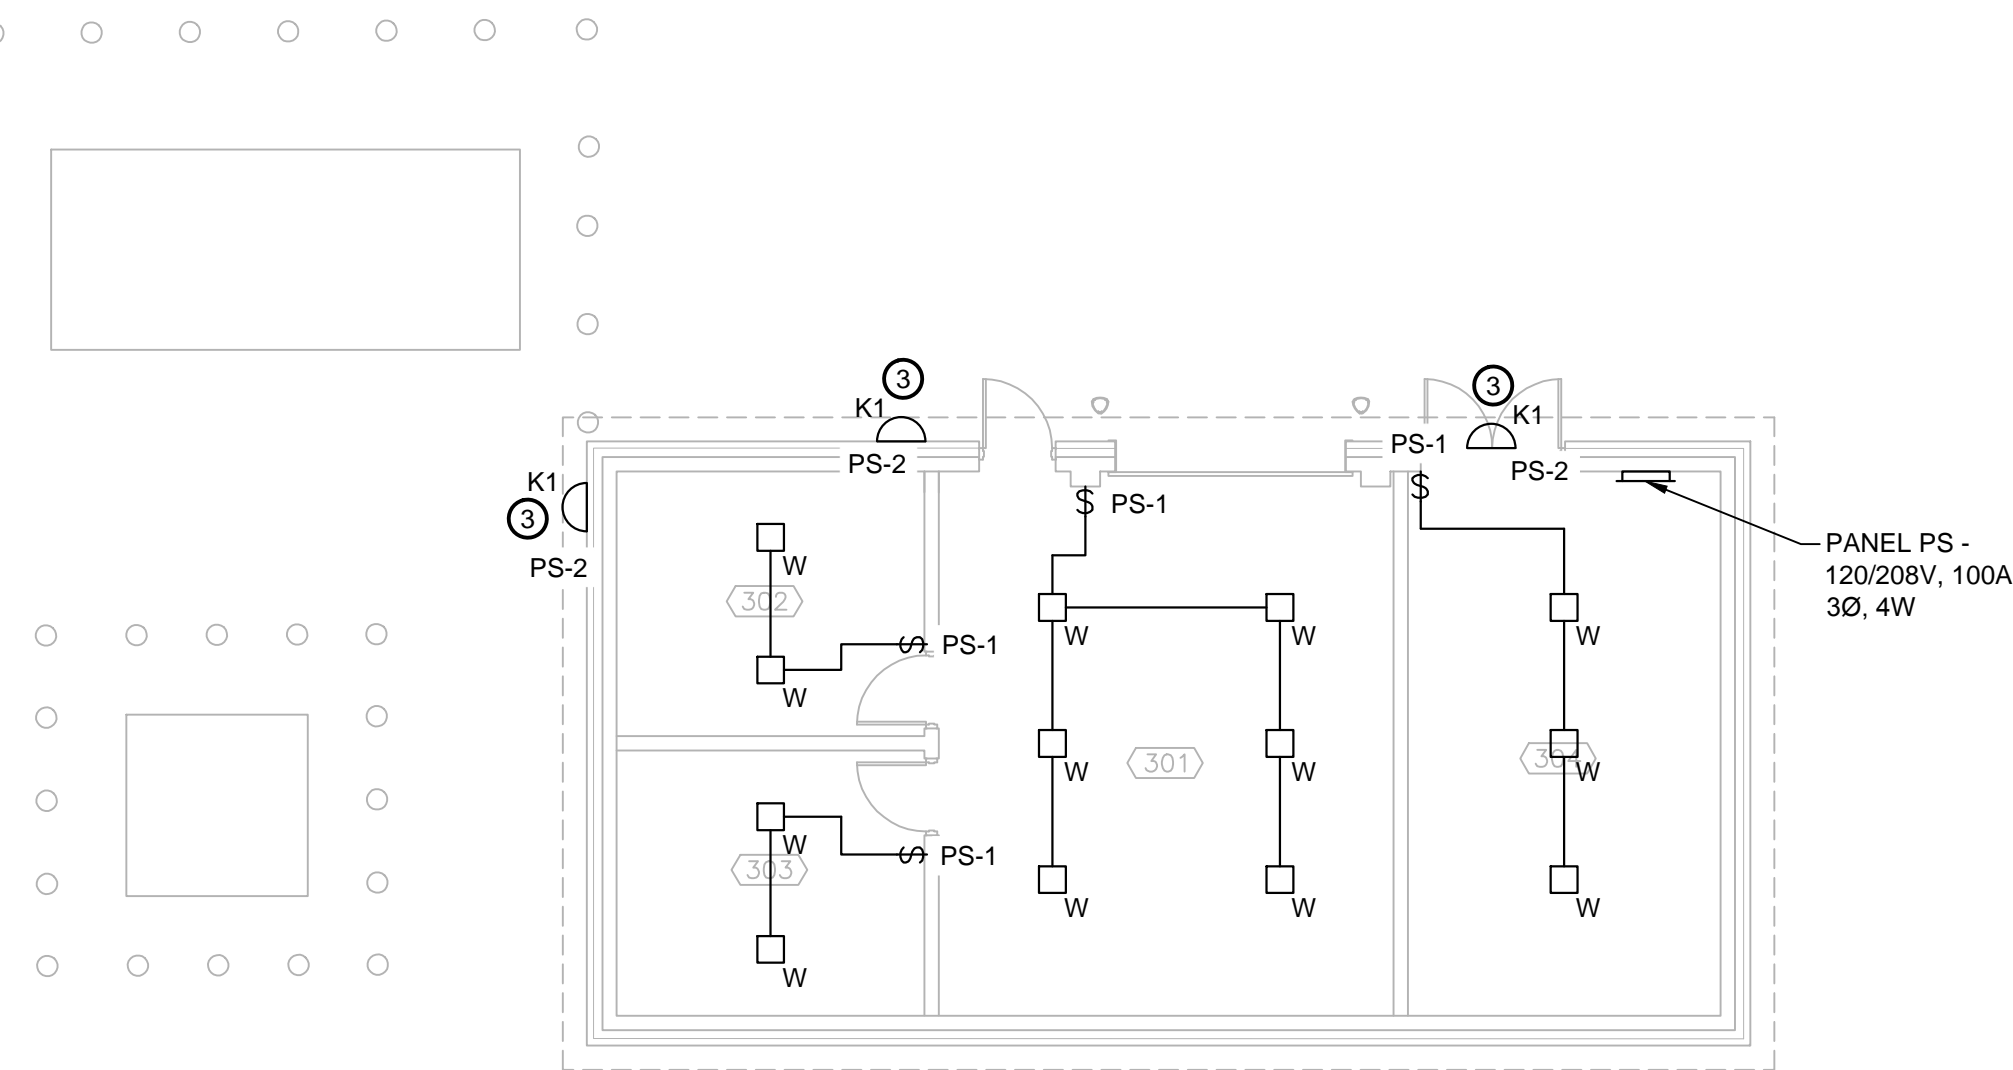


DRY STORAGE BUILDING LIGHTING PLAN

SCALE : 1:100



CONST. NORTH

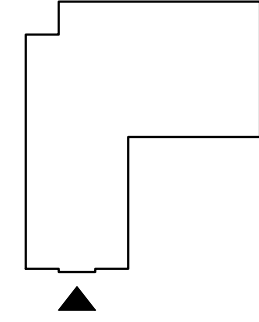

KEY PLAN

SCALE - NTS



0	RELEASED FOR CONSTRUCTION	01/29/2016
revisions		date
project		projet

NEW  
G.O.C.B  
SAINT-LÉONARD  
NEW BRUNSWICK

drawing dessin  
PENTHOUSE AND  
DRY STORAGE PLANS  
LIGHTING AND DETAILS

designed SRP	conçu
date JANUARY 29, 2016	
drawn CAM	dessiné
date JANUARY 29, 2016	
approved DAG	approuvé
date FEBRUARY 17, 2016	
Tender	Soumission

PWGSC Project Manager	Administrateur de projet TPSCG
project number	no. du projet
R.069499.001	
drawing no.	no. du dessin
2602-2	