




TYPICAL ROOF DRAIN
SCALE: 1:5
0mm 100mm 200mm 300mm 400mm 500mm

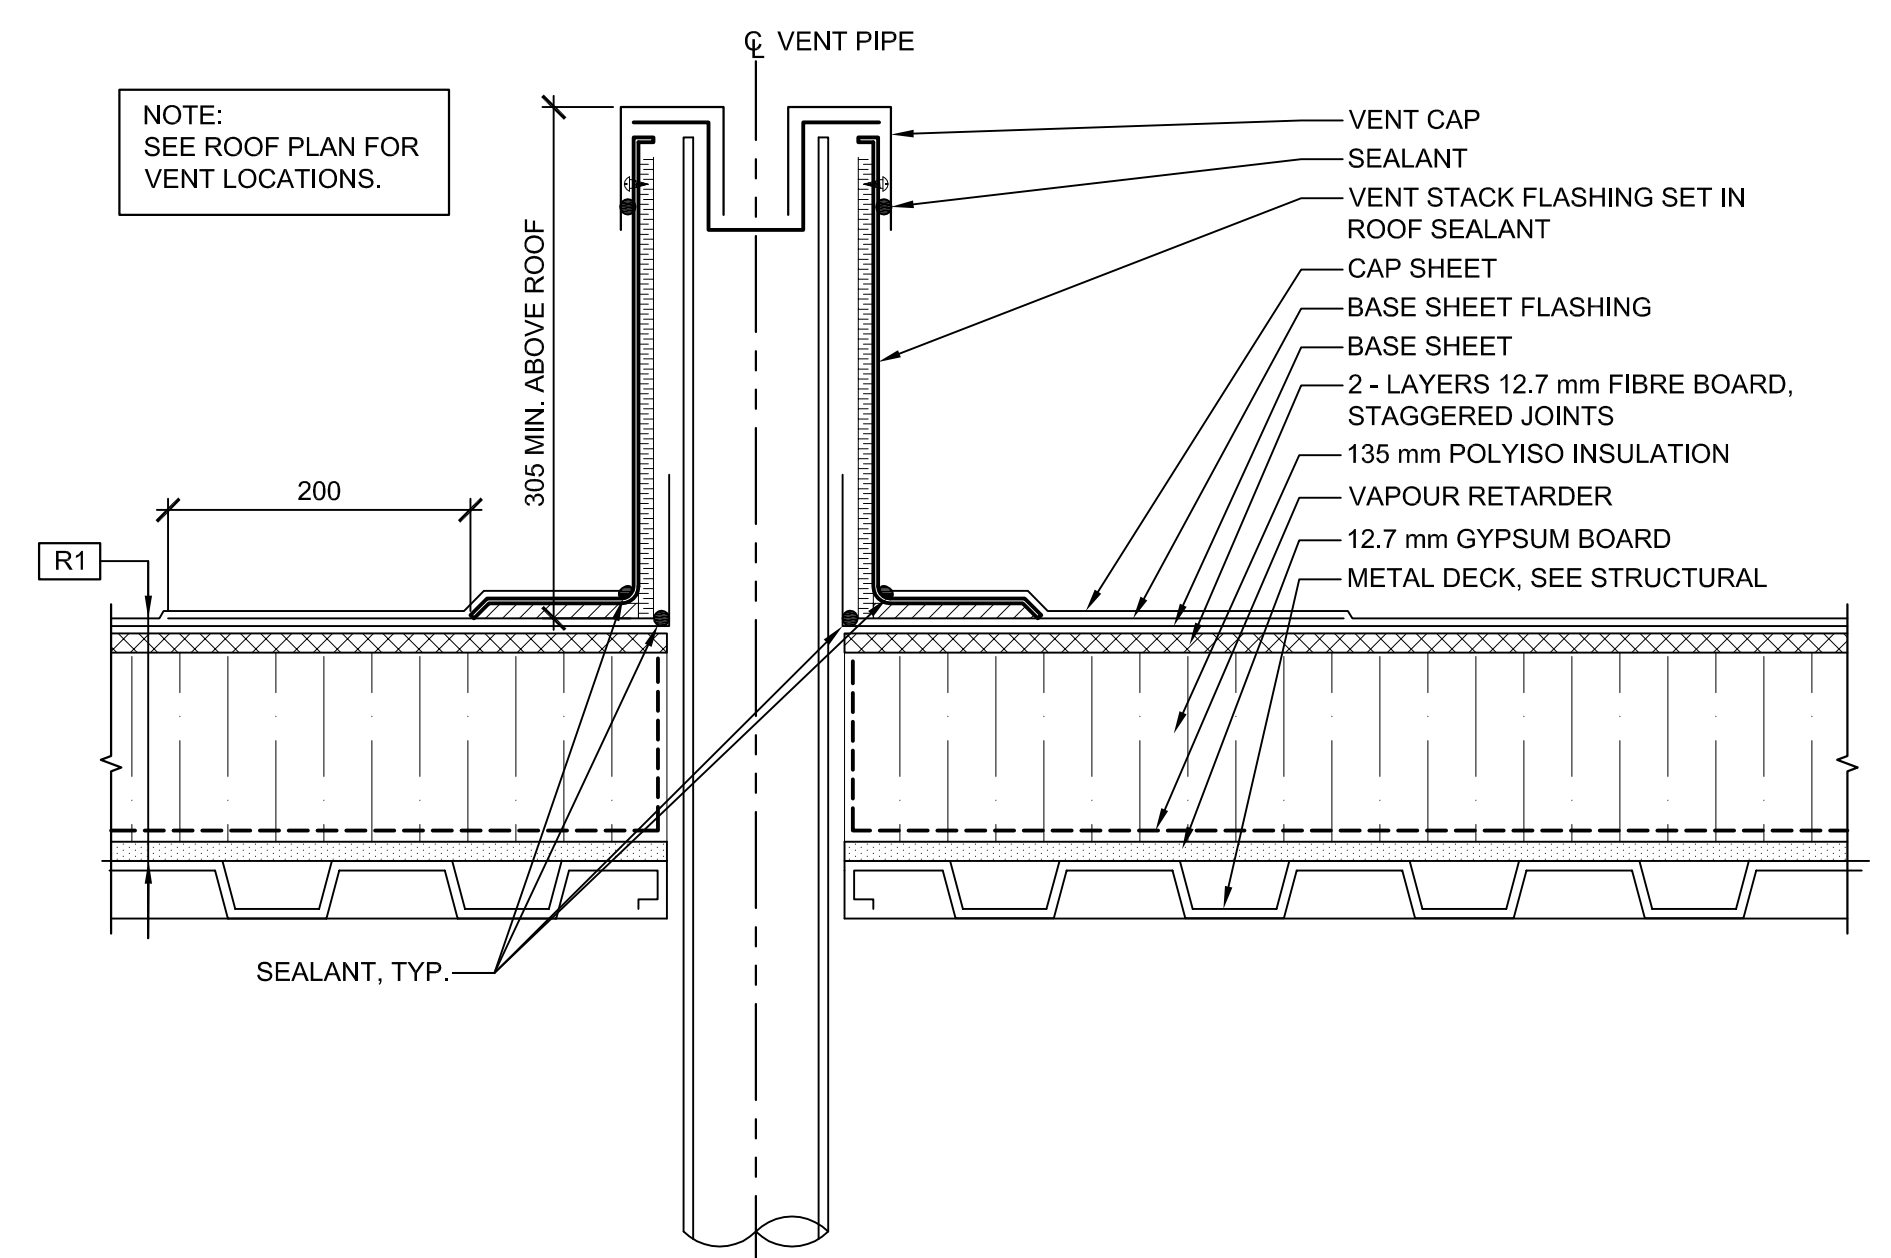


TYPICAL VENT STACK
SCALE: 1:5
0mm 100mm 200mm 300mm 400mm 500mm

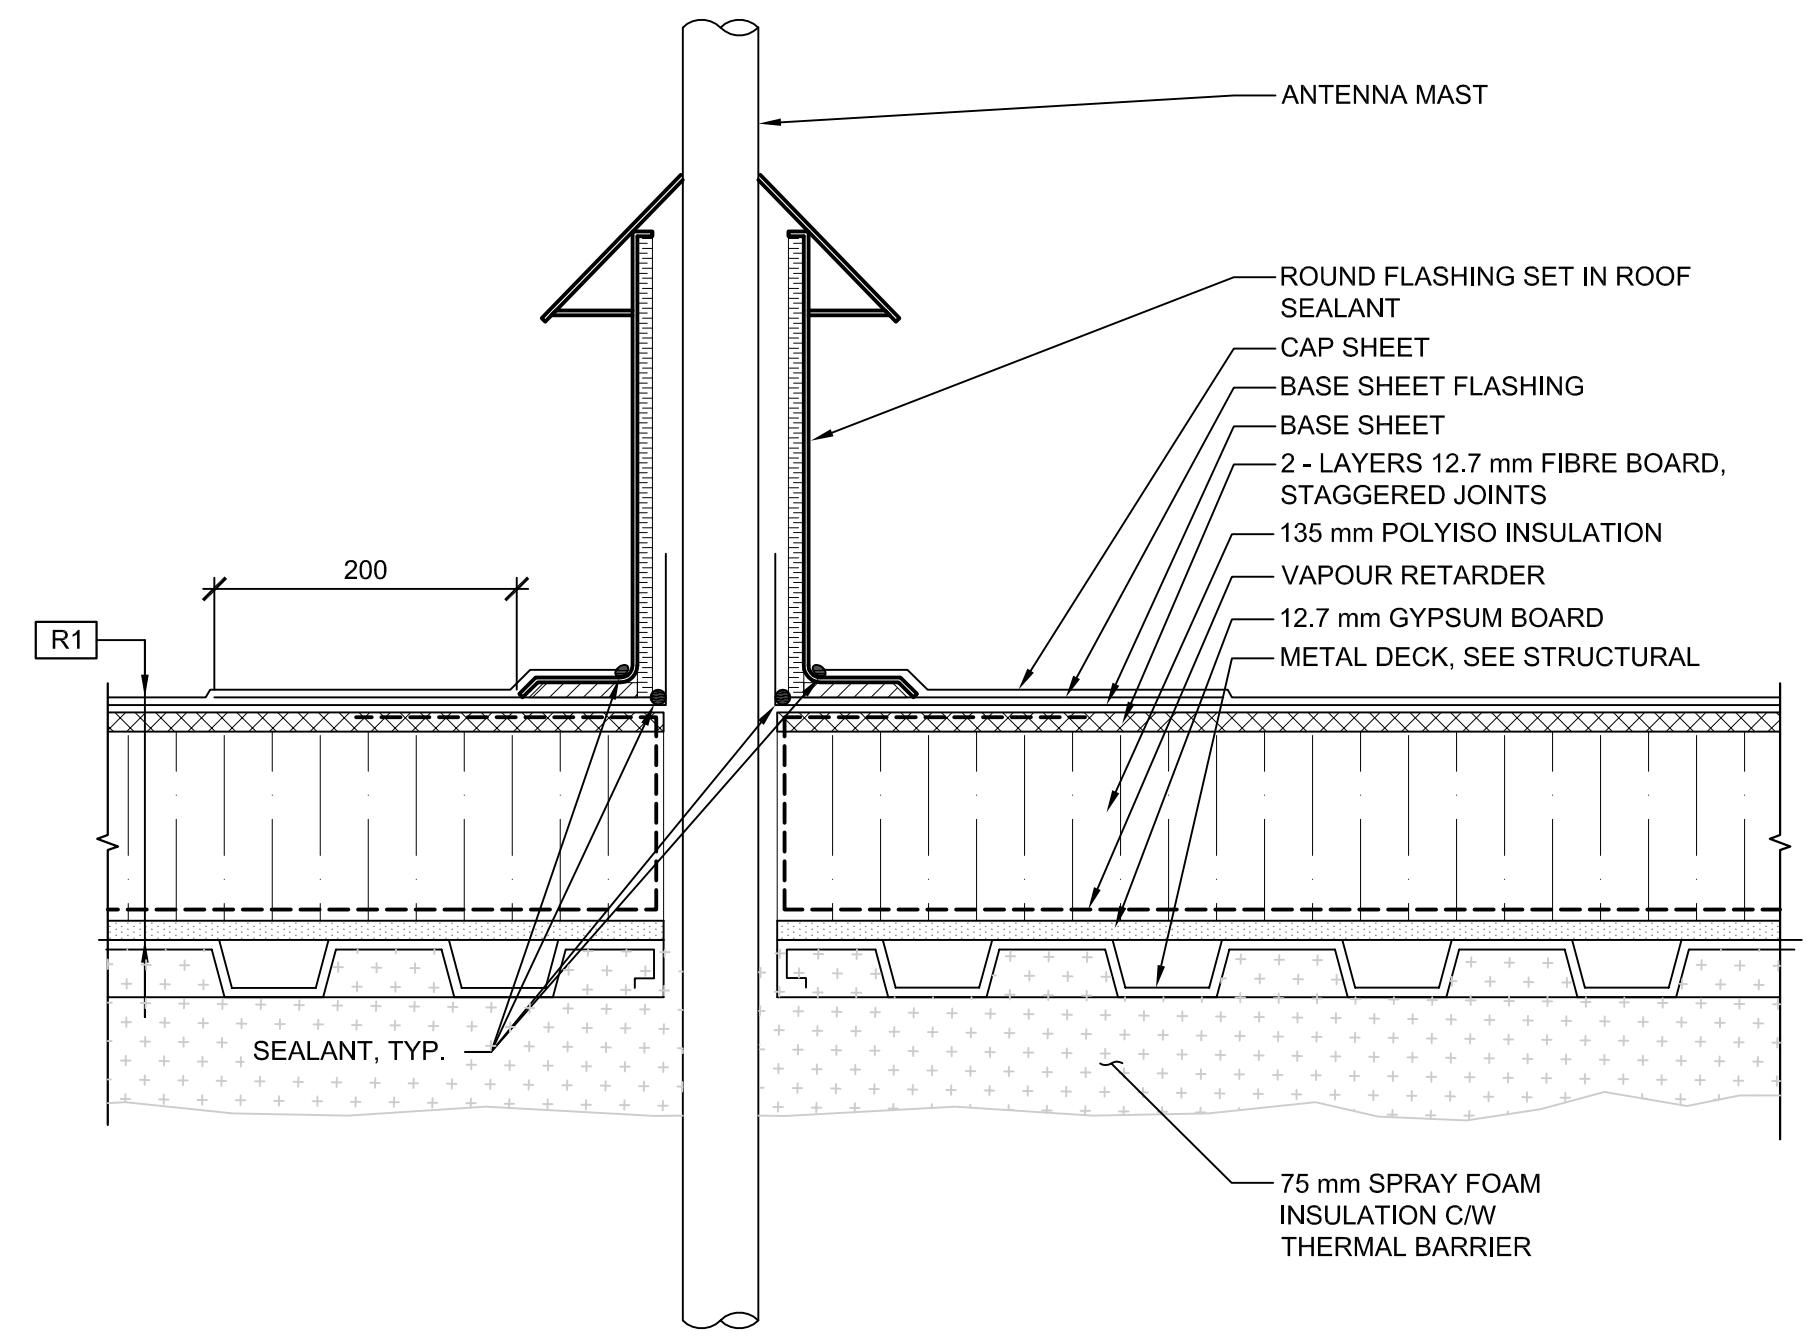


FLASHING AT ANTENNA MAST
SCALE: 1:5
0mm 100mm 200mm 300mm 400mm 500mm

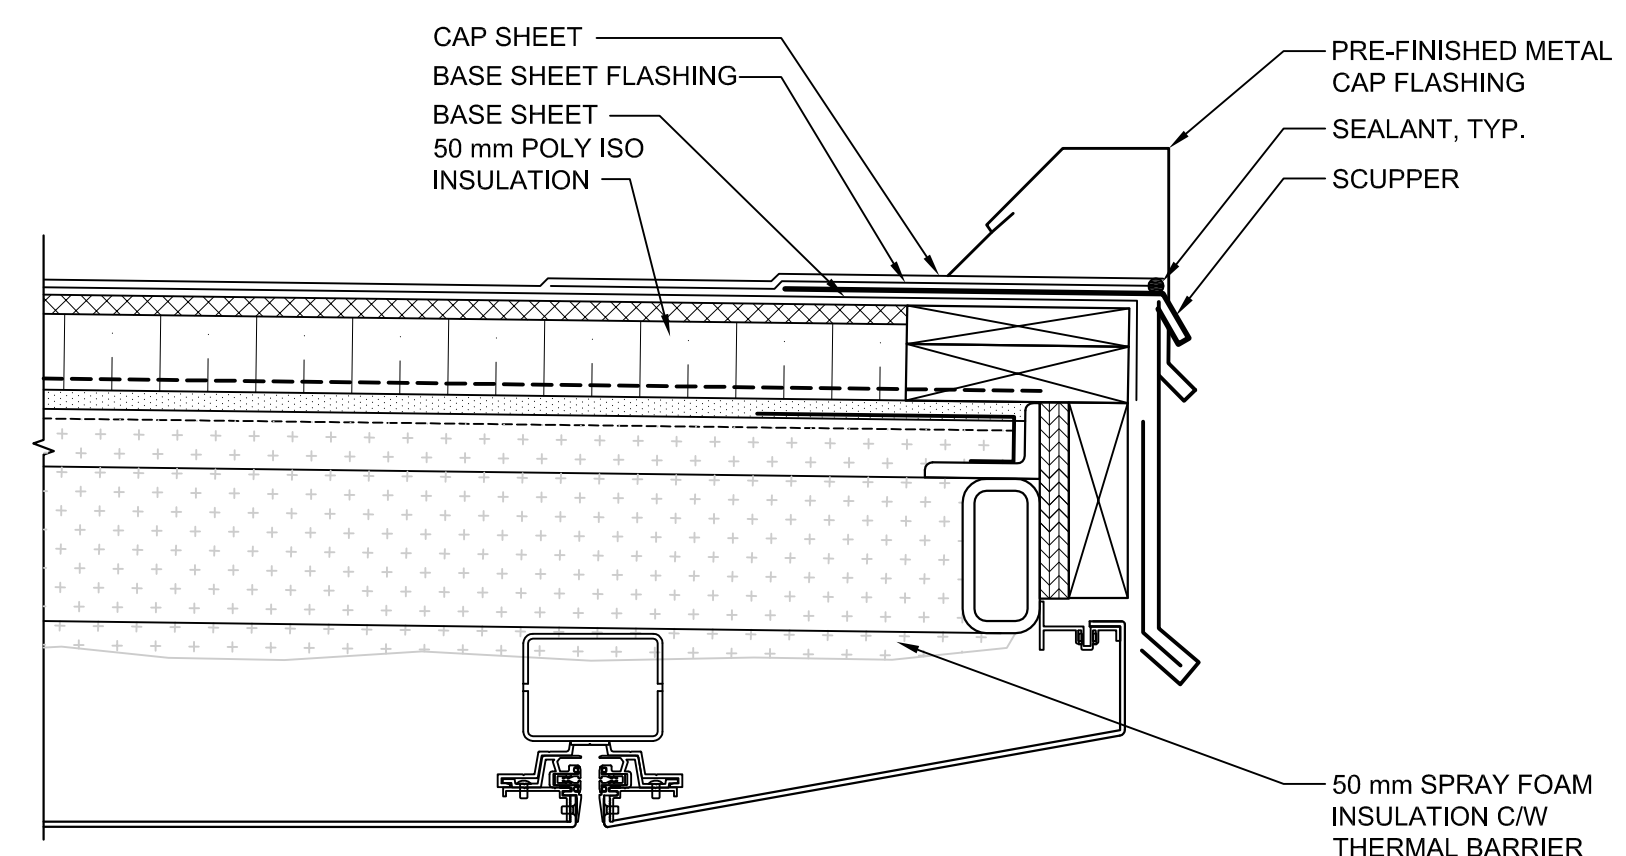


ROOF SCUPPER
SCALE: 1:5
0mm 100mm 200mm 300mm 400mm 500mm

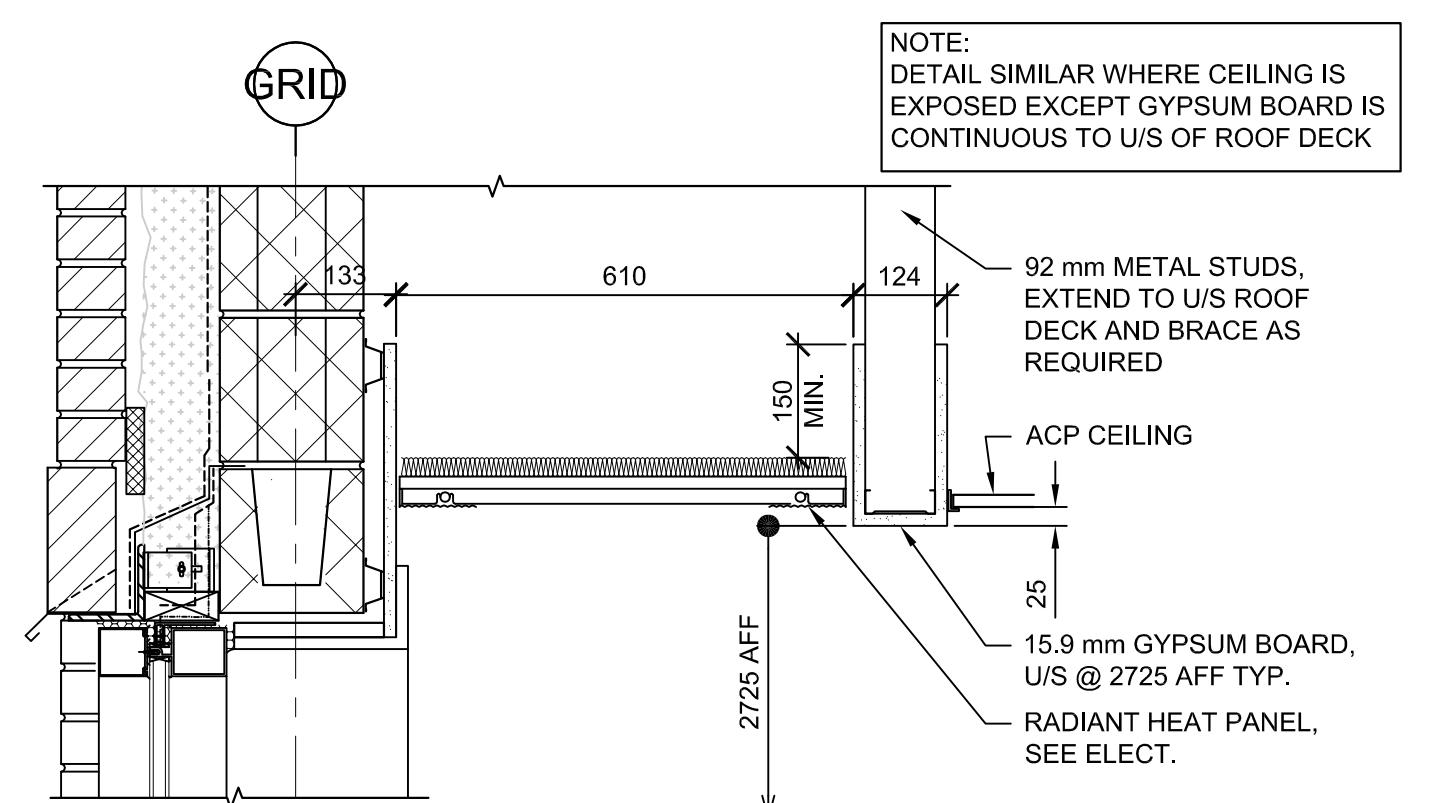


TYPICAL BULKHEAD AT RADIANT PANEL
SCALE: 1:10
0mm 100 200 300 400 500 600 700 800 900 1000mm

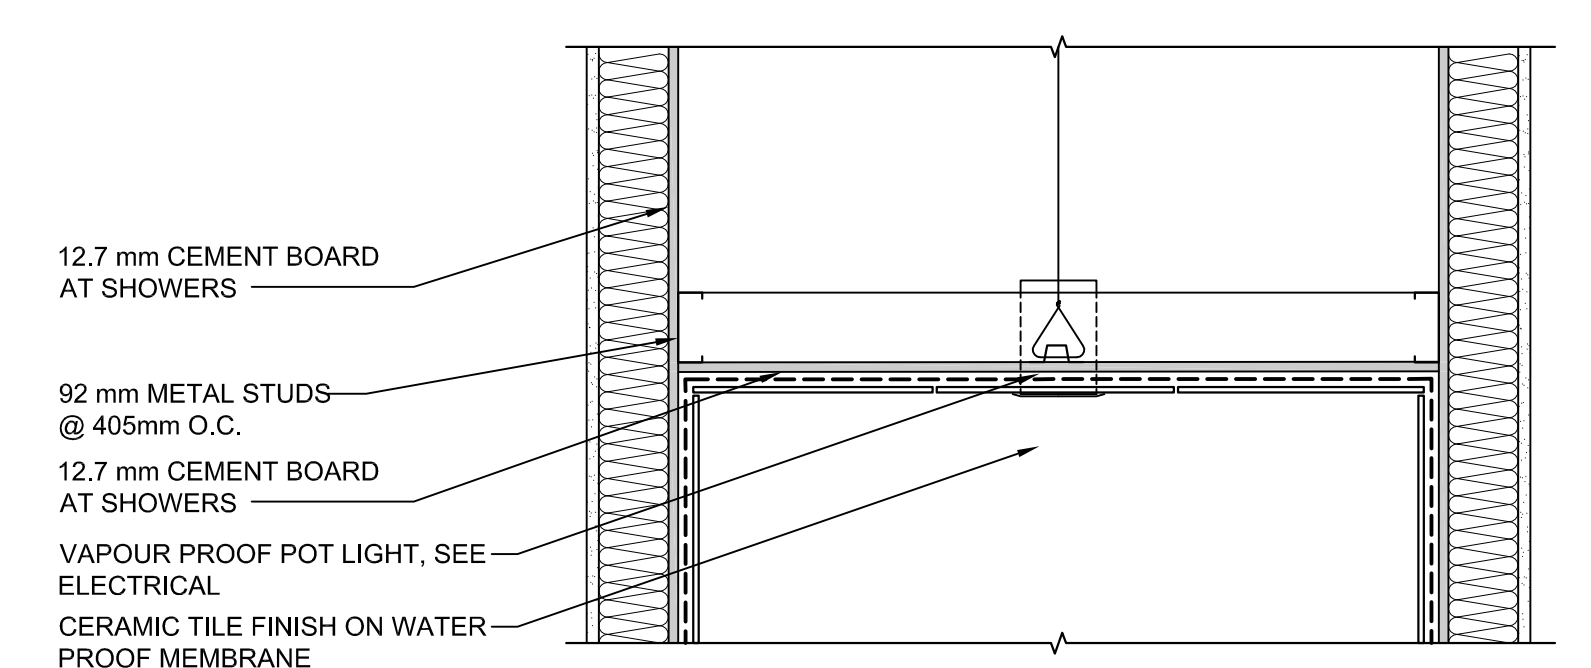


TYPICAL SHOWER STALL
SCALE: 1:10
0mm 100 200 300 400 500 600 700 800 900 1000mm

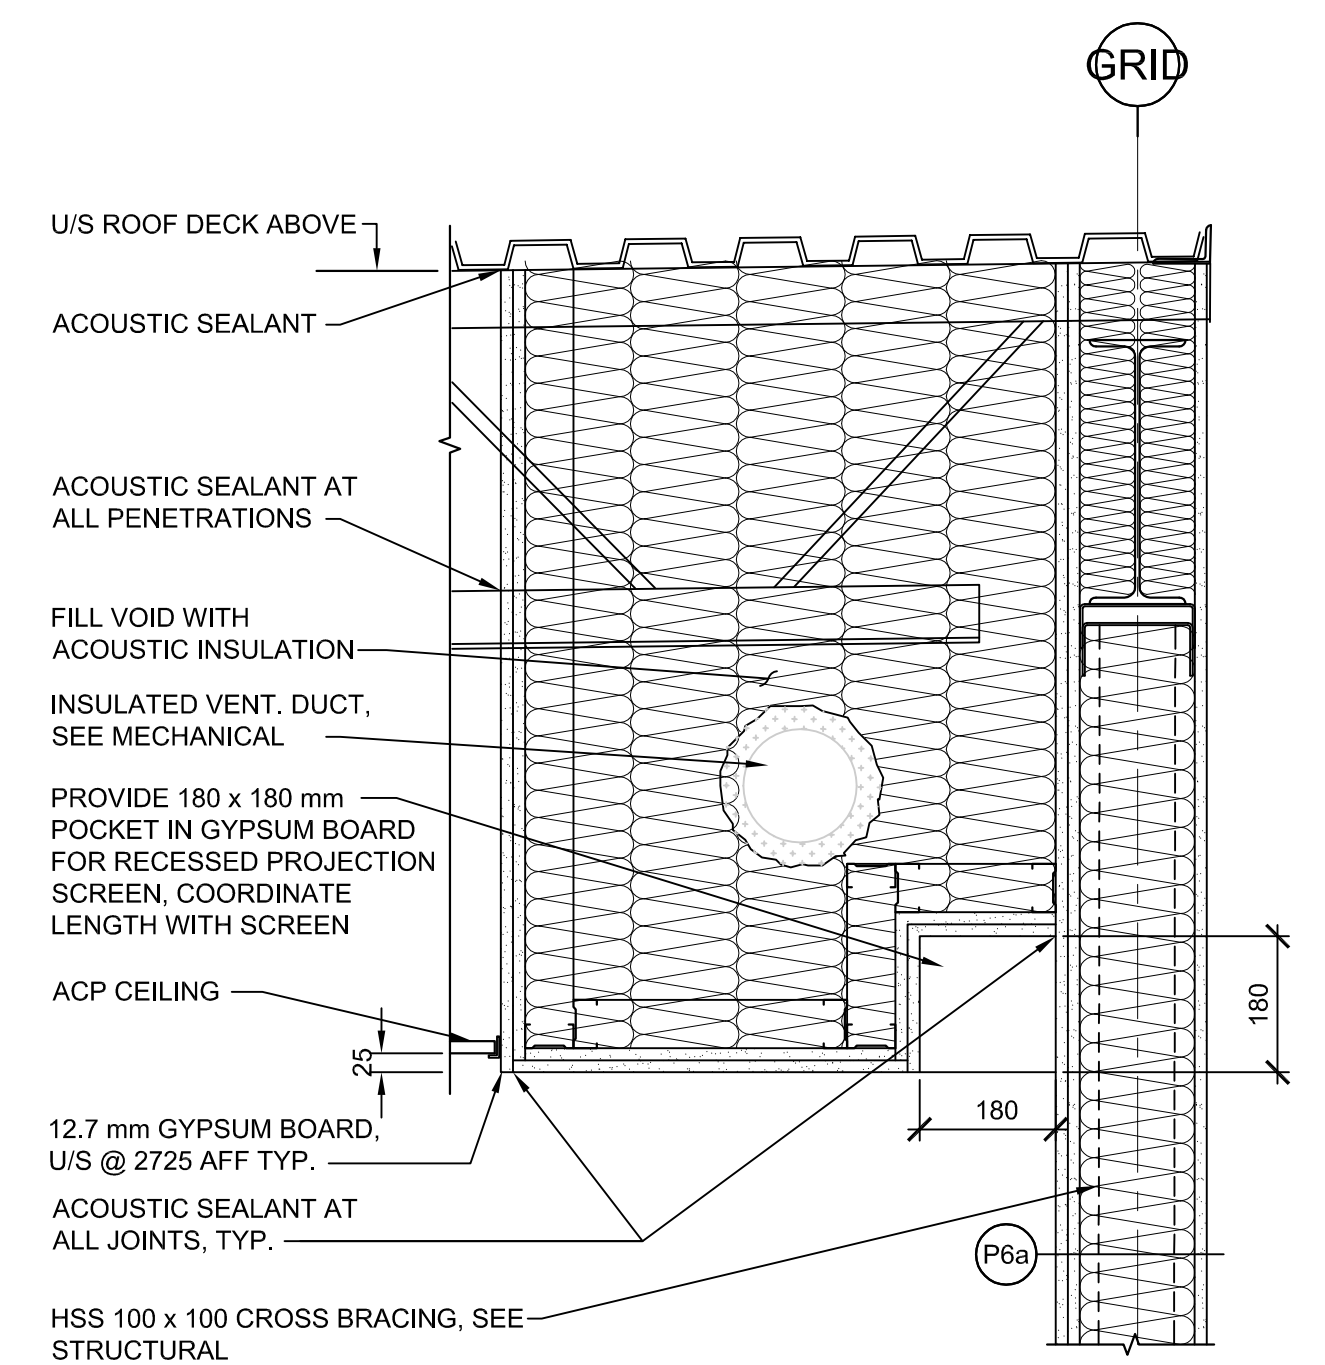

SECTION @ ACOUSTIC BULKHEAD
SCALE: 1:10
0mm 100 200 300 400 500 600 700 800 900 1000mm

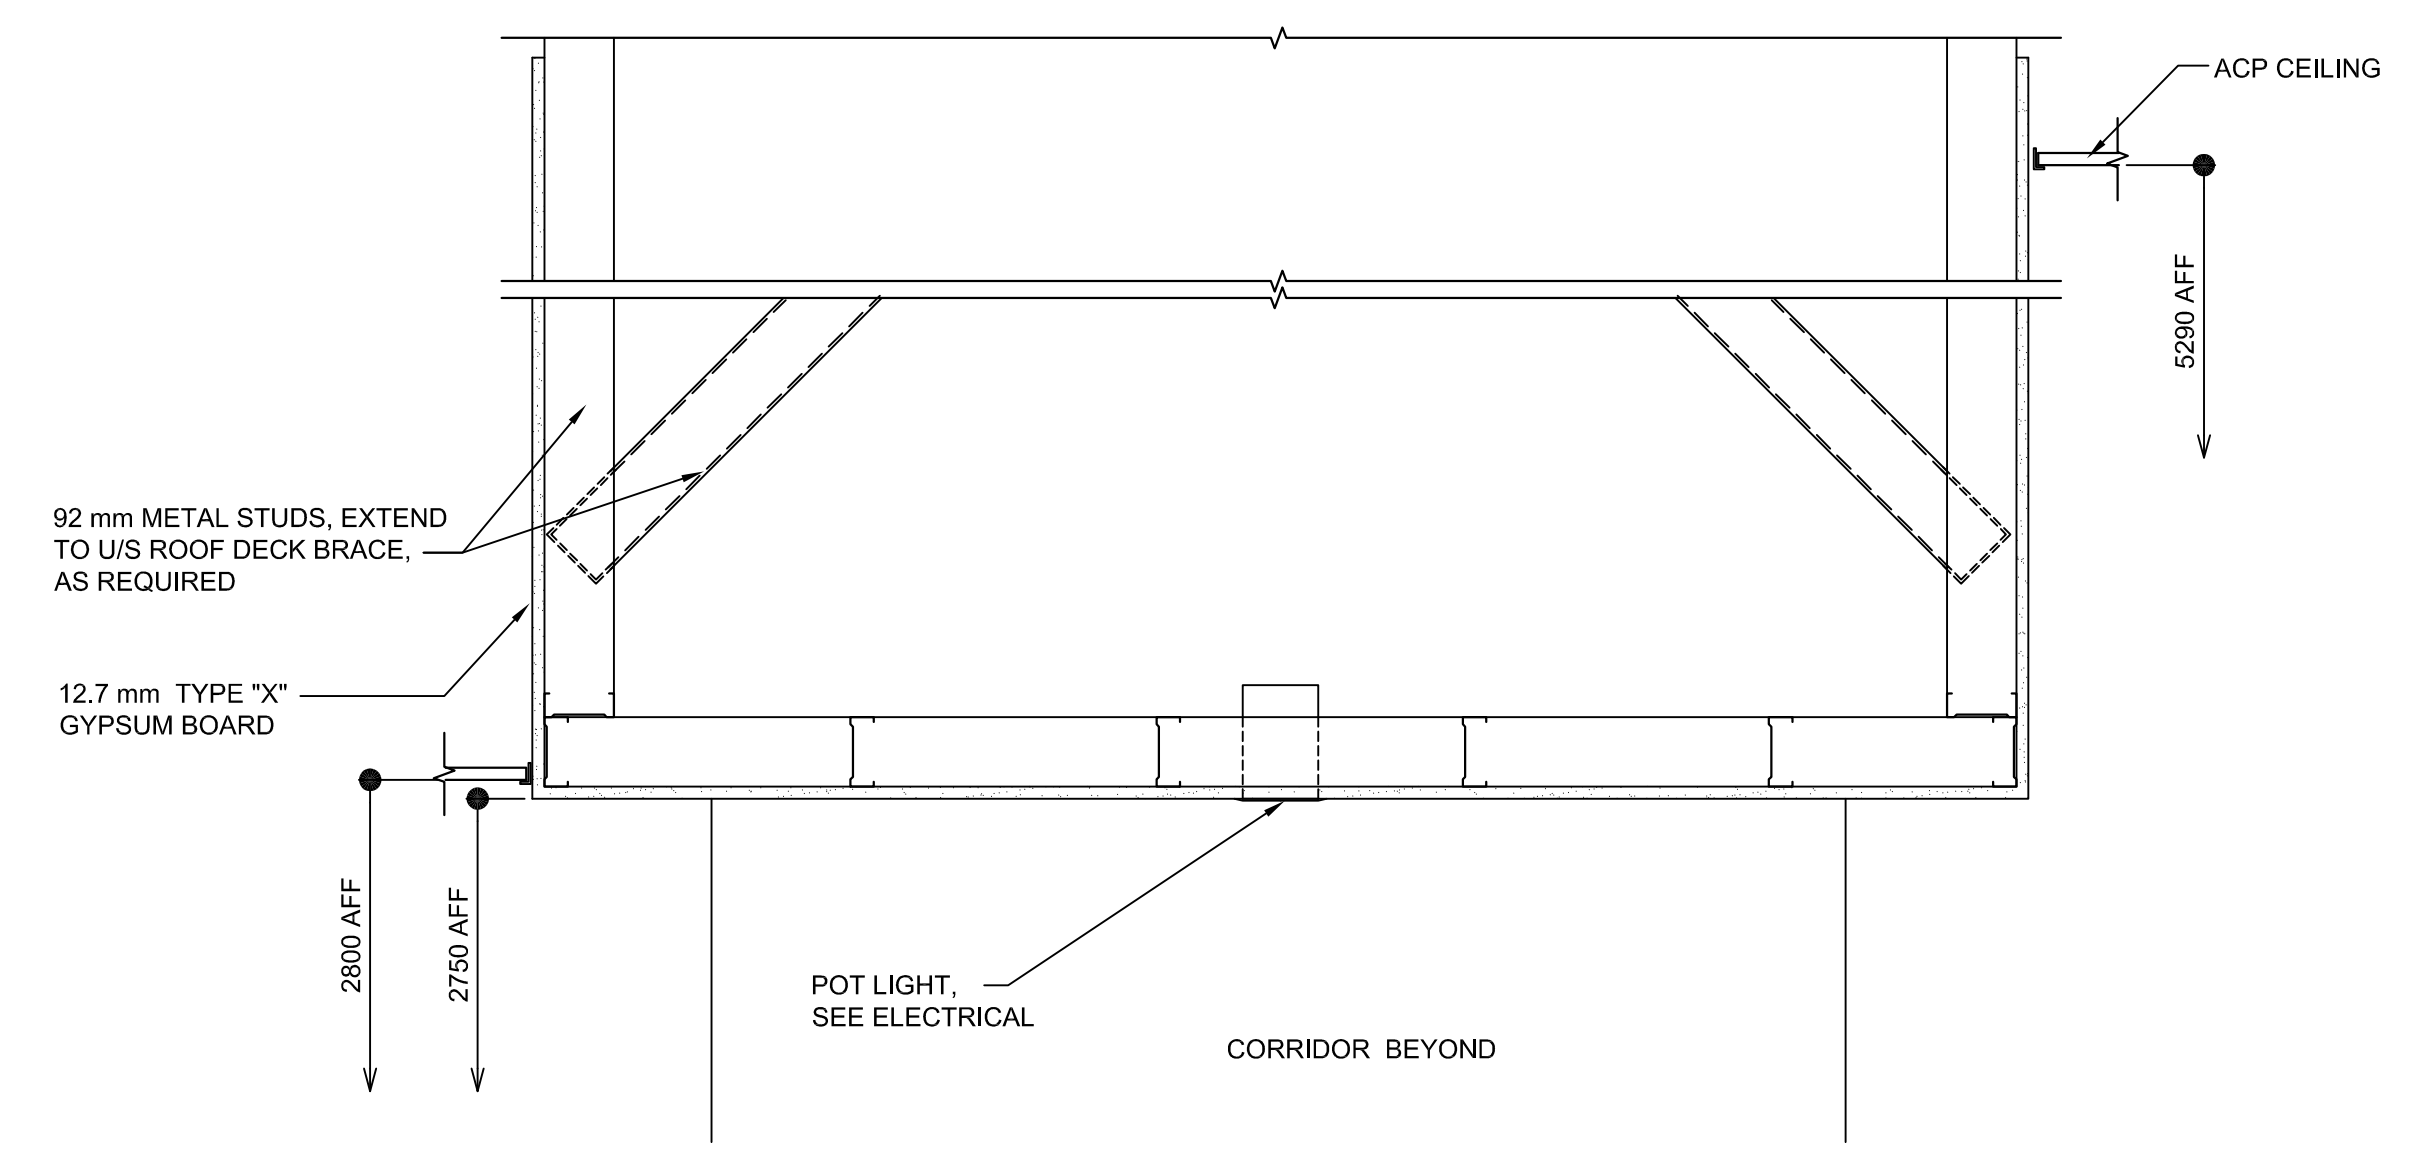

TYPICAL BULKHEAD AT CORRIDORS
SCALE: 1:10
0mm 100 200 300 400 500 600 700 800 900 1000mm

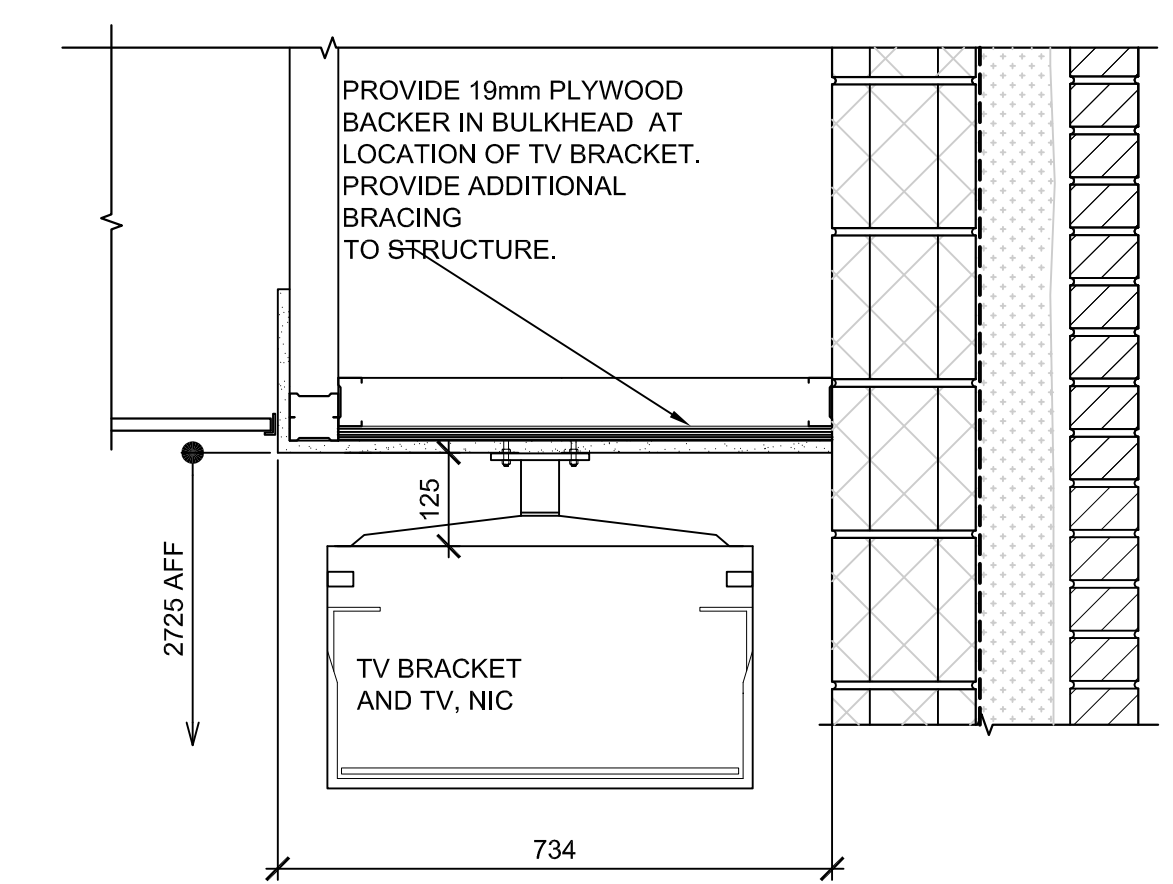

TV MOUNTING BRACKET @ U/S BULKHEAD
SCALE: 1:10
0mm 100 200 300 400 500 600 700 800 900 1000mm



0	RELEASED FOR CONSTRUCTION	01/29/2016
revisions		date
project	NEW G.O.C.B SAINT-LEONARD NEW BRUNSWICK	
project		

ROOF AND REFLECTED CEILING PLAN DETAILS

designed	CET	conçu
date	JANUARY 29, 2016	
drawn	BCF	dessiné
date	JANUARY 29, 2016	
approved	DAG	approuvé
date	FEBRUARY 17, 2016	
Tender		Soumission

PWSC Project Manager	Administrateur de projets TPSC
project number	no. du projet
R.069499.001	
drawing no.	no. du dessin
604-8	