


ROOF PLAN - PENTHOUSE

SCALE : 1:100

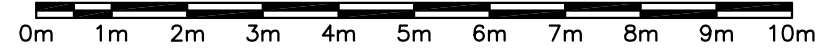

TYPICAL R1 ROOF CONSTRUCTION


- 2 PLY MODIFIED BITUMEN ROOF ASSEMBLY
- 2 - LAYERS 12.7mm FIBRE BOARD
- 135mm POLYISO INSULATION (PLUS TAPERED WHERE INDICATED)
- VAPOUR RETARDER
- 12.7mm EXTERIOR GRADE GYPSUM BOARD
- METAL DECK, REFER TO STRUCTURAL DRAWINGS

LEGEND

- RD SUMP RECEIVER (TYPICAL 1000 x 1000) ROOF DRAIN
- VS VENT STACK
- RD ROOF WALKWAY
- DIRECTION OF SLOPE
- TAPERED INSULATION
- ANTENNA



GENERAL NOTES

1. SEE DRAWING 604-5 FOR TYPICAL PARAPET DETAILS.
2. COORDINATE SIZE, QUANTITY AND LOCATION OF ROOF VENT STACKS AND ROOF DRAINS WITH MECHANICAL DRAWINGS AND SPECS.
3. SEE DRAWING 604-8 FOR TYPICAL ROOF DETAILS.
4. PROVIDE AN ADDITIONAL LAYER OF ROOFING MEMBRANE AT ROOF WALKWAYS LOCATED AT AREA OF DOORS AND ROOF HATCH.

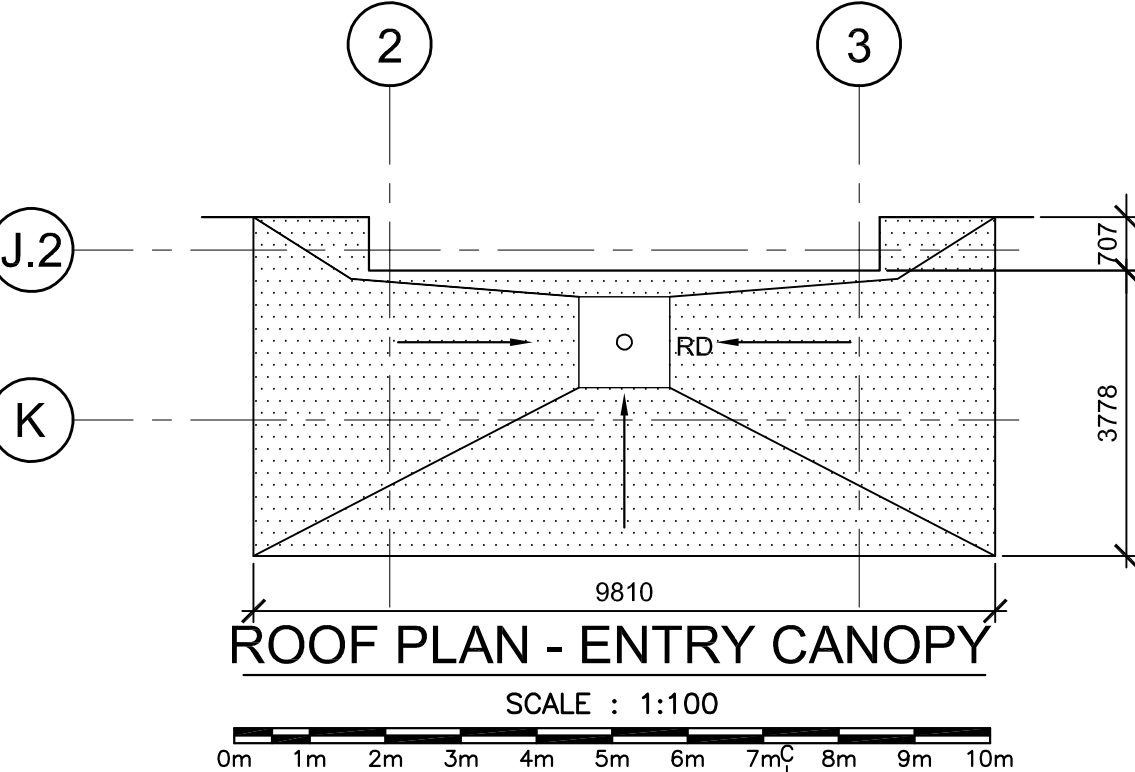

ROOF PLAN - ENTRY CANOPY

SCALE : 1:100

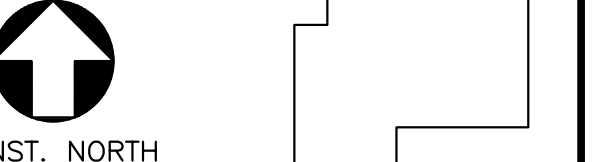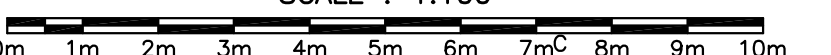

KEY PLAN

SCALE - NTS



0	RELEASED FOR CONSTRUCTION	01/29/2016
revisions		date

project
**NEW
G.O.C.B
SAINT-LEONARD
NEW BRUNSWICK**
project

drawing
design

ROOF PLANS

designed	SJO/GAR/CET	conçu
date	JANUARY 29, 2016	
drawn	GB	dessiné
date	JANUARY 29, 2016	
approved	DAG	approuvé
date	FEBRUARY 17, 2016	
Tender	Soumission	
PWSC Project Manager	Administrateur de projets TPSGC	no. du projet
project number	R.069499.001	
drawing no.	601-5	no. du dessin