





DOOR TYPES
SCALE: 1:50

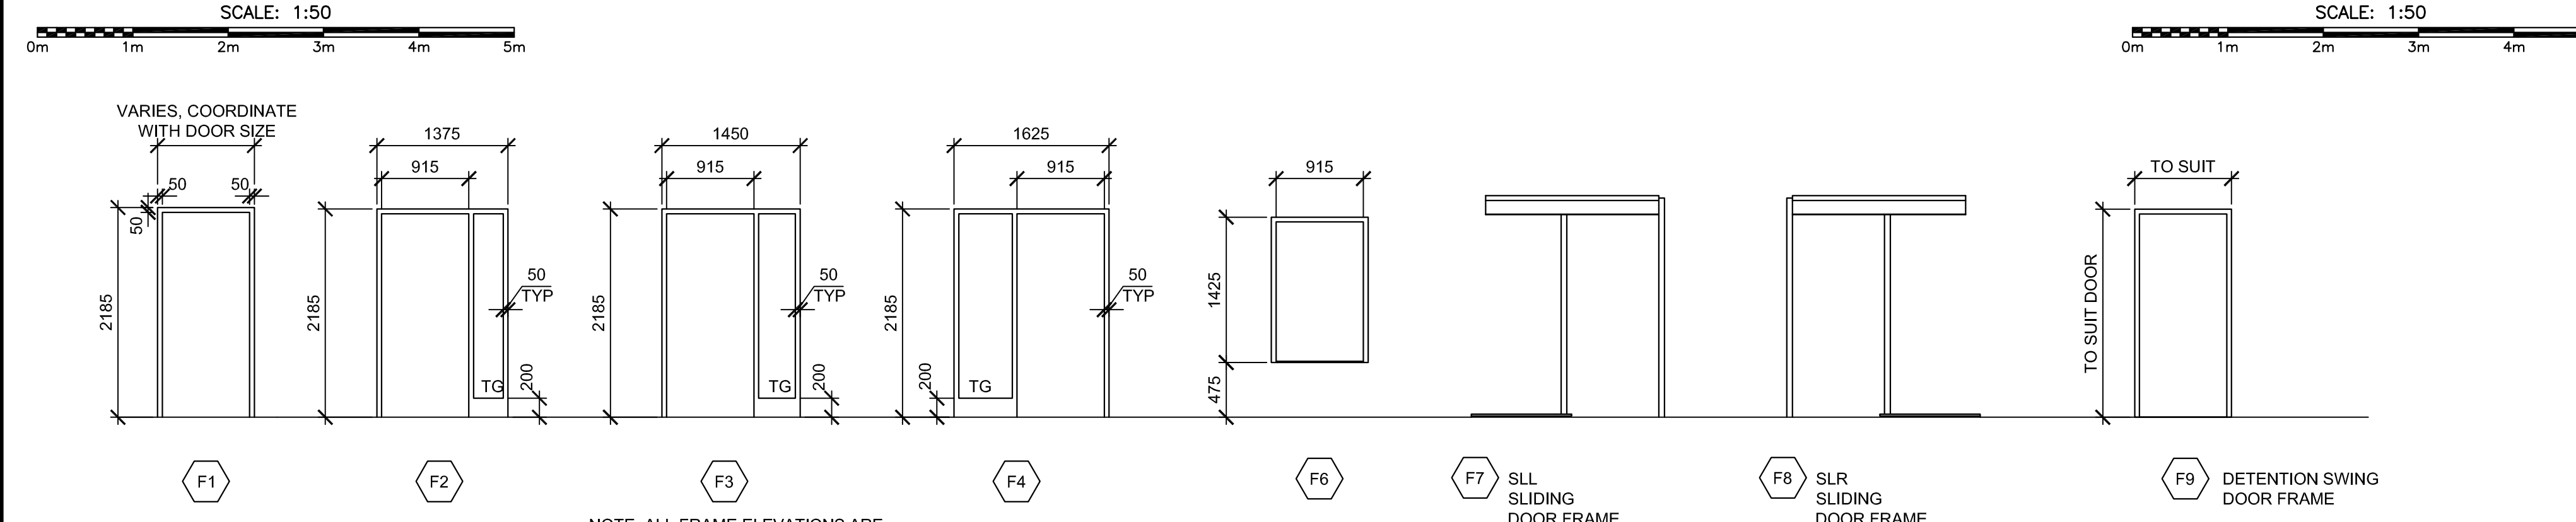

DOOR FRAME ELEVATIONS
SCALE: 1:50

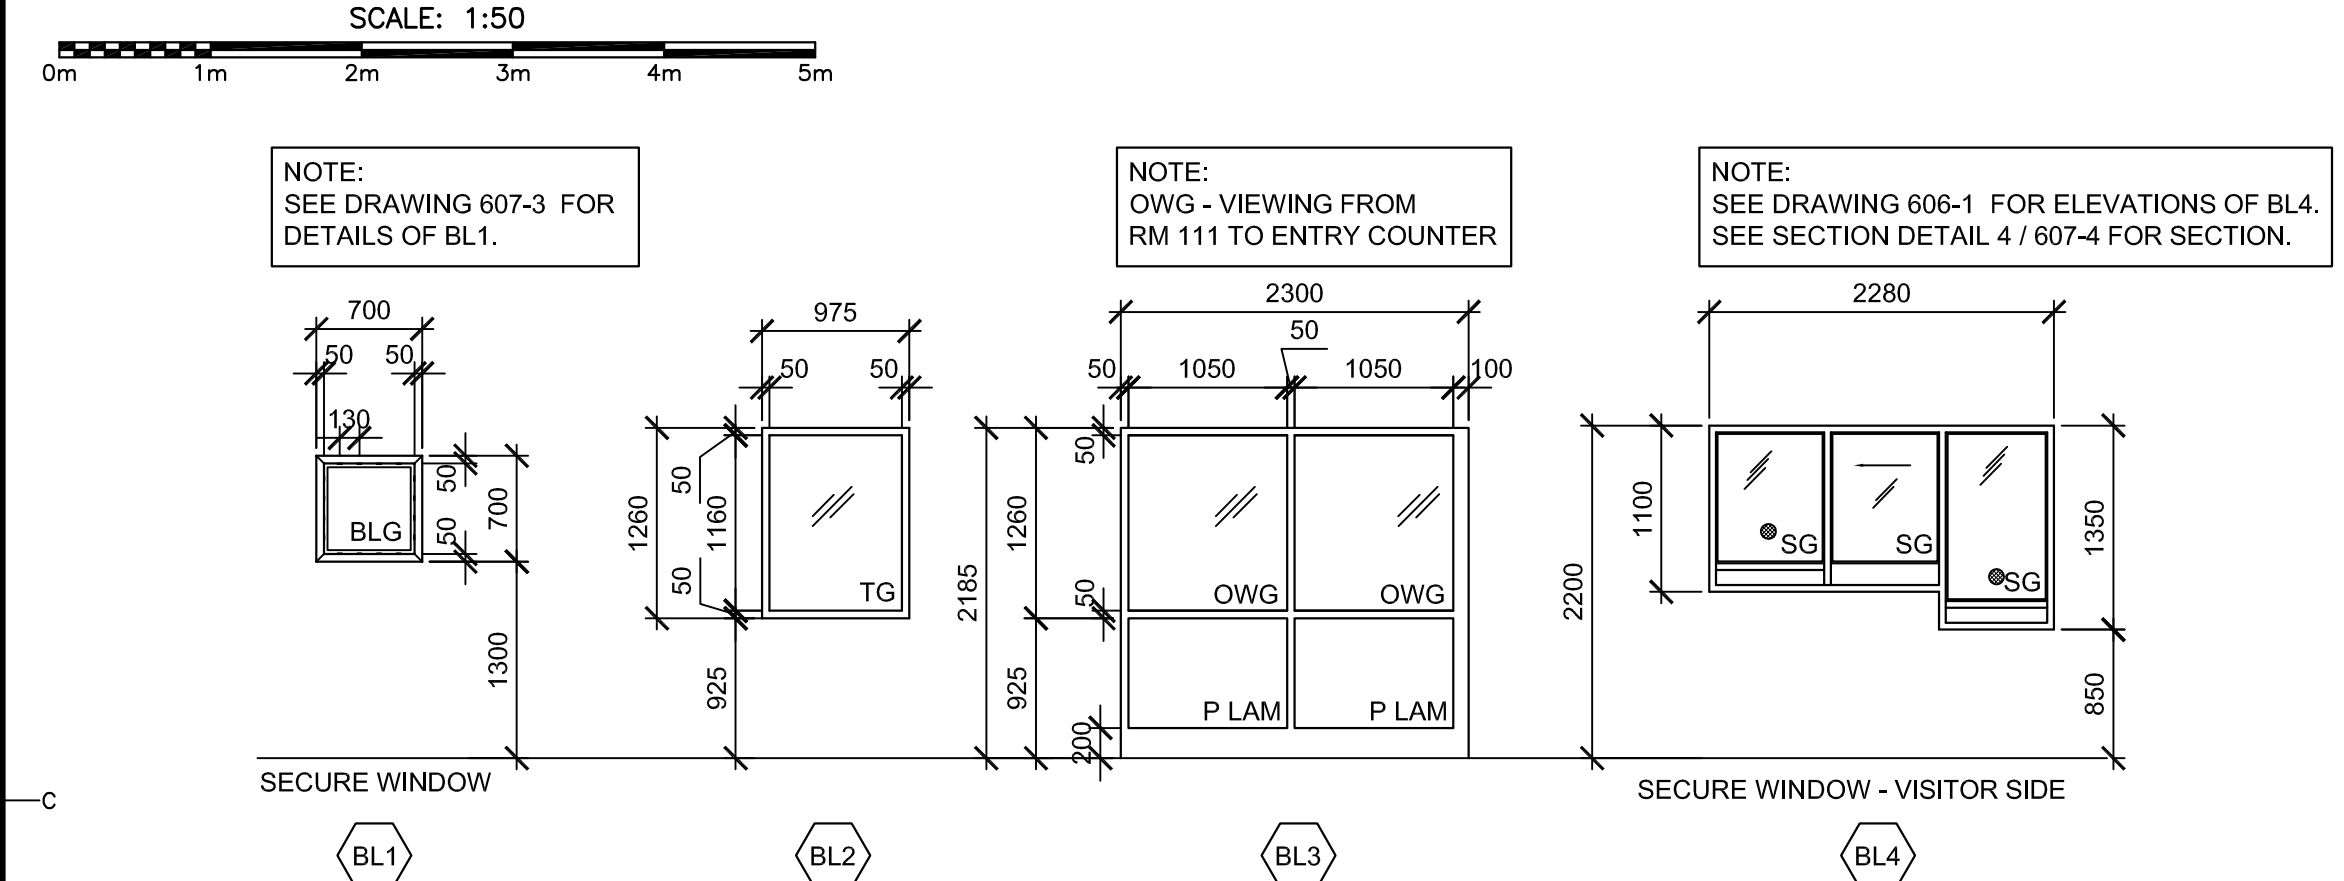

BORROWED LIGHT ELEVATIONS
SCALE: 1:50

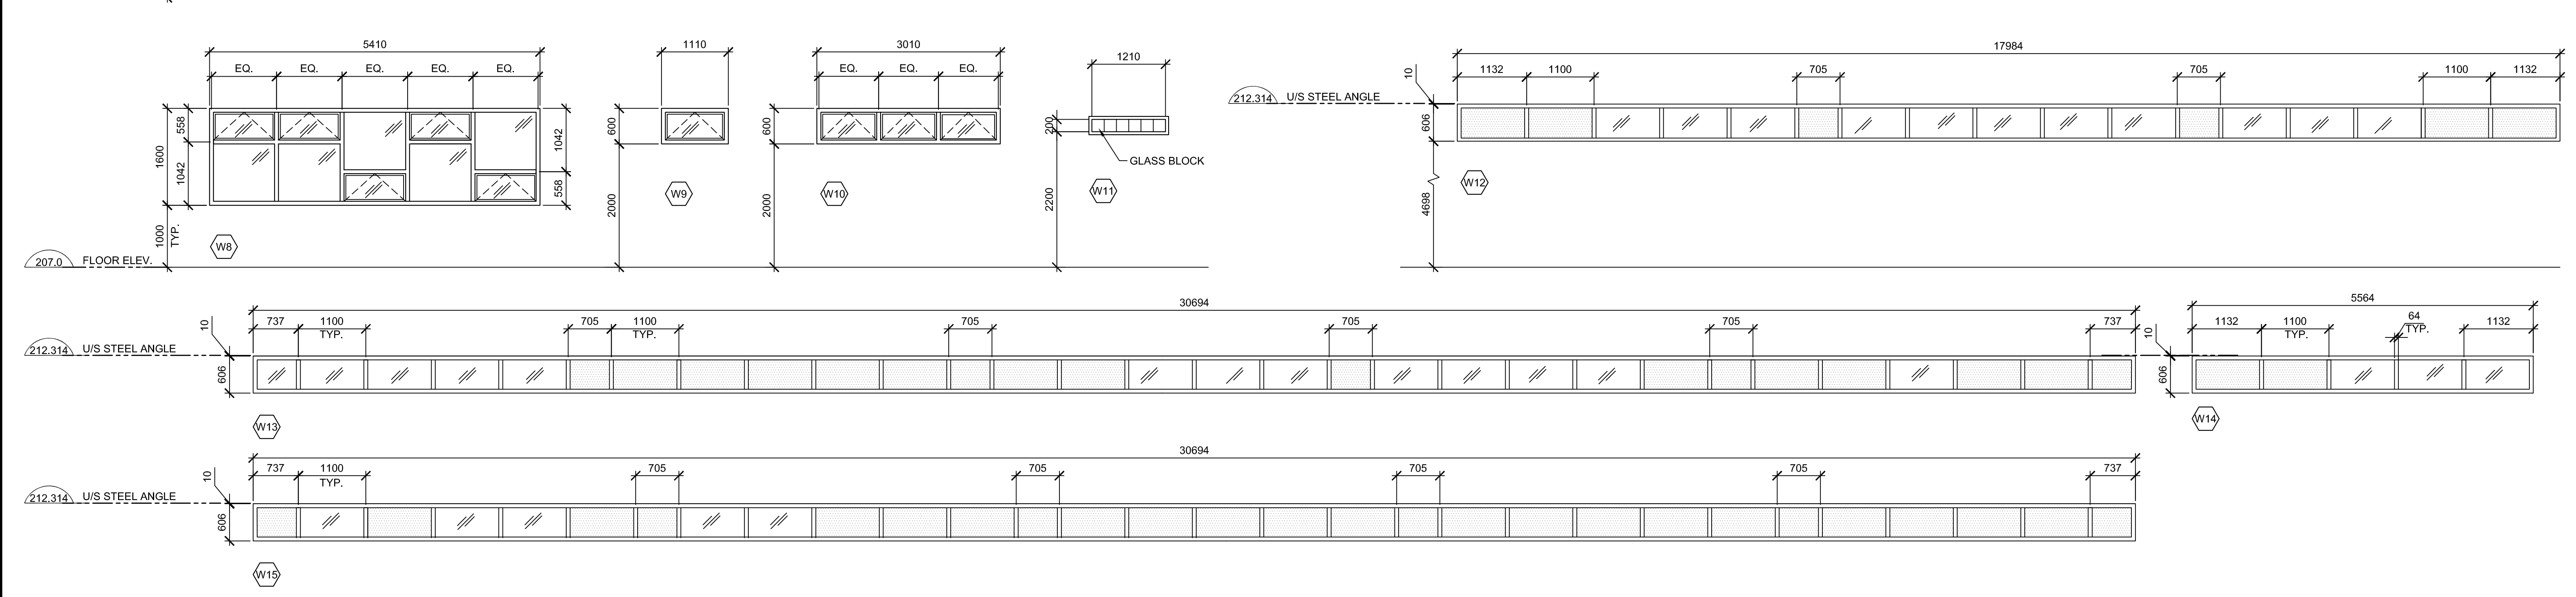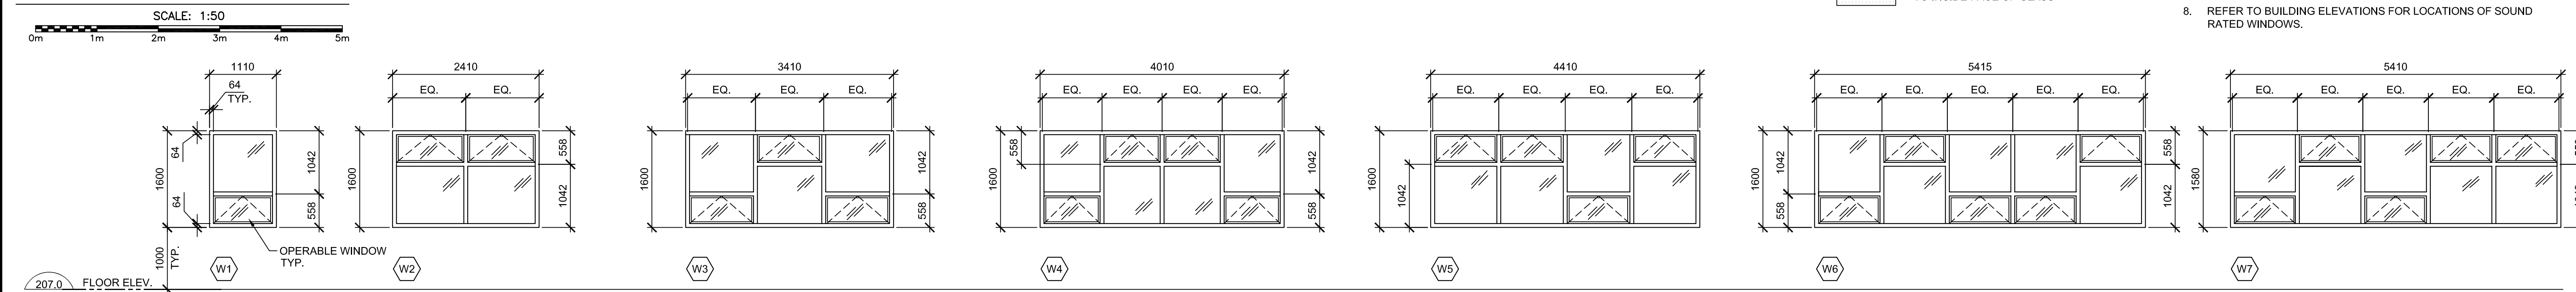


WINDOW ELEVATIONS
SCALE: 1:20

ENTRANCE FRAMING NOTES

- GLAZING IN EXTERIOR CURTAIN WALL FRAMING AND ALUMINUM DOOR IS IGU WITH SECURITY FILM ON THE INSIDE FACE OF GLASS, TYPICAL.
- GLAZING IN INTERIOR CURTAIN WALL FRAMING IS TG WITH SECURITY FILM ON WAITING RM 101 SIDE OF GLASS, TYPICAL.

CURTAIN WALL ELEVATIONS
SCALE: 1:50

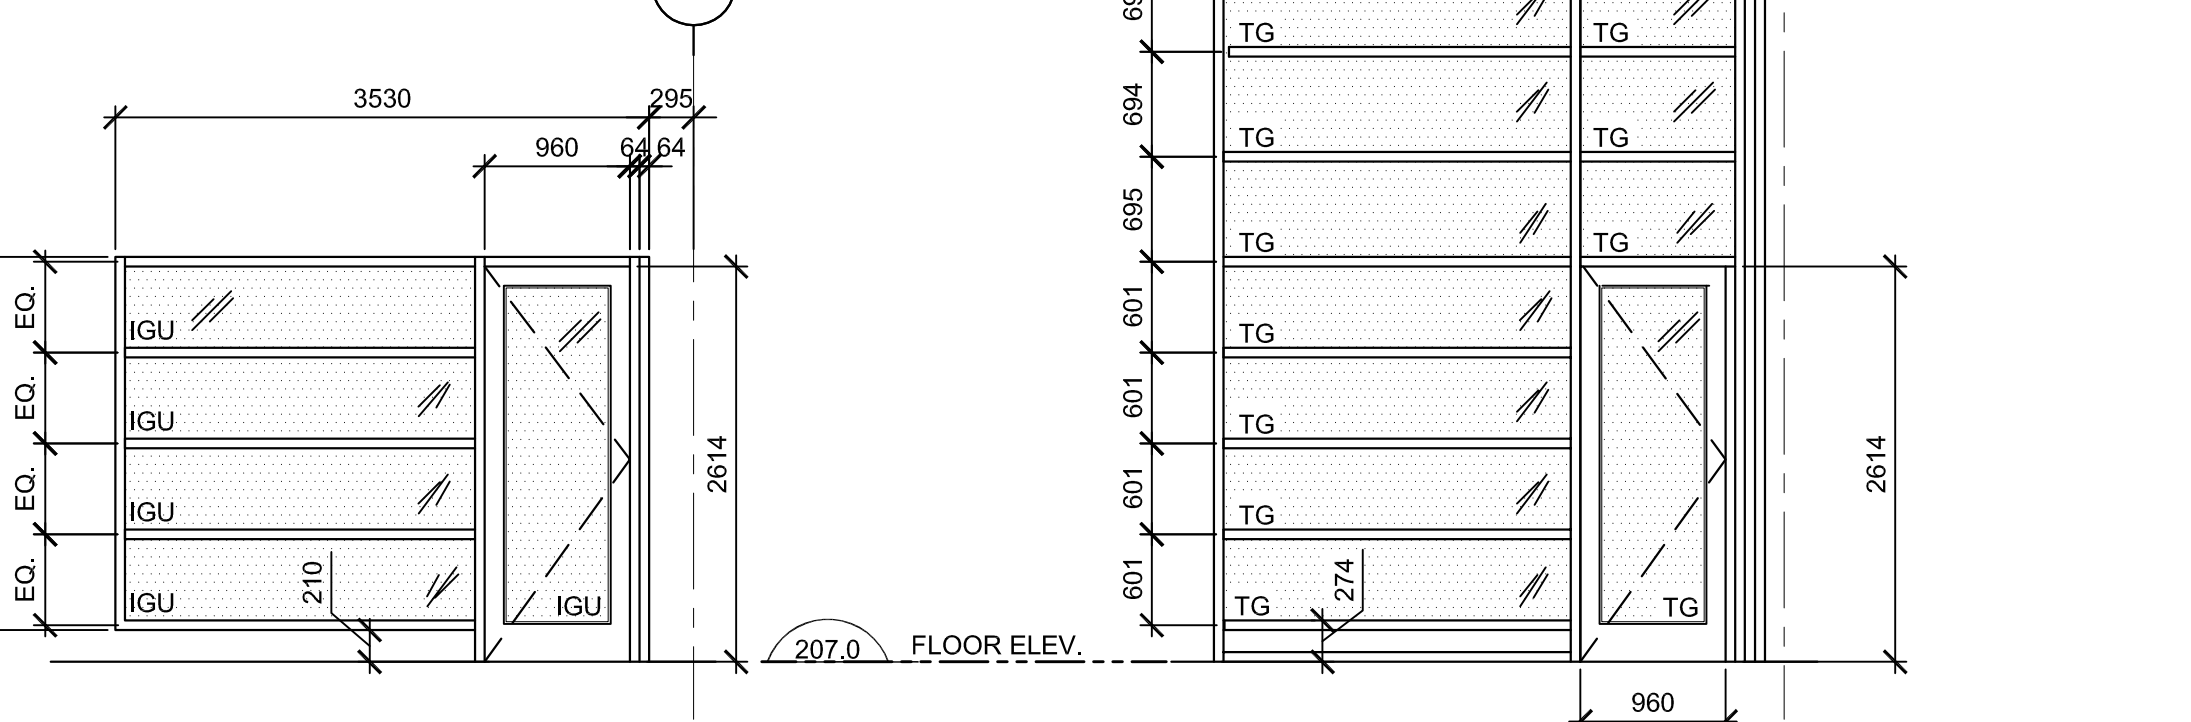

LEGEND

- FP FOOD PASS THROUGH
PH PEEP HOLE

GLAZING LEGEND

- PG POLYCARBONATE GLAZING
TG TEMPERED GLAZING
IGU INSULATED TEMPERED GLAZING UNIT
OWG ONE WAY VIEWING GLAZING
BLG TEMPERED GLAZING C/W BLINDS
SG SECURITY GLAZING
WG WIRED GLAZING

WINDOW GLAZING LEGEND

- INSULATING GLASS UNIT
SPANDREL GLASS WITH INSULATED BACK PAN
SECURITY FILM APPLIED TO INSIDE FACE OF GLASS

GENERAL NOTES

- WINDOW AND DOOR ELEVATIONS ARE FROM THE EXTERIOR VIEW UNO.
- SEE BUILDING ELEVATIONS DRAWING 602-1 FOR QUANTITY AND LOCATION OF WINDOW TYPES.
- SEE FLOOR PLANS FOR DIMENSIONS TO WINDOWS.
- WINDOW DIMENSIONS ARE MASONRY OPENINGS TYPICAL.
- REFER TO REFLECTED CEILING PLAN AND BUILDING ELEVATIONS FOR LOCATIONS OF SUNSHADES. REFER TO DRAWING 607-5 FOR SECTION DETAIL AT SUNSHADES.
- ALL DIMENSIONS TO CURTAIN WALL MULLIONS ARE TO CENTERLINE OF MULLION UNLESS SHOWN OTHERWISE.
- REFER TO DRAWINGS 607-3 AND 607-4 FOR SECURE WINDOW AND DOOR DETAILS.
- REFER TO DRAWINGS 607-5 AND 607-6 FOR HEAD, JAMB AND SILL DETAILS.
- REFER TO BUILDING ELEVATIONS FOR LOCATIONS OF SOUND RATED WINDOWS.



0	RELEASED FOR CONSTRUCTION	01/29/2016
revisions		date

project
**NEW
G.O.C.B
SAINT-LÉONARD
NEW BRUNSWICK**
project

drawing
designed
designé

DOOR AND WINDOW ELEVATIONS

designed	SJO/GAR/CET	conçu
date	JANUARY 29, 2016	
drawn	CLT	dessiné
date	JANUARY 29, 2016	
approved	DAG	approuvé
date	FEBRUARY 17, 2016	
Tender		Soumission
PWGSC Project Manager	Administrateur de projets TPSC	no. du projet
project number	R.069499.001	
drawing no.	607-2	no. du dessin