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exp. Project No. FRE-00214763-A5

BUILDINGS - EARTH & ENVIRONMENT
 ENERGY - INDUSTRIAL
 INFRASTRUCTURE - SUSTAINABILITY

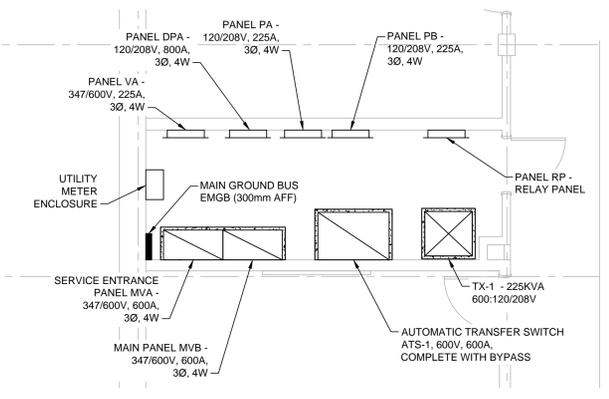
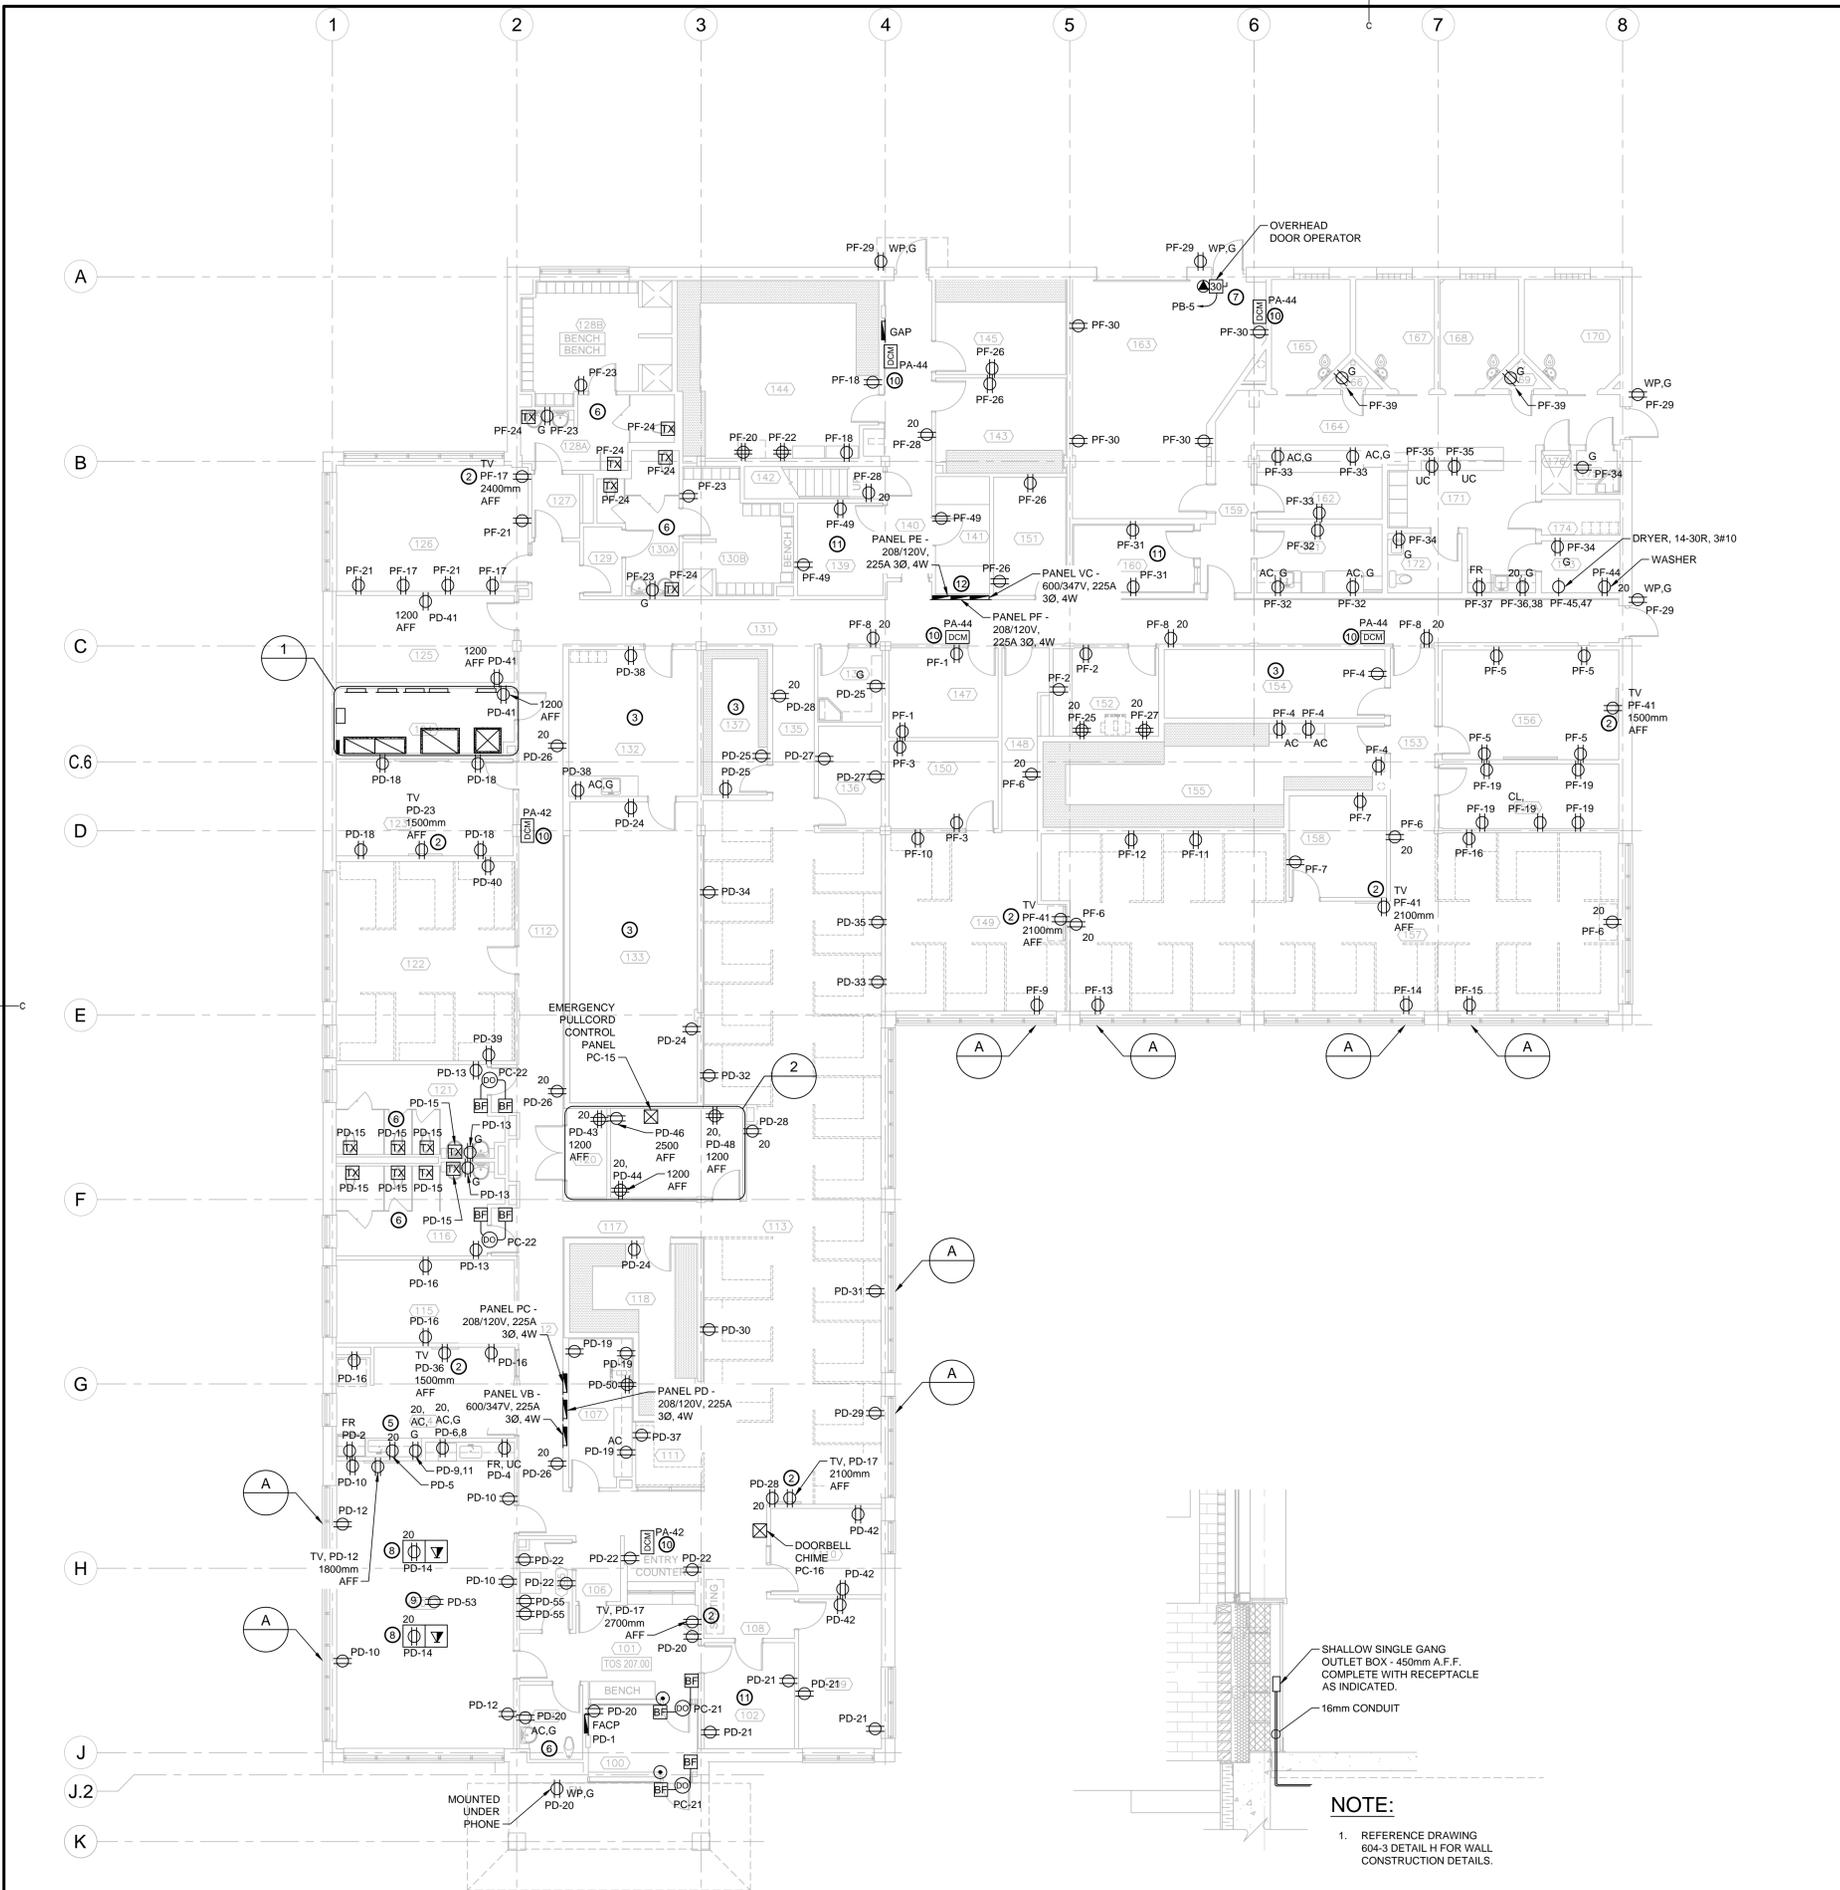
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KEY PLAN

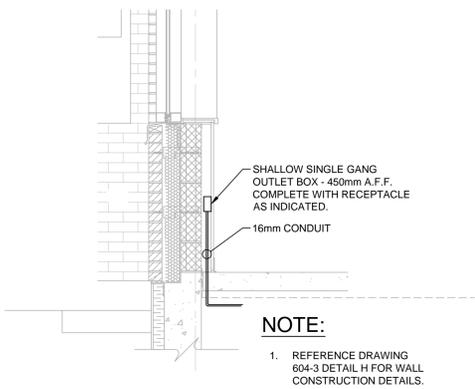
SCALE - NTS

- ### KEYNOTES
- INSTALL RECEPTACLE ON BOTTOM EXTERIOR OF CABLE TRAY FOR EACH EQUIPMENT RACK. REFERENCE DRAWING 2700-1.
 - INSTALL IN RECESSED AV BOX COMPLETE WITH DATA AND CATV OUTLET. COORDINATE MOUNTING HEIGHTS WITH FURNITURE LAYOUT AND DIVISION 27.
 - ELECTRICAL BOXES SHALL NOT BE INSTALLED WITHIN OR OVER THIS ROOM UNLESS SPECIFICALLY SERVICING EQUIPMENT OR DEVICES LOCATED WITHIN.
 - INSTALL 19mm PLYWOOD BACKBOARD COMPLETE WITH 2 COATS GREY FIRE RETARDANT PAINT.
 - INSTALL RECEPTACLE FOR MICROWAVE (BY OTHERS) UNDER CABINET IN COORDINATION WITH CASEWORK INSTALLATION.
 - PROVIDE 120V CIRCUITS FOR HANDS-FREE FIXTURES IN COORDINATION WITH DIVISION 22 REQUIREMENTS.
 - OVERHEAD DOOR CONTROL DEVICES SUPPLIED AND INSTALLED BY DIVISION 8. WIRE AND CONDUIT PER MANUFACTURER'S REQUIREMENTS BY DIVISION 26.
 - CONTRACTOR TO VERIFY FINAL FLOOR BOX LOCATION WITH DEPARTMENTAL REPRESENTATIVE PRIOR TO INSTALLATION.
 - INSTALL RECEPTACLE IN CEILING SPACE FOR PROJECTOR.
 - PROVIDE 120V CIRCUIT FOR DOOR CONTROLLER (SUPPLIED BY DEPARTMENTAL REPRESENTATIVE, INSTALLED BY DIVISION 28). COORDINATE FINAL LOCATIONS ON SITE.
 - FLUSH MOUNT DEVICES IN ROOMS WITH ACOUSTIC WALL PANELS. SUPPLY ALL EXTENSION RINGS AND TAMPERPROOF HARDWARE AS REQUIRED.
 - PANELS PE, PF AND VC TO BE INSTALLED IN WALL OUTSIDE OF ROOM 141 ONLY.



ROOM 120 AND ROOM 119 LAYOUT

SCALE: 1:50



NOTE:

- REFERENCE DRAWING 604-3 DETAIL H FOR WALL CONSTRUCTION DETAILS.

RECEPTACLE - AT W3 WALL TYPE

SCALE: 1:20

POWER FLOOR PLAN - MAIN LEVEL

SCALE: 1:100

0m 1m 2m 3m 4m 5m 6m 7m 8m 9m 10m

ROOM 120 AND ROOM 119 LAYOUT

SCALE: 1:50

0m 1m 2m 3m 4m 5m



0	RELEASED FOR CONSTRUCTION	01/29/2016
revisions		date
project		project

NEW
 G.O.C.B
 SAINT-LÉONARD
 NEW BRUNSWICK

drawing design
MAIN FLOOR PLAN ELECTRICAL

designed SRP	conçu
date JANUARY 29, 2016	
drawn CAM	dessiné
date JANUARY 29, 2016	
approved DAG	approuvé
date FEBRUARY 17, 2016	
Tender	Submission

IPWSC Project Manager / Administrateur de projets IPWSC
 project number / no. du projet
R.069499.001

drawing no. / no. du dessin
2601-2