





CONST. NORTH

KEY PLAN
 SCALE - NTS




0	RELEASED FOR CONSTRUCTION	01/29/2016
revisions		date
project	NEW G.O.C.B SAINT-LÉONARD NEW BRUNSWICK	
project		

drawing	ROOF PLANS		design
designed	SJO/GAR/CET		conçu
date	JANUARY 29, 2016		
drawn	GB		dessiné
date	JANUARY 29, 2016		
approved	DAG		approuvé
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Tender			Soumission
PWSC Project Manager	Administrateur de projets TPSGC		
project number	R.069499.001		no. du projet
drawing no.	601-5		no. du dessin

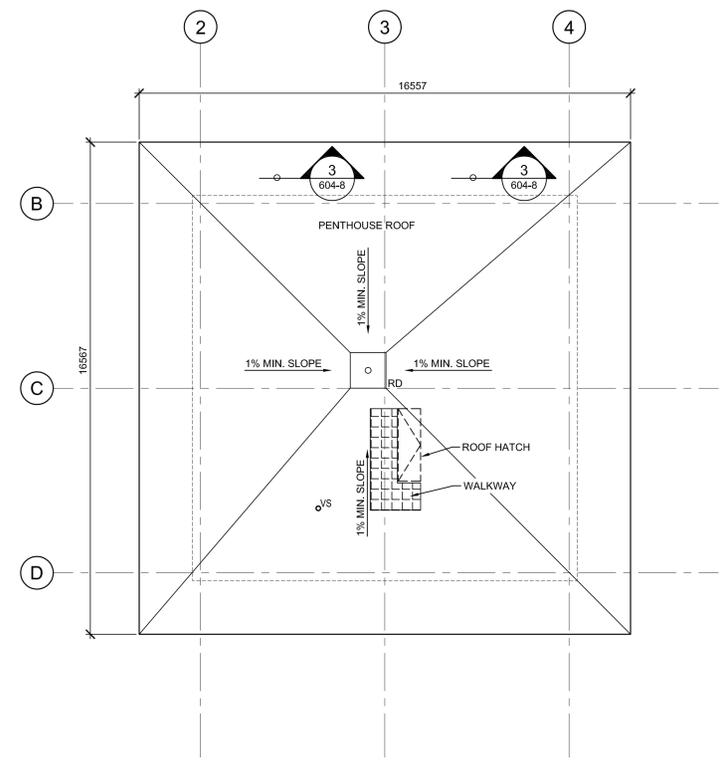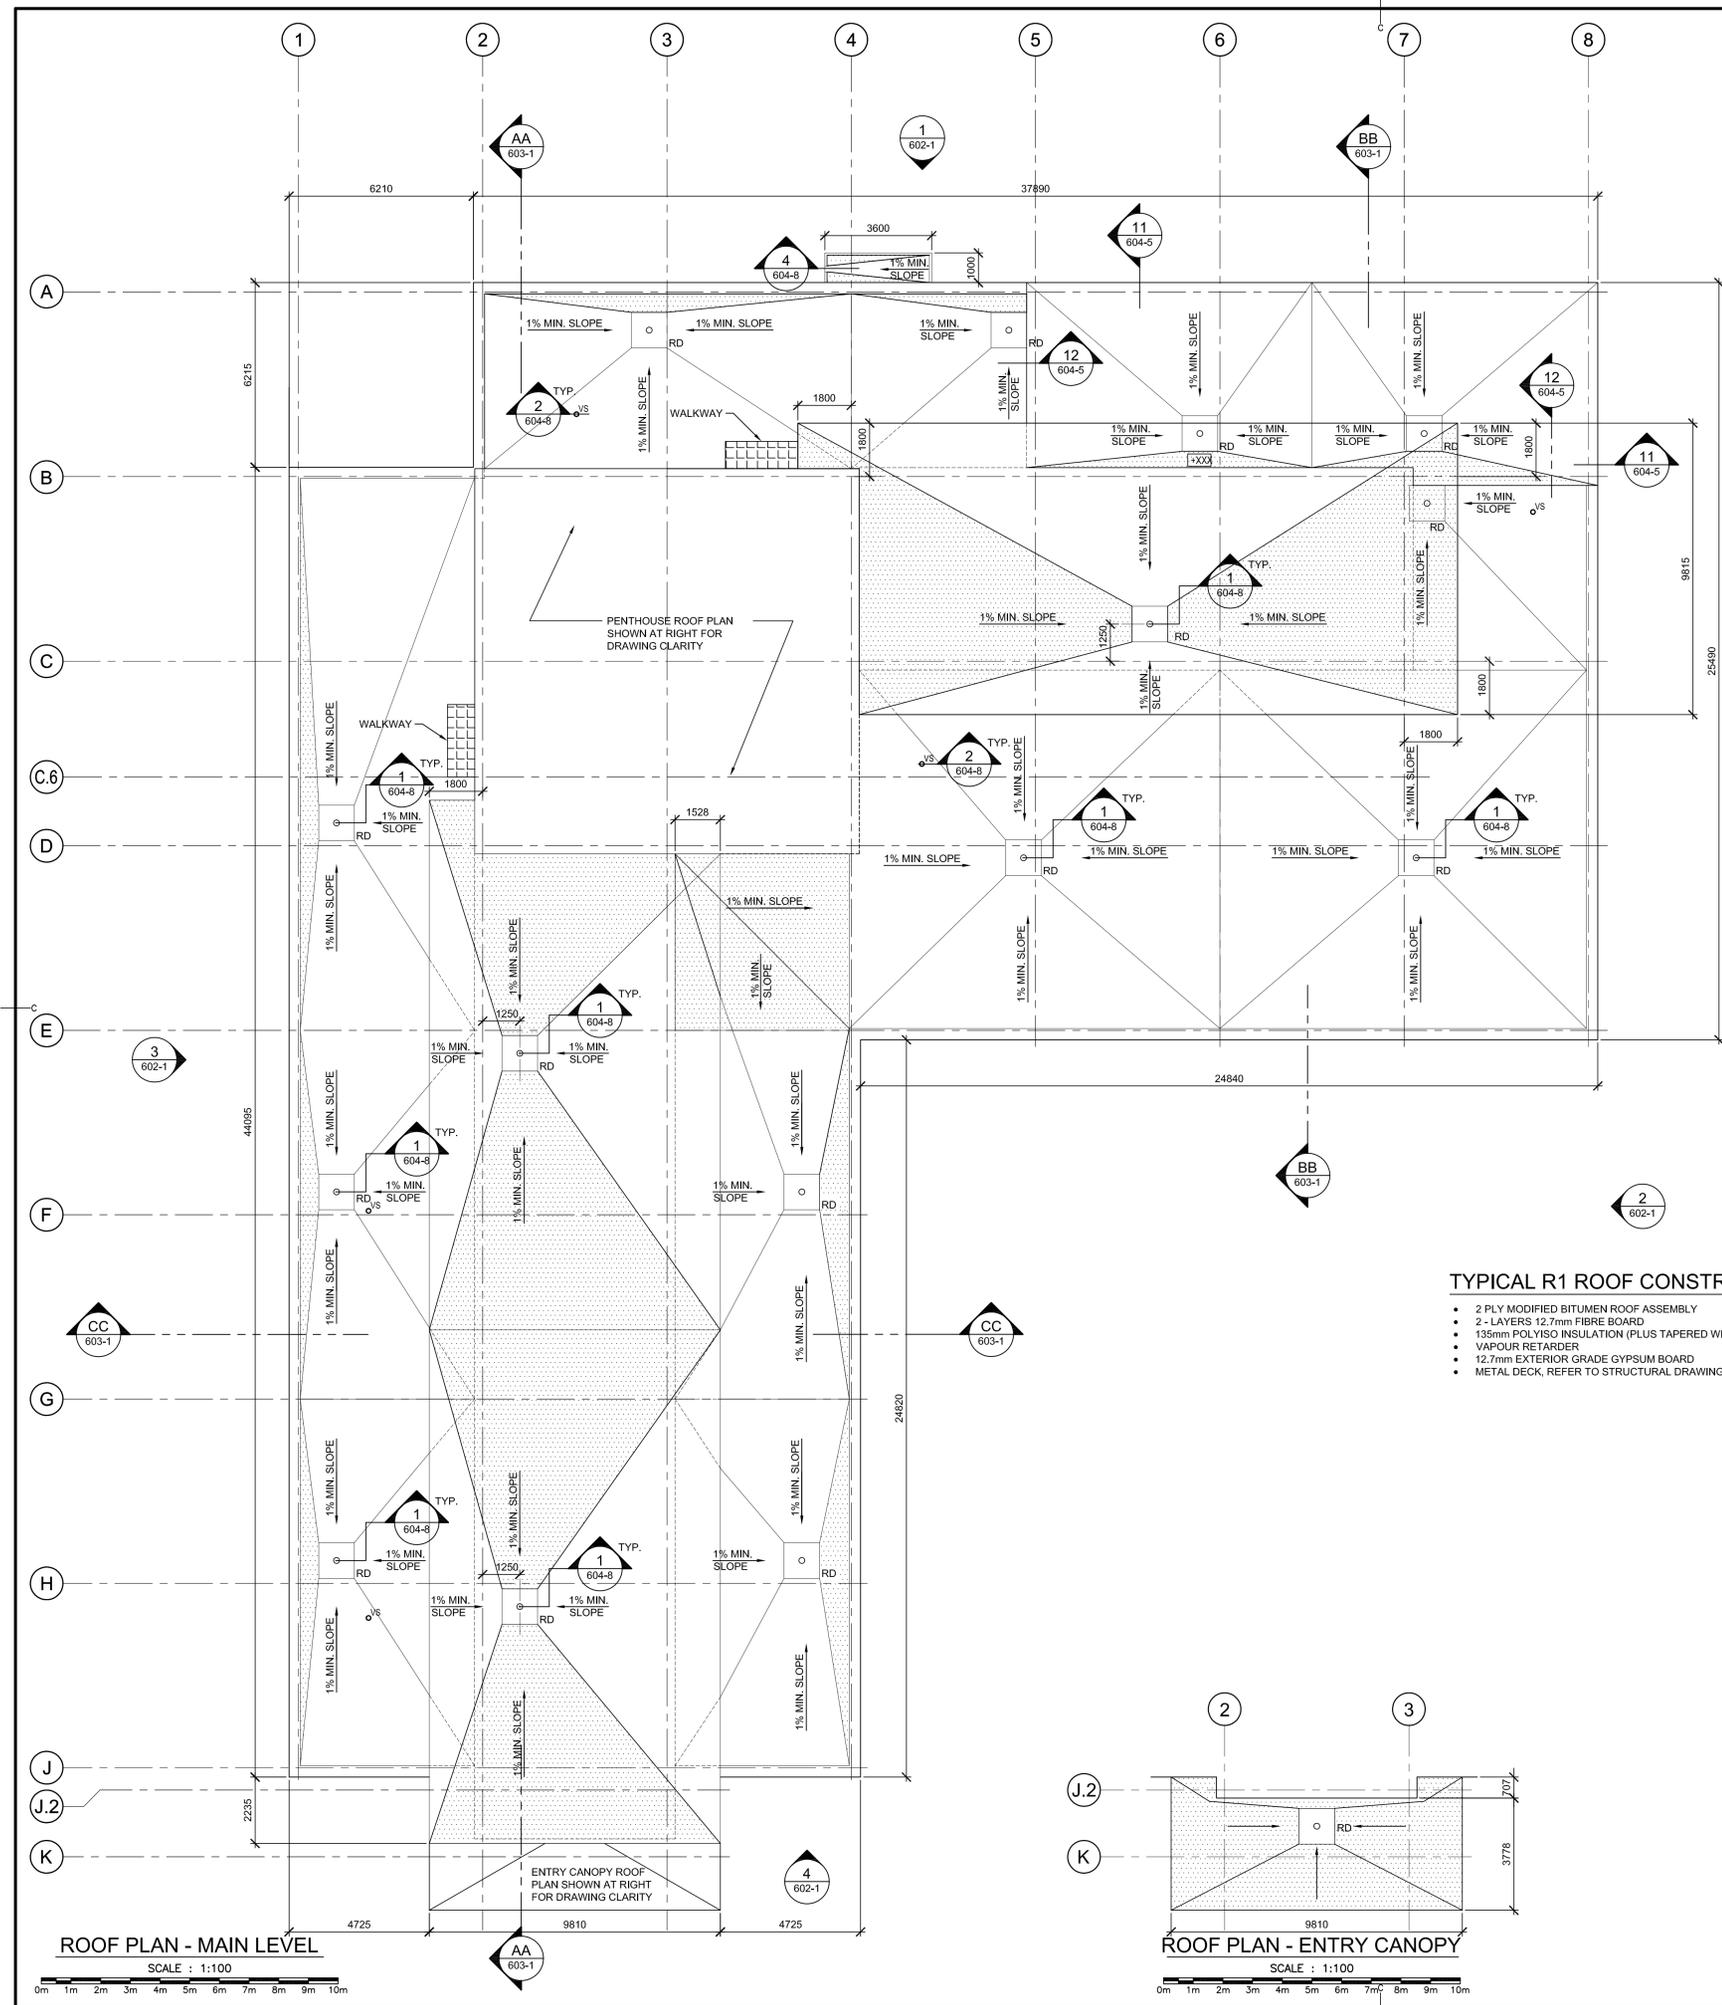

ROOF PLAN - PENTHOUSE
 SCALE : 1:100

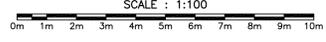

TYPICAL R1 ROOF CONSTRUCTION


- 2 PLY MODIFIED BITUMEN ROOF ASSEMBLY
- 2 - LAYERS 12.7mm FIBRE BOARD
- 135mm POLYISO INSULATION (PLUS TAPERED WHERE INDICATED)
- VAPOUR RETARDER
- 12.7mm EXTERIOR GRADE GYPSUM BOARD
- METAL DECK, REFER TO STRUCTURAL DRAWINGS

LEGEND


- RD → SUMP RECEIVER (TYPICAL 1000 x 1000) ROOF DRAIN
- VS → VENT STACK
- ▤ → ROOF WALKWAY
- → DIRECTION OF SLOPE
- ▨ → TAPERED INSULATION
- → ANTENNA

GENERAL NOTES

1. SEE DRAWING 604-5 FOR TYPICAL PARAPET DETAILS.
2. COORDINATE SIZE, QUANTITY AND LOCATION OF ROOF VENT STACKS AND ROOF DRAINS WITH MECHANICAL DRAWINGS AND SPECS.
3. SEE DRAWING 604-8 FOR TYPICAL ROOF DETAILS.
4. PROVIDE AN ADDITIONAL LAYER OF ROOFING MEMBRANE AT ROOF WALKWAYS LOCATED AT AREA OF DOORS AND ROOF HATCH.

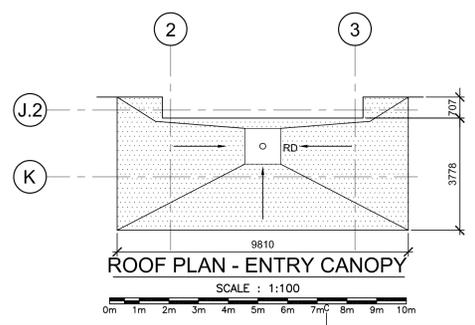

ROOF PLAN - ENTRY CANOPY
 SCALE : 1:100

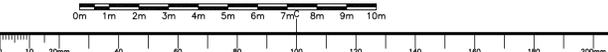

ROOF PLAN - MAIN LEVEL
 SCALE : 1:100

