


SMALL CRAFT HARBOURS



NOTES

1. CONTRACTOR IS RESPONSIBLE TO ENSURE ALL WORK ADHERES TO SAFETY REGULATIONS, BUILDING CODES & CONSTRUCTION BEST PRACTICES; MUNICIPAL REGULATIONS, AND MATERIAL MANUFACTURER INSTALLATION SPECIFICATIONS.
2. DO NOT SCALE DRAWINGS.
3. CONTRACTOR TO VERIFY ALL DIMENSIONS ON SITE BEFORE PROCEEDING WITH THIS WORK.
4. ALL ELEVATIONS ARE IN METERS UNLESS OTHERWISE NOTED.
5. ALL DIMENSIONS ARE MILLIMETERS UNLESS OTHERWISE NOTED.

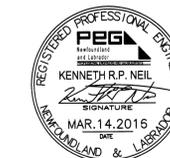

PROVINCE OF NEWFOUNDLAND  
 PERMIT HOLDER  
 Class "A"  
 This Permit Allows  
**CROSBIE ENGINEERING LIMITED**  
 To practice Professional Engineering  
 in Newfoundland and Labrador  
 Permit No. as issued by PEO-NL 09123  
 which is valid for the year 2015.

2	ISSUED FOR TENDER	14/03/16
1	RE-ISSUED FOR 100% REVIEW	17/02/16
0	ISSUED FOR 100%	04/01/15
B	ISSUED FOR 99% REVIEW	10/11/15
A	ISSUED FOR REVIEW	04/11/15

revisions		date
project		projct

WHARF RECONSTRUCTION  
 CHANGE ISLANDS, NL

drawing dessin

SITE PLAN, LEGEND  
 & GENERAL NOTES

designed	K.N.	concu
date	OCTOBER 2015	
drawn	D.R.	dessine
date	OCTOBER 2015	
approved		approve

Tender *Paul Curran* Soumission

DFO Project Manager

project number 710689 no. du projet


drawing no. E1 no. du dessin

GENERAL NOTES:

1. ALL WORK TO BE IN ACCORDANCE WITH THE LATEST REQUIREMENTS OF: THE NATIONAL BUILDING CODE OF CANADA, LATEST EDITION; CANADIAN ELECTRICAL CODE, CURRENT EDITION; ANY OTHER AUTHORITIES HAVING JURISDICTION.
2. THIS DRAWING IS NOT TO BE USED FOR CONSTRUCTION UNLESS IT IS ISSUED FOR CONSTRUCTION AND STAMPED AND SIGNED BY THE PROJECT ENGINEER.
3. CONTRACTOR TO PROVIDE ALL CUTTING, PATCHING AND PAINTING TO MATCH EXISTING. SEE SPECIFICATION FOR DETAILS. COORDINATE ON SITE.
4. CONTRACTOR SHALL BE RESPONSIBLE FOR CLEAN UP AND DISPOSALS OF WORK AREA ON A DAILY BASIS. AFTER EACH WORKING SHIFT WORK AREA TO BE CLEANED AND FREE OF DEBRIS.
5. ALL WIRING TO BE INSTALLED IN CONDUIT AS INDICATED.
6. ALL EXISTING ELECTRICAL EQUIPMENT REMOVED TO BE TURNED OVER TO OWNER. IF OWNER REFUSES THEN CONTRACTOR TO REMOVE FROM SITE AND DISPOSE.
7. APPROXIMATE LOCATION OF EXISTING ELECTRICAL SHED. CONTRACTOR TO REMOVE ALL EXISTING ELECTRICAL EQUIPMENT, WIRING, CONDUIT, ETC. CONTRACTOR TO ALSO COORDINATE WITH NEWFOUNDLAND AND LABRADOR HYDRO THE REMOVAL OF EXISTING ELECTRICAL SERVICE AND CONSTRUCTION OF NEW OVERHEAD SERVICE TO NEW SHED AS INDICATED.

ELECTRICAL LEGEND

- (B) HID LIGHTING FIXTURE. TO BE KEENE #3130100MAL1 OR APPROVED EQUAL. SEE SPEC.
- (A) FLUORESCENT LIGHTING FIXTURE. TO BE CFI #VTS248-VX C/W POLYCARBONATE LENS OR APPROVED EQUAL. SEE SPEC.
- \$ SINGLE POLE TOGGLE SWITCH. 15 AMP. 120 VOLT, YELLOW, MARINE GRADE C/W PVC MARINE GRADE COVERPLATE. SEE SPEC. FOR MORE INFORMATION. MOUNT 1200mm ABOVE FINISHED FLOOR.
- (T) LINE VOLTAGE THERMOSTAT RATED 240 VOLT, 4500 WATTS, DPST, WHITE. MOUNT 1200mm AFF.
- SURFACE MOUNTED PANELBOARD
- ☛ LIGHT POLE AND FIXTURES. SEE DETAIL ON DRAWING E5.
- ☛ ELECTRICAL PEDESTAL. SEE DETAILS ON DRAWING E3.
- WP (D) DUPLEX U-GROUND RECEPTACLE. 120 VOLT, 15 AMP, MARINE GRADE. YELLOW & C/W PVC MARINE GRADE COVERPLATE. WALL MOUNT 400mm ABOVE FINISHED FLOOR. "WP" INDICATES WEATHERPROOF GASKET AND COVERPLATE.
- ☛ TYPE CIRCUIT ELECTRIC HEATER.
- JIB CRANE. SEE DETAILS ON DRAWING E5.

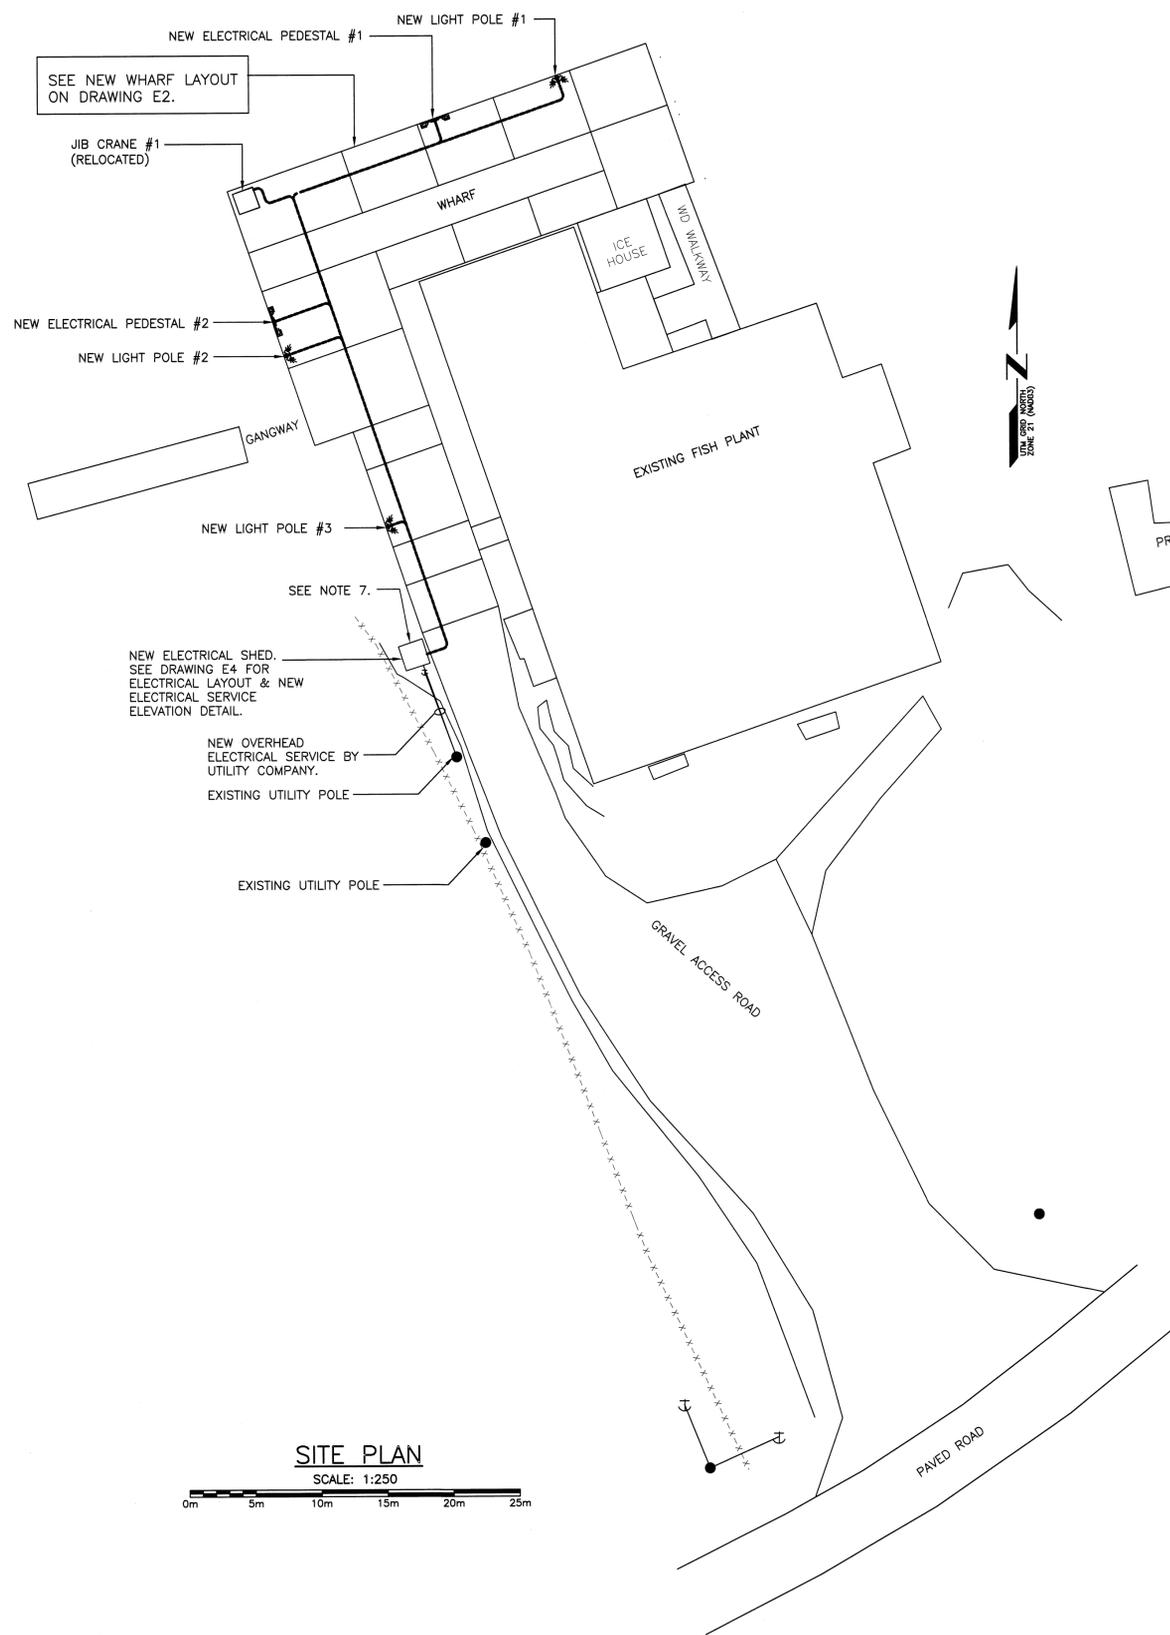

SITE PLAN  
 SCALE: 1:250

