


PLAN-UPPER FLOOR
CEILING SPACE

1
M2.0


PARTIAL UPPER FLOOR PLAN
RENOVATIONS COMPRESSED AIR

SCALE : 1:100
0m 1m 2m 3m 4m 5m 6m 7m 8m 9m 10m

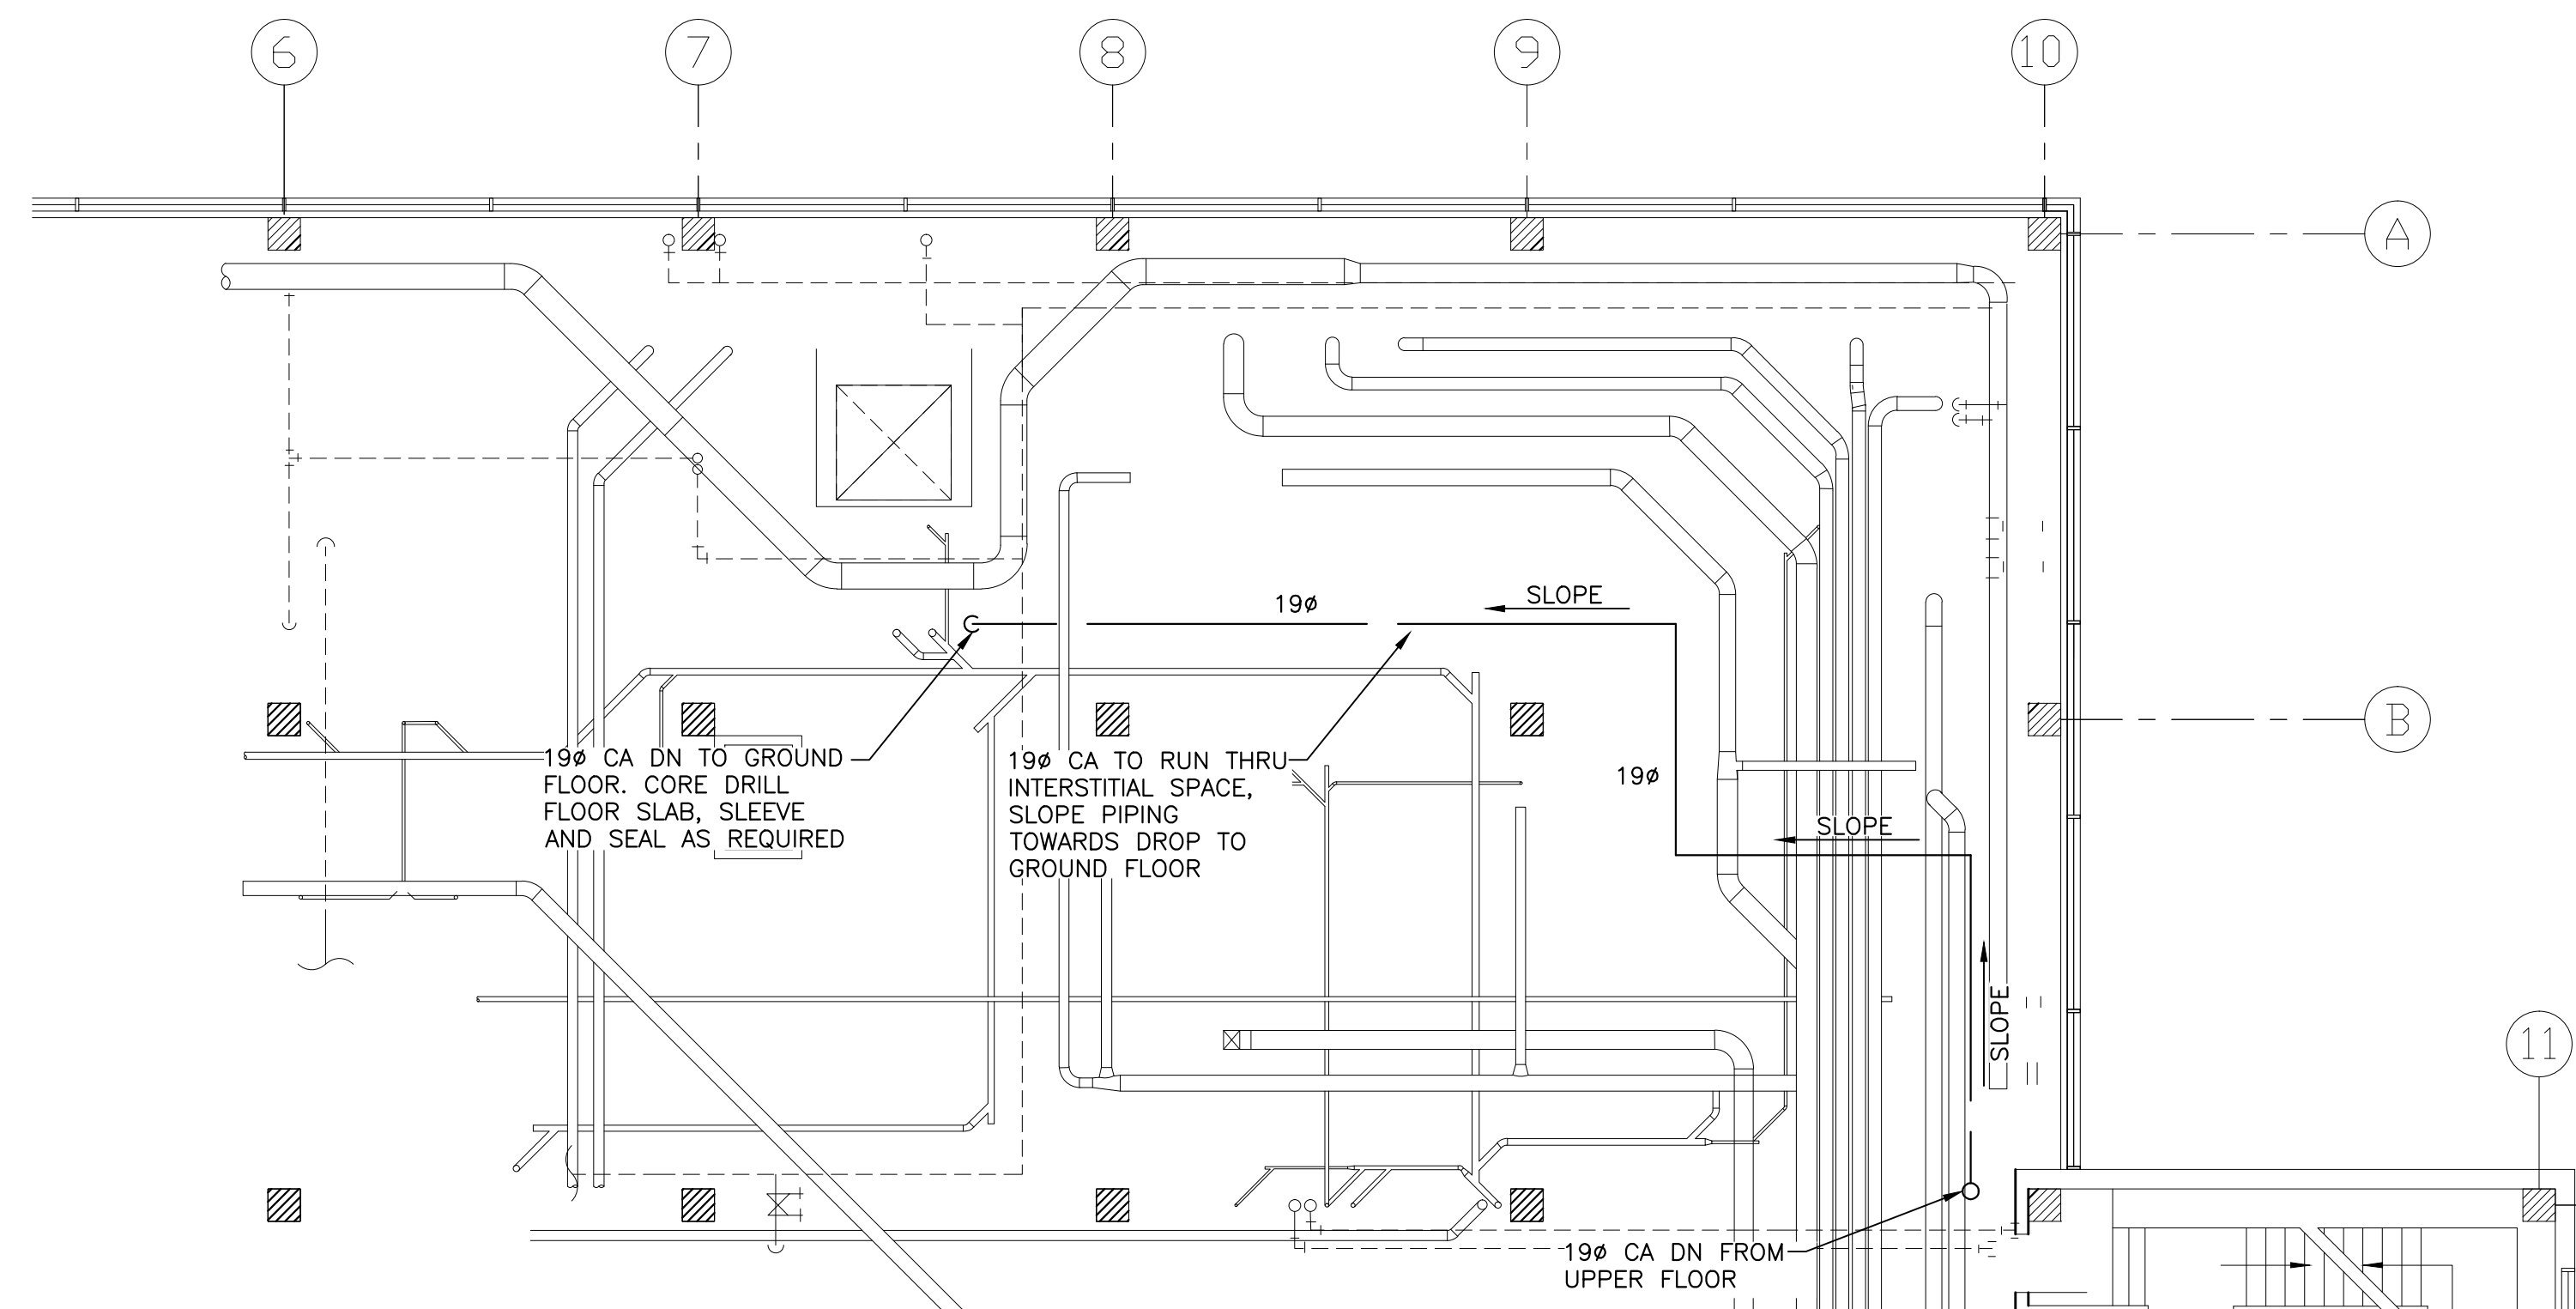


PARTIAL INTERSTITIAL FLOOR PLAN
RENOVATIONS COMPRESSED AIR

SCALE : 1:100
0m 1m 2m 3m 4m 5m 6m 7m 8m 9m 10m

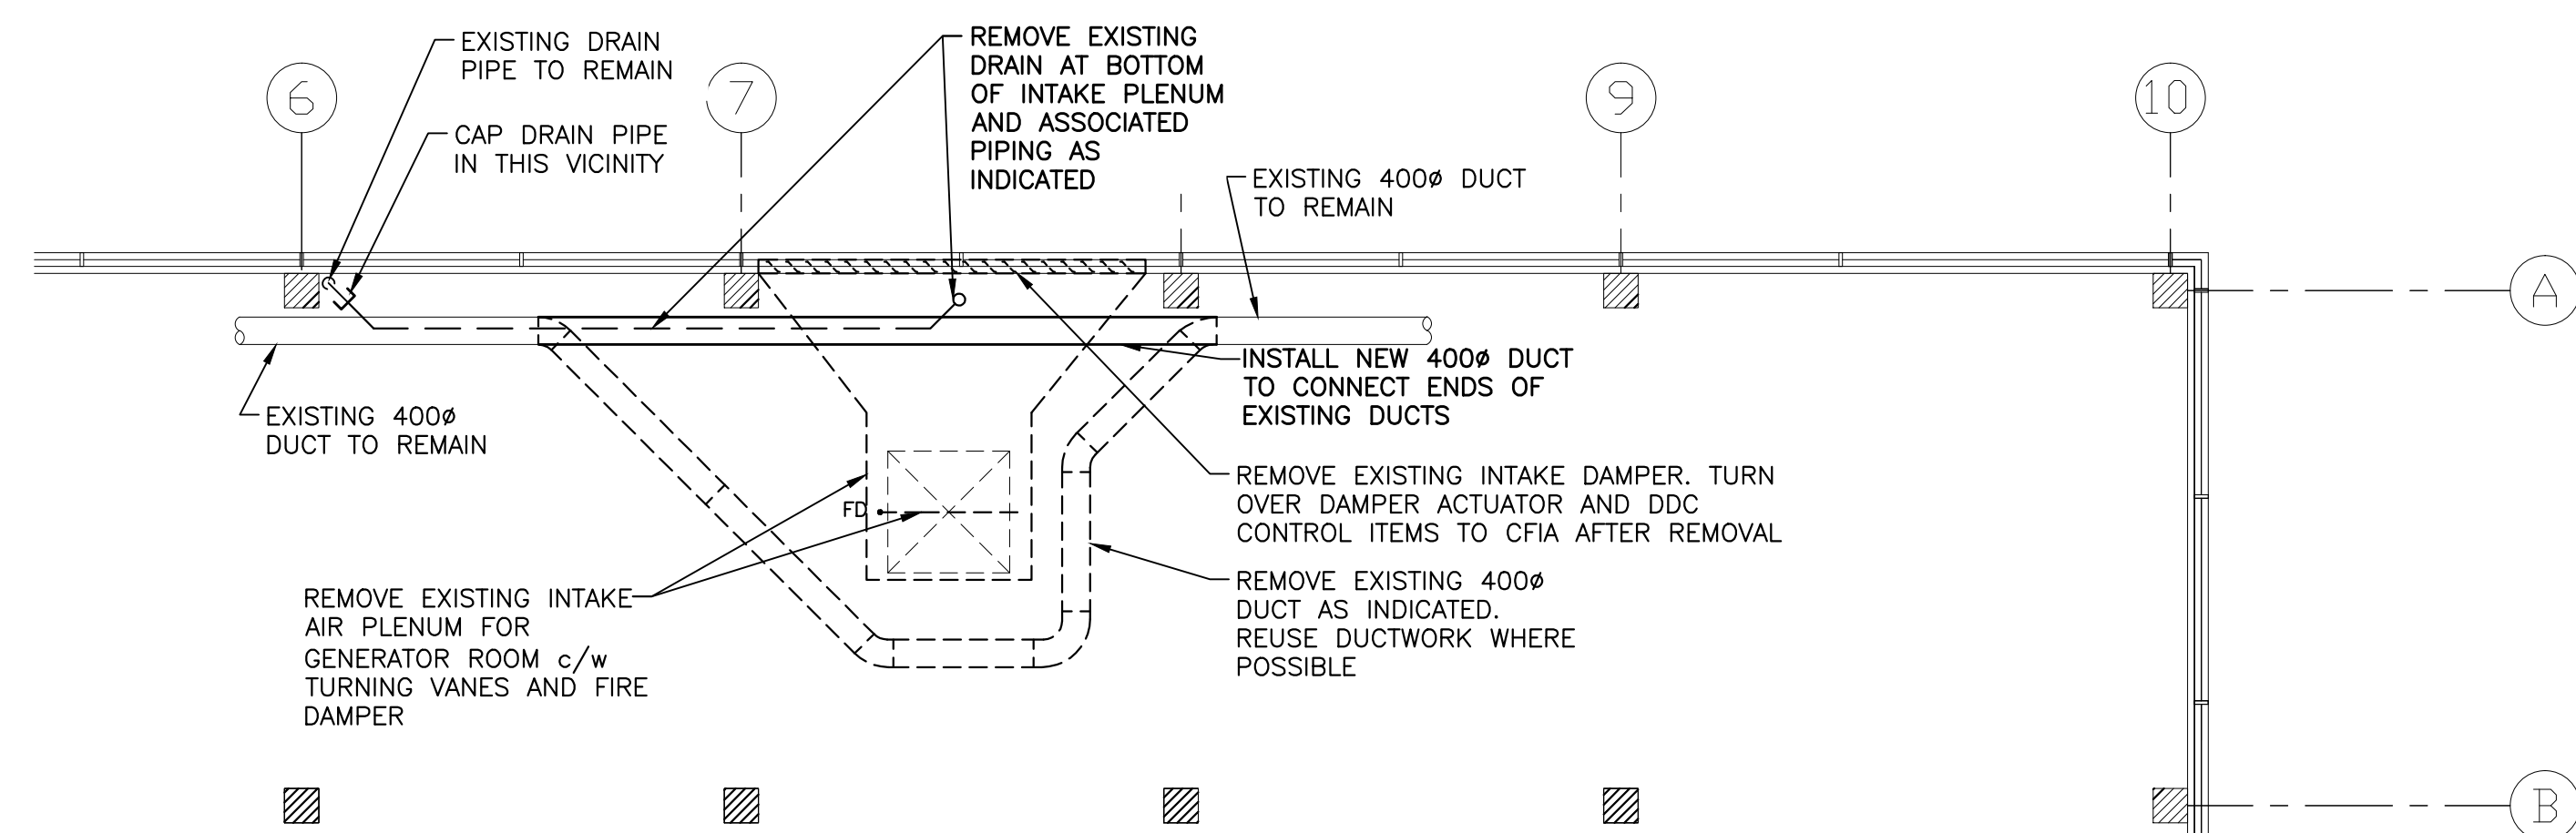


PARTIAL INTERSTITIAL FLOOR PLAN
RENOVATIONS PLUMBING AND VENTILATION

SCALE : 1:100
0m 1m 2m 3m 4m 5m 6m 7m 8m 9m 10m

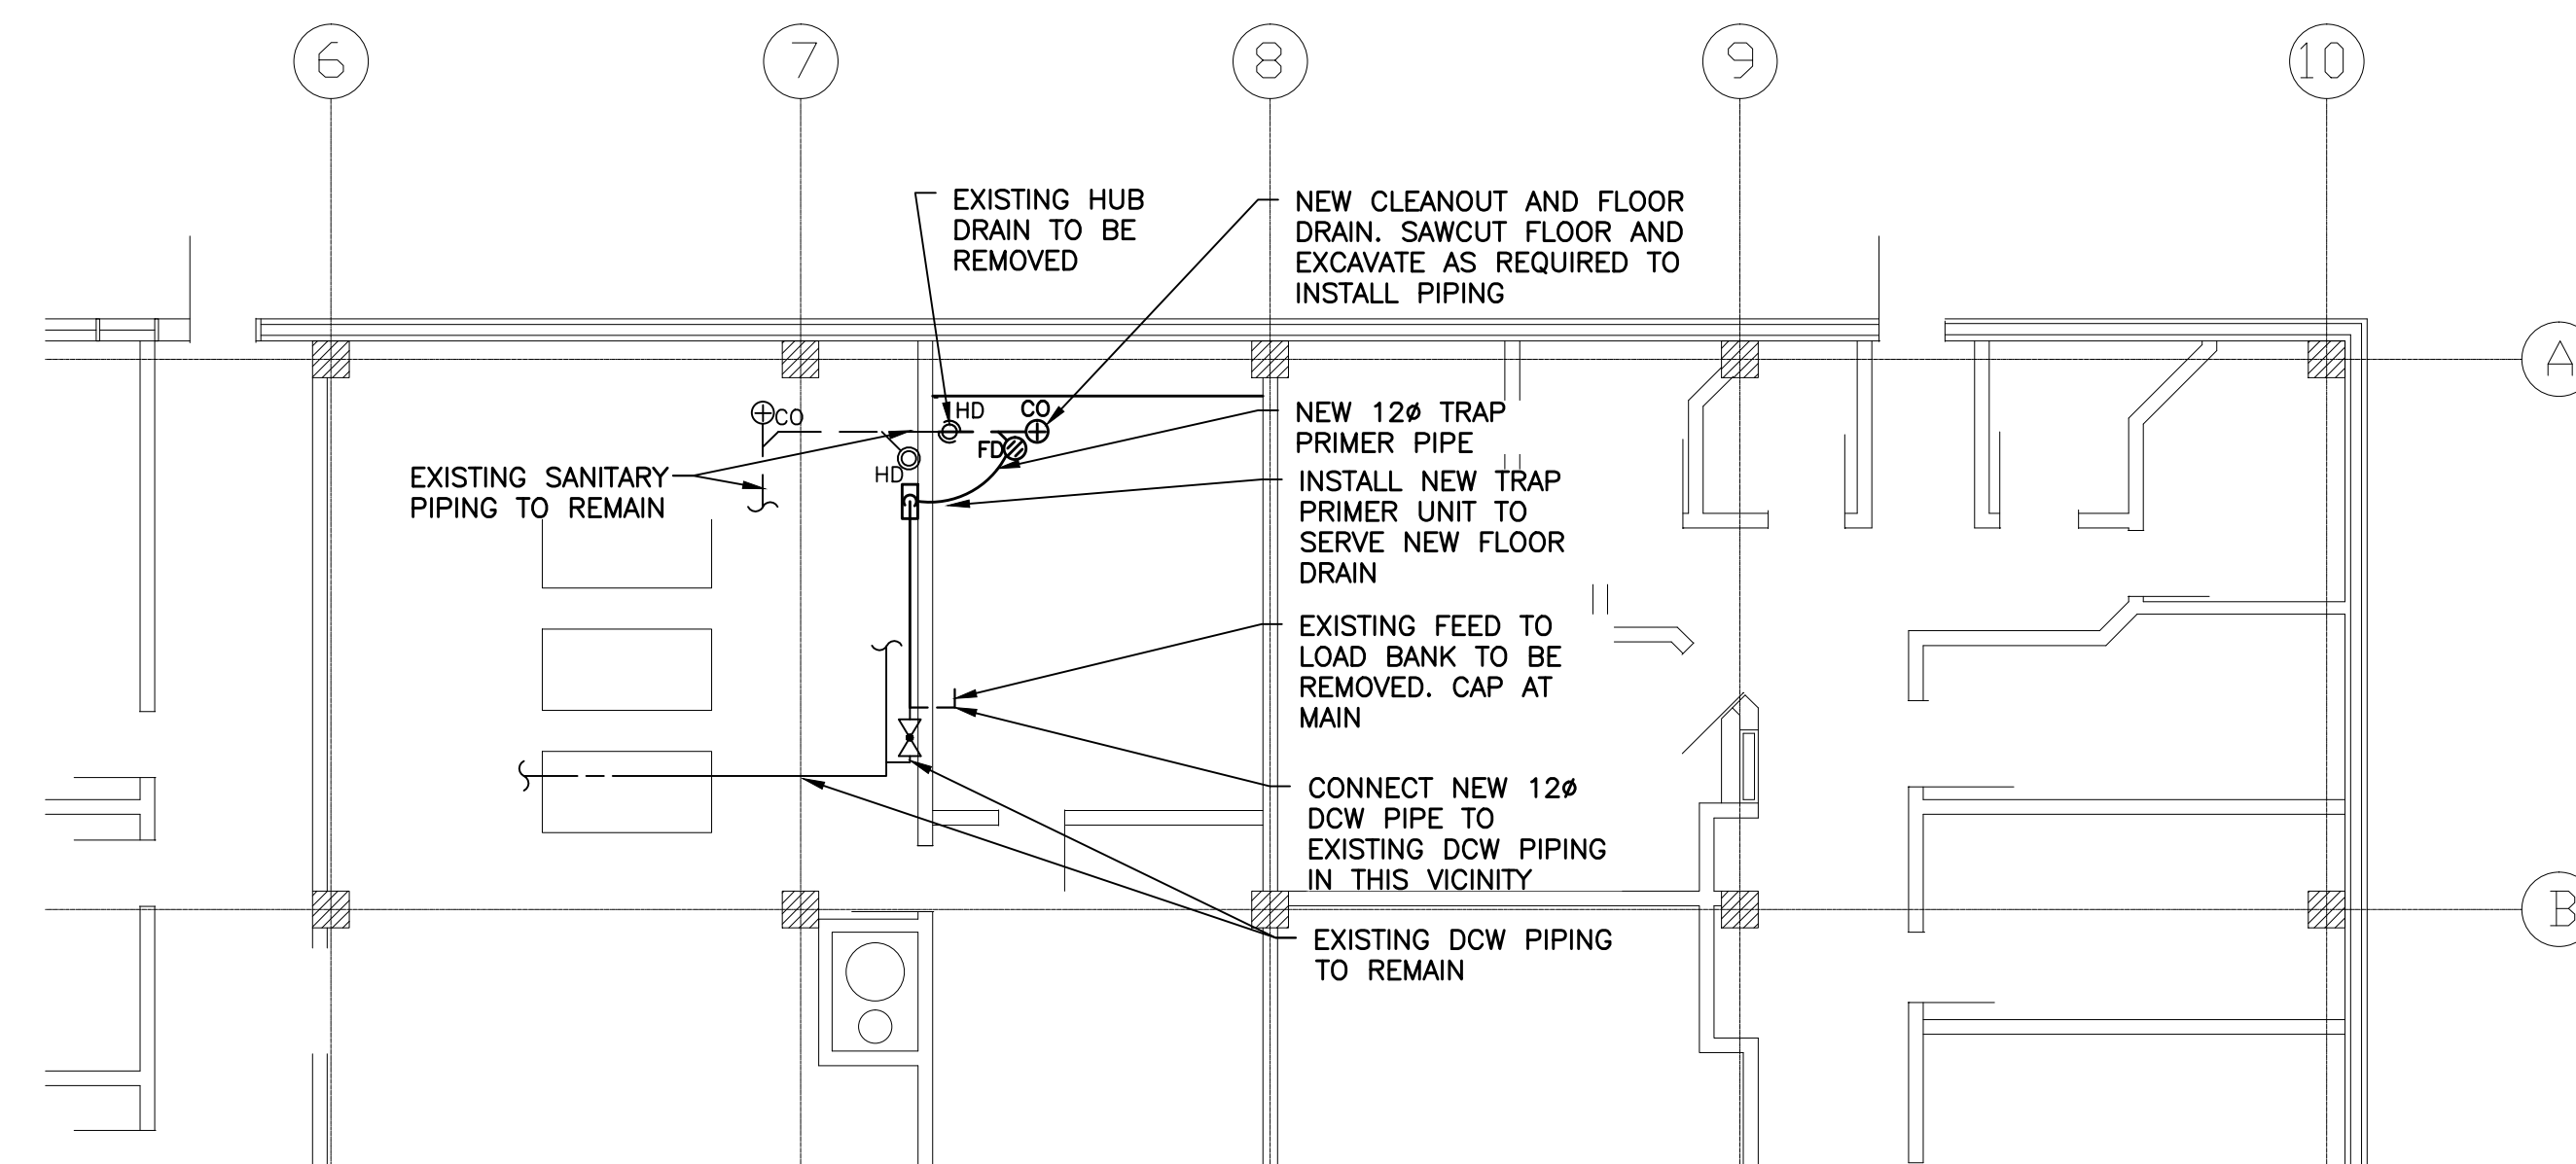


PARTIAL GROUND FLOOR PLAN
RENOVATIONS PLUMBING

SCALE : 1:100
0m 1m 2m 3m 4m 5m 6m 7m 8m 9m 10m

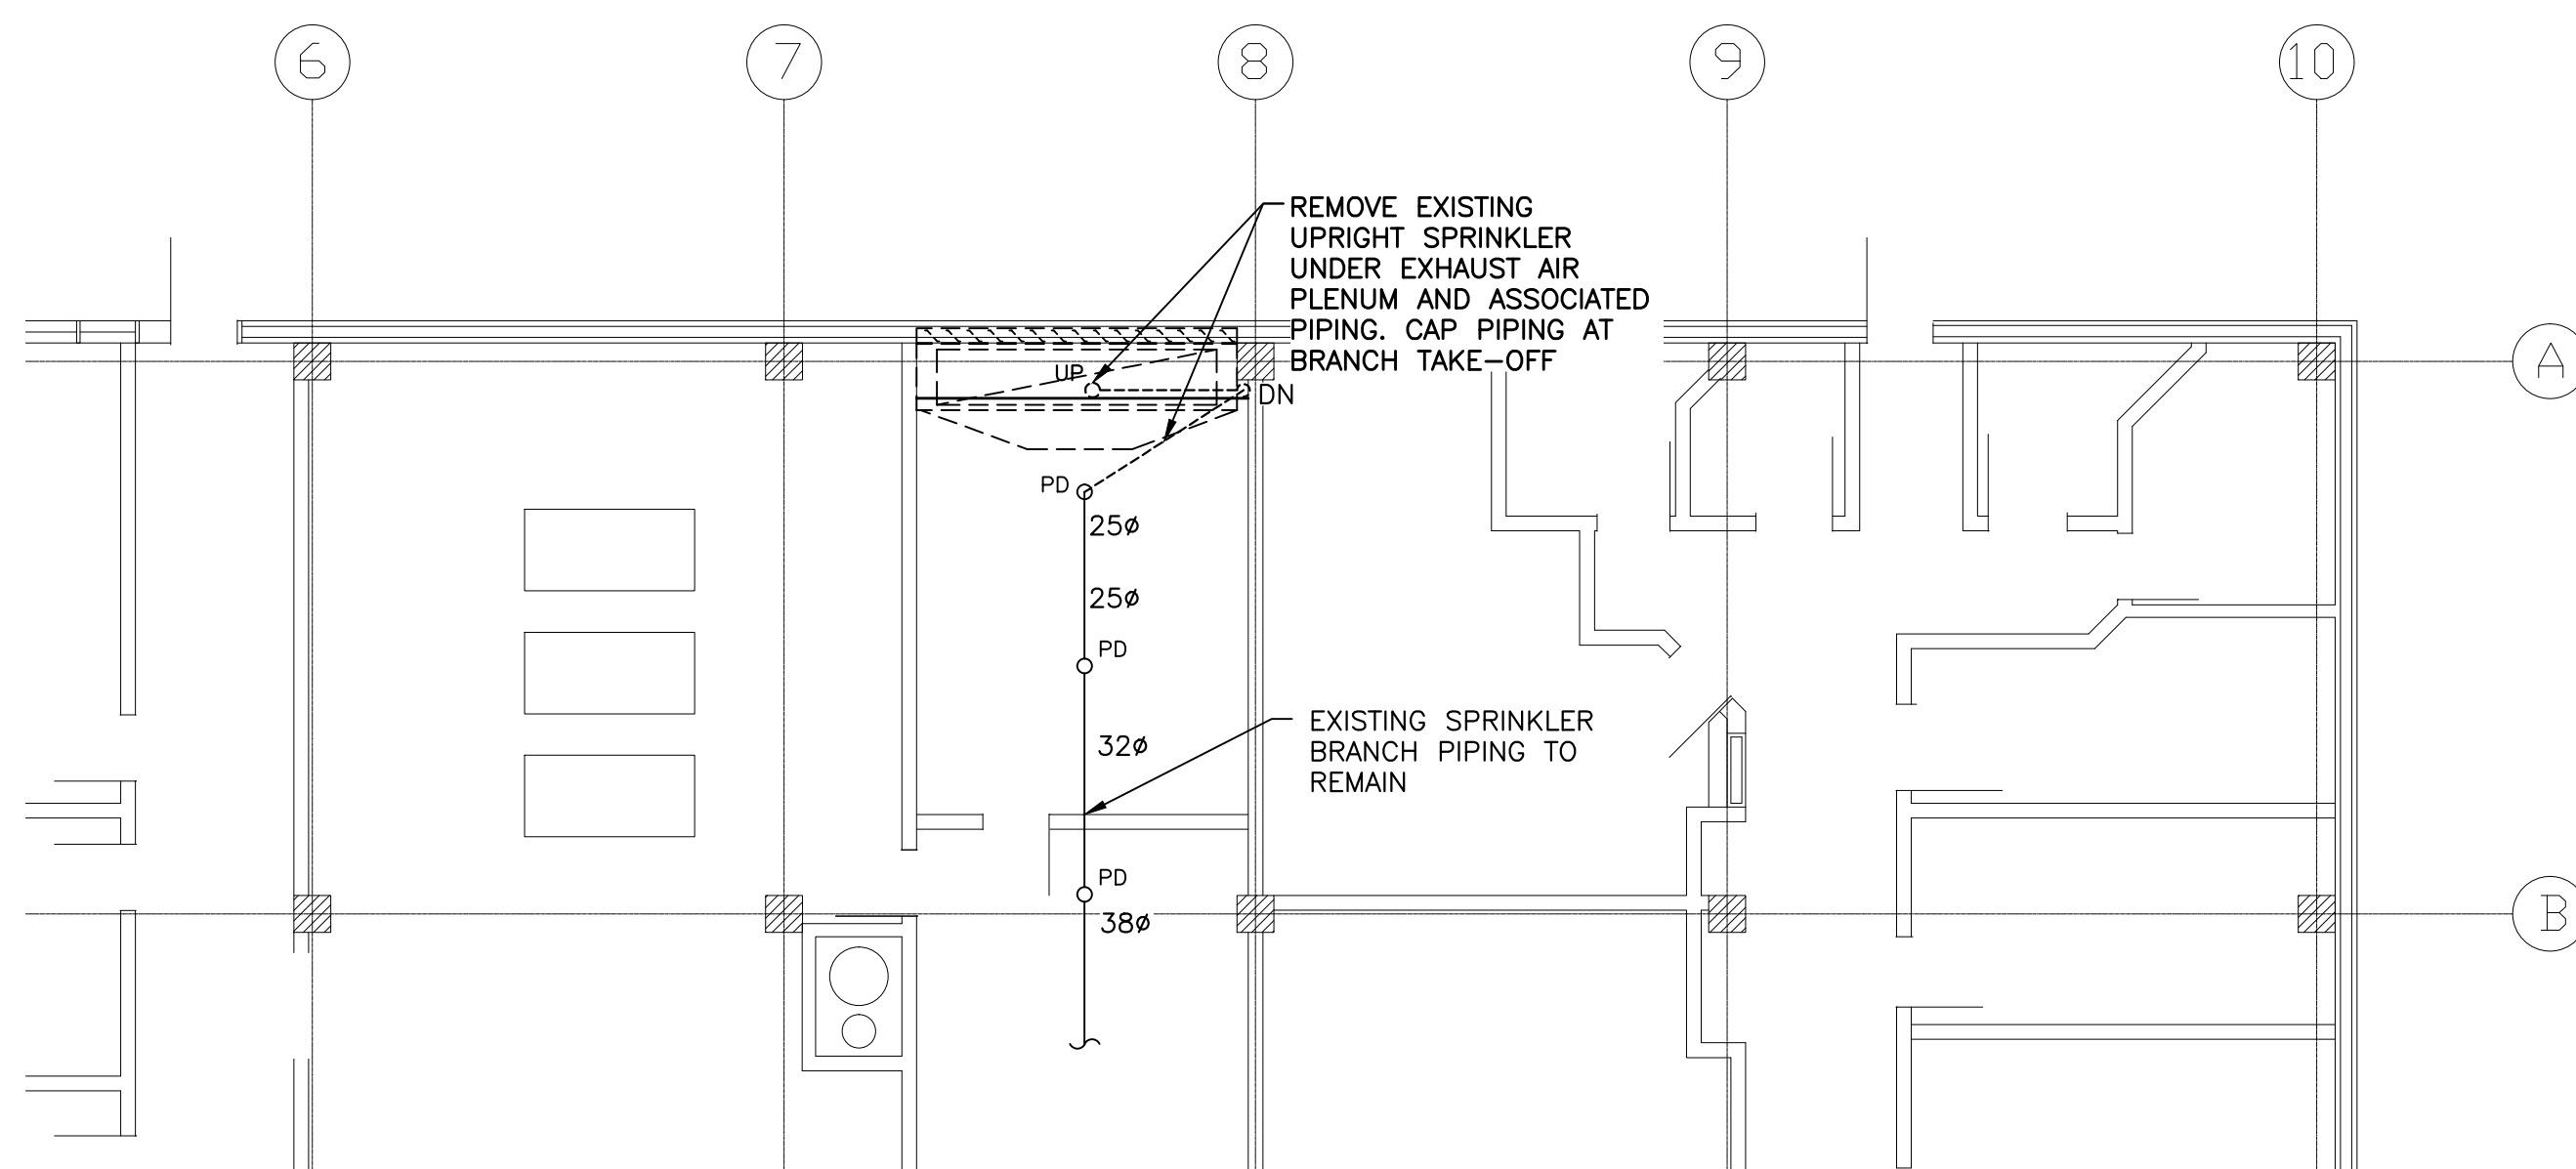

PARTIAL GROUND FLOOR PLAN
RENOVATIONS SPRINKLER

SCALE : 1:100
0m 1m 2m 3m 4m 5m 6m 7m 8m 9m 10m


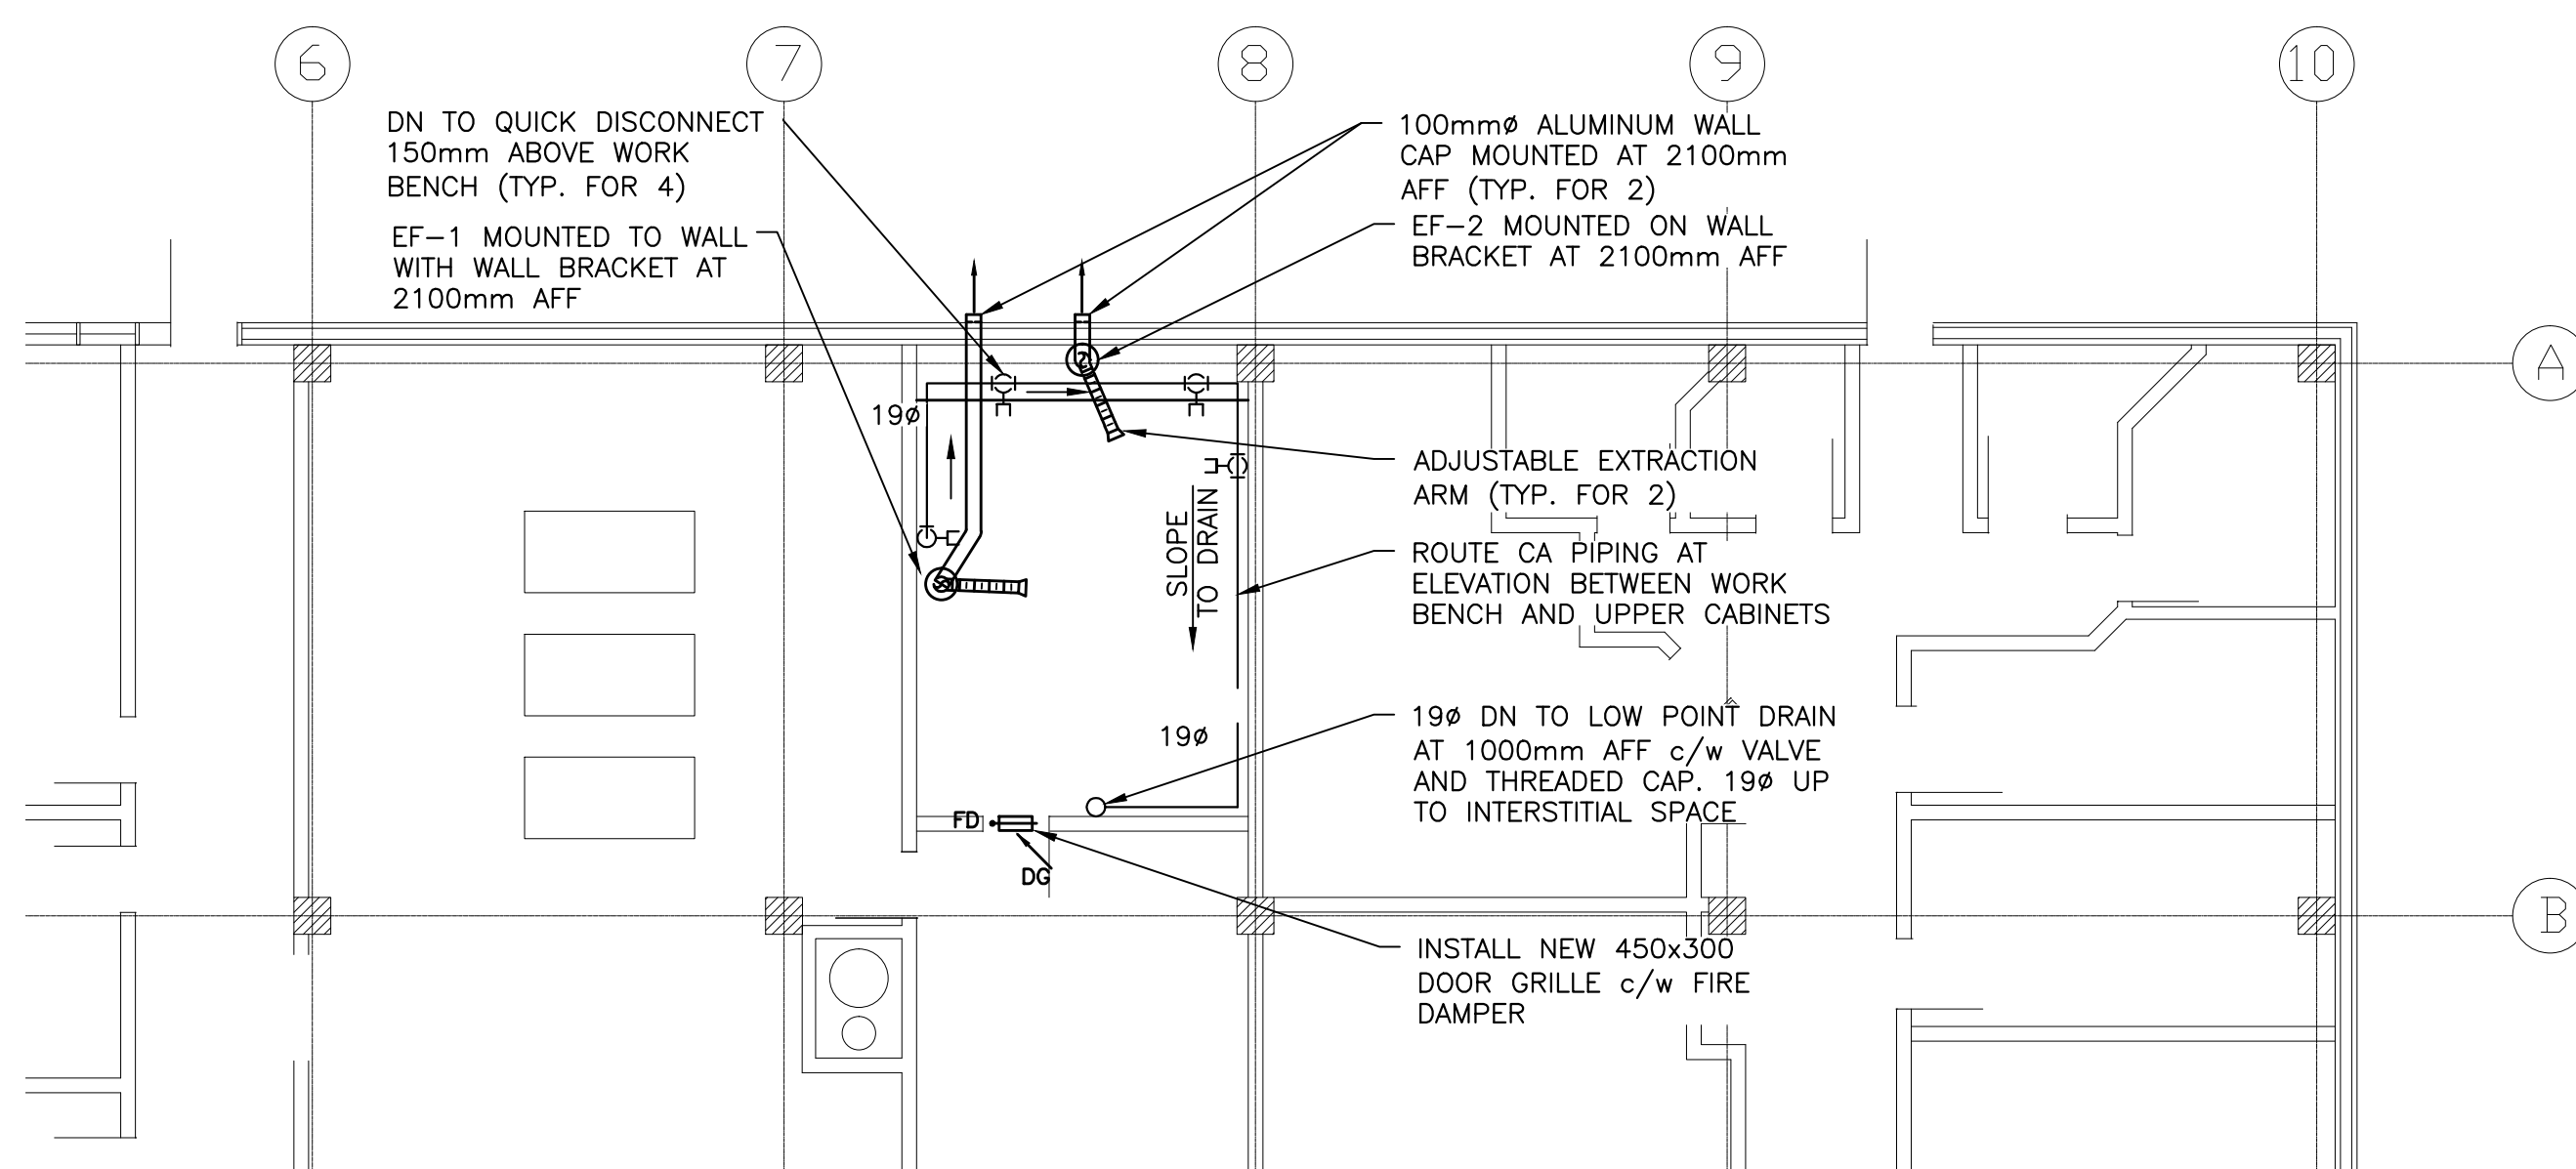


PARTIAL GROUND FLOOR PLAN RENOVATIONS
VENTILATION AND COMPRESSED AIR

SCALE : 1:100
0m 1m 2m 3m 4m 5m 6m 7m 8m 9m 10m

DRAIN SCHEDULE

DESIGN.	SERVICE	MFG./MODEL	REMARKS
FD	GENERAL PURPOSE FLOOR DRAIN	REFER TO SPECIFICATION	c/w POLISHED NICKEL BRONZE 150mmØ STRAINER & FRAME, TRAP PRIMER CONNECTION, OUTLET TO MATCH PIPE

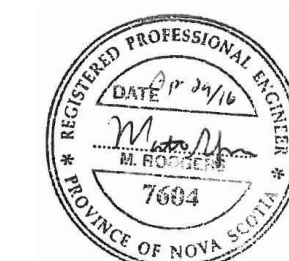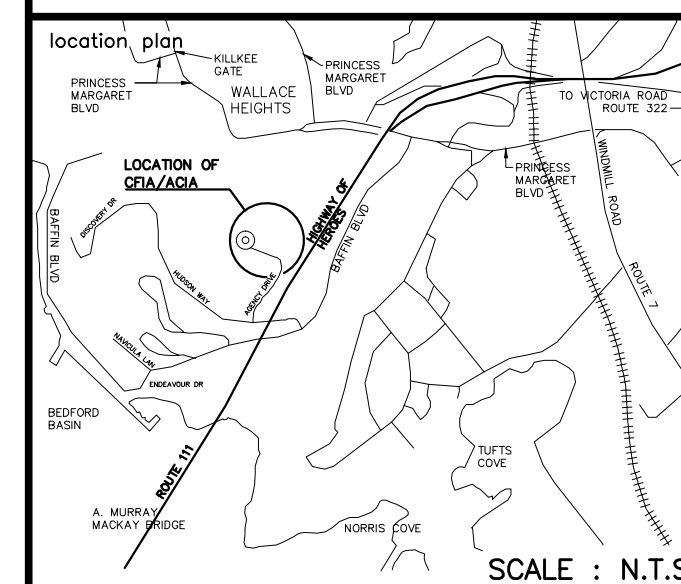

0	ISSUED FOR TENDER	04/29/2016
revisions		date
project	CFIA LABORATORY WALL CLADDING, ROOFING AND GENERATOR REPLACEMENT DARTMOUTH, N.S.	project

MECHANICAL FLOOR PLANS
VENTILATION & SPRINKLER

designed	MJR	conçu
date	JANUARY 2016	
drawn	MEH	dessiné
date	JANUARY 2016	
approved		approuvé
date		
tender		soumission
PWSC Project Manager	Administrateur de projets TPSC	
project number		no. du projet
	H0014	
drawing no.		no. du dessin
	M2.0	