

NEW SITE PLAN
SCALE: 1:250

- LEGEND**
- SYMBOLS**
- AQUACULTURE
 - ⊕ ANCHOR BLOCK
 - BOLLARD
 - ⊕ BOREHOLE
 - BOUNDARY MARKER
 - CARD POSITION BUOY
 - ▭ CATCH BASIN
 - CLEAT
 - CULVERT
 - ⊕ DERRICK
 - ⊕ DISPOSAL
 - ⊕ DREDGE CONTROL
 - ⊕ ELECTRICAL OUTLET
 - ⊕ FIRE HYDRANT
 - ⊕ FIRST AID
 - ⊕ FISH HANDLING EQUIP.
 - ⊕ FOG HORN
 - ⊕ FUEL PUMP
 - ⊕ H PILE
 - ⊕ HORIZONTAL CONTROL
 - ⊕ INVERT PIPE
 - ⊕ JIB CRANE
 - ⊕ LADDER
 - ⊕ LIFE RING
 - ⊕ LIGHT STANDARD
 - ⊕ MANHOLE
 - ⊕ MARSH
 - ⊕ MAST/TOWER
 - ⊕ NAVIGATION LIGHT
 - ⊕ OBSERVED BUOY
 - ⊕ OBSERVED SPAR BUOY
 - ⊕ PIPE PILE
 - ⊕ RANGE LIGHT
 - ⊕ SAFETY POST
 - ⊕ SEWER OUTFLOW PIPE
 - ⊕ SIGN
 - ⊕ TELEPHONE
 - ⊕ TELEPHONE POLE
 - ⊕ TIDE GAUGE/STAFF
 - ⊕ TREE
 - ⊕ UTILITY POLE
 - ⊕ VERTICAL CONTROL
 - ⊕ WATER TAP/OUTLET
 - ⊕ WATER VALVE
 - ⊕ WATER WELL
 - ⊕ WOOD PILE
- LINE TYPE**
- ⊕ ARMOUR STONE
 - ⊕ CL RAILROAD
 - ⊕ DRAIN PIPE
 - ⊕ EDGE ROAD / SHOULDER
 - ⊕ FENCE LINE
 - ⊕ FLOATING WAVEBREAK
 - ⊕ GUARD RAIL
 - ⊕ HIGH WATER MARK
 - ⊕ LOW WATER MARK
 - ⊕ MARSH OUTLINE
 - ⊕ PROPERTY BOUNDARY
 - ⊕ RANGE LIGHT EXTENSION
 - ⊕ RETAINING WALL
 - ⊕ RIPRAP
 - ⊕ TOE OF BANK
 - ⊕ TREE LINE
 - ⊕ UNDERGROUND CABLE

- LEGEND:**
- 0.00 APPROX. EXISTING ELEVATIONS
 - X.XX FINISH ELEVATIONS
 - DENOTES AREA OF NEW CRIB
 - ▨ DENOTES DREDGING AREA
 - ▨ DENOTES AREA TO BE BACKFILLED WITH ROCK AND GRAVEL FILL AND TOPPED WITH 100mm OF GRANULAR BASE.
 - ▨ DENOTES NEW SUPPORT CRIBS UNDER EXISTING BUILDING

- GENERAL NOTES:**
- CONTRACTOR TO MAINTAIN A MINIMUM 1.5m SHOULDER BETWEEN TOP OF DREDGE SLOPE AND EXISTING STRUCTURE TO ENSURE THE EXISTING CRIB IS NOT UNDERMINED OR DAMAGED.
 - FINISHED GRADES SHOWN ON THE BACKFILLED AREAS ARE APPROXIMATE. CONTRACTOR TO ENSURE GRADES ARE ESTABLISHED TO PROVIDE POSITIVE DRAINAGE AND TIE INTO EXISTING STRUCTURES AND TOPOGRAPHY.

POINTS	NORTHINGS	EASTINGS
A	5 484 176.52	659 500.16
B	5 484 166.37	659 506.94
C	5 484 190.09	659 542.44

Charter and Oceans
Perches et Océans
Canada

SMALL CRAFT HARBOURS

- NOTES**
- ALL ELEVATIONS ARE IN METRES UNLESS OTHERWISE NOTED.
 - ALL DIMENSIONS ARE IN MILLIMETRES UNLESS OTHERWISE NOTED.

PROVINCE OF NEWFOUNDLAND AND LABRADOR

P.E.G. PERMIT HOLDER

This Permit Allows
DELOITTE ENGINEERING CONSULTANTS LTD.
To practice Professional Engineering
in Newfoundland and Labrador.
Permit No. as issued by P.E.G. 0018
which is valid for the year 2016.

A	A - DETAIL NUMBER
B	B - LOCATION SHEET
C	C - DETAIL SHEET


0	ISSUED FOR TENDER	16/05/3
revisions		date
project		project

MARGINAL WHARF RECONSTRUCTION
SUMMERFORD, NL

drawing _____ dessin _____

NEW SITE PLAN AND WHARF LAYOUT

designed C. SARGENT	concu
date OCTOBER, 2015	
drawn P. CURTIS	dessine
date OCTOBER, 2015	
approved _____	approuvé
Tender _____	Submission
DFD Project Manager _____	
project number 714358	no. du projet
drawing no. C2 OF 7	no. du dessin

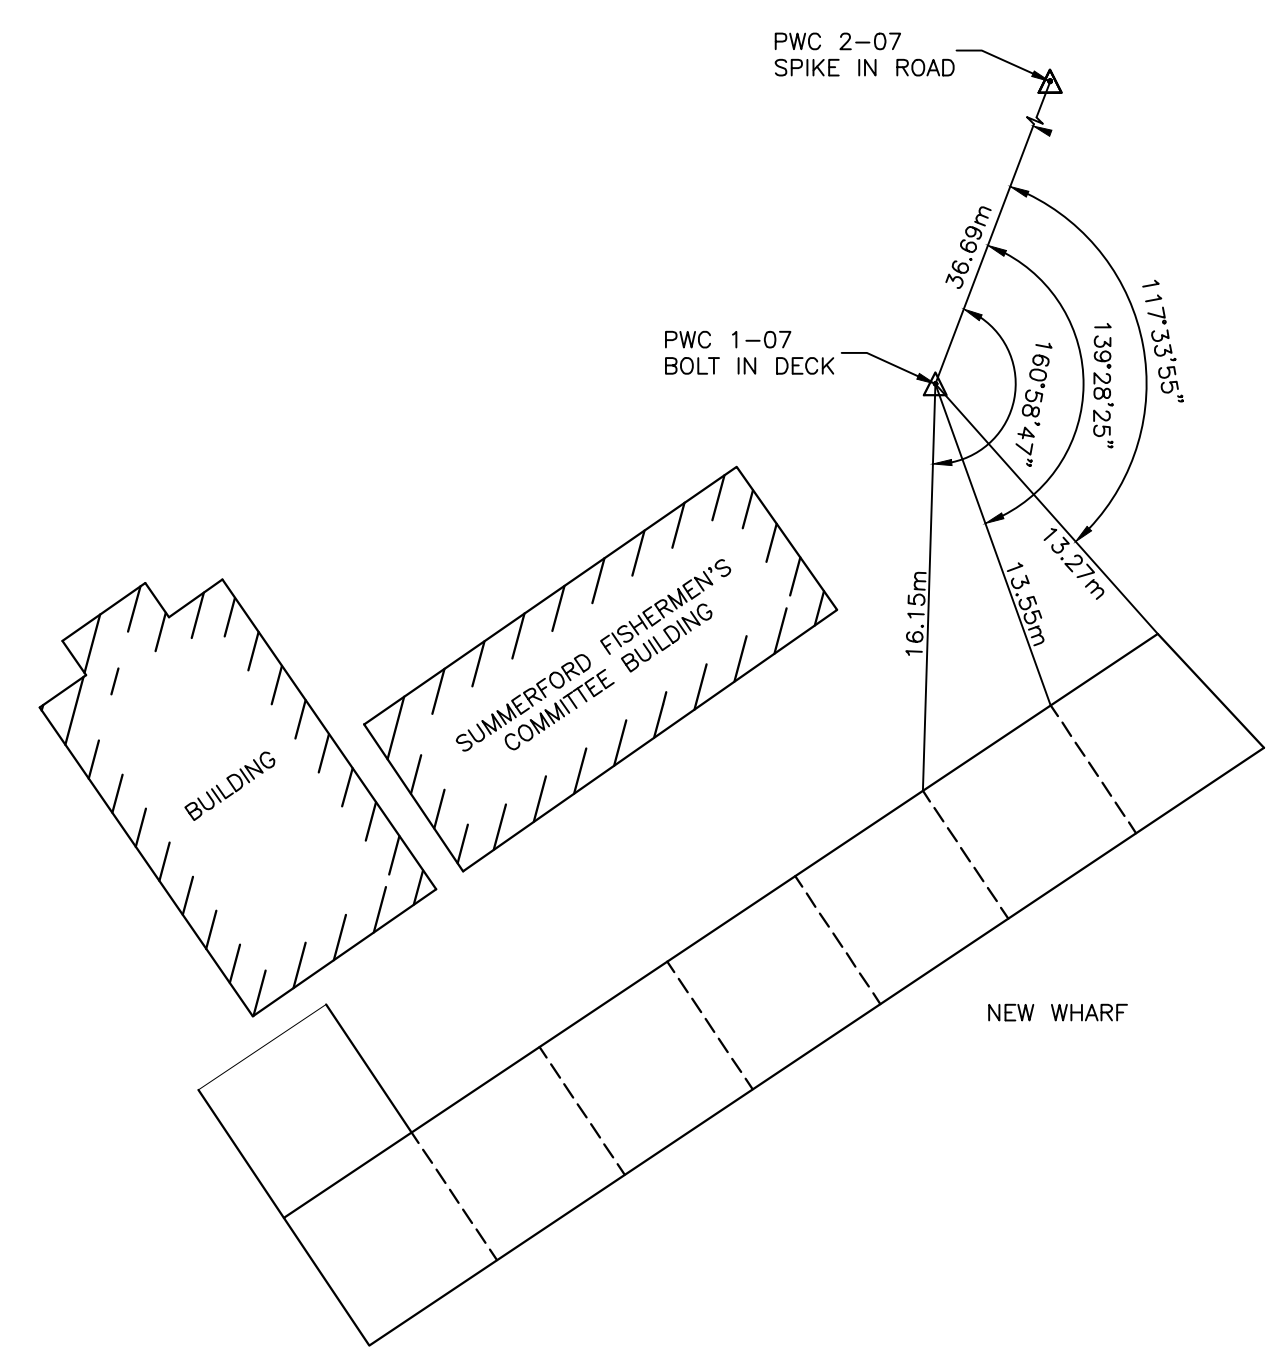

TIE-INS FOR NEW WHARF
SCALE: NTS