



PLAN - ROOF FRAMING LAYOUT (EXISTING)

SCALE/ÉCHELLE: 1:100
0m 1m 2m 3m 4m 5m 6m 7m 8m 9m 10m

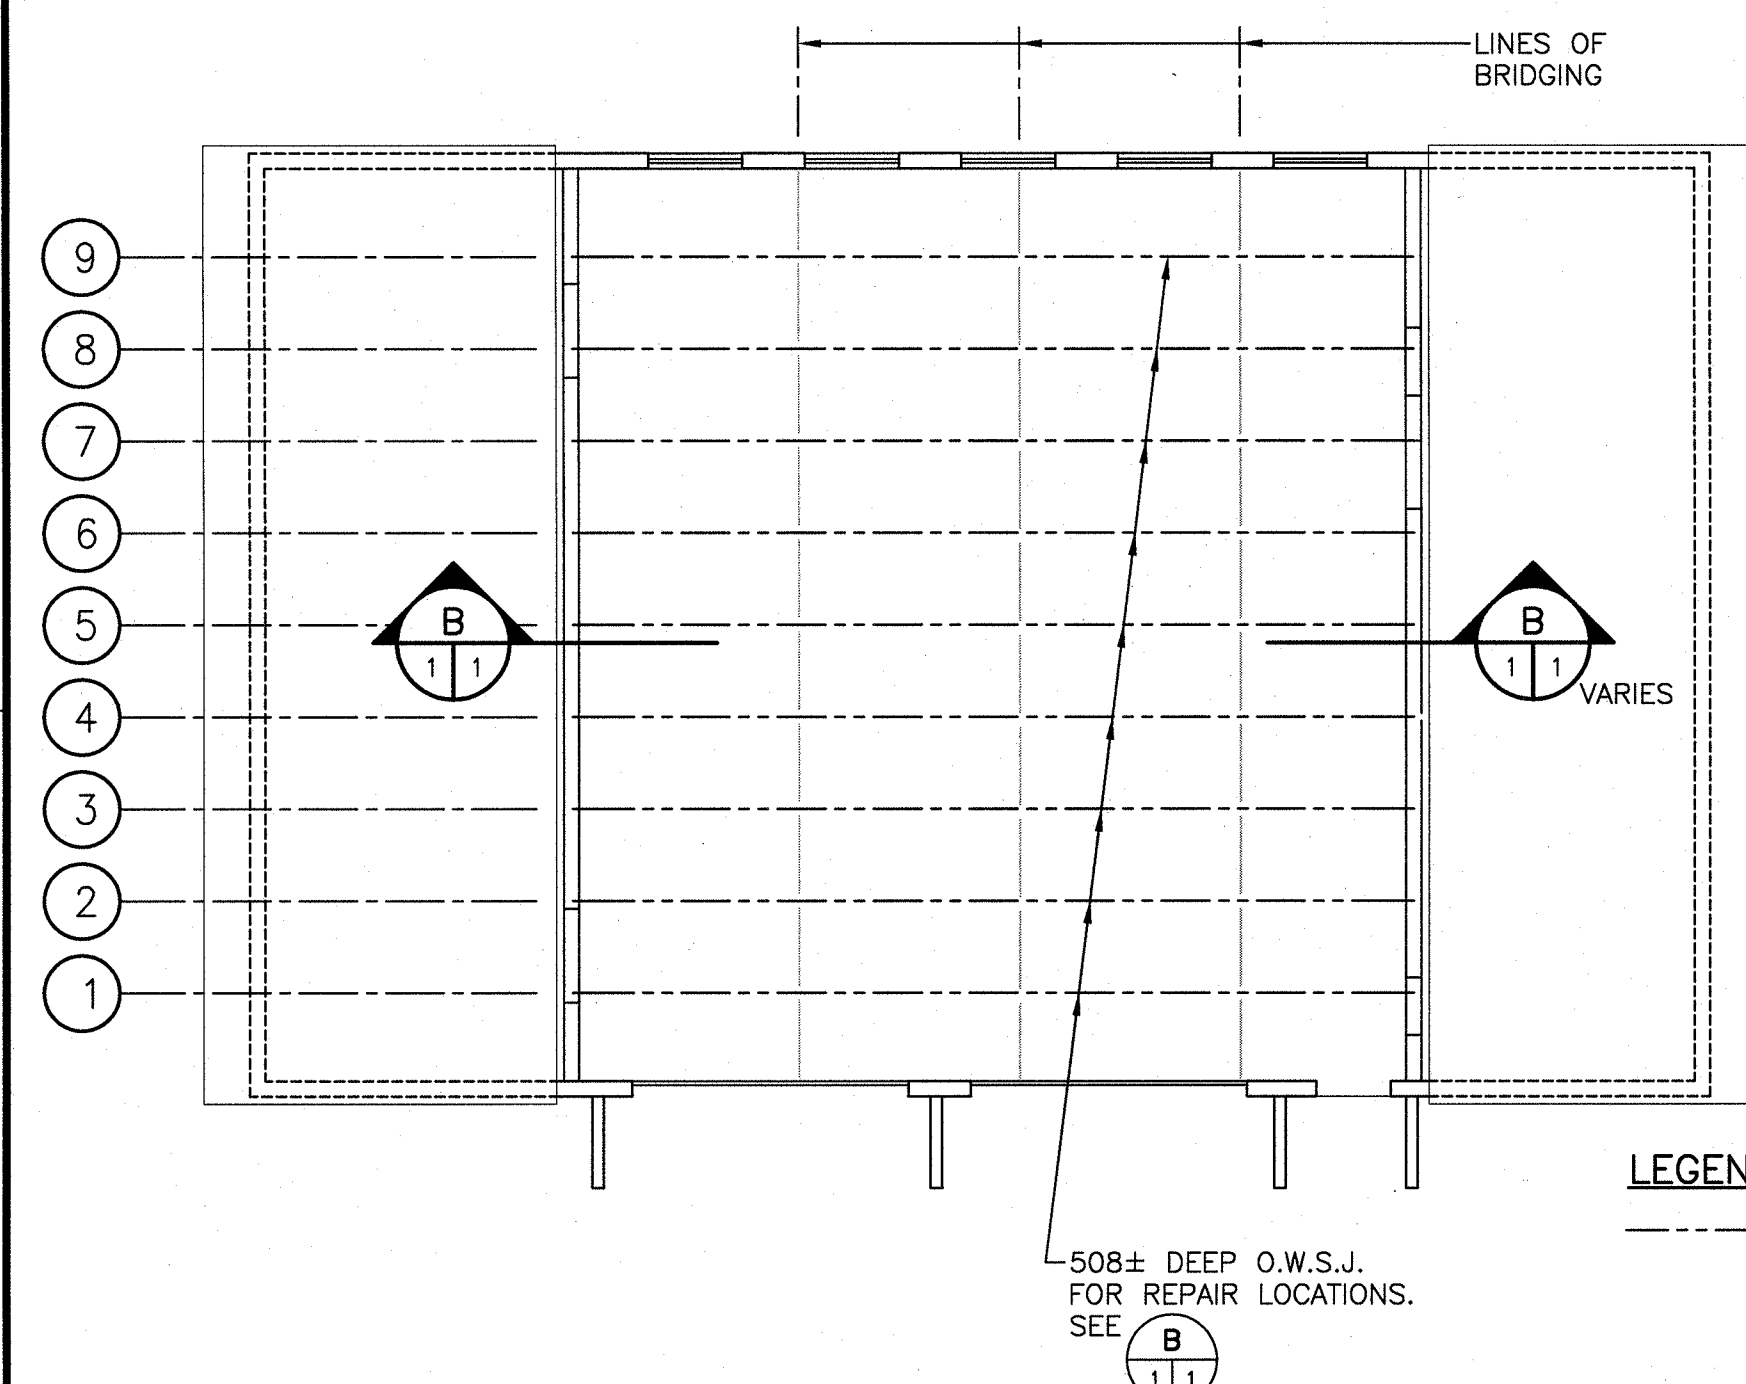

PLAN - UPPER ROOF O.W.S.J. REPAIRS


SCALE/ÉCHELLE: 1:100
0m 1m 2m 3m 4m 5m 6m 7m 8m 9m 10m

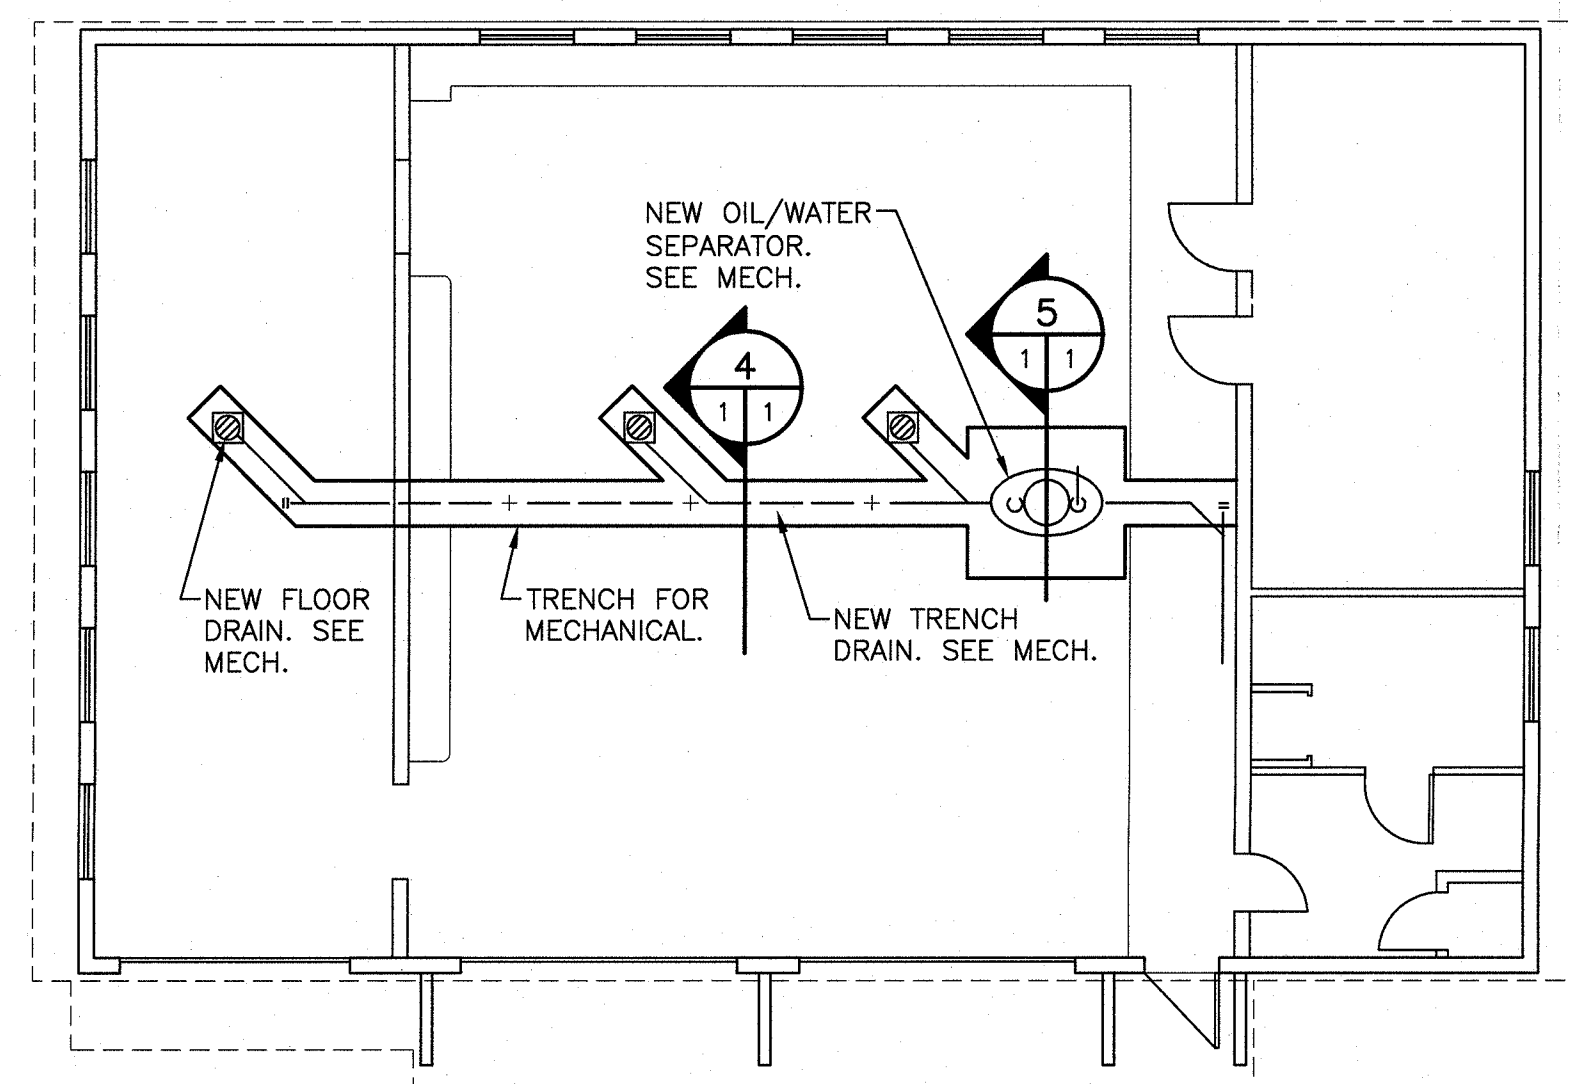

FLOOR PLAN - TRENCHING/SLAB REPAIRS


SCALE/ÉCHELLE: 1:100
0m 1m 2m 3m 4m 5m 6m 7m 8m 9m 10m

NOTE: EXACT ROUTING AND DIMENSIONS OF SLAB REMOVALS AND REINSTATEMENTS TO VARY TO SUIT INSTALLATION OF SERVICES. COORDINATE WITH MECHANICAL.

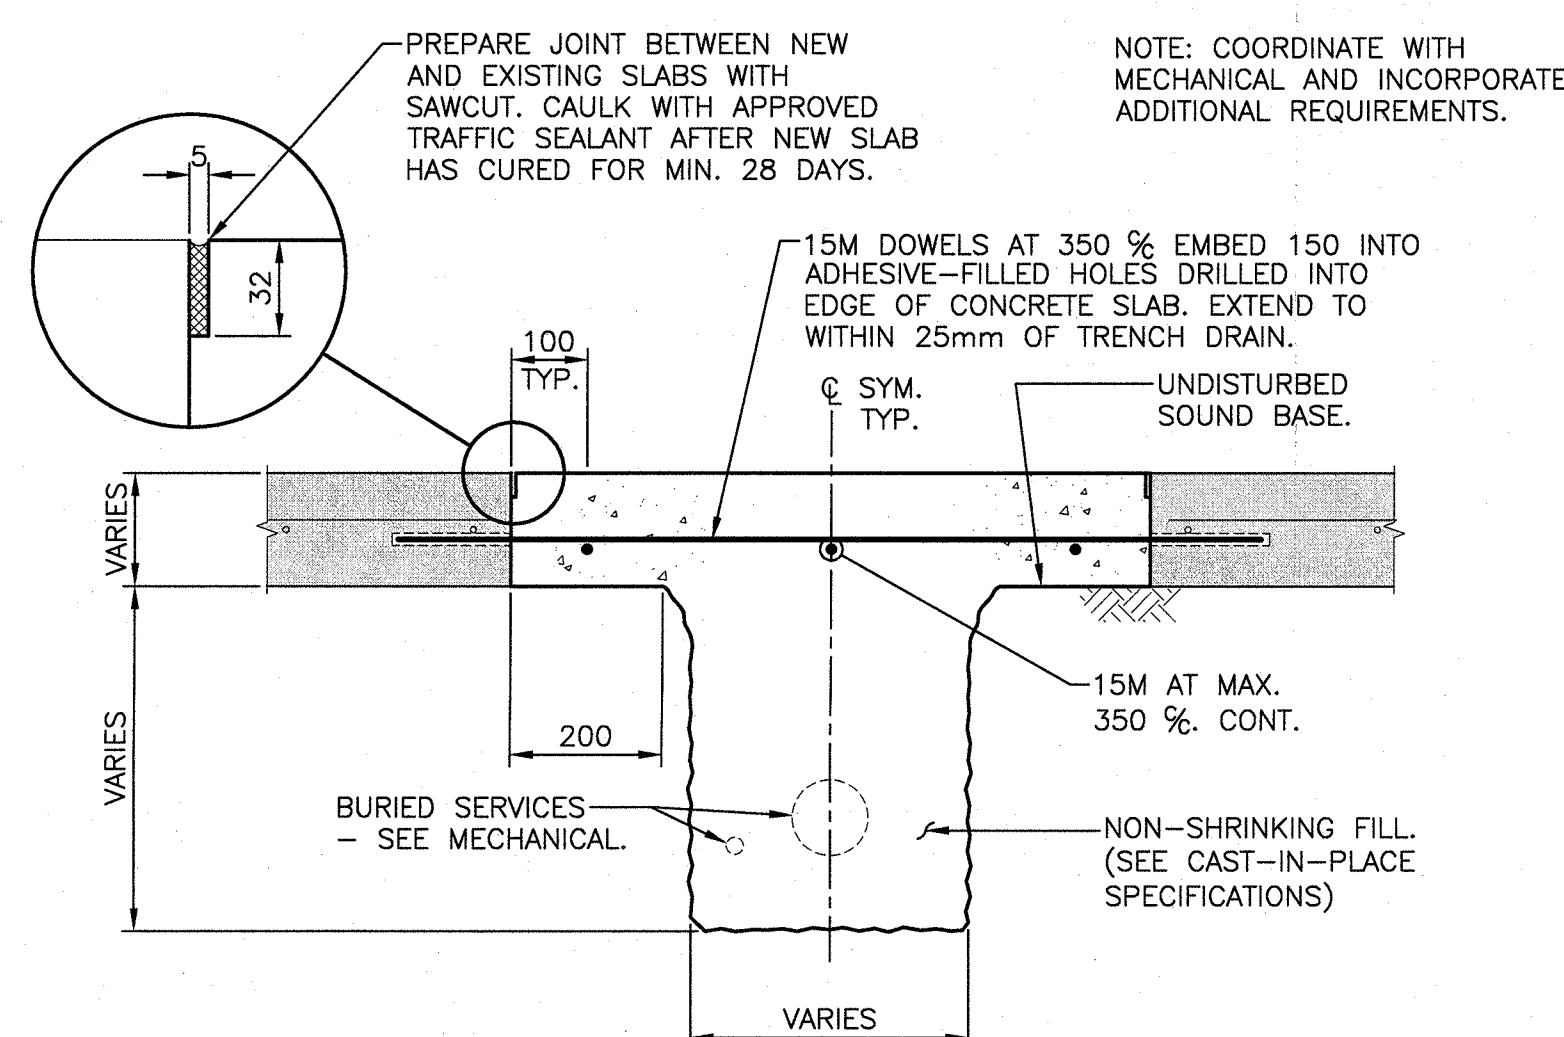


TYPICAL CONCRETE SLAB INFILL AT TRENCH

SCALE/ÉCHELLE: 1:10
0m 100 200 300 400 500 600 700 800 900 1000mm

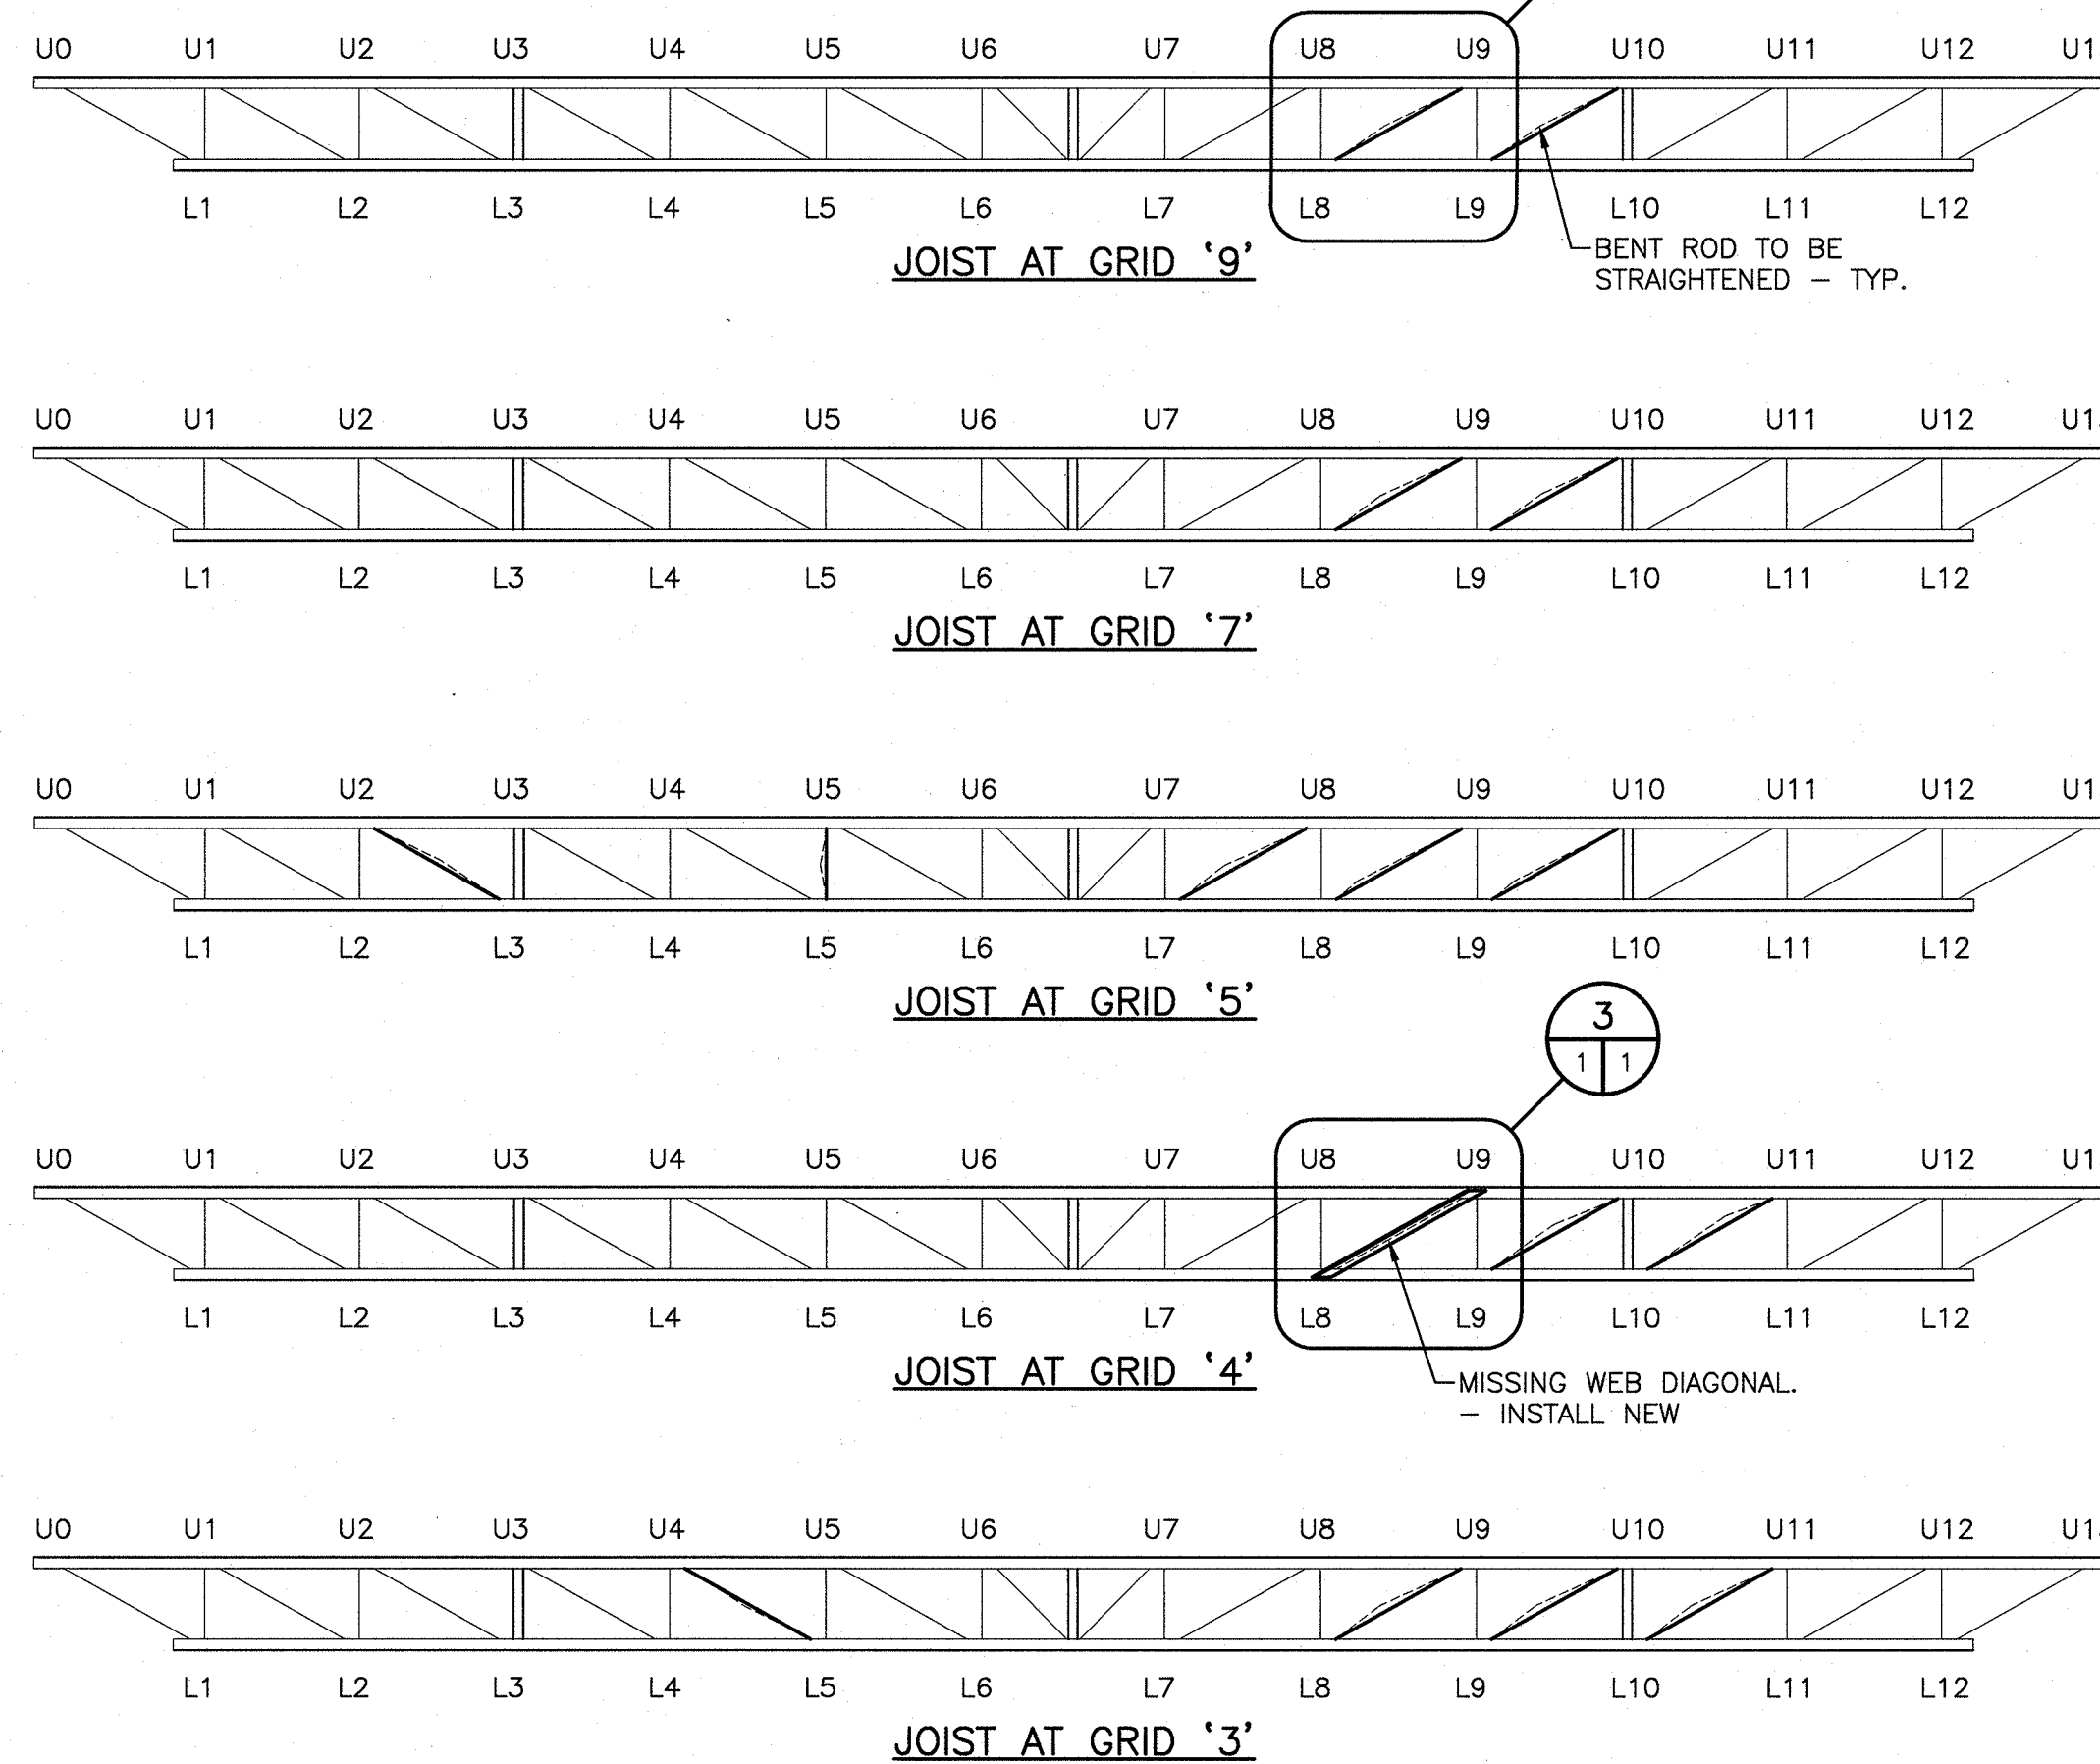


ROOF O.W.S.J. MEMBERS TO BE REPAIRED

SCALE/ÉCHELLE: 1:40
0m 1m 2m 3m 4m 5m

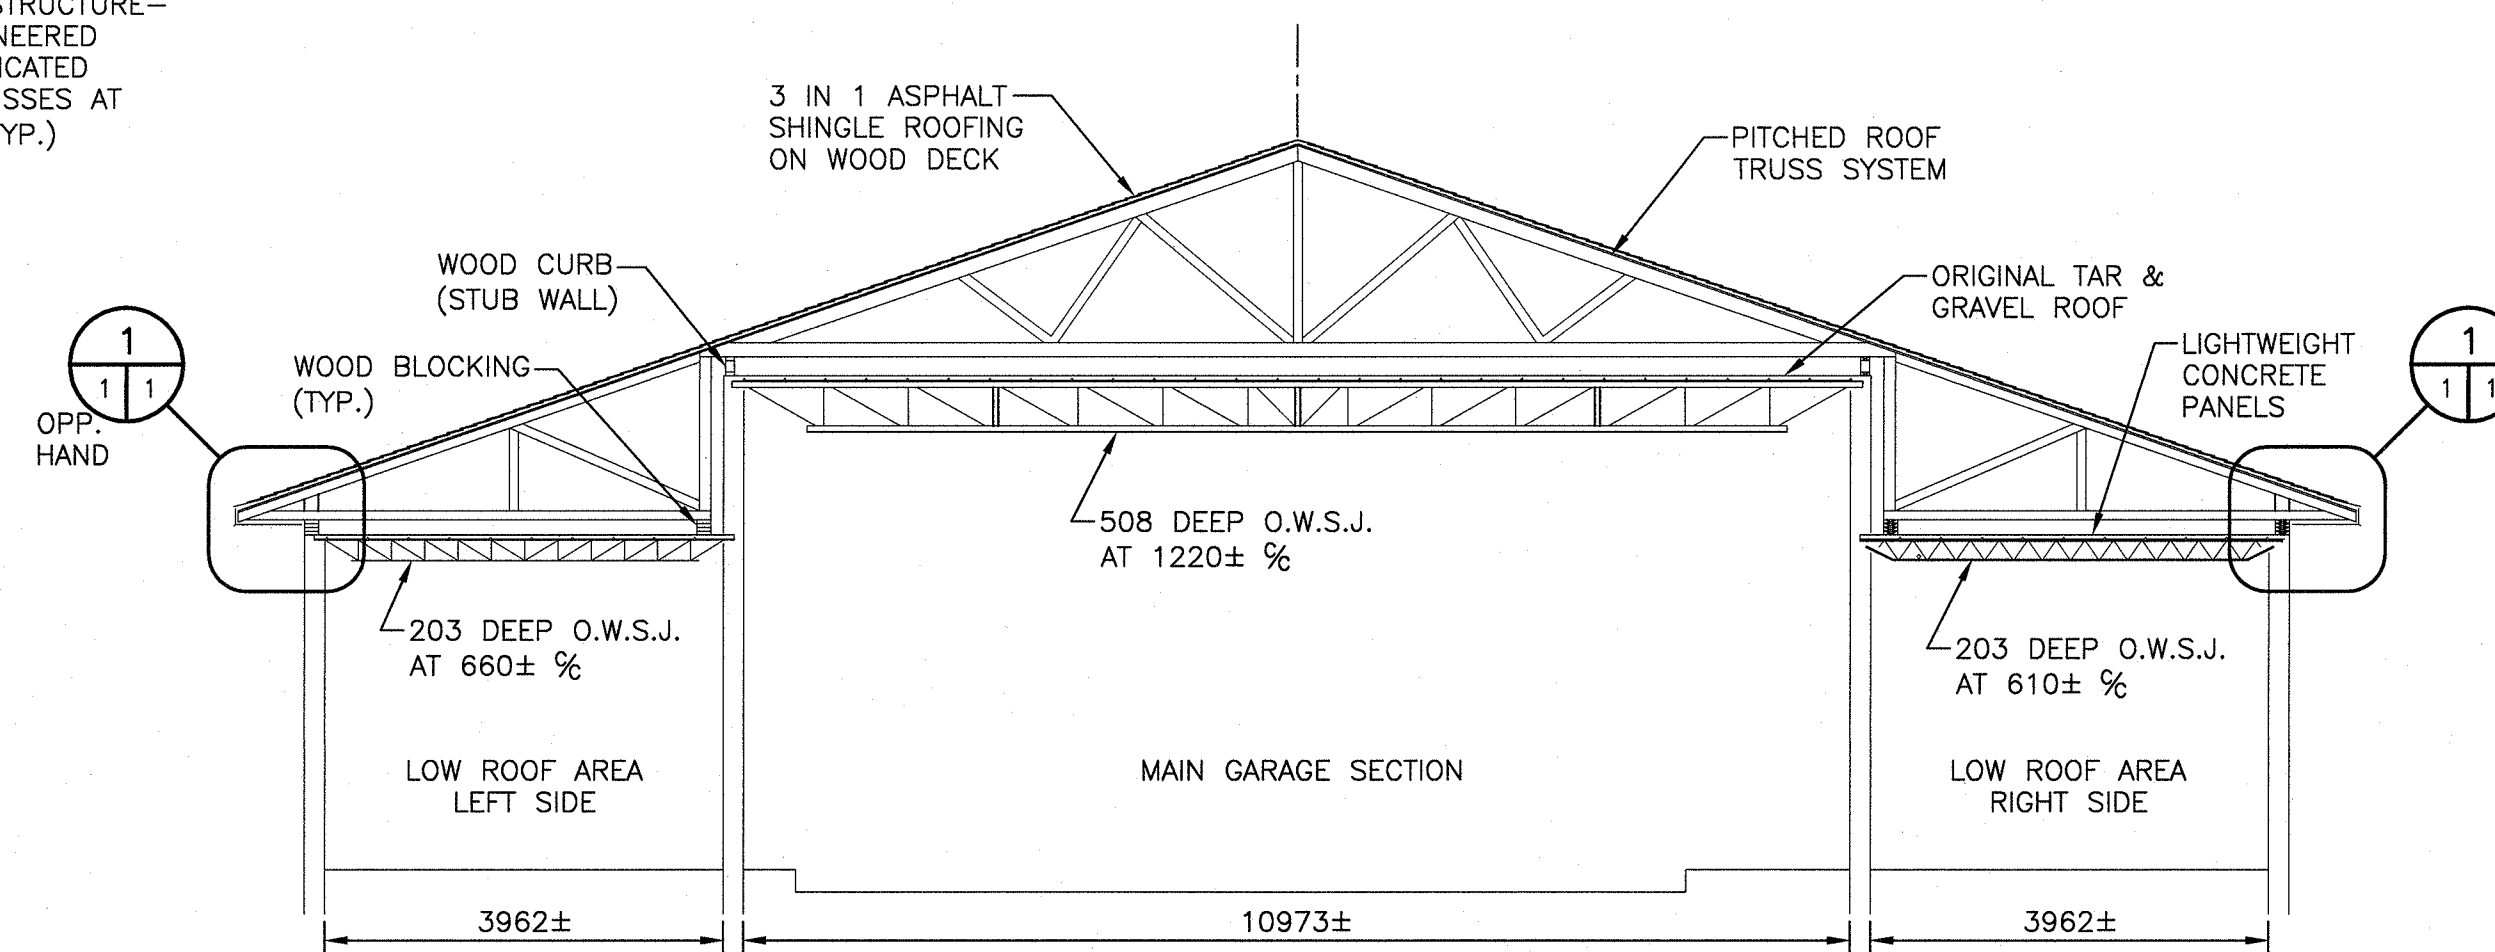


TYPICAL CROSS SECTION THRU ROOF

SCALE/ÉCHELLE: 1:75
0m 1m 2m 3m 4m 5m 6m 7m 8m 9m 10m

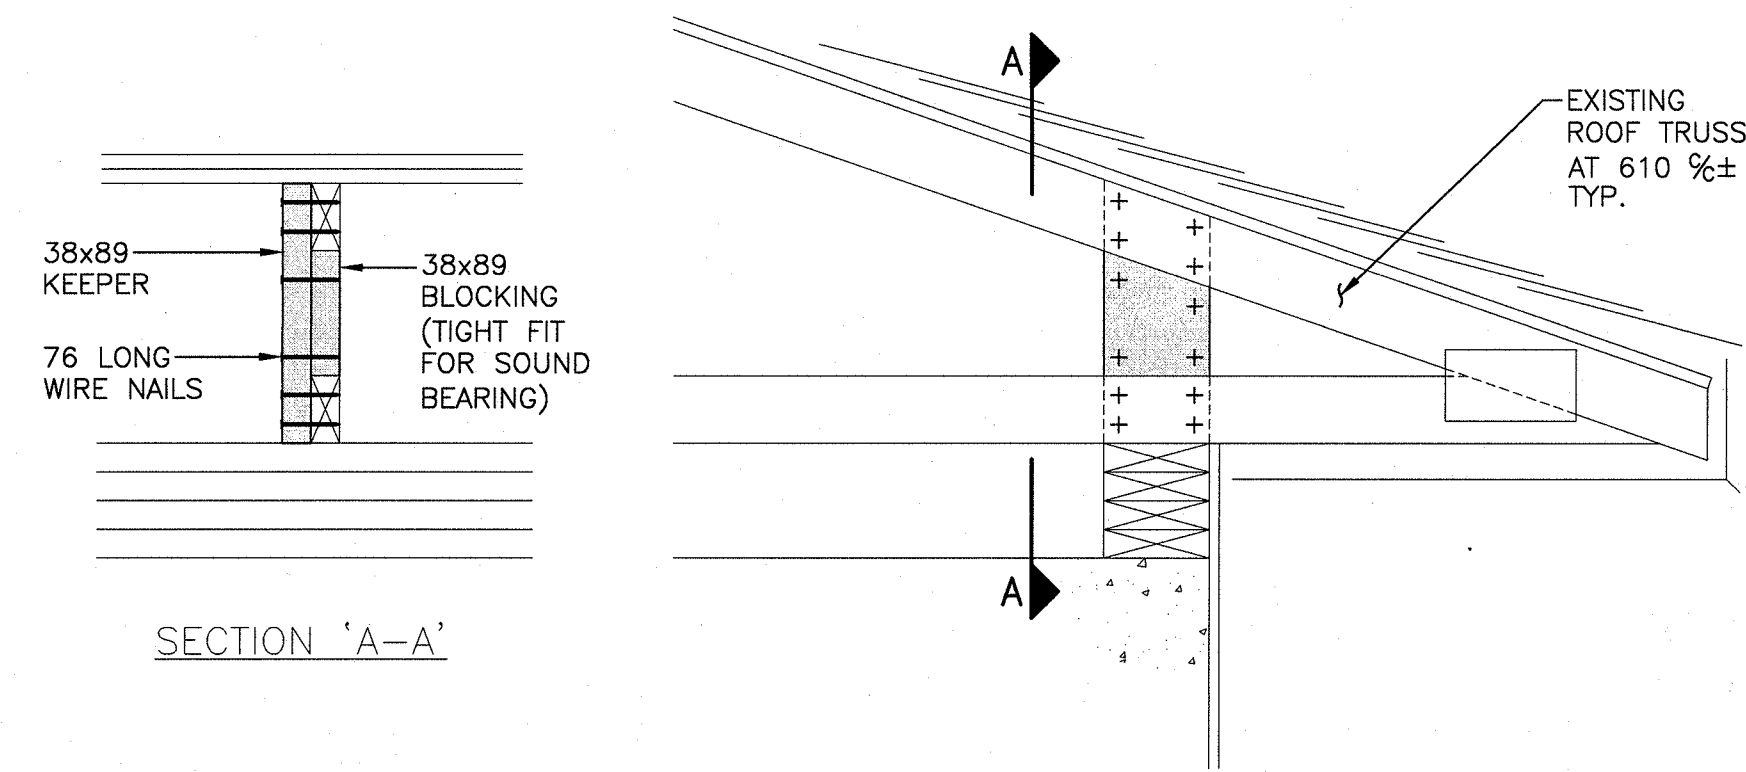


TRUSS BLOCKING DETAIL

SCALE/ÉCHELLE: 1:10
0m 100 200 300 400 500 600 700 800 900 1000mm

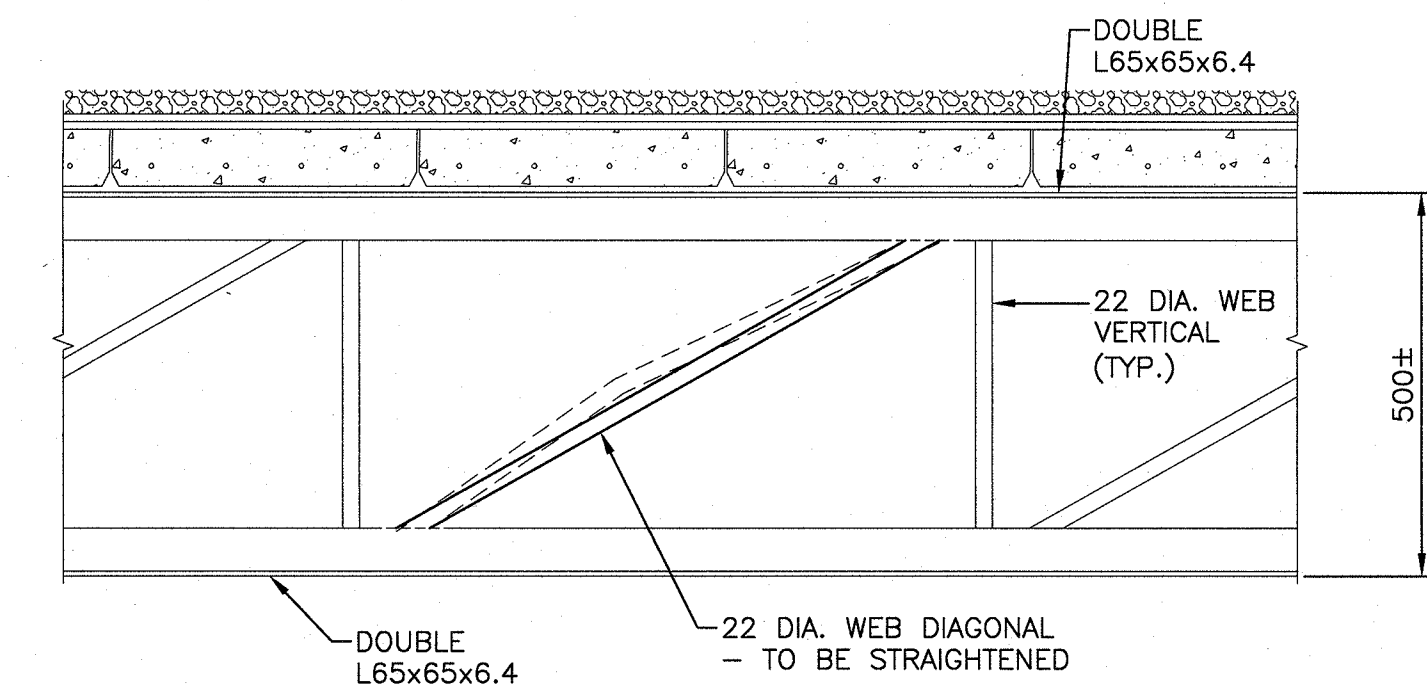


ROOF JOIST REPAIR

SCALE/ÉCHELLE: 1:10
0m 100 200 300 400 500 600 700 800 900 1000mm

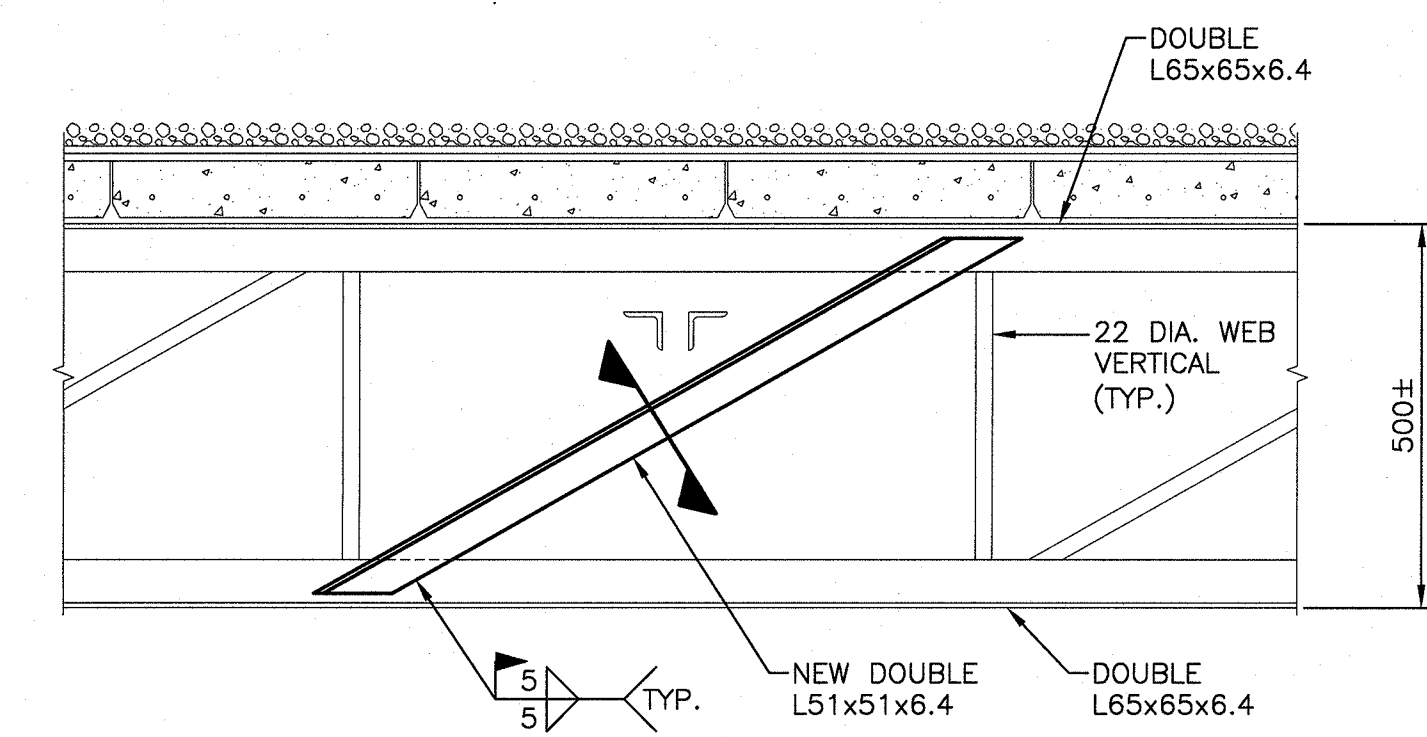


ROOF JOIST REPAIR

SCALE/ÉCHELLE: 1:10
0m 100 200 300 400 500 600 700 800 900 1000mm

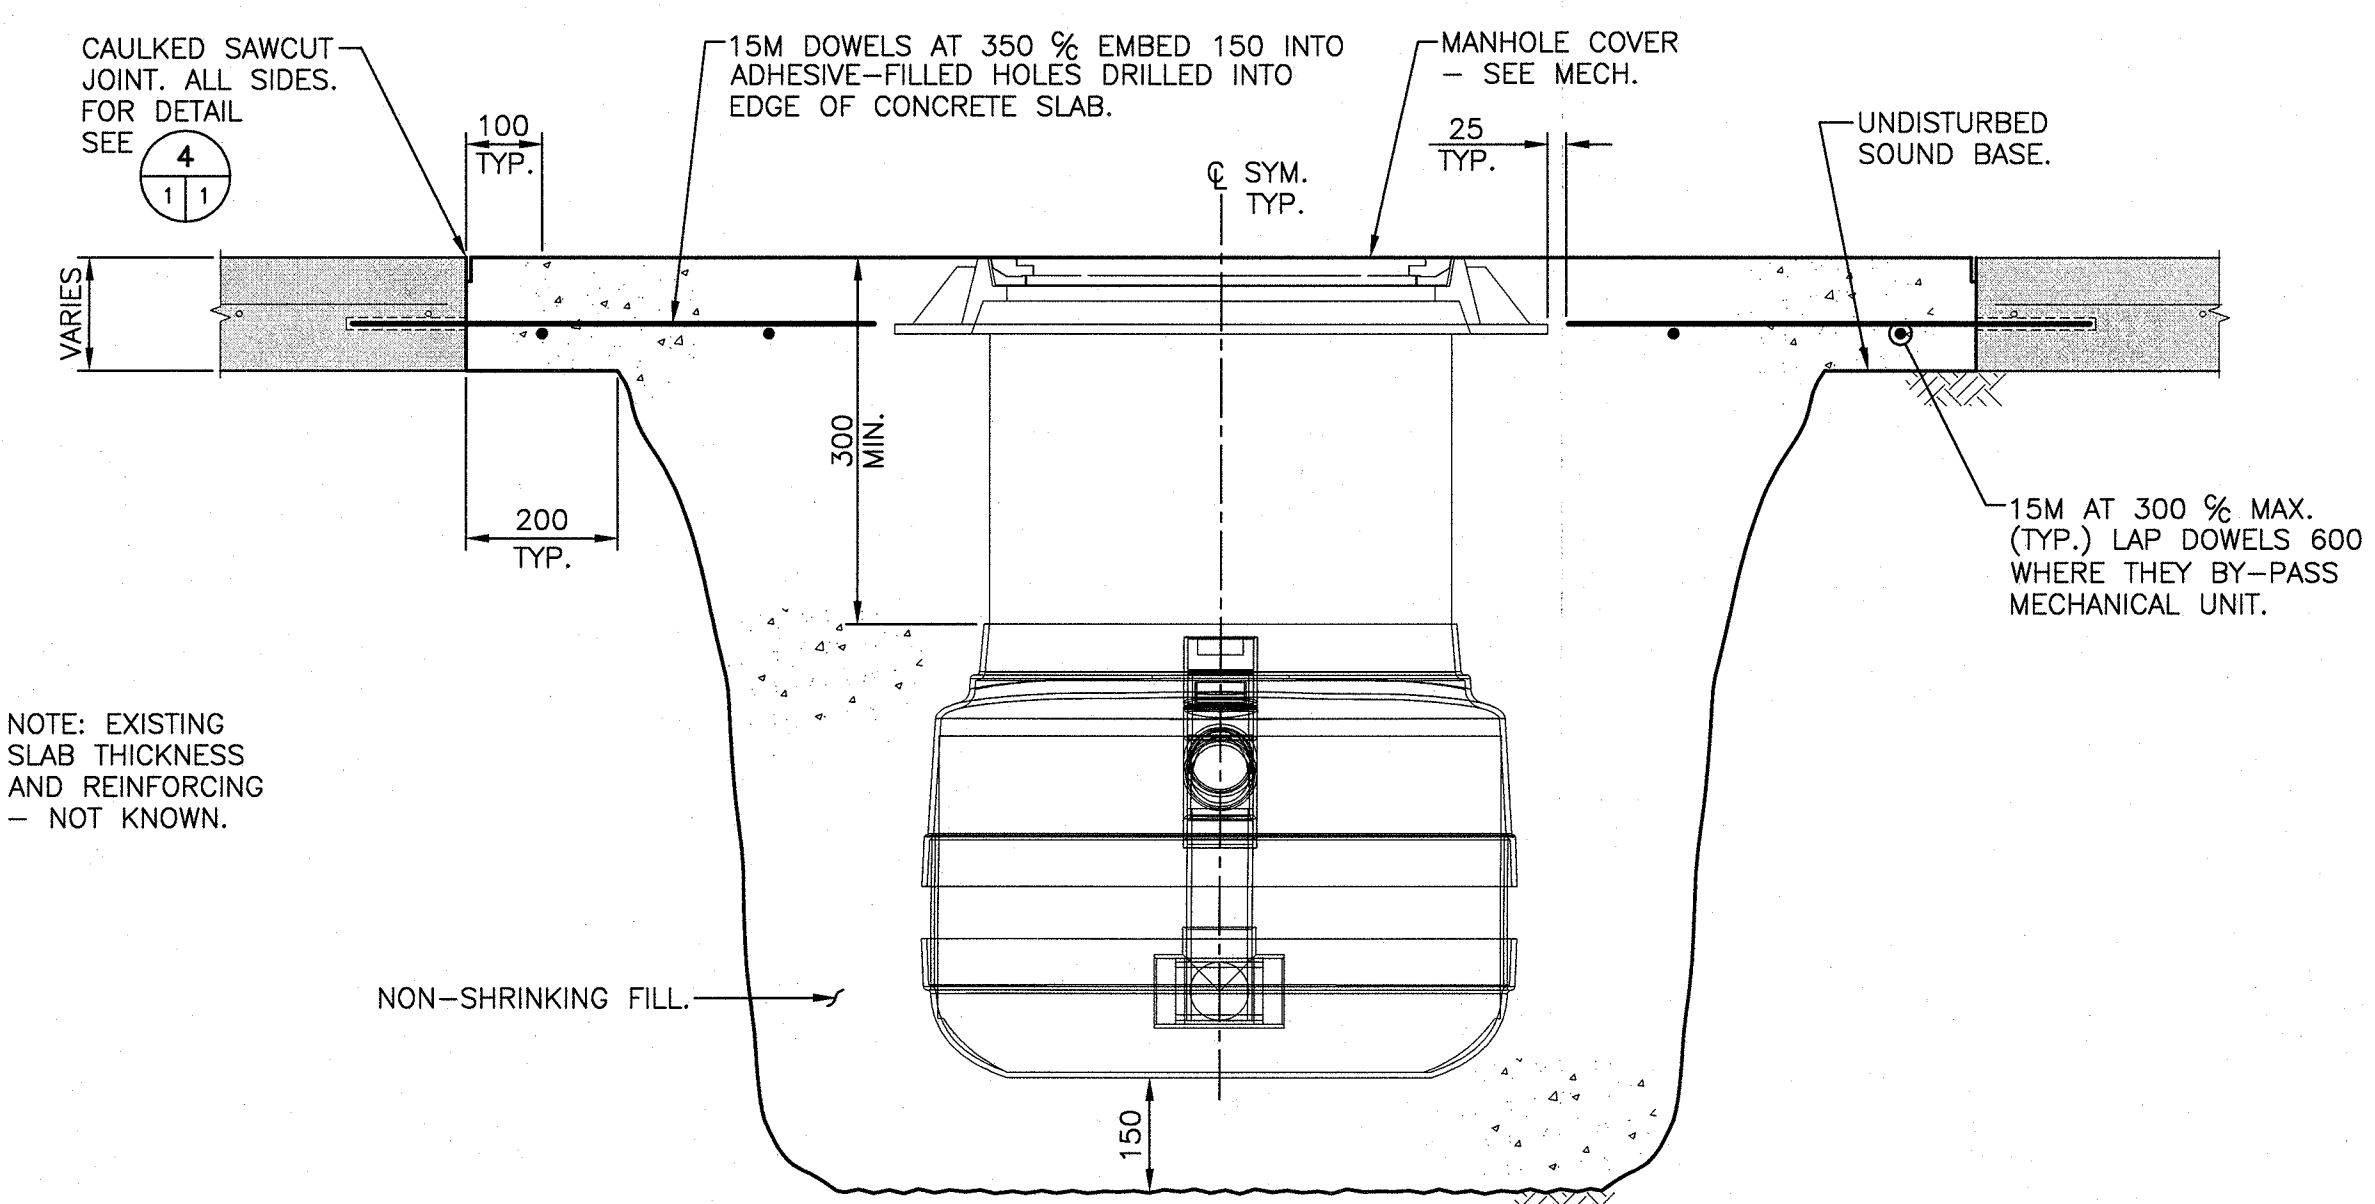

TYPICAL INFILL DETAIL AT OIL INTERCEPTOR

SCALE/ÉCHELLE: 1:10
0m 100 200 300 400 500 600 700 800 900 1000mm

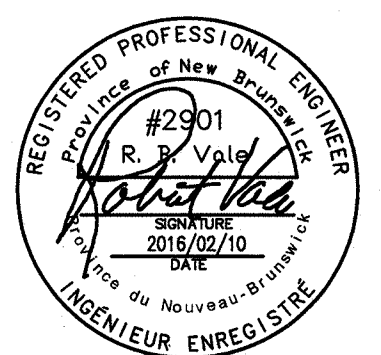

0	ISSUED FOR 100% REVIEW	FEB.19 2016
revisions		date

project
REPAIR & UPGRADE BUILDING 90 ATLANTIC INSTITUTION RENOUS RENOUS, NB

drawing
MISCELLANEOUS STRUCTURAL PLANS, SECTIONS AND DETAILS

designed RBV NOV. 2015
drawn RK NOV. 2015
approved JMC FEB. 2016
Tender 2016-04-05
Project Manager Administrateur de projets IPSC
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