TERRA NOVA NATIONAL PARK PARK HOUSING RECAPITALIZATION

ISSUED FOR TENDER MARCH 24, 2016

LIST OF DRAWINGS

ARCHITECTURAL:

A1 - EXISTING FLOOR PLAN HOUSE #5

A2 - RENOVATION DETAILS HOUSE #5

A3 - EXISTING FLOOR PLANS HOUSE #6 AND #7

A4 - RENOVATION DETAILS HOUSE #6 AND #7

A5 - EXISTING FLOOR PLANS HOUSE #8 AND #9

A6 - RENOVATION DETAILS HOUSE #8 AND #9

A7 - EXISTING FLOOR PLAN HOUSE #10

A8 - RENOVATION DETAILS HOUSE #10

A9 - SECTIONS, DETAILS, AND SCHEDULES

MECHANICAL:

M1 - HOUSE #5 AND #10 HEATING DEMOLITION,

NEW HEATING LAYOUT AND SCHEDULE

M2 - HOUSE #6, #7, #8 AND #9 HEATING

DEMOLITION, NEW HEATING LAYOUT AND SCHEDULE

M3 - MECHANICAL DETAILS


ELECTRICAL:


E1 - LEGEND AND GENERAL NOTES

E2 - HOUSE NO. 5 AND 10 - ELECTRICAL LAYOUTS

E3 - HOUSE NO. 6 AND 7 - ELECTRICAL LAYOUTS

E4 - HOUSE NO. 8 AND 9 - ELECTRICAL LAYOUTS

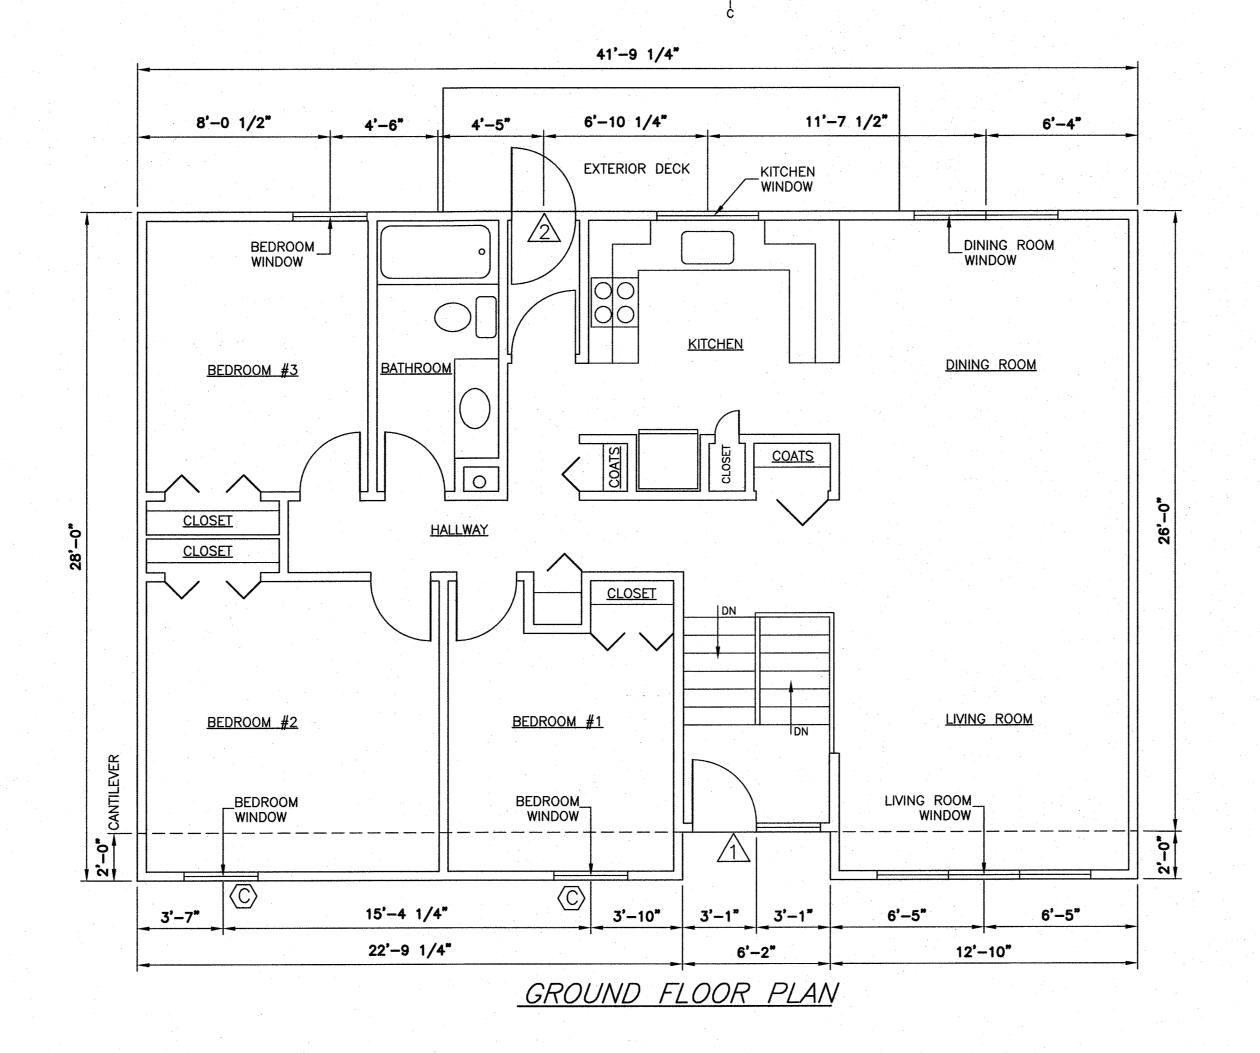

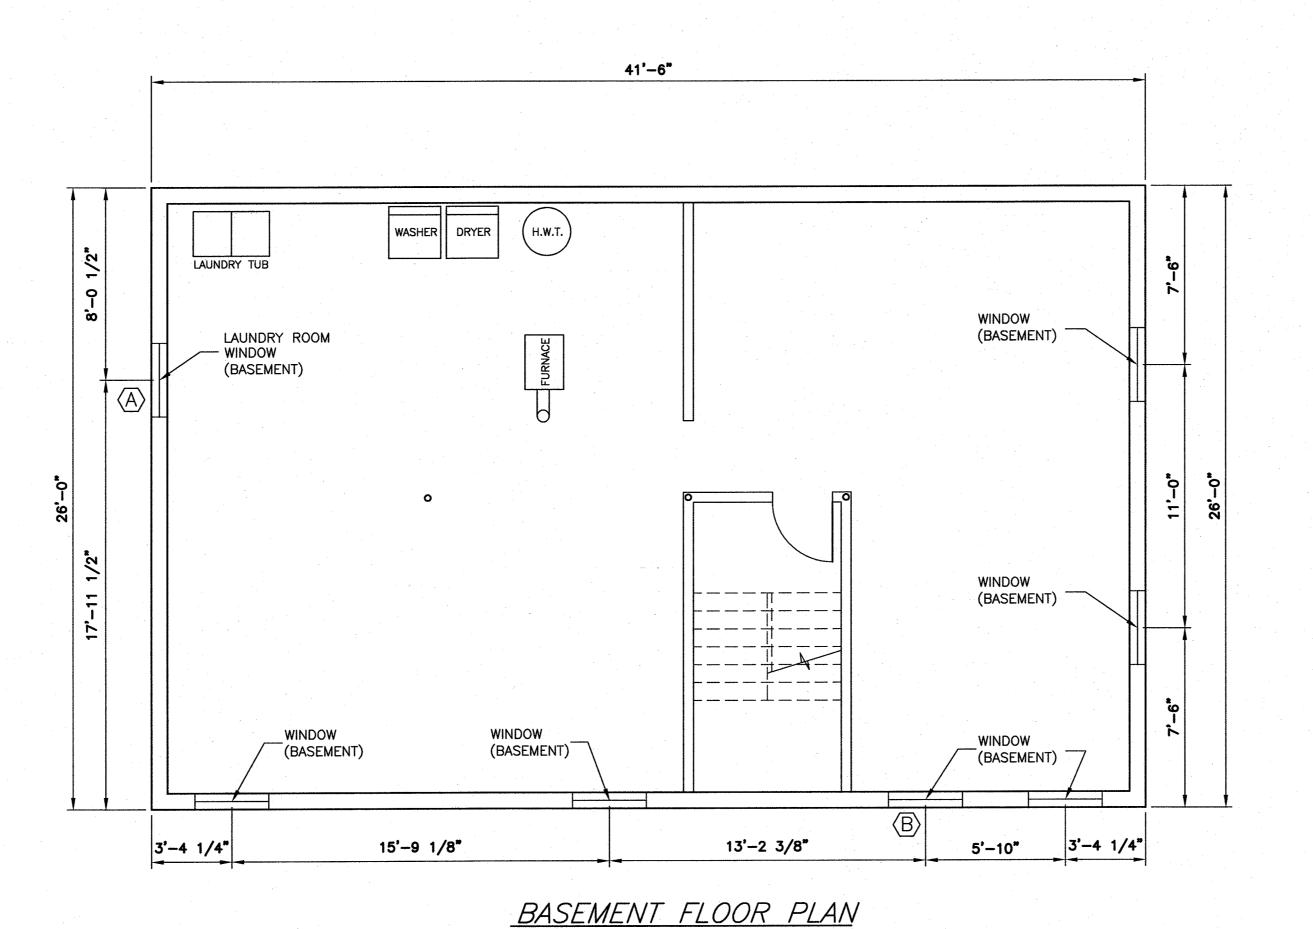

PWGSC A1

NOTES

1. DO NOT SCALE FROM DRAWINGS.

- 2. ALL DIMENSIONS IN INCHES AND FEET UNLESS OTHERWISE NOTED. CONTRACTOR TO VERIFY ALL DIMENSIONS ONSITE BEFORE PROCEEDING WITH ANY PORTION OF THE
- WORK. 3. DETAILS OF THE EXISTING STRUCTURE ARE SHOWN FOR INFORMATION PURPOSES ONLY. CONTRACTOR SHALL VISIT SITE AND REVIEW AND VERIFY THE EXTENT OF THE WORK SPECIFIED WITHIN THE CONTRACT
- 4. LOCATION OF PARTITION WALLS ARE APPROXIMATE ONLY AS FLOOR PLAN IS BASED ON ORIGINAL CONSTRUCTION. ANY POTENTIAL REVISIONS TO FLOOR PLAN ARE NOT REFLECTED, THEREFORE CONTRACTOR TO VERIFY ROOM DIMENSIONS.

LEGEND:

DOCUMENTS.

DOOR TYPE, SEE DOOR SCHEDULE ON SHEET A9

WINDOW TYPE, SEE WINDOW SCHEDULE ON SHEET A9

Public Works and Travaux Publics et Services gouvernementaux Canada



To practice Professional Engineering in Newfoundland and Labrador.

Permit No. as issued by PEG <u>N0453</u> which is valid for the year 2016



		ı
2	ISSUED FOR TENDER	16/03
1	ISSUED FOR 100% REVIEW	16/03
0	ISSUED FOR REVIEW	16/01
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A	A detail no. no. du detail	1	F	1
C	B location drawing sur dessin no. C drawing no. dessin no.	no.	В	C


TERRA NOVA NATIONAL PARK PARK HOUSING **RECAPITALIZATION**


EXISTING FLOOR PLAN HOUSE #5

	date	MARCH 2016	
	drawn	R.S.	dessine
	date	MARCH 2016	
	approve	d	approuve
	date		
.,	Tender		Soumission
	PWC Pro	oject Manager	Administrateur de projets TPC
٠,	project	number	no. du projet

PRO 000610

MERIDIAN PROJECT NO. CC15CRE082

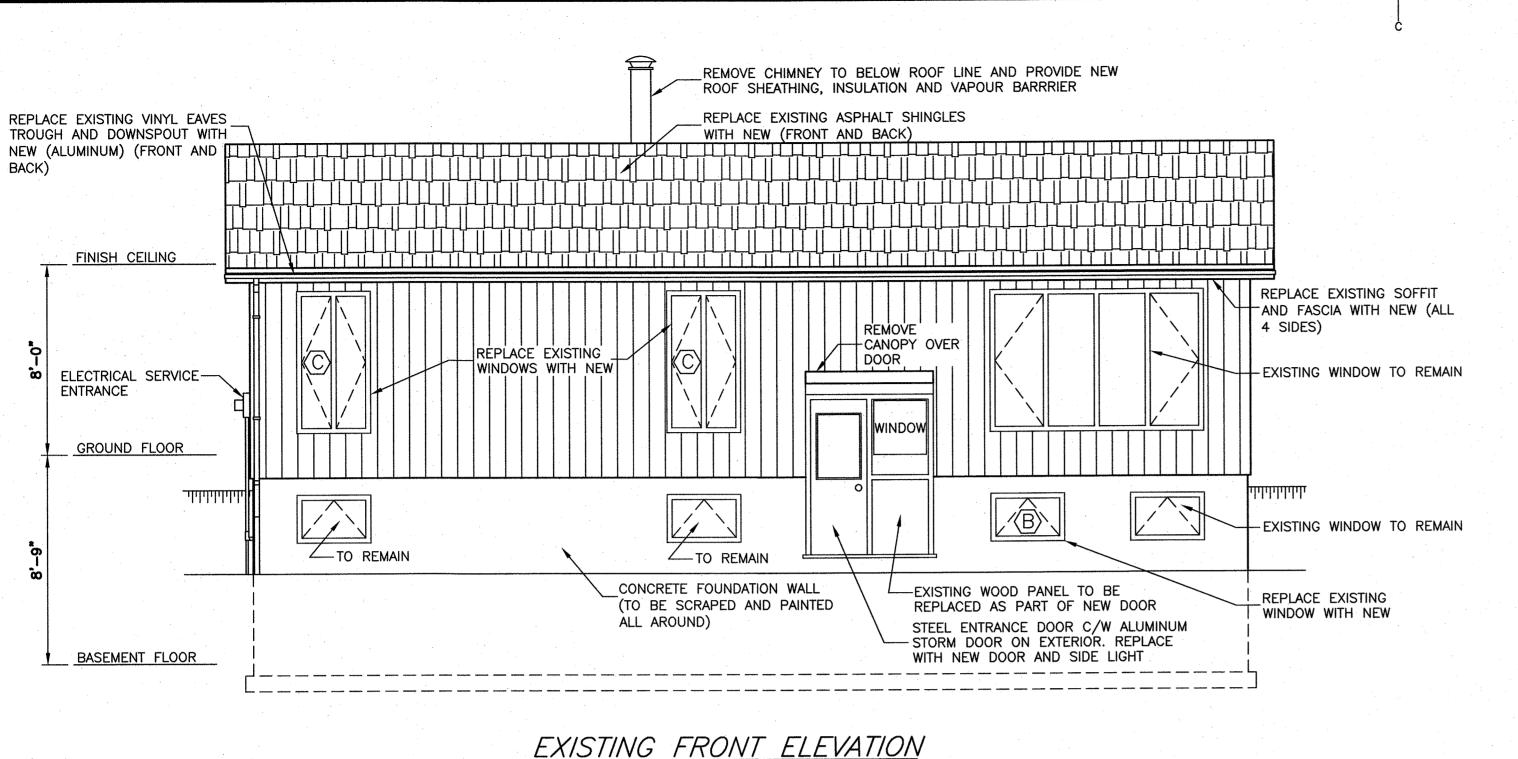

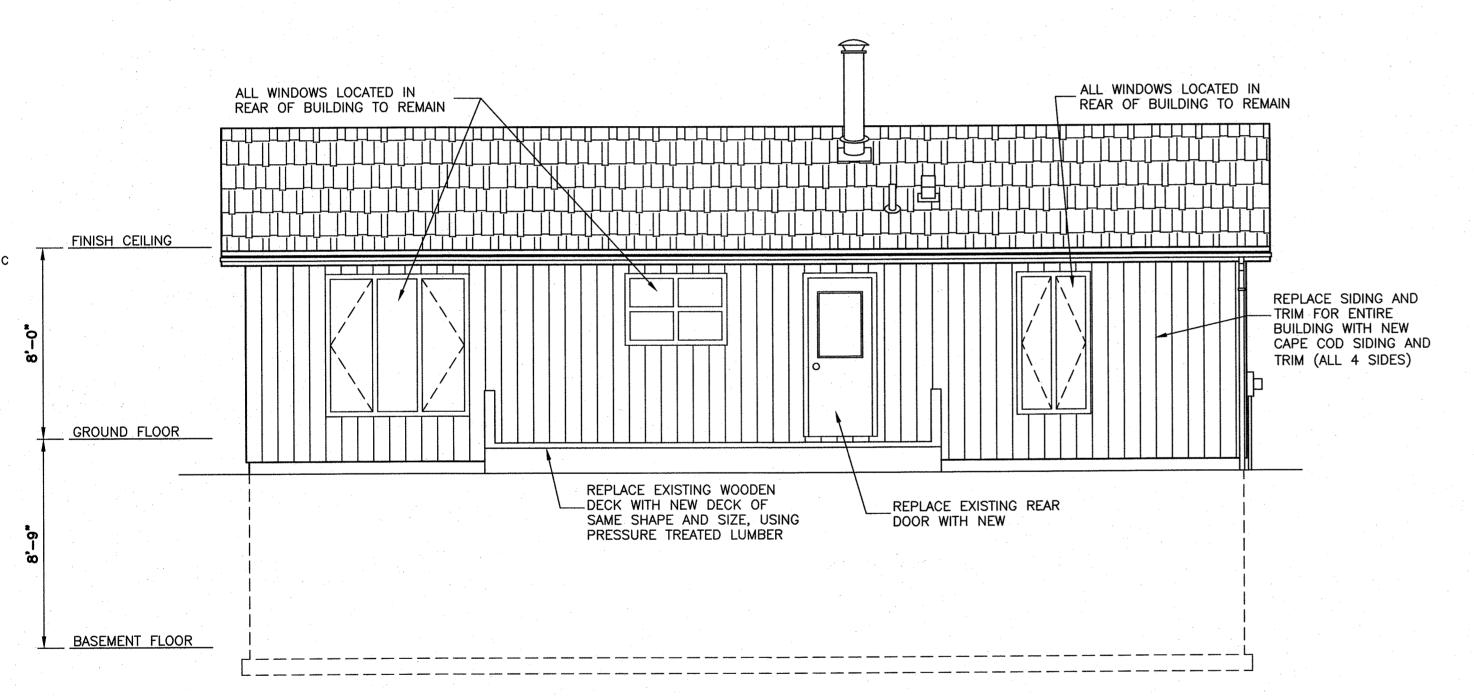


EXISTING REAR ELEVATION


NOTES

- 1. DO NOT SCALE FROM DRAWINGS.
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- 3. DETAILS OF THE EXISTING STRUCTURE ARE SHOWN FOR INFORMATION PURPOSES ONLY. CONTRACTOR SHALL VISIT SITE AND REVIEW AND VERIFY THE EXTENT OF THE WORK SPECIFIED WITHIN THE CONTRACT DOCUMENTS.
- 4. CONTRACTOR TO MAKE ADEQUATE PROVISIONS FOR CONSTRUCTION STRESSES, WEATHER PROTECTION AND FOR TEMPORARY BRACING AND SHORING TO KEEP THE STRUCTURE PLUMB AND LEVEL DURING ALL PHASES OF WORK.
- 5. EXISTING BUILDING COMPONENTS TO BE REMOVED AND REPLACED AS INDICATED ON THE DRAWINGS.
- 6. COORDINATE WITH OWNER TEMPORARY RELOCATION OF MATERIALS AND EQUIPMENT LOCATED INSIDE STRUCTURE. CONTRACTOR TO REMOVE/RELOCATE BUILDING CONTENTS AS DIRECTED BY OWNER'S REPRESENTATIVE.

- 7. ALL MATERIALS AND CONSTRUCTION METHODS SHALL BE IN ACCORDANCE WITH THE NATIONAL BUILDING CODE OF CANADA, LATEST EDITION, AND CSA 086.1, LATEST EDITION.
- 8. PROVIDE ALL NECESSARY TRIM AND FINISH FOR ALL DOORS, WINDOW OPENINGS, PATCH WORK, ETC.
- INSTALL NEW EXTERIOR VENTS AS REQUIRED BY MECHANICAL SYSTEMS. COORDINATE THIS WORK WITH INSTALLATION OF NEW SIDING.
- 10. CONTRACTOR TO VERIFY DIMENSIONS OF WINDOWS AND DOORS DEEMED FOR REPLACEMENT PRIOR TO FINALIZING ORDER WITH SUPPLIER. DIMENSIONS SHOWN AND REFERENCED IN DOOR SCHEDULE ARE APPROXIMATE ONLY, AND NOT TO BE TAKEN AS FINAL.
- 11. IF DURING REMOVAL OF SIDING, WINDOWS, SHINGLES, OR ANY OTHER BUILDING COMPONENT RESULTS IN DISCOVERY OF ROT, CONTRACTOR TO CONTACT OWNER'S REPRESENTATIVE TO DETERMINE IF SHEATHING SHALL BE REPLACED PRIOR TO COVERING UP.

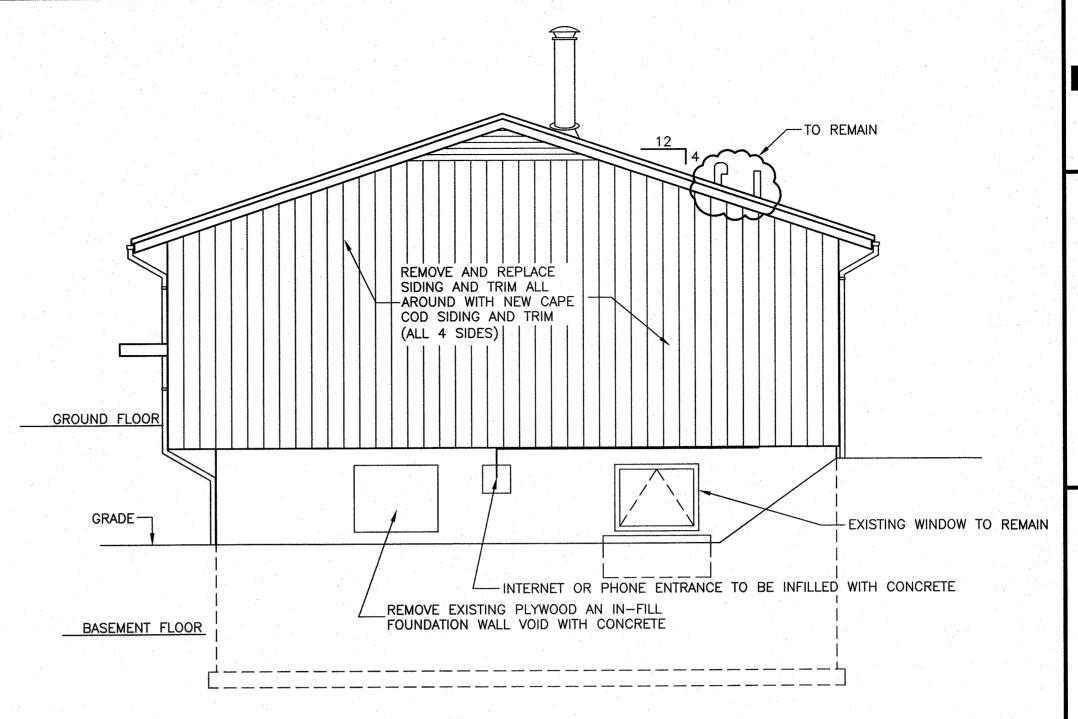

EXISTING RIGHT SIDE ELEVATION

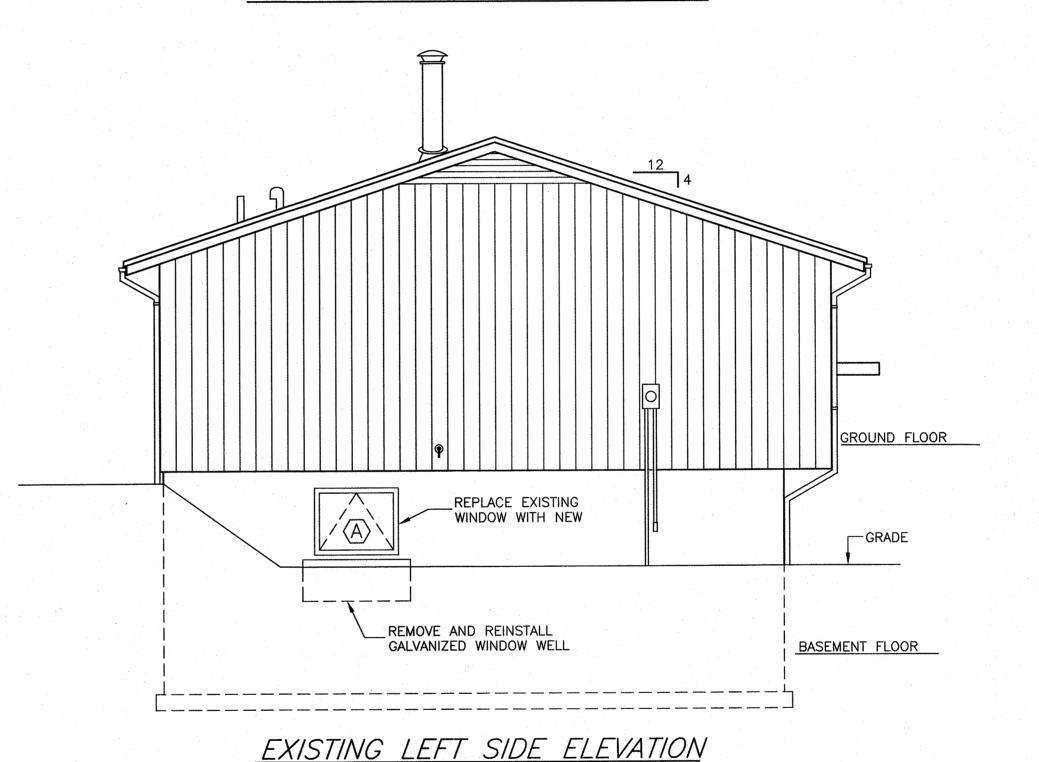

LEGEND:

DOOR TYPE, SEE DOOR
SCHEDULE ON SHEET A9
WINDOW TYPE, SEE WINDOW
SCHEDULE ON SHEET A9

Public Works and Travaux Publics et Services gouvernementaux Canada

PROVINCE OF NEWFOUNDLAND AND LABRADOR
PERMIT HOLDER
And Labrador
This Permit Allows

Meridian Engineering Inc.

To practice Professional Engineering in Newfoundland and Labrador.

Permit No. as issued by PEG N0453

which is valid for the year 2016



2 ISSUED FOR TENDER 16/03/2
1 ISSUED FOR 100% REVIEW 16/03/0
0 ISSUED FOR REVIEW 16/01/2
revisions date

A detail no.
no. du detail

B location drawing no.
sur dessin no.

C drawing no.
dessin no.

TERRA NOVA NATIONAL PARK

projet

project

drawing

PARK
PARK HOUSING
RECAPITALIZATION

RENOVATION DETAILS HOUSE #5

designed J.S. concu
date MARCH 2016
drawn R.S. dessine
date MARCH 2016
approved approuve

Tender Soumission

PWC Project Manager Administrateur de projets TPC

project number no. du projet


PRO 000610


TIDIS Document No. Not in System


A-2


MERIDIAN PROJECT NO. CC15CRE082


PWGSC A1

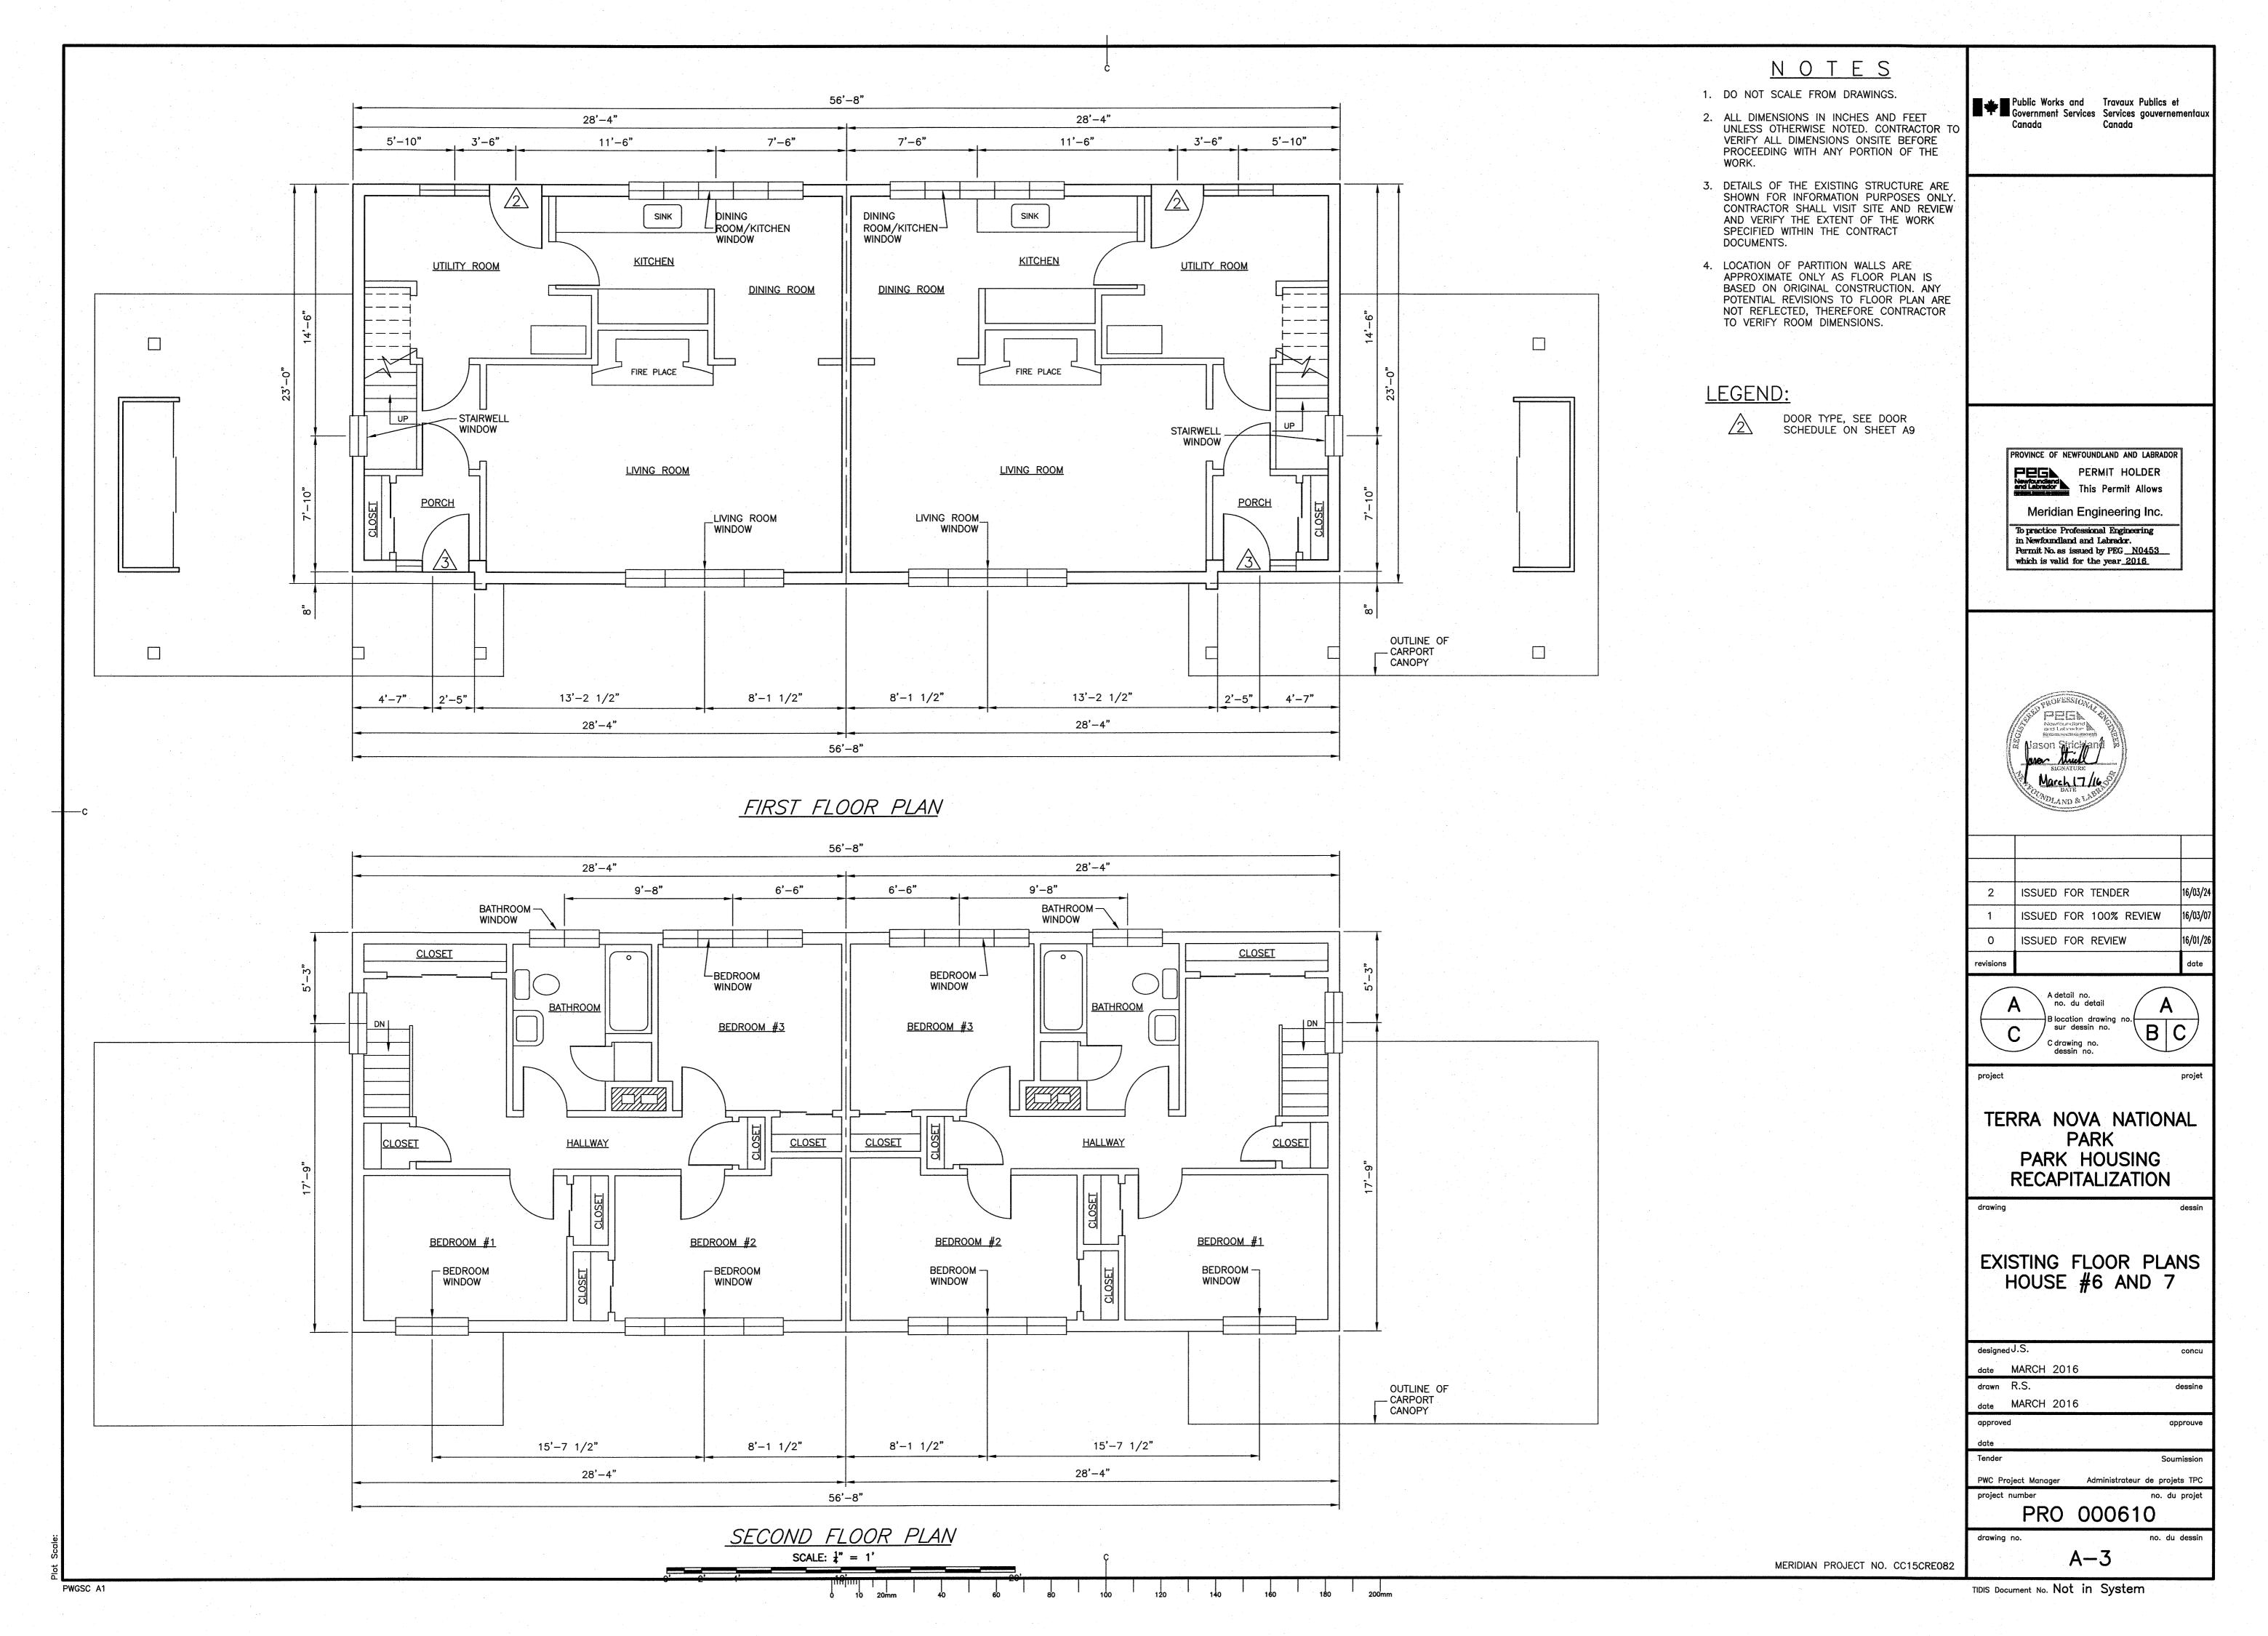

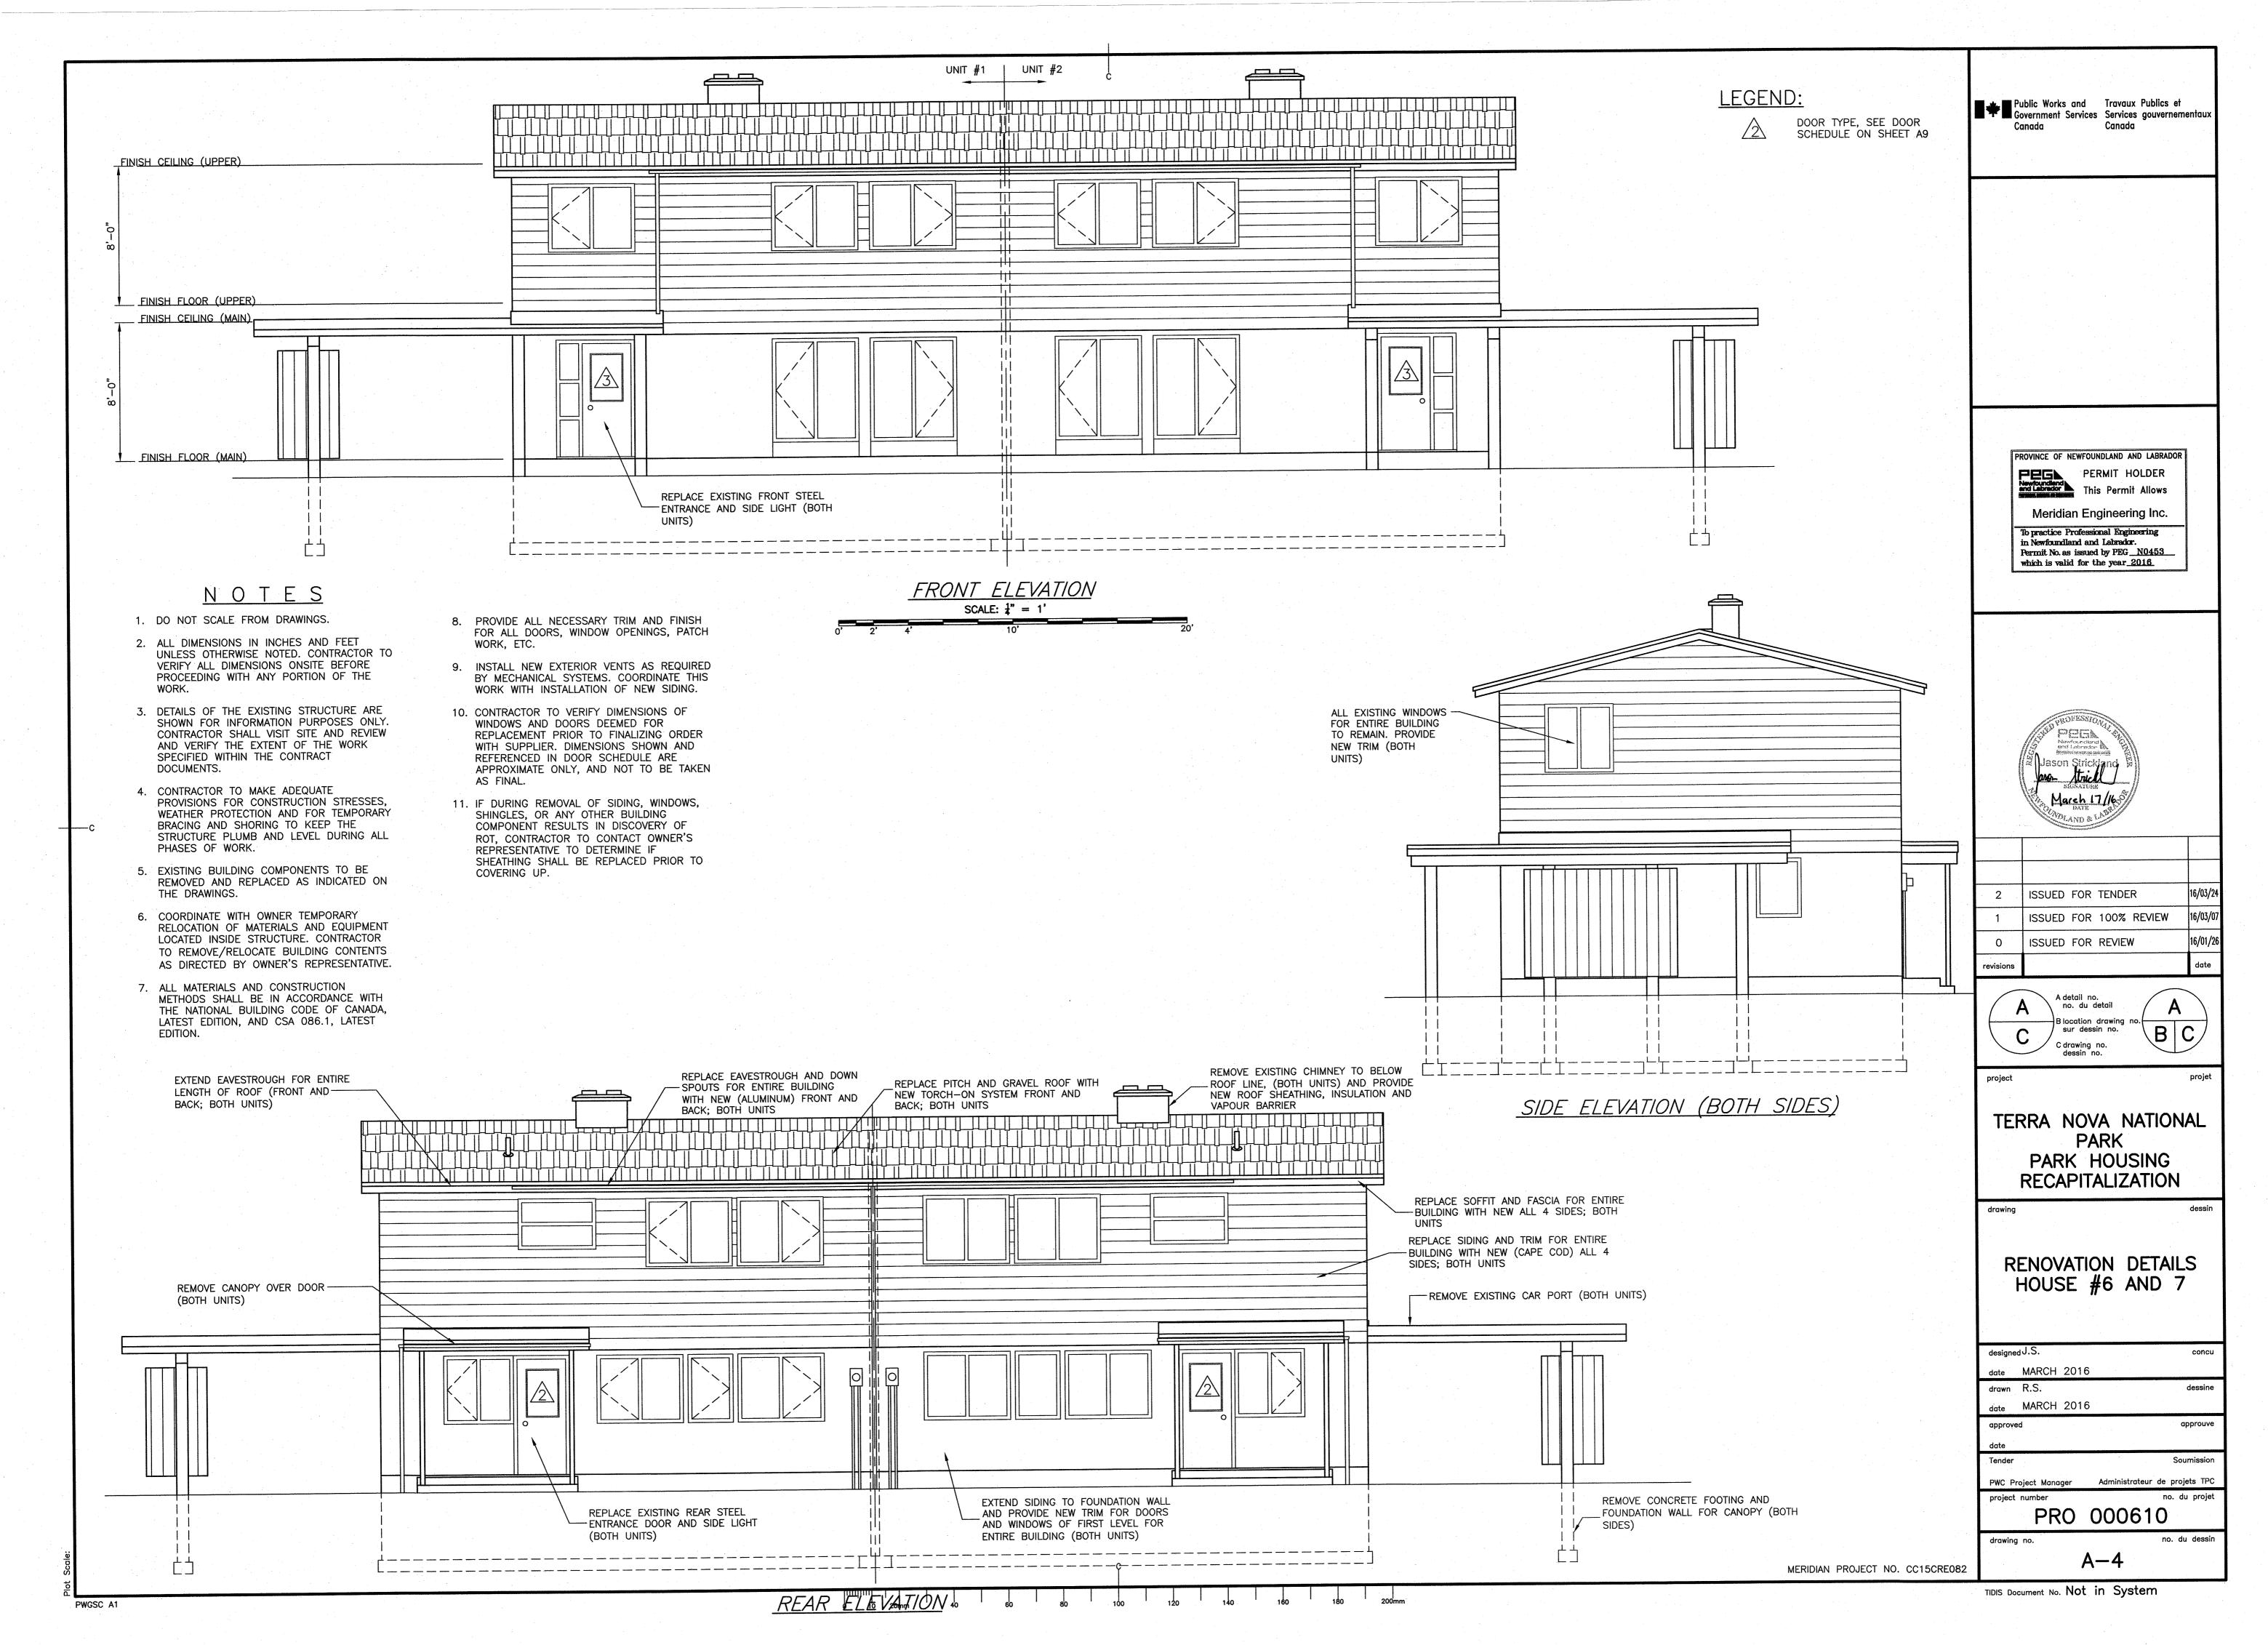


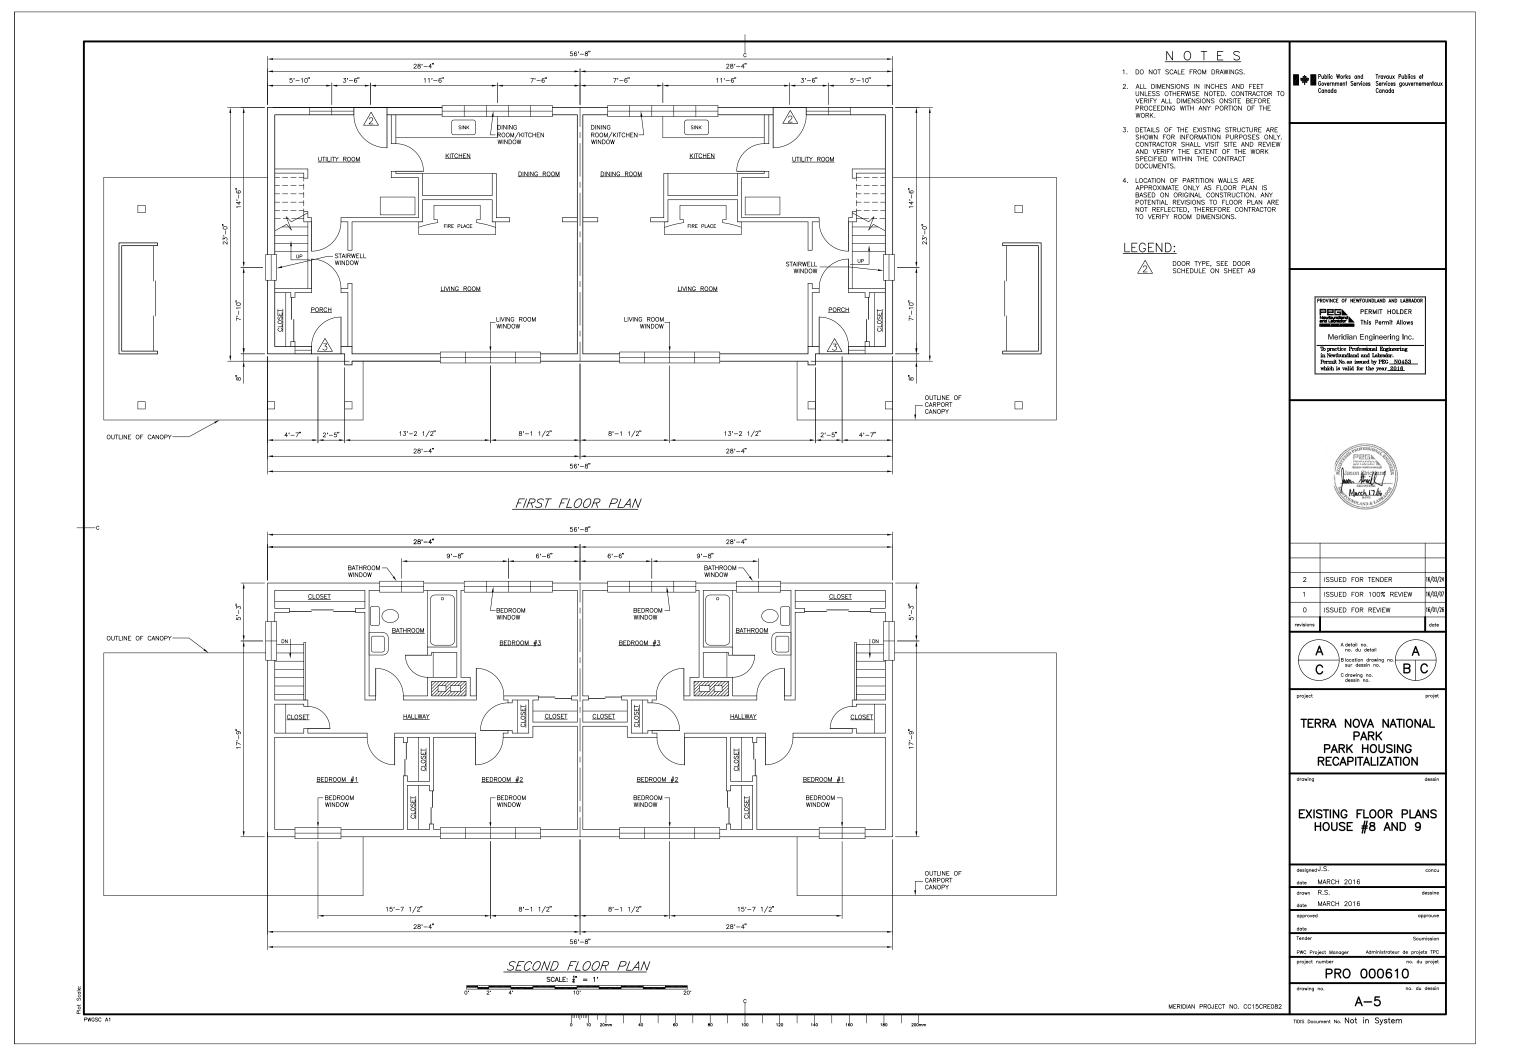


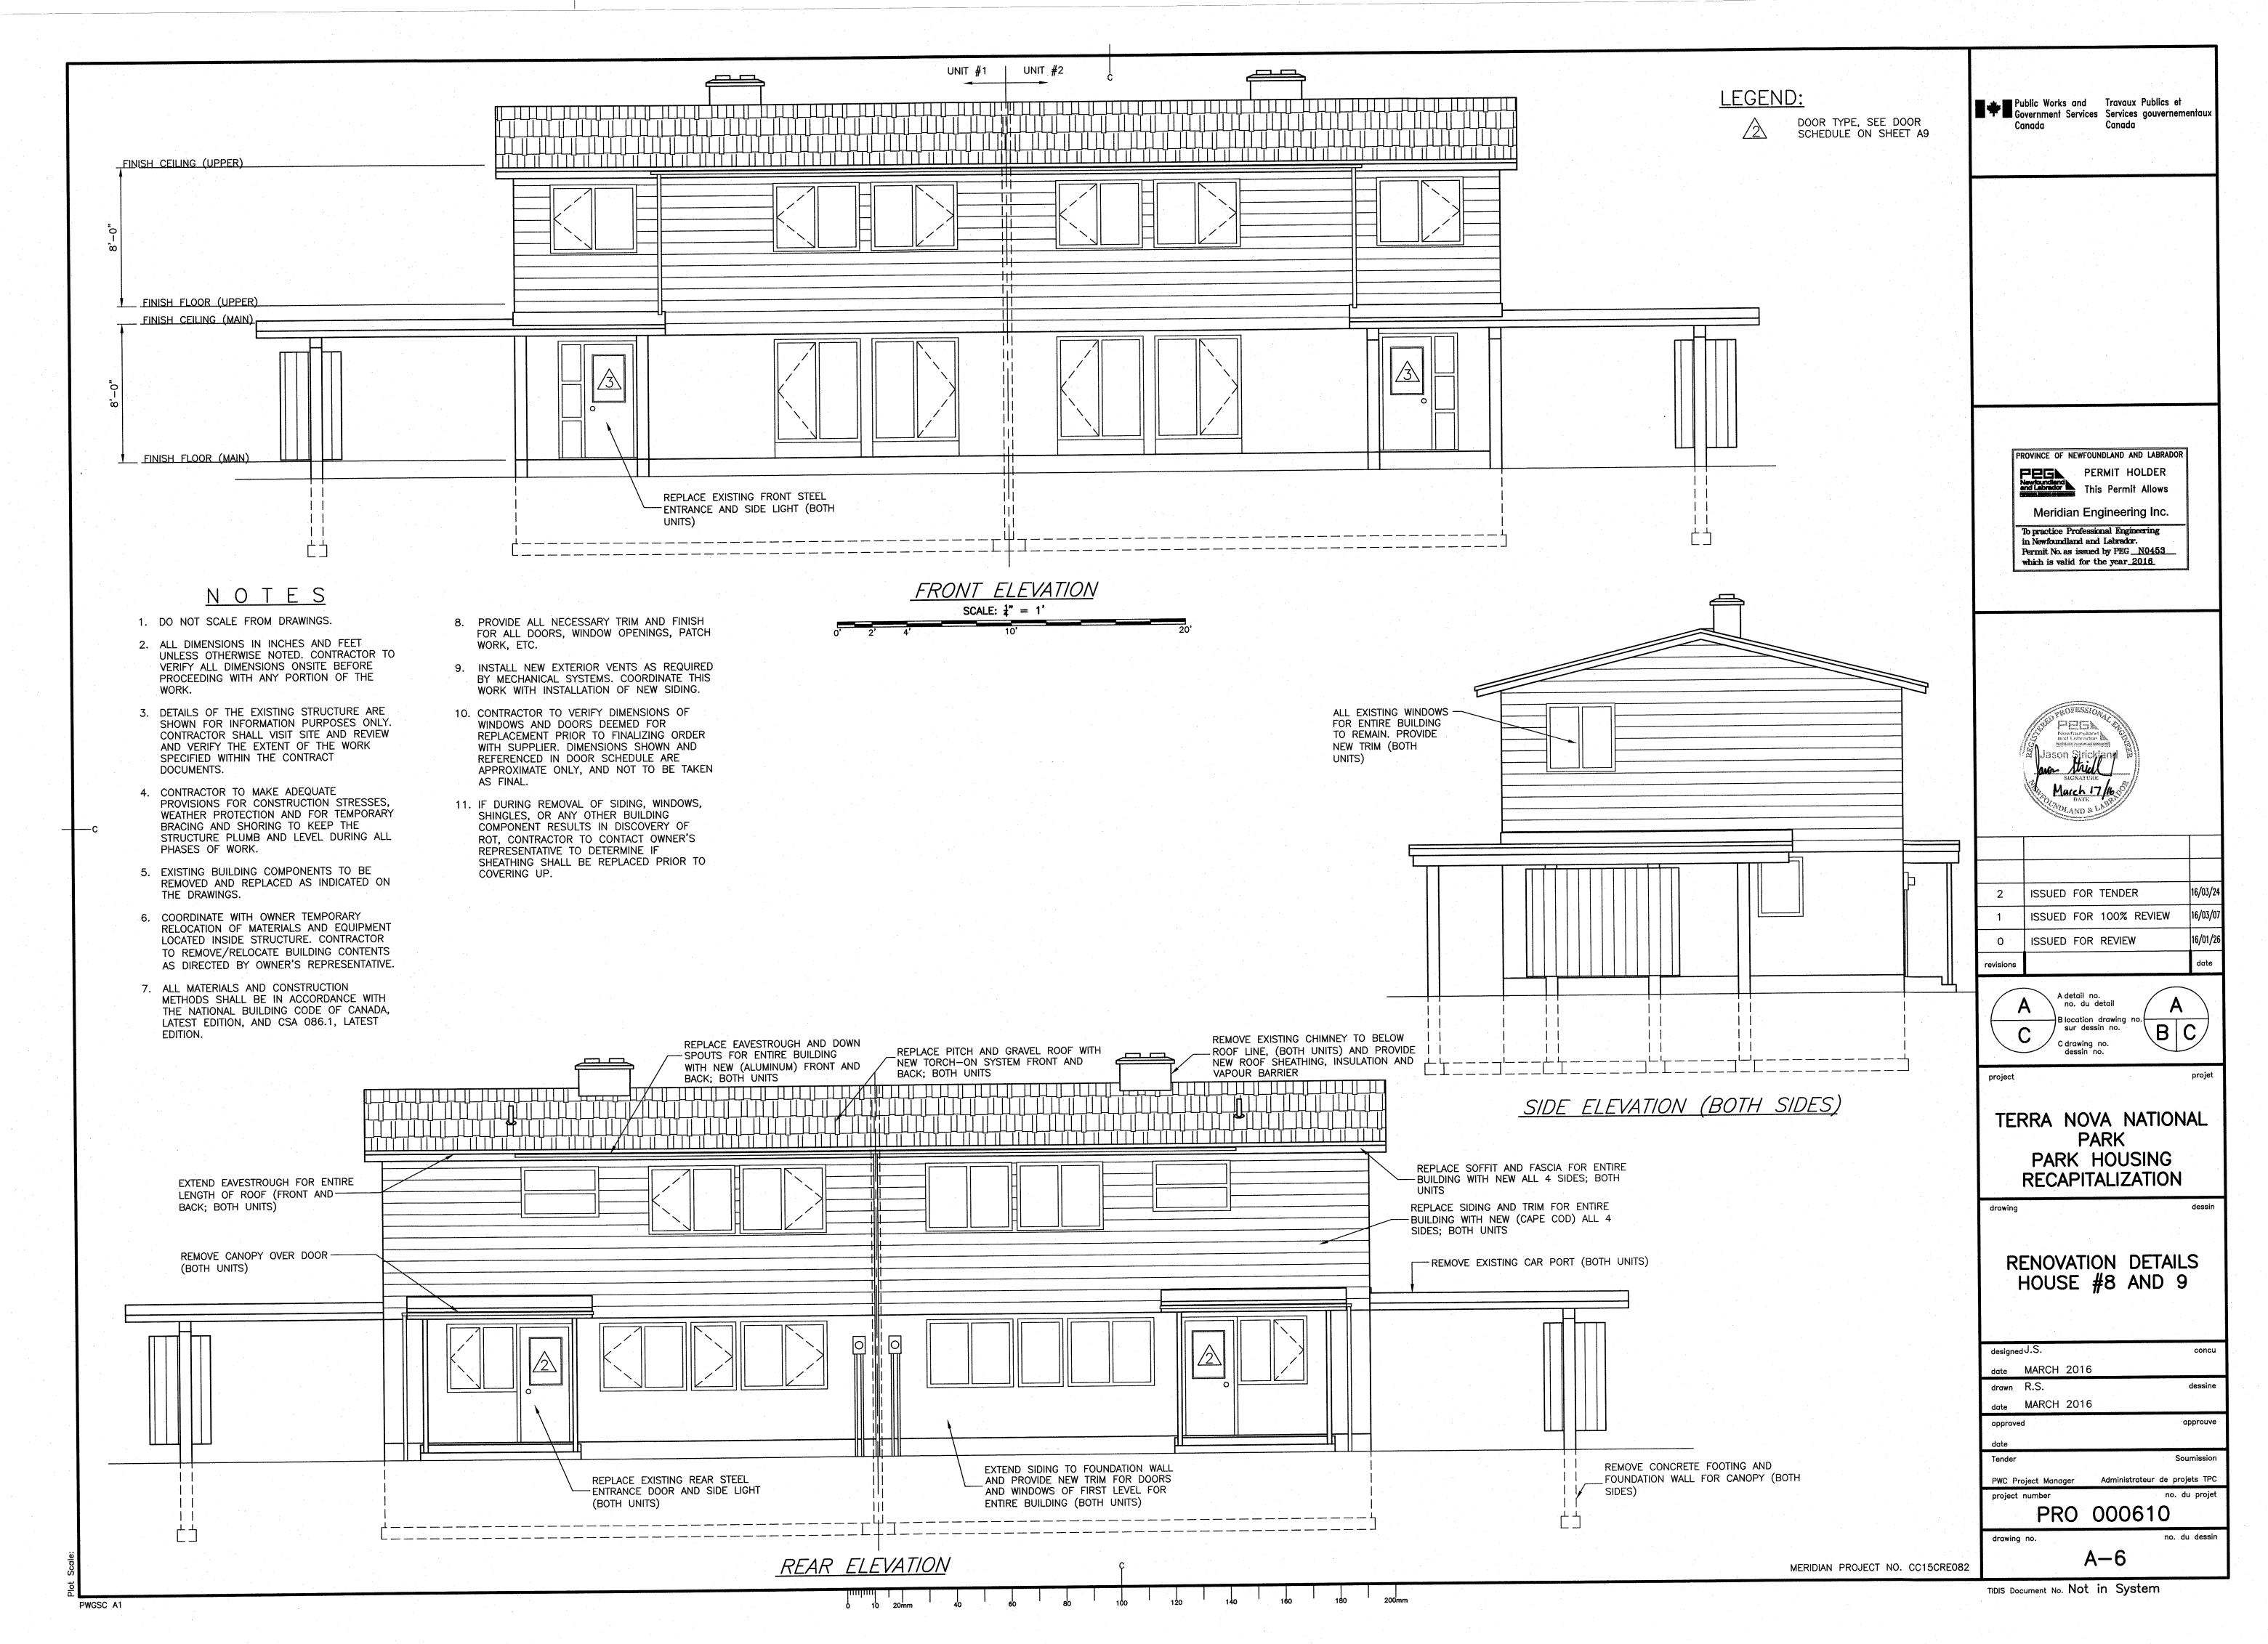


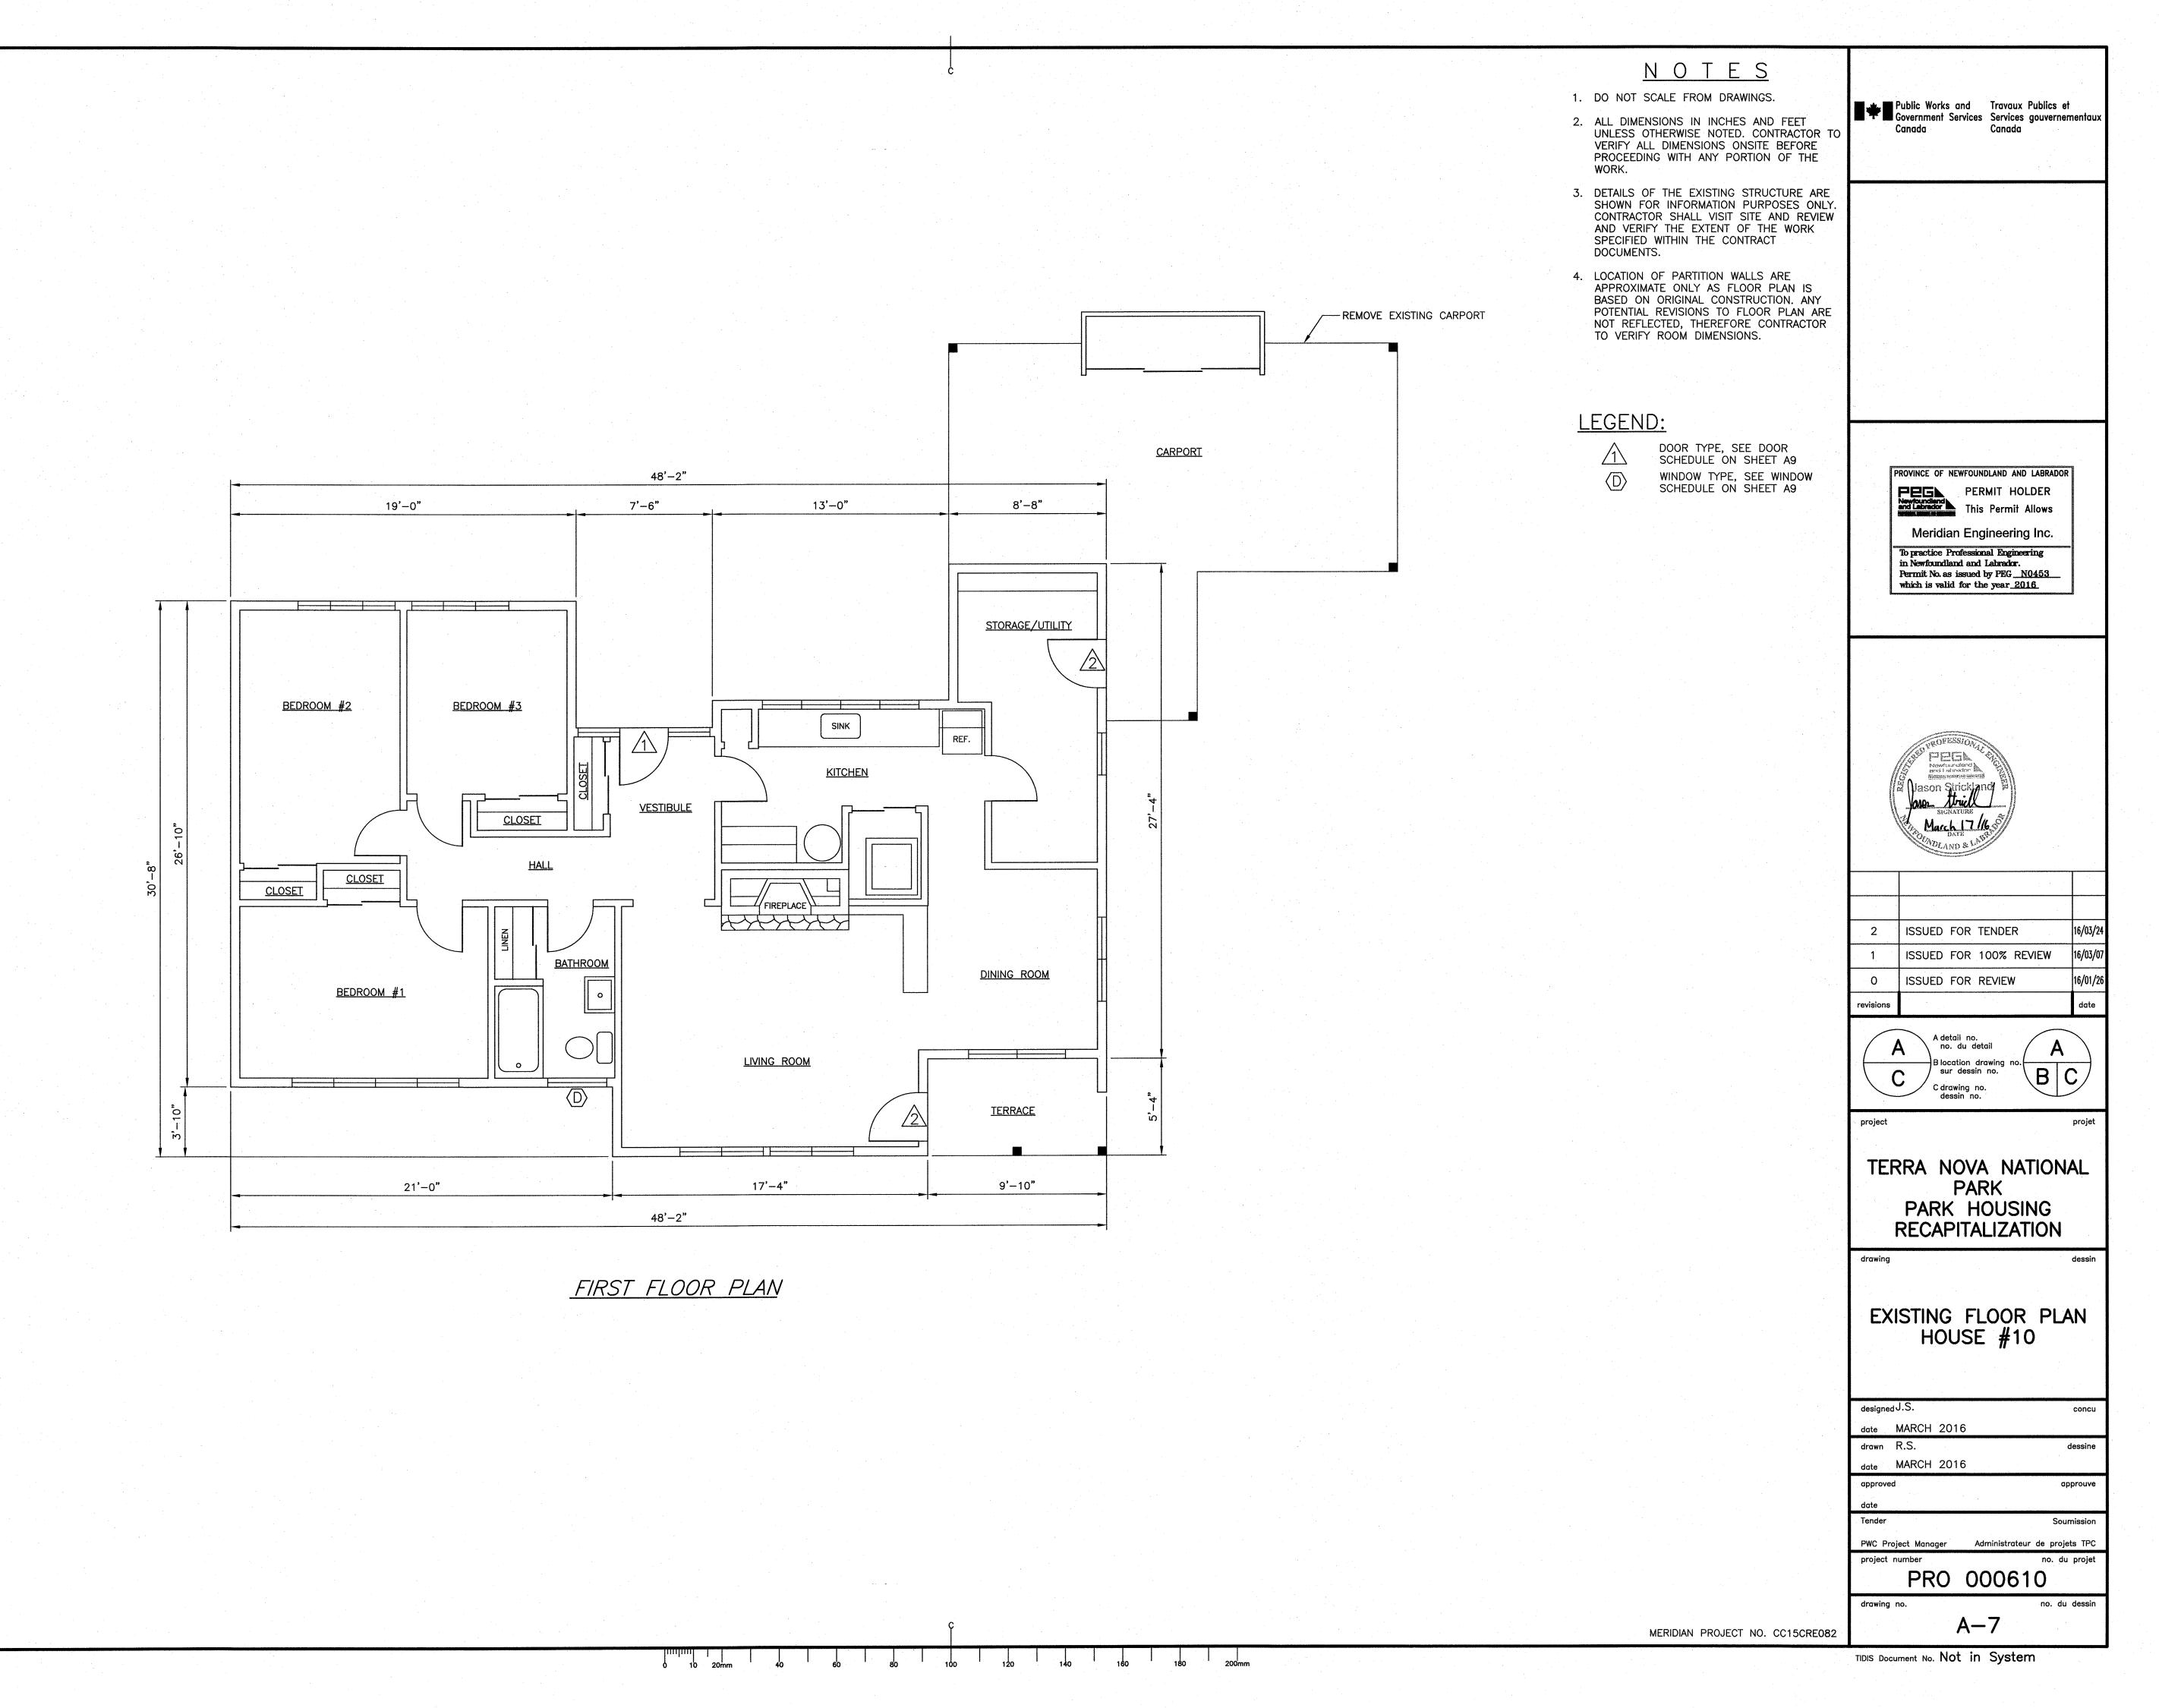



PWGSC A1

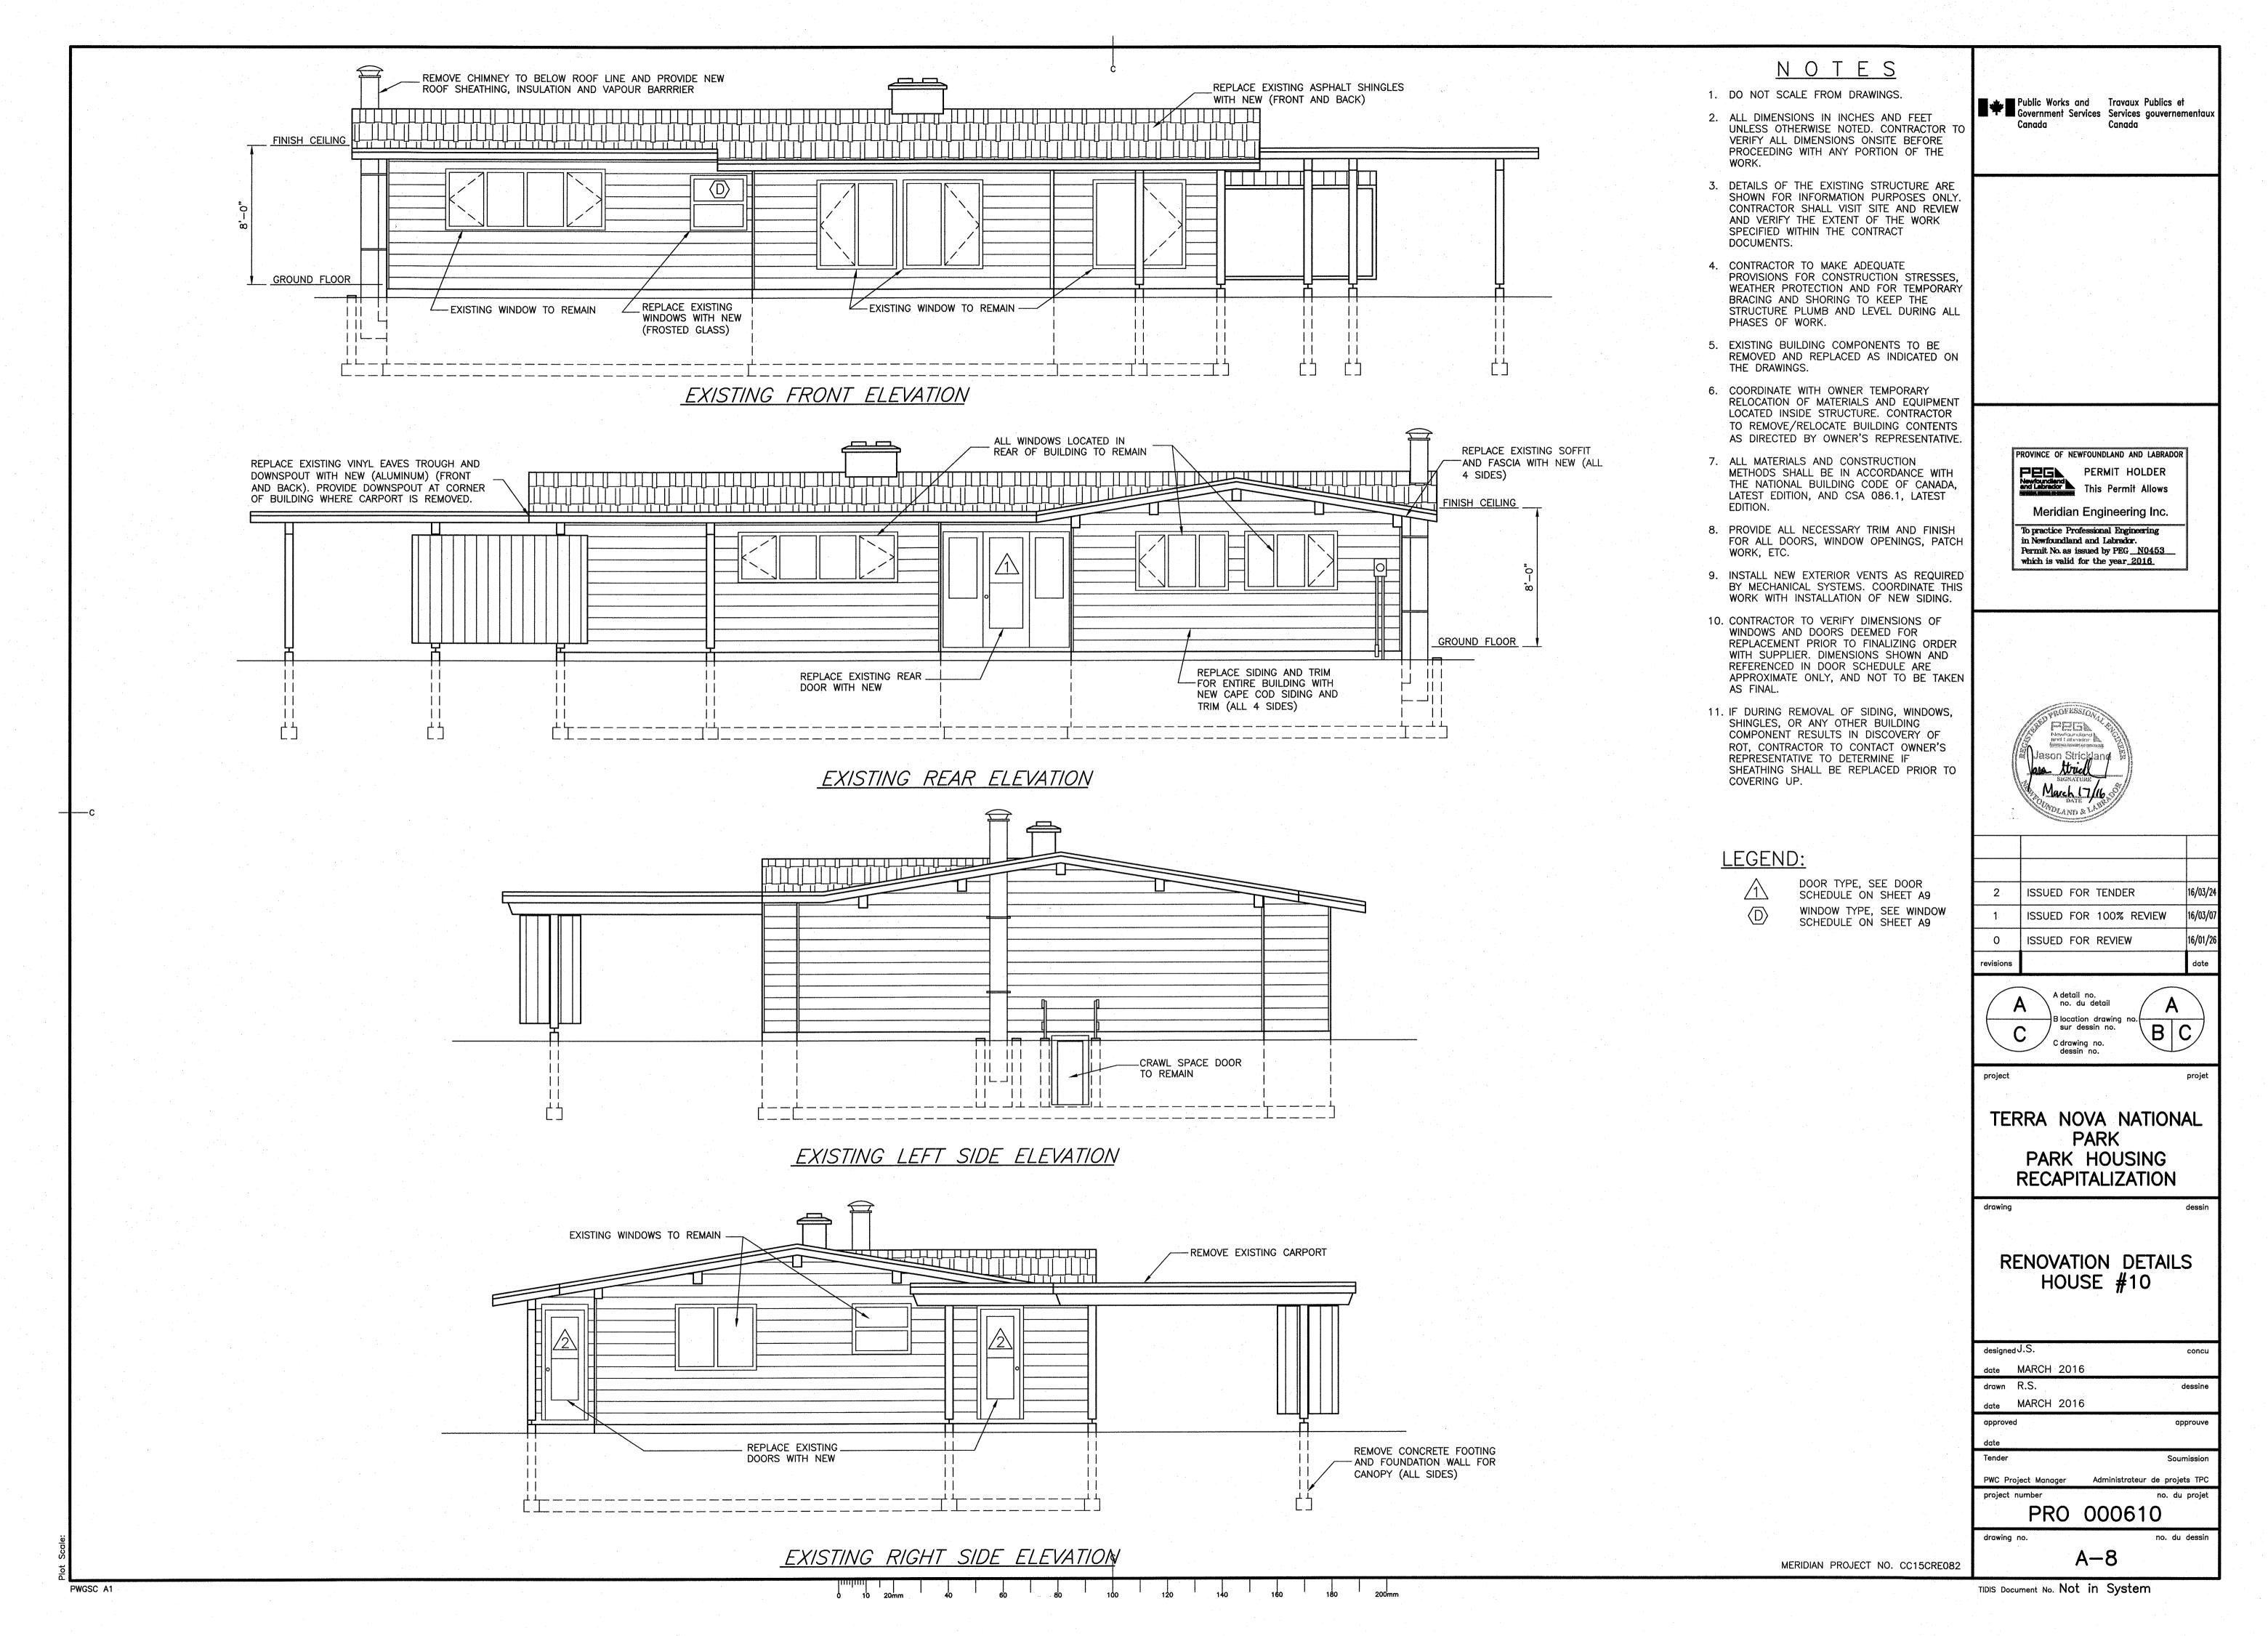

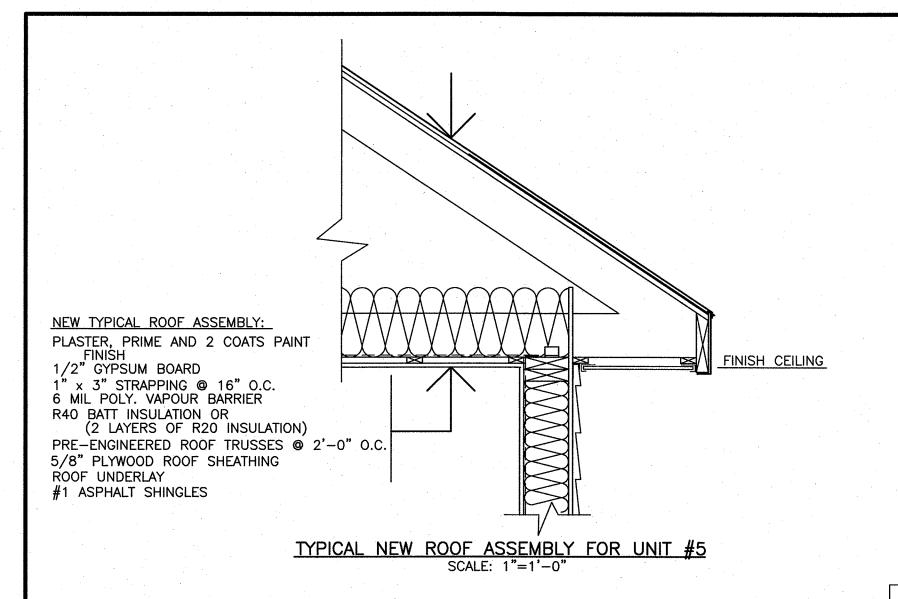

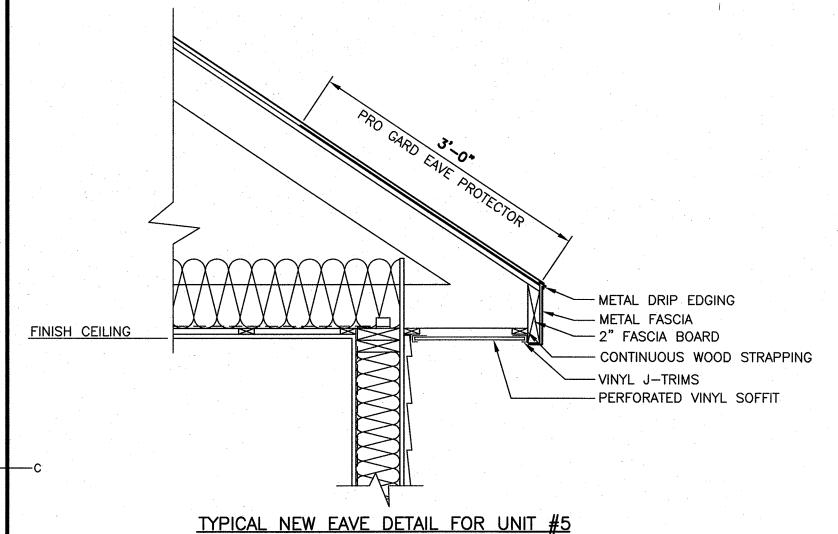

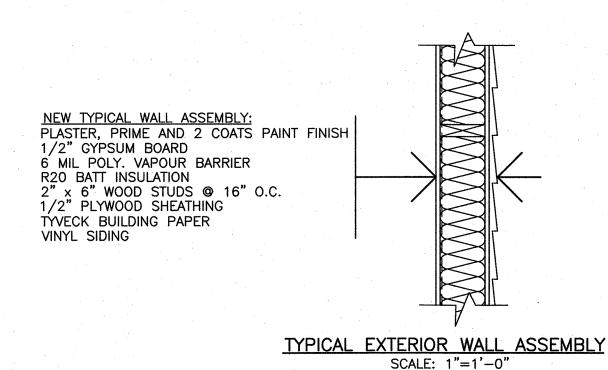


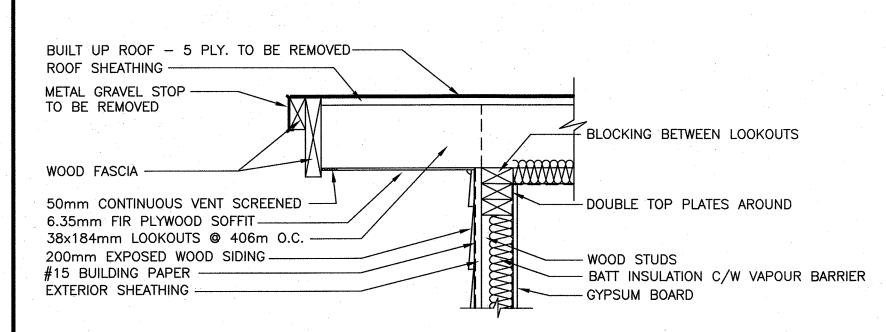

TYPICAL EXISTING EAVE DETAIL FOR UNITS #6 - #10

PWGSC A1


WINDOW SCHEDULE					
WINDOW No.	QTY	SIZE	FINISH	TYPE	REMARKS
Α	1	SIZE TO MATCH EXISTING	WHITE	Α	REMOVE EXISTING
В	1	SIZE TO MATCH EXISTING	WHITE	В	REMOVE EXISTING
С	2	SIZE TO MATCH EXISTING	WHITE	С	REMOVE EXISTING
D	1	SIZE TO MATCH EXISTING	WHITE	D	REMOVE EXISTING; NEW TO BE FROSTED GLASS
					FIXED WINDOW TYPE C: CASEMENT WINDOW FIXED WINDOW TYPE D: SLIDING WINDOW

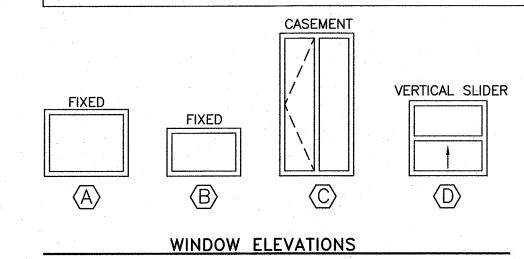


DOOR SCHEDULE						
DOOR No.	SIZE	MATERIAL	FINISH	FRAME	REMARKS	
Λ	MATCH TO FIT EXISTING	STEEL	PRE-FINISH	PSF	INSULATED STEEL DOOR C/W 2 SIDE LIGHTS	
2	MATCH TO FIT EXISTING	STEEL	PRE-FINISH	PSF	INSULATED STEEL DOOR C/W HALF GLASS	
<u>/</u> 3\	MATCH TO FIT EXISTING	STEEL	PRE-FINISH	PSF	INSULATED STEEL DOOR C/W 1 SIDE LIGHTS	

NOTES:


- . SEE NOTE 7 IN TITLE BLOCK.
- 2. FOR R.S.O. CHECK WITH MANUFACTURER'S RECOMMENDATIONS.
 3. EXTERIOR DOOR HARDWARE:
 - A. KNOB STYLE CYLINDRICAL MECHANICAL LOCK
 - B. DEADBOLT
 - C. 3 HINGES
 - D. DOOR STOP
 - E. WEATHERSTRIPPING
 - F. THRESHOLD

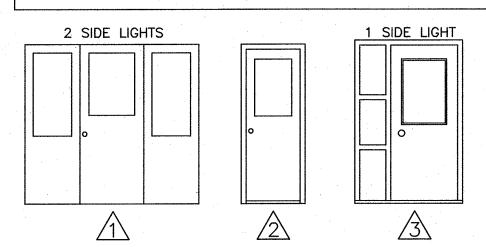


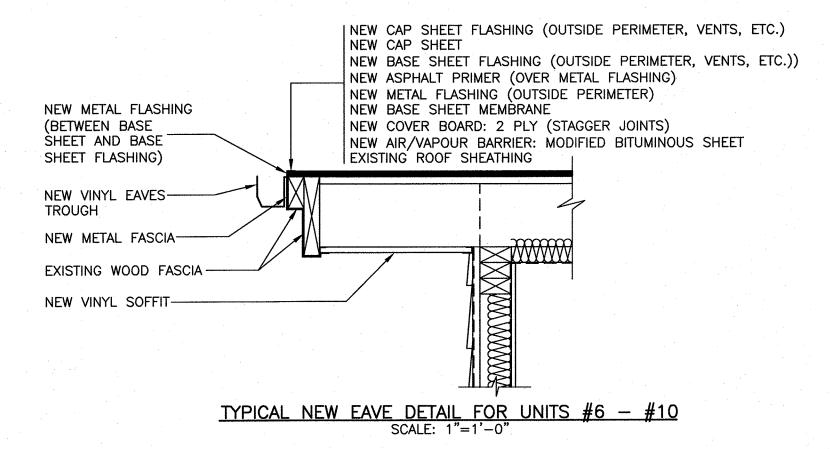

NOTES

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- 4. CONTRACTOR TO MAKE ADEQUATE PROVISIONS FOR CONSTRUCTION STRESSES, WEATHER PROTECTION AND FOR TEMPORARY BRACING AND SHORING TO KEEP THE STRUCTURE PLUMB AND LEVEL DURING ALL PHASES OF WORK.
- 5. ALL MATERIALS AND CONSTRUCTION METHODS SHALL BE IN ACCORDANCE WITH THE NATIONAL BUILDING CODE OF CANADA, LATEST EDITION, AND CSA 086.1, LATEST EDITION.
- 6. PROVIDE ALL NECESSARY TRIM AND FINISH FOR ALL DOORS, WINDOW OPENINGS, PATCH WORK, ETC.
- 7. SIZE OF NEW DOORS AND WINDOWS SHALL BE SAME AS EXISTING. IF SOME SIZES ARE UNAVAILABLE, CONTRACTOR WILL BE PERMITTED, AT NO EXTRA COST, TO MODIFY WALL STUDS AND FRAMING TO ACCOMMODATE NEW DOOR OR WINDOW. ONLY INCREASE IN SIZES SHALL BE PERMITTED.
- 8. CONTRACTOR TO VERIFY DIMENSIONS OF WINDOWS AND DOORS DEEMED FOR REPLACEMENT PRIOR TO FINALIZING ORDER WITH SUPPLIER. DIMENSIONS SHOWN AND REFERENCED IN DOOR SCHEDULE ARE APPROXIMATE ONLY, AND NOT TO BE TAKEN AS FINAL.
- 9. TAR AND GRAVEL ROOF TO BE REMOVED TO WOOD DECKING, WITH NEW ROOF SYSTEM COMPONENTS INSTALLED OVER EXISTING WOODEN DECK.

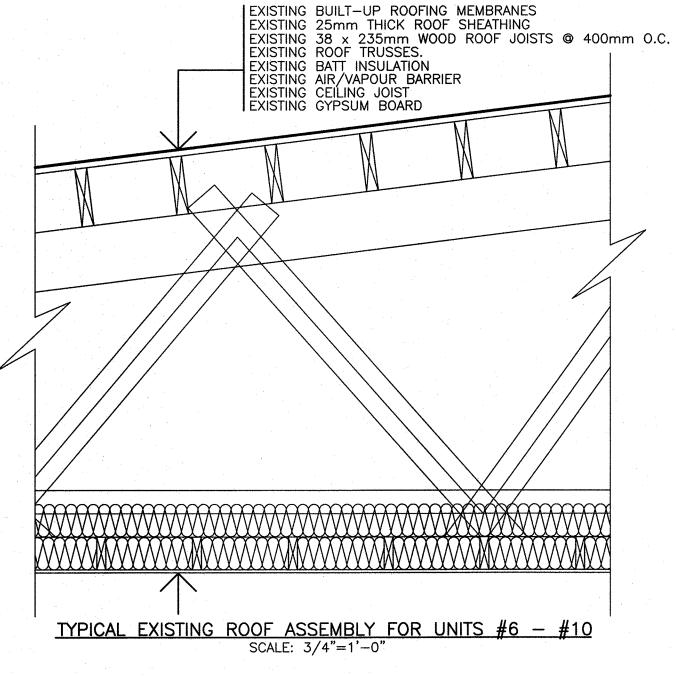

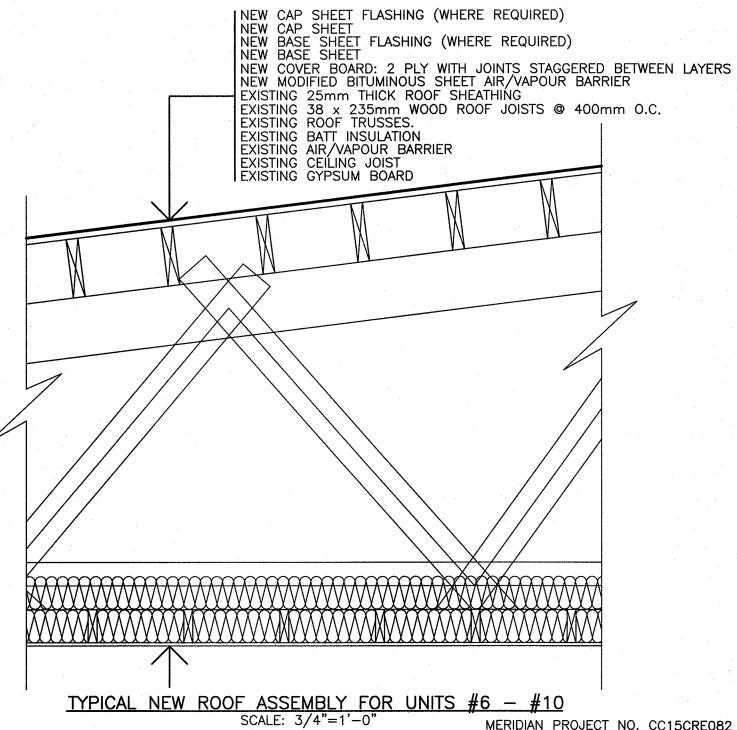

Public Works and Travaux Publics et
Government Services Services gouvernementaux
Canada

PROVINCE OF NEWFOUNDLAND AND LABRADOR

PERMIT HOLDER


Newfoundland
and Labrador

This Permit Allows


Meridian Engineering Inc.

To practice Professional Engineering in Newfoundland and Labrador.

Permit No. as issued by PEG N0453 which is valid for the year 2016

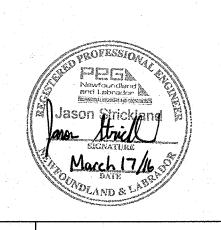

2 ISSUED FOR TENDER 16/03/2
1 ISSUED FOR 100% REVIEW 16/03/0
0 ISSUED FOR REVIEW 16/01/2

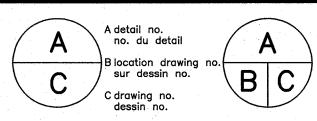

projet

Soumission

project

drawing

drawing no.

TERRA NOVA NATIONAL
PARK
PARK HOUSING
RECAPITALIZATION

SECTIONS, DETAILS AND SCHEDULES

designed J.S. concu
date MARCH 2016
drawn R.S. dessine
date MARCH 2016
approved approuve

PWC Project Manager Administrateur de projets TPC


project number no. du projet

PRO 000610

no. du dessin A-9

MECHANICAL VENTILATION LEGEND:

VENTILATION

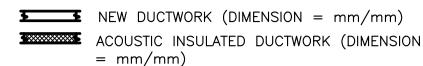



SUPPLY/FRESH AIR DUCTS UP & DOWN RETURN/EXHAUST AIR DUCTS UP & DOWN



TYPICAL 90° DUCT ELBOWS; (R/W = 1.0 & w THENNING VALUE)

MAGNETIC STARTER BY MECH.

DEMOLITION NOTES:


- 1. DEMOLITION CONTRACTOR SHALL BE RESPONSIBLE FOR COMPLETE REMOVAL AND DISCARDING OF ALL DEMOLITION WASTE INCLUDING UNFORESEEN ITEMS WITHIN THE SCOPE OF WORK.
- 2. DEMOLITION CONTRACTOR SHALL FIELD VERIFY ALL EXISTING CONDITIONS AFFECTING THE WORK.
- 3. THESE DRAWINGS ARE DIAGRAMMATIC AND INDICATE THE GENERAL EXTENT OF WORK TO BE PERFORMED. THE EXACT EXTENT OF DEMOLITION SHALL BE REQUIRED BY NEW WORK.
- 4. DEPARTMENTAL REPRESENTATIVE SHALL HAVE FIRST RIGHT OF REFUSAL ON ALL EQUIPMENT BEING REMOVED.

DRAWING NOTES:

(1) FUEL TANK TO BE REMOVED AND DISPOSED OF IN AN ENVIORNMENTALLY FASHION. COMPLETION OF A "DISMANTLING, DECOMMISSIONING OR DESTRUCTION NOTICE" REQUIRED FOR THE FUEL TANK TO BE REMOVED. CLEAN AND DEGREASE AREA OF WORK. MAKE GOOD ANY DAMAGES IN AREA OF WORK.


GENERAL NOTES:

- 1. ALL WORK TO BE COORDINATED WITH THE DEPARTMENTAL REPRESENTATIVE ON SITE. OBTAIN ALL REQUIRED SECURITY CLEARANCE FOR CARRYING OUT WORK IN BUILDING PRIOR TO COMMENCEMENT OF WORK. ARRANGE FOR DAILY ACCESS AND SUPERVISION AS REQUIRED WITH BUILDING MANAGEMENT.
- 2. OBTAIN ALL HOT WORK PERMITS FOR CUTTING INTO EXISTING DUCTWORK AS REQUIRED.
- 3. CLEAN DEBRIS FROM SITE CONTINUOUSLY WHILE WORK IS BEING CARRIED OUT.
- 4. COORDINATE SHUTDOWN OF FUEL SYSTEMS WITH BUILDING MANAGEMENT. A MINIMUM OF 48 HOURS PRIOR TO CARRYING OUT THE WORK IN ALL AREAS. WORK MAY HAVE TO BE CARRIED OUT AFTER HOURS IN SOME LOCATIONS.
- 5. ALL LOCATIONS ARE TO BE CONSIDERED APPROXIMATE ONLY. CONFIRM ALL LOCATIONS ON SITE AND ADJUST AS REQUIRED.
- 6. COORDINATE WITH ALL OTHER TRADES.
- 7. ALL PENETRATIONS ARE TO BE PROPERLY FIRE STOPPED WITH A ULC LISTED MATERIAL.
- 8. COMPLETION OF A DISMANTLING DECOMMISSIONING OR DESTRUCTION NOTICE"
- 9. FUEL MANIFEST REQUIRED FROM THE CONTRACTOR INDICATED THE QUANTITY AND WHERE THE FUEL WAS DISPOSED OFF. THE EXISTING TANK DECOMMISSIONING WILL BE REQUIRED FROM CONTRACTOR INDICATING THE QUANTITY AND WHERE THE FUEL WAS DISPOSED OF. THE EXISTING TANK DECOMMISSIONING WILL BE REQUIRED TO TAKE PLACE BY CONTRACTORS LICENSED FOR THIS ACTIVITY IN THE PROVINCE OF NL.
- 10. CONTRACTOR TO FILL OUT FUEL TANK CHECKLIST.
- 11. NOTIFY WITHIN 60 DAYS IF IT'S A REGISTERED TANK. PLACE TAG ON FILL PIPE ANYTIME A TANK IS OUT OF SERVICE. FILL OUT PERMANENT WITHDRAWAL FROM SERVICE FORM.
- 12. CONTRACTOR TO REVIEW ASBESTOS MANAGEMENT PLAN PRIOR TO ANY DEMO, DRILLING OR REINSTATEMENT OF WORK.

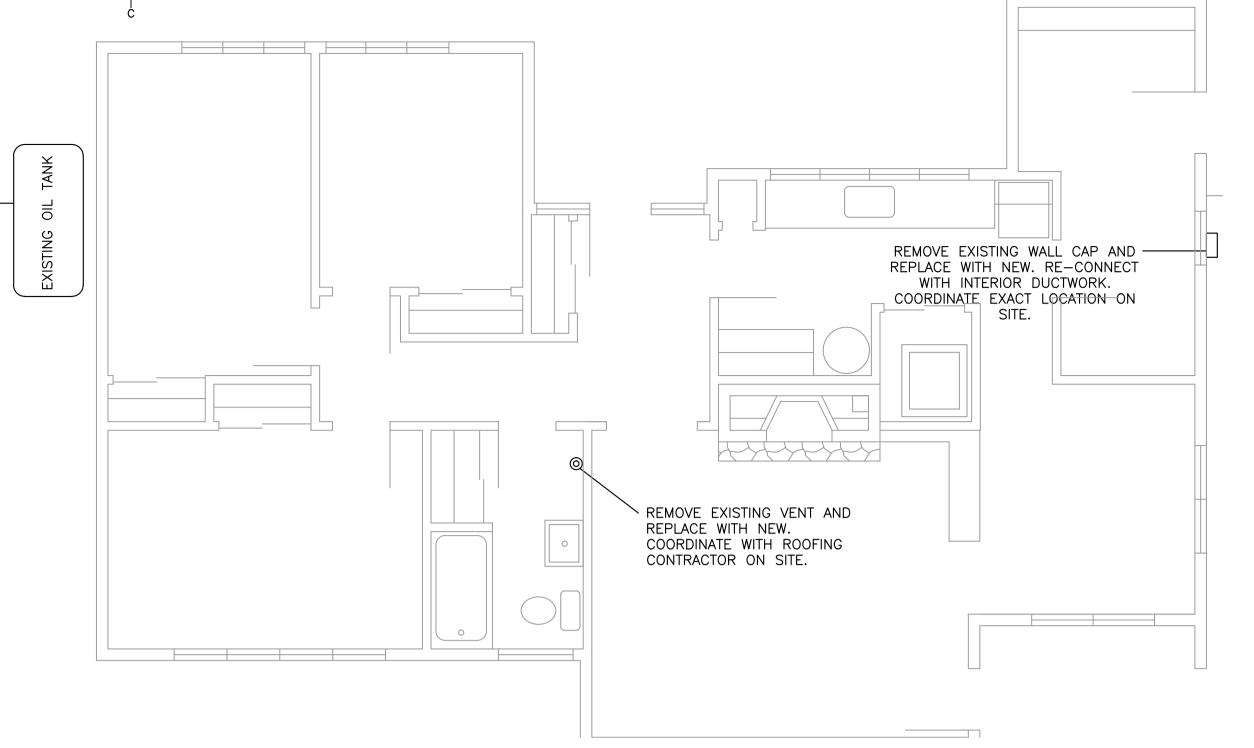


HOUSE #10 ROOF PLAN - DEMOLITION AND NEW WORK LAYOUT




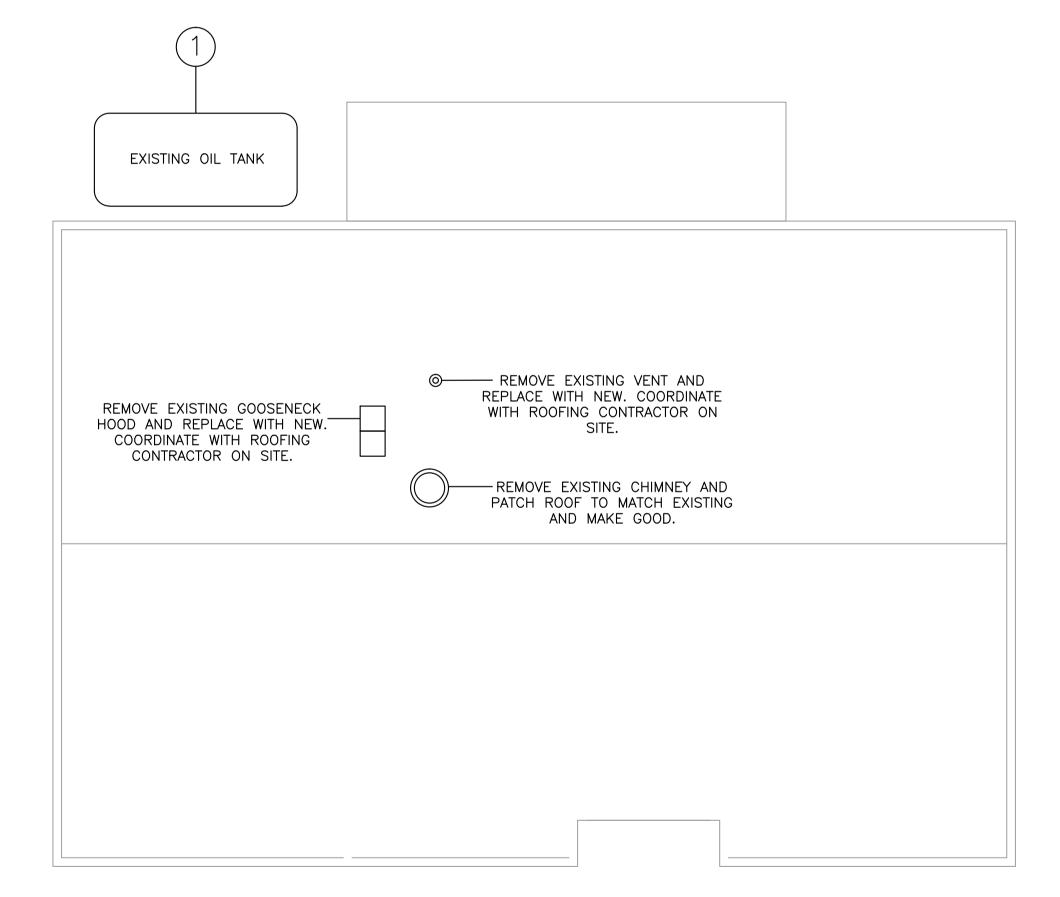

HOUSE #5 MAIN FLOOR PLAN - DEMOLITION AND NEW WORK LAYOUT

SCALE: 1:50

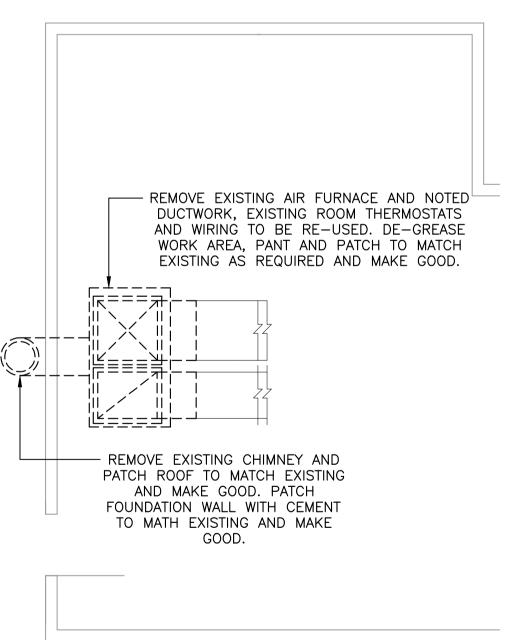

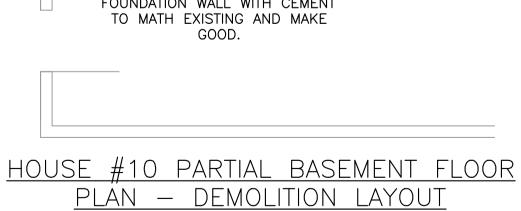

SCALE: 1:50

HOUSE #10 BASEMENT FLOOR PLAN - NEW HEATING LAYOUT SCALE: 1:50

NEW AIRSIDE FURNACE (AF-1) SEE SCHEDULE FOR DETAILS.

AIR FURNACE STARTER.

PROVIDE CONCRETE SERVICE PAD 150MM

THICK. RE- CONNECT THERMOSTAT(S) TO

NEW 400/400 SUPPLY AND RETURN DUCTWORK TO CONNECT

TO EXISTING DUCTWORK, PROVIDE ADDITIONAL TRANSITIONS AND FITTINGS AS REQUIRED TO MAKE CONNECTION. COORDINATE EXACT

LOCATION ON SITE.

ELECTRIC FURNACE SCHEDULE CAPACIT ELECTRICAL DATA STAGE DETAILS MANUFACTURE MODEL NO. TAG FAN HP MCA REMARKS KW. VOLTAGE PH. # OF STAGES HZ. POWERED ELECTRICAL DISCONNECT, AIR FLOW STELPRO SEFECM2321B AF-11/2 23 240 60 SWITCH, CONTROLS TRANSFORMER 24 VOLT, SCR.

To practice Professional Engineering in Newfoundland and Labrador Permit No. as issued by PEG-NL D0123 which is valid for the year 2016. 4 DAVID A. SMITH SIGNATURE MARCH 24, 2016

PROVINCE OF NEWFOUNDLAND

CROSBIE ENGINEERING LIMITED


PERMIT HOLDER

Class "A" This Permit Allows

Public Works and Travaux Publics et
Government Services Services gouvernementaux

Canada

ISSUED FOR TENDER ISSUED 100% REVIEW ISSUED FOR 75% REVIEW

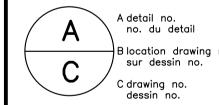

project

SCHEDULE.

Tender

TERRA NOVA NATIONAL

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PARK PARK HOUSING RECAPITALIZATION

HOUSE #5 AND #10 HEATING DEMOLITION, NEW HEATING LAYOUT AND


designed D.S. concu date MARCH 2016 drawn B.D. dessine date MARCH 2016 approuve


Administrateur de projets TPC project number PRO 000610

Soumission

no. du dessin drawing no. M-1

PWGSC A1

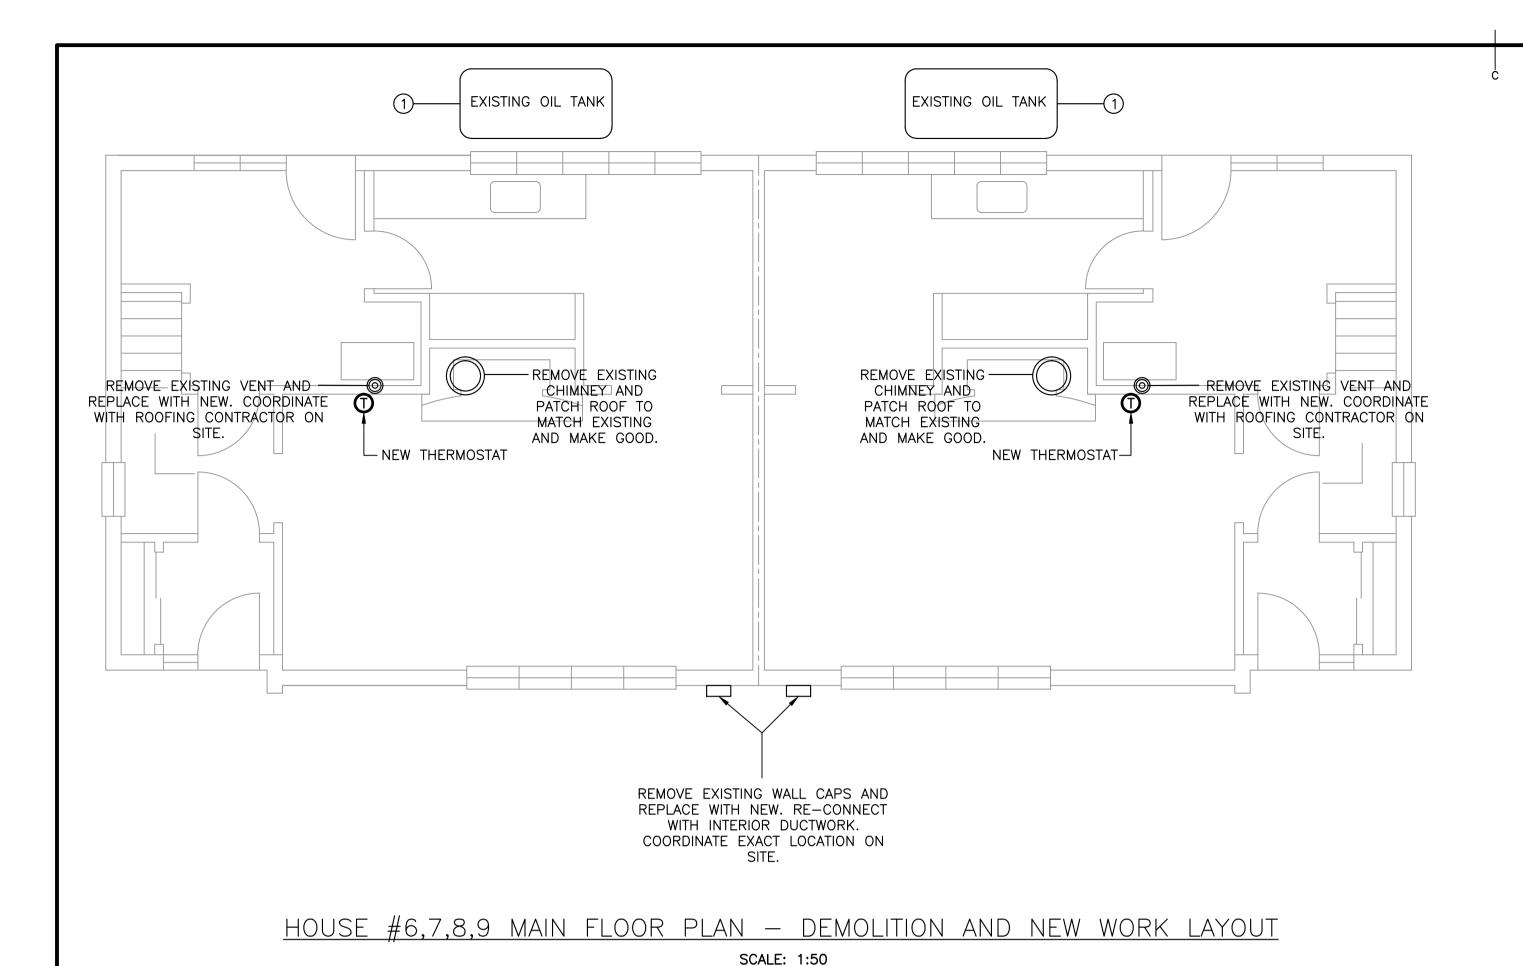

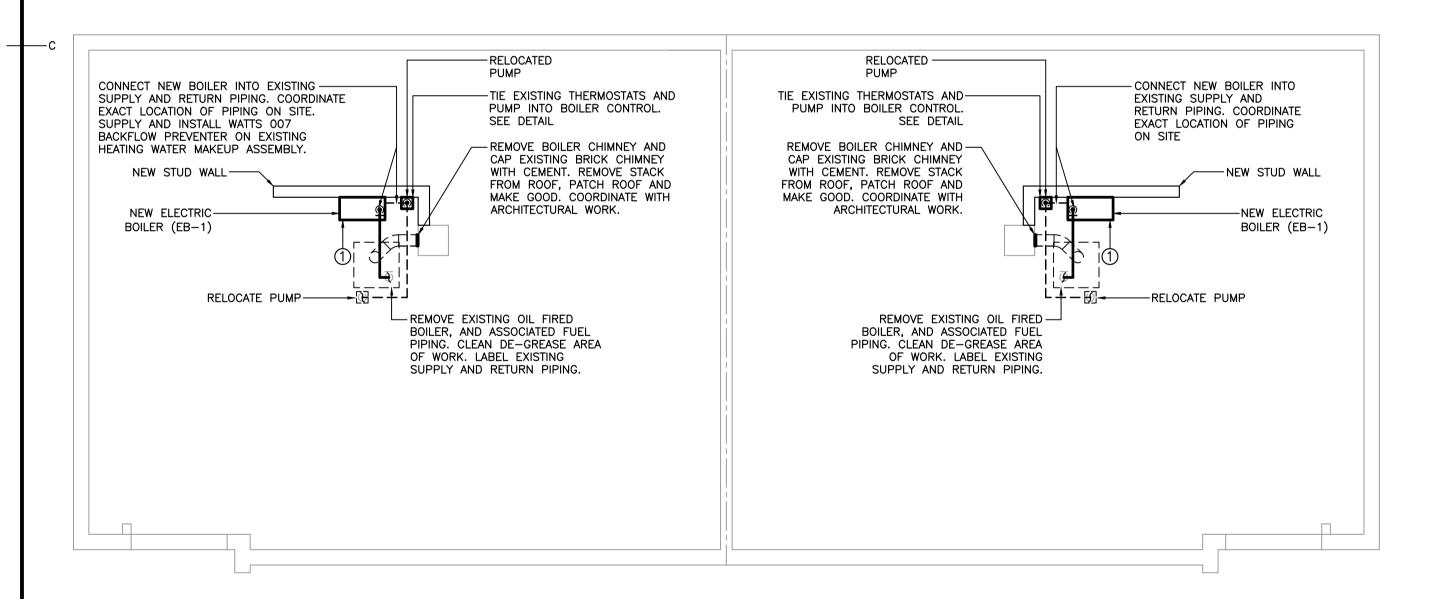

HOUSE #6,7,8,9 MAIN FLOOR PLAN - DEMOLITION AND NEW WORK LAYOUT

SCALE: 1:50

PWGSC A1

GENERAL NOTES:

- 1. ALL WORK TO BE COORDINATED WITH THE DEPARTMENTAL REPRESENTATIVE ON SITE. OBTAIN ALL REQUIRED SECURITY CLEARANCE FOR CARRYING OUT WORK IN BUILDING PRIOR TO COMMENCEMENT OF WORK. ARRANGE FOR DAILY ACCESS AND SUPERVISION AS REQUIRED WITH BUILDING MANAGEMENT.
- 2. OBTAIN ALL HOT WORK PERMITS FOR CUTTING INTO EXISTING DUCTWORK AS REQUIRED.
- 3. CLEAN DEBRIS FROM SITE CONTINUOUSLY WHILE WORK IS BEING CARRIED OUT.
- 4. COORDINATE SHUTDOWN OF FUEL SYSTEMS WITH BUILDING MANAGEMENT. A MINIMUM OF 48 HOURS PRIOR TO CARRYING OUT THE WORK IN ALL AREAS. WORK MAY HAVE TO BE CARRIED OUT AFTER HOURS IN SOME LOCATIONS.
- 5. ALL LOCATIONS ARE TO BE CONSIDERED APPROXIMATE ONLY. CONFIRM ALL LOCATIONS ON SITE AND ADJUST AS REQUIRED.
- 6. COORDINATE WITH ALL OTHER TRADES.
- 7. ALL PENETRATIONS ARE TO BE PROPERLY FIRE STOPPED WITH A ULC LISTED MATERIAL.
- 8. COMPLETION OF A DISMANTLING DECOMMISSIONING OR DESTRUCTION NOTICE"
- 9. FUEL MANIFEST REQUIRED FROM THE CONTRACTOR INDICATED THE QUANTITY AND WHERE THE FUEL WAS DISPOSED OFF. THE EXISTING TANK DECOMMISSIONING WILL BE REQUIRED FROM CONTRACTOR INDICATING THE QUANTITY AND WHERE THE FUEL WAS DISPOSED OF. THE EXISTING TANK DECOMMISSIONING WILL BE REQUIRED TO TAKE PLACE BY CONTRACTORS LICENSED FOR THIS ACTIVITY IN THE PROVINCE OF NL.
- 10. CONTRACTOR TO FILL OUT FUEL TANK CHECKLIST.
- 11. NOTIFY WITHIN 60 DAYS IF IT'S A REGISTERED TANK. PLACE TAG ON FILL PIPE ANYTIME A TANK IS OUT OF SERVICE. FILL OUT PERMANENT WITHDRAWAL FROM SERVICE FORM.
- 12. CONTRACTOR TO REVIEW ASBESTOS MANAGEMENT PLAN PRIOR TO ANY DEMO, DRILLING OR REINSTATEMENT OF WORK.

DEMOLITION NOTES:


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- 2. DEMOLITION CONTRACTOR SHALL FIELD VERIFY ALL EXISTING CONDITIONS AFFECTING THE WORK.
- 3. THESE DRAWINGS ARE DIAGRAMMATIC AND INDICATE THE GENERAL EXTENT OF WORK TO BE PERFORMED. THE EXACT EXTENT OF DEMOLITION SHALL BE REQUIRED BY NEW WORK.
- 4. O&M SHALL HAVE FIRST RIGHT OF REFUSAL ON ALL EQUIPMENT BEING REMOVED.

DRAWING NOTES:

1 FUEL TANK TO BE REMOVED AND DISPOSED OF IN AN ENVIORNMENTALLY FASHION. COMPLETION OF A "DISMANTLING, DECOMMISSIONING OR DESTRUCTION NOTICE" REQUIRED FOR THE FUEL TANK TO BE REMOVED. CLEAN AND DEGREASE AREA OF WORK. MAKE GOOD ANY DAMAGES IN AREA OF WORK.


Public Works and Services Services gouvernementaux


Public Works and Travaux Publics et

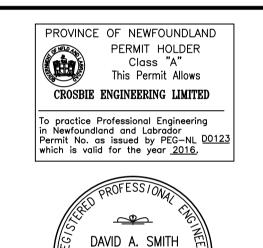

SIGNATURE

MARCH 24, 2016

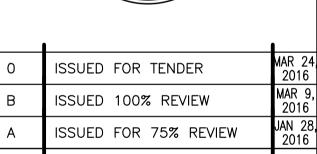

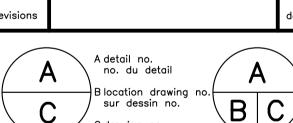

C drawing no.

project

TERRA NOVA NATIONAL PARK PARK HOUSING RECAPITALIZATION

Tender

drawing no.

HOUSE #6, #7, #8, AND #9 HEATING DEMOLITION, NEW HEATING LAYOUT AND SCHEDULE.

designed D.S. concu date MARCH 2016 drawn B.D. dessine date MARCH 2016 approved approuve

Administrateur de projets TPC

PRO 000610

Soumission

no. du dessin

M-2

ELECTRIC BOILER SCHEDULE


				ELECTRICAL LOAD					MAX.
DWG TAG	MANUFACTURER	MODEL	NET CAPACITY (LITRES)	TOTAL (KW)	CURRENT AMP	ELEMENTS	STAGES	VOLTAGE	OPERATING PRESS. (KPA)
EB-1	THERMOLEC	STANDARD	-	23	-	-	1	240/1/60	207

NOTES -

C/W PRESSURE RELIEF VALVE, DRAIN VALVE & TRIDICATOR (TEMP./PRESS. GAGE).

HONEYWELL RELAY SWITCH FOR PUMP CONTROL

FLUID IS 40% GLYCOL.

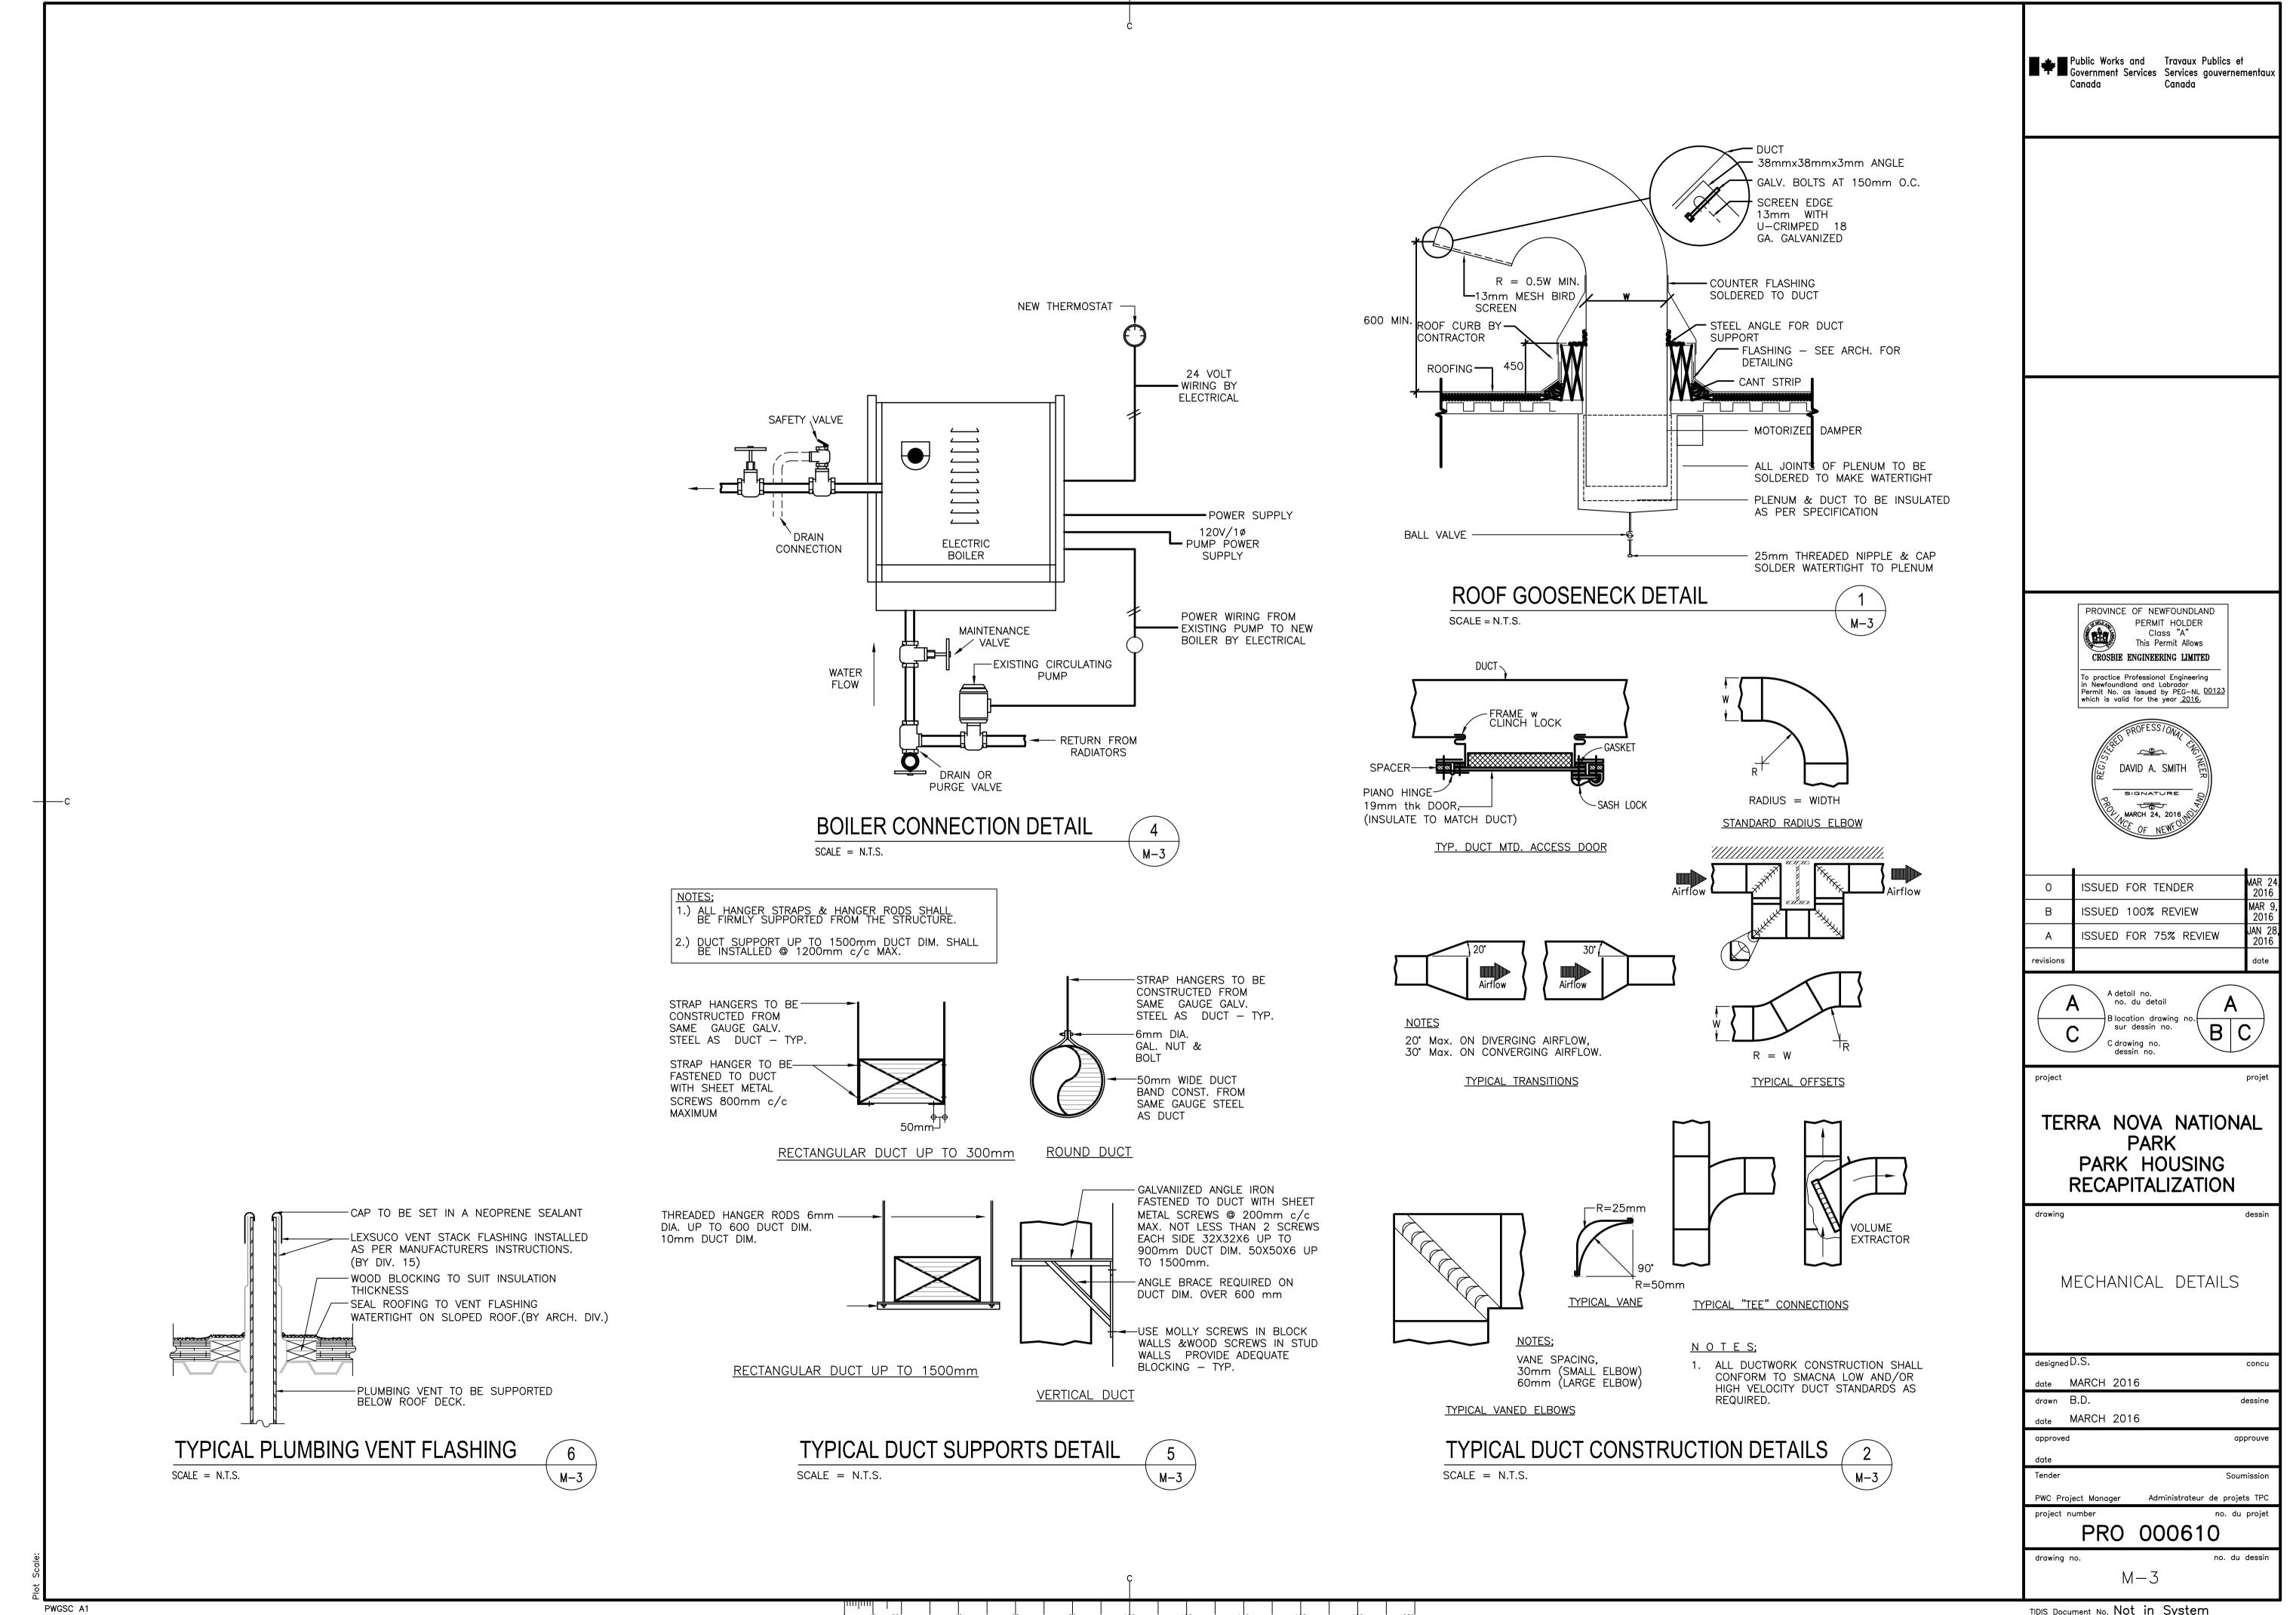

GENERAL NOTES:

SYMBOL

LIGHT SOURCE

- 1. CONTRACTOR TO PROVIDE ALL CUTTING, PATCHING AND PAINTING TO MATCH EXISTING. SEE SPECIFICATION FOR DETAILS. COORDINATE ON SITE.
- 2. CONTRACTOR MUST VERIFY ALL DIMENSIONS AND CONDITIONS ON SITE BEFORE PROCEEDING WITH ANY PORTION OF THIS WORK. DO NOT SCALE FROM DRAWINGS. CONTRACTOR TO ASSESS WORK AREA IN ADVANCE WITH DEPARTMENTAL REPRESENTATIVE REPRESENTATIVE FOR COORDINATION OF RELATED DAILY WORK SCHEDULES, PARKING, BUILDING ACCESS, AND STORAGE OF EQUIPMENT.
- 3. WORK SHALL BE SCHEDULED DURING NORMAL WORKING HOURS CONTRACTOR MAY WORK AFTER NORMAL WORKING HOURS AS COORDINATED BY DEPARTMENTAL REPRESENTATIVE. BUILDING TO REMAIN OPERATIONAL DURING CONSTRUCTION.
- 4. CONTRACTOR SHALL BE RESPONSIBLE FOR CLEAN UP AND DISPOSALS OF WORK AREA ON A DAILY BASIS. AFTER EACH WORKING SHIFT BUILDING TO BE CLEANED AND FREE OF DEBRIS. BUILDING GARBAGE BINS ARE NOT TO BE
- 5. ANY ELECTRICAL SYSTEM SHUTDOWN TO BE SCHEDULED AFTER NORMAL BUSINESS HOURS AND SHALL BE COORDINATED WITH DEPARTMENTAL REPRESENTATIVE. SUFFICIENT NOTICE SHALL BE GIVEN. 5 WORKING DAYS NOTICE IS REQUIRED FOR ANY DISRUPTION.
- 6. WORK TO BE CARRIED OUT IN CONSIDERATION OF CLIENT COMFORT AND OPERATIONS.
- 7. ALL WIRING TO BE INSTALLED IN CONDUIT AS INDICATED.
- 8. ACCESS TO FACILITY TO BE COORDINATED WITH DEPARTMENTAL REPRESENTATIVE.
- 9. PROVIDE TYPED REVISED PANELBOARD DIRECTORIES FOR ALL PANELBOARDS WHERE BRANCH CIRCUITS WERE EITHER REMOVED, MODIFIED, OR ADDED.
- 10. LABEL ALL EQUIPMENT ASSOCIATED WITH THIS PROJECT WITH LAMICOID TAGS.
- 11. ALL EXISTING ELECTRICAL EQUIPMENT REMOVED TO BE TURNED OVER TO DEPARTMENTAL REPRESENTATIVE. IF DEPARTMENTAL REPRESENTATIVE REFUSES THEN CONTRACTOR TO REMOVE FROM SITE AND DISPOSE.

MOUNTING

EXTERIOR WALL

LIGHTING FIXTURE SCHEDULE

| VOLTS |

120

LAMPS

1 × 20W LED

MANUFACTURER

LITHONIA

CAT. NO.

OLWX1LED-20W-40K-120


LEGEND

<u>LIGHTING</u>


- ED LIGHTING FIXTURE, CEILING MOUNTED. LETTER DENOTES TYPE. SEE LIGHTING FIXTURE SCHEDULE & SPECIFICATIONS FOR DESCRIPTION.
- (A) LED LIGHTING FIXTURE, WALL MOUNTED. LETTER DENOTES TYPE. SEE LIGHTING FIXTURE SCHEDULE & SPECIFICATIONS FOR DESCRIPTION.
- \$3 SINGLE POLE TOGGLE SWITCH. 15 AMP, SPECIFICATION GRADE, WHITE C/W STAINLESS STEEL COVERPLATE. SEE SPEC. FOR MORE INFORMATION. MOUNT
 - 1200mm ABOVE FINISHED FLOOR.
 "p" INDICATES PILOT LIGHT
 - "3" INDICATES THREE WAY SWITCH, SIMILAR TO ABOVE.
 - "4" INDICATES FOUR WAY SWITCH, SIMILAR TO ABOVE.


REMARKS

Public Works and Travaux Publics et
Government Services Services gouvernementaux
Canada Canada

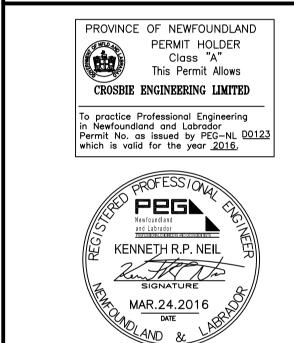

0	ISSUED FOR TENDER	MAR.2 2016
В	ISSUED FOR 100% REVIEW	MAR.0 2016
Α	ISSUED FOR 66% REVIEW	JAN.28 2016
revisions		date

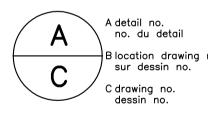

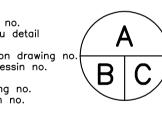

project

TERRA NOVA NATIONAL
PARK
PARK HOUSING
RECAPITALIZATION

drawing

LEGEND AND GENERAL NOTES

designed K.N. concu
date MARCH 2016
drawn D.R. dessine
date MARCH 2016
approved approuve
date
Tender Soumission


C Project Manager Administrateur de projets TPC


oject number no. du projet

PRO 000610


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CEL. PROJECT NO. 15-2023



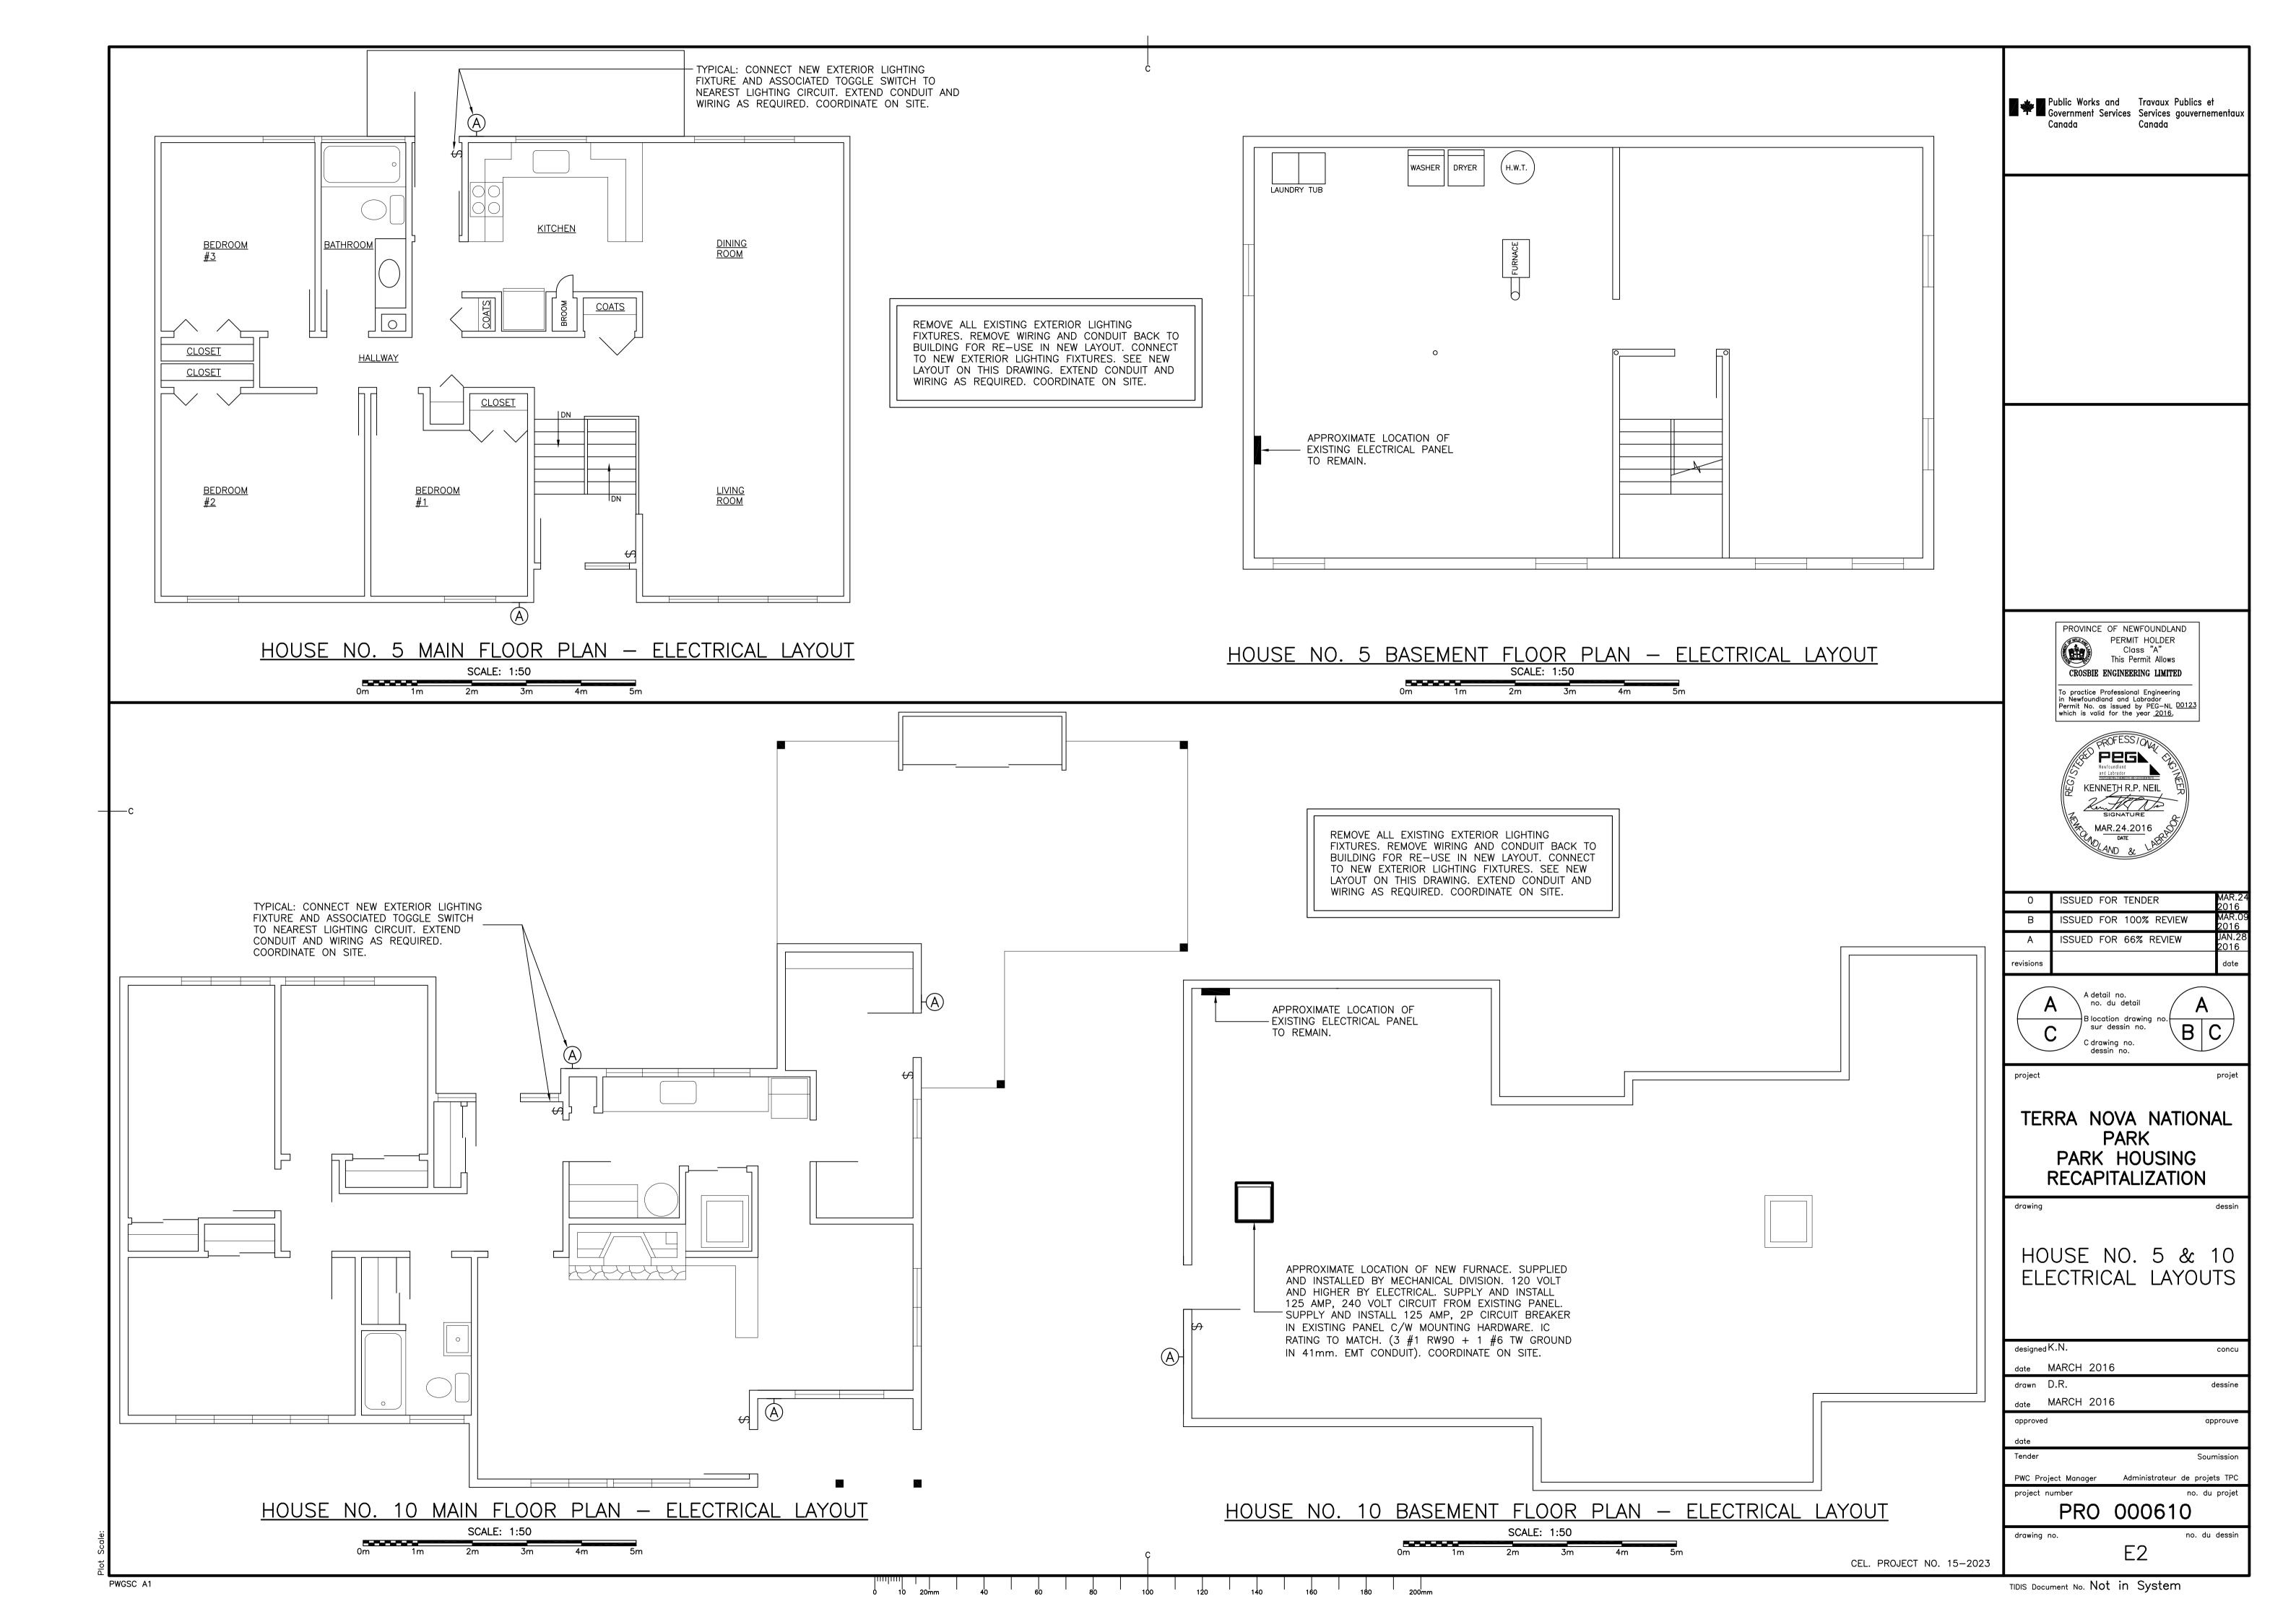

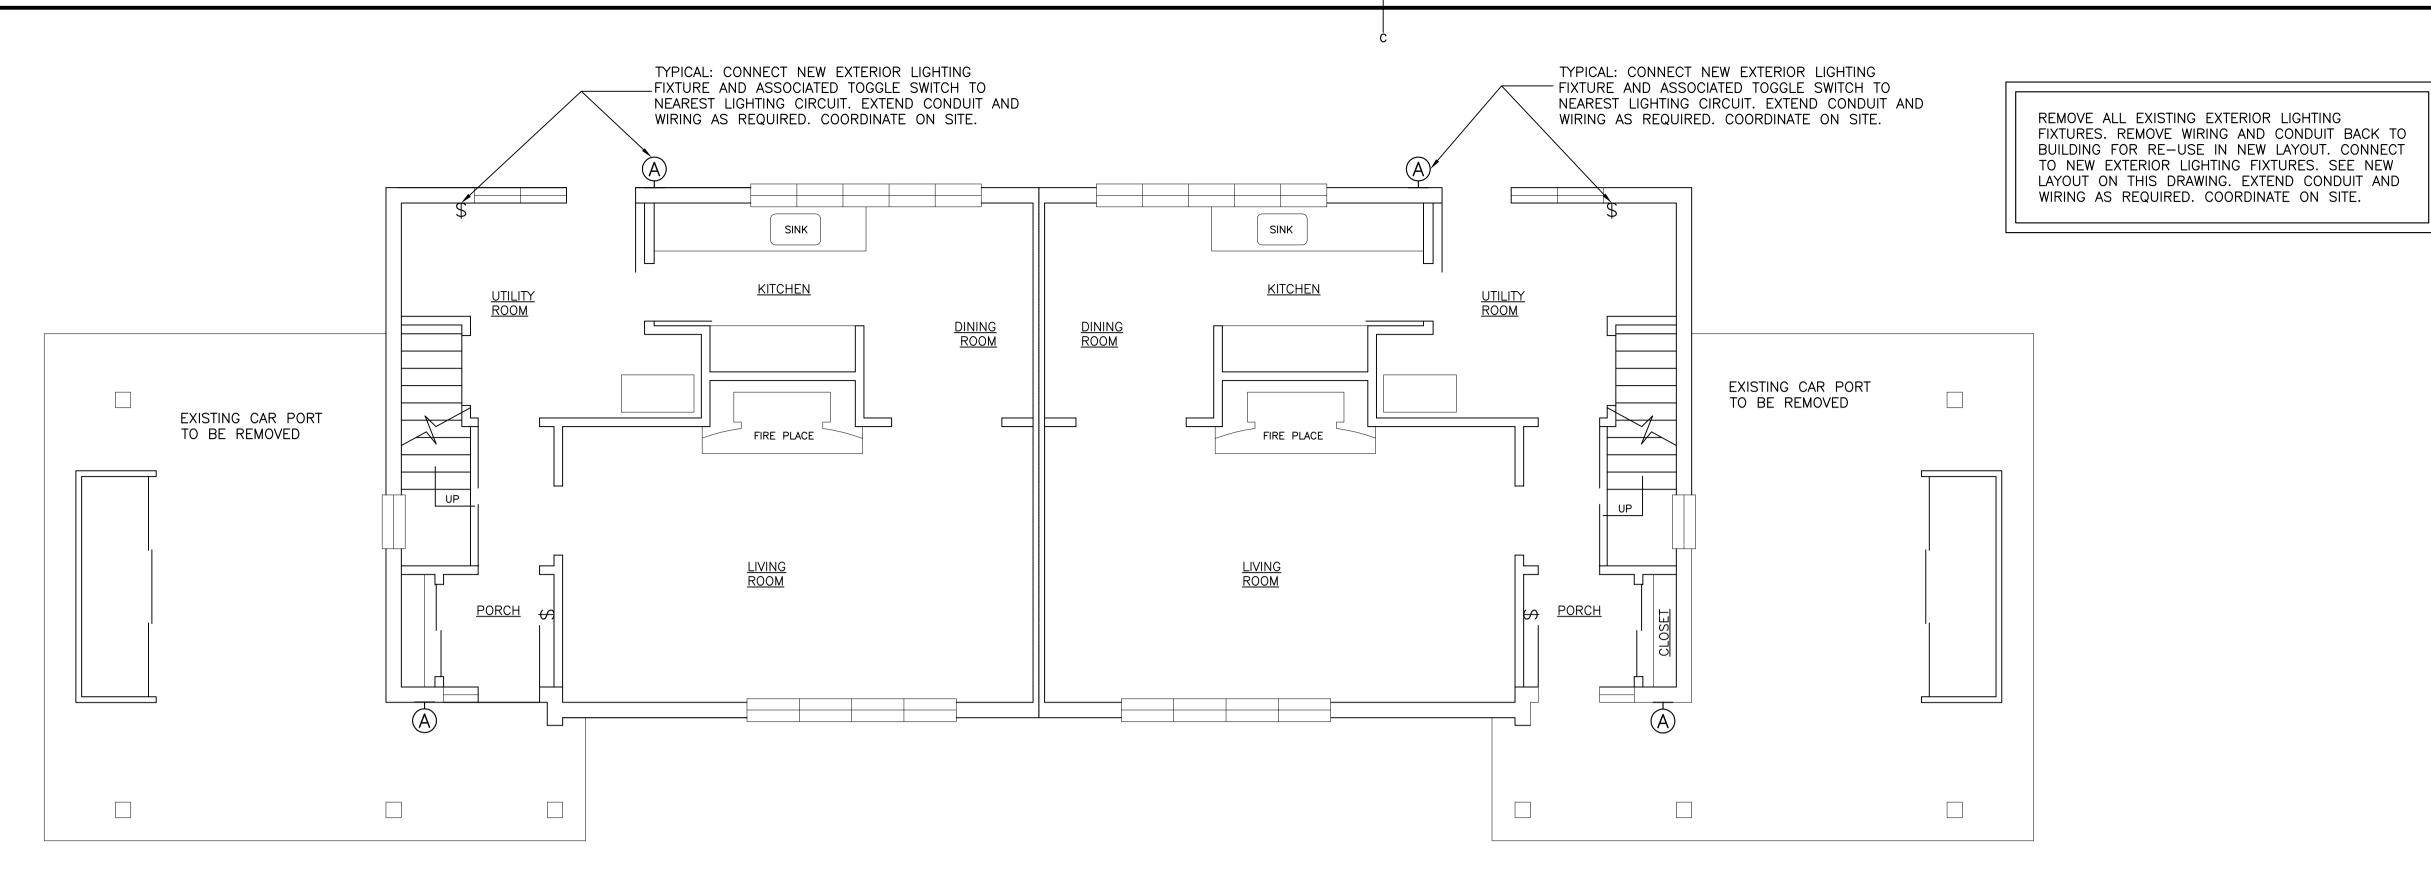HOUSE NO. 6 & 7 MAIN FLOOR PLAN - ELECTRICAL LAYOUT SCALE: 1:50 .

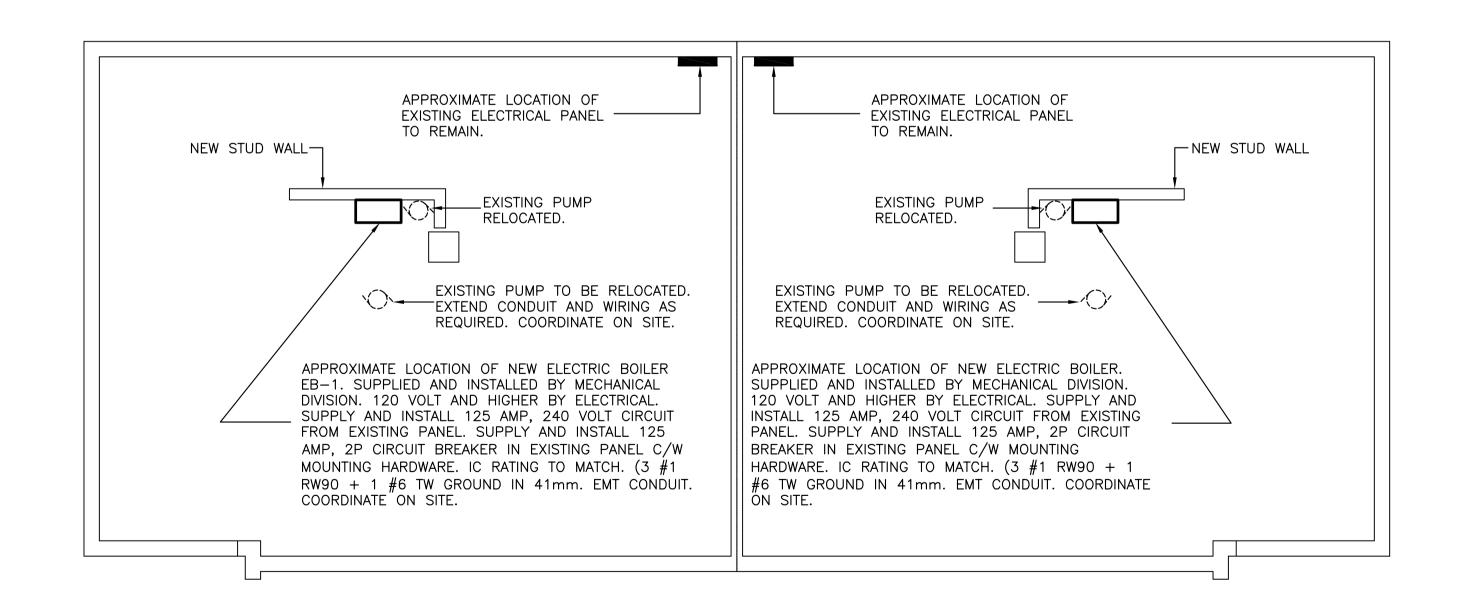



HOUSE NO. 6 & 7 BASEMENT FLOOR PLAN - ELECTRICAL LAYOUT 0m 1m

Public Works and Travaux Publics et
Government Services Services gouvernementaux Canada



revisions		dat
Α	ISSUED FOR 66% REVIEW	JAN 201
В	ISSUED FOR 100% REVIEW	MAF 201
0	ISSUED FOR TENDER	201

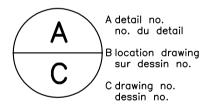

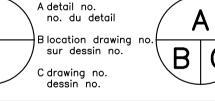

project

TERRA NOVA NATIONAL PARK PARK HOUSING RECAPITALIZATION


HOUSE NO. 6 & 7 ELECTRICAL LAYOUTS

designe	concu	
date	MARCH 2016	
drawn	D.R.	dessine
date	MARCH 2016	
approve	ed	approuve
date		
Tender		Soumission
PWC P	roject Manager	Administrateur de projets TPC


project number

PRO 000610 no. du dessin

CEL. PROJECT NO. 15-2023

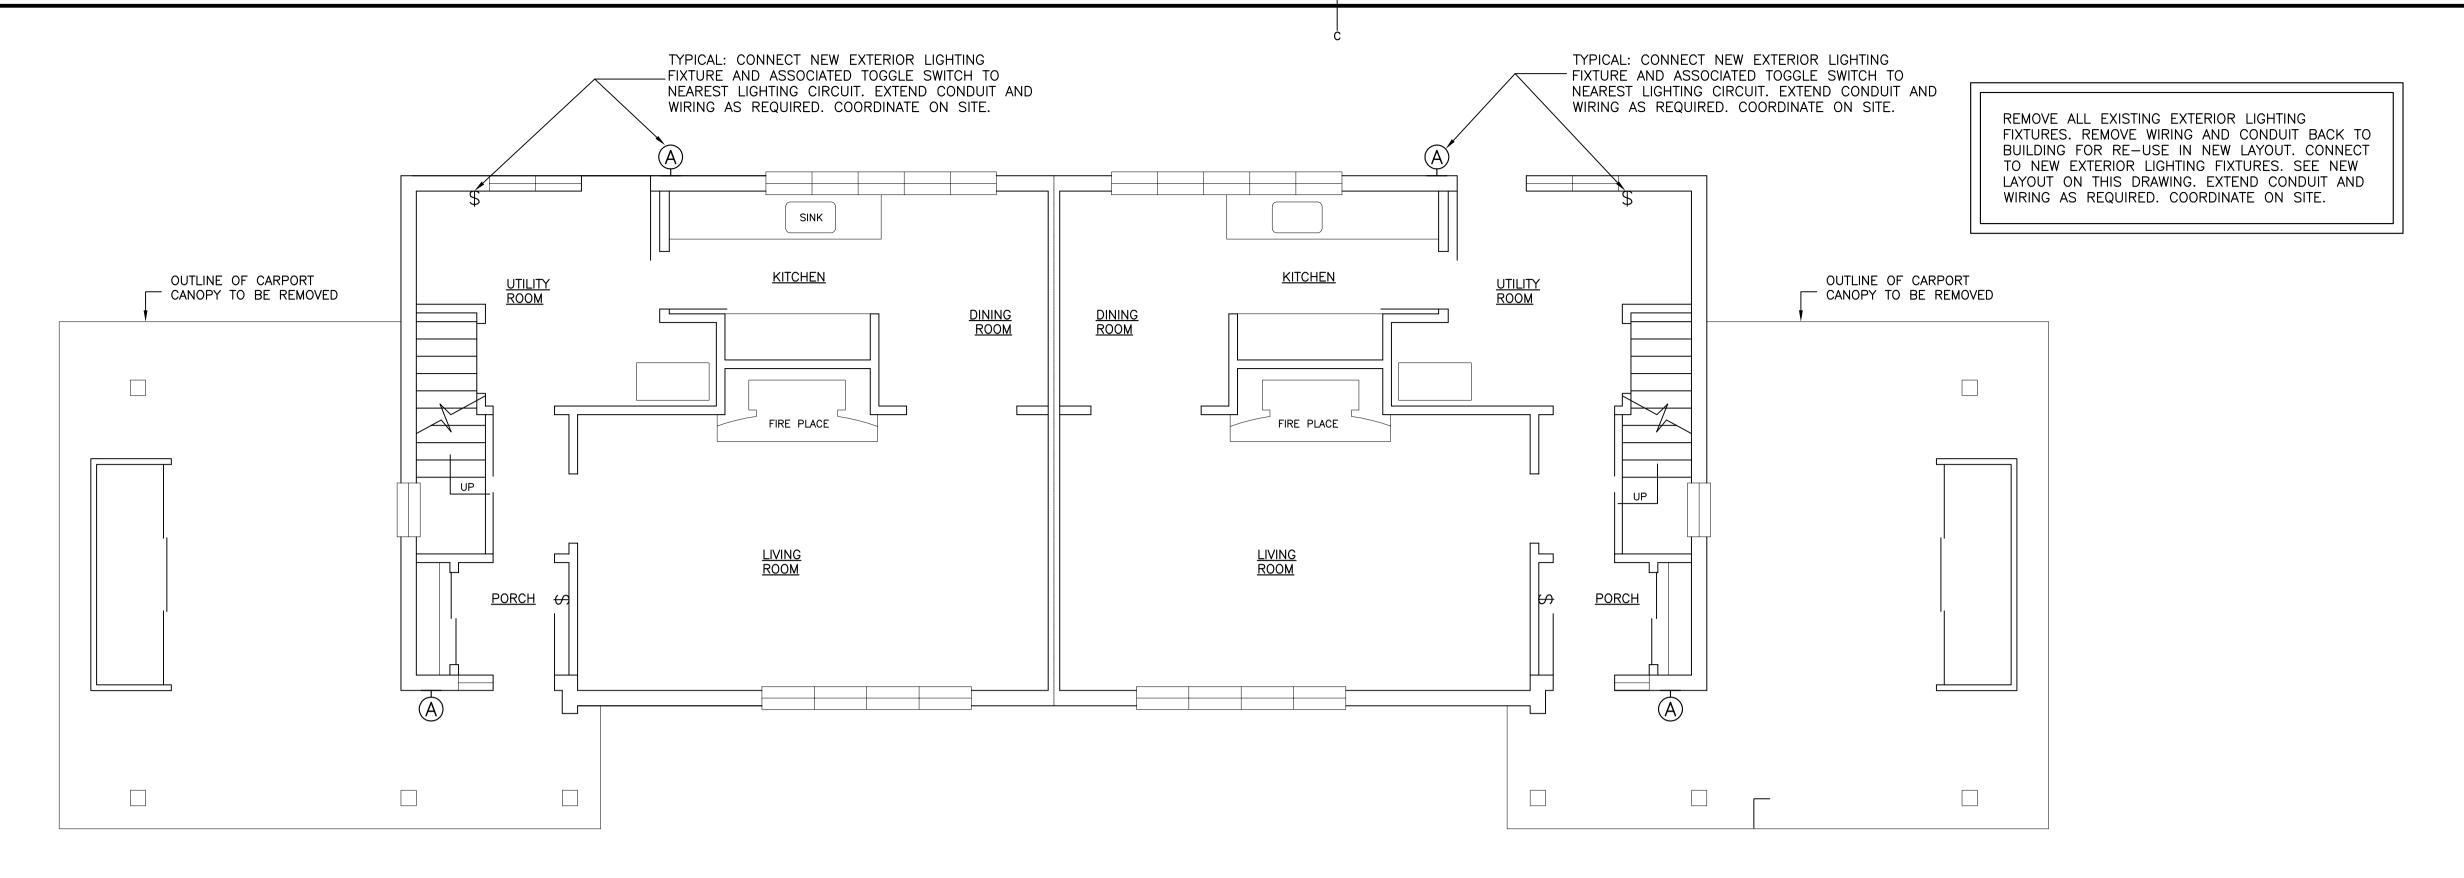

HOUSE NO. 8 & 9 MAIN FLOOR PLAN - ELECTRICAL LAYOUT SCALE: 1:50

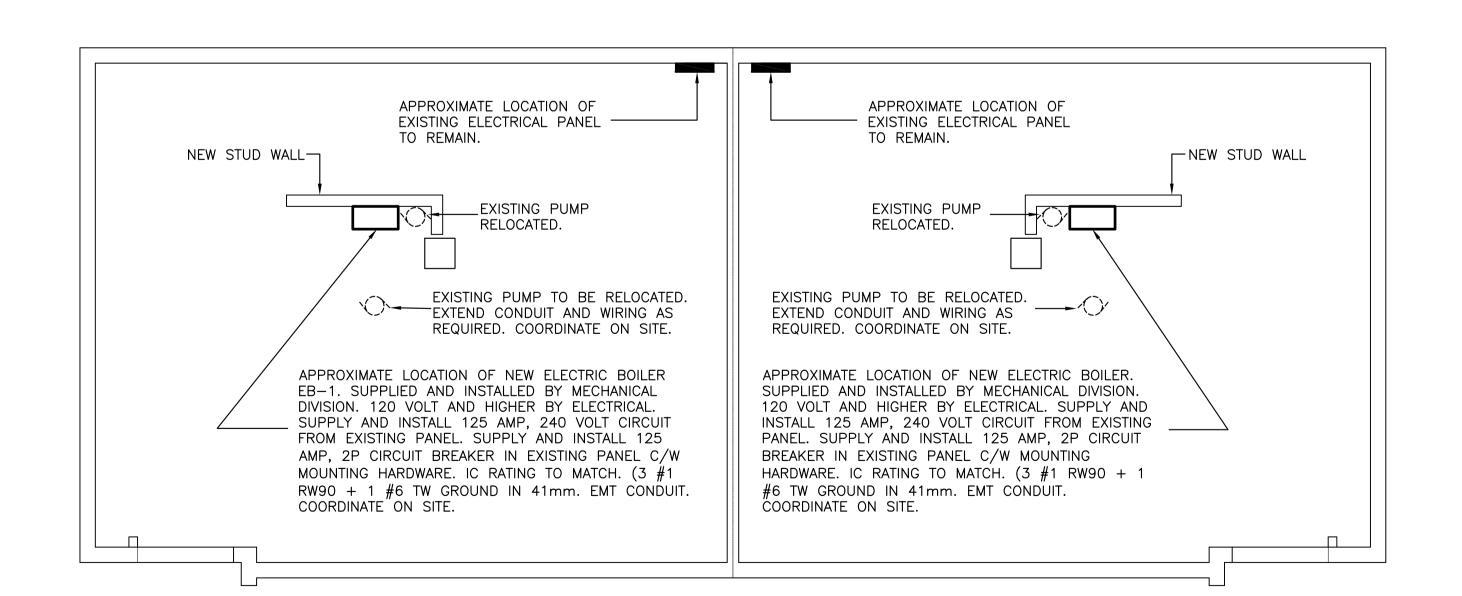


HOUSE NO. 8 & 9 BASEMENT FLOOR PLAN - ELECTRICAL LAYOUT


SCALE: 1:50 0m 1m

Public Works and Travaux Publics et
Government Services Services gouvernementaux Canada

> PROVINCE OF NEWFOUNDLAND PERMIT HOLDER This Permit Allows CROSBIE ENGINEERING LIMITED To practice Professional Engineering in Newfoundland and Labrador Permit No. as issued by PEG-NL D0123 which is valid for the year 2016. KENNETH R.P. NEIL

0	ISSUED FOR TENDER	MAI 201
В	ISSUED FOR 100% REVIEW	MAI 20
Α	ISSUED FOR 66% REVIEW	JAN 20
revisions		do

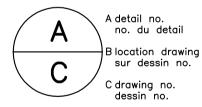

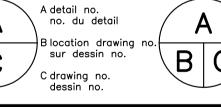

TERRA NOVA NATIONAL PARK PARK HOUSING RECAPITALIZATION

HOUSE NO. 8 & 9 ELECTRICAL LAYOUTS

designed K.N. concu date MARCH 2016 drawn D.R. dessine date MARCH 2016 approuve Soumission PWC Project Manager Administrateur de projets TPC

project number PRO 000610

no. du dessin

CEL. PROJECT NO. 15-2023