


GREENHOUSE - O/H HEATING PLAN

SCALE: 1:50

0m 1m 2m 3m 4m 5m

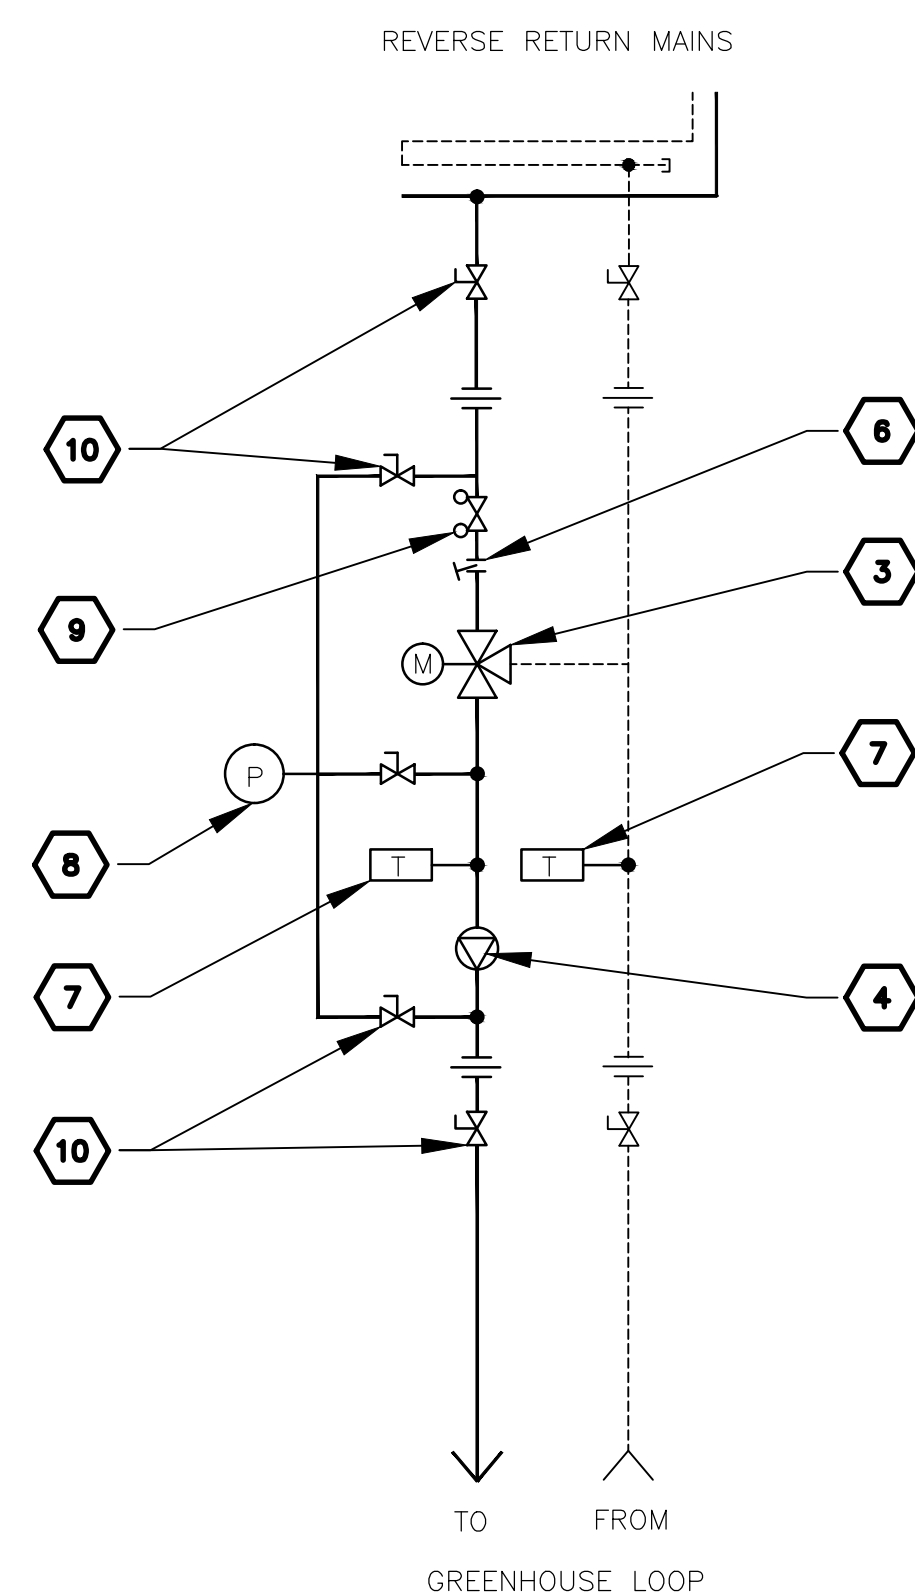

TYPICAL MIXING GROUP  
NTS.

KEYED NOTES:

- 1-  $\phi 75\text{mm}$  SCH 40, CONNECT TO HWS FROM THE EXISTING GREENHOUSE
- 2-  $\phi 75\text{mm}$  SCH40, CONNECT TO HWR TO THE EXISTING GREENHOUSE
- 3- 3 WAY MIXING VALVE (TYP.)
- 4- CIRCULATING PUMP (TYP.)
- 5- 32mm ALUM. FINNED PIPE (TYP.)
- 6- STRAINER
- 7- TEMPERATURE GAUGE
- 8- PRESSURE GAUGE
- 9- BALANCING VALVE
- 10- ISOLATION VALVE
- 11- PIPE DROP (TYP.)
- 12- PIPE RISER (TYP.)
- 13- 2 WAY MIXING VALVE

GENERAL NOTES:

- PROVIDE AND INSTALL AUTOMATIC AIR VENTS AT HIGH POINTS.
- PROVIDE AND INSTALL SEDIMENT DRAINS AT LOW POINTS.
- REFER TO THE MECHANICAL AND CIVIL DRAWINGS FOR INTERCONNECTIONS BETWEEN THE GREENHOUSE SYSTEMS AND THE EXISTING SYSTEMS IN THE FACILITY.



**ghe**  
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GREENHOUSE EXTENSION

Designed by  
AT

Drawn by  
AE

Approved by  
BRAD SITARZ

PWGSC Project Manager  
Administrateur de Projets TPSGC

Drawing title  
Titre du dessin

GREENHOUSE  
OVERHEAD HEATING  
PLAN

Project no./No. du projet  
R.076333.001

Drawing no./No. du dessin  
GHM-01

Revision no.  
0