

ghe

Greenhouse Engineering

86 Glenview Avenue, Toronto, Ontario M4R 1P6, Canada  
Tel: (416) 489 3816 Fax: (416) 481 3883

PUBLIC WORKS &  
GOVERNMENT SERVICES  
CANADA

Project  
MORDEN, MANITOBA  
101 ROUTE 100, UNIT 100

MORDEN RESEARCH  
AND DEVELOPMENT CENTRE  
GREENHOUSE EXTENSION

Designed by  
AT

Conçu par

Drawn by  
AE

Dessiné par

Approved by

Approuvé par

PWGSC Project Manager  
BRAD SITARZ

Administrateur de Projets TPSGC

Drawing title

Titre du dessin

GREENHOUSE  
INTERNAL ELEVATIONS

Project no./No. du projet

R.076333.001


Drawing no./No. du dessin

GH-07

OF 16

Revision no.


0

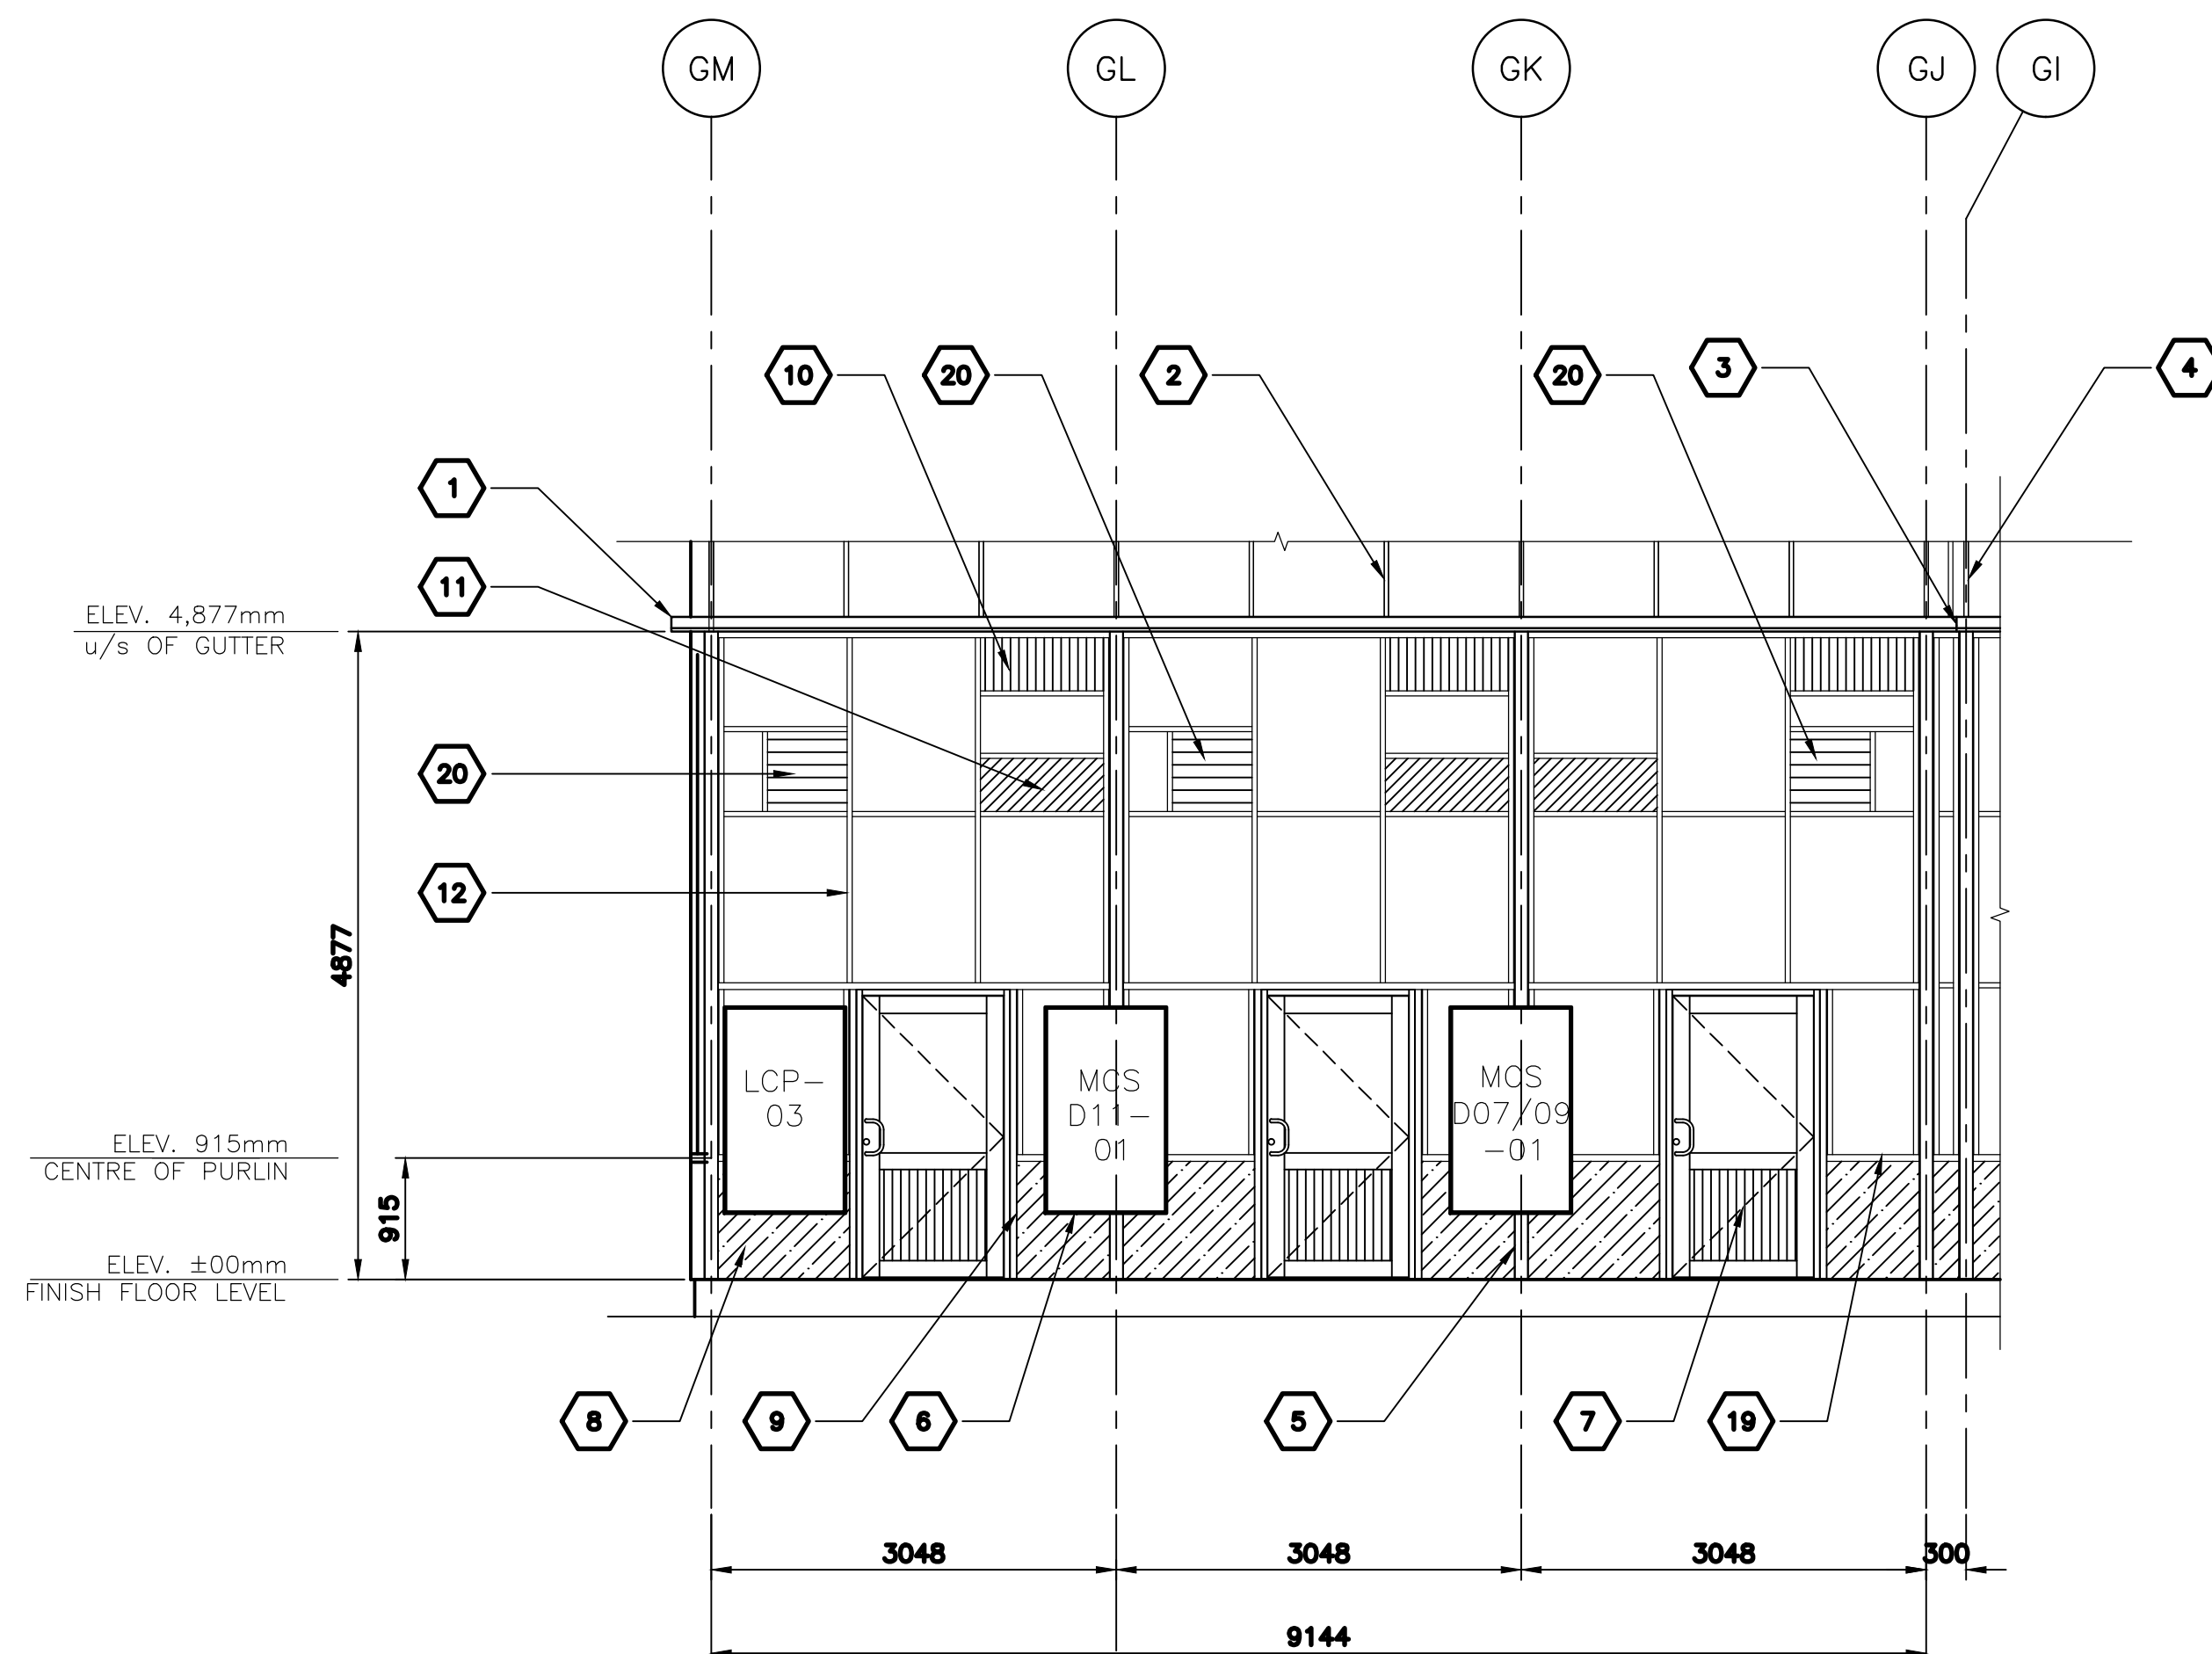

CORRIDOR - EAST ELEVATION

1  
GH-7


SCALE: 1:50  
0m 1m 2m 3m 4m 5m

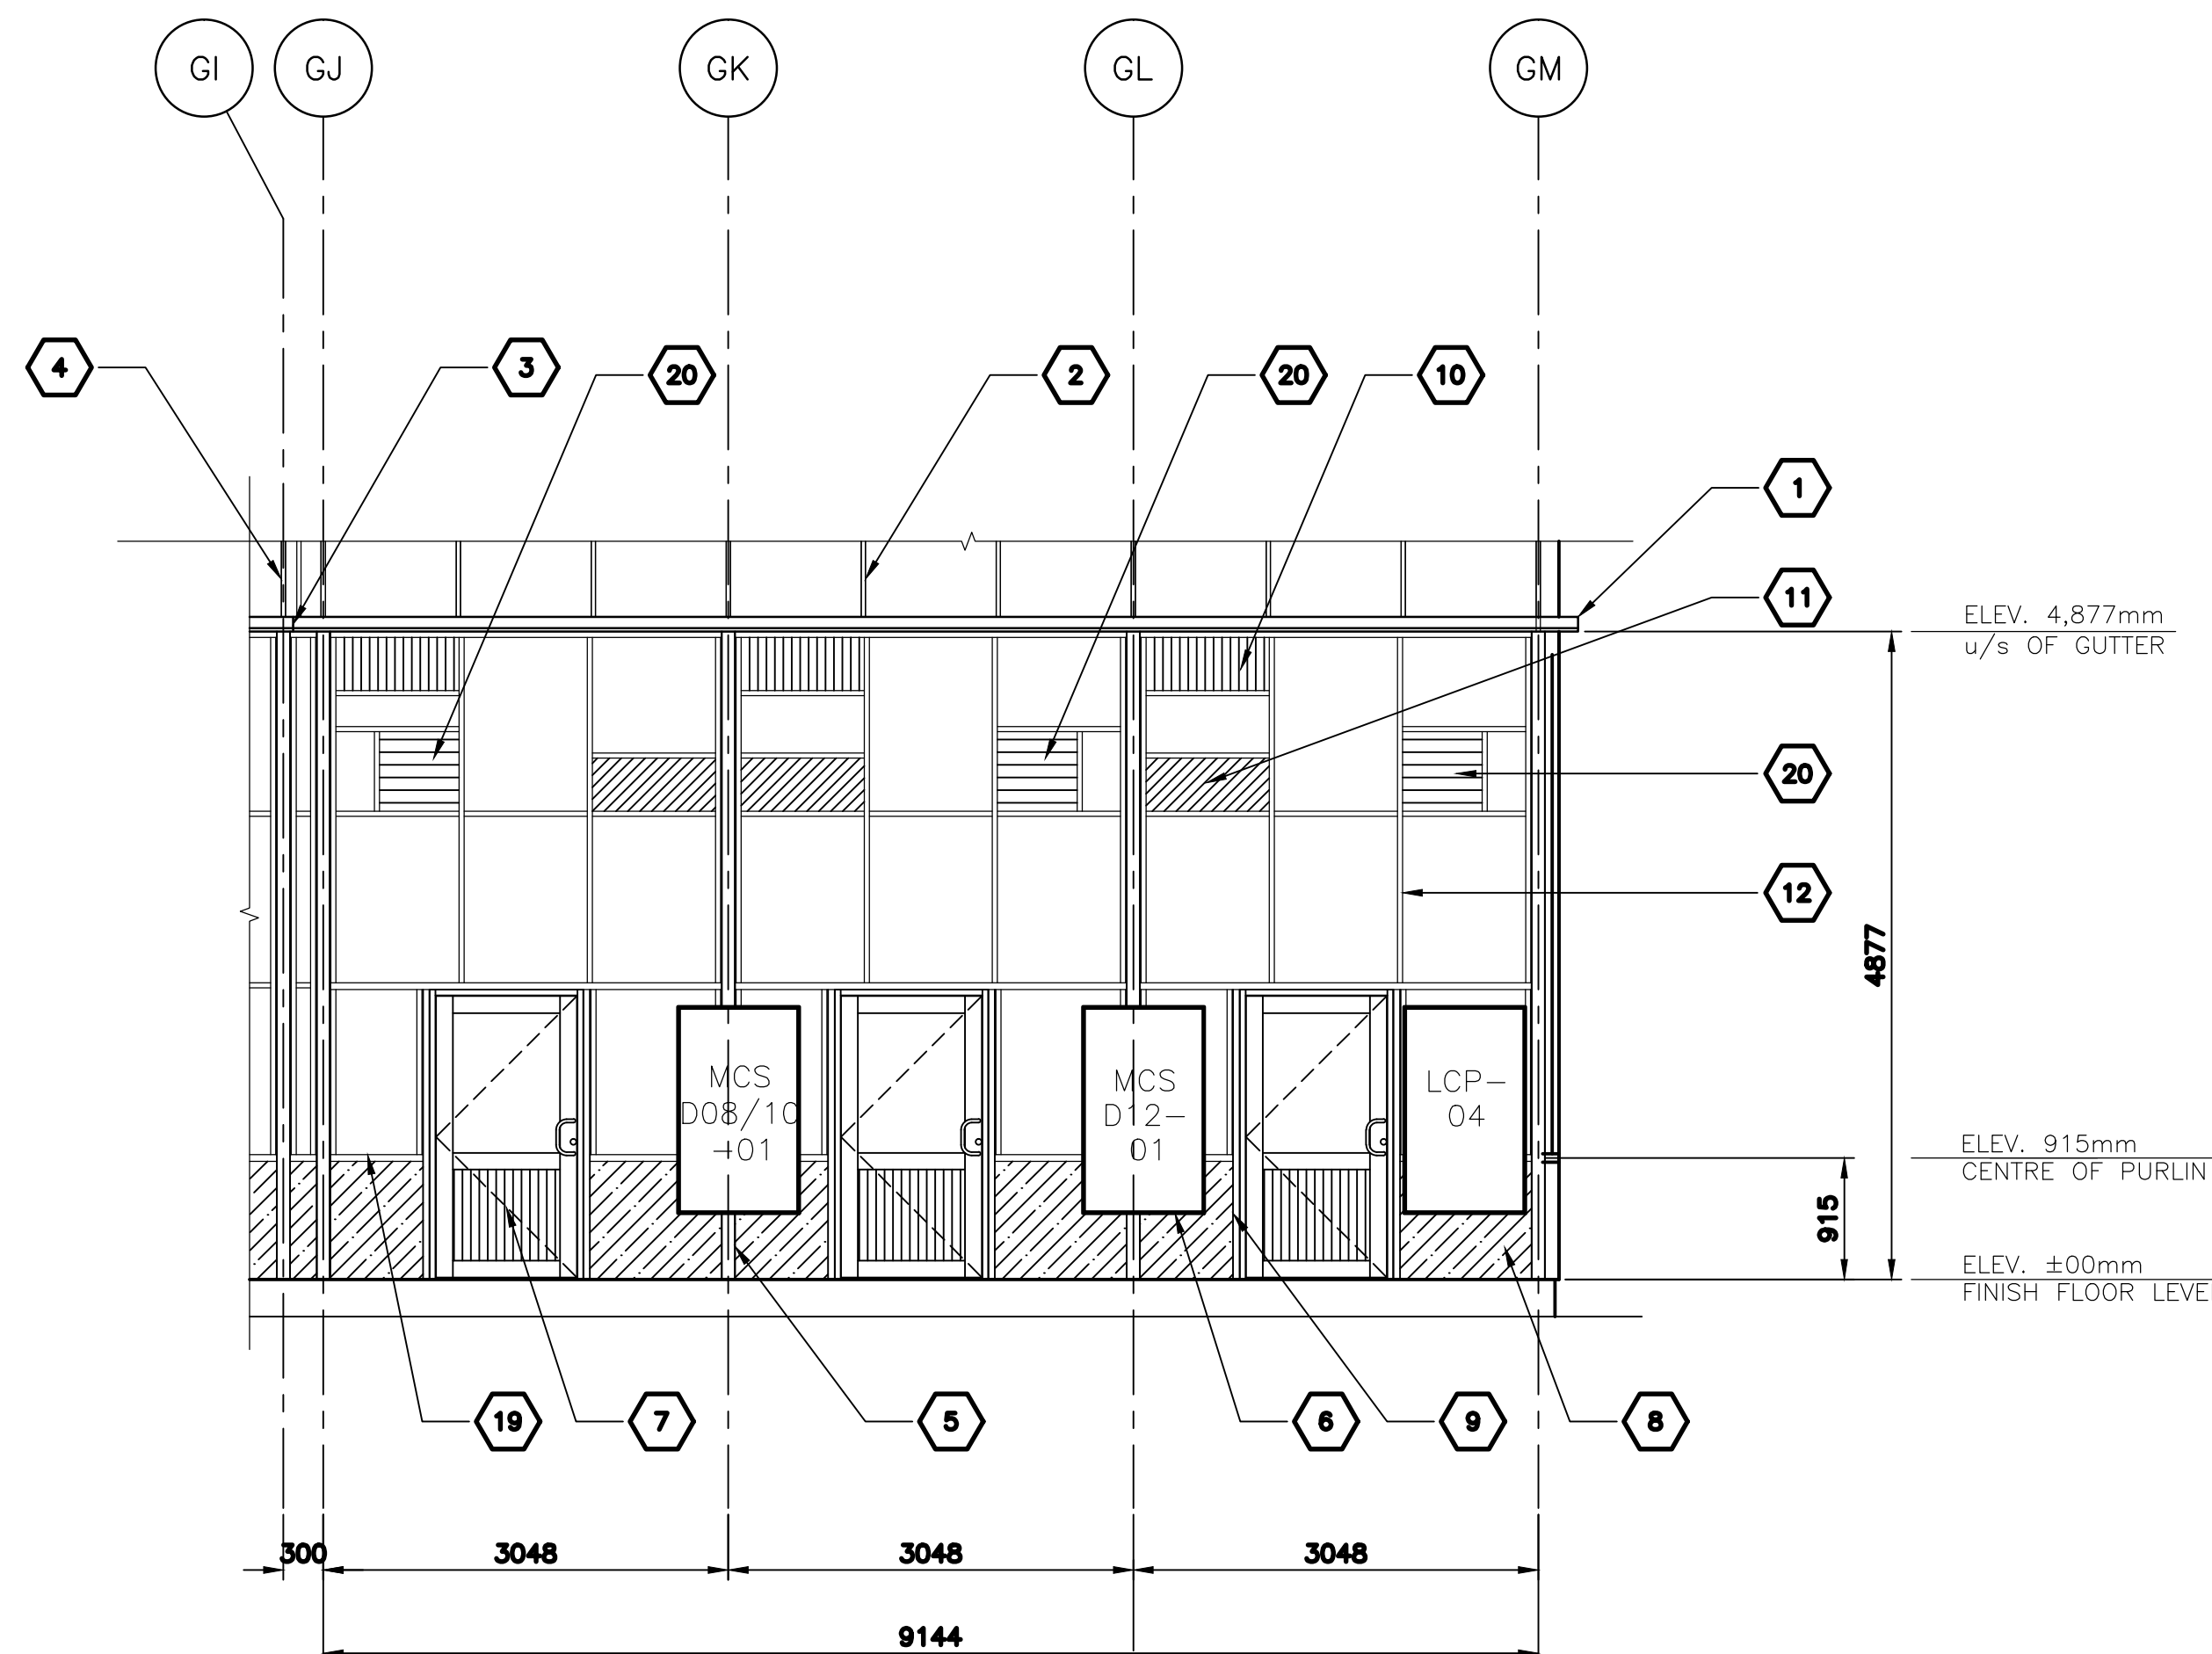

CORRIDOR - WEST ELEVATION

2  
GH-7

SCALE: 1:50  
0m 1m 2m 3m 4m 5m

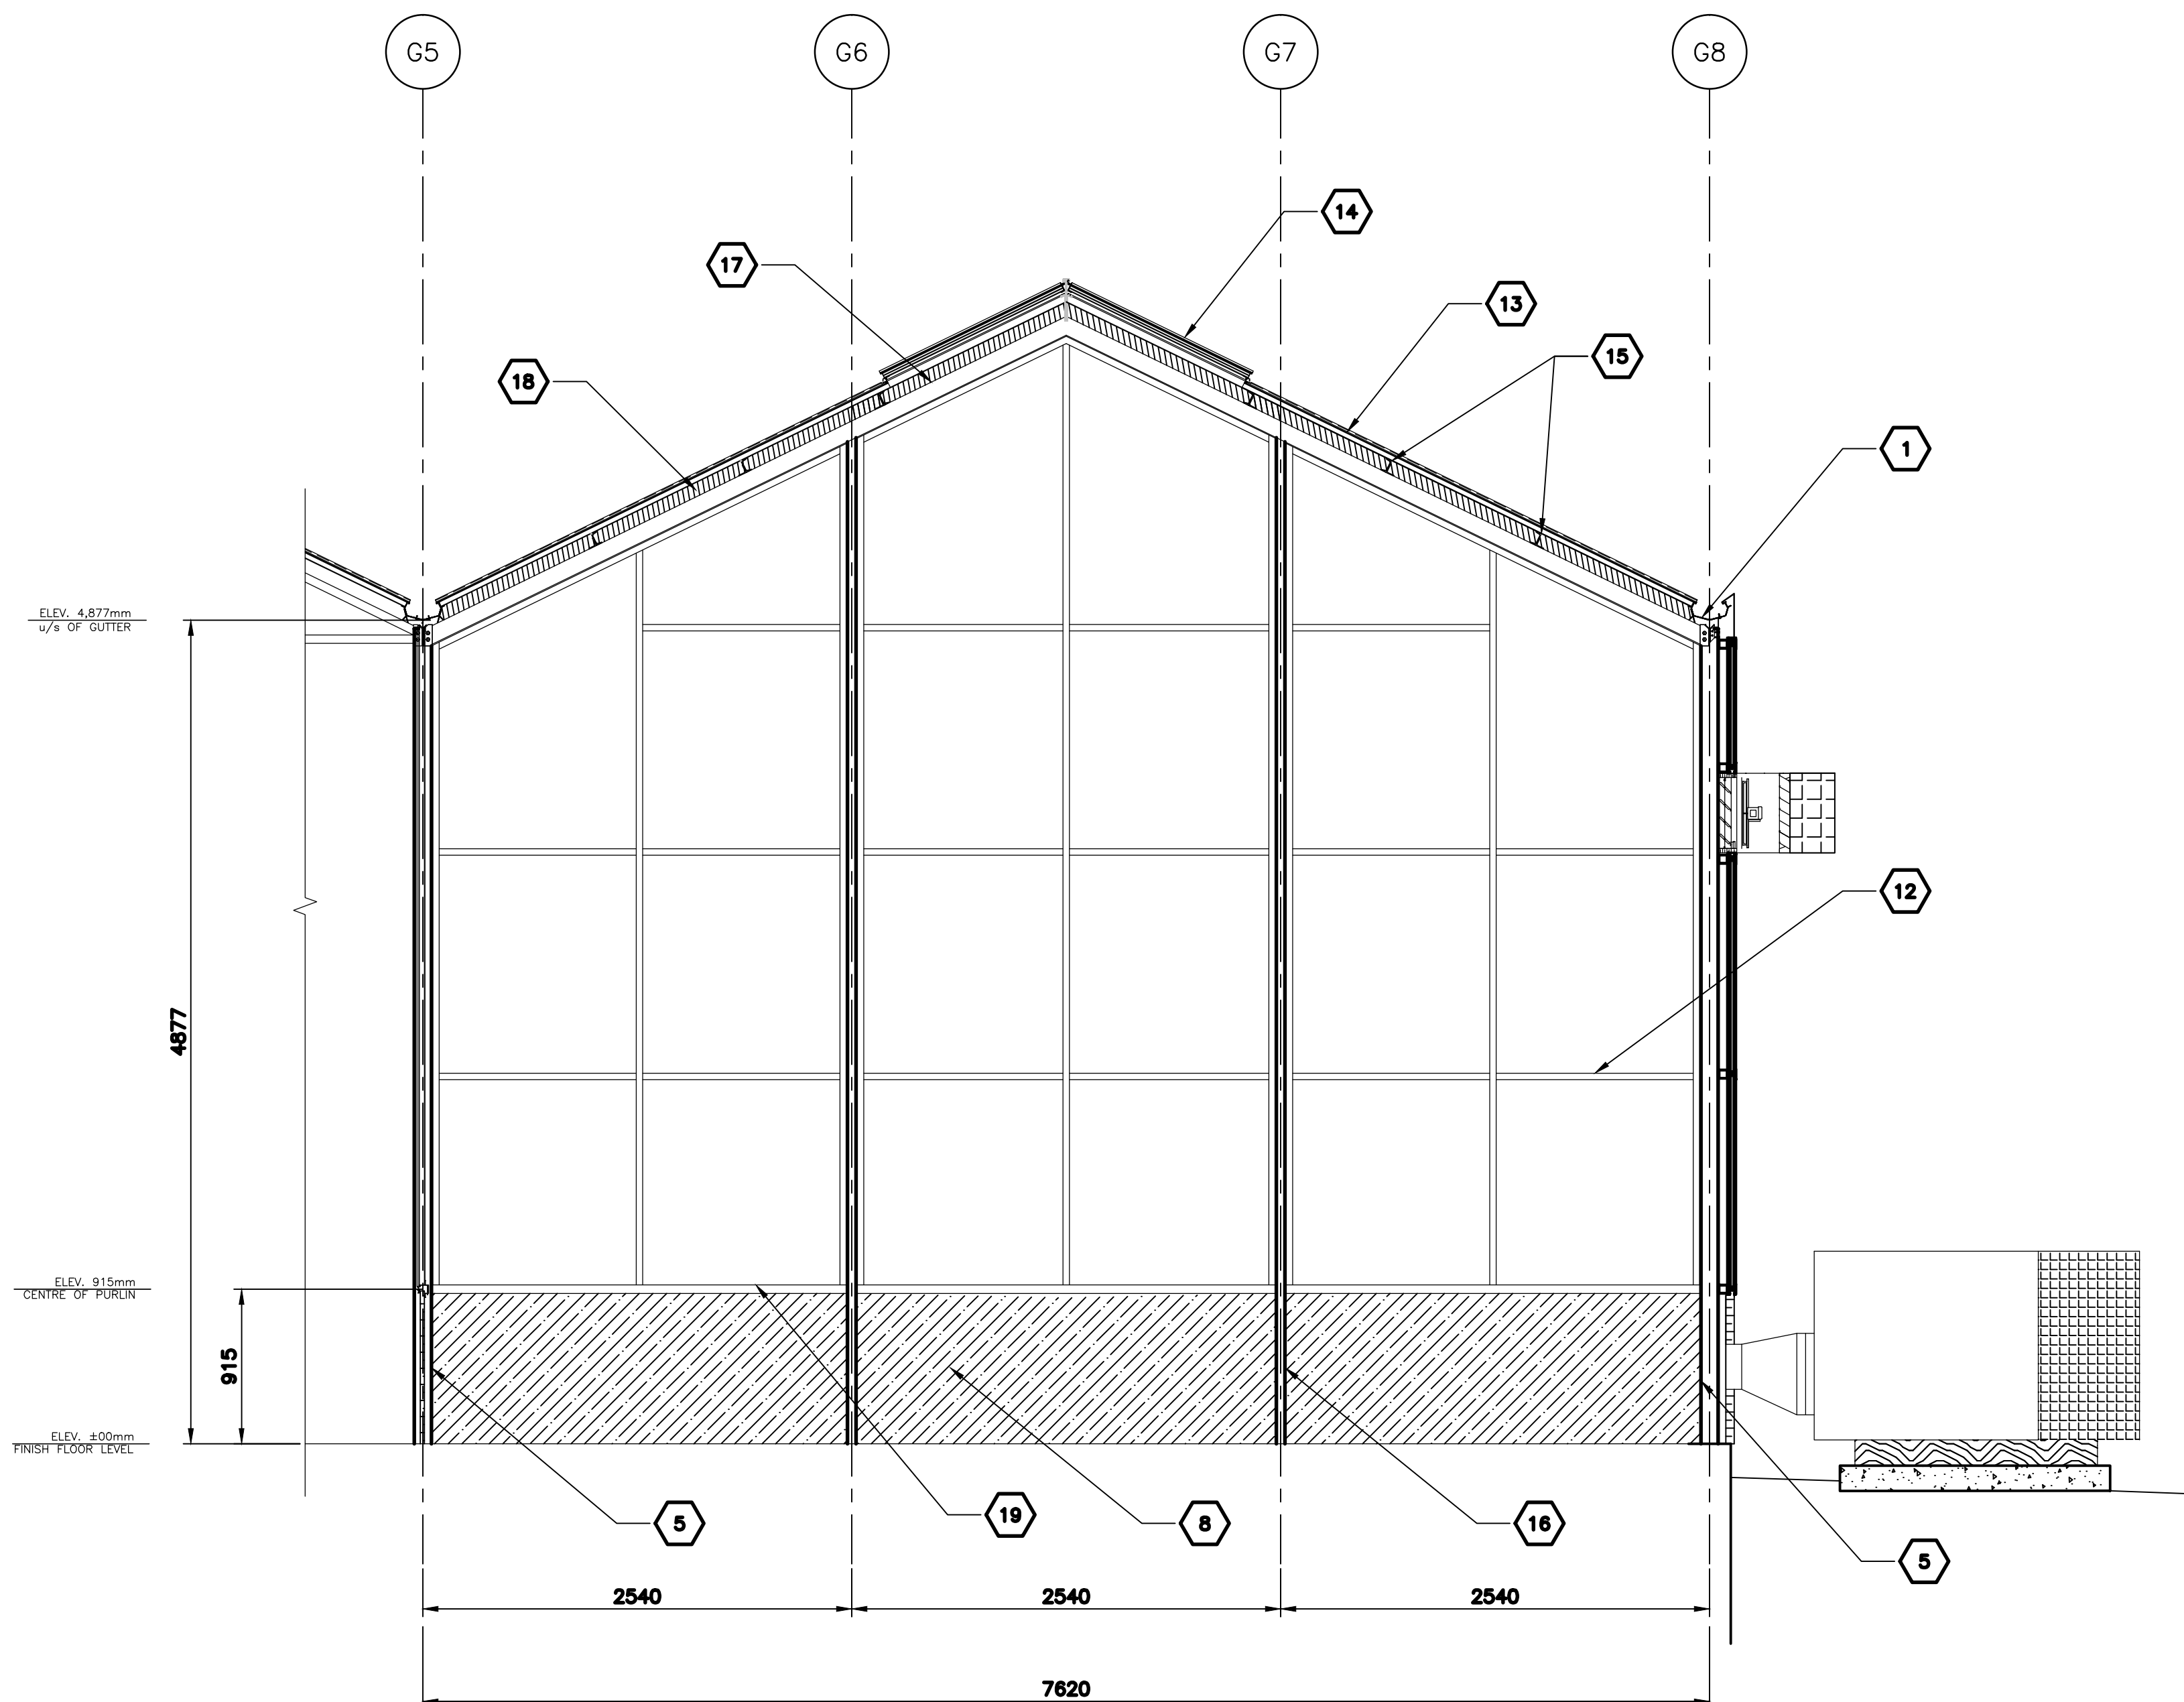

INTERNAL GABLE ELEVATION

3  
GH-7

SCALE: 1:30

KEYED NOTES / NOTES AU PLAN

- 1- ALUM. GUTTER (TYP.)
- 2- ALUM. GLAZING ROOF BARS w/6mm FULLY LAMINATED GLASS UNITS w/FOUR SIDES EDGE SUPPORT
- 3- CONNECT THE NEW GUTTER TO THE EXISTING GUTTER
- 4- EXISTING ROOF
- 5- 100X100mm GALVANIZED HSS POST
- 6- CONTROL PANEL
- 7- 1067mm X 2134mm ALUM. DOOR (TYP.)
- 8- 25mm FOAM SANDWICH PANEL
- 9- 50X100mm GALVANIZED HSS POST (TYP.)
- 10- 4mm ALUM. PANEL FOR MECHANICAL SERVICES TO COMPARTMENT (TYP.)
- 11- 4mm ALUM. PANEL FOR ELECTRICAL SERVICES TO COMPARTMENT (TYP.)
- 12- ALUM. GLAZING BARS w/4mm TEMP. GLASS
- 13- ALUM. GLAZING ROOF BARS w/6mm FULLY LAMINATED GLASS UNITS w/FOUR SIDES EDGE SUPPORT
- 14- 1200mm RIDGE VENT FOR ALL COMPARTMENTS
- 15- ROOF PURLINS
- 16- 50X100mm GALVANIZED HSS GABLE POST (TYP.)
- 17- 50X100mm GALVANIZED HSS GABLE RAFTER
- 18- ALUM. CLOSURE
- 19- ALUM. SILL
- 20- 600mm X 600mm TRANSFER LOUVER WITH MOTORIZED DAMPER