




1 SOUTH ELEVATION  
SCALE: ÉCHELLE: 1/200

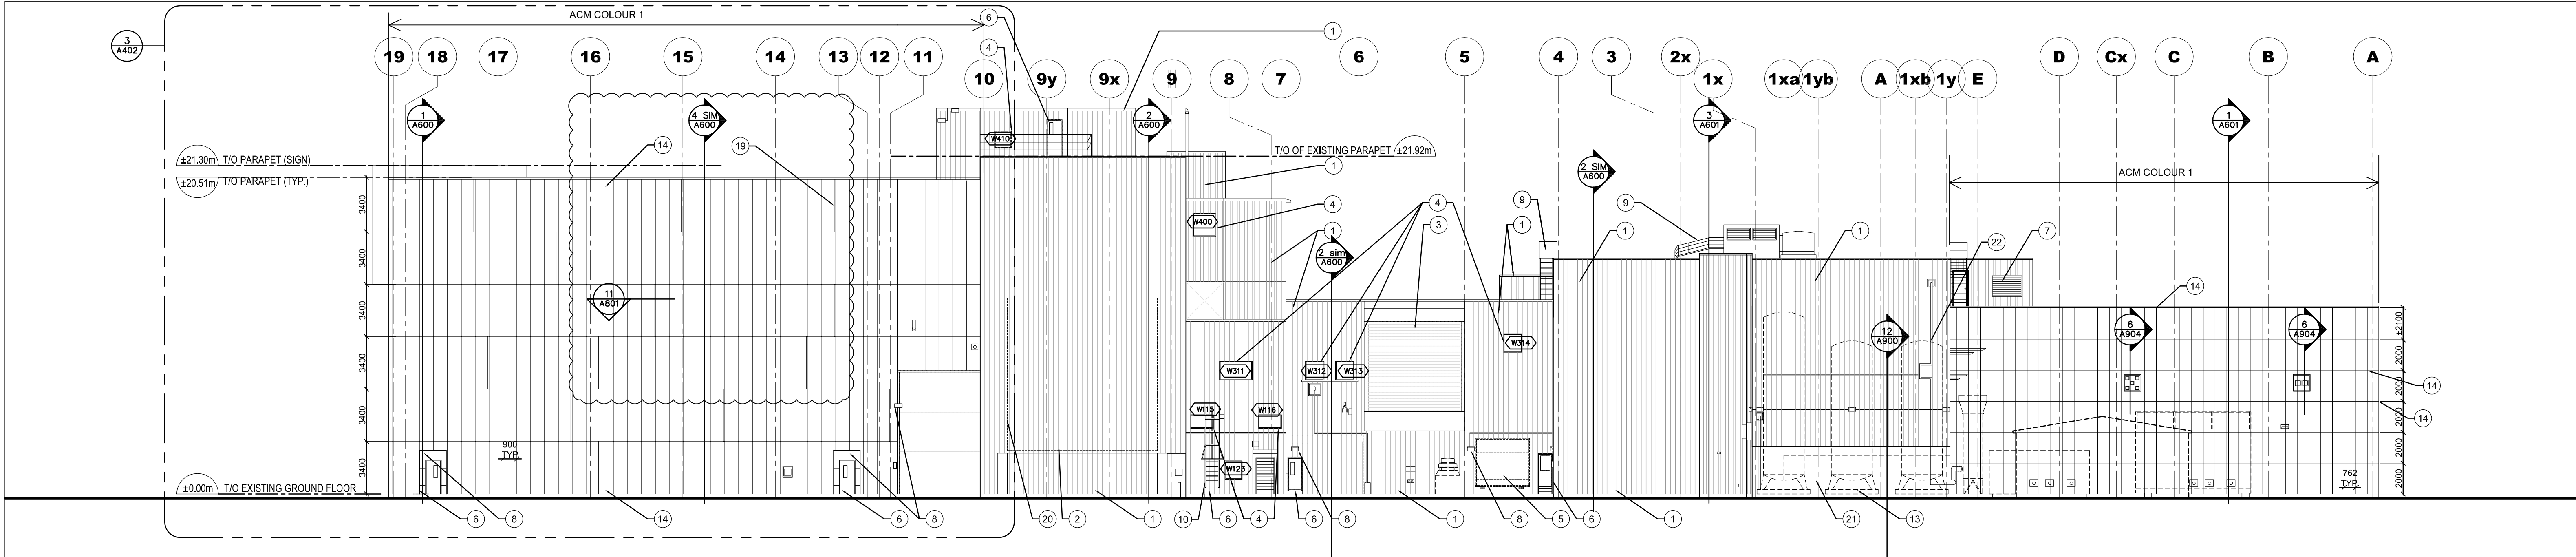

2 NORTH ELEVATION  
SCALE: ÉCHELLE: 1/200

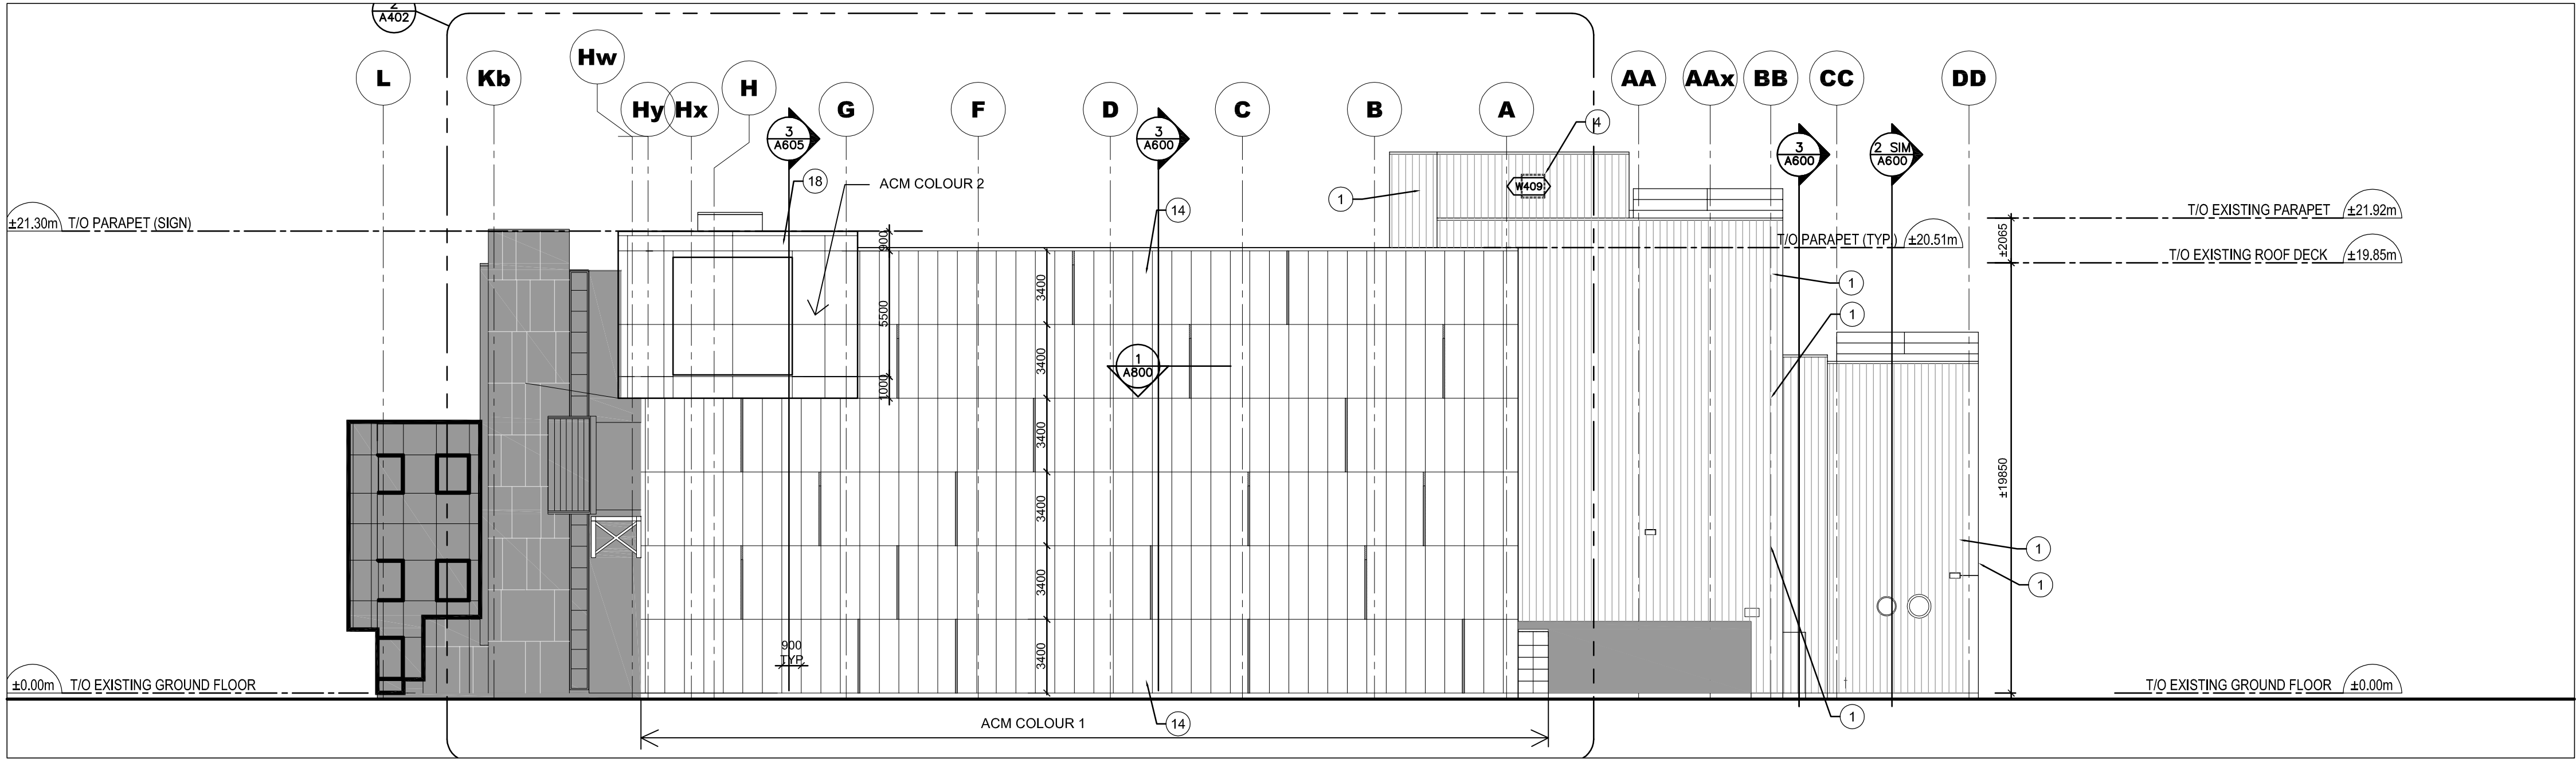

3 EAST ELEVATION  
SCALE: ÉCHELLE: 1/200

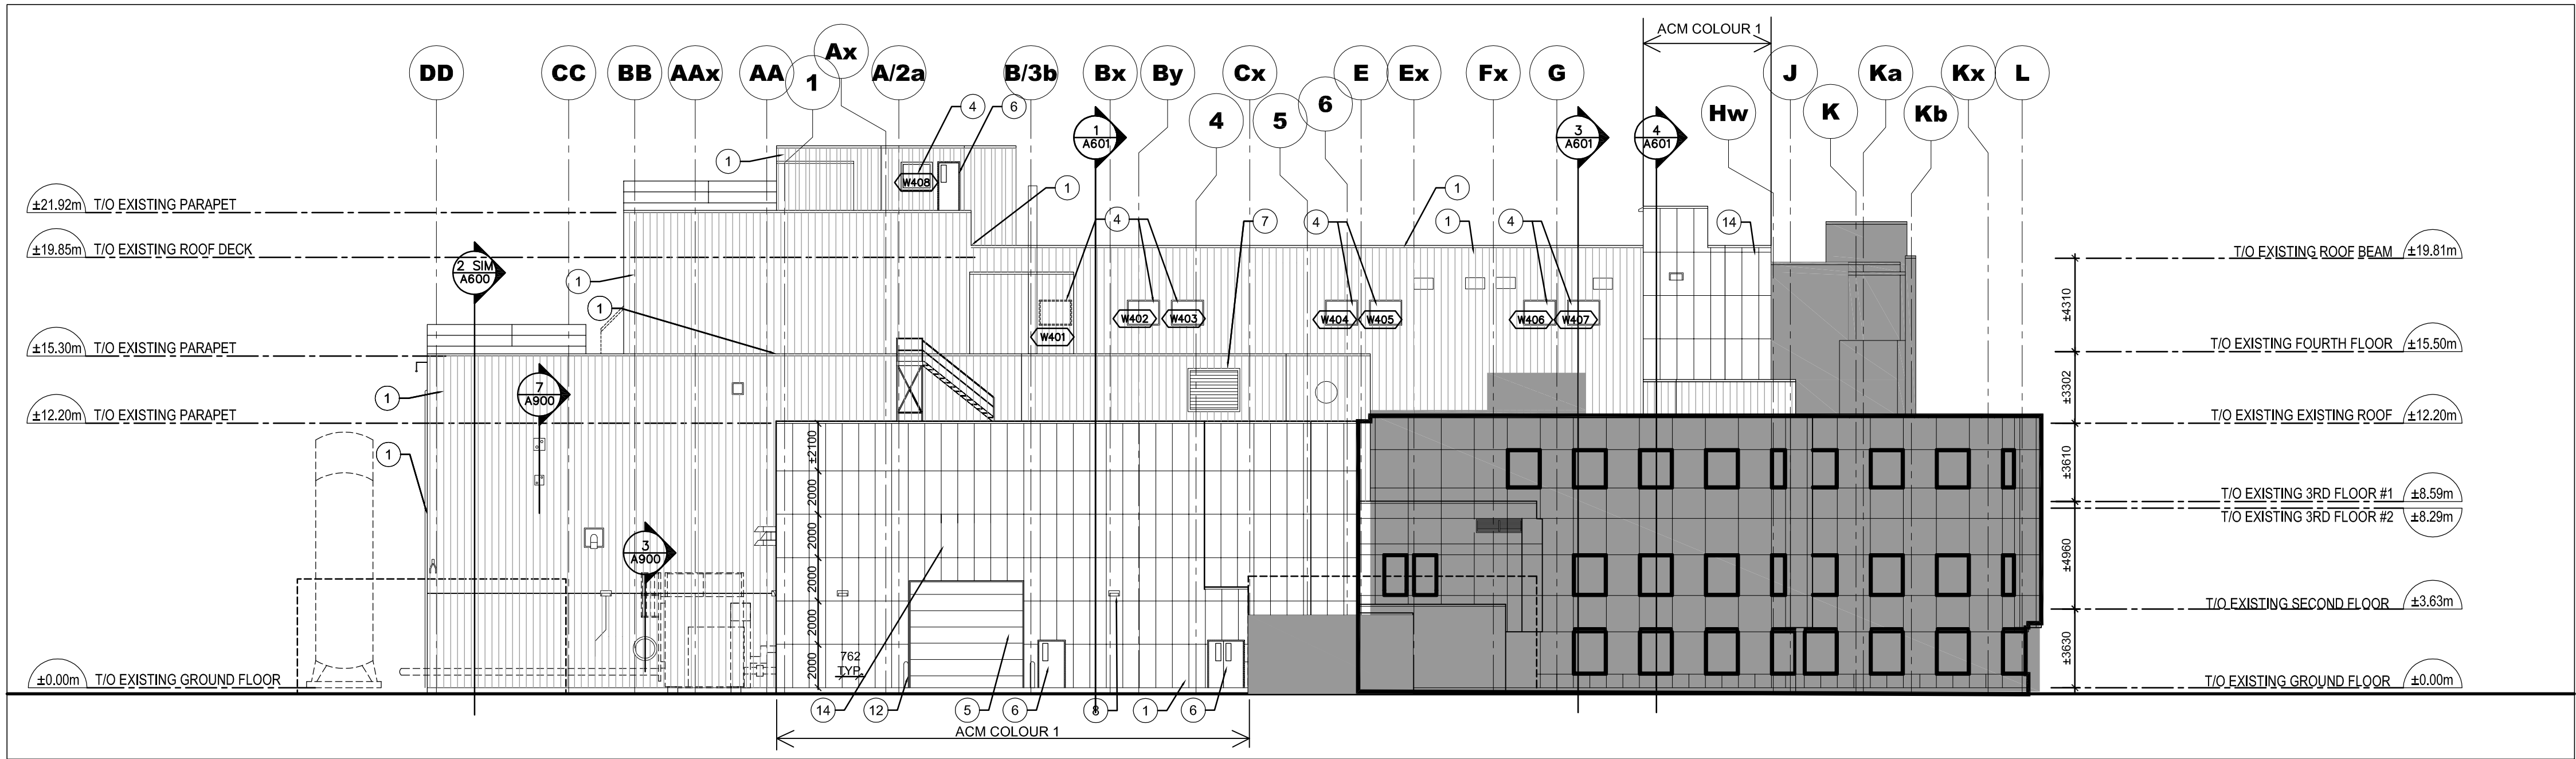

4 WEST ELEVATION  
SCALE: ÉCHELLE: 1/200

#### DRAWING NOTES: ①

- 1 NEW METAL SIDING CLADDING. WALL TYPE W2
- 2 INFILL WALL. REFER WALL SECTIONS AND STRUCTURAL
- 3 NEW MOTORIZED OVERHEAD DOOR C/W FLASHINGS AND TRIM
- 4 NEW THERMALLY BROKEN ALUM FRAMED WINDOWS WITH DOUBLE GLAZED SEALED UNITS WITHIN EXISTING OPENINGS
- 5 EXISTING OVERHEAD DOOR- REPAINTED
- 6 NEW INSUATED METAL DOOR AND FRAME
- 7 NEW VENTS/MECH LOUVRES, REFER MECH SERIES
- 8 NEW EXTERIOR LIGHTING. REFER ELECTRICAL SERIES
- 9 EXISTING ROOF ACCESS STAIRS. RE-PAINT
- 10 NEW ROOF ACCESS LADDERS
- 11 NEW PIPE GUARDRAILS
- 12 EXISTING BOLLARD. RE-PAINT
- 13 EXISTING LIQUID NITROGEN TANKS
- 14 NEW COMPOSITE ALUM PANEL CLADDING.
- 15 LED LIGHT PANELS (ALL WHITE)
- 16 NEW COMPOSITE ALUM PANEL CLADDING.
- 17 NEW CURTAINWALL CLADDING.
- 18 COMPOSITE CLAD SIGNAGE PANELS
- 19 PANEL GAPS (NO LIGHTING THIS ELEVATION)
- 20 INFILLED AREA AT REMOVED OVERHEAD DOOR
- 21 LED LIGHT PANELS ( WHITE WITH RED TOP SECTION)
- 22 RE-INSTALLED NITROGEN PIPING REFER MECH


#### LEGEND:

AREAS NOT IN SCOPE

ALUMINUM COMPOSITE PANELS:  
ACM-1 COLOUR: PEWTER  
ACM-2 COLOUR: BONE WHITE  
METAL SIDING:

MS-1 COLOUR: CHARCOAL  
FLASHINGS:  
MF-1: METAL FLASHING - PEWTER  
MF-2: METAL FLASHING - BONE WHITE  
MF-3: METAL FLASHING - CHARCOAL  
REFER TO SPECIFICATIONS FOR DETAILS

5.		
4.	ISSUED FOR ADDENDUM #1	2016.07.26
3.	ISSUED FOR TENDER	2016.05.09
2.	ISSUED FOR 99% REVIEW	2016.02.08
1.	ISSUED FOR 66% REVIEW	2015.11.17

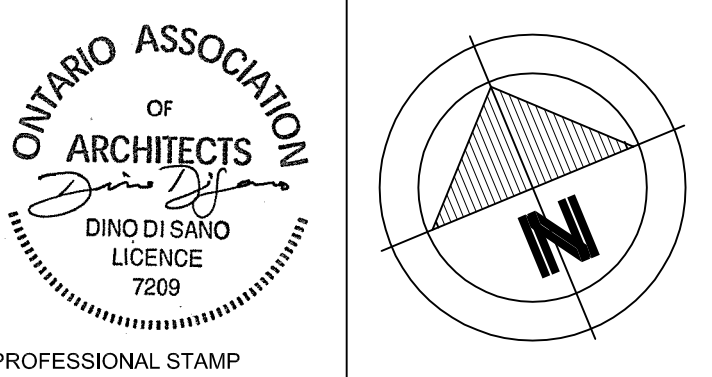

A	A detail no. no. du détail	A
C	B location drawing no. sur dessin no.	B
	C drawing no. dessin no.	C

project  
DAVID FLORIDA LABORATORY  
BUILDING No. 65, SHIRLEY'S BAY, ONTARIO  
BUILDING ENVELOPE REFIT  
PROJECT

drawing  
ELEVATIONS  
dessin

designed	D.S./S.J.	conçu
date	04-08-2016	
drawn	B.H./M.B.	dessiné
date	04-08-2016	
reviewed	B.H.	examiné
date	04-08-2016	
approved	D.S.	approuvé
date	04-08-2016	
scale	as noted	

project no.  
no. du projet  
drawing no.  
no. du dessin  
CSA15-G1  
A-400