



1 ANECHOIC CHAMBER-CONTROL ROOM SHAFT  
SCALE: ÉCHELLE: 1/25

2 ANECHOIC CHAMBER-EXTERIOR WALL  
SCALE: ÉCHELLE: 1/25

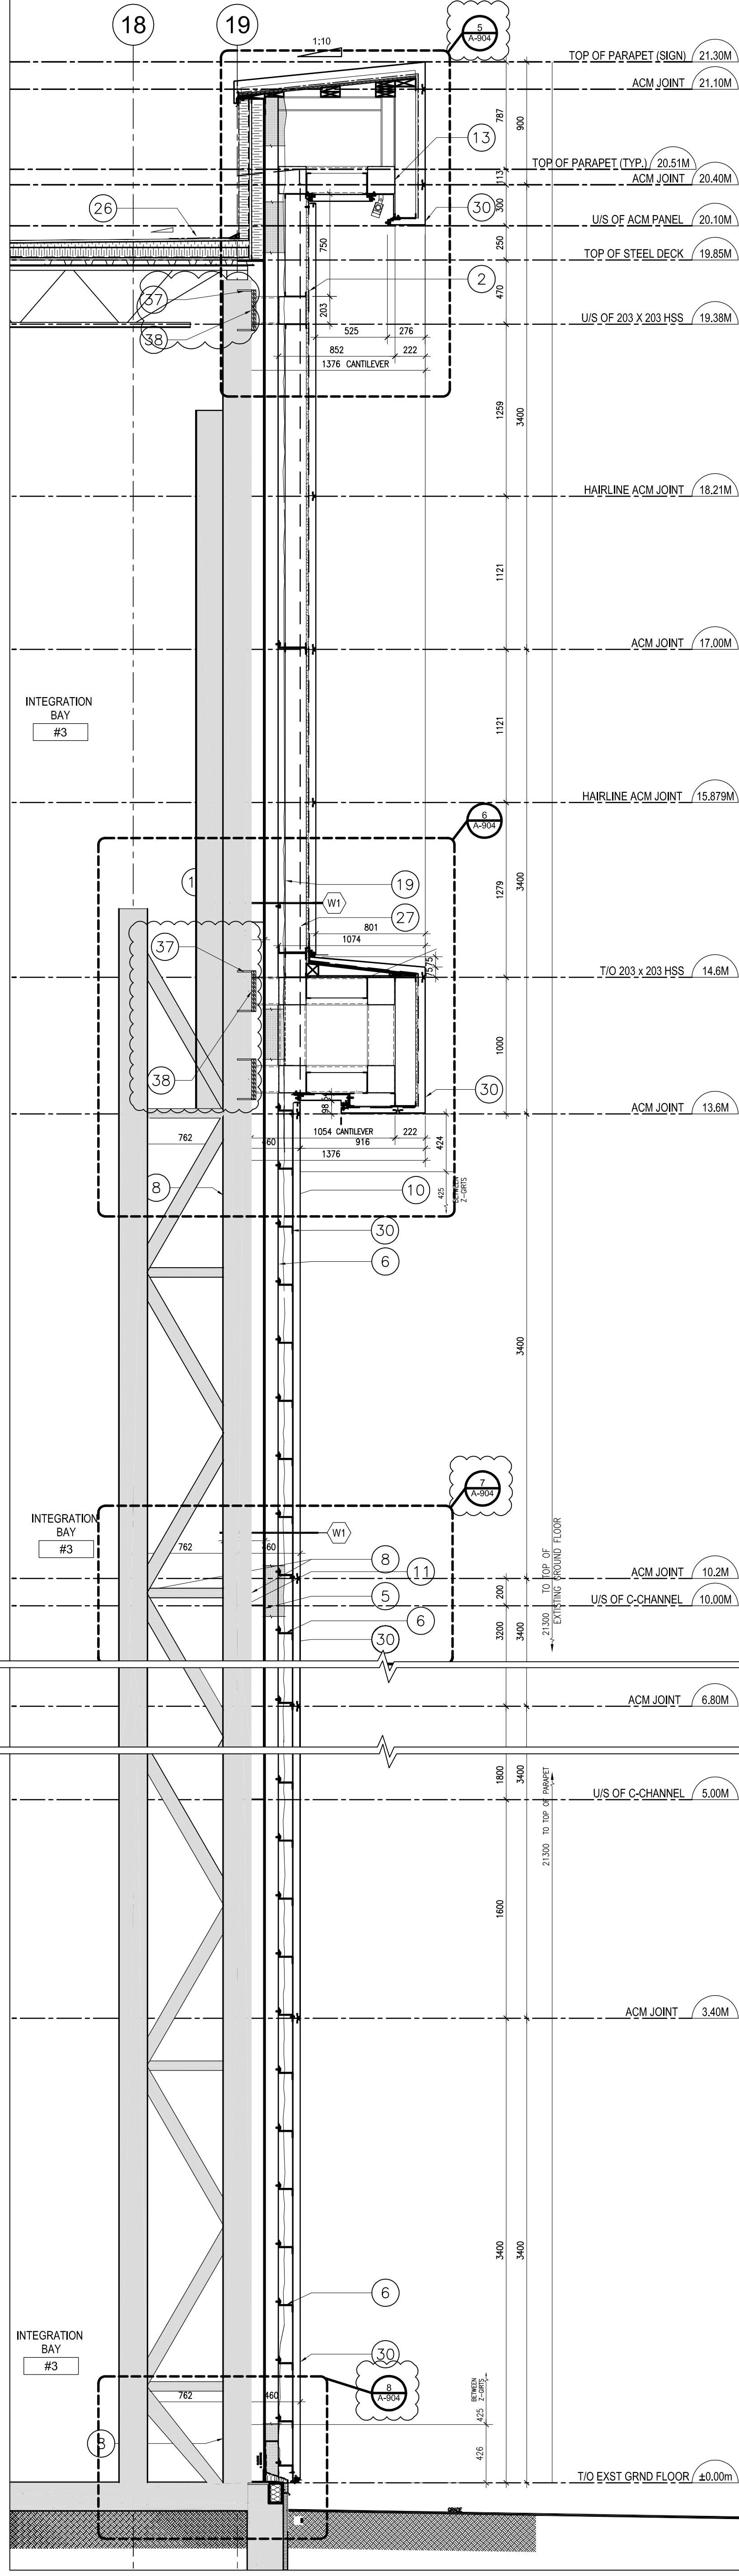

3 ANECHOIC CHAMBER-CONTROL ROOM SHAFT AT BAY 3  
SCALE: ÉCHELLE: 1/25

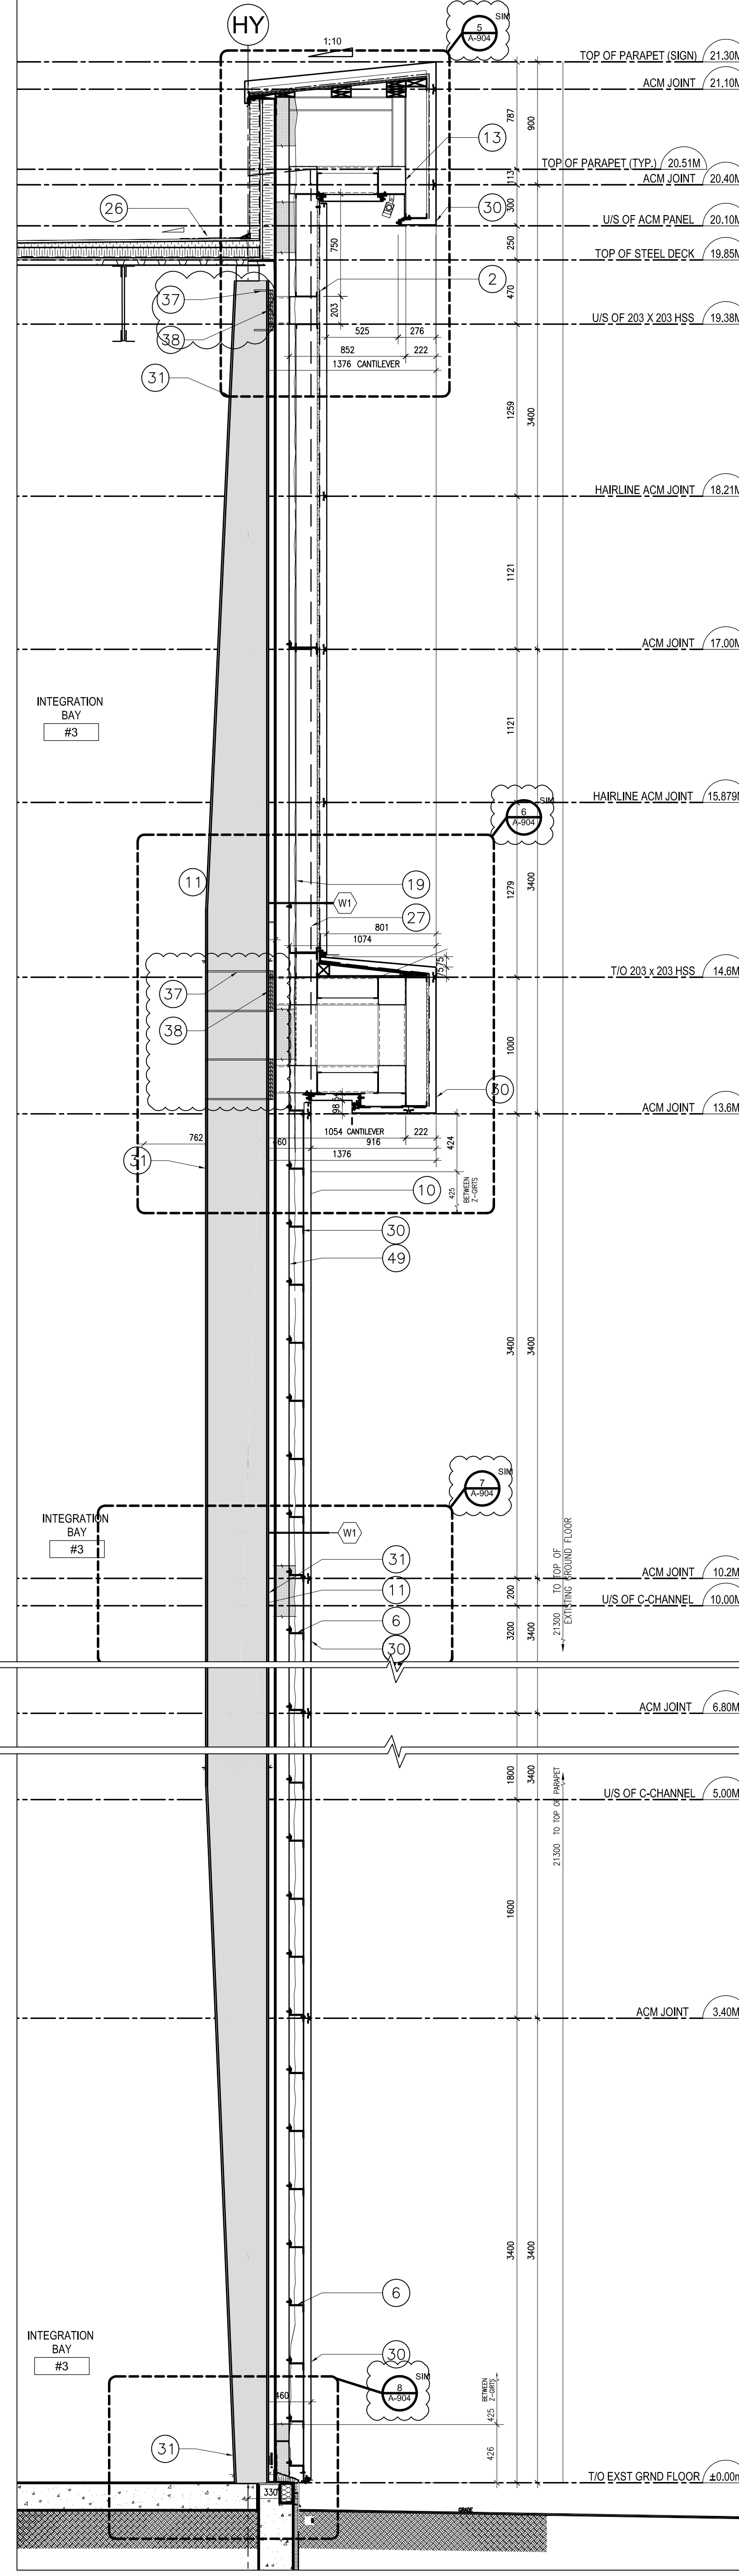

4 ANECHOIC CHAMBER-CONTROL ROOM SHAFT AT BAY 3  
SCALE: ÉCHELLE: 1/25

- DRAWING NOTES: ⑥
- CLOSED CELL FOAM INSULATION
  - CONTINUOUS AV BARRIER
  - PRE-FINISHED METAL STARTER STRIP
  - PRE-FINISHED METAL FLASHING
  - EXISTING LINEAR PANEL
  - 104 Z-GIRT @ 425 O.C.
  - RESERVED
  - W200 X 53 STEEL COLUMN
  - EXISTING CLOSURE ANGLE
  - C-100 X 9 STEEL CHANNEL @ 900 O.C.
  - C310 X 37 EXISTING STEEL CHANNEL @ 5.0M O.C. ±
  - STEEL PLATE
  - 203 X 203 X 6.4
  - INSECT SCREEN
  - INTERMEDIATE ZGIRT 203 DEEP
  - 6MIL CEMENT PARGING
  - CLOSURE PANEL @ CHANNELS
  - RIGID VS SEMI RIGID MINERAL WOOL INSULATION CAVITY TYPE 76MM MAX TAPER TO 38MIN
  - 152 STEEL STUD @ 400 O.C.
  - 16 GYPSUM BOARD
  - 19 EXT. GRADE PLYWOOD C/W WOOD BLOCKING
  - NEW LINEAR PANEL
  - NEW C100 X 9 CHANNEL @ 300 O.C.
  - RESERVED
  - 75MM SEMI RIGID INSULATION
  - REFER TO DETAIL 14-A903 FOR ALL PARAPETS CONNECTING TO EXISTING ROOF
  - EXTEND OF ACM BEYOND
  - 92 STEEL STUD @ 400 O.C.
  - EXISTING ROOF ANGLE
  - FACE OF ACM PANEL
  - W610 CHAMFERED STEEL COLUMN
  - PREFINISHED METAL CAP FLASHING TO MATCH SIDING COLOUR
  - CARRY ROOF MEMBRANE UP AND OVER PARAPET
  - 19MM EXTERIOR GRADE PLYWOOD
  - INTERIOR WORK NOT IN SCOPE
  - CONCRETE PIER TO REMAIN
  - STEEL STIFFENER REFER TO STRUCTURAL
  - STEEL PLATES REFER TO STRUCTURAL

- LEGEND:
- DESIGNATES EXISTING CONSTRUCTION TO REMAIN

Public Works and Government Services Canada / Travaux publics et services gouvernementaux Canada

Canadian Space Agency / Agence spatiale canadienne

Pageau Morel

CLELAND JARDINE ENGINEERING LIMITED

580 TERRY FOX DRIVE, SUITE 200 KANATA, ONTARIO, K2L 4B9  
TEL: (855) 551-1553 FAX: (855) 551-1703  
EMAIL: mail@clelandjardine.com

COLE+Associates ARCHITECTS INC.

5.		
4.	ISSUED FOR ADDENDUM #1	2016.07.26
3.	ISSUED FOR TENDER	2016.05.09
2.	ISSUED FOR 99% REVIEW	2016.02.08
1.	ISSUED FOR 66% REVIEW	2015.11.17

No.	Revision	Date

PROFESSIONAL STAMP

ONARIO ASSOCIATION OF ARCHITECTS  
DINO DI SANIO  
LICENCE 7259

A detail no. no. du détail  
B location drawing no. sur dessin no.  
C drawing no. dessin no.

A B C

project project

DAVID FLORIDA LABORATORY  
BUILDING No. 65, SHIRLEY'S BAY, ONTARIO

BUILDING ENVELOPE REFIT PROJECT

drawing dessin

WALL SECTIONS

designed D.S./S.J. concu  
date 04-08-2016  
drawn B.H./M.B. dessine  
date 04-08-2016  
reviewed B.H. examine  
date 04-08-2016  
approved D.S. approuve  
date 04-08-2016  
scale as noted

project no. no. du projet  
CSA15-G1  
drawing no. no. du dessin  
A-605