



1 RESERVED
SCALE: ÉCHELLE - 1:25
A604



2 ANECHOIC CHAMBER SHAFT SECTION
SCALE: ÉCHELLE - 1:25
A604

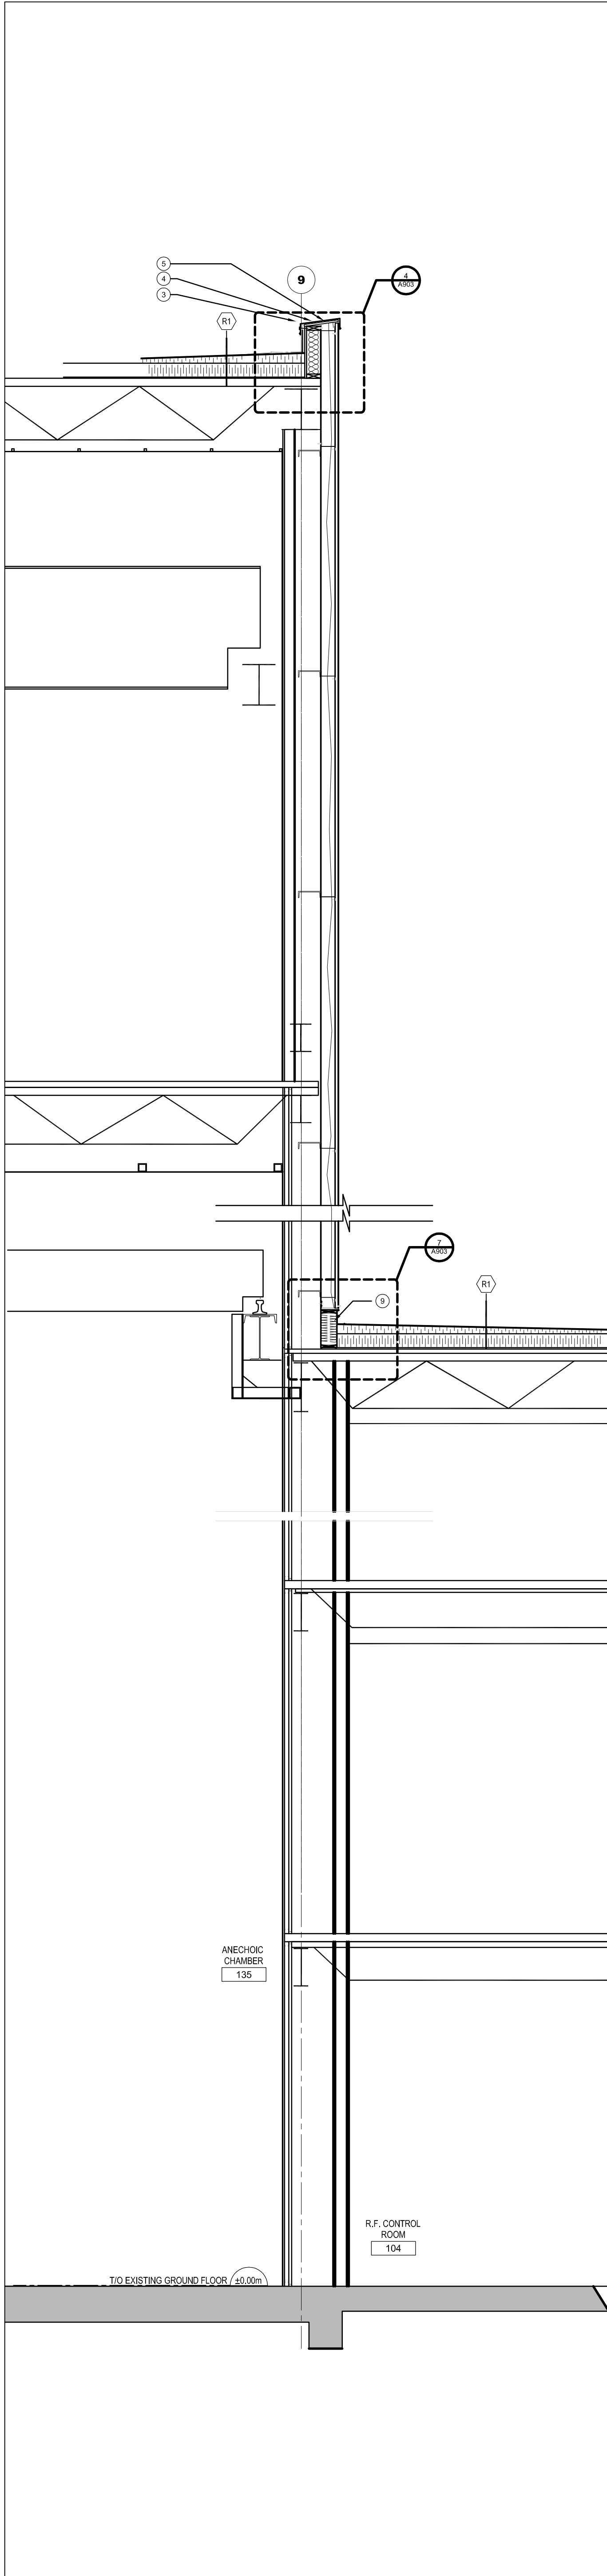

3 RESERVED
SCALE: ÉCHELLE - 1:25
A604

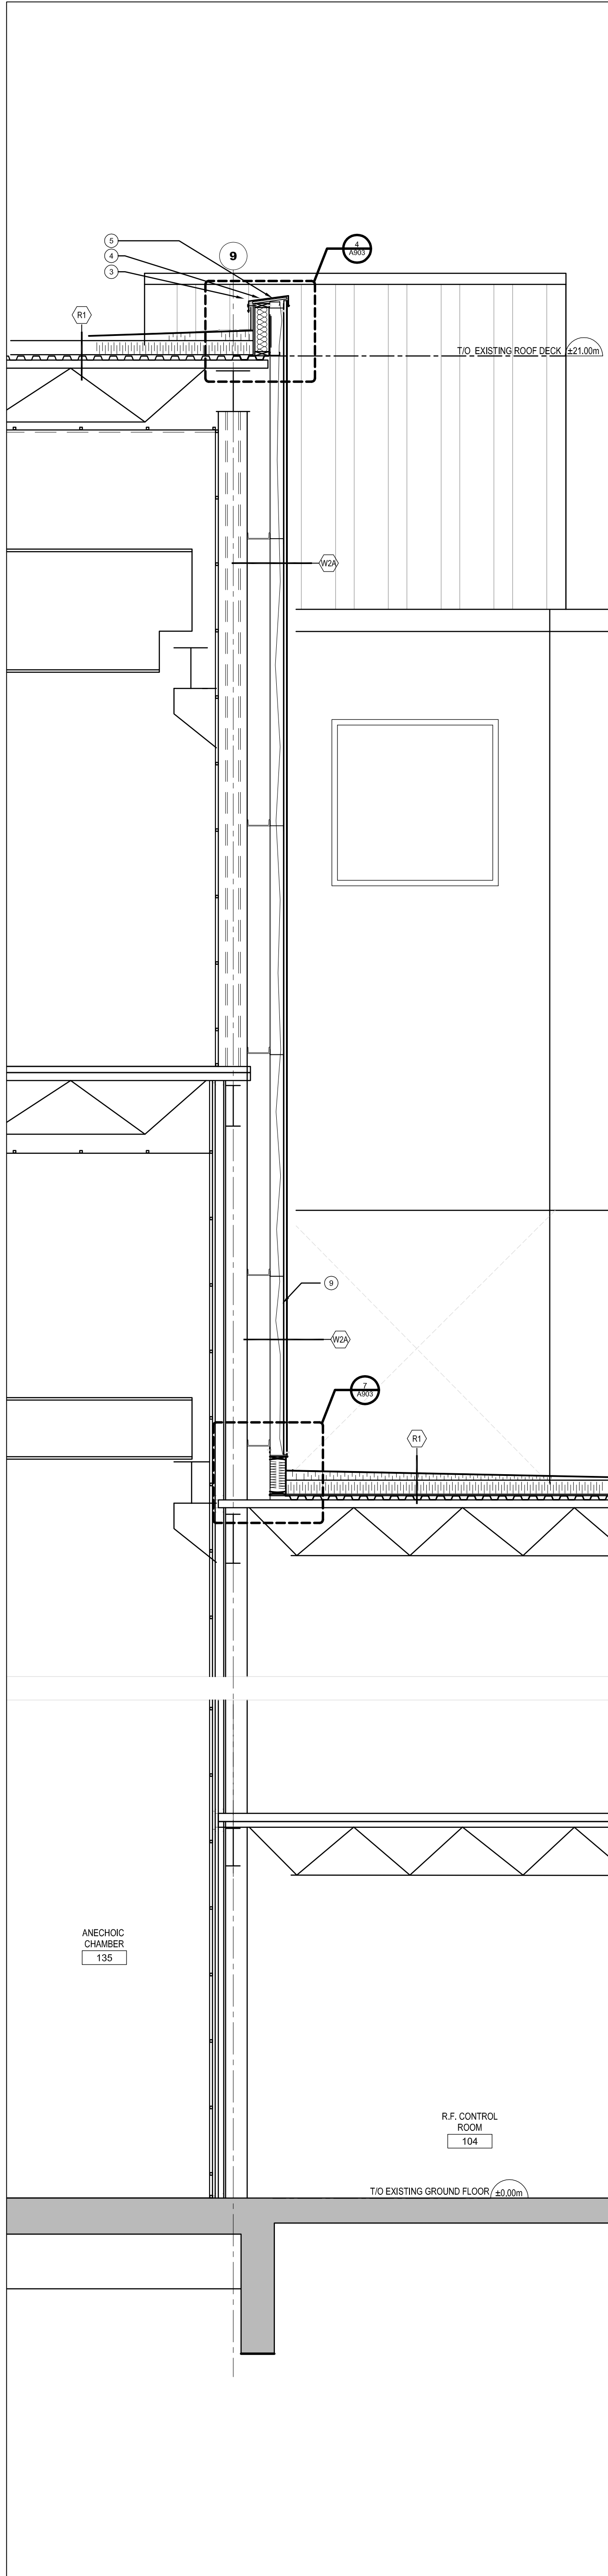


4 ANECHOIC CHAMBER - OFFICE SECTION
SCALE: ÉCHELLE - 1:25
A604

DRAWING NOTES: ①



- EXISTING ROOFING TO REMAIN
- TIE IN NEW BASE AND CAP SHEET TO EXISTING ROOF MEMBRANE
- PREFINISHED METAL CAP FLASHING TO MATCH SIDING COLOUR
- CARRY ROOF MEMBRANE UP AND OVER PARAPET
- 19MM EXTERIOR GRADE PLYWOOD
- METAL STUD FRAMING
- EXISTING STRUCTURE
- METAL CLOSURE STRIP C/W WEEP HOLES
- INSULATED UPSTAND, REFER DETAIL
- PREFINISHED METAL DRIP EDGE FLASHING TO MATCH SIDING COLOUR
- INSULATED METAL DOOR AND FRAME
- METAL THRESHOLD
- PATCH AND REPAIR DAMAGED CONCRETE SLAB AS REQUIRED
- INFILL WALL
- PREFINISHED ALUM CAP FLASHING TO MATCH SIDING COLOUR
- NEW LOUVRE
- CONCRETE PIER TO REMAIN
- COMPOSITE ALUM PANELS
- NEW STEEL STRUCTURE
- ALUM CURTAIN WALL
- NEW STEEL STRUCTURE

LEGEND:

- DESIGNATES EXISTING CONSTRUCTION TO REMAIN
- DUAL DENSITY MINERAL WOOL INSULATION BOARD

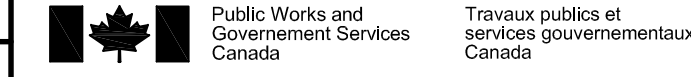

5.	ISSUED FOR ADDENDUM #2	2016.06.05
4.	ISSUED FOR ADDENDUM #1	2016.07.26
3.	ISSUED FOR TENDER	2016.05.09
2.	ISSUED FOR 99% REVIEW	2016.02.05
1.	ISSUED FOR 66% REVIEW	2015.11.17
No.	Revision	Date

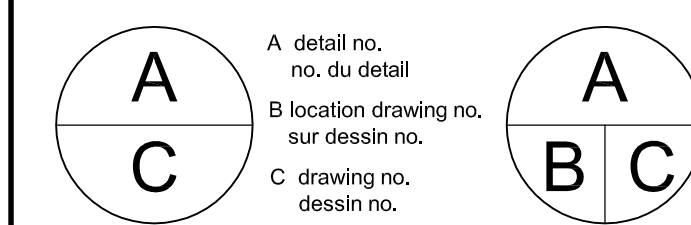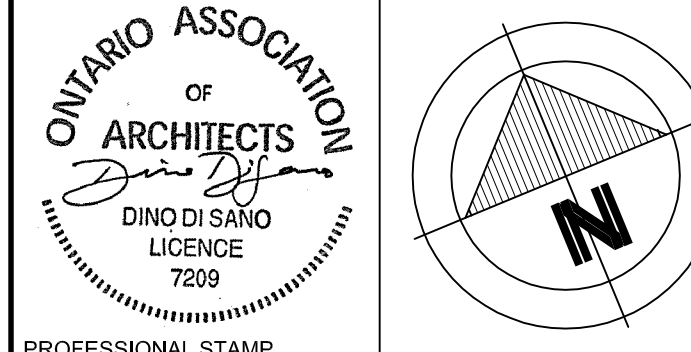

project project
DAVID FLORIDA LABORATORY
BUILDING No. 65, SHIRLEY'S BAY, ONTARIO
BUILDING ENVELOPE REFIT
PROJECT

drawing dessin
WALL SECTIONS

designed	D.S./S.J.	conçu
date	04-08-2016	
drawn	B.H./M.B.	dessiné
date	04-08-2016	
reviewed	B.H.	examiné
date	04-08-2016	
approved	D.S.	approuvé
date	04-08-2016	
scale	as noted	

project no. no. du projet
CSA15-G1
drawing no. no. du dessin
A-604