



1 ANECHOIC CHAMBER-CONTROL ROOM SHAFT
SCALE: ÉCHELLE: 1/25

2 ANECHOIC CHAMBER-EXTERIOR WALL
SCALE: ÉCHELLE: 1/25

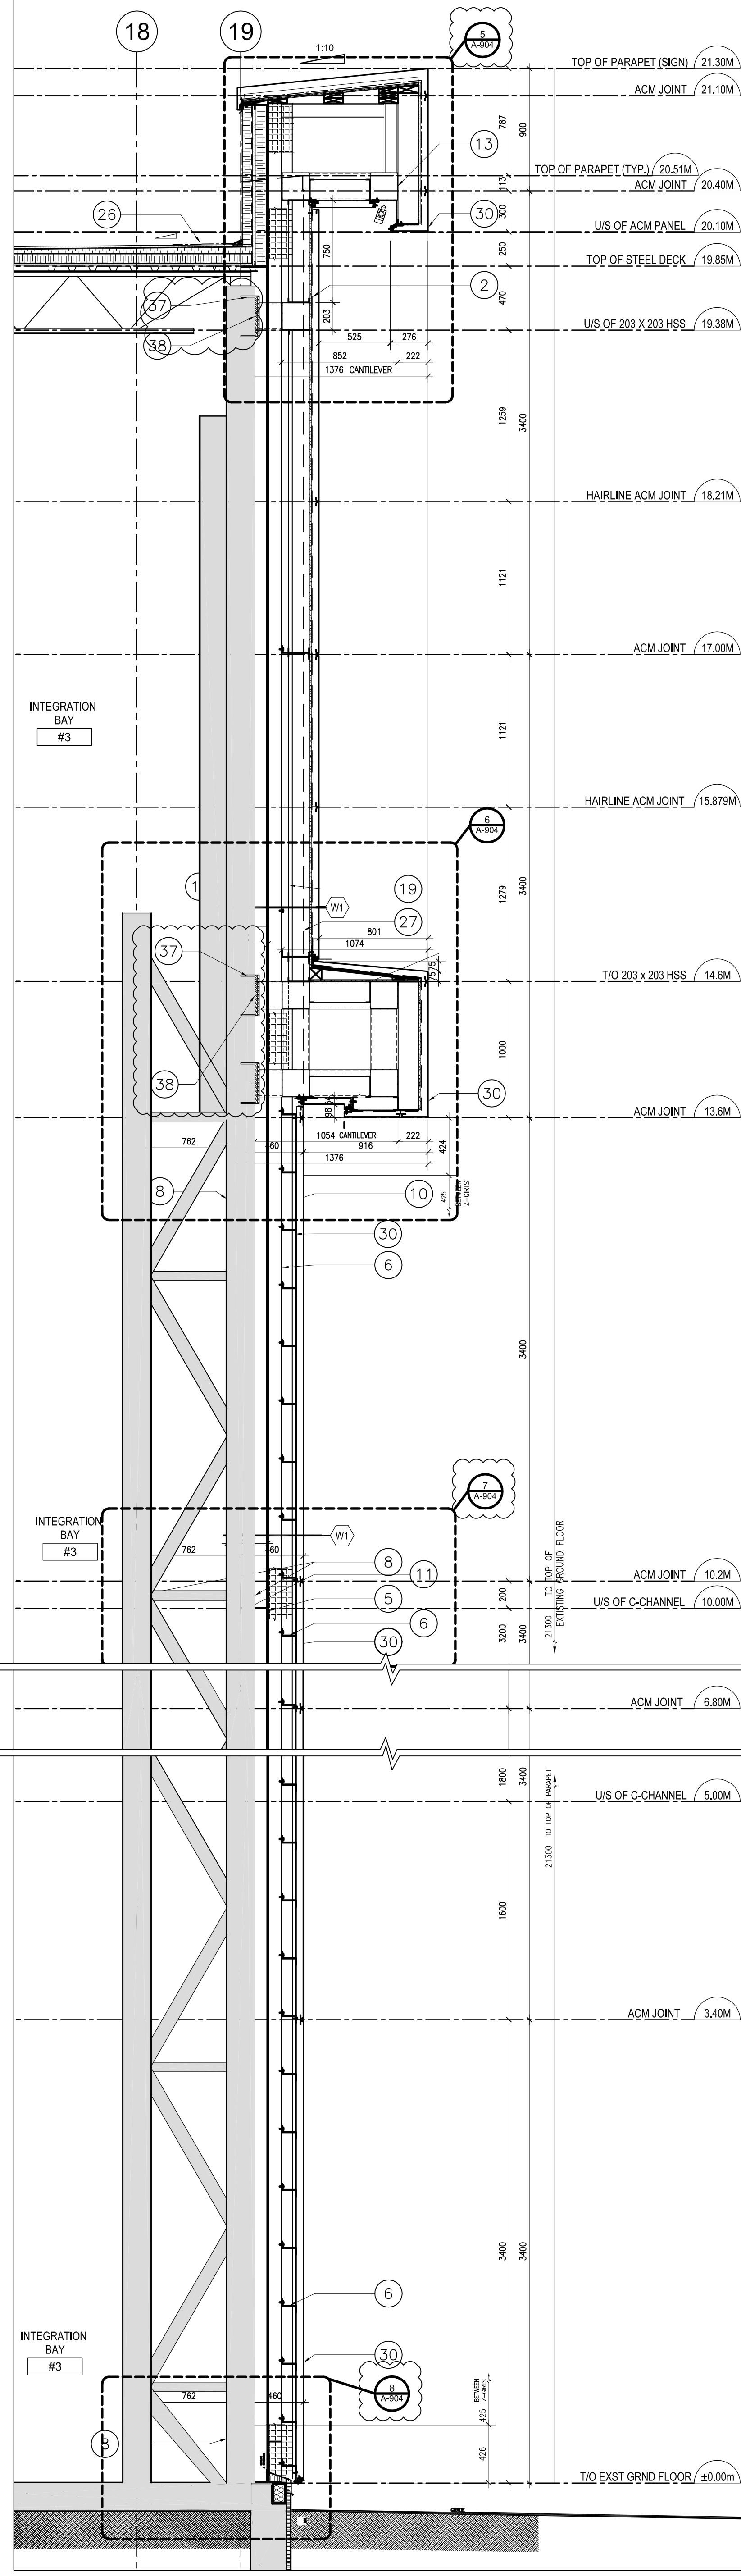

3 ANECHOIC CHAMBER-CONTROL ROOM SHAFT AT BAY 3
SCALE: ÉCHELLE: 1/25

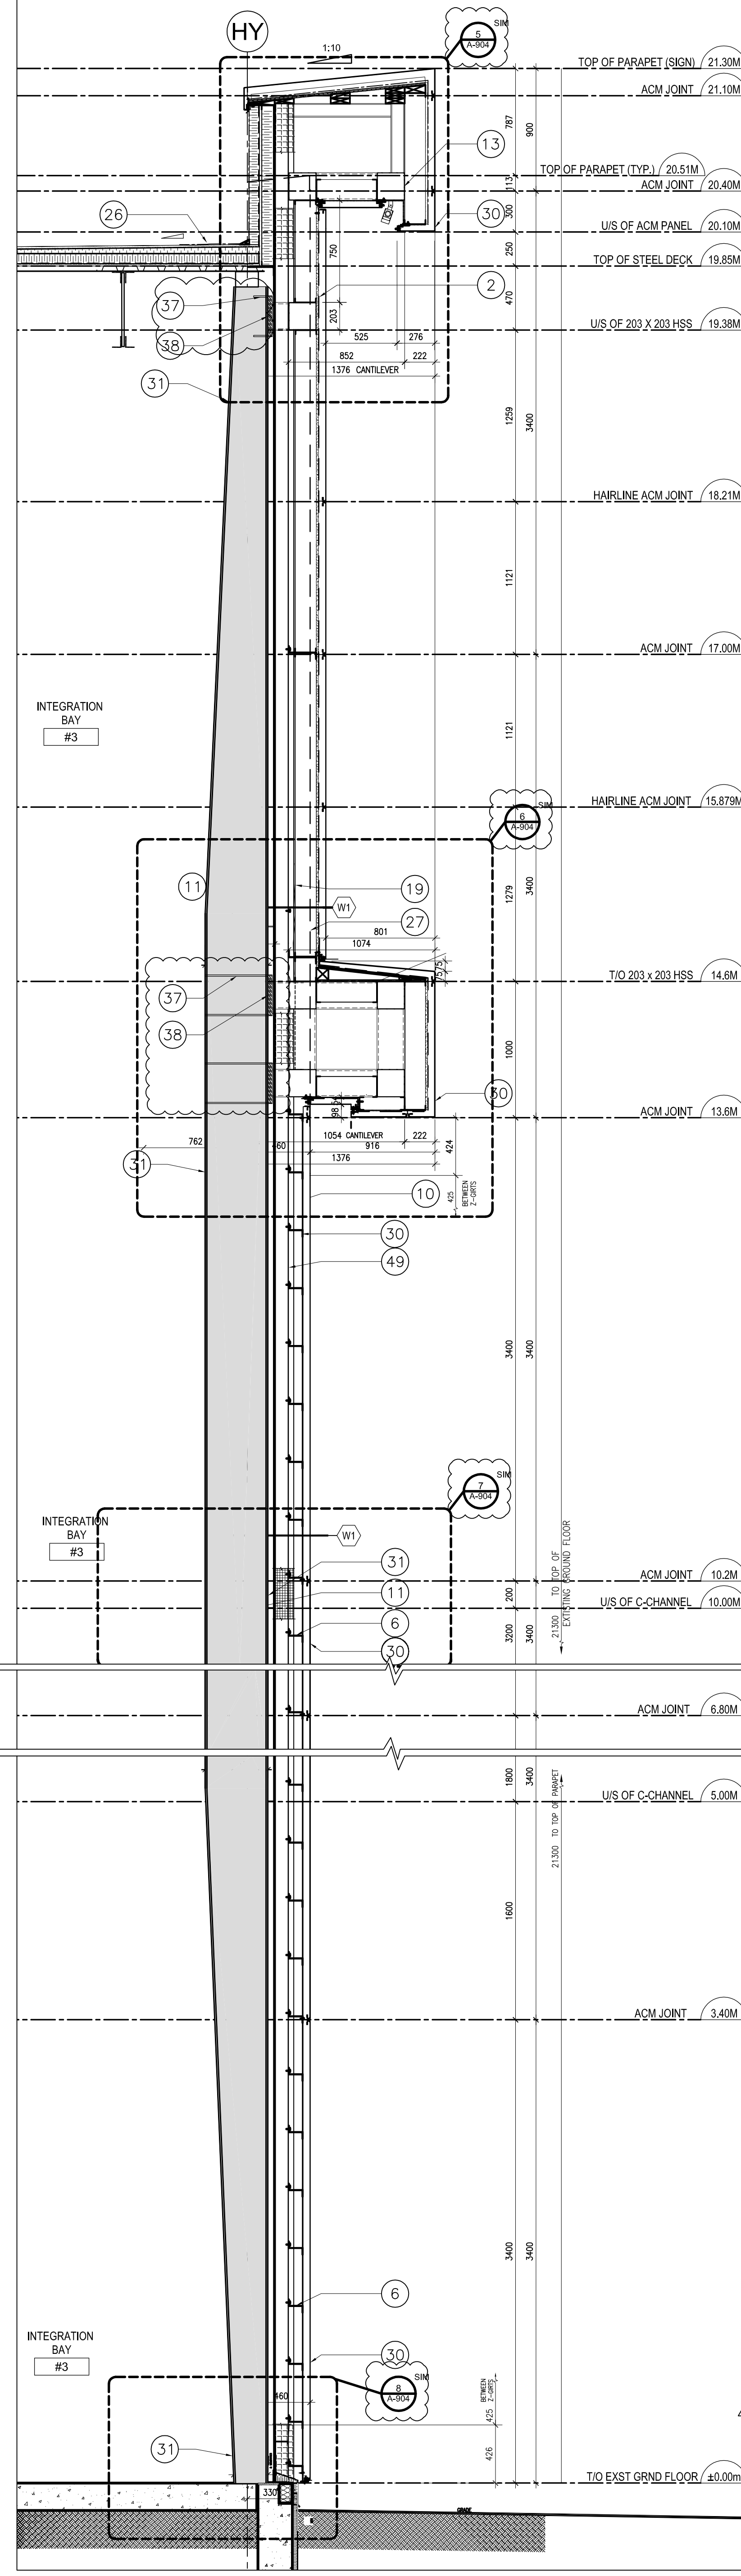

4 ANECHOIC CHAMBER-CONTROL ROOM SHAFT AT BAY 3
SCALE: ÉCHELLE: 1/25

- DRAWING NOTES: ⑩
- DUAL DENSITY MINERAL WOOL INSULATION BOARD
 - CONTINUOUS A/V BARRIER
 - PRE-FINISHED METAL STARTER STRIP
 - PRE-FINISHED METAL FLASHING
 - EXISTING LINEAR PANEL
 - 104 Z-GIRT @ 425 O.C.
 - RESERVED
 - W200 X 53 STEEL COLUMN
 - EXISTING CLOSURE ANGLE
 - C-100 X 9 STEEL CHANNEL @ 900 O.C.
 - C310 X 37 EXISTING STEEL CHANNEL @ 5.0M O.C. ±
 - STEEL PLATE
 - 203 X 203 X 6.4
 - INSECT SCREEN
 - INTERMEDIATE ZGIRT 203 DEEP
 - 6MIL CEMENT PARGING
 - CLOSURE PANEL @ CHANNELS
 - RIGID VS SEMI RIGID MINERAL WOOL INSULATION CAVITY TYPE 76MM MAX TAPER TO 38MIN
 - 152 STEEL STUD @ 400 O.C.
 - 16 GYPSUM BOARD
 - 19 EXT. GRADE PLYWOOD C/W WOOD BLOCKING
 - NEW LINEAR PANEL
 - NEW C100 X 9 CHANNEL @ 300 O.C.
 - RESERVED
 - 75MM SEMI RIGID INSULATION
 - REFER TO DETAIL 14-A903 FOR ALL PARAPETS CONNECTING TO EXISTING ROOF
 - EXTEND OF ACM BEYOND
 - 92 STEEL STUD @ 400 O.C.
 - EXISTING ROOF ANGLE
 - FACE OF ACM PANEL
 - W610 CHAMFERED STEEL COLUMN
 - PREFINISHED METAL CAP FLASHING TO MATCH SIDING COLOUR
 - CARRY ROOF MEMBRANE UP AND OVER PARAPET
 - 19MM EXTERIOR GRADE PLYWOOD
 - INTERIOR WORK NOT IN SCOPE
 - CONCRETE PIER TO REMAIN
 - STEEL STIFFENER REFER TO STRUCTURAL
 - STEEL PLATES REFER TO STRUCTURAL

LEGEND:

DESIGNATES EXISTING CONSTRUCTION TO REMAIN

DUAL DENSITY MINERAL WOOL INSULATION BOARD

DESIGNED: D.S./S.J. concu
DATE: 04-08-2016
DRAWN: B.H./M.B. dessine
DATE: 04-08-2016
REVIEWED: B.H. examine
DATE: 04-08-2016
APPROVED: D.S. approuve
DATE: 04-08-2016
SCALE: as noted

PROJECT NO. CSA15-G1 NO. DU PROJET
DRAWING NO. A-605 NO. DU DESIN

Public Works and Government Services Canada / Travaux publics et services gouvernementaux Canada

Canadian Space Agency / Agence spatiale canadienne

PAGEAUMOREL

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COLE+Associates ARCHITECTS INC.

5.	ISSUED FOR ADDENDUM #2	2016.08.05
4.	ISSUED FOR ADDENDUM #1	2016.07.26
3.	ISSUED FOR TENDER	2016.05.09
2.	ISSUED FOR 99% REVIEW	2016.02.05
1.	ISSUED FOR 66% REVIEW	2015.11.17

No. Revision Date

ONTARIO ASSOCIATION OF ARCHITECTS
DINO DI SAVIO
LICENCE 7259

PROFESSIONAL STAMP

A detail no. no. du détail
B location drawing no. sur dessin no.
C drawing no. dessin no.

A B C

project project
DAVID FLORIDA LABORATORY
BUILDING No. 65, SHIRLEY'S BAY, ONTARIO
BUILDING ENVELOPE REFIT PROJECT

drawing dessin
WALL SECTIONS

designed D.S./S.J. concu
date 04-08-2016
drawn B.H./M.B. dessine
date 04-08-2016
reviewed B.H. examine
date 04-08-2016
approved D.S. approuve
date 04-08-2016
scale as noted

project no. CSA15-G1 no. du projet
drawing no. A-605 no. du dessin