




1 SOUTH ELEVATION  
SCALE: ÉCHELLE: 1:200

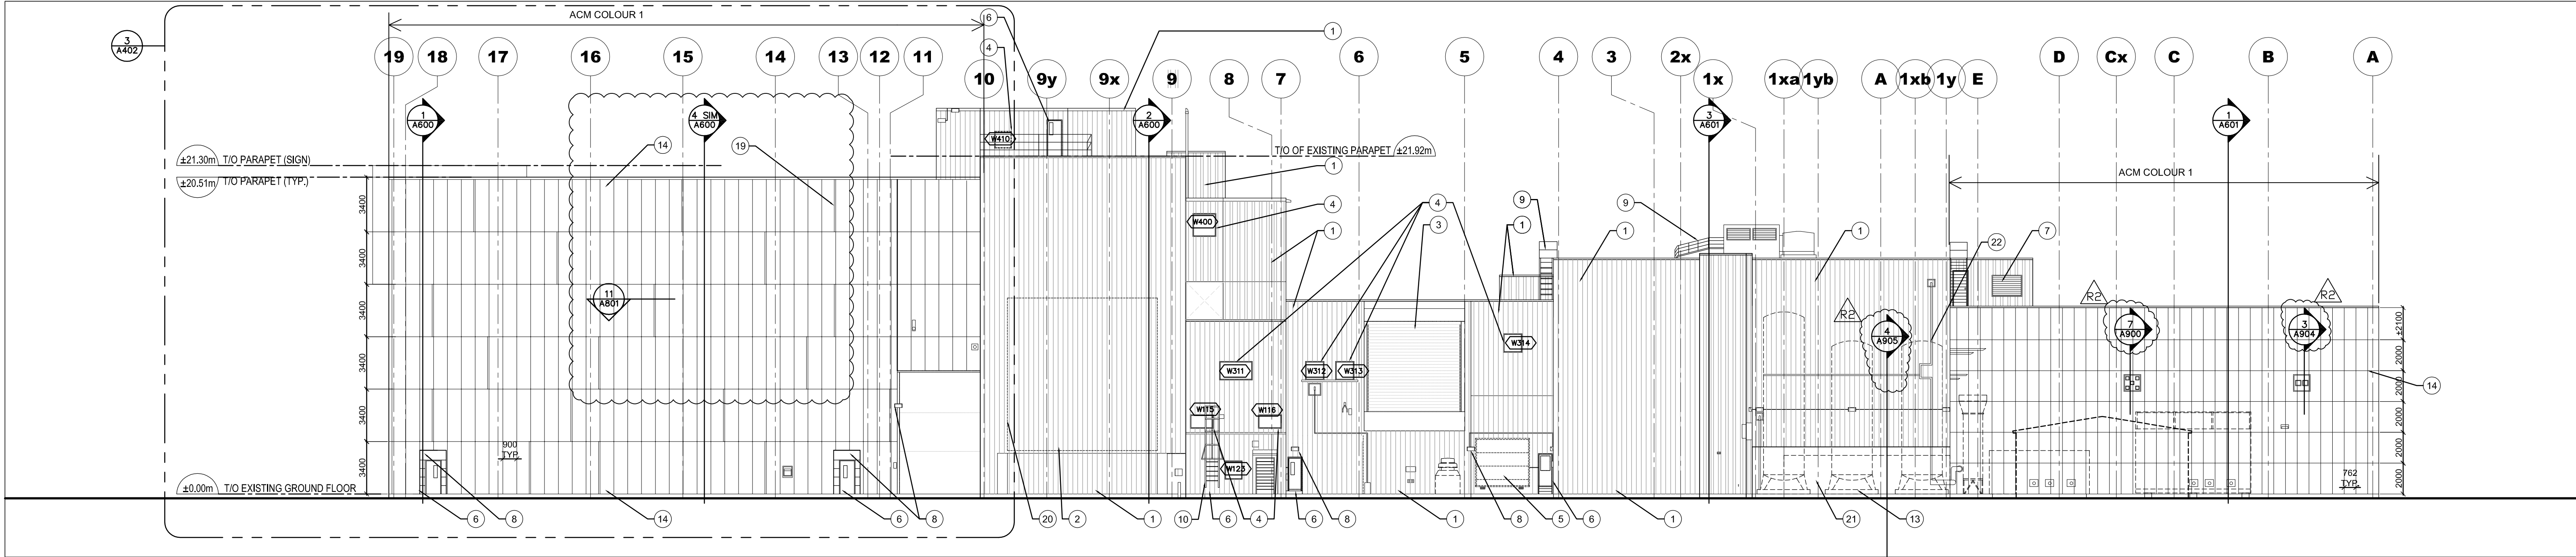

2 NORTH ELEVATION  
SCALE: ÉCHELLE: 1:200

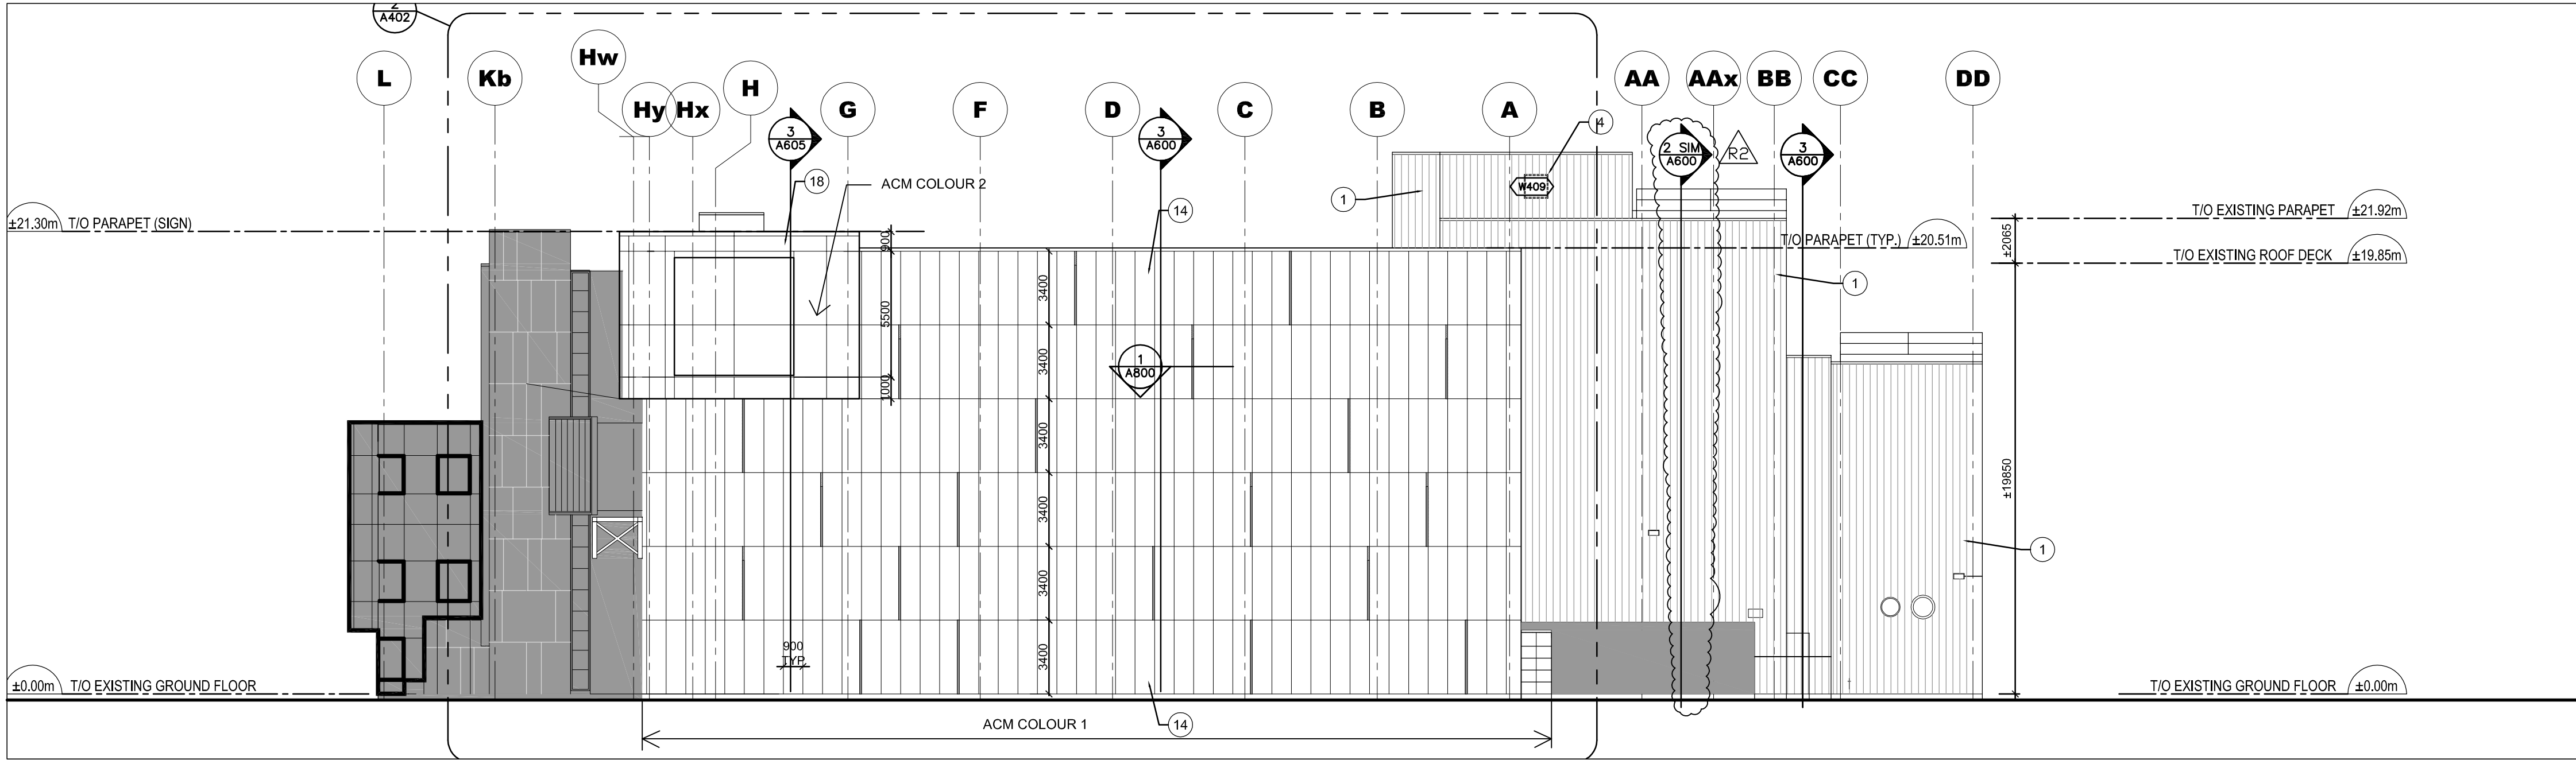

3 EAST ELEVATION  
SCALE: ÉCHELLE: 1:200

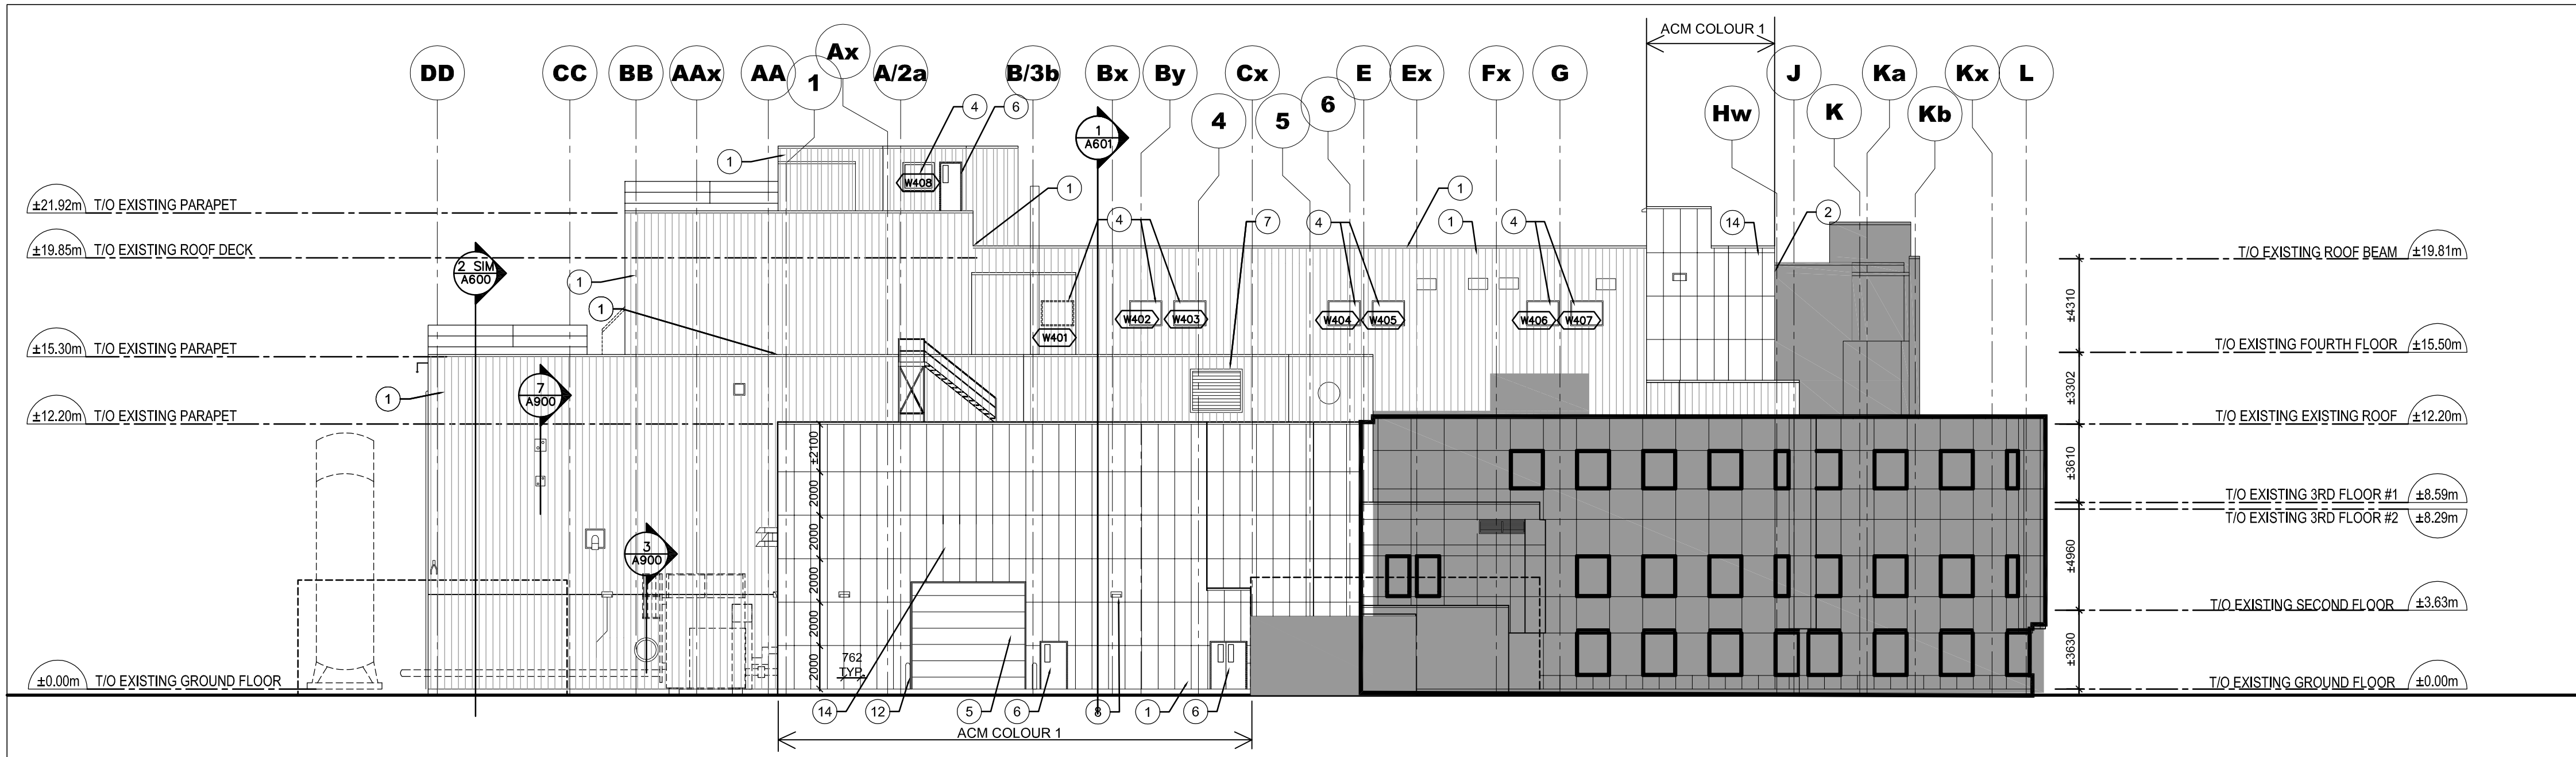

4 WEST ELEVATION  
SCALE: ÉCHELLE: 1:200

#### DRAWING NOTES: ⑧

- ① NEW METAL SIDING CLADDING, WALL TYPE W2
- ② INFILL WALL, REFER WALL SECTIONS AND STRUCTURAL
- ③ NEW MOTORIZED OVERHEAD INSULATED COILING DOOR AS SPECIFIED, ASSEMBLY TO INCLUDE ALL ASSOCIATED COWLINGS, COMPONENT ENCLOSURES, FLASHINGS AND TRIM NEEDED FOR A COMPLETE INSTALLATION. INSTALLATION IS TO BE FROM THE OUTSIDE ONLY AND IS TO CONFORM TO EXISTING OPENING. ACCESS AND WORK IN INTERIOR SPACE BEHIND DOOR, IF NEEDED, IS SUBJECT TO PROVISIONS IN SECTION 01 14 00.
- ④ NEW THERMALLY BROKEN ALUM. FRAMED WINDOWS WITH DOUBLE GLAZED SEALED UNITS WITHIN EXISTING OPENINGS
- ⑤ EXISTING OVERHEAD DOOR- REPAINTED
- ⑥ NEW INSUATED METAL DOOR AND FRAME
- ⑦ NEW VENTS/MECH LOUVRES, REFER MECH SERIES
- ⑧ NEW EXTERIOR LIGHTING, REFER ELECTRICAL SERIES
- ⑨ EXISTING ROOF ACCESS STAIRS, RE-PAINT
- ⑩ NEW ROOF ACCESS LADDERS
- ⑪ NEW PIPE GUARDRAILS
- ⑫ EXISTING BOLLARD, RE-PAINT
- ⑬ EXISTING LIQUID NITROGEN TANKS
- ⑭ NEW COMPOSITE ALUM PANEL CLADDING.
- ⑮ LED LIGHT PANELS (ALL WHITE)
- ⑯ RESERVED
- ⑰ NEW CURTAINWALL CLADDING.
- ⑱ COMPOSITE CLAD SIGNAGE PANELS
- ⑲ PANEL GAPS (NO LIGHTING THIS ELEVATION)
- ⑳ INFILLED AREA AT REMOVED OVERHEAD DOOR
- ㉑ LED LIGHT PANELS ( WHITE WITH RED TOP SECTION)
- ㉒ RE-INSTALLED NITROGEN PIPING REFER MECH

#### LEGEND:

AREAS NOT IN SCOPE

ALUMINUM COMPOSITE PANELS:

ACM-1 COLOUR: PEWTER

ACM-2 COLOUR: BONE WHITE

METAL SIDING:

MS-1 COLOUR: CHARCOAL

FLASHINGS:

MF-1: METAL FLASHING - PEWTER

MF-2: METAL FLASHING - BONE WHITE

MF-3: METAL FLASHING - CHARCOAL

REFER TO SPECIFICATIONS FOR DETAILS

5. ISSUED FOR ADDENDUM #2 2016.08.05



4. ISSUED FOR ADDENDUM #1 2016.07.26

3. ISSUED FOR TENDER 2016.05.09

2. ISSUED FOR 99% REVIEW 2016.02.05

1. ISSUED FOR 66% REVIEW 2015.11.17

No. Revision Date

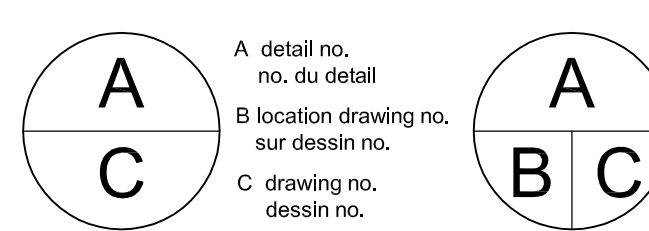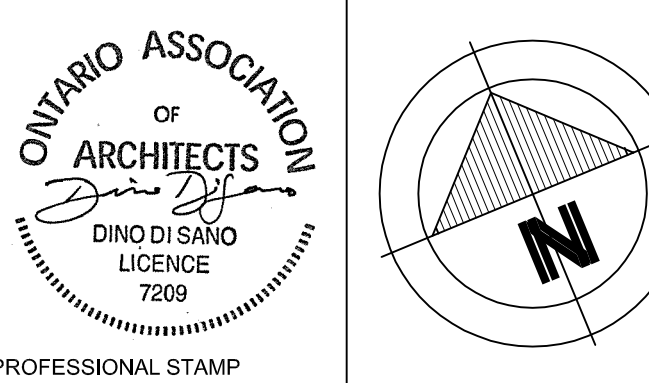

project project

DAVID FLORIDA LABORATORY

BUILDING No. 65, SHIRLEY'S BAY, ONTARIO

BUILDING ENVELOPE REFIT  
PROJECT

drawing dessin

ELEVATIONS

designed D.S./S.J. concu

date 04-08-2016

drawn B.H.M.B. dessine

date 04-08-2016

reviewed B.H. examine

date 04-08-2016

approved D.S. approuve

date 04-08-2016

scale as noted

project no. no. du projet

CSA15-G1

drawing no. no. du dessin

A-400