




1 ELEVATION (NORTH)
SCALE / ÉCHELLE - 1/200

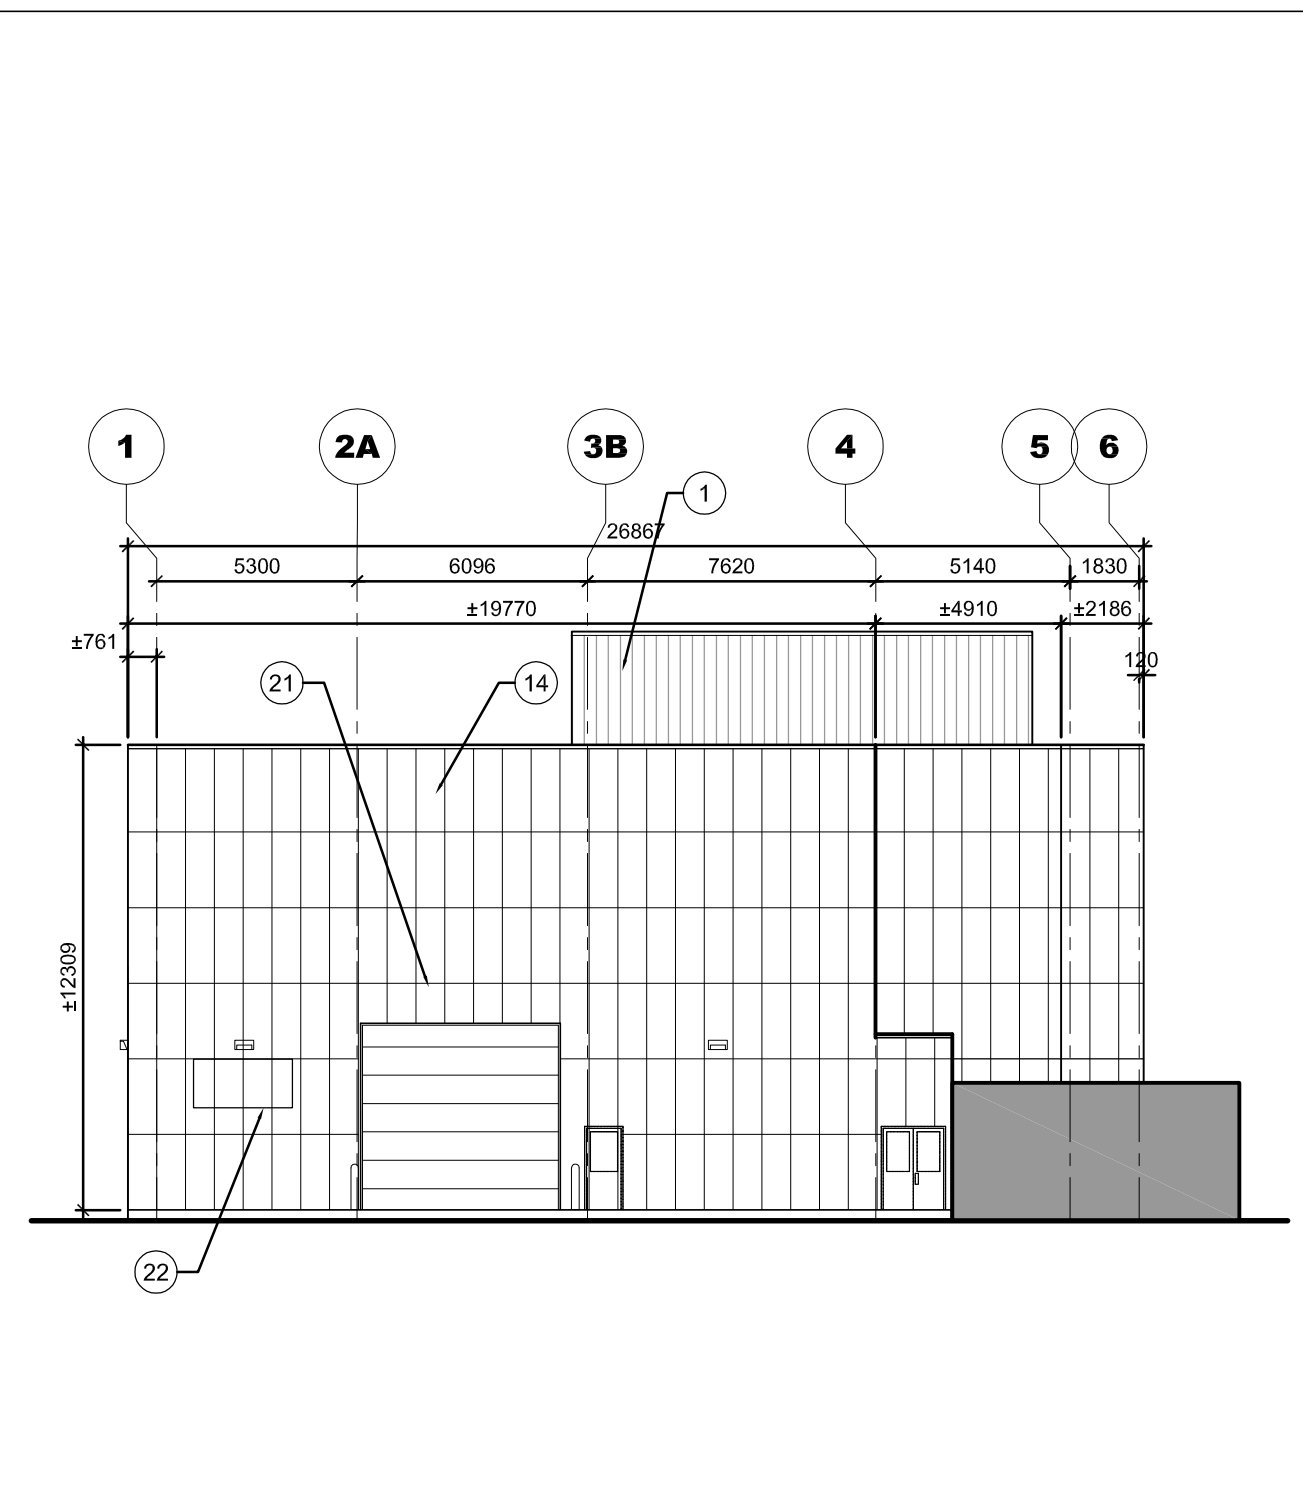


2 ELEVATION (WEST)
SCALE / ÉCHELLE - 1/200

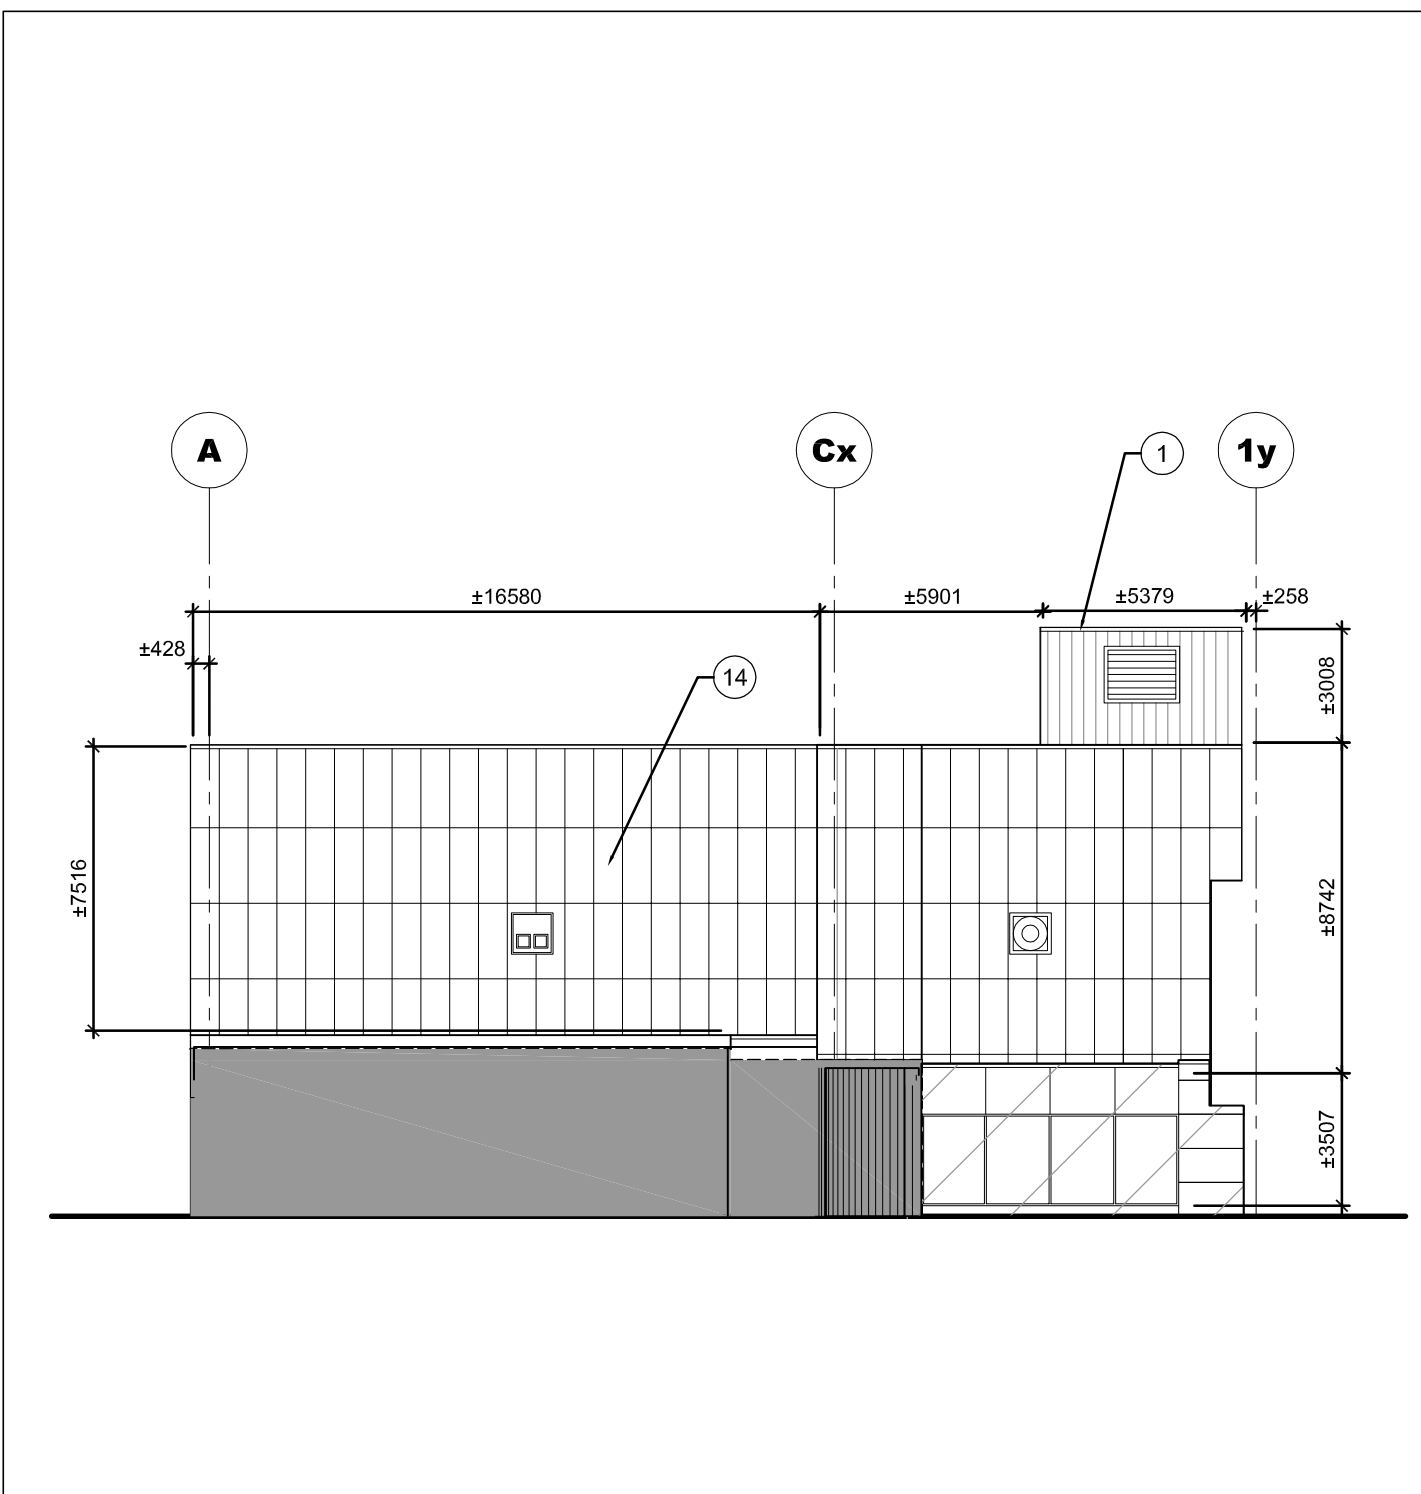


3 ELEVATION (SOUTH)
SCALE / ÉCHELLE - 1/200

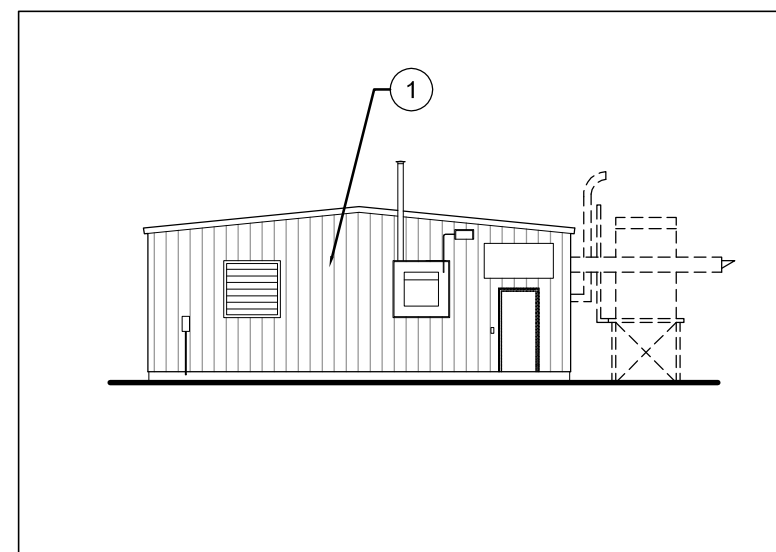


4 ELEVATION (NORTH)
SCALE / ÉCHELLE - 1/200

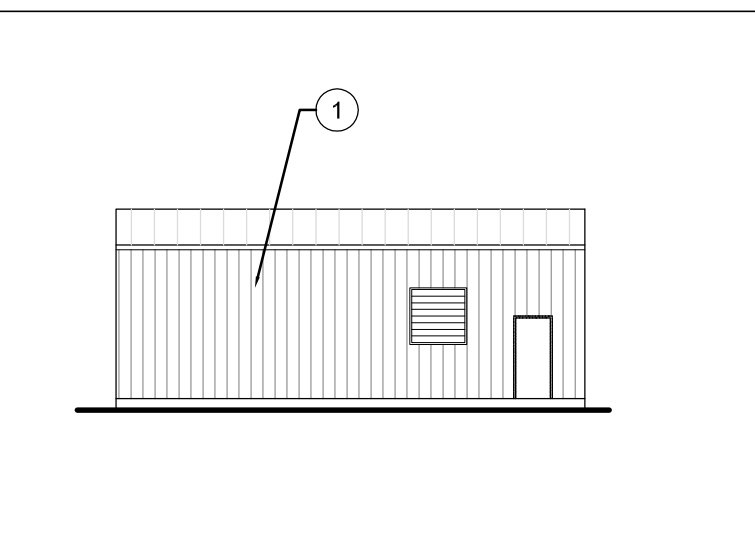


5 ELEVATION (EAST)
SCALE / ÉCHELLE - 1/200

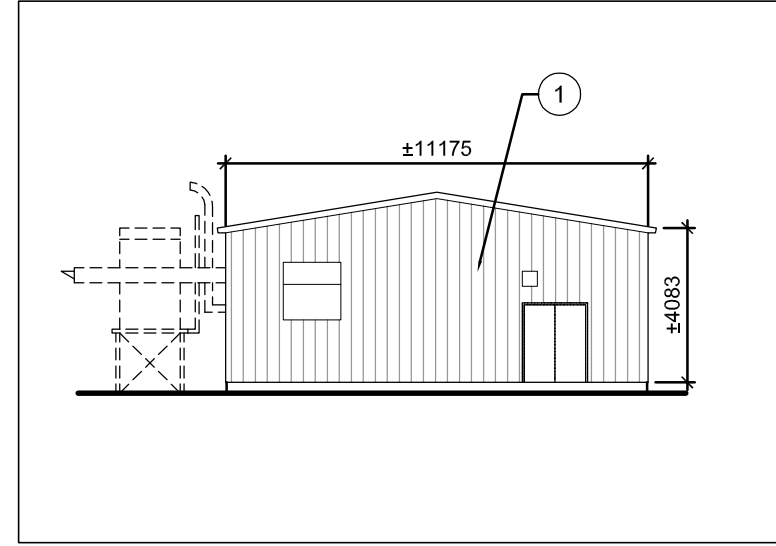


6 ELEVATION (SOUTH)
SCALE / ÉCHELLE - 1/200

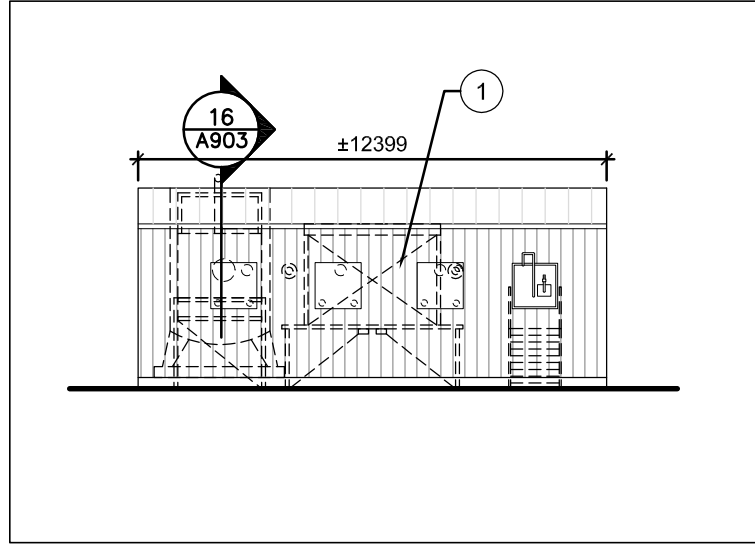


7 ELEVATION (WEST)
SCALE / ÉCHELLE - 1/200

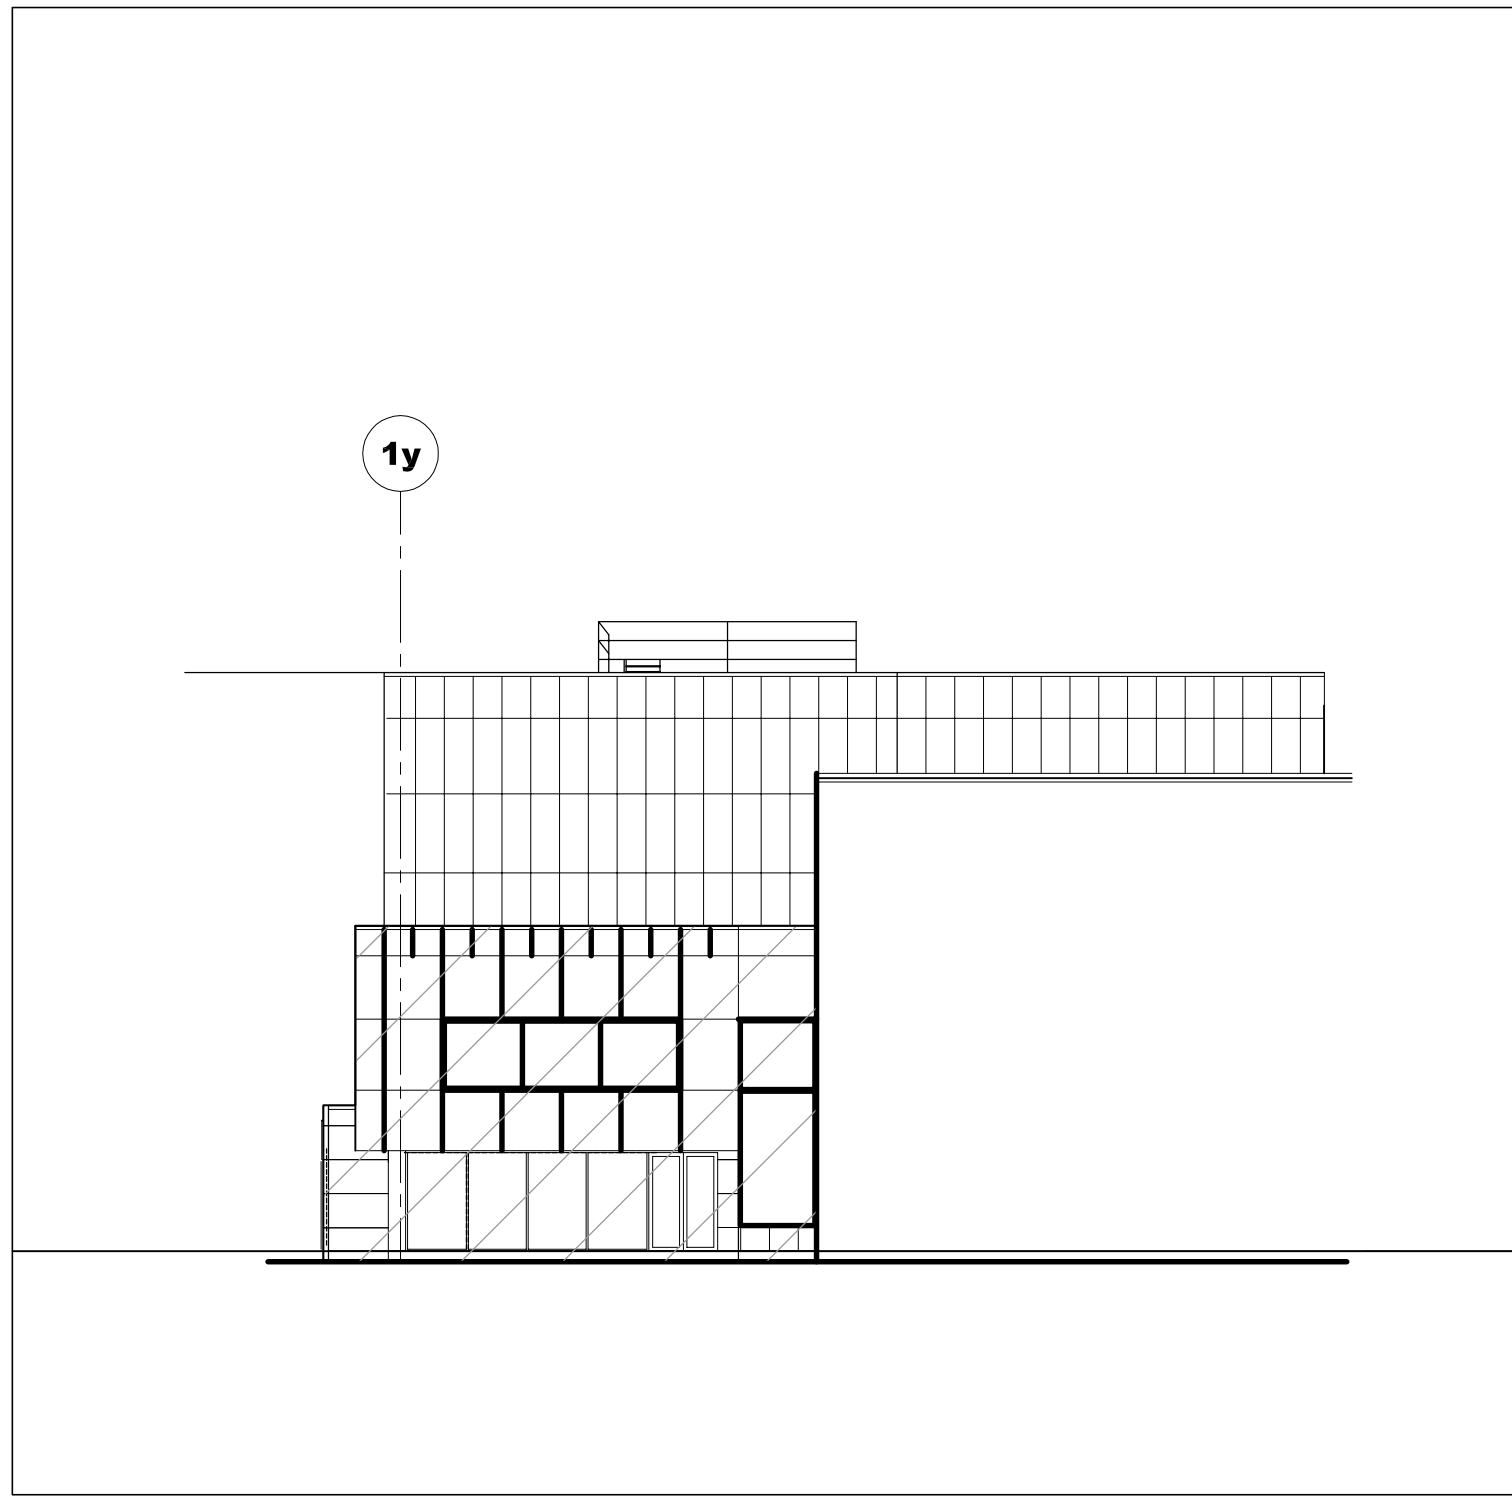


8 ELEVATION (SOUTH)
SCALE / ÉCHELLE - 1/200

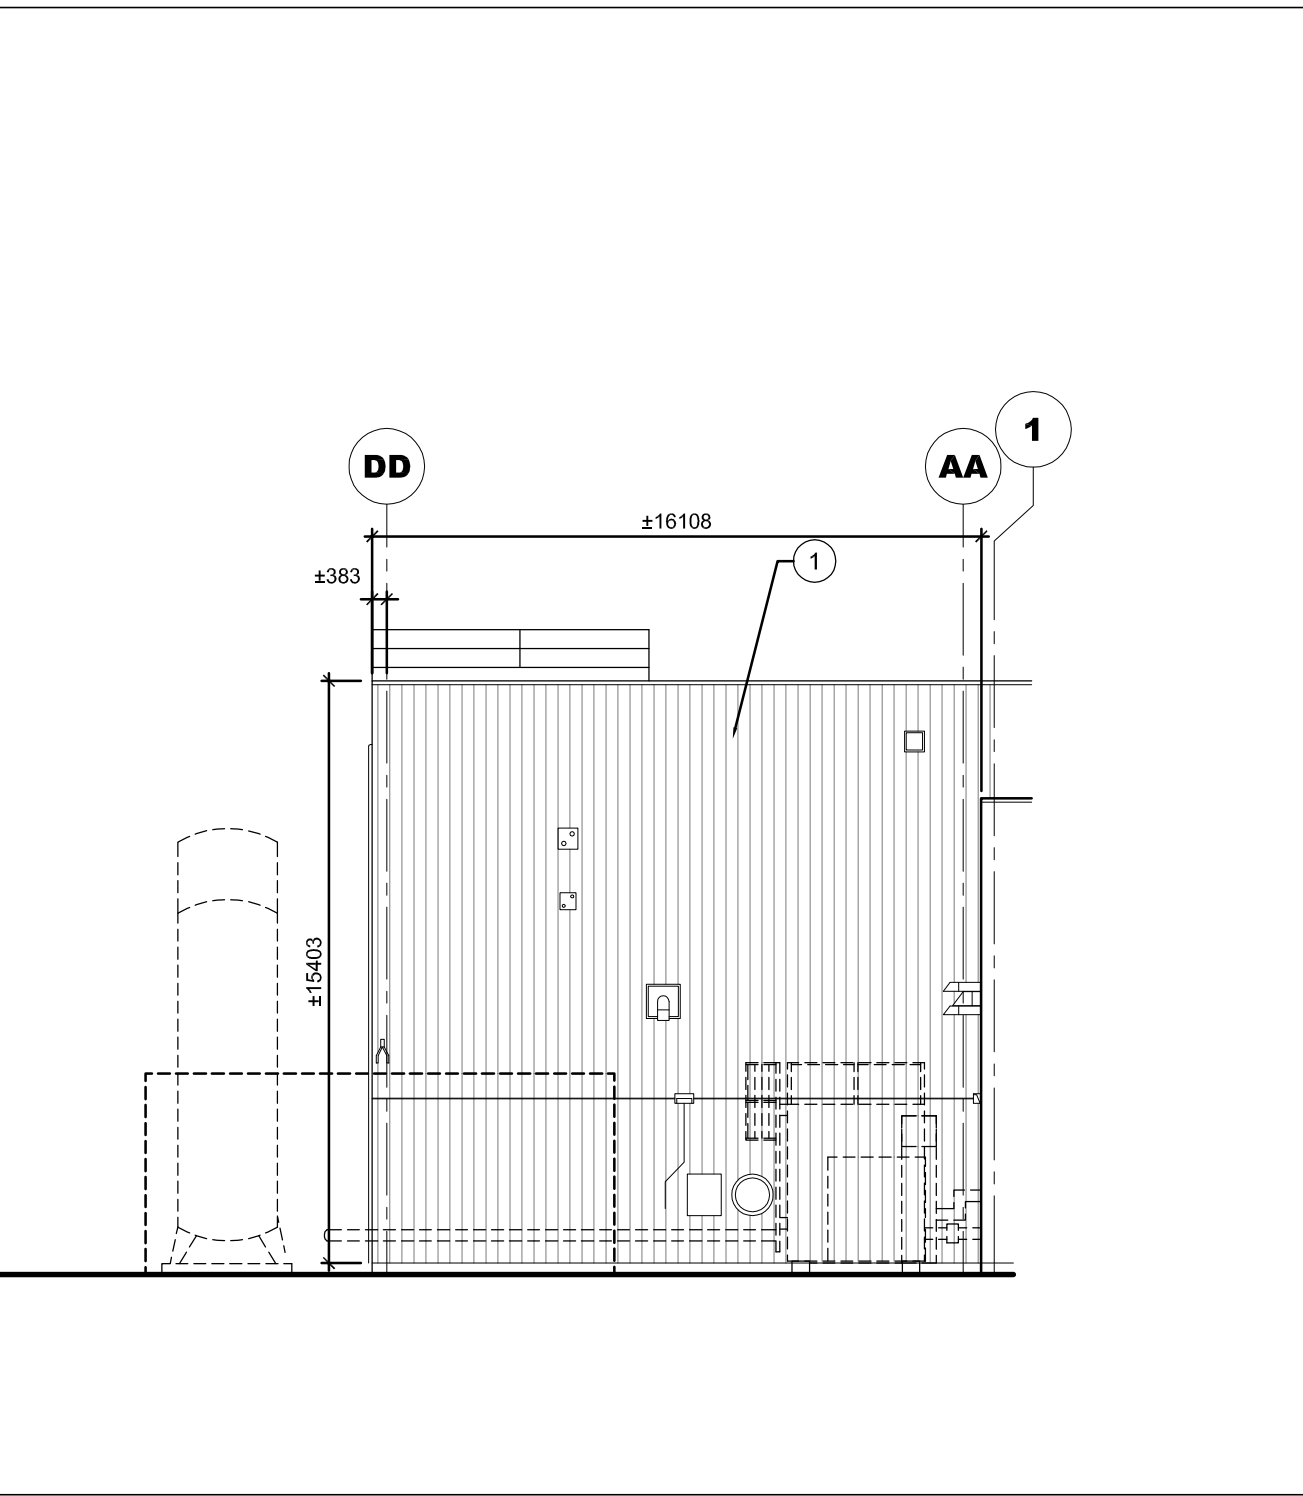


9 ELEVATION (WEST)
SCALE / ÉCHELLE - 1/200

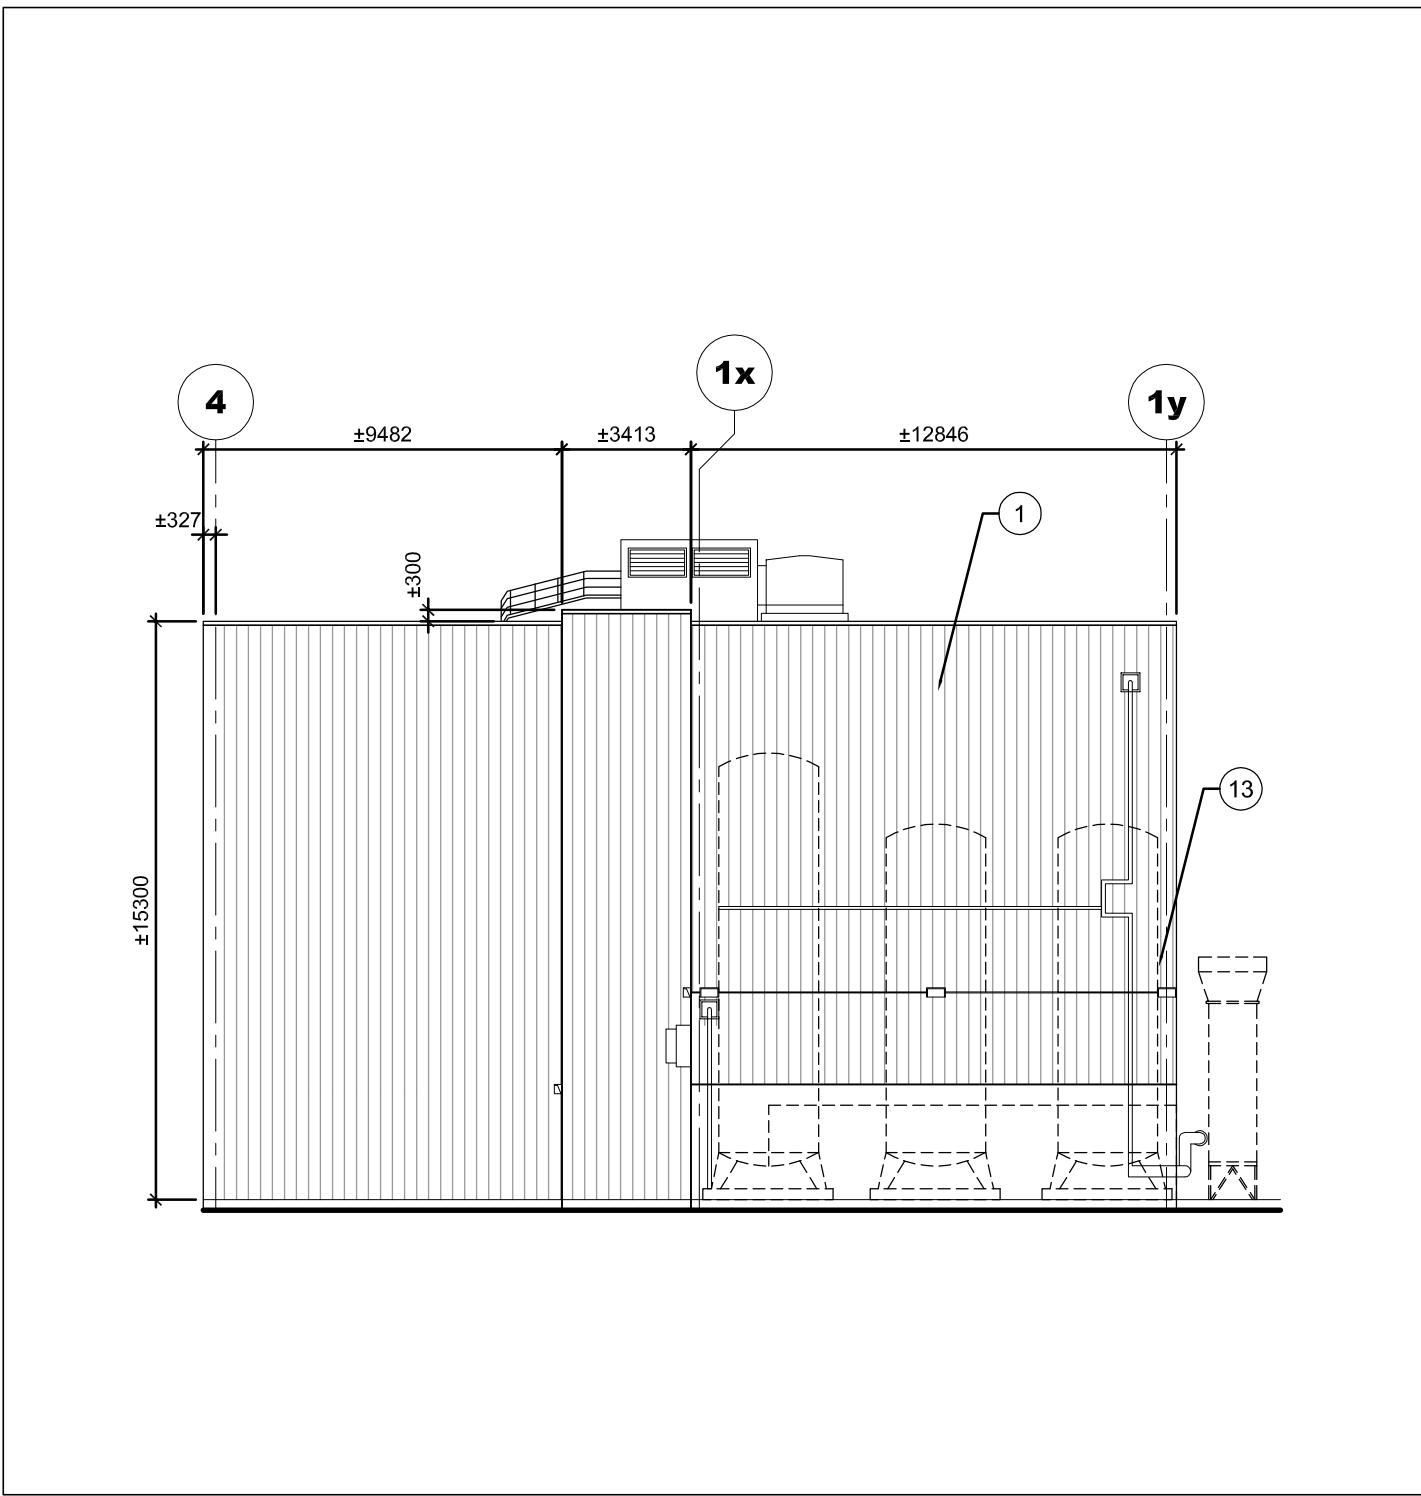


10 ELEVATION (NORTH)
SCALE / ÉCHELLE - 1/200

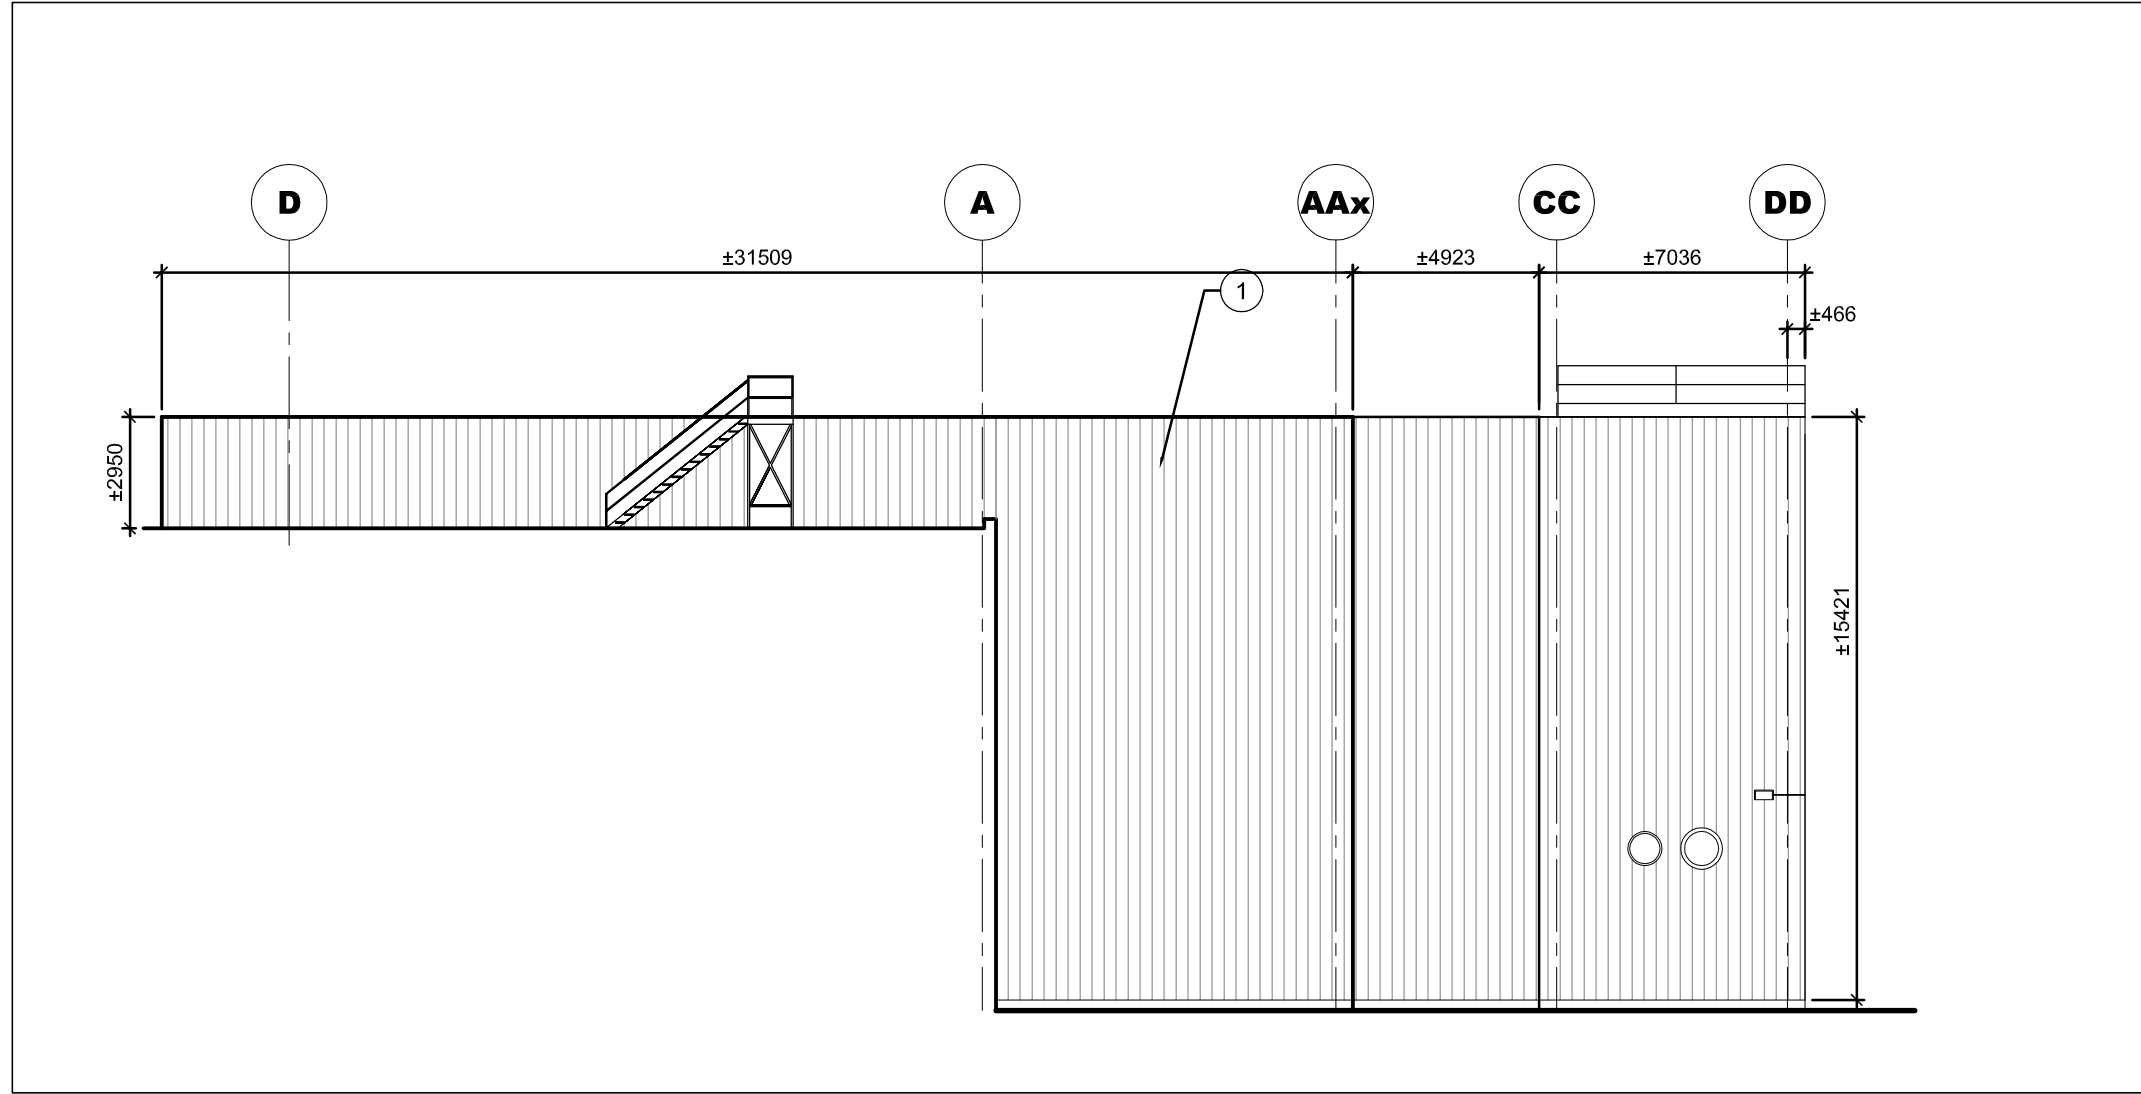

11 ELEVATION
SCALE / ÉCHELLE - 1/200

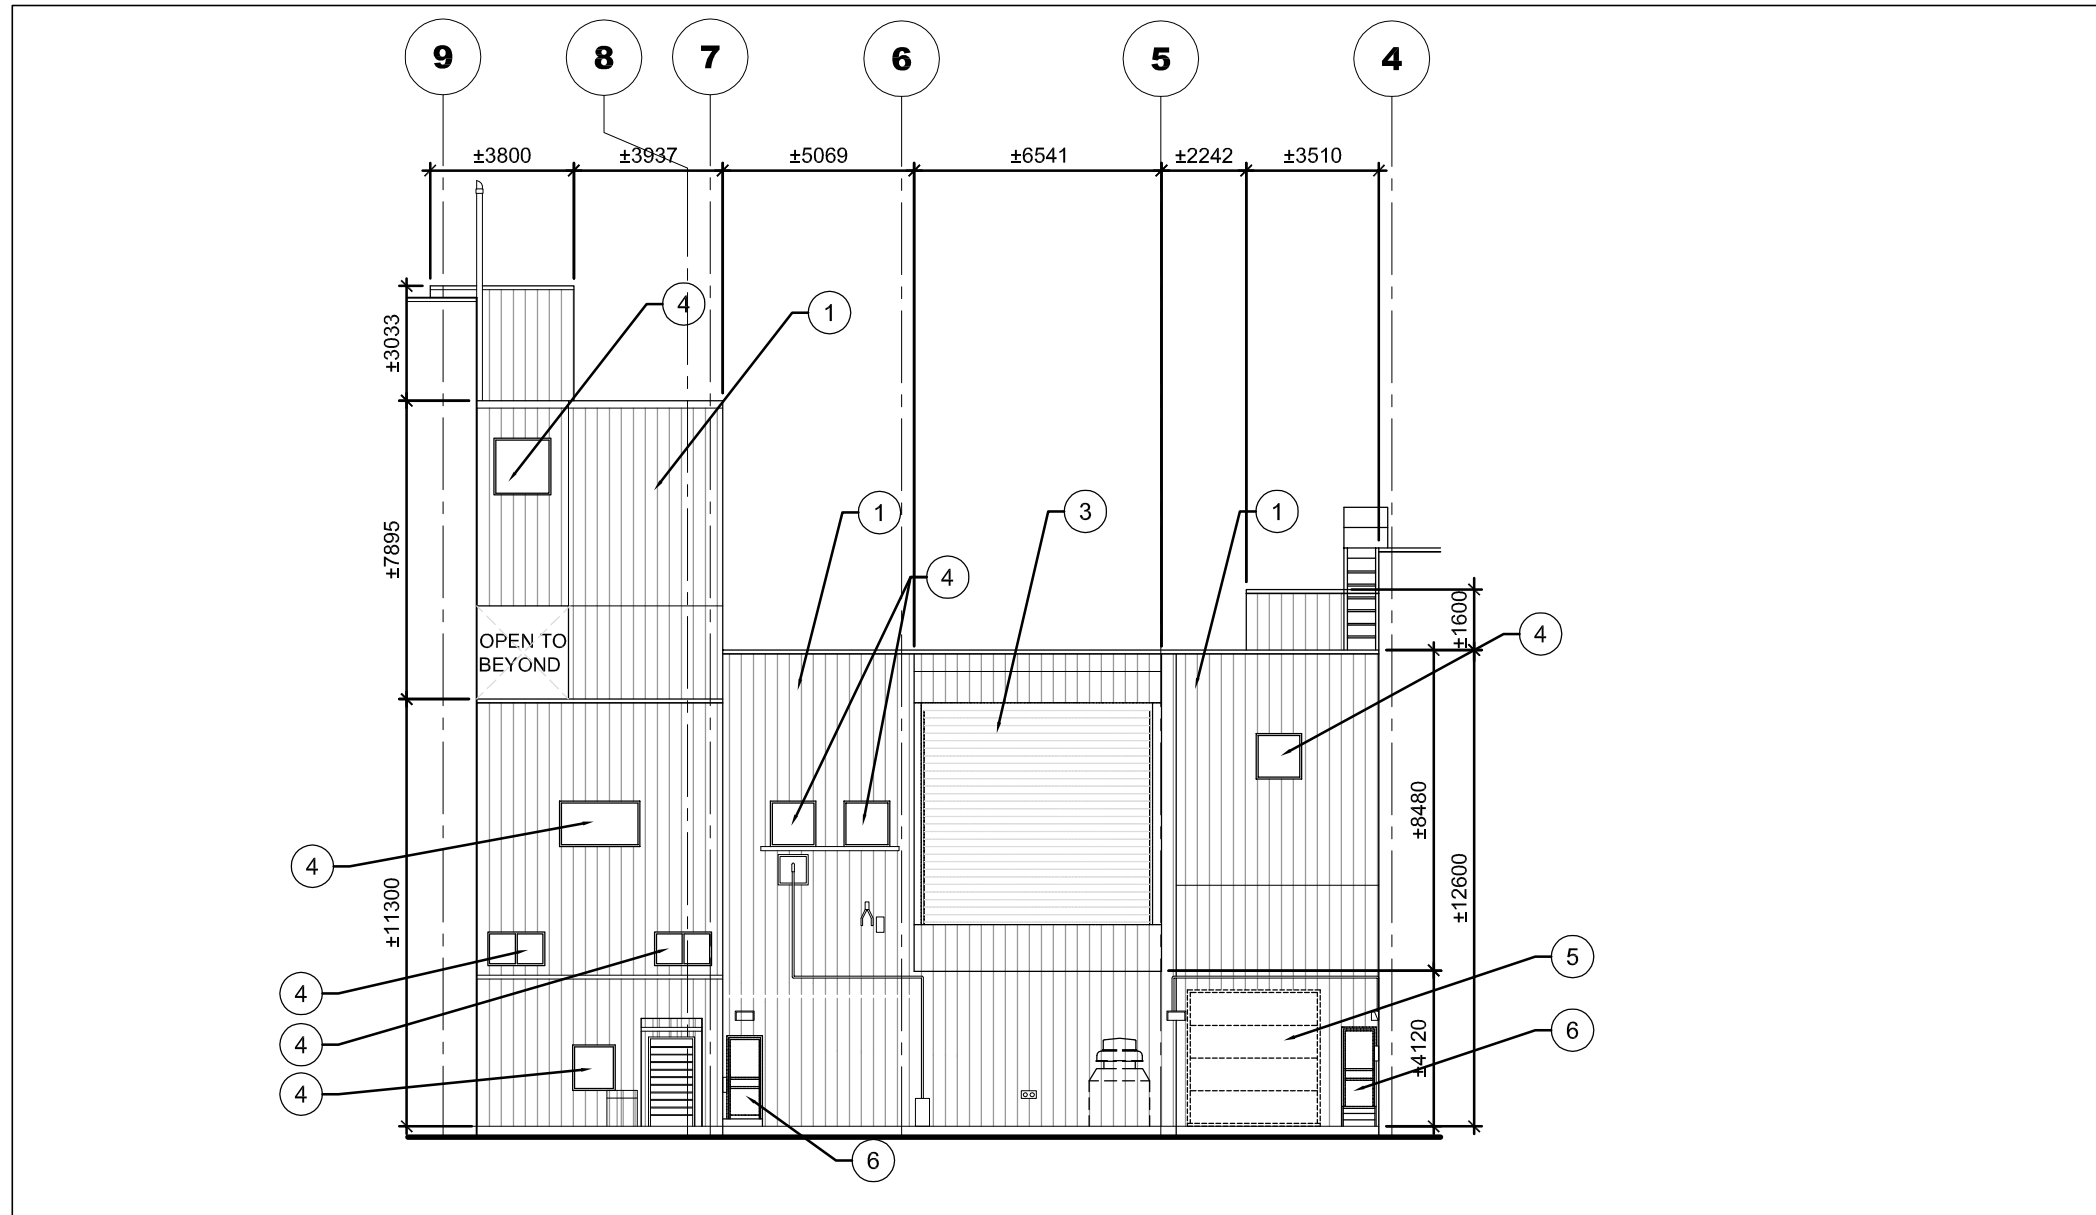

13 ELEVATION
SCALE / ÉCHELLE - 1/200

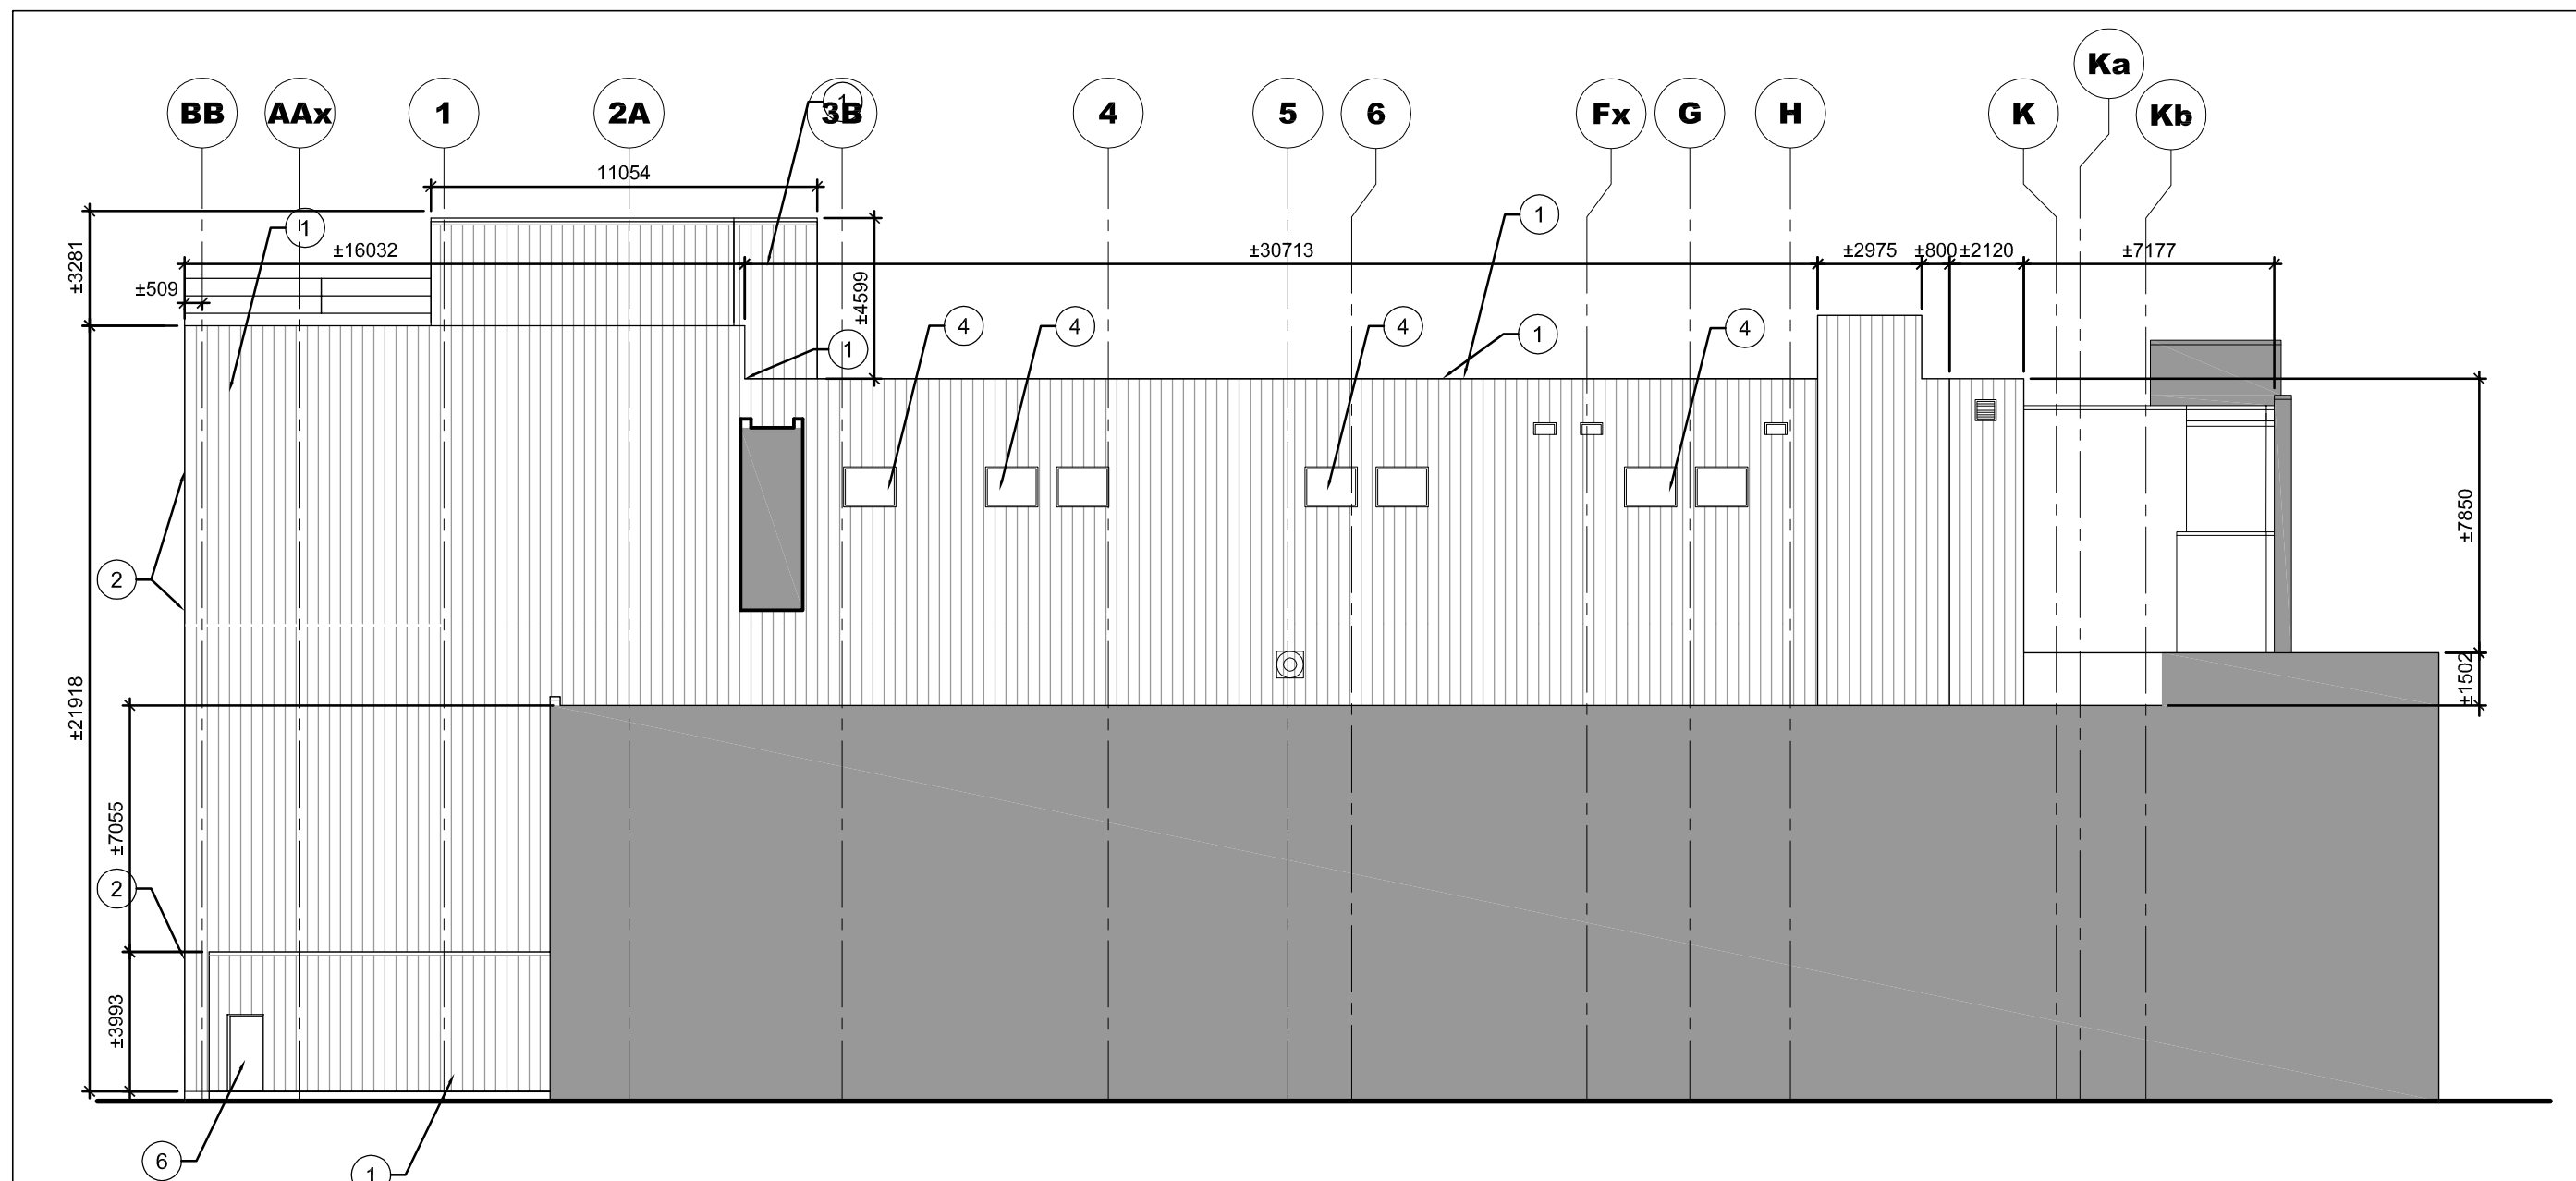

12 ELEVATION (WEST)
SCALE / ÉCHELLE - 1/200



DRAWING NOTES: ②

- 1 NEW METAL SIDING CLADDING, WALL TYPE W2
- 2 INFILL WALL, REFER WALL SECTIONS AND STRUCTURAL
- 3 NEW MOTORIZED OVERHEAD DOOR C/W FLASHINGS AND TRIM
- 4 NEW THERMALLY BROKEN ALUM FRAMED WINDOWS WITH DOUBLE GLAZED SEALED UNITS WITHIN EXISTING OPENINGS
- 5 EXISTING OVERHEAD DOOR- REPAINTED
- 6 NEW INSUATED METAL DOOR AND FRAME
- 7 NEW VENTS/MECH LOUVRES, REFER MECH SERIES
- 8 NEW EXTERIOR LIGHTING, REFER ELECTRICAL SERIES
- 9 EXISTING ROOF ACCESS STAIRS. RE-PAINT
- 10 NEW ROOF ACCESS LADDERS
- 11 NEW PIPE GUARDRAILS
- 12 EXISTING BOLLARD, RE-PAINT
- 13 EXISTING LIQUID NITROGEN TANKS
- 14 NEW COMPOSITE ALUM PANEL CLADDING.
- 15 LED LIGHT PANELS TYPICAL
- 16 RESERVED
- 17 NEW CURTAINWALL CLADDING.
- 18 COMPOSITE CLAD SIGNAGE PANELS
- 19 PANEL GAPS (NO LIGHTING THIS ELEVATION)
- 20 INFILLED AREA AT REMOVED OVERHEAD DOOR
- 21 INFILL BACK UP WALL AT WINDOW REMOVAL LOCATION
- 22 SIGN REMOVE & REINSTALL

AREAS NOT IN SCOPE

LEGEND:

5.	ISSUED FOR ADDENDUM #2	2016.06.09
4.	ISSUED FOR ADDENDUM #1	2016.07.26
3.	ISSUED FOR TENDER	2016.05.09
2.	ISSUED FOR 99% REVIEW	2016.02.09
1.	ISSUED FOR 66% REVIEW	2015.11.17

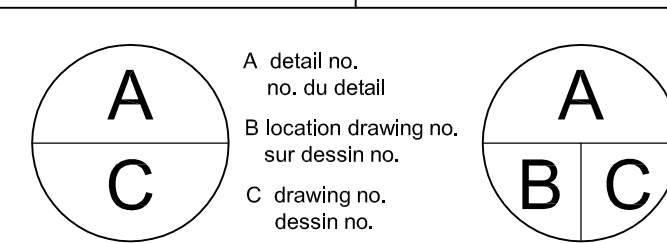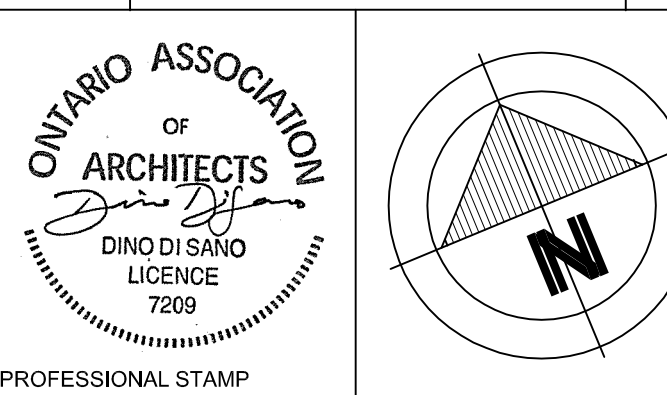

project
DAVID FLORIDA LABORATORY
BUILDING No. 65, SHIRLEY'S BAY, ONTARIO
BUILDING ENVELOPE REFIT
PROJECT

drawing
ELEVATIONS

designed	D.S./S.J.	conçu
date	04-08-2016	
drawn	B.H./M.B.	dessiné
date	04-08-2016	
reviewed	B.H.	examiné
date	04-08-2016	
approved	D.S.	approuvé
date	04-08-2016	
scale	as noted	

project no.
drawing no.
no. du projet
no. du dessin
CSA15-G1
A-401