

NOTES

SURVEY PARTY CHIEF: EDDIE BEARNS  
SURVEY (LAST): ALUMINUM BOAT  
SURVEY (LAST): MAY 08, 2012

SOUNDING TYPE: SINCE TRANSFER  
SOUNDING SETTING: N/A  
DEPTH GATE USED: REF. OF SOUND 1500 M/H  
LAST SURVEY POSITION: DOCS (WITH OFF)  
DATA TYPE/PROCESS: USED  
OLD DRAWING FILE(S):  
TIDAL REDUCTION SCHEME

OFFICE PROCESSOR: EDDIE BEARNS  
DATE OF PROCESSING: MAY 2012  
REDUCTION OF MINIMUM DEPTHS

MODE OF PLACING: EAST OF MINIMUM DEPTHS  
REDUCTION OF MINIMUM DEPTHS

CONTROL POINTS:

PT. NAME	EASTING	NORTHING	CD	ELV	DESCRIPTION
782224	610701.380	520068.804			PROVINCIAL BRASS PLACQUE SET IN BEDROCK
782225	610701.380	520068.804			PROVINCIAL BRASS PLACQUE SET IN BEDROCK
PMC 1-95	610726.344	5199274.835			BOLT SET IN BEDROCK
PMC 2-95	611084.112	5199823.440		+4.682 m	IP DRIVEN IN GRAVEL
PMC 3-95	611084.112	5199823.440		+2.163 m	SPIKE IN PAVEMENT
PMC 4-95	611221.777	5200160.984			BRASS PLACQUE IN CONCRETE BLOCK
PMC 5-95	611082.710	5200162.500		+3.012 m	ANCHOR BOLT IN A CONCRETE BLOCK
PMC 6-95	611081.191	5199142.040			

ALL SOUNDINGS & ELEVATIONS IN METRES.

ALL SOUNDINGS & ELEVATIONS REFERRED TO GEODETIC BM 927288 ELEV. +4.012 m (BRASS PLACQUE SET IN BRIDGE) USING 1.270 m AS THE DIFFERENCE BETWEEN GEODETIC DATUM & CHART DATUM ON MAY 10-11-1989 BY PWC SURVEY CREW.

NOTE: USED 1.27m AS THE DIFFERENCE BETWEEN GEODETIC & CHART DATUMS.

SOUNDINGS TAKEN USING NAVSOUND 210 ECHO SOUNDER AND POSITIONED BY TRIMBLE DIFFERENTIAL GPS POSITIONING SYSTEM BETWEEN MAY 08, 2012 BY PWCOS SURVEY CREW.

COORDINATES FOR HORIZONTAL CONTROL ARE GIVEN ON THE UTM, WARPING PLANE, ZONE 22, USING THE NORTH AMERICAN DATUM OF 1983 (NAD83).

SOUNDINGS WERE REDUCED BY DISTANCE & RE-CHECKED FROM SOUNDING CHARTS BEFORE BEING CORRECTED FOR TIDE & BAR CHECK CORRECTION.

SOUNDINGS WERE REDUCED USING HYPACK MAX VER 02.12.

SPEED OF SOUND WAS OBTAINED USING A DODBAR-PRO VELOMETER.

LEGEND

SYMBOLS



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SCALE: 1:250


0m 5m 10m 15m 20m 25m



SMALL CRAFT HARBOURS


NOTES:

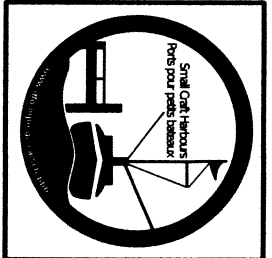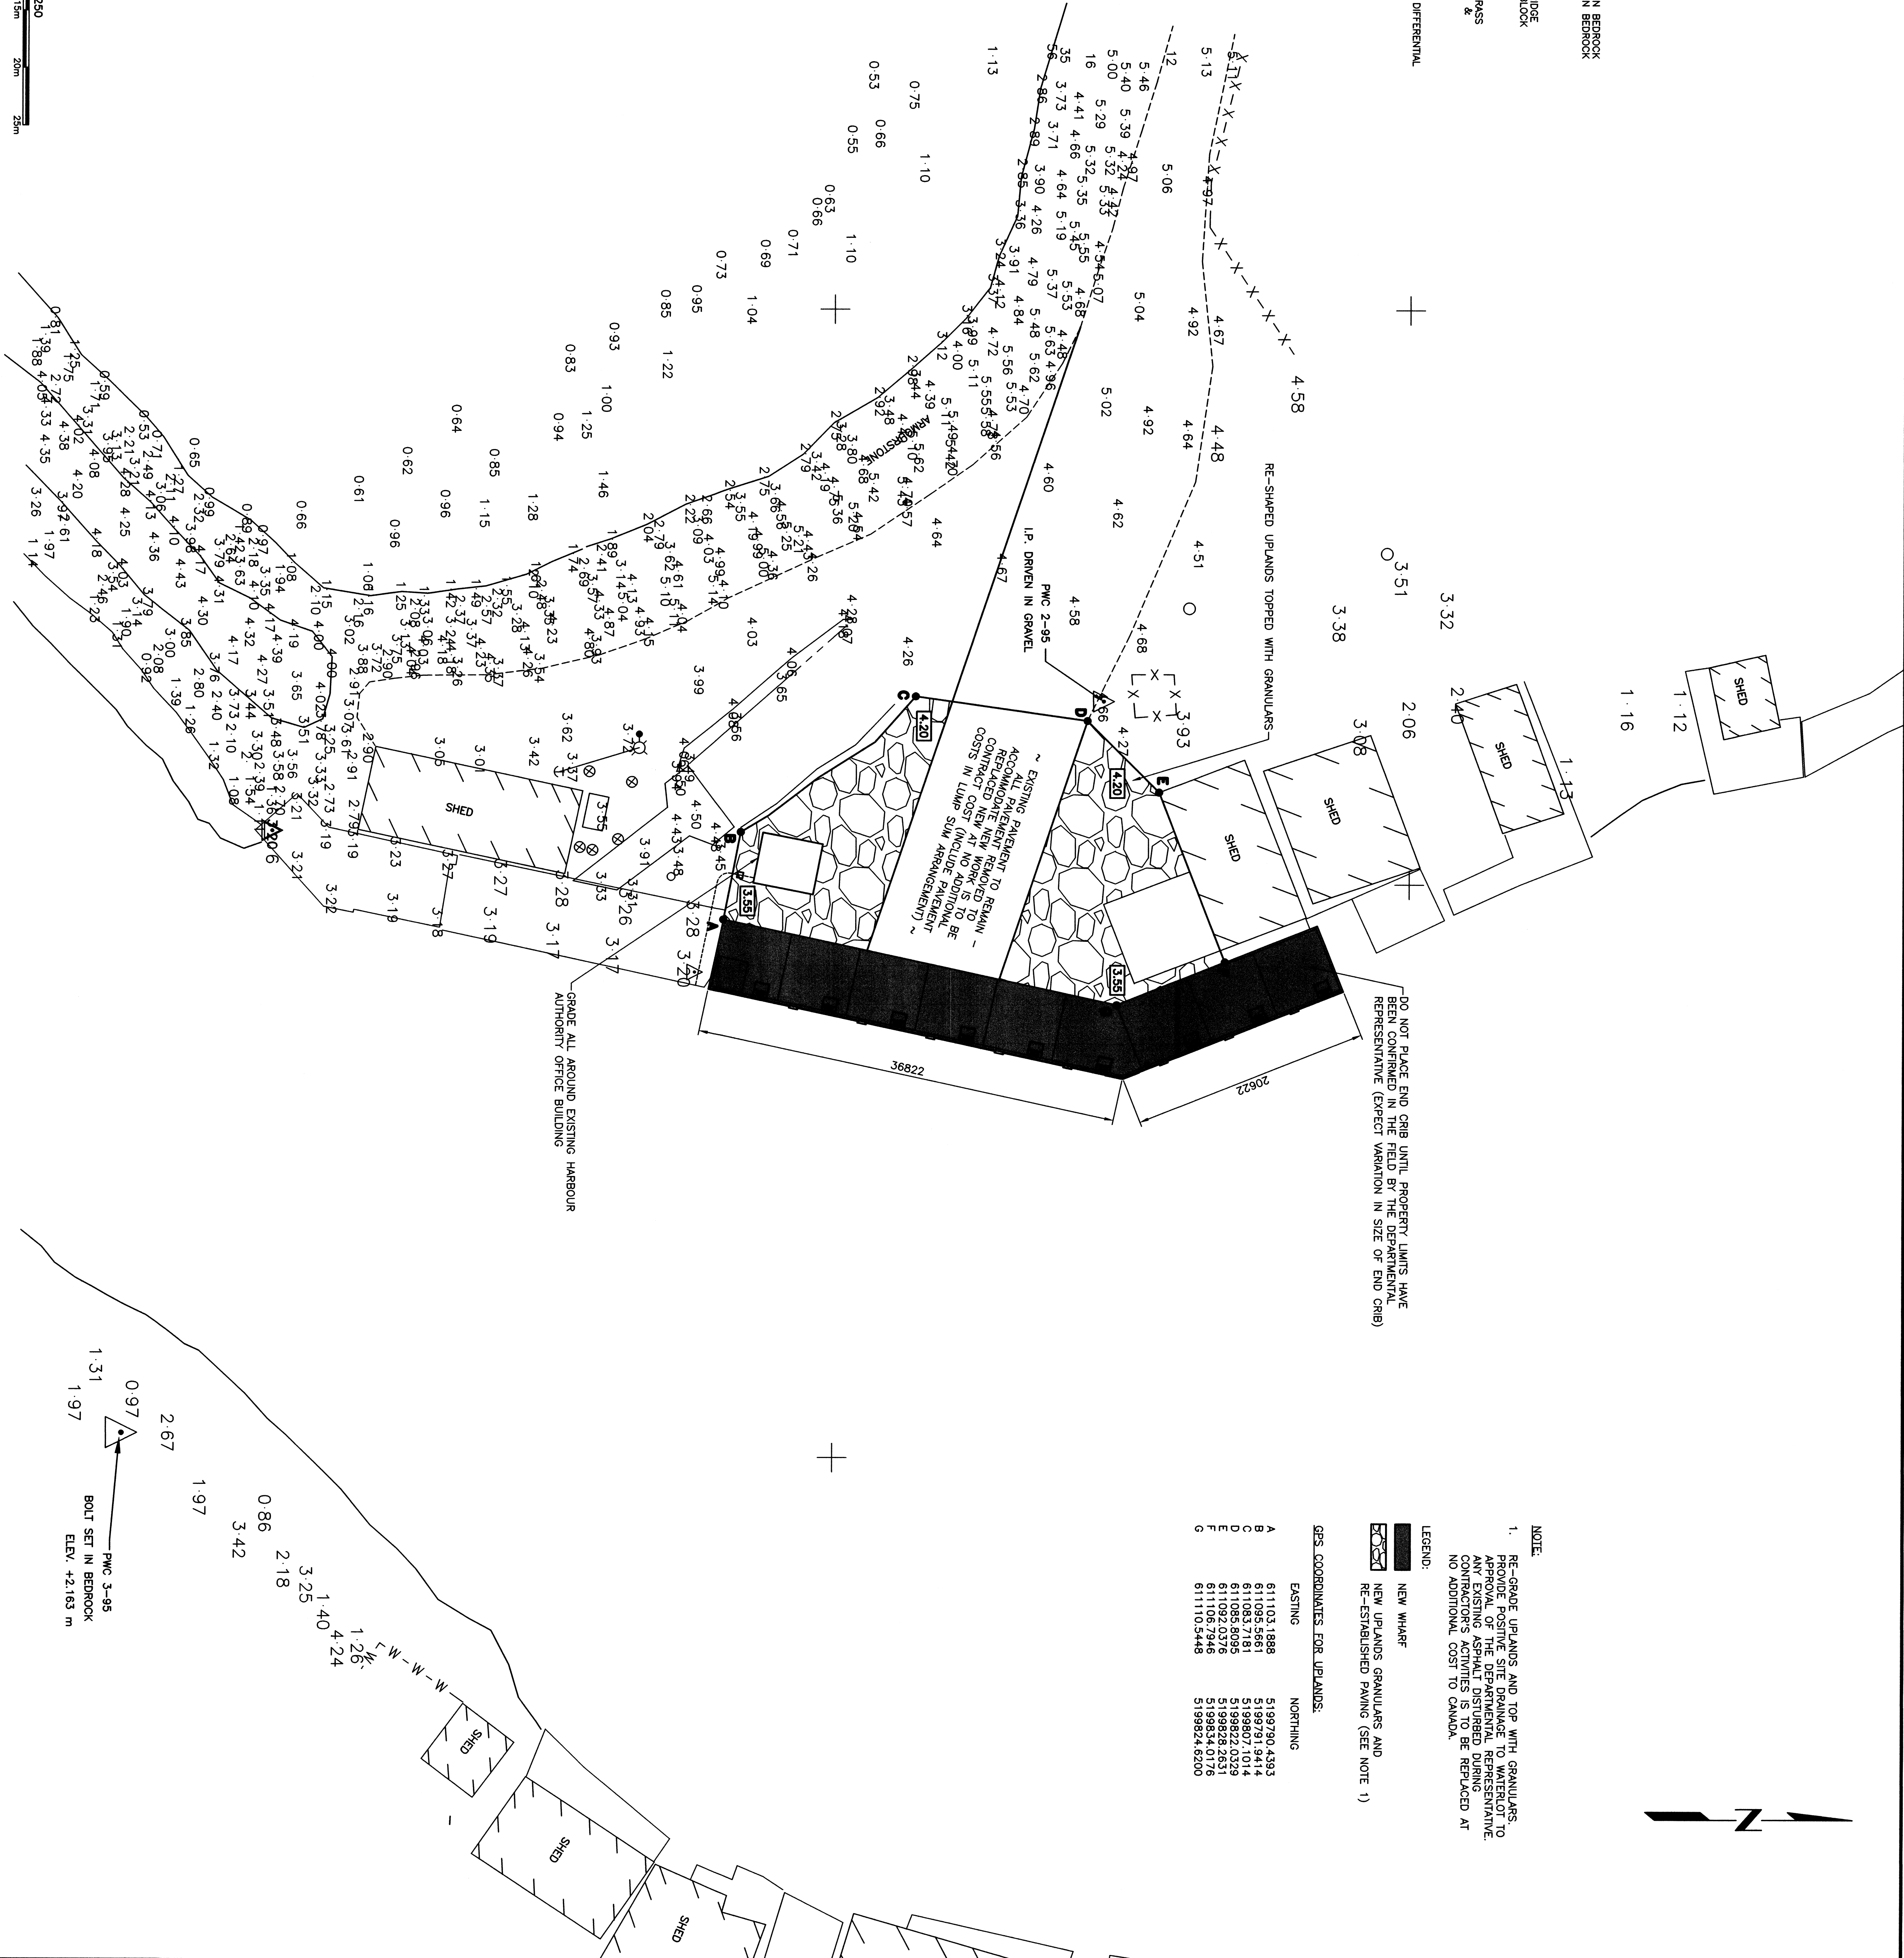1. ALL ELEVATIONS ARE IN METRES
2. UNLESS OTHERWISE NOTED

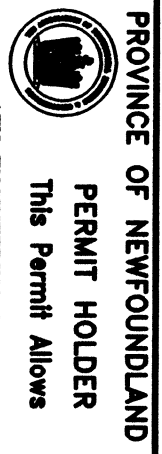

PERMIT HOLDER  
The Permit Holder  
ANY ENGINEERING INC.

To practice Professional Engineering  
in Newfoundland and Labrador, a person  
must be a member of the Engineering Council  
which is valid for the year 2016.

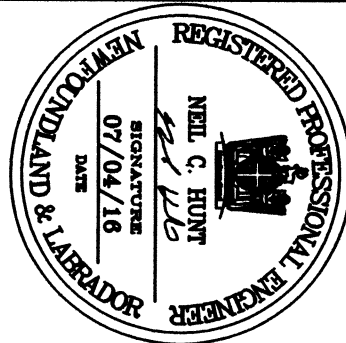

ISSUED FOR TENDER		07/04/16
B	ISSUED FOR 90% REVIEW	05/07/16
A	ISSUED FOR REVIEW	12/28/15
revisions		date
project		project

WHARF  
RECONSTRUCTION  
LAWN, NL

NEW SITE PLAN

designed N.H.	control
drawn P.H.	checked
date JULY 4, 2016	approved

Project number: 718889

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