

PRELIMINARY
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Revision/	Description/Description	Date/Date
E	ISSUED FOR TENDER	Sep.12, 16
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C	99% CONSTRUCTION DOCUMENTS	June 27, 16
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A	DESIGN DEVELOPMENT SUBMISSION	Feb. 19, 16

Client/client
Public Works and Government Services Canada
100 - 167 Lombard Avenue
Winnipeg, Manitoba

Project title/Titre du projet
Lower Fort Garry (LFG)
National Historic Site, Manitoba
HERITAGE BUILDING RECAPITALIZATION

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Ressources Architectural et de Directeur d'ingénierie, TPSCG
Client/client
PARKS CANADA
Drawing title/Titre du dessin
**BIG HOUSE
BASEMENT FLOOR PLAN**



Project No./No. du projet R.075212.001	Sheet/Fauille A2.1 OF 20	Revision no./ La Révision no. D
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GENERAL NOTES:

1. PROVIDE 38 X 89 WOOD BLOCKING FOR ALL NEW WALL MOUNTED EQUIPMENT, MILLWORK, ETC.
2. DIMENSIONS TAKEN TO FACE OF STONE WALL / STUD UNLESS NOTED OTHERWISE.
3. ANY EXISTING WALLS DAMAGED IN THE COURSE OF THIS PROJECT MUST BE REPAIRED AND PATCHED IN KIND WITH A 3 COAT PLASTER (SCRATCH, BROWN AND FINISH COATS) AND PAINTED TO MATCH EXISTING.
4. EXISTING WALLS MAY NOT BE PLUMB. SITE CONFIRM EXISTING CONDITIONS.

BIG HOUSE BASEMENT FLOOR PLAN KEYNOTES:

1. INSTALL NEW LIFT WITH THREE LEVEL STOPS (GRADE, MAIN LEVEL AND BASEMENT LEVEL).
2. NEW OPENING IN EXISTING FOUNDATION WALL. FINISH WITH BUSHHAMMERED TYNDALL STONE.
3. EXISTING STOVES TO BE RE-ASSEMBLED IN PLACE UNDER THE SUPERVISION OF A DEPARTMENTAL REPRESENTATIVE
4. NEW FIRE PULL STATION MOUNTED ON ALUMINUM POST @ 1100mm A.F.F.
5. 102mm x 102mm HSS UPRIGHTS CAST INTO CONCRETE. REFER TO STRUCTURAL.
6. REPLACE REMOVED STONES WITH LIKE STONES AND PAINT TO MATCH EXISTING ON BOTH SIDES OF NEW OPENING.
7. EXISTING STRUCTURAL REINFORCED CONCRETE WALL WITH STONE FACING ON EITHER SIDE.
8. LINE OF WEEPING TILE BELOW
9. 12mm RAW STEEL FLAT PLATE SUMP PIT COVER
10. 50mm WEEPING TILE DISCHARGE PIPE
11. BLOCK IN EXISTING OPENING WITH CONCRETE BLOCK. CORE THROUGH FOR NEW STORZ CONNECTION. REFER TO MECHANICAL.

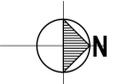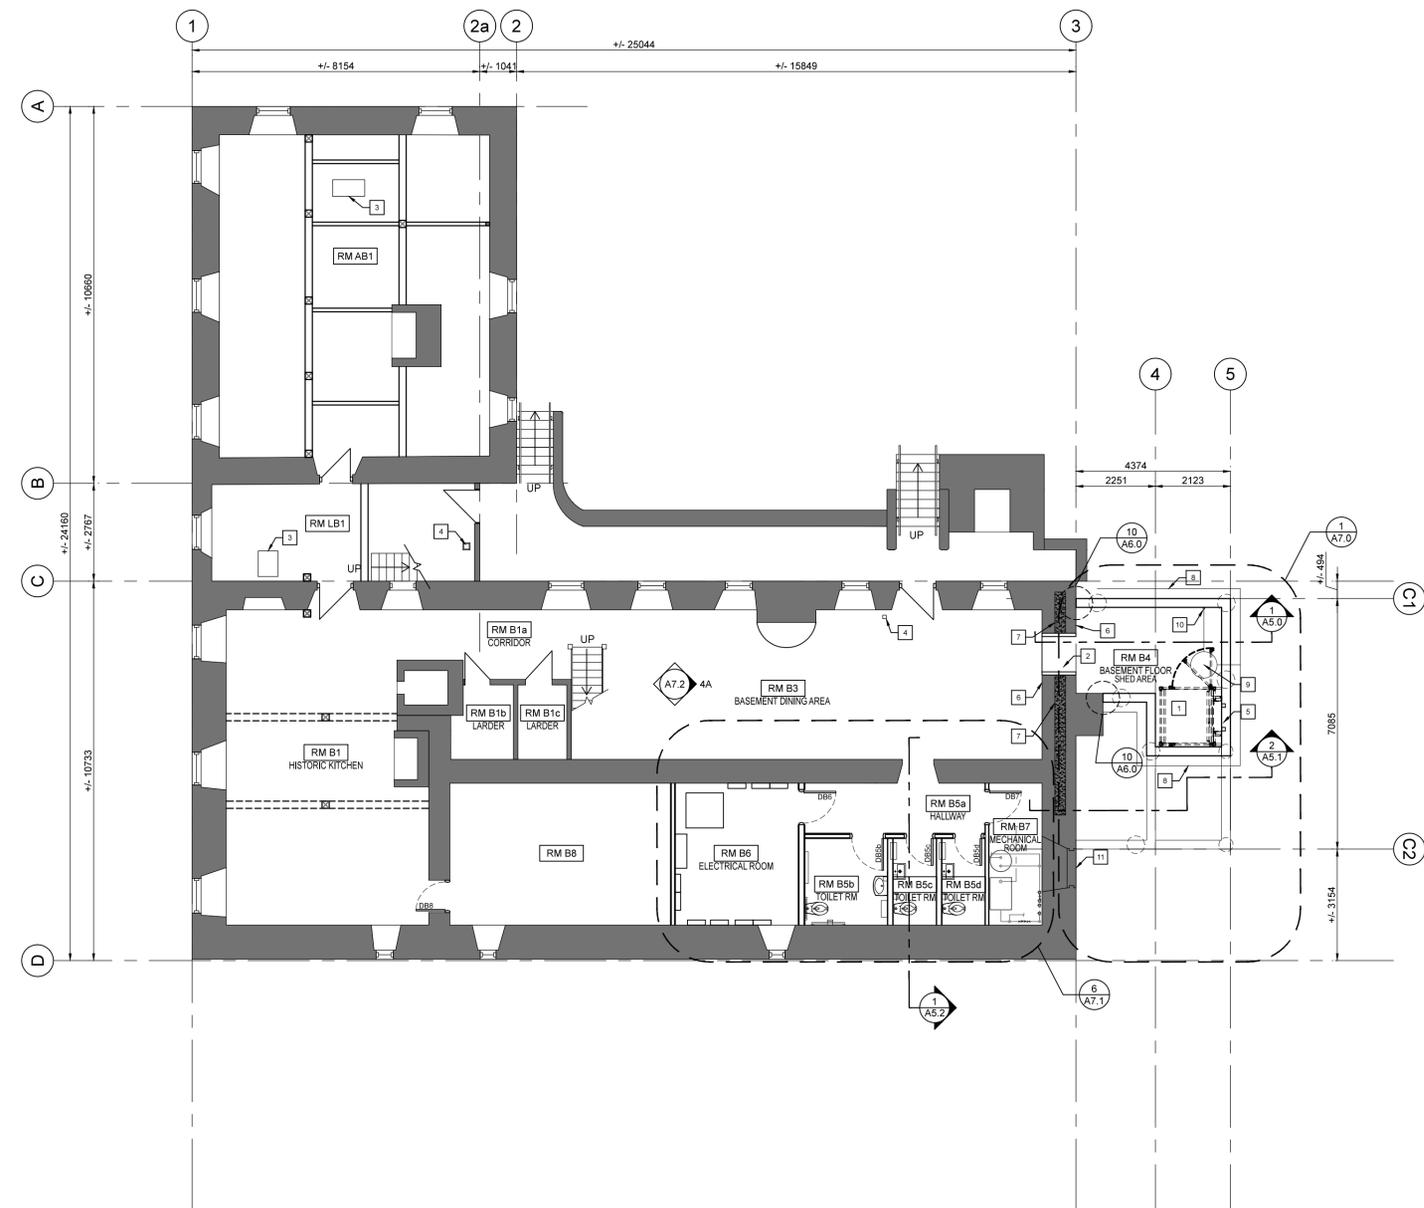

1 BIG HOUSE BASEMENT FLOOR PLAN
A2.1 SCALE: 1:100