

Travaux publics et
Services gouvernementaux
Canada

REAL PROPERTY SERVICES Pacific Region

SERVICES IMMOBILIERS Région de Pacifique

IOS TIMBER AND CONCRETE FLOATS
A, B, C & D



	DRAWING LIST
SHEET NO.	TITLE
G000	COVER SHEET & DRAWING LIST
M100	NEW FLOAT 'D' LAYOUT - MECHANICAL
M101	NEW FLOAT 'A' LAYOUT - MECHANICAL
M102	NEW FLOAT 'B1, 'B2 & 'C' LAYOUT - MECHANICAL
E001	KEY PLAN, SYMBOL LEGEND
E010	EXISTING FLOAT 'D' - DEMOLITION
E011	EXISTING FLOAT 'A' - DEMOLITION
E012	EXISTING FLOAT 'B1', 'B2' & 'C' - DEMOLITION
E100	NEW FLOAT 'D' LAYOUT - ELECTRICAL
E101	NEW FLOAT 'A' LAYOUT - ELECTRICAL
E102	NEW FLOAT 'B1', 'B2 & 'C' LAYOUT - ELECTRICAL
E103	EXISTING NORTH WHARF KIOSK 2 - ELECTRICAL
E500	ELECTRICAL DETAILS (1 OF 2)
E501	ELECTRICAL DETAILS (2 OF 2)
E502	NEW FLOAT TYPICAL INSTALLATION ELEVATION
E600	PROPOSED SINGLE LINE DIAGRAM (1 OF 3)
E601	PROPOSED SINGLE LINE DIAGRAM (2 OF 3)
E602	PROPOSED SINGLE LINE DIAGRAM (3 OF 3)
E700	SCHEDULES



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L PROPERTY SERVICES

REAL PROPERTY SERVICES
Pacific Region
SERVICES IMMOBILIERS
Région de Pacifique



Stantec Consulting Ltd.
www.stantec.com
STANTEC PROJECT NO.: 115615284 TSK200

Revision/	Description / Description	Date / Date
0	ISSUED FOR TENDER	2016.08.05
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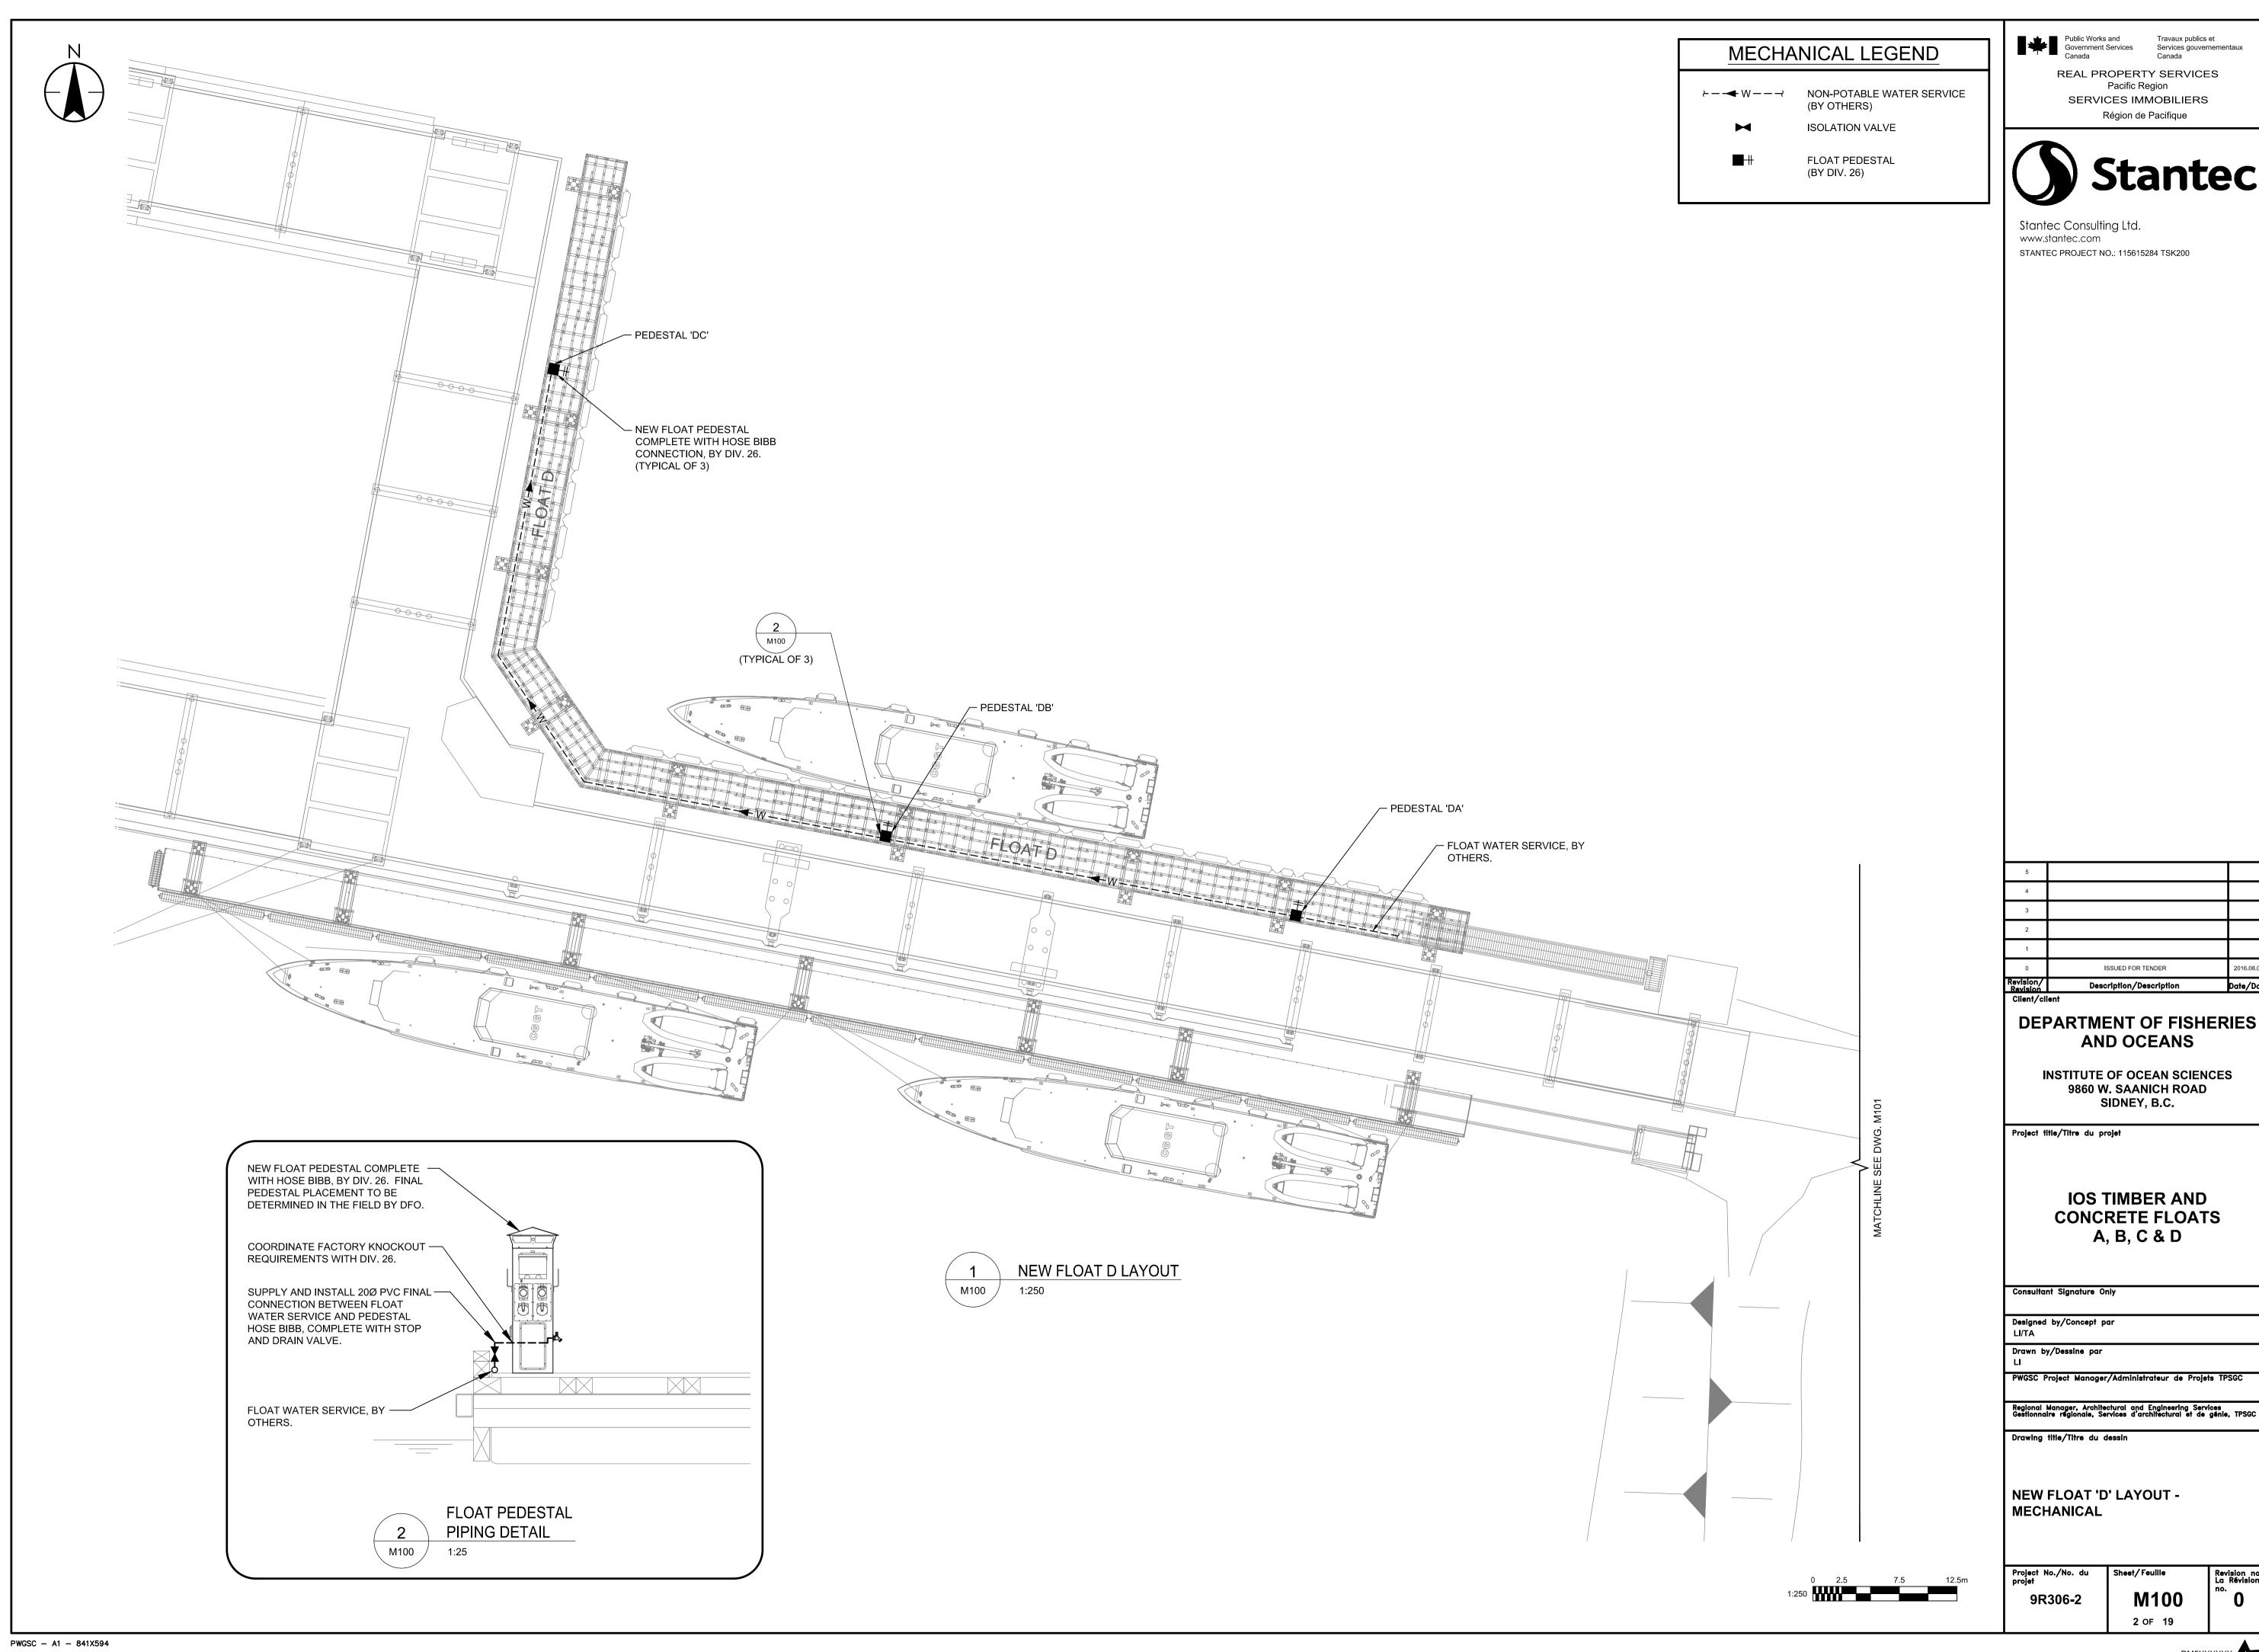
DEPARTMENT OF FISHERIES AND OCEANS


INSTITUTE OF OCEAN SCIENCES 9860 W. SAANICH ROAD SIDNEY, B.C.


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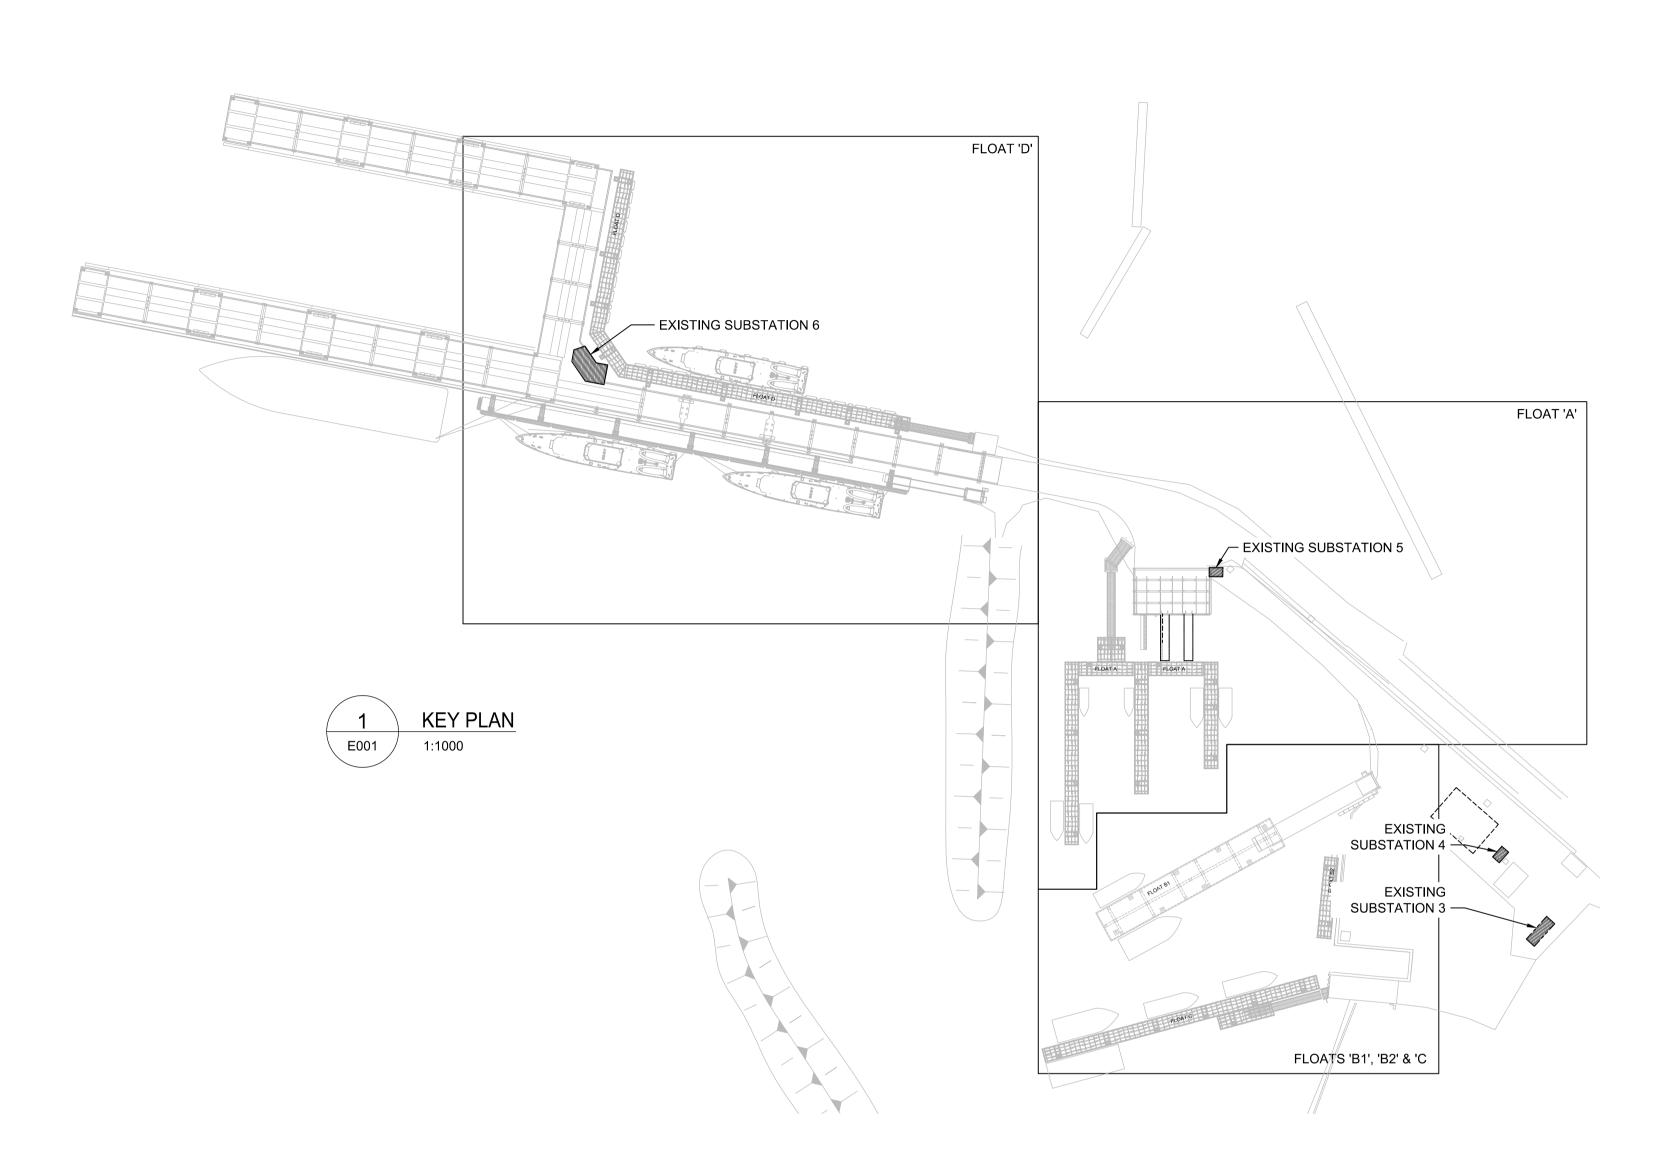
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	Drawn by/Dessine par AG		
	PWGSC Project Manager	/Administrateur de Projet	s TPSGC
	Regional Manager, Archite Gestionnaire régionale, Se	ctural and Engineering Serv rvices d'architectural et de	ices génie, TPSGC
	COVER SHEET	& DRAWING LI	ST
	Project No./No. du projet	Sheet/Feuille	Revision no La Révision
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J		1 OF 19	







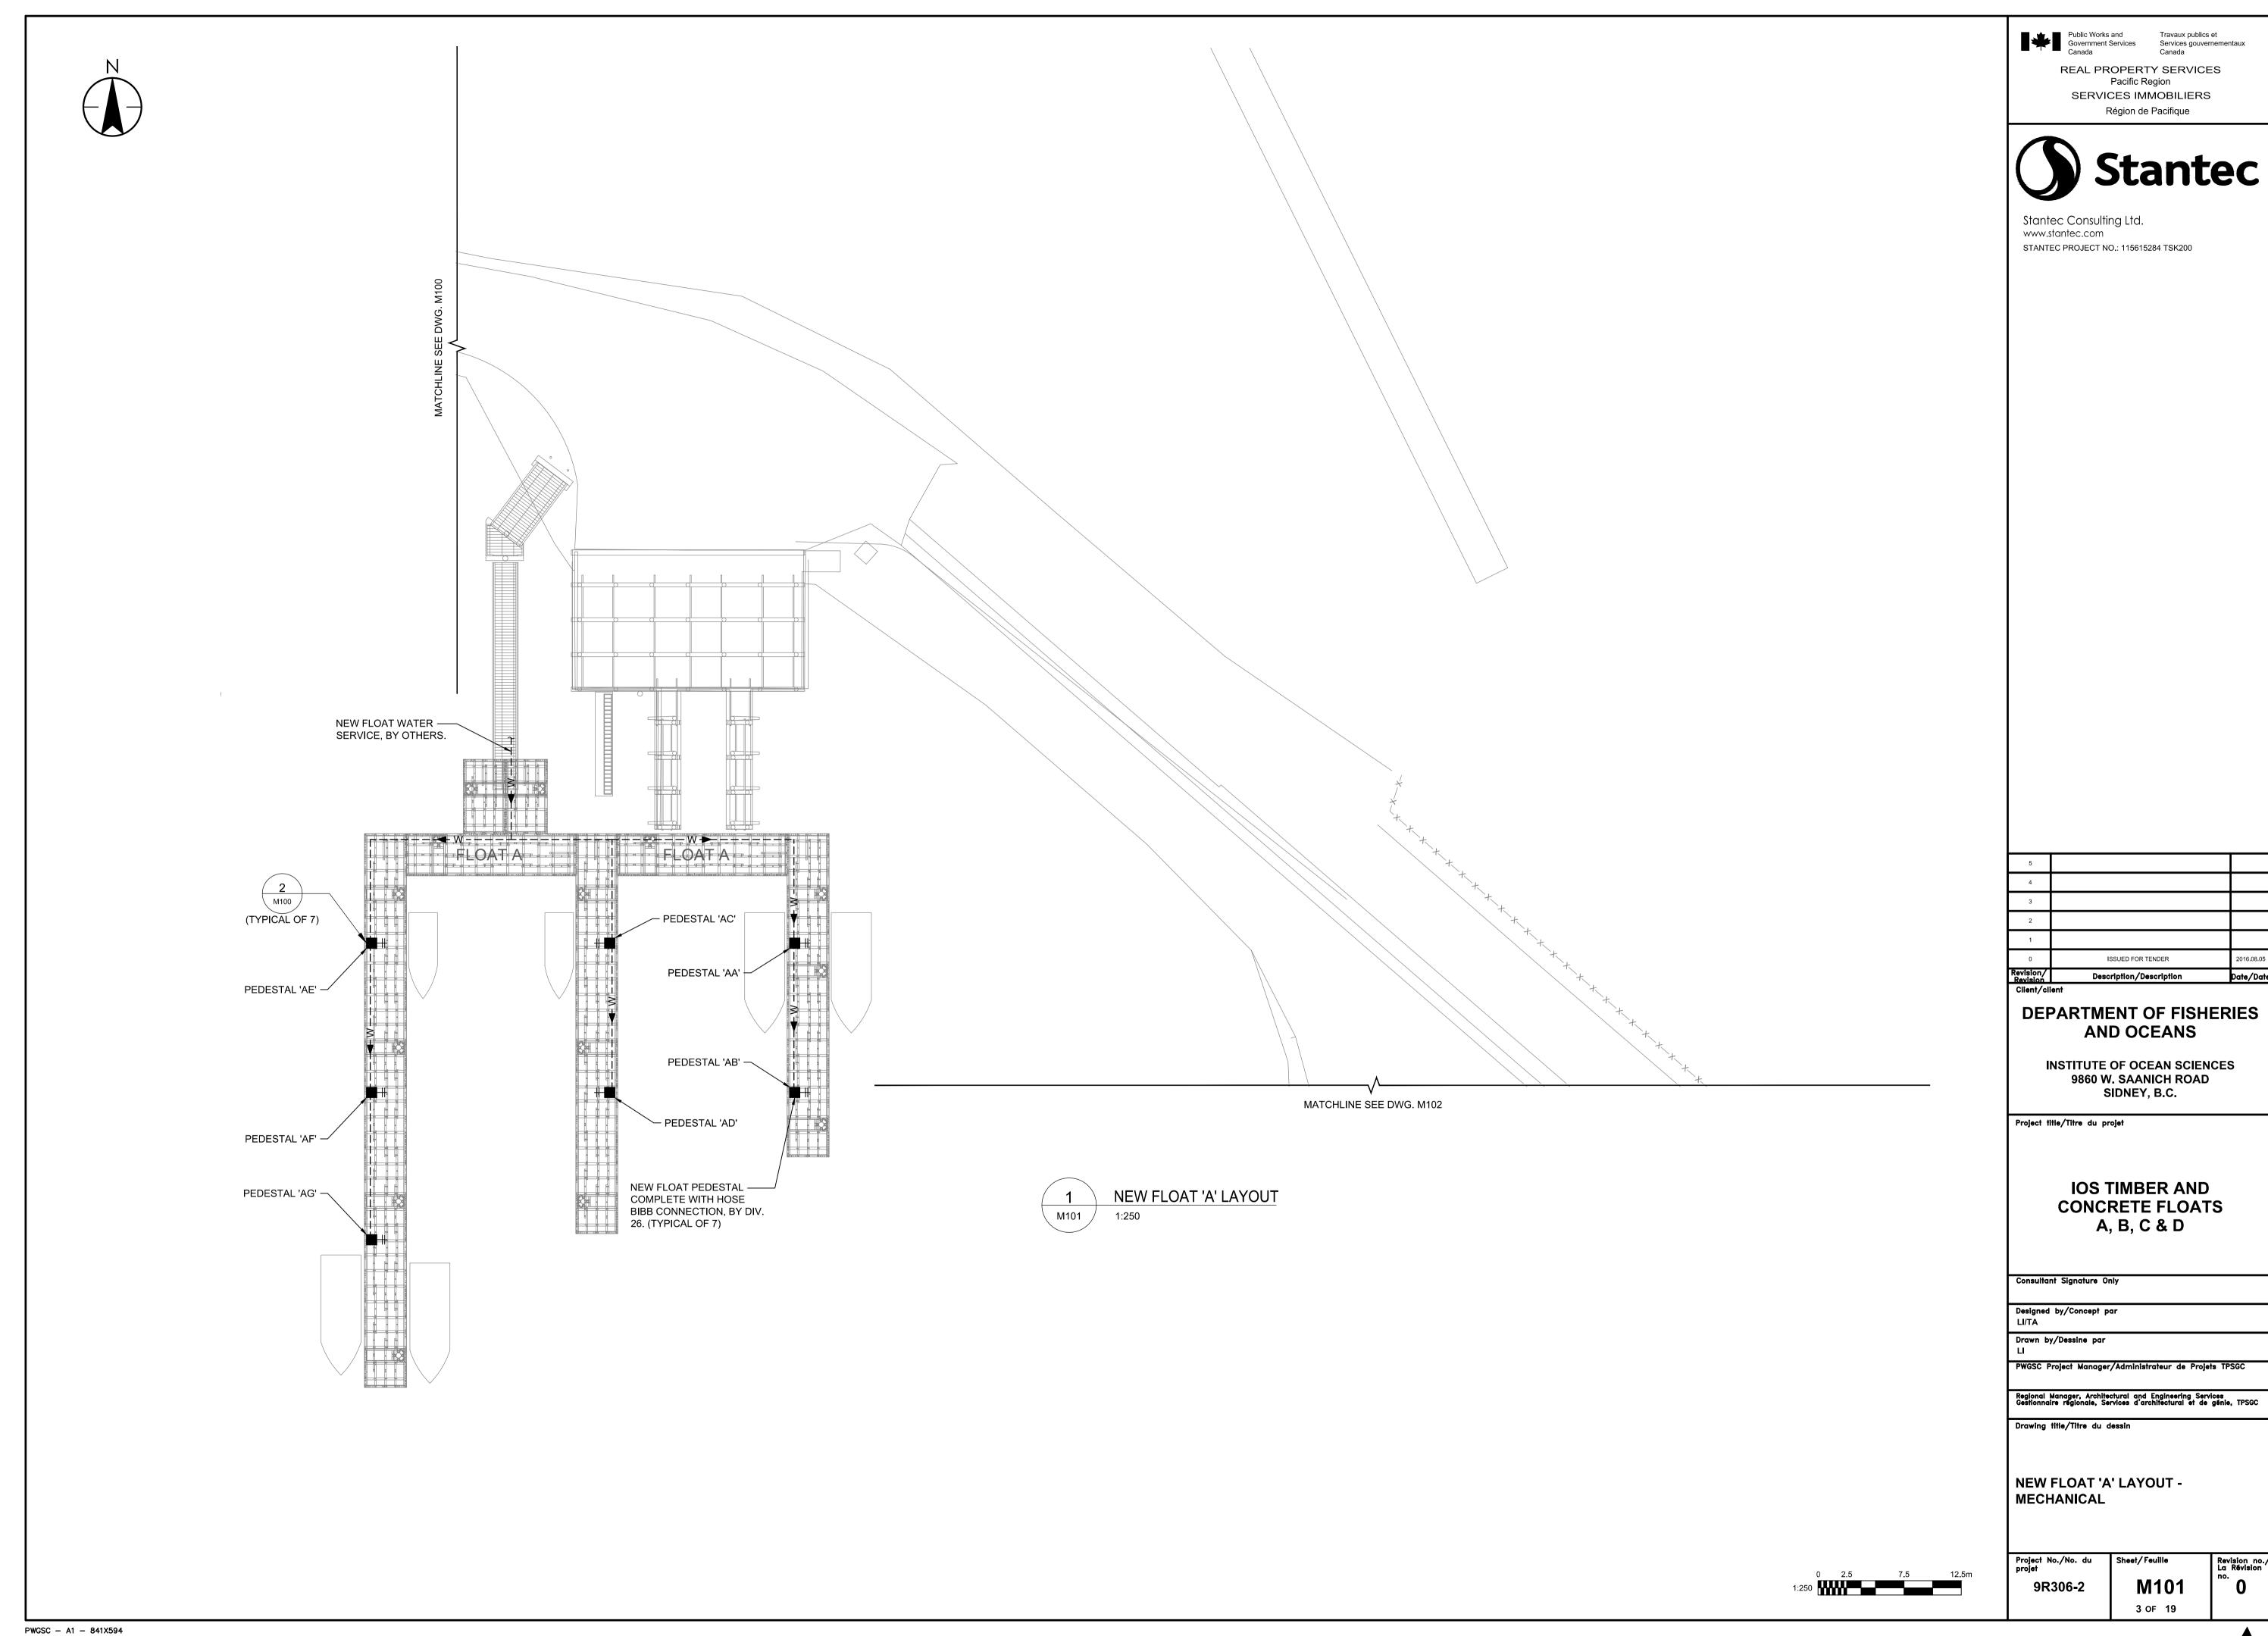

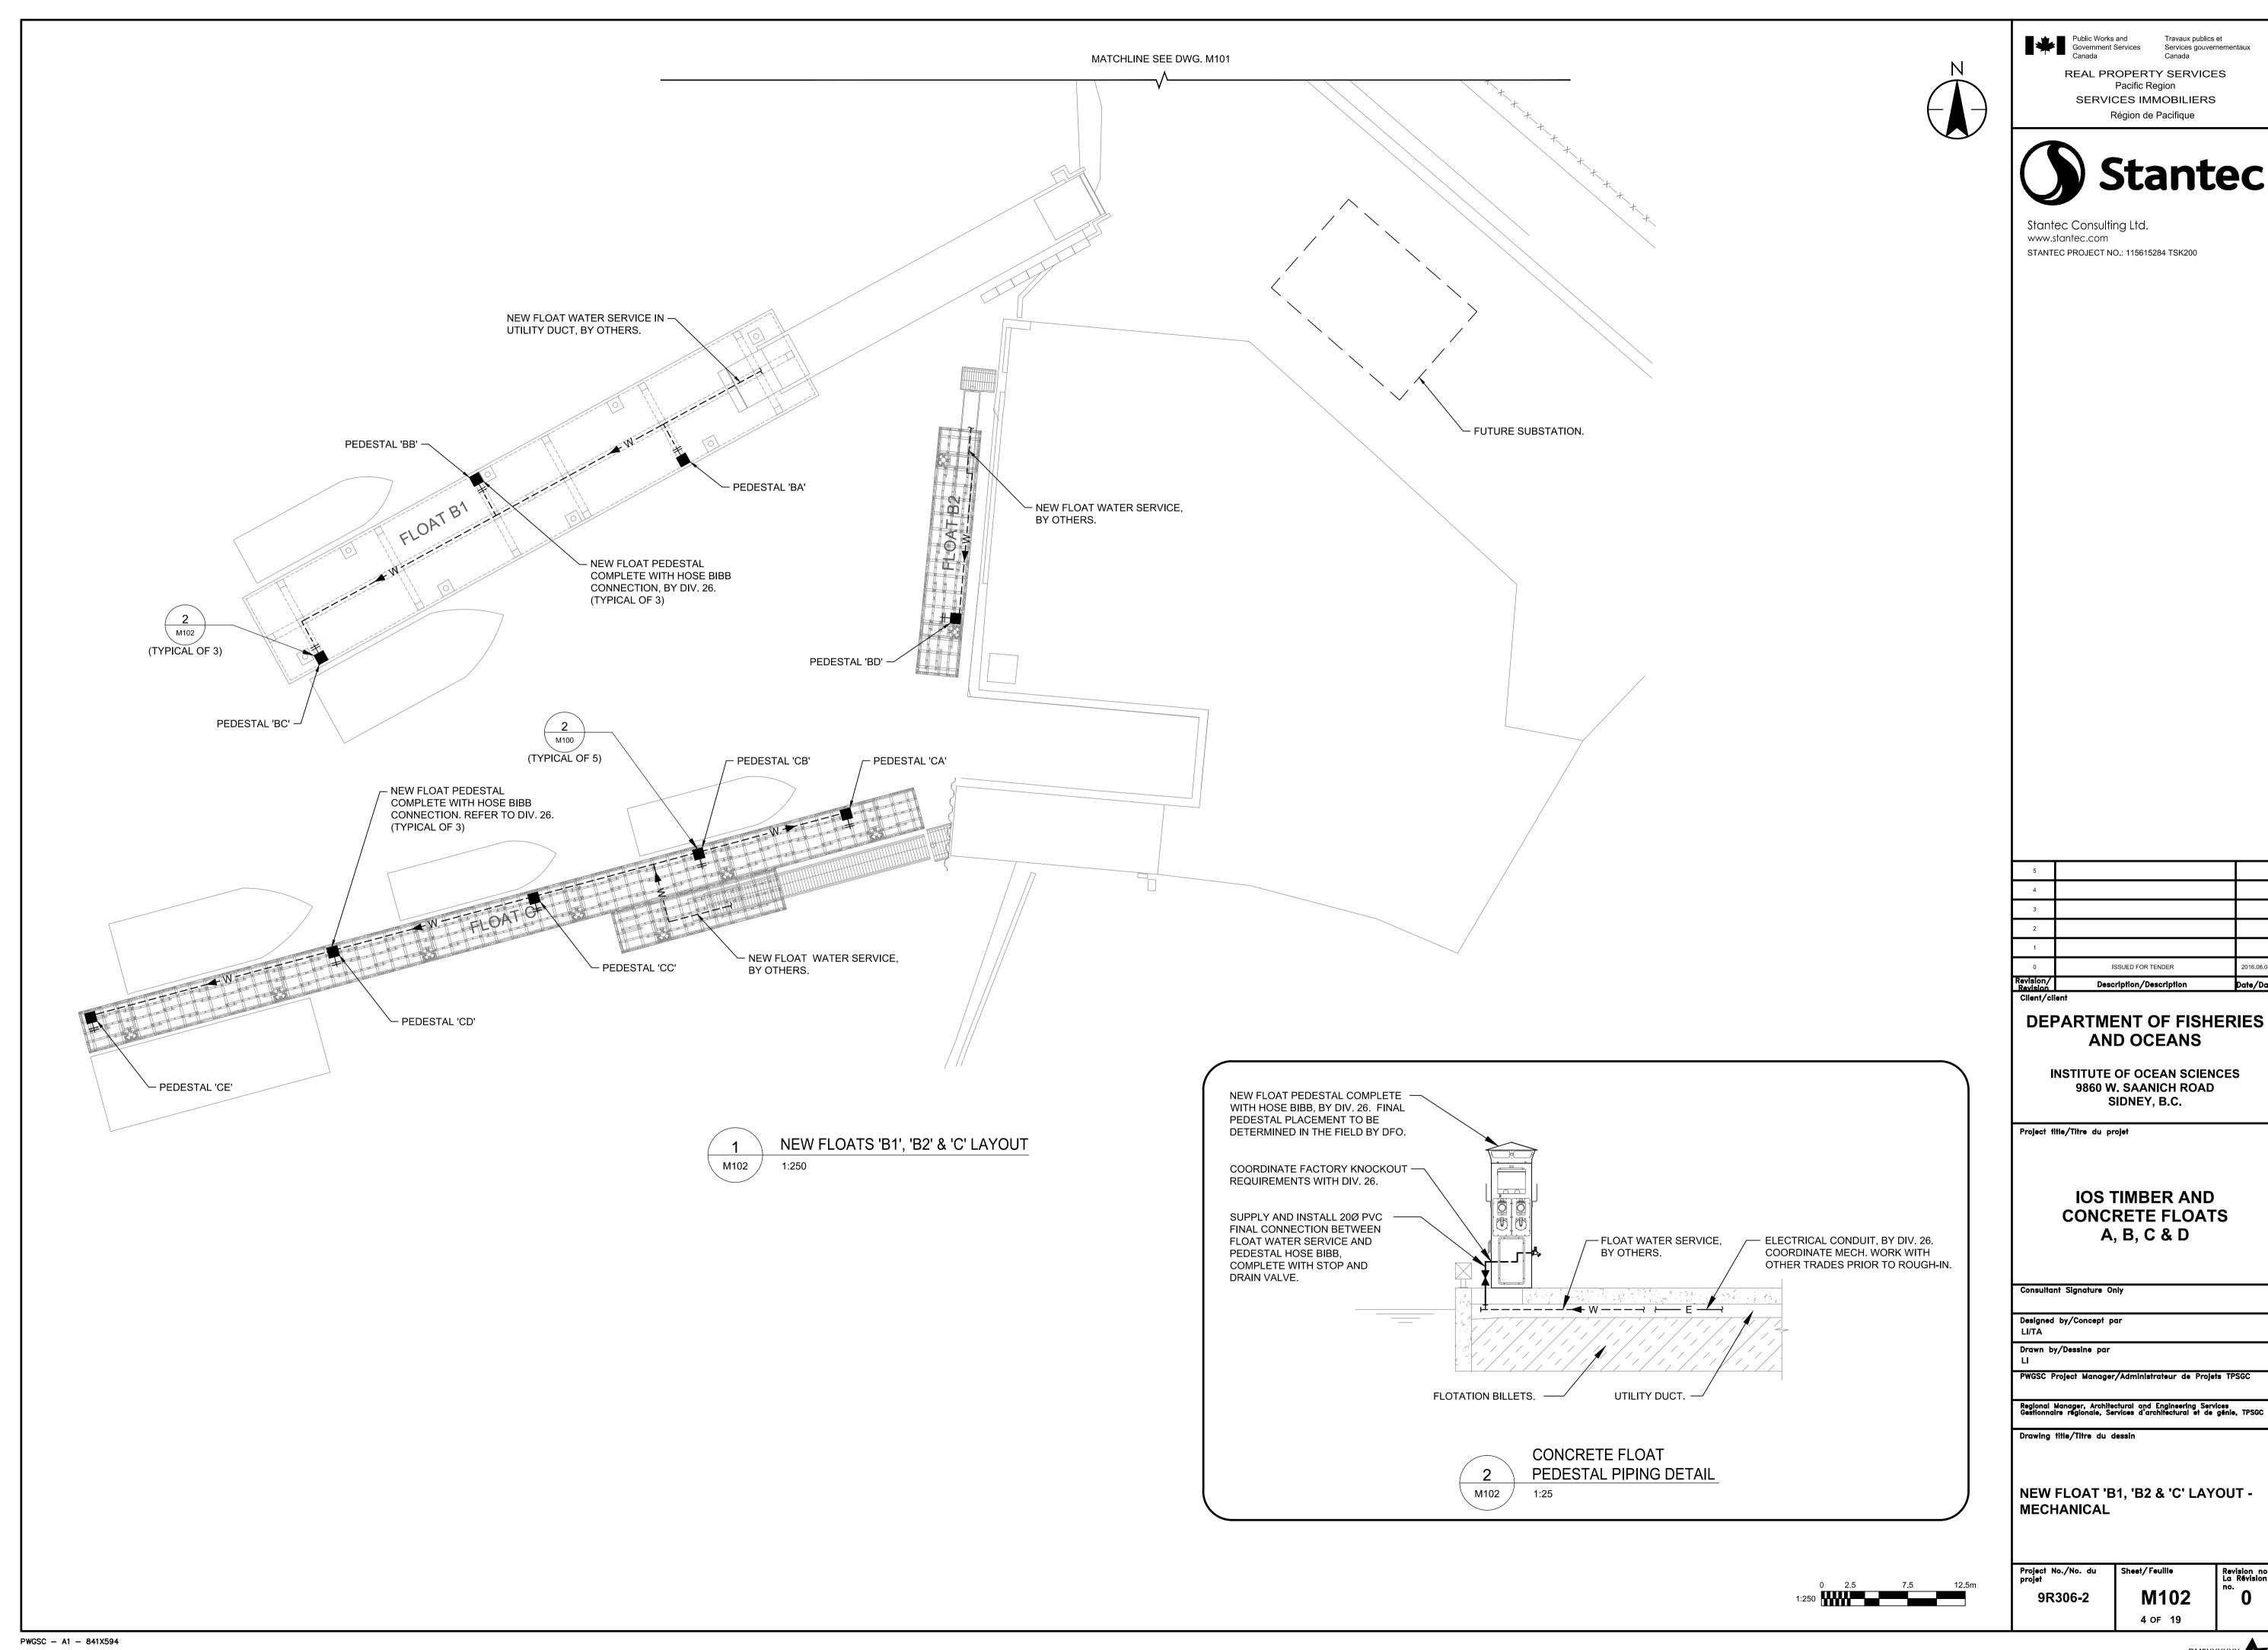

	SCHEMATIC SYMBOLS
~~	DISCONNECT SWITCH
	FUSE
\sim	BREAKER
 	TRANSFORMER
щи	AUTOTRANSFORMER
₽#	CURRENT TRANSFORMERS (# INDICATES NUMBER OF CTs IN GROUP)
-3⊊#	POTENTIAL TRANSFORMERS (# INDICATES NUMBER OF PTs IN GROUP)
⊣⊢	NORMALLY OPEN CONTACT
-₩-	NORMALLY CLOSED CONTACT
K	KEY INTERLOCK
\bigcirc	VOLTMETER
DMS	DIGITAL METER SYSTEM
UPS	UNINTERRUPTED POWER SOURCE
Δ	DELTA CONNECTION
Y	WYE CONNECTION
÷	GROUND CONNECTION
46	CAPACITOR
ı ⊷ ⊶	LIGHTNING ARRESTOR
PANEL PNL N2A 42CCT	PANELBOARD
	PUSH PULL SWITCH
	GROUND BUS
МН	CONCRETE MANHOLE/PULLBOX
РВ	STAINLESS STEEL PULLBOX
++	CONNECTION
~~~	SPACE HEATER
X	LIGHT
مله	PUSHBUTTON SWITCH, NORMALLY CLOSED
-	PUSHBUTTON SWITCH, NORMALLY OPEN
\mathcal{L}	SELECTOR SWITCH
HOA	HAND-OFF-AUTO SWITCH
-∞- -	MAGNETIC MOTOR STARTER
-~~	MANUAL MOTOR STARTER
−x−	MOTOR OVERLOAD
4	BREAK LINE
~	CONTINUATION BREAK

ELECTRICAL SYMBOLS

POLE MOUNTED LUMINAIRE (SINGLE HEAD)

DUPLEX 5-20R RECEPTACLE, T-SLOT

SPLIT CIRCUIT DUPLEX 5-15R RECEPTACLE

⊕GF DUPLEX 5-15R RECEPTACLE C/W INTEGRAL GFCI PROTECTION

DUPLEX 5-15R RECEPTACLE

SINGLE 5-15R RECEPTACLE

TWO DUPLEX 5-15R RECEPTACLES

FIRE ALARM HORN STROBE

LINETYPES

ABBREVIATIONS

UNDERGROUND COMMUNICATION CONDUIT

— UNDERGROUND POWER CONDUIT

EX EXISTING DEVICE TO REMAIN

NEW DEVICE

AFG ABOVE FINISHED GRADE

GROUND FAULT

JUNCTION BOX

STAINLESS STEEL

TBD TO BE DETERMINED

WEATHERPROOF

U/G UNDERGROUND

GF

SS

TYP

REMOVE EXISTING DEVICE

RELOCATE EXISTING DEVICE

ABOVE FINISHED FLOOR

GFCI GROUND FAULT CIRCUIT INTERRUPTER

RP REPLACE EXISTING DEVICE WITH NEW DEVICE

EXISTING DEVICE IN RELOCATED POSITION

LIQUID—TIGHT FLEXIBLE STEEL CONDUIT
RIGID POLYVINYL CHLORIDE CONDUIT

ABOVE GROUND CONDUIT

		1
İ	Ю	SPECIAL RECEPTACLE (TYPE AS INDICATED)
	⋄♦	REEL CORD RECEPTACLE (TYPE AS INDICATED)
	$\overline{\bigcirc}$	FLOOR MOUNTED DUPLEX 5-15R RECEPTACLE
İ	$\overline{igoplus}$	TWO FLOOR MOUNTED DUPLEX 5-15R RECEPTACLES
	•	UTILITY POLE (TYPE AS INDICATED)
	J	CEILING MOUNTED JUNCTION BOX
	Ų	WALL MOUNTED JUNCTION BOX
	J	FLOOR MOUNTED JUNCTION BOX
		POWER PANELBOARD
		PANEL (TYPE AS INDICATED - SECURITY, LIGHTING RELAY, ETC.)
		SURFACE RACEWAY (TYPE AS INDICATED)
	•	PUSHBUTTON (TYPE AND WIRING AS INDICATED)
	\top	GROUND BUS BAR
		ROOM REFERENCE GROUND BUS
	9	MOTOR
	ÓD-	MOTOR c/w DISCONNECT SWITCH
	ÓM	COMBINATION DISCONNECT AND MAGNETIC MOTOR STARTER
		DISCONNECT SWITCH
	ď	FUSED DISCONNECT SWITCH
\dashv	\boxtimes	MAGNETIC MOTOR STARTER
-	T	THERMOSTAT
-	-C> MP	MANUAL MOTOR STARTER c/w PILOT LIGHT
\dashv		EMERGENCY STOP PUSHBUTTON (RED MUSHROOM STYLE BUTTON)
	00	START/STOP PUSHBUTTONS - (DC - SAWDUST COLLECTOR CONTROL) UP/DOWN/START PUSHBUTTONS - (OH - OVERHEAD DOOR CONTROL)
	ເ⇔ SC	CEILING FAN VARIABLE SPEED CONTROL SWITCH
	PP	POWER PULLPIT
	РВ	POWER PULLBOX
	СР	COMMUNICATION PULLPIT
	СВ	COMMUNICATION PULLBOX
	Т	TRANSFORMER
		PEDESTAL
		CONDUIT STUB
	Θ——	CONDUIT UP
		CONDUIT DOWN
	•	DEVICE MOUNTED ABOVE MILLWORK COUNTERTOP
	Ē	FIRE ALARM MANUAL PULLSTATION
- 1	<u> </u>	

	Public Works and Government Services Canada	Travaux publics et Services gouvernementaux Canada
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www.stc	Consulting Ltd. antec.com PROJECT NO.: 115615	antec

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DEPARTMENT OF FISHERIES AND OCEANS

INSTITUTE OF OCEAN SCIENCES 9860 W. SAANICH ROAD SIDNEY, B.C.

Project title/Titre du projet

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Consultant Signature Only

Designed by/Concept par
AD/MB

Drawn by/Dessine par
AG

PWGSC Project Manager/Administrateur de Projets TPSGC

Regional Manager, Architectural and Engineering Services Gestionnaire régionale, Services d'architectural et de génie, TPSGC

Drawing title/Titre du dessin


KEY PLAN, SYMBOL LEGEND

Project No./No. du projet

9R306-2

E001

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Public Works and Government Services Services gouvernementaux Canada

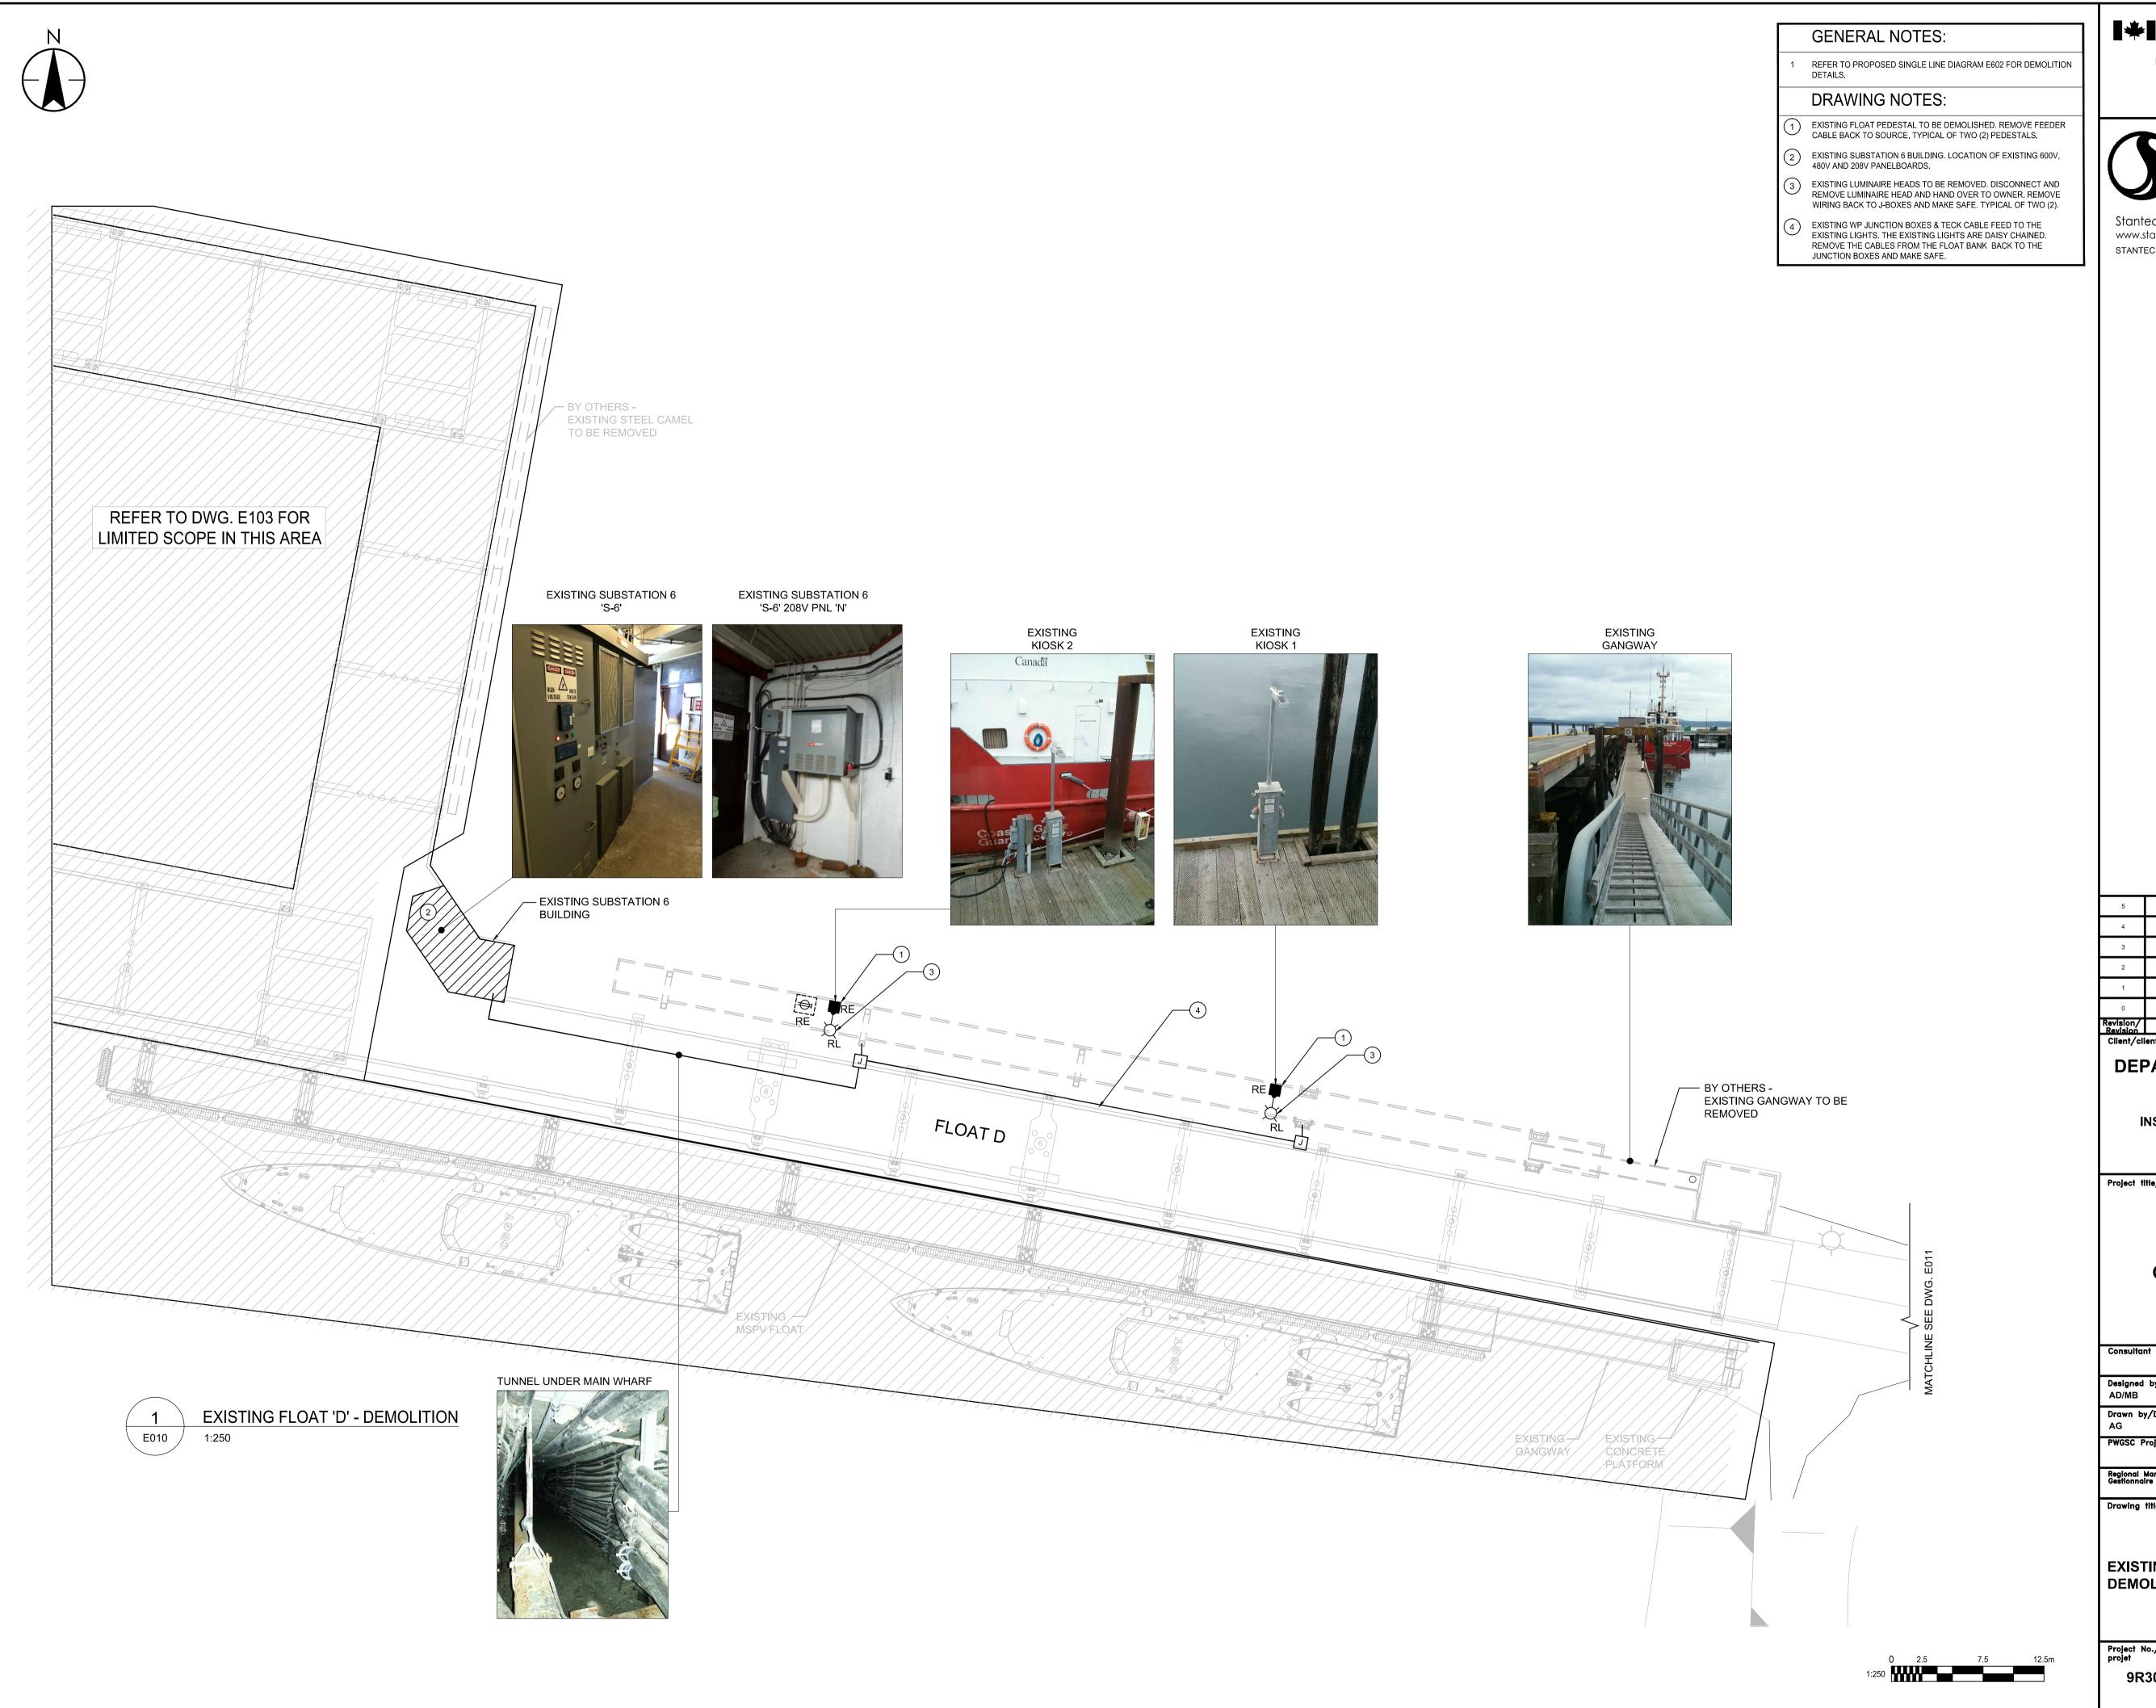REAL PROPERTY SERVICES Pacific Region SERVICES IMMOBILIERS Région de Pacifique



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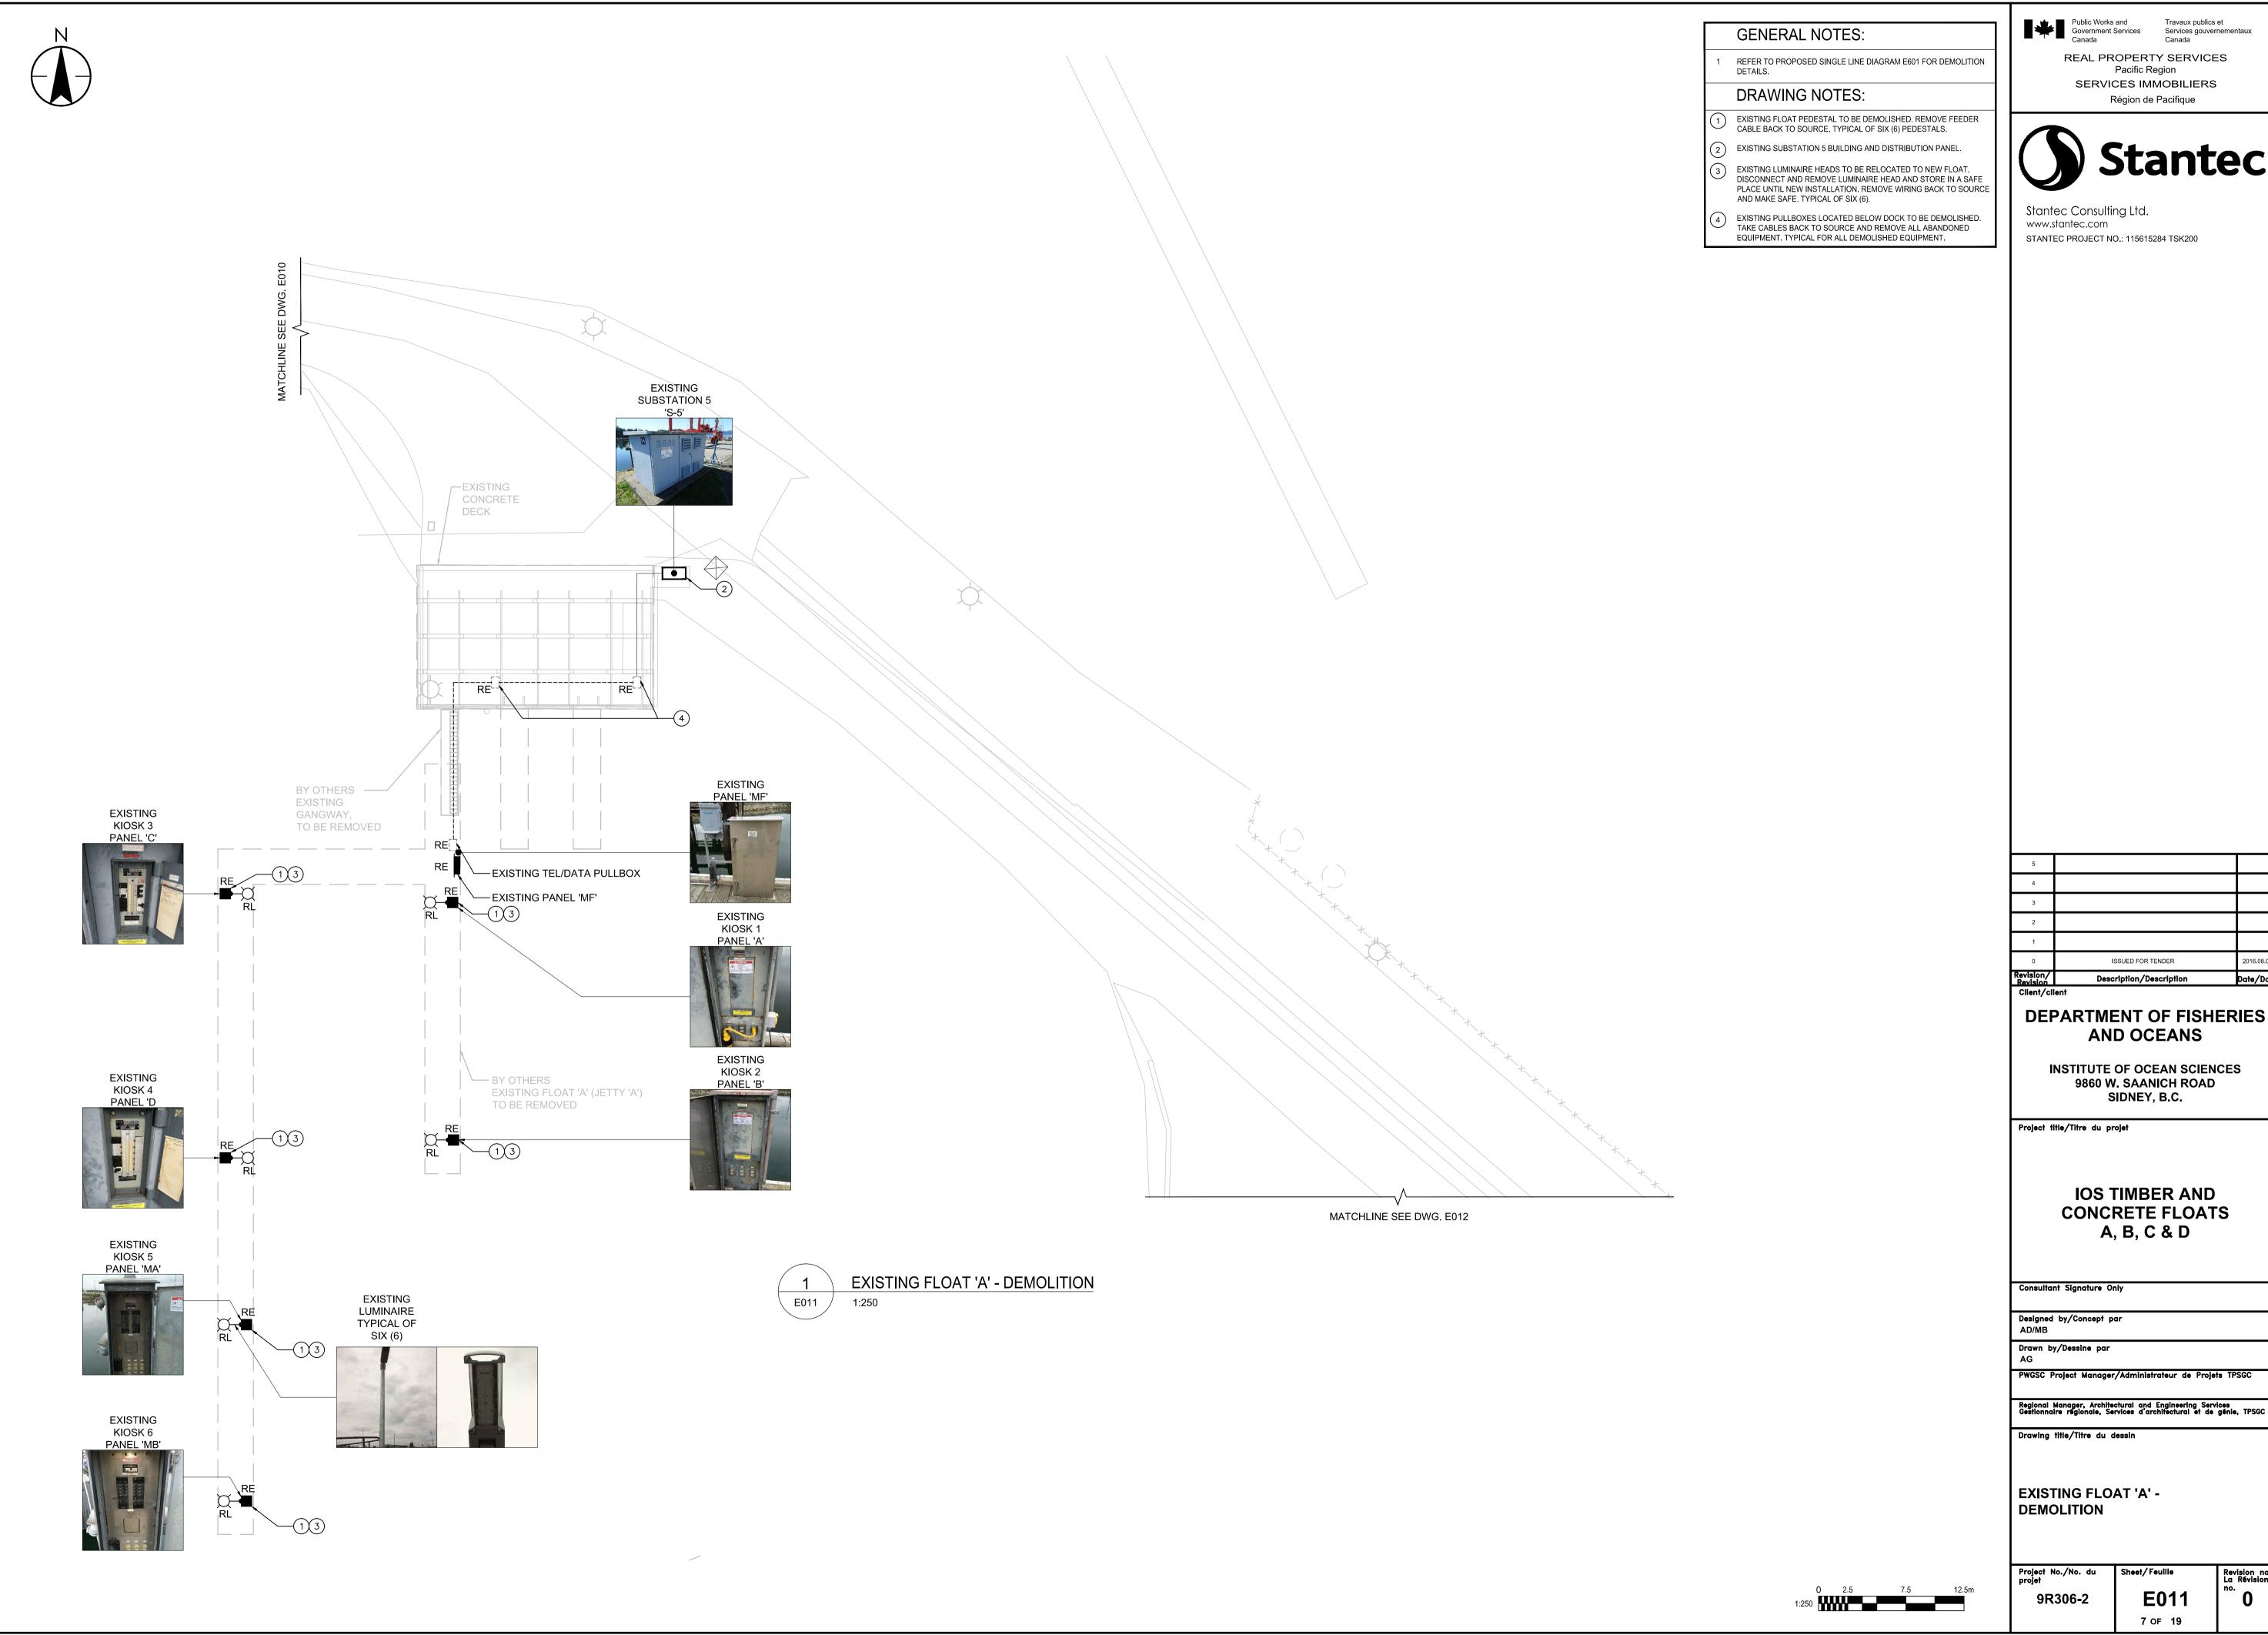
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EXISTING FLOAT 'D' -DEMOLITION


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Travaux publics et Services gouvernementaux

REAL PROPERTY SERVICES Pacific Region SERVICES IMMOBILIERS Région de Pacifique



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Drawn by/Dessine par

PWGSC Project Manager/Administrateur de Projets TPSGC

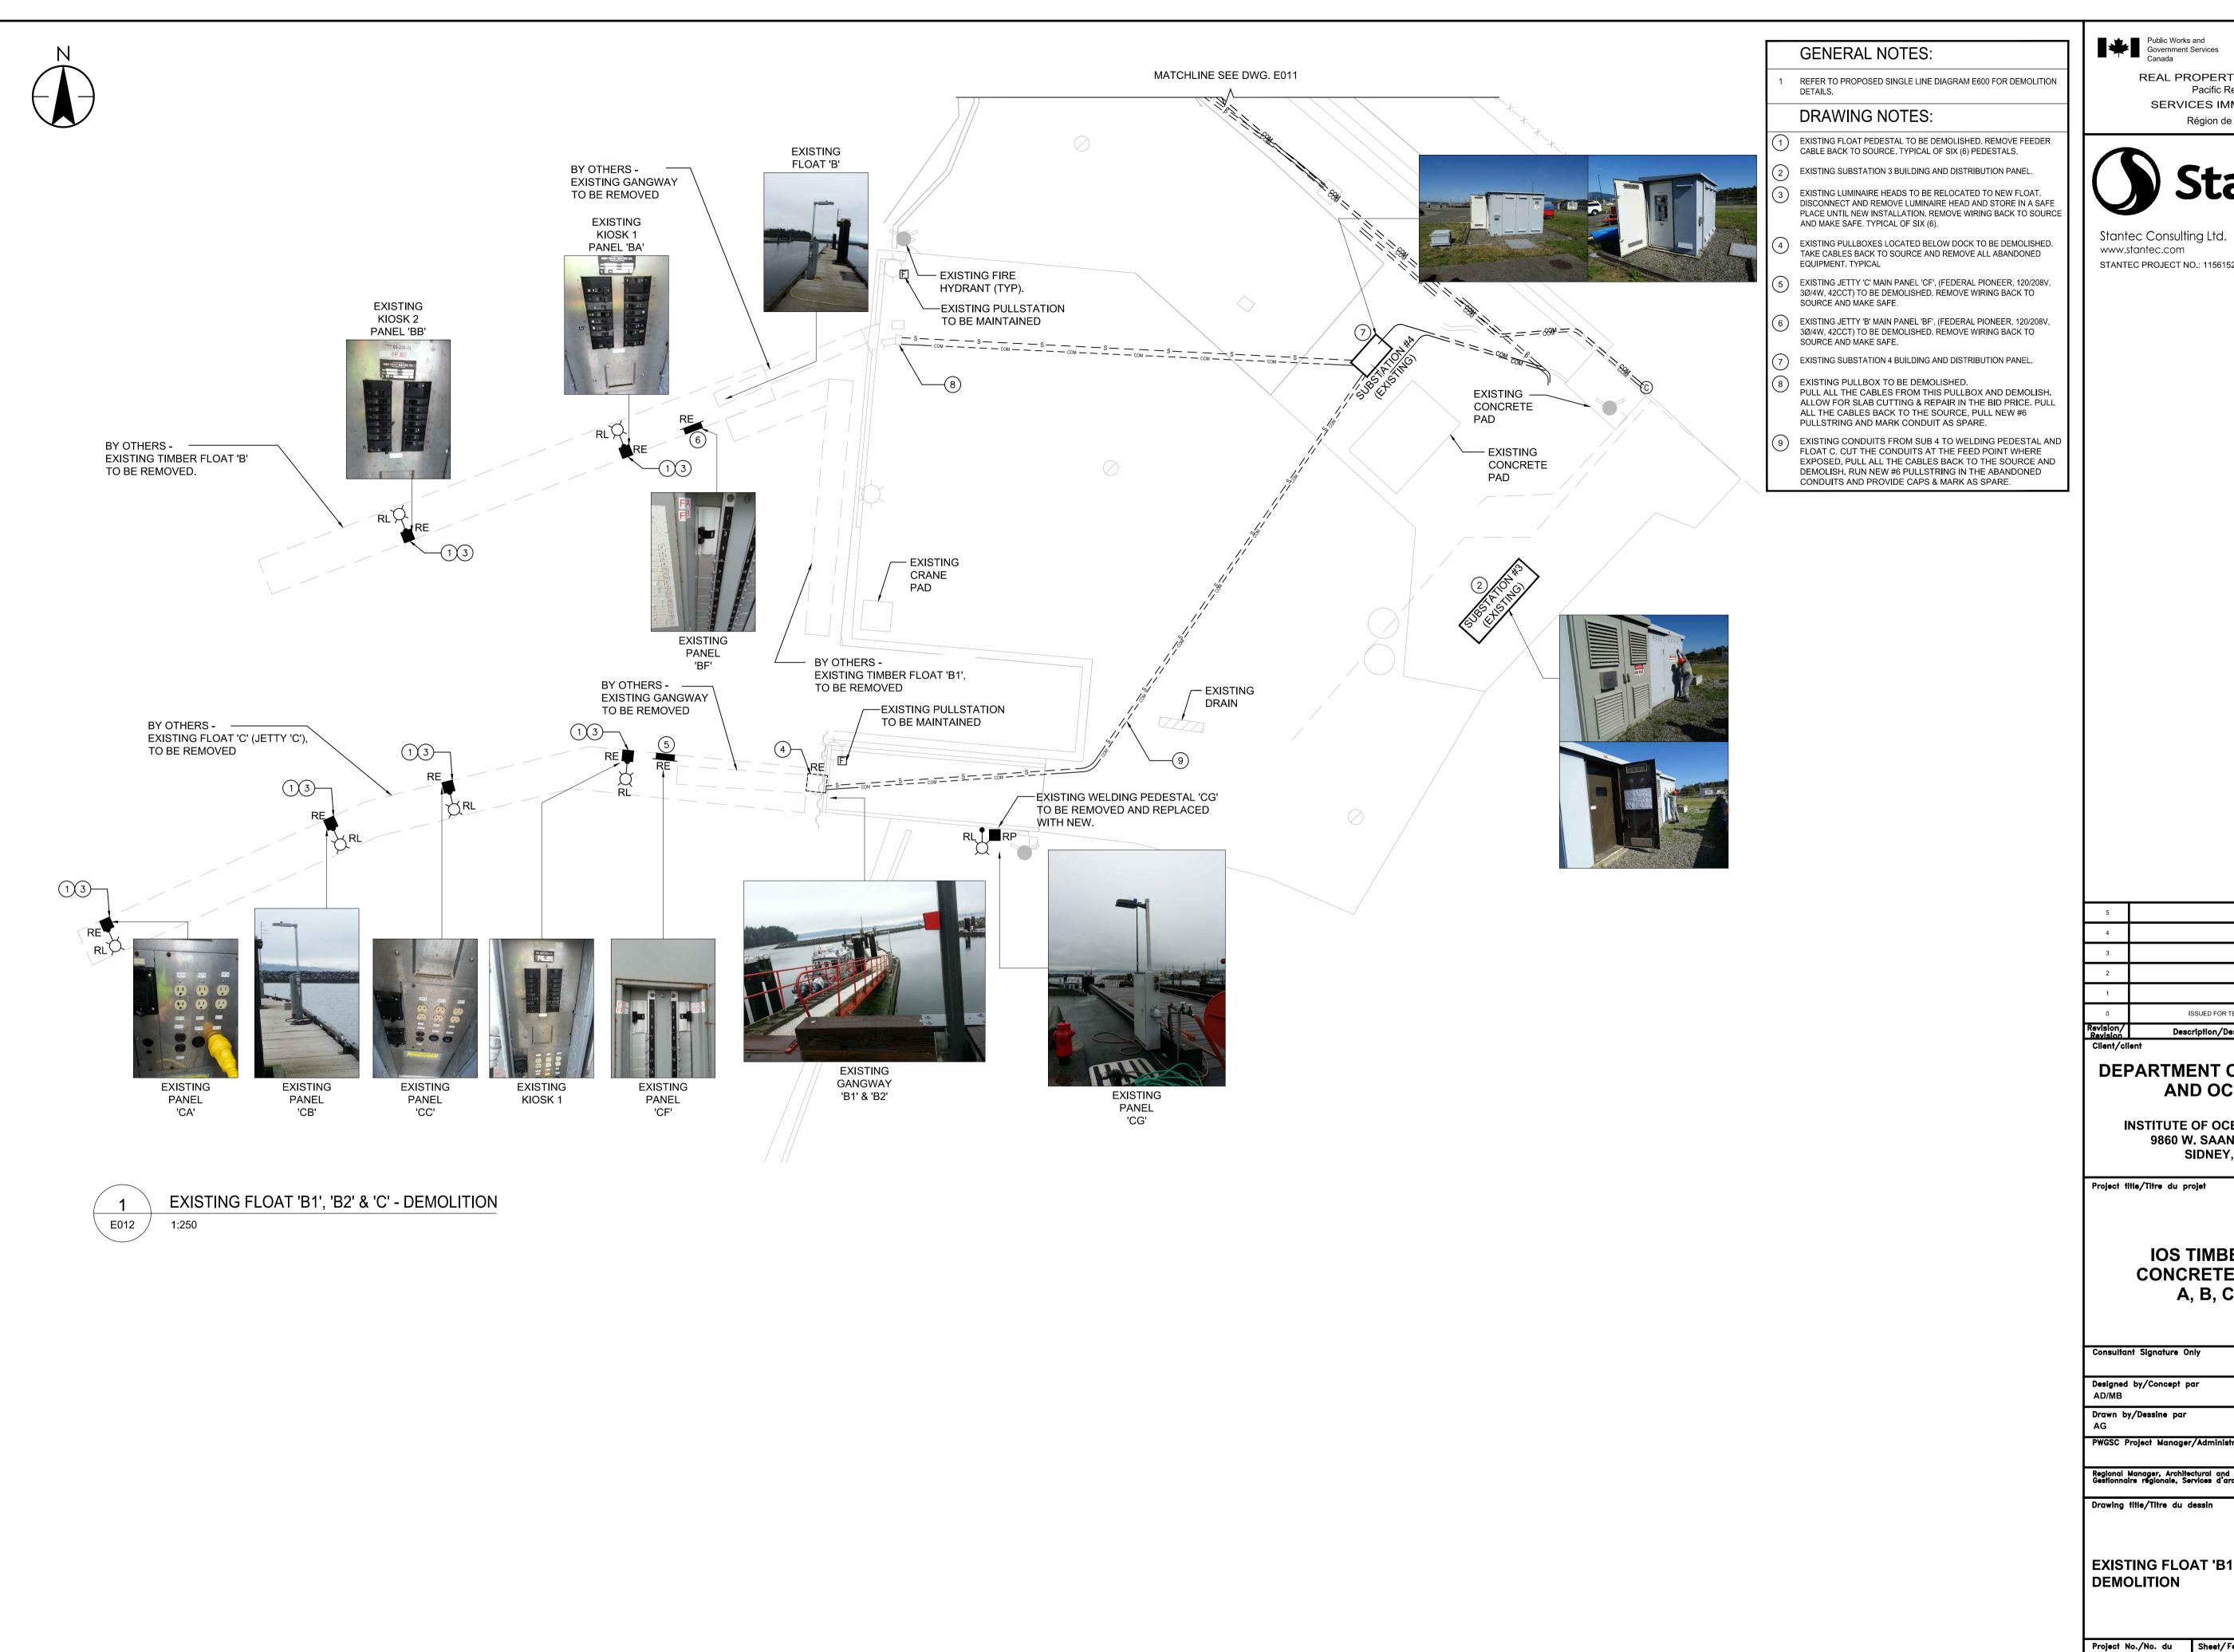
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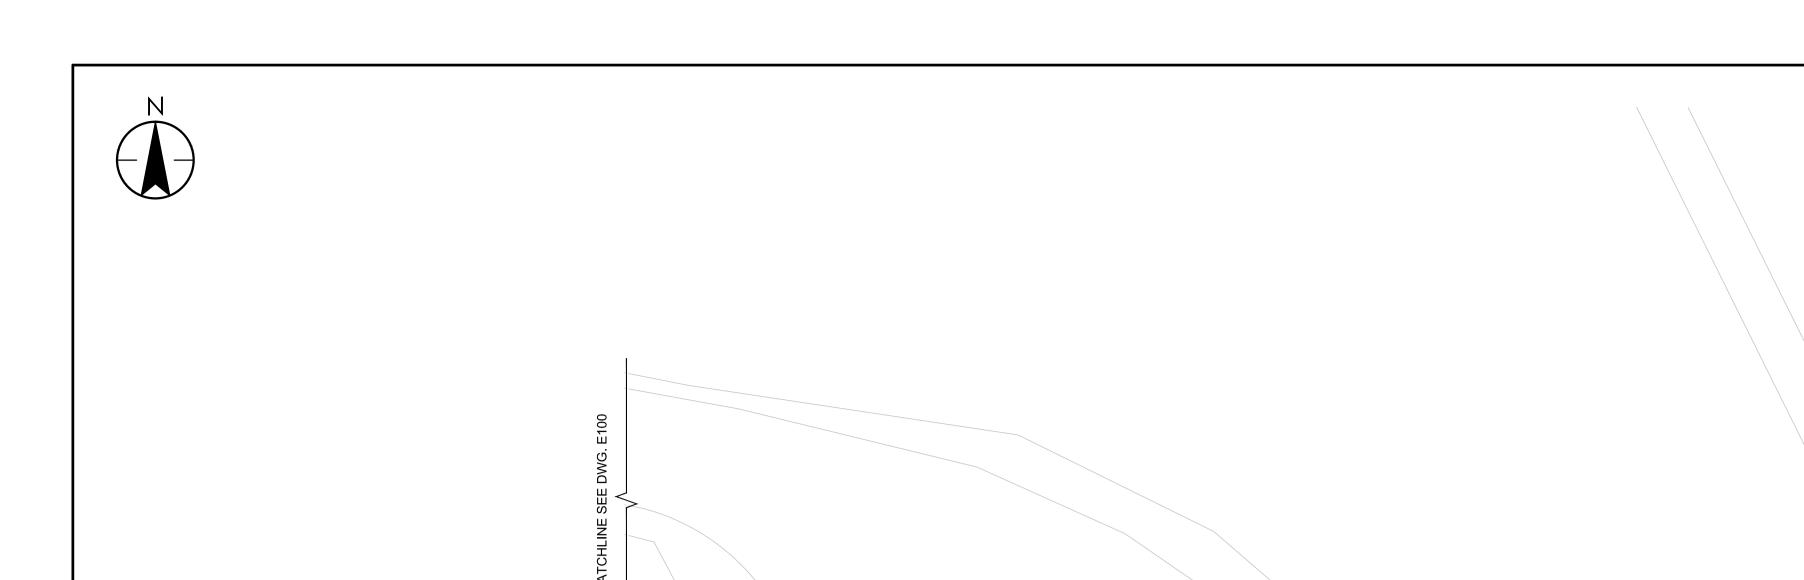
EXISTING FLOAT 'B1', 'B2' & 'C' -DEMOLITION

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E012

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-NEW GANGWAY

'2CDP-FLA'

FLOAT A

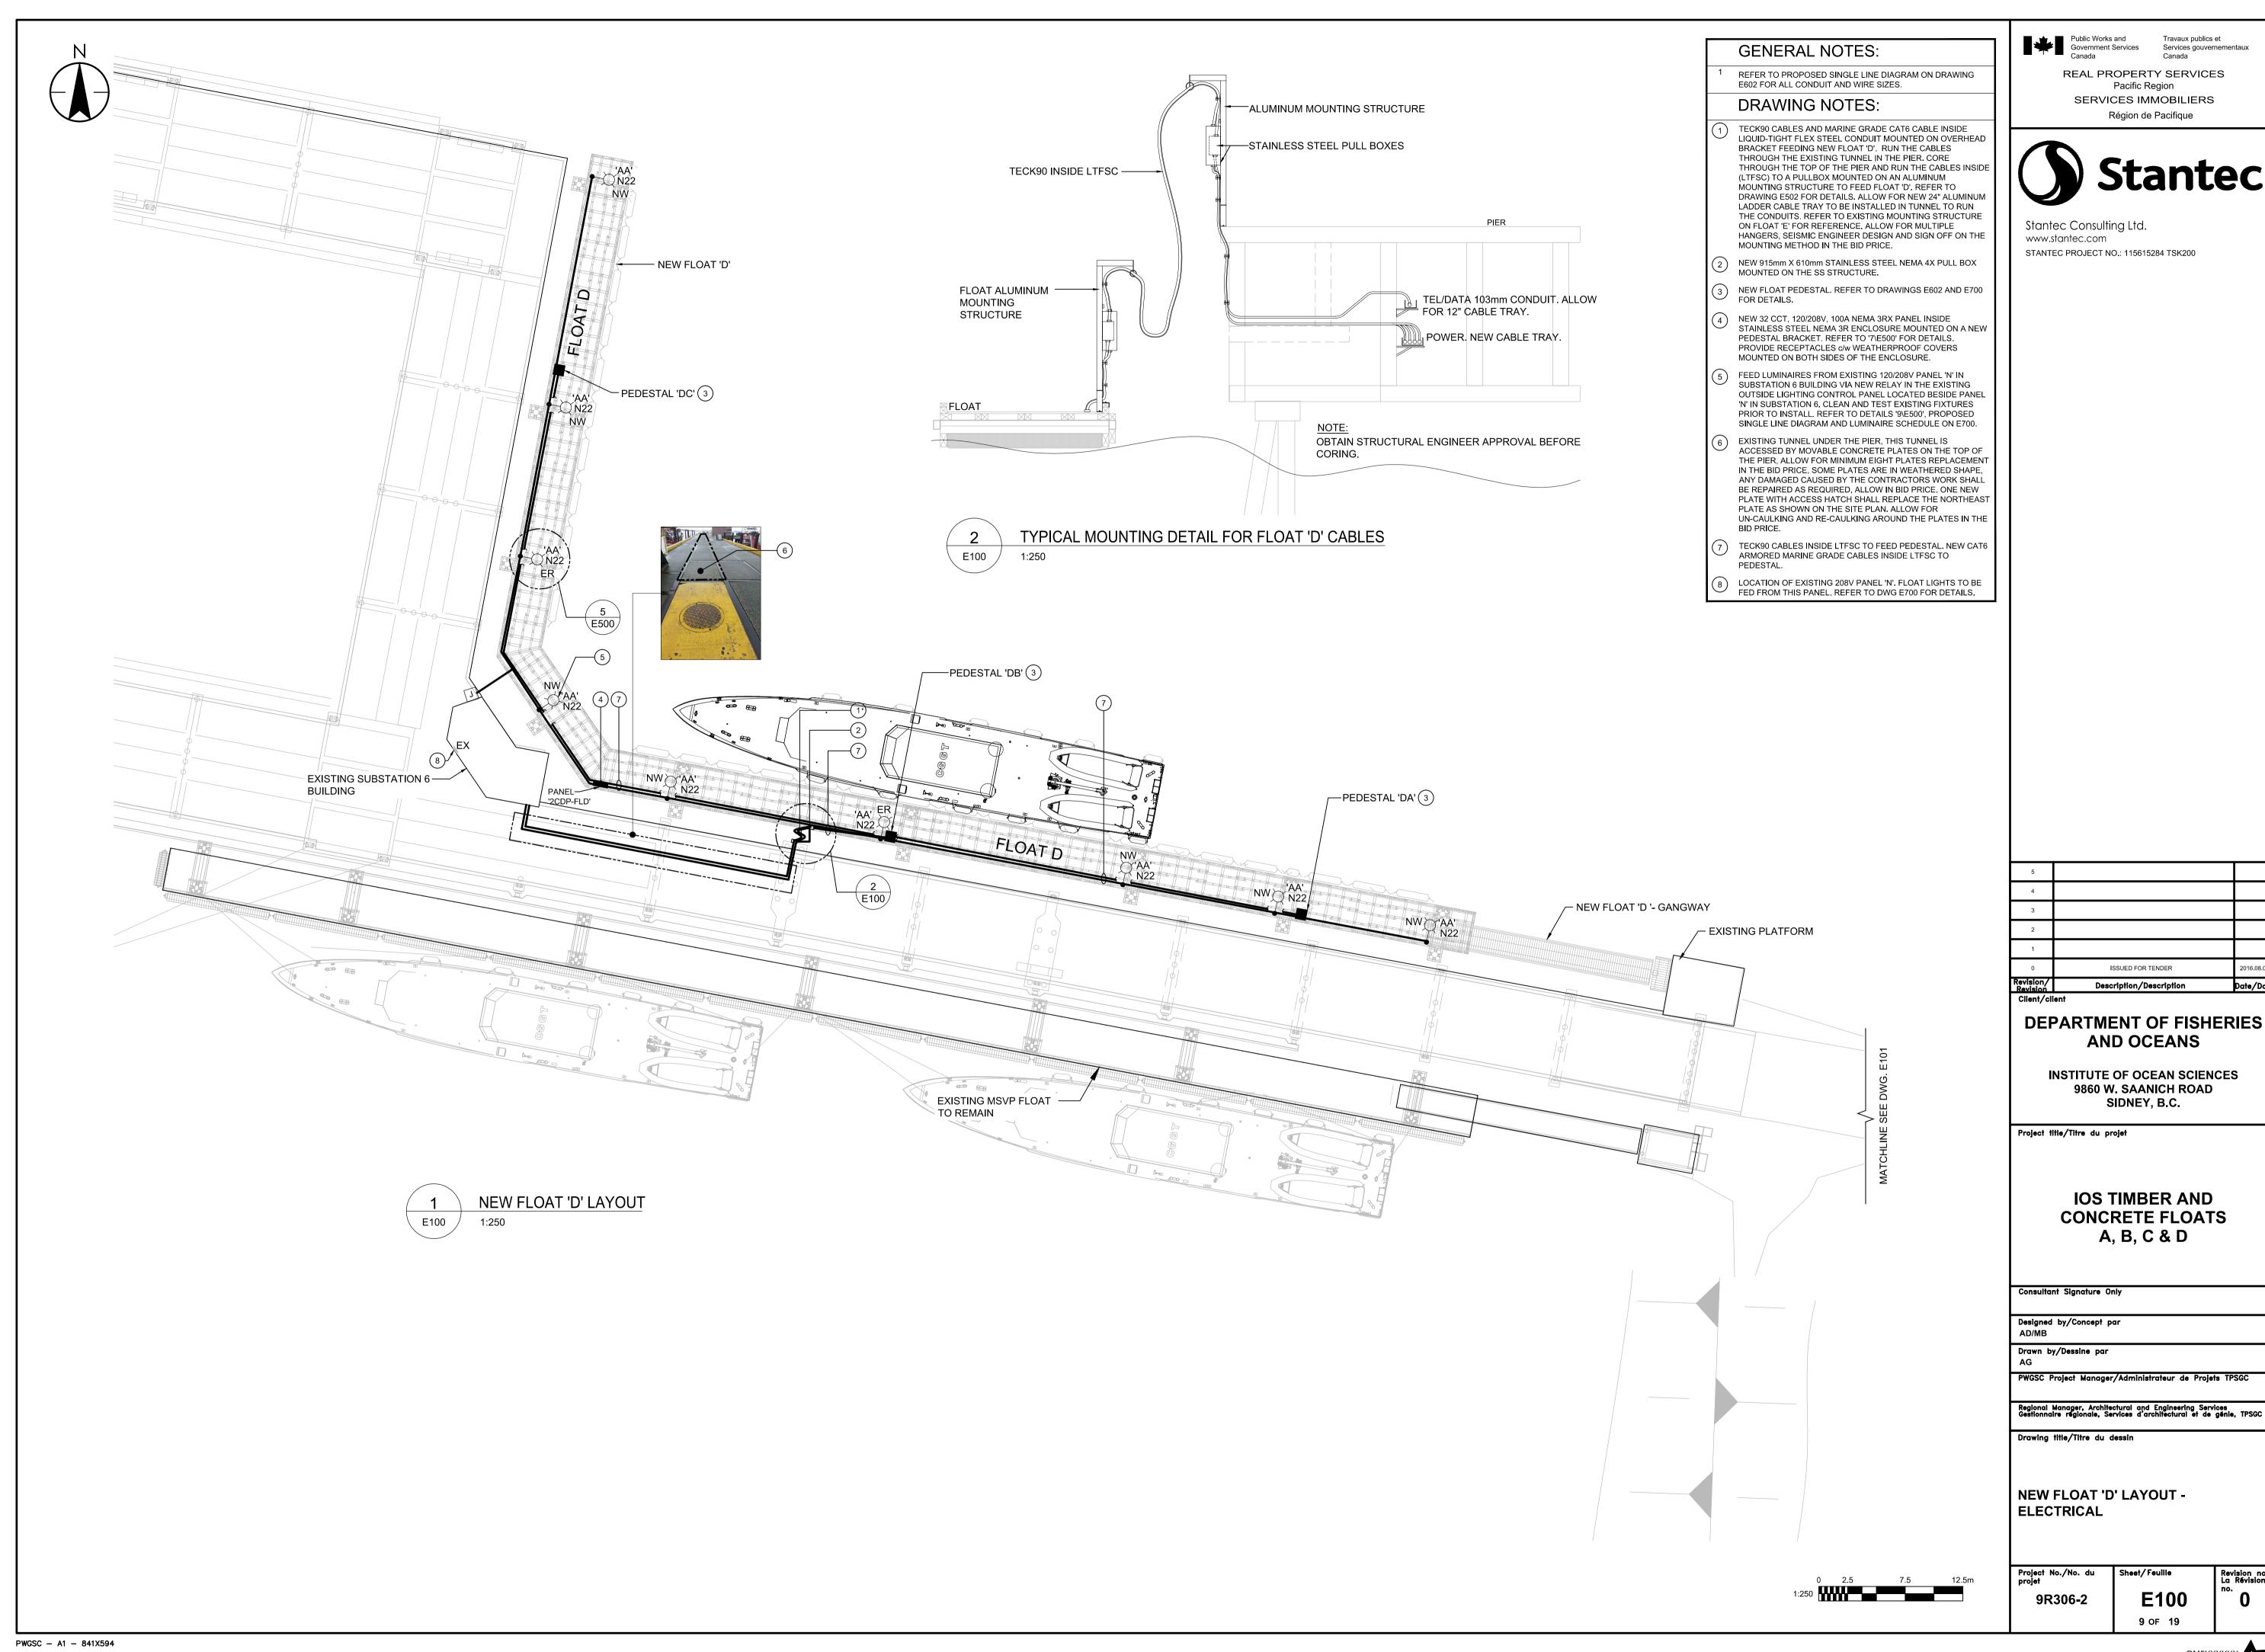- CONDUIT MOUNTED TO INSIDE OF MOORING TOE RAIL (TYP.)

-PEDESTAL

--PEDESTAL

-PEDESTAL

FLOAT A

—PEDESTAL 'AD'

- NEW FLOAT 'A'

PEDESTAL

PEDESTAL -

TO SUBSTATION 6

EX

- EXISTING

(OUTDOOR

KIOSK)

SUBSTATION 5

-EXISTING

NEW FLOAT 'A' LAYOUT

E101

TELECOM. PULLPIT

MATCHLINE SEE DWG. E102

GENERAL NOTES:

REFER TO PROPOSED SINGLE LINE DIAGRAM ON DRAWING E601 FOR ALL CONDUIT AND WIRE SIZES.

DRAWING NOTES:


- PROVIDE A NEW 915mm X 610mm SS NEMA 4X PULLBOX AND INSTALL UNDER THE FLOAT GANGWAY, RUN NEW ALUMINUM CONDUITS C/W WIRING TO NEW ALUMINUM MOUNTING STRUCTURE/BRACKETS. MOUNT NEW 915mm X 610mm SS PULLBOX ON THE MOUNTING STRUCTURE AND TERMINATE THE ALUMINUM CONDUIT TO THIS PULLBOX. FROM THIS PULLBOX, RUN NEW TECK90 CABLE INSIDE THE LTFSC TO THE FLOAT PANEL. STRAP THE LTFSC UNDER THE WALL BOARD USING SS UNI-STRUT AND HEAVY DUTY SS P-STRAPS. ALLOW FOR MAXIMUM OF 1m SPACING BETWEEN THE STRAPS IN THE BID PRICE. CARRY THE COST OF ALL MATERIAL, LABOUR, STRUCTURAL ENGINEERING AND SEISMIC SIGNOFF FOR A COMPLETE AND OPERATIONAL SYSTEM, REFER TO DETAIL '1\E-502' AND DRAWING NOTES FOR DETAILS.
- PEDESTAL FEEDS: INSTALL INDIVIDUAL FEEDS FOR EACH PEDESTAL. RUN NEW TECK90 CABLE INSIDE LTFSC FROM THE FLOAT PANEL TO EACH PEDESTAL. RUN THE LTFSC UNDER THE FLOAT FLOOR PANELS. REFER TO '8\E-500' FOR DETAILS.
- PROVIDE A NEW 915mm X 610mm SS NEMA 4X PULLBOX MOUNTED ON AN ALUMINUM STRUCTURE LOCATED ON THE NEW FLOAT AND FEED FROM THE GANGWAY PULLBOX AND STRUCTURE. TERMINATE THE TECK90 CABLES TO THE FLOAT PANEL AS SHOWN ON DETAIL '1\E-502'.
- NEW 1525mm X 915mm LOCKABLE STAINLESS STEEL NEMA 3R ENCLOSURE c/w 600A, 120/208V, 60 CCT NEMA 3RX MARINE GRADE PRE-MANUFACTURED DISTRIBUTION PANEL INSTALLED INSIDE THE SS ENCLOSURE c/w BRACKETS TO MOUNT ON THE FLOAT TO FEED THE PEDESTALS.
- 5 PROVIDE ONE (1) NEW 103mm RPVC FROM THE EXISTING TELECOM PULLBOX TO A NEW PULLBOX.
- (6) PROVIDE A NEW TELECOM PULLPIT, REFER TO NOTE 7.
- (7) NEW 2 X [915mm X 610mm] PULLPIT C/W HEAVY DUTY SPRING LOAD COVER. ONE (1) FOR POWER AND ONE (1) FOR DATA.
- (8) NEW 4 X 103mm RPVC U/G CONDUITS & CABLES ENCASED IN A CONCRETE DUCT BANK AS SHOWN ON '4\E-501'.
- PROVIDE NEW 3 X 103mm RPVC CONDUITS TO FEED PULLBOX UNDER THE GANGWAY. TERMINATE THE RPVC TO THE ALUMINUM CONDUITS WHERE THE CONDUITS ARE EXPOSED USING RAINTIGHT COUPLINGS. (RPVC UNDERGROUND, ALUMINUM UNDER THE GANGWAY TO THE MOUNTING STRUCTURE). REFER TO '1\E-502' FOR DETAILS.
- PROVIDE A NEW 615mm X 407mm SS NEMA 4X PULLBOX INSTALLED UNDER THE FLOAT GANGWAY. RUN NEW ARMORED MARINE GRADE CAT6 CABLES FROM THE EXISTING COM. BOX TO THE FLOATS, CONTINUOUS RUNS WITHOUT SPLICES. USE RPVC FOR ALL U/G RUNS, ALUMINUM CONDUIT UNDER THE GANGWAY AND LTFSC UNDER THE BOARWALK AND ON THE FLOAT. REFER TO '1\E-502' FOR DETAILS.
- PEDESTAL'S TELECOM/DATA FEEDS FROM TELECOM BOX: INSTALL 1 X 103mm LTFSC TO USE AS A SLEEVE FOR THE CAT6 WIRING. DAISY CHAIN THE CONDUIT BY INSTALLING A WEATHERPROOF JB BEHIND EACH PEDESTAL TO FEED THAT SPECIFIC PEDESTAL, ALLOW FOR 1 X 103mm LTFSC ON EACH FINGER OF THE FLOAT BACK TO THE MAIN PULLBOX. REFER TO '8\E500' FOR DETAILS.
- PROVIDE A NEW 1 X 103mm RPVC TO SUBSTATION 6.
- FEED NEW AND RELOCATED LUMINAIRES FROM EXISTING 120/208V PANEL 'N' IN SUBSTATION 6 BUILDING VIA NEW RELAY IN THE EXISTING OUTSIDE LIGHTING CONTROL PANEL LOCATED BESIDE PANEL 'N' IN SUBSTATION 6. CLEAN AND TEST EXISTING FIXTURES PRIOR TO INSTALL, TYPICAL FOR SIX (6) LUMINAIRES. PROVIDE ONE (1) NEW LUMINAIRE AND MOUNT ON TOP OF POLE ON NEW PEDESTAL. REFER TO E700 LUMINAIRE SCHEDULE, DETAIL '5\E500' AND PROPOSED SINGLE LINE DIAGRAM.

Public Works and Government Services Services gouvernementaux Canada

REAL PROPERTY SERVICES Pacific Region SERVICES IMMOBILIERS Région de Pacifique



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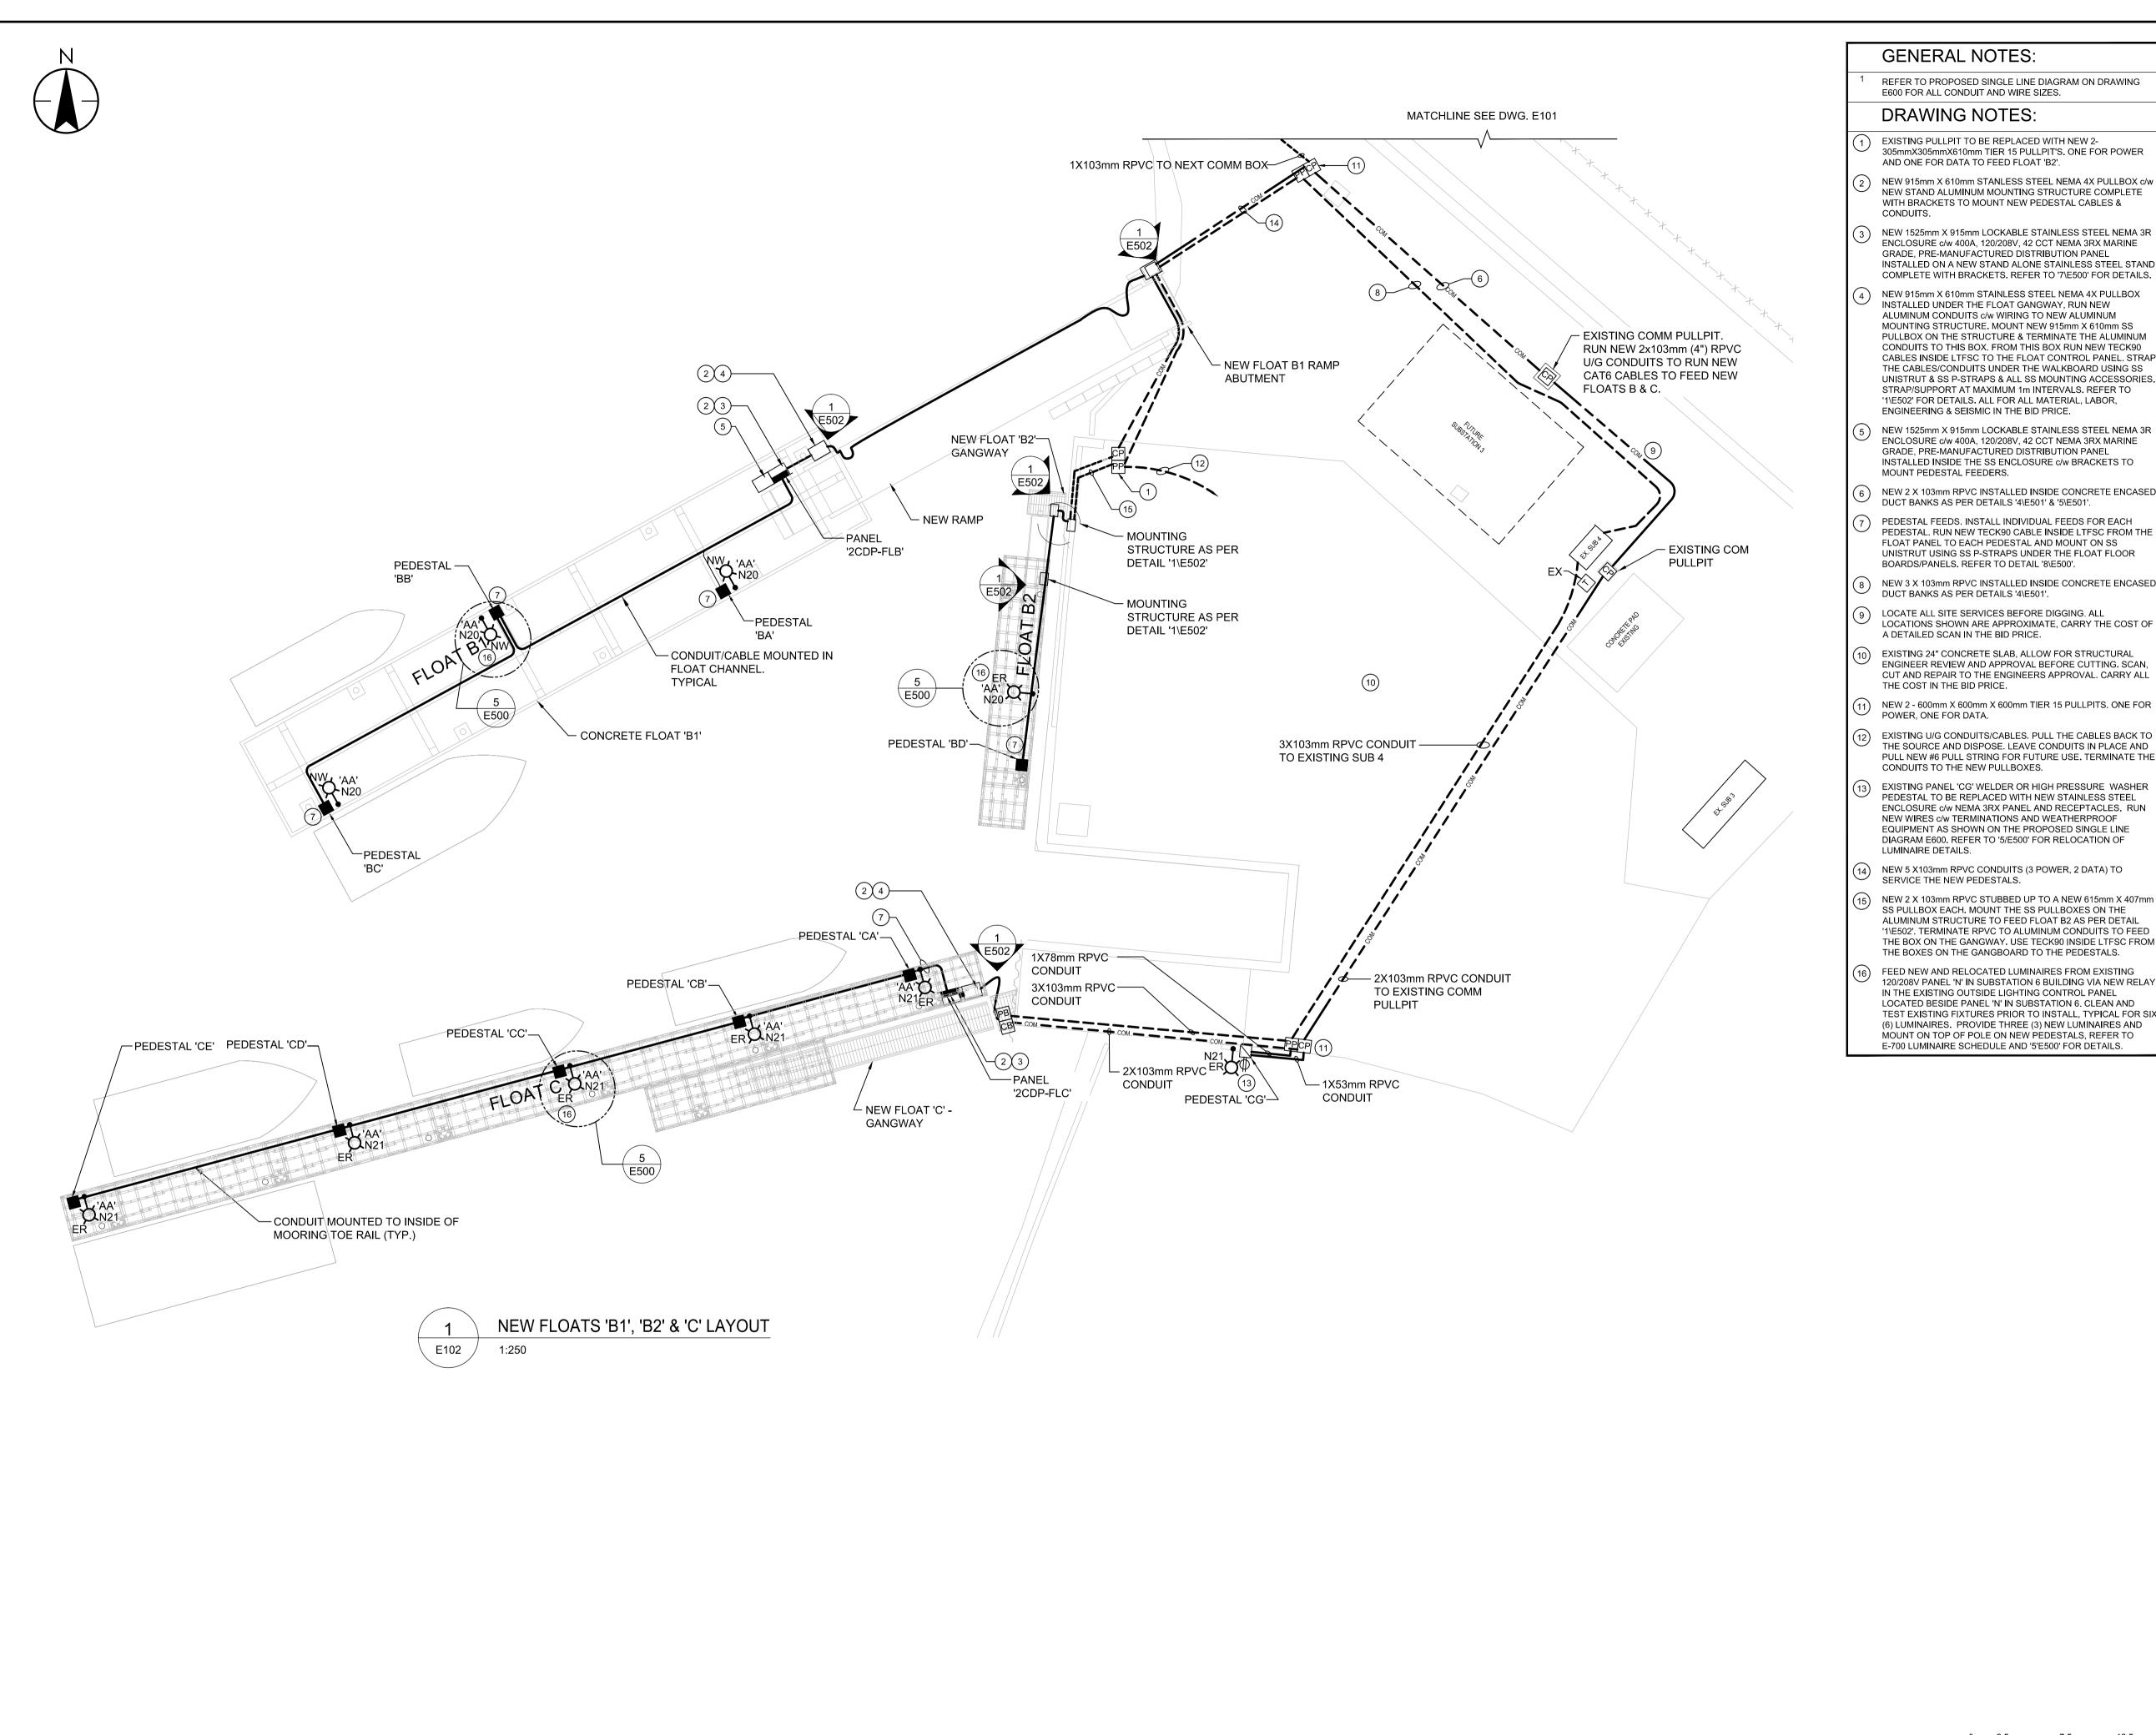
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NEW FLOAT 'A' LAYOUT -**ELECTRICAL**

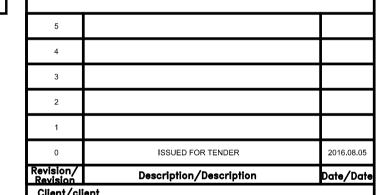Project No./No. du projet 9R306-2

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REFER TO PROPOSED SINGLE LINE DIAGRAM ON DRAWING

- 305mmX305mmX610mm TIER 15 PULLPIT'S, ONE FOR POWER
 - NEW 915mm X 610mm STANLESS STEEL NEMA 4X PULLBOX c/w NEW STAND ALUMINUM MOUNTING STRUCTURE COMPLETE
- NEW 1525mm X 915mm LOCKABLE STAINLESS STEEL NEMA 3R ENCLOSURE c/w 400A, 120/208V, 42 CCT NEMA 3RX MARINE GRADE, PRE-MANUFACTURED DISTRIBUTION PANEL INSTALLED ON A NEW STAND ALONE STAINLESS STEEL STAND COMPLETE WITH BRACKETS. REFER TO '7\E500' FOR DETAILS.
- NEW 915mm X 610mm STAINLESS STEEL NEMA 4X PULLBOX INSTALLED UNDER THE FLOAT GANGWAY, RUN NEW ALUMINUM CONDUITS c/w WIRING TO NEW ALUMINUM MOUNTING STRUCTURE. MOUNT NEW 915mm X 610mm SS PULLBOX ON THE STRUCTURE & TERMINATE THE ALUMINUM CONDUITS TO THIS BOX. FROM THIS BOX RUN NEW TECK90 CABLES INSIDE LTFSC TO THE FLOAT CONTROL PANEL. STRAP THE CABLES/CONDUITS UNDER THE WALKBOARD USING SS UNISTRUT & SS P-STRAPS & ALL SS MOUNTING ACCESSORIES. STRAP/SUPPORT AT MAXIMUM 1m INTERVALS. REFER TO '1\E502' FOR DETAILS. ALL FOR ALL MATERIAL, LABOR,
- NEW 1525mm X 915mm LOCKABLE STAINLESS STEEL NEMA 3R ENCLOSURE c/w 400A, 120/208V, 42 CCT NEMA 3RX MARINE GRADE, PRE-MANUFACTURED DISTRIBUTION PANEL INSTALLED INSIDE THE SS ENCLOSURE c/w BRACKETS TO
- NEW 2 X 103mm RPVC INSTALLED INSIDE CONCRETE ENCASED
- PEDESTAL. RUN NEW TECK90 CABLE INSIDE LTFSC FROM THE FLOAT PANEL TO EACH PEDESTAL AND MOUNT ON SS UNISTRUT USING SS P-STRAPS UNDER THE FLOAT FLOOR
- NEW 3 X 103mm RPVC INSTALLED INSIDE CONCRETE ENCASED
- LOCATIONS SHOWN ARE APPROXIMATE, CARRY THE COST OF
- EXISTING 24" CONCRETE SLAB, ALLOW FOR STRUCTURAL ENGINEER REVIEW AND APPROVAL BEFORE CUTTING. SCAN, CUT AND REPAIR TO THE ENGINEERS APPROVAL. CARRY ALL
- THE SOURCE AND DISPOSE. LEAVE CONDUITS IN PLACE AND PULL NEW #6 PULL STRING FOR FUTURE USE. TERMINATE THE
- PEDESTAL TO BE REPLACED WITH NEW STAINLESS STEEL ENCLOSURE c/w NEMA 3RX PANEL AND RECEPTACLES. RUN NEW WIRES c/w TERMINATIONS AND WEATHERPROOF EQUIPMENT AS SHOWN ON THE PROPOSED SINGLE LINE DIAGRAM E600. REFER TO '5/E500' FOR RELOCATION OF
- NEW 2 X 103mm RPVC STUBBED UP TO A NEW 615mm X 407mm SS PULLBOX EACH. MOUNT THE SS PULLBOXES ON THE ALUMINUM STRUCTURE TO FEED FLOAT B2 AS PER DETAIL '1\E502'. TERMINATE RPVC TO ALUMINUM CONDUITS TO FEED THE BOX ON THE GANGWAY. USE TECK90 INSIDE LTFSC FROM THE BOXES ON THE GANGBOARD TO THE PEDESTALS.
- 120/208V PANEL 'N' IN SUBSTATION 6 BUILDING VIA NEW RELAY IN THE EXISTING OUTSIDE LIGHTING CONTROL PANEL LOCATED BESIDE PANEL 'N' IN SUBSTATION 6. CLEAN AND TEST EXISTING FIXTURES PRIOR TO INSTALL, TYPICAL FOR SIX (6) LUMINAIRES. PROVIDE THREE (3) NEW LUMINAIRES AND MOUNT ON TOP OF POLE ON NEW PEDESTALS, REFER TO E-700 LUMINAIRE SCHEDULE AND '5'E500' FOR DETAILS.

Public Works and Government Services Canada

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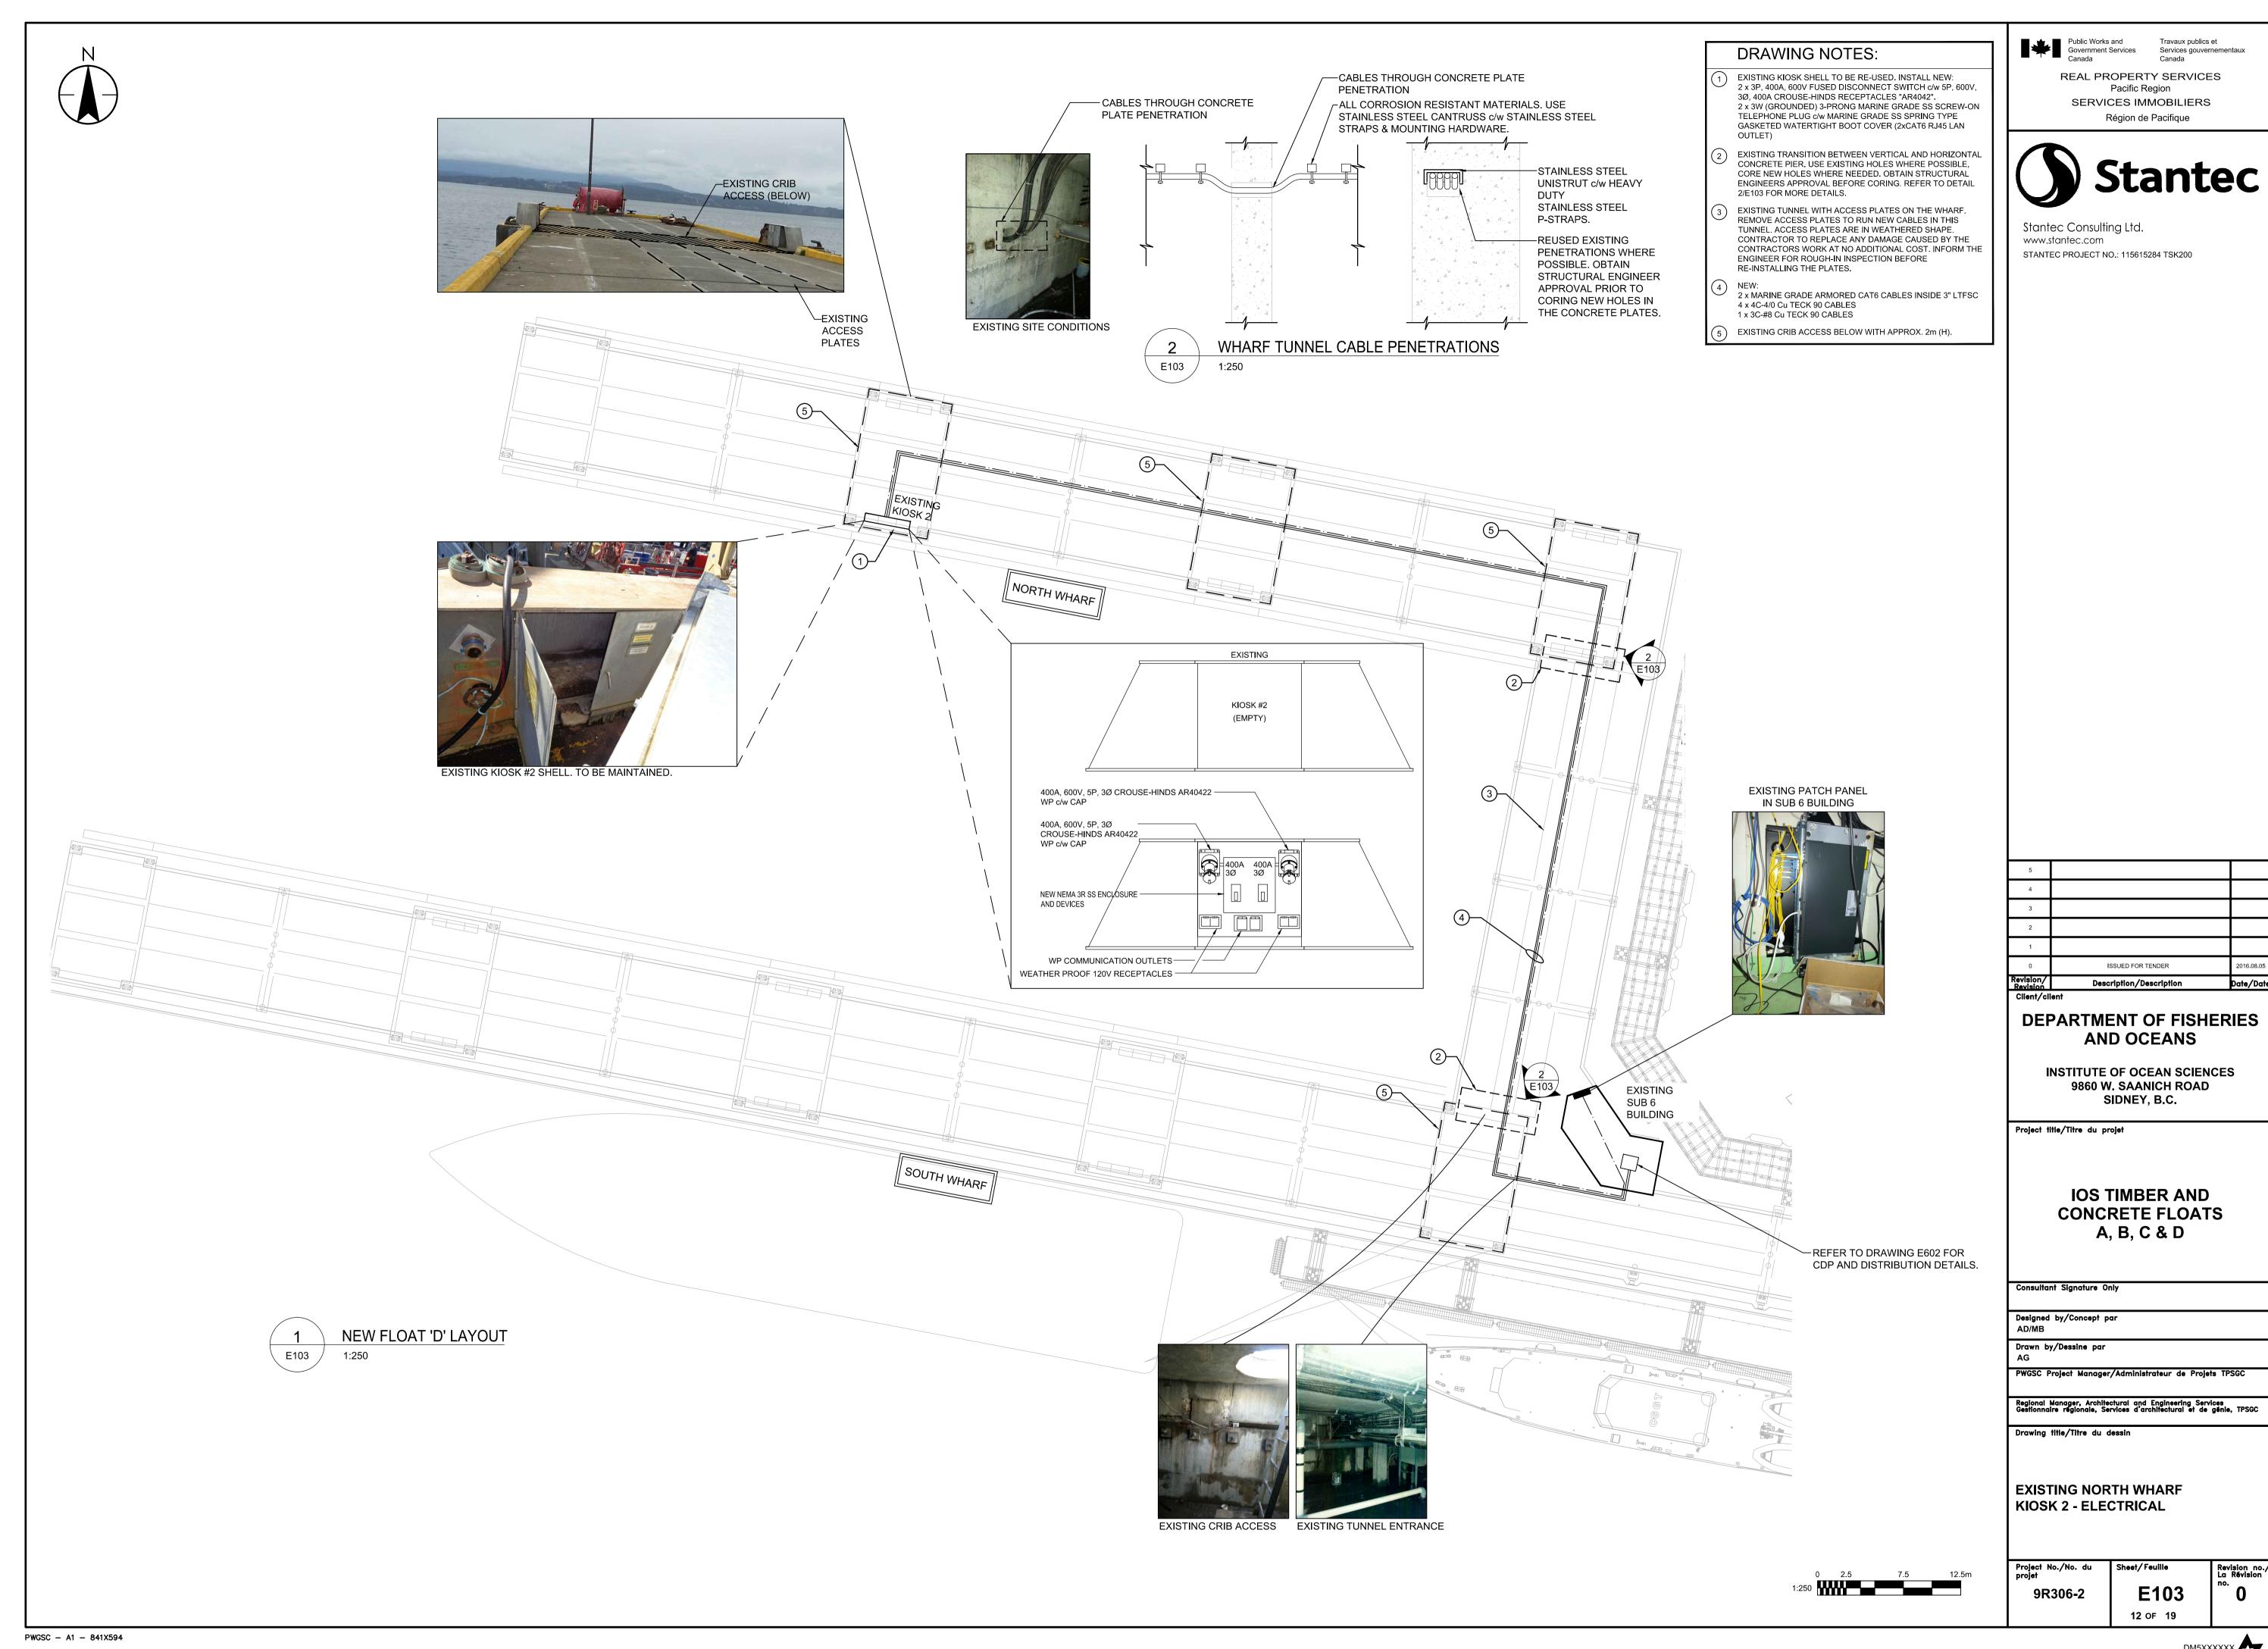
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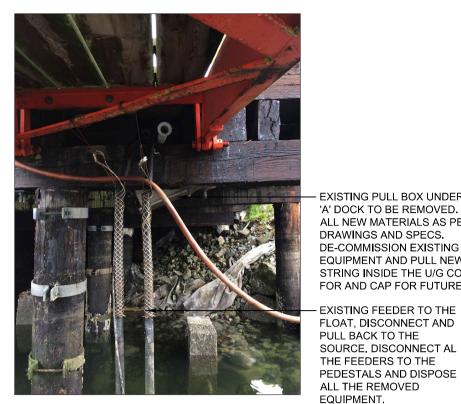
NEW FLOAT 'B1', 'B2 & 'C' LAYOUT - ELECTRICAL

Project No./No. du projet 9R306-2

E102

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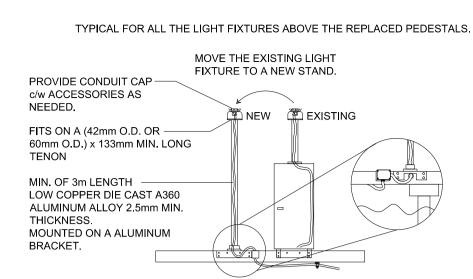
EXISTING PULL BOX UNDER FLOAT 'A' DOCK TO BE REMOVED. INSTALL ALL NEW MATERIALS AS PER DRAWINGS AND SPECS. DE-COMMISSION EXISTING EQUIPMENT AND PULL NEW PULL STRING INSIDE THE U/G CONDUITS OR AND CAP FOR FUTURE USE. EXISTING FEEDER TO THE FLOAT, DISCONNECT AND





- PHOTO's SHOWING TYPICAL ALUMINUM STAND/HANGER, CANTRUSS, P-STRAP, HOOKS, TECK90 CABLE AND PVC SLEEVE FOR A PULL BOX ON FLOAT 'E'.

NEW FLOAT 'D' FEED SHALL BE PULLED THROUGH THE EXISTING HATCH UNDER KIOSK 13. ALLOW FOR MULTIPLE HANGERS/STRUCTURES TO CARRY THE CABLE STRUCTURE PER PEDESTAL. SUBMIT MOUNTING STRUCTURE DESIGN FOR APPROVAL. ALL WORK PERFORMED BY DIV 26 SHALL BE REVIEWED AND APPROVED BY THE CONTRACTORS SEISMIC ENGINEER PRIOR TO SUBSTANTIAL COMPLETION.



- 1. RUN NEW #8 TECK90 CABLE TO FEED THE LIGHTS ON THE NEW FLOATS. DAISY CHAIN FEED IS ACCEPTABLE ON THE FLOAT.
- 2. MAINTAIN PROTECTION FOR THE LUMINAIRE UNTIL ALL NEW FLOATS ARE INSTALLED. RE-INSTALL ON NEW APPARATUS AS



— TYPICAL NEW LED LIGHTING INSTALLED ON TOP OF THE EXISTING PEDESTAL TO BE RE-USED, INSTALL NEW MOUNTING BRACKETS AND RE-MOUNT AS SHOWN ON '5\E-501'. RUN NEW TECK90 CABLE DAISY CHAINED TO FEED NEW LIGHTS.



Public Works and Government Services

Travaux publics et Services gouvernementaux

REAL PROPERTY SERVICES Pacific Region

EXISTING PULLBOX AND FEEDER SCALE: N.T.S.



EXISTING PEDESTAL AND NEW PULLBOX LOCATION SCALE: N.T.S.



HANGER AND CABLE DETAILS SCALE: N.T.S.



FLOAT PEDESTAL LIGHTING DETAILS SCALE: N.T.S.




LED LIGHTING MOUNTING DETAIL SCALE: N.T.S.



EXISTING PULLPIT FEEDING FLOAT 'B' TO BE REPLACED ----WITH TWO (2) NEW 305mm X 305mm X 615mm HEAVY DUTY PULLPITS TO FEED NEW FLOAT 'B2'. INSTALL ALL




NEW. ALLOW FOR SURFACE CUT AND REPAIR TO INSTALL THE NEW CONDUITS AND PULLPIT.

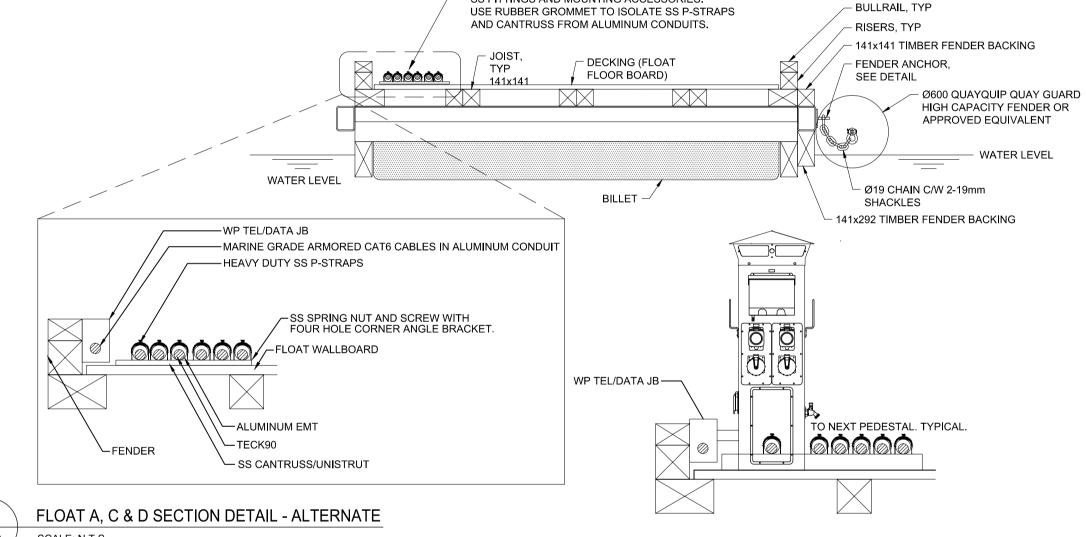

SS CANTRUSS & 4" MAX ALUMINUM CONDUITS. USE SS FITTINGS AND MOUNTING ACCESSORIES.

E500 SCALE: N.T.S.

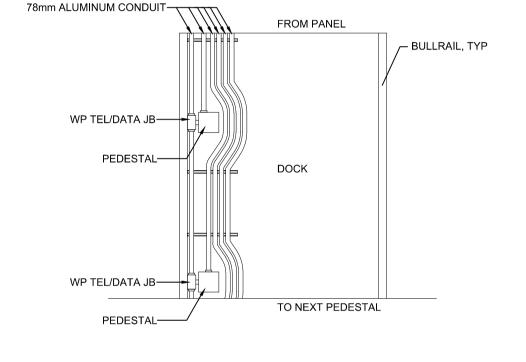

- 78mm LTFC PEDESTAL

 $\stackrel{ extstyle o}{ o}$ TO NEXT PEDESTAL. TYPICAL.

Description/Description **DEPARTMENT OF FISHERIES AND OCEANS**

> **INSTITUTE OF OCEAN SCIENCES** 9860 W. SAANICH ROAD SIDNEY, B.C.

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IOS TIMBER AND CONCRETE FLOATS A, B, C & D

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Regional Manager, Architectural and Engineering Services Gestionnaire régionale, Services d'architectural et de génie, TPSGC

Drawing title/Titre du dessin

| ELECTRICAL DETAILS (1 OF 2)

9R306-2

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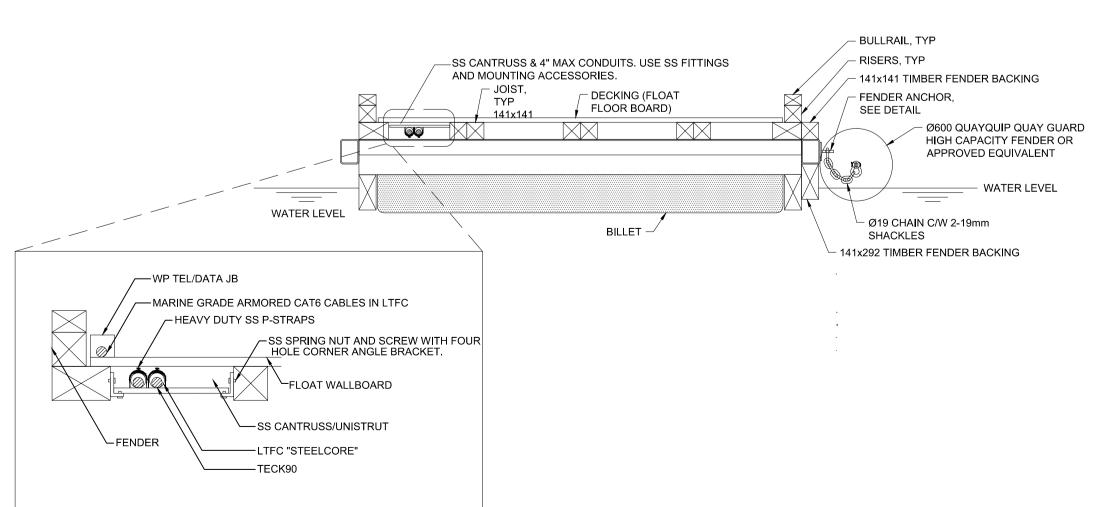
FLOAT 'B' PULLPIT DETAILS SCALE: N.T.S.



SERVICE. REFER TO SPECIFICATIONS.





NEW PREMANUFACTURED FLOAT DISTRIBUTION PANEL,
MOUNTED INSIDE STAND-ALONE NEMA 3R c/w
STAINLESS STEEL NEMA 3R ENCLOSURE AND MAIN BREAKER, CIRCUITS AS SHOWN ON SLD. REFER TO SPECIFICATIONS. TYPICAL: 2CDP-FLA 2CDP-FLB









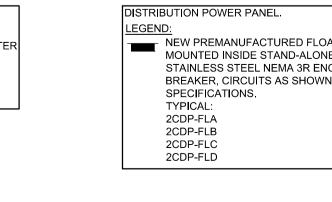

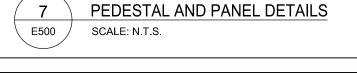

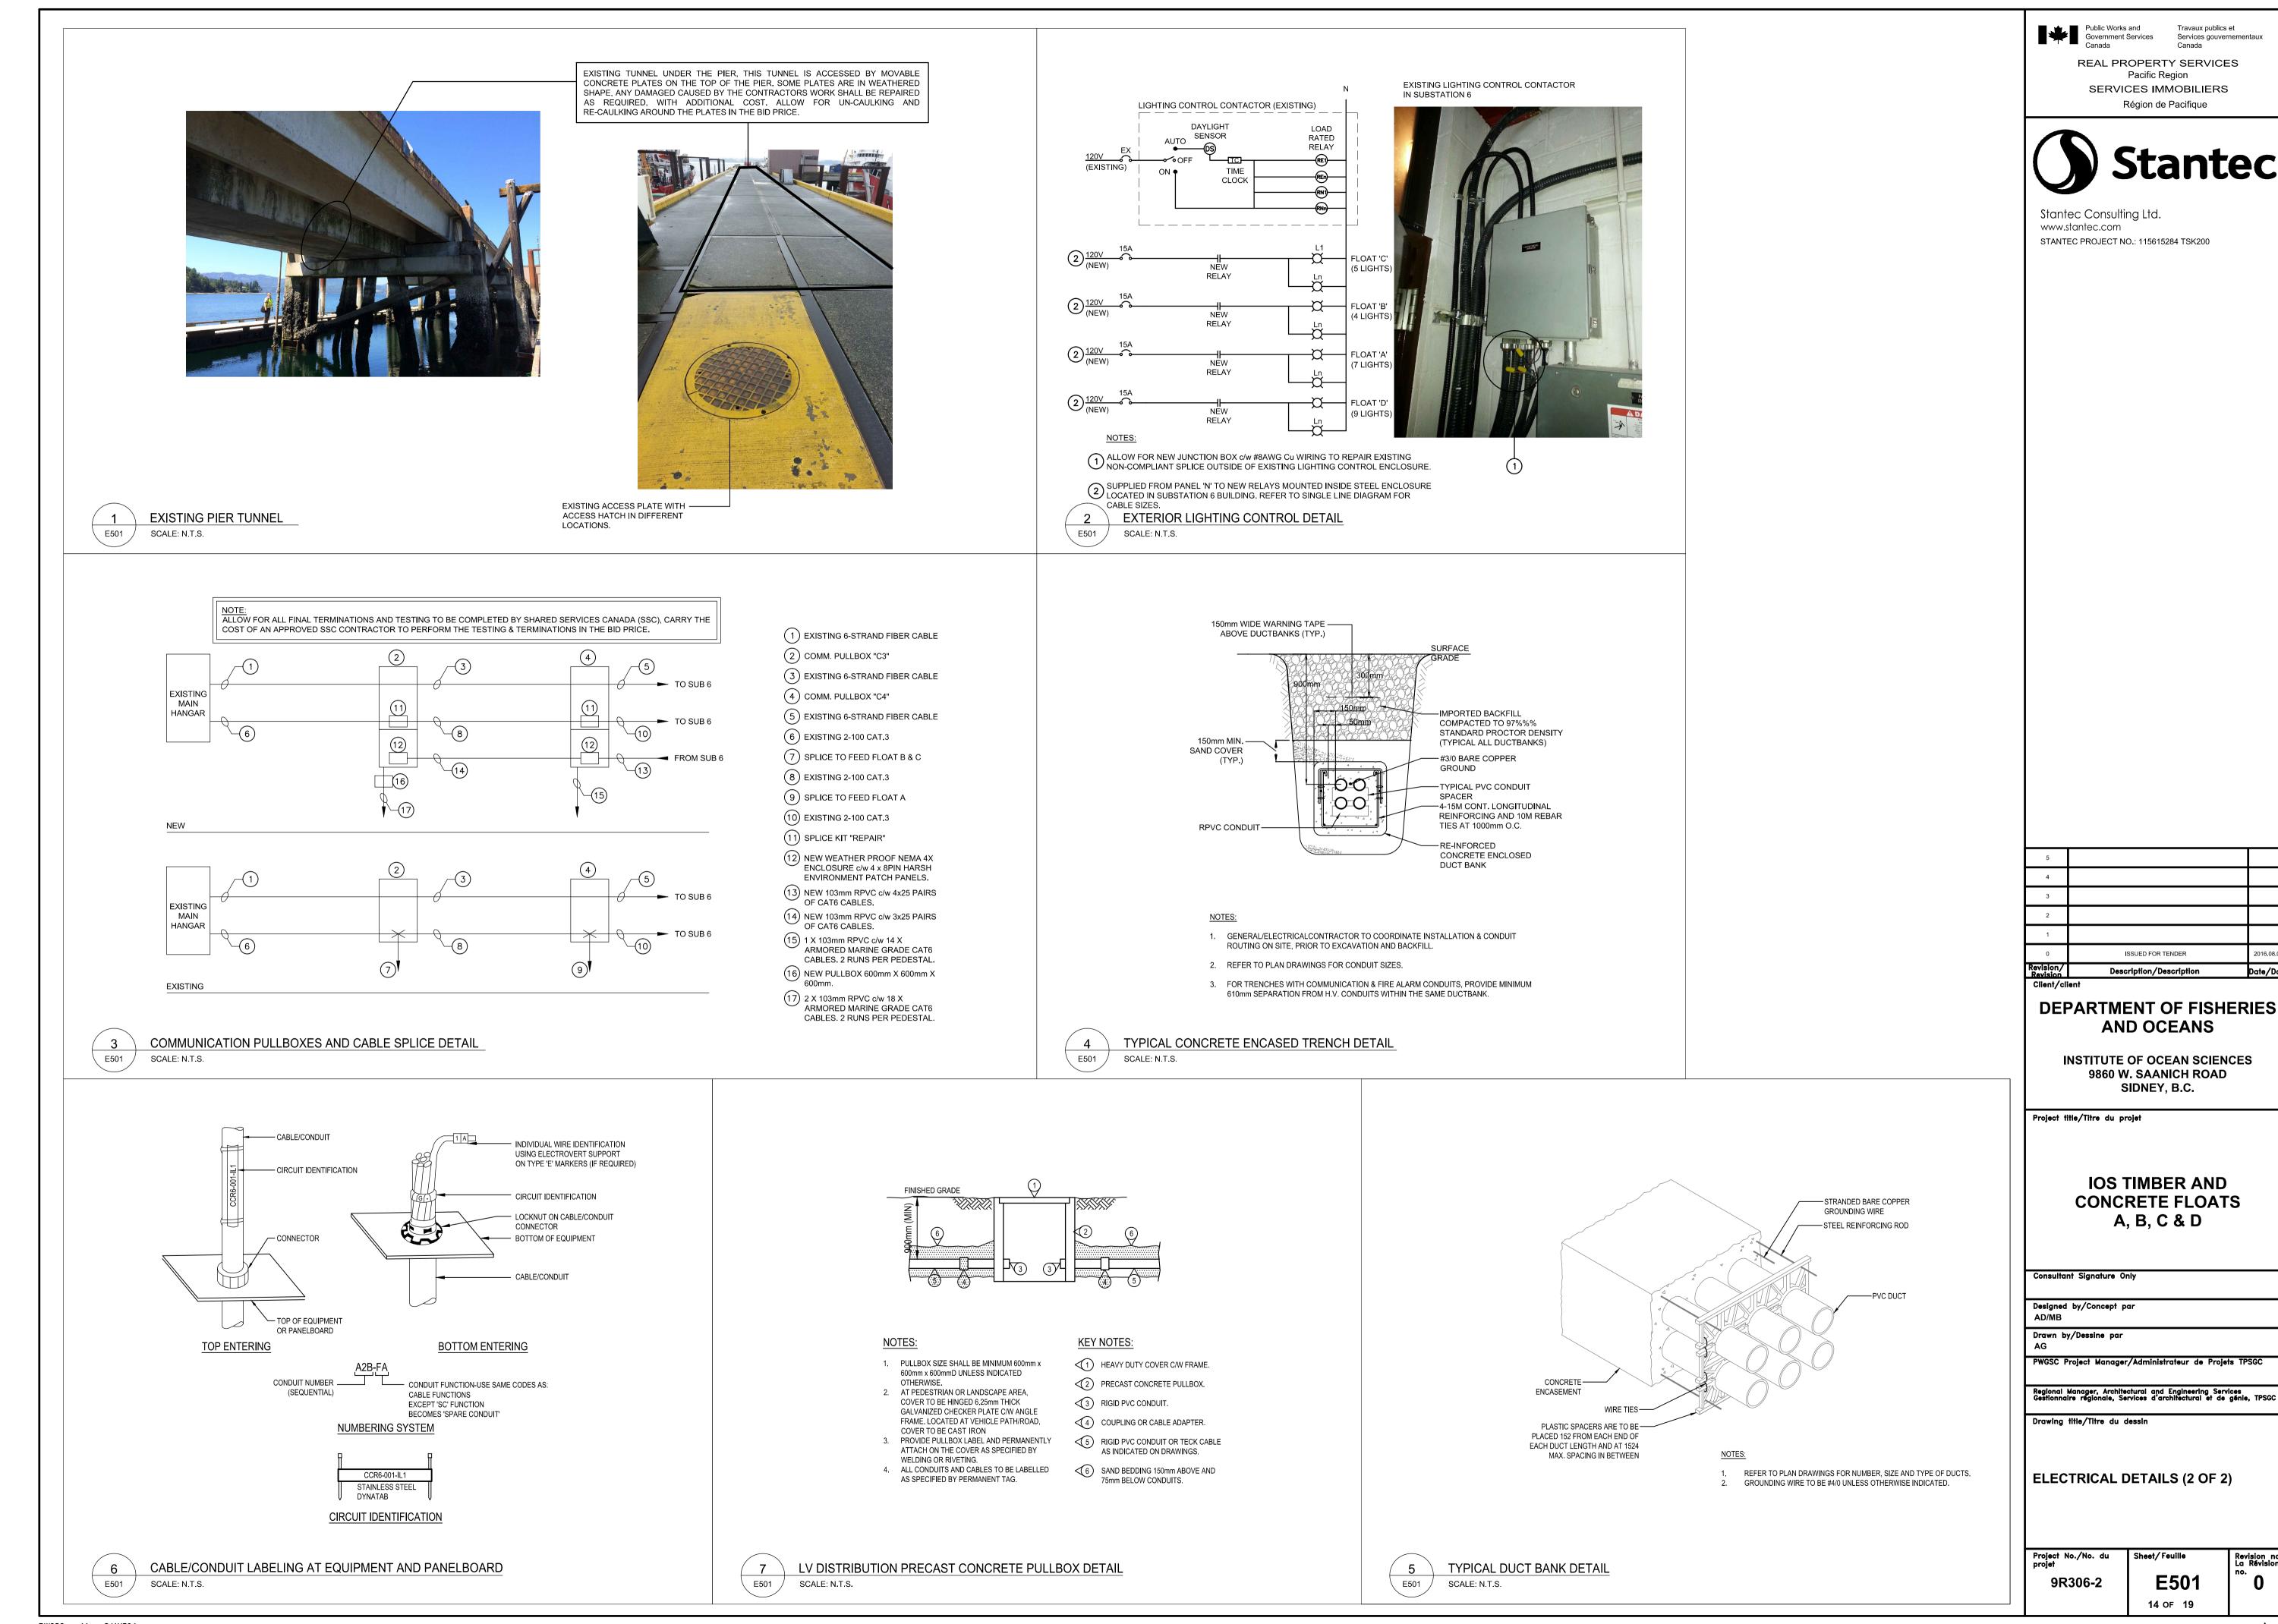

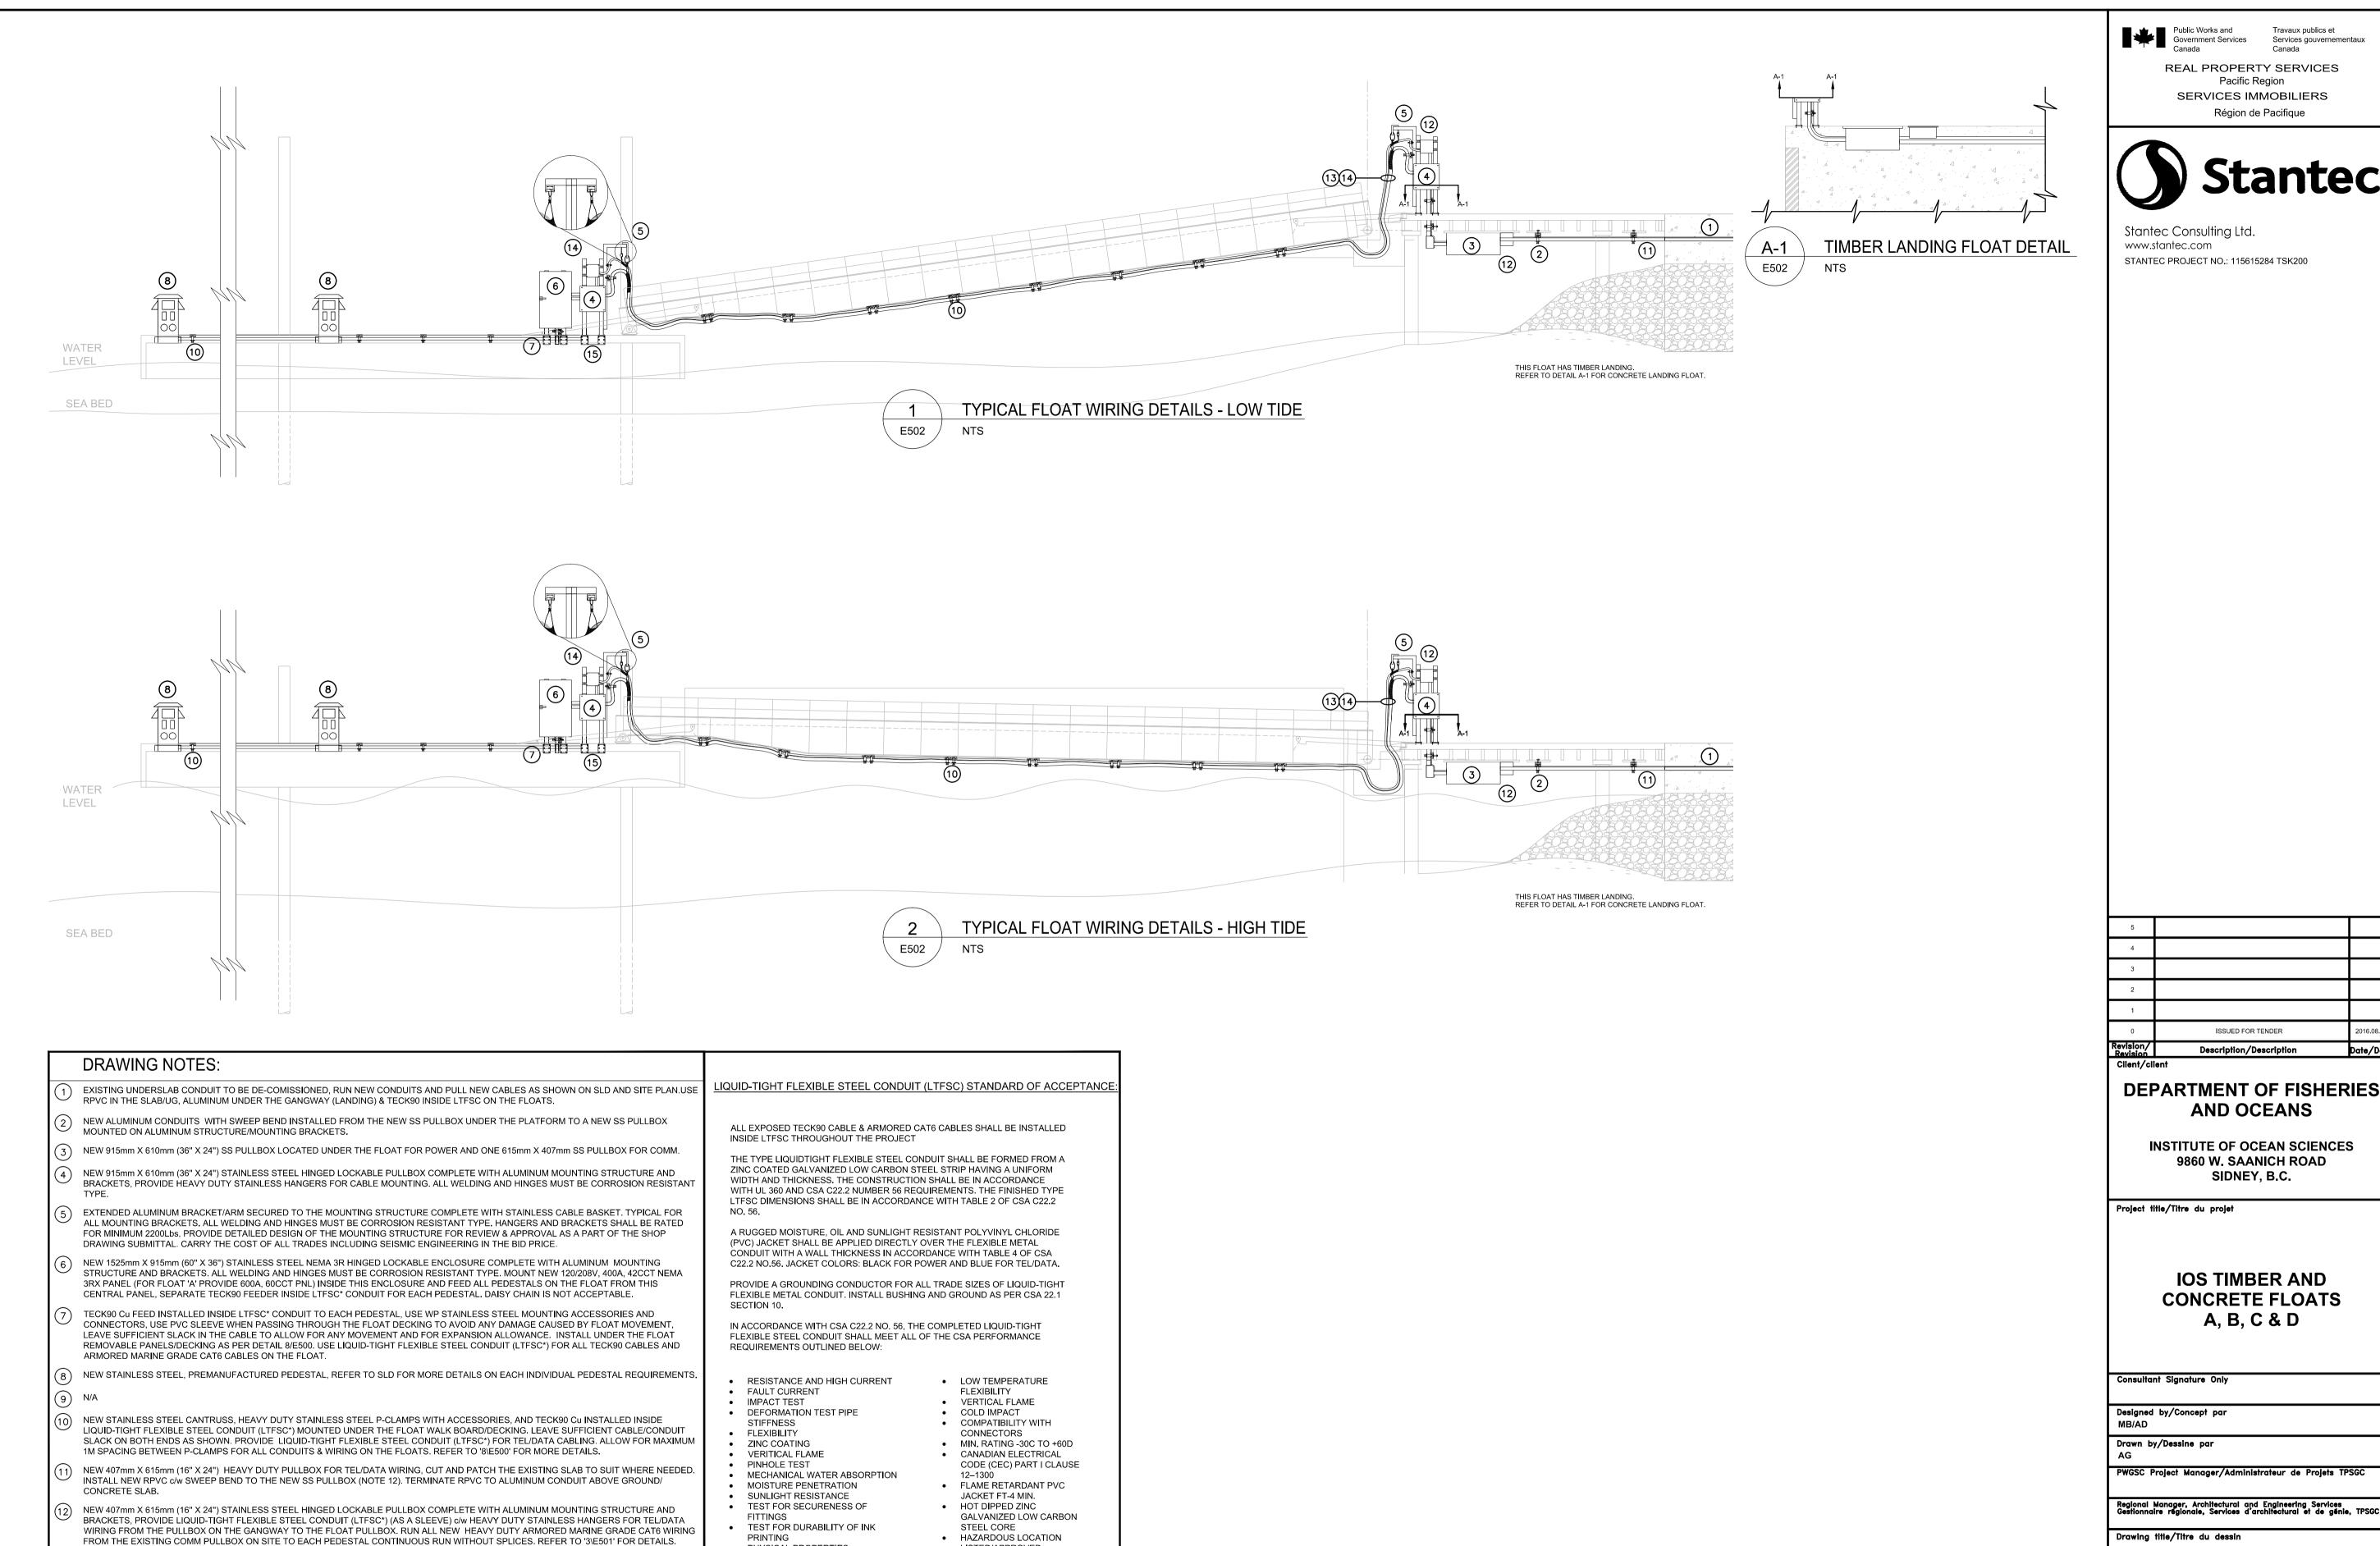

PHYSICAL PROPERTIES

ORIGINAL TENSILE AND

AIR OVEN AGING TEST

OIL IMMERSION TEST

DEFORMATION TEST

TENSION

ELONGATION

L**I**STED/APPROVED

BONDED ENDS OF THE

CONDUITS

REAL PROPERTY SERVICES **SERVICES IMMOBILIERS**



Revision/	Description/Description	Date/Date
0	ISSUED FOR TENDER	2016.08.05
1		
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3		
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DEPARTMENT OF FISHERIES

INSTITUTE OF OCEAN SCIENCES 9860 W. SAANICH ROAD

IOS TIMBER AND **CONCRETE FLOATS**

Drawing title/Titre du dessin

NEW FLOAT TYPICAL INSTALLATION ELEVATION

Project No./No. du 9R306-2

E502 14 OF 19


FOR DETAILS.

(13) NEW TECK90 CABLES RUN INSIDE LIQUID-TIGHT FLEXIBLE STEEL CONDUIT (LTFSC*) TO THE PULLBOX ON THE FLOAT.

NEW LIQUID-TIGHT FLEXIBLE STEEL CONDUIT (LTFSC*) FROM THE TEL/DATA PULLBOX ON THE FLOAT. DAISY CHAINED TO EACH PEDESTAL.

RUN ALL TEL/DATA WIRING THROUGH THIS SLEEVE. INSTALL TO THE INSIDE OF THE FLOAT FENDER, TERMINATE TO A JUNCTION BOX BEHIND

THE PEDESTAL TO FEED EACH PEDESTAL. LEAVE SUFFICIENT SLACK AT BOTH ENDS TO ALLOW FOR FLOAT MOVEMENT. REFER TO '1\E500'

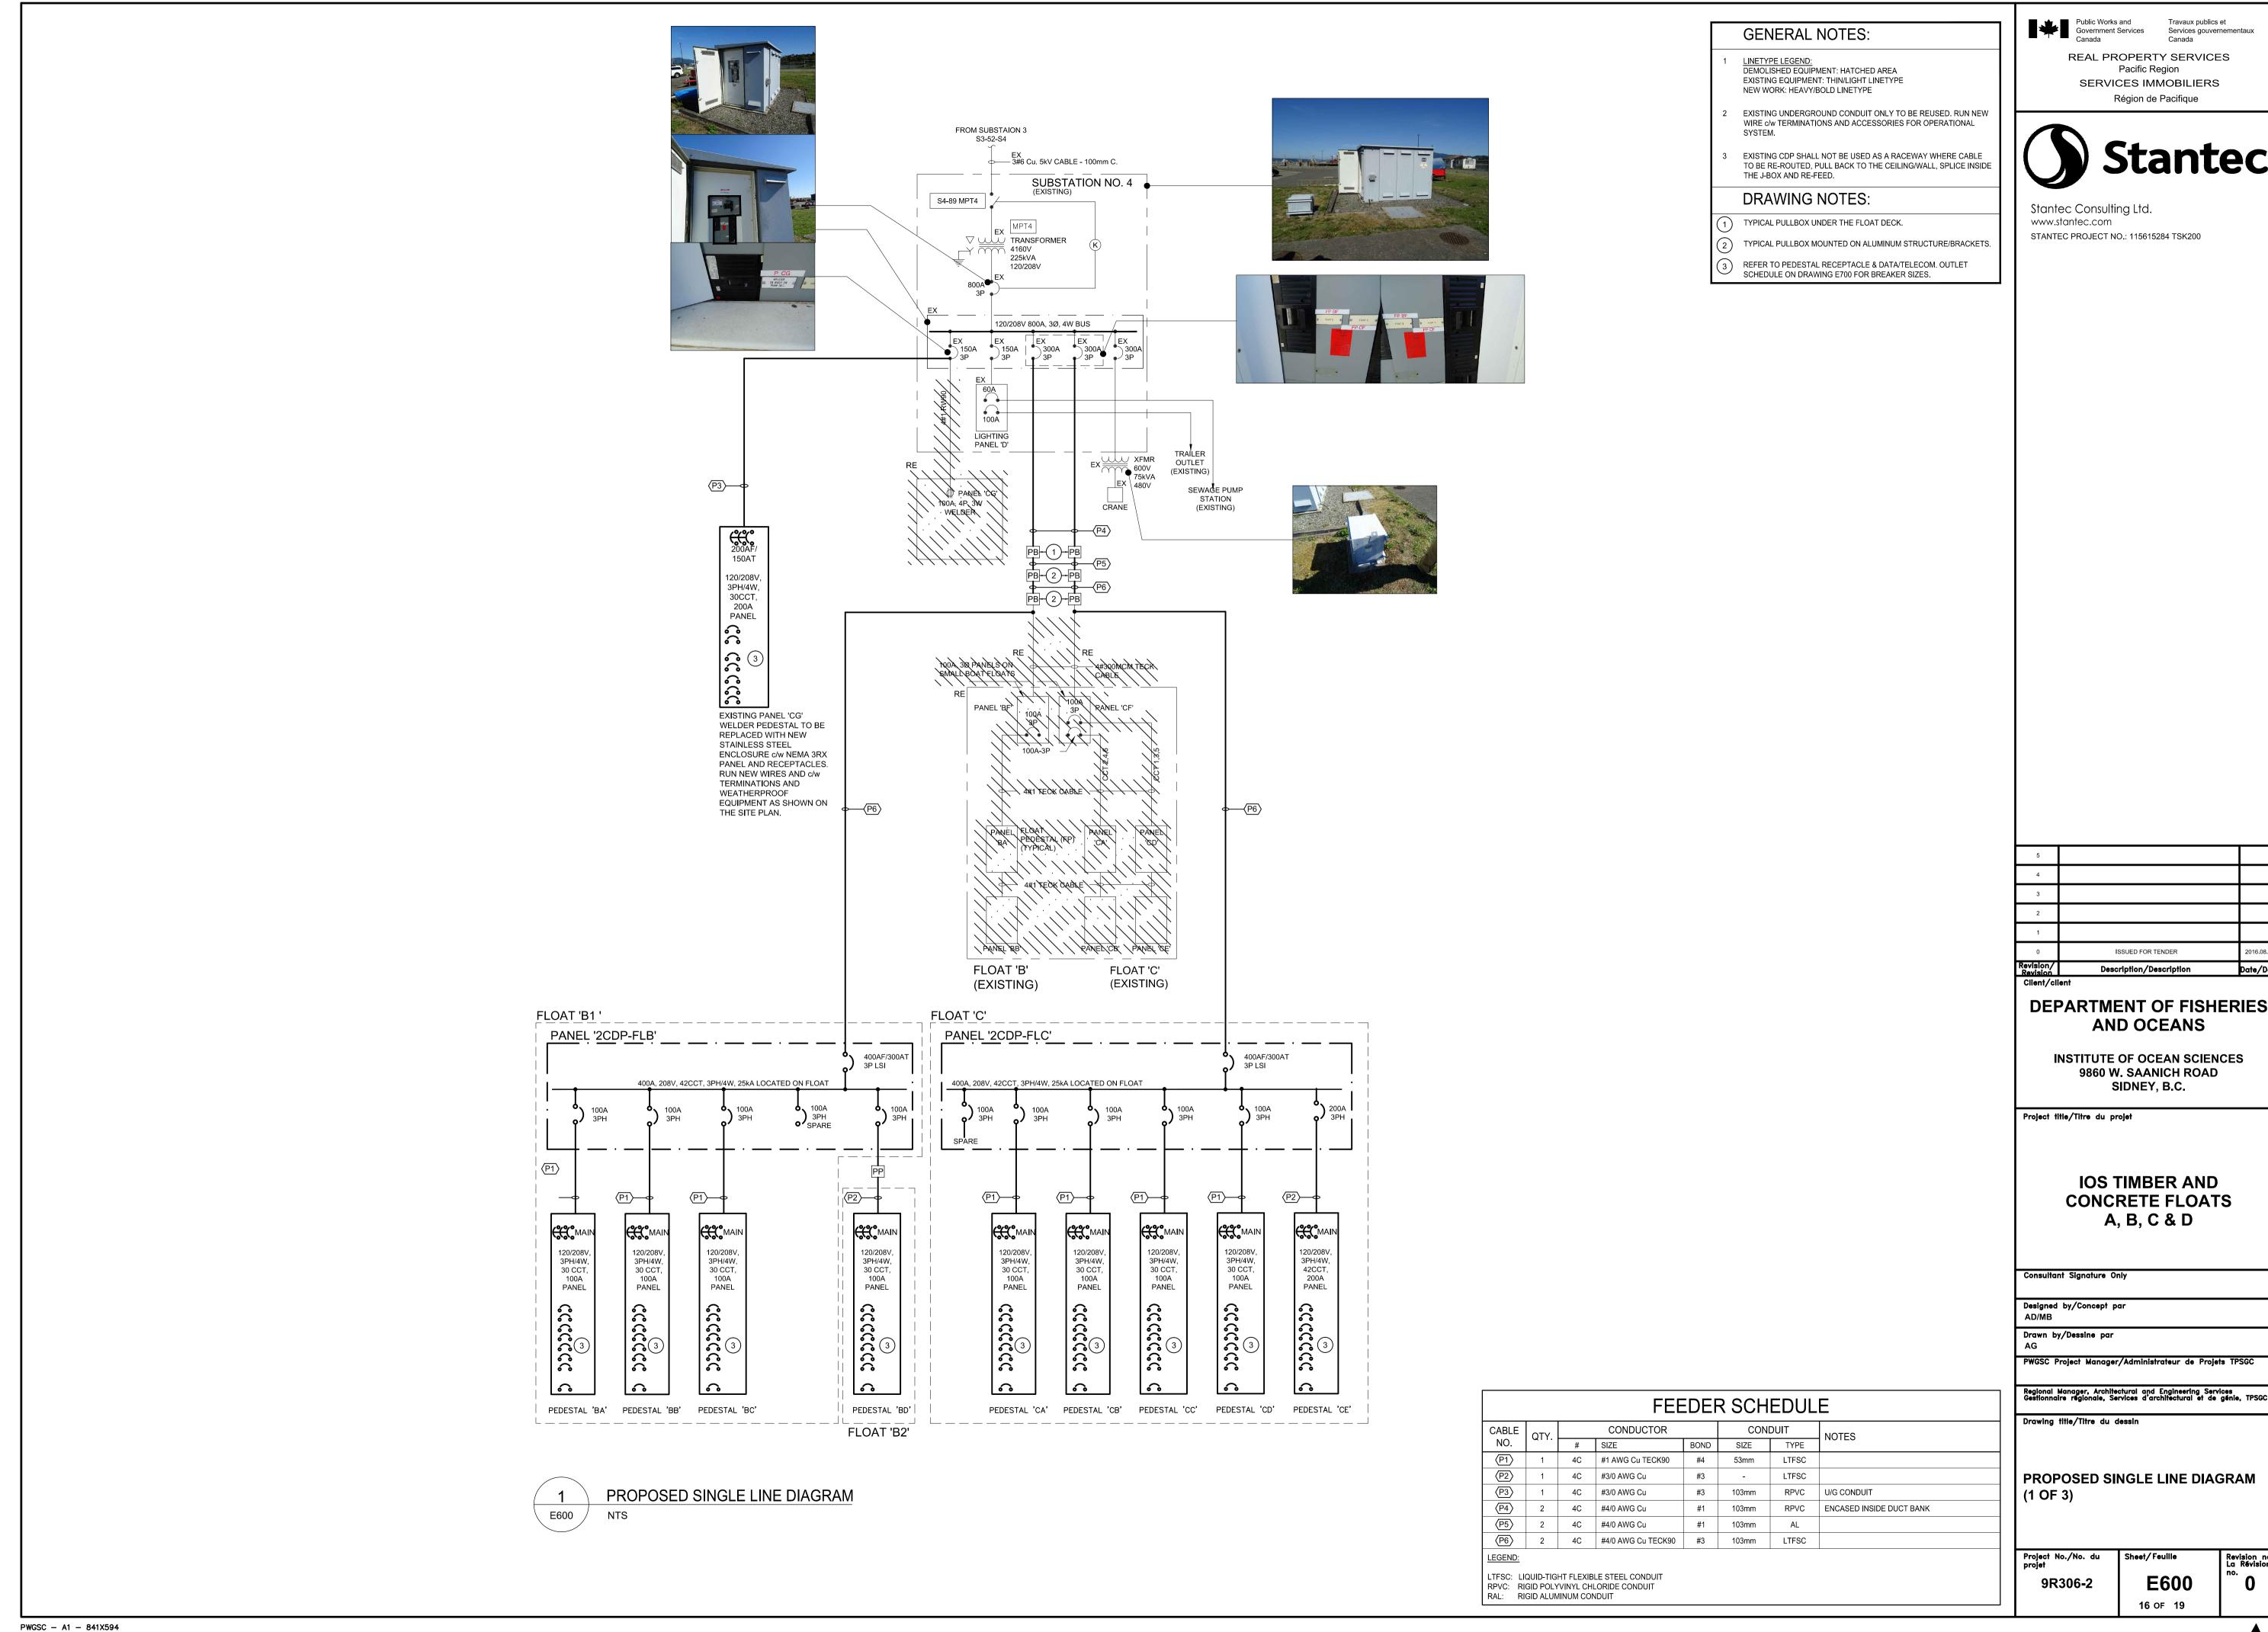




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DEPARTMENT OF FISHERIES

PROPOSED SINGLE LINE DIAGRAM

Revision no. La Révision

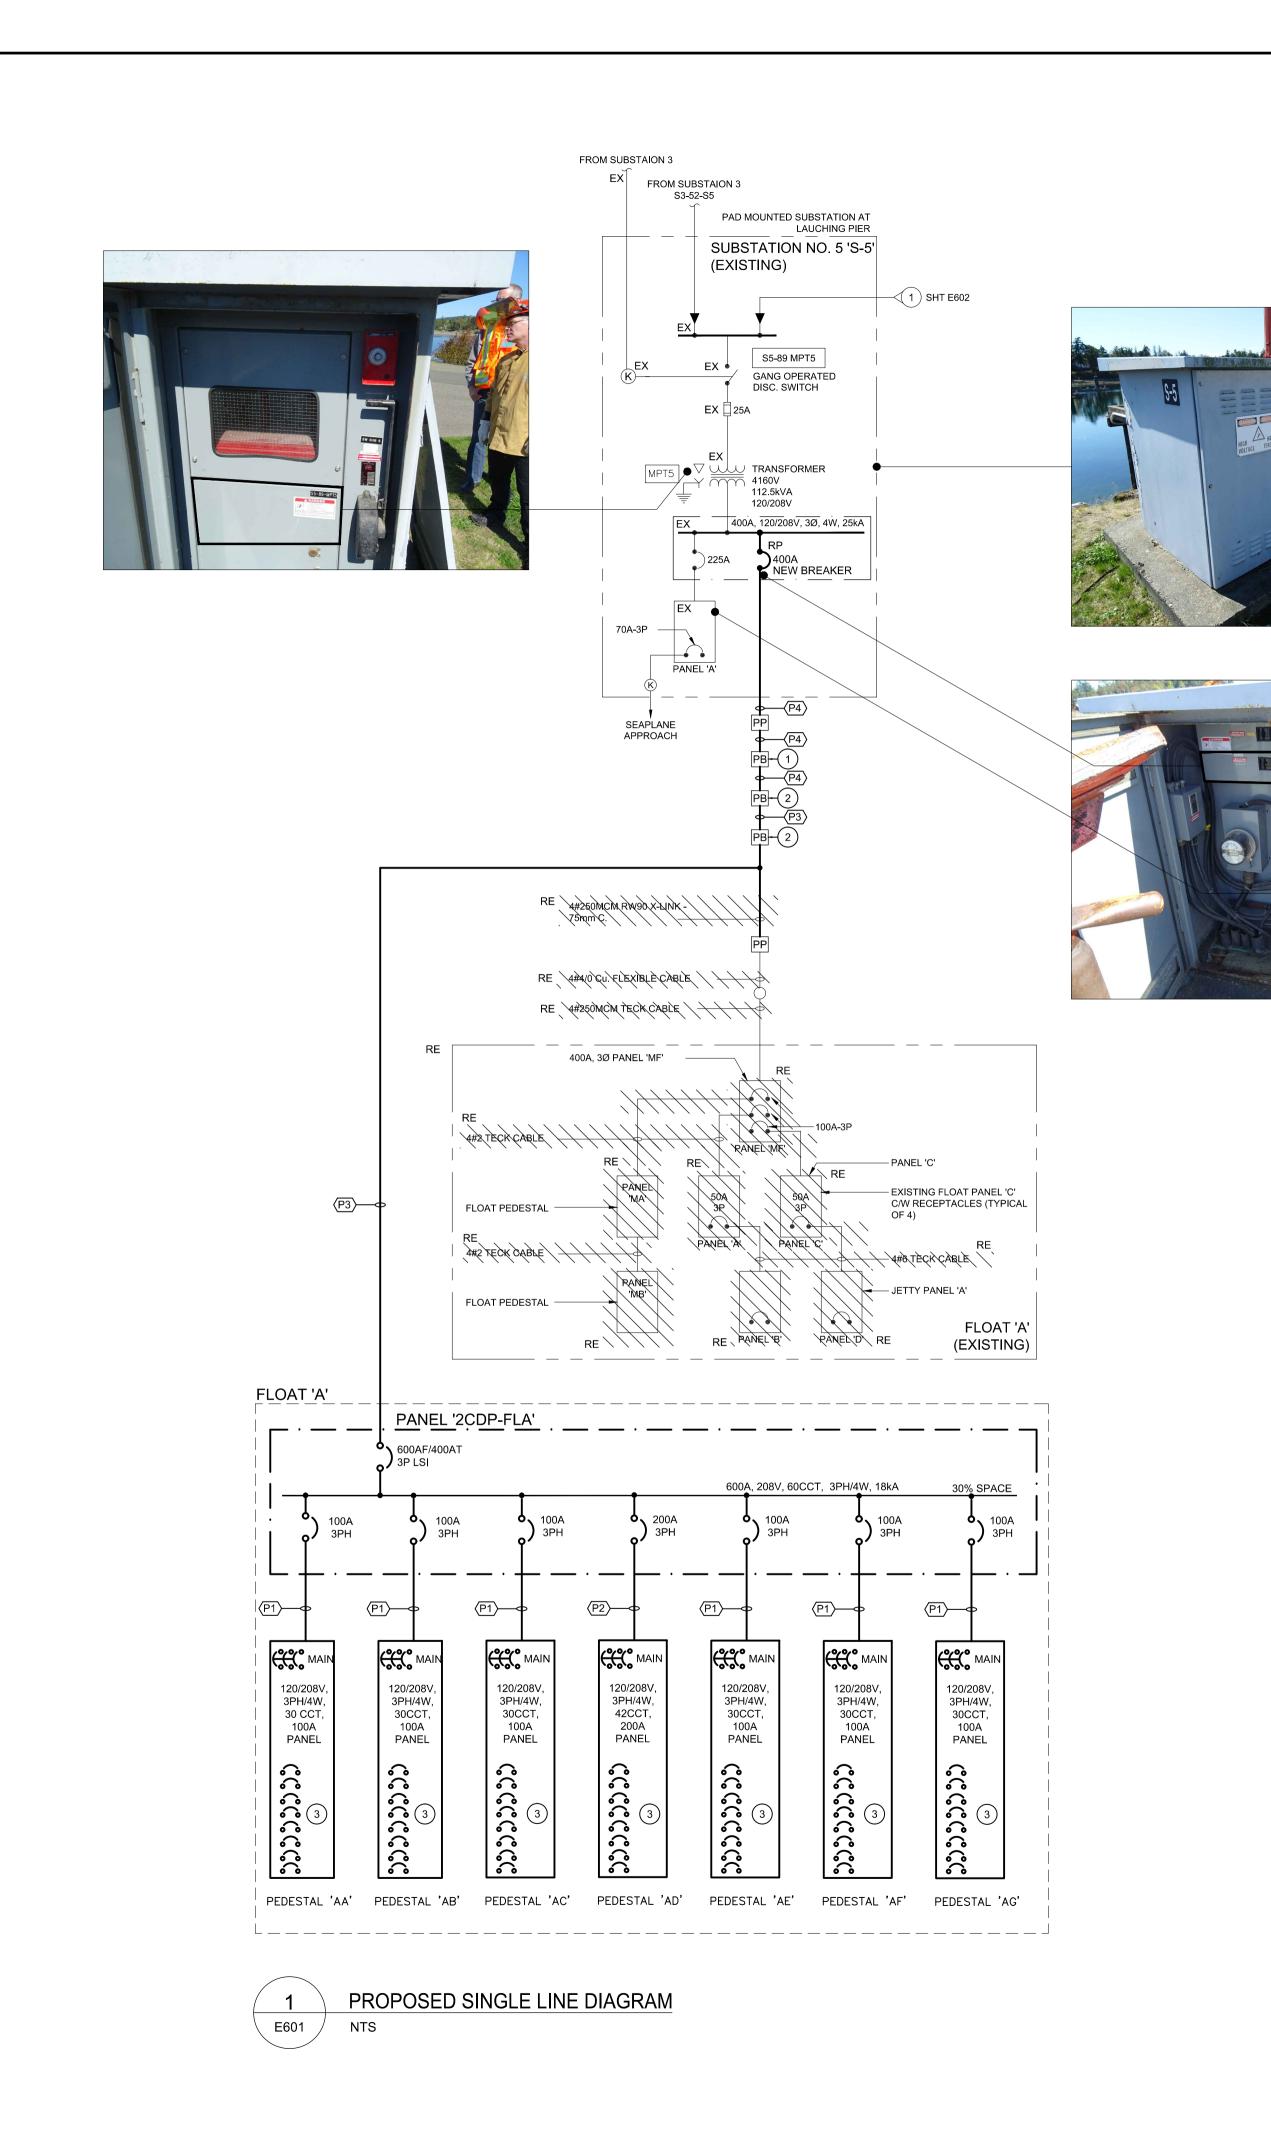

GENERAL NOTES:

LINETYPE LEGEND:
DEMOLISHED EQUIPMENT: HATCHED AREA EXISTING EQUIPMENT: THIN/LIGHT LINETYPE
NEW WORK: HEAVY/BOLD LINETYPE

EXISTING UNDERGROUND CONDUIT ONLY TO BE REUSED. RUN NEW WIRE c/w TERMINATIONS AND ACCESSORIES FOR OPERATIONAL

EXISTING CDP SHALL NOT BE USED AS A RACEWAY WHERE CABLE TO BE REE-ROUTED, PULL BACK TO THE CEILING/WALL, SPLICE INSIDE THE J-BOX AND RE-FEED.

DRAWING NOTES:

FEEDER SCHEDULE

BOND

CONDUIT

TYPE

LTFSC

RPVC 2 X 103mm RPVC SPARE CONDUITS

SIZE

CONDUCTOR

4C #1 AWG Cu TECK90 #4

4C #3/0 AWG Cu TECK90 #3

4C #4/0 AWG Cu TECK90 #3 103mm

2 4C #4/0 AWG Cu TECK90 #3 103mm

SIZE

LTFSC: LIQUID-TIGHT FLEXIBLE STEEL CONDUIT RPVC: RIGID POLYVINYL CHLORIDE CONDUIT AL: ALUMINUM CONDUIT

CABLE QTY.

LEGEND:

TYPICAL PULLBOX UNDER THE FLOAT DECK.

TYPICAL PULLBOX MOUNTED ON ALUMINUM STRUCTURE/BRACKETS.

REFER TO PEDESTAL RECEPTACLE & DATA/TELECOM. OUTLET SCHEDULE ON DRAWING E700 FOR BREAKER SIZES.

Public Works and Government Services Services gouvernementaux Canada

REAL PROPERTY SERVICES Pacific Region SERVICES IMMOBILIERS Région de Pacifique



Stantec Consulting Ltd. www.stantec.com STANTEC PROJECT NO.: 115615284 TSK200

Revision/ Revision Client/client	ISSUED FOR TENDER Description/Description	2016.08.05 Date/Date
0	ISSUED FOR TENDER	2016.08.05
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DEPARTMENT OF FISHERIES AND OCEANS

INSTITUTE OF OCEAN SCIENCES 9860 W. SAANICH ROAD SIDNEY, B.C.

Project title/Titre du projet

IOS TIMBER AND CONCRETE FLOATS A, B, C & D

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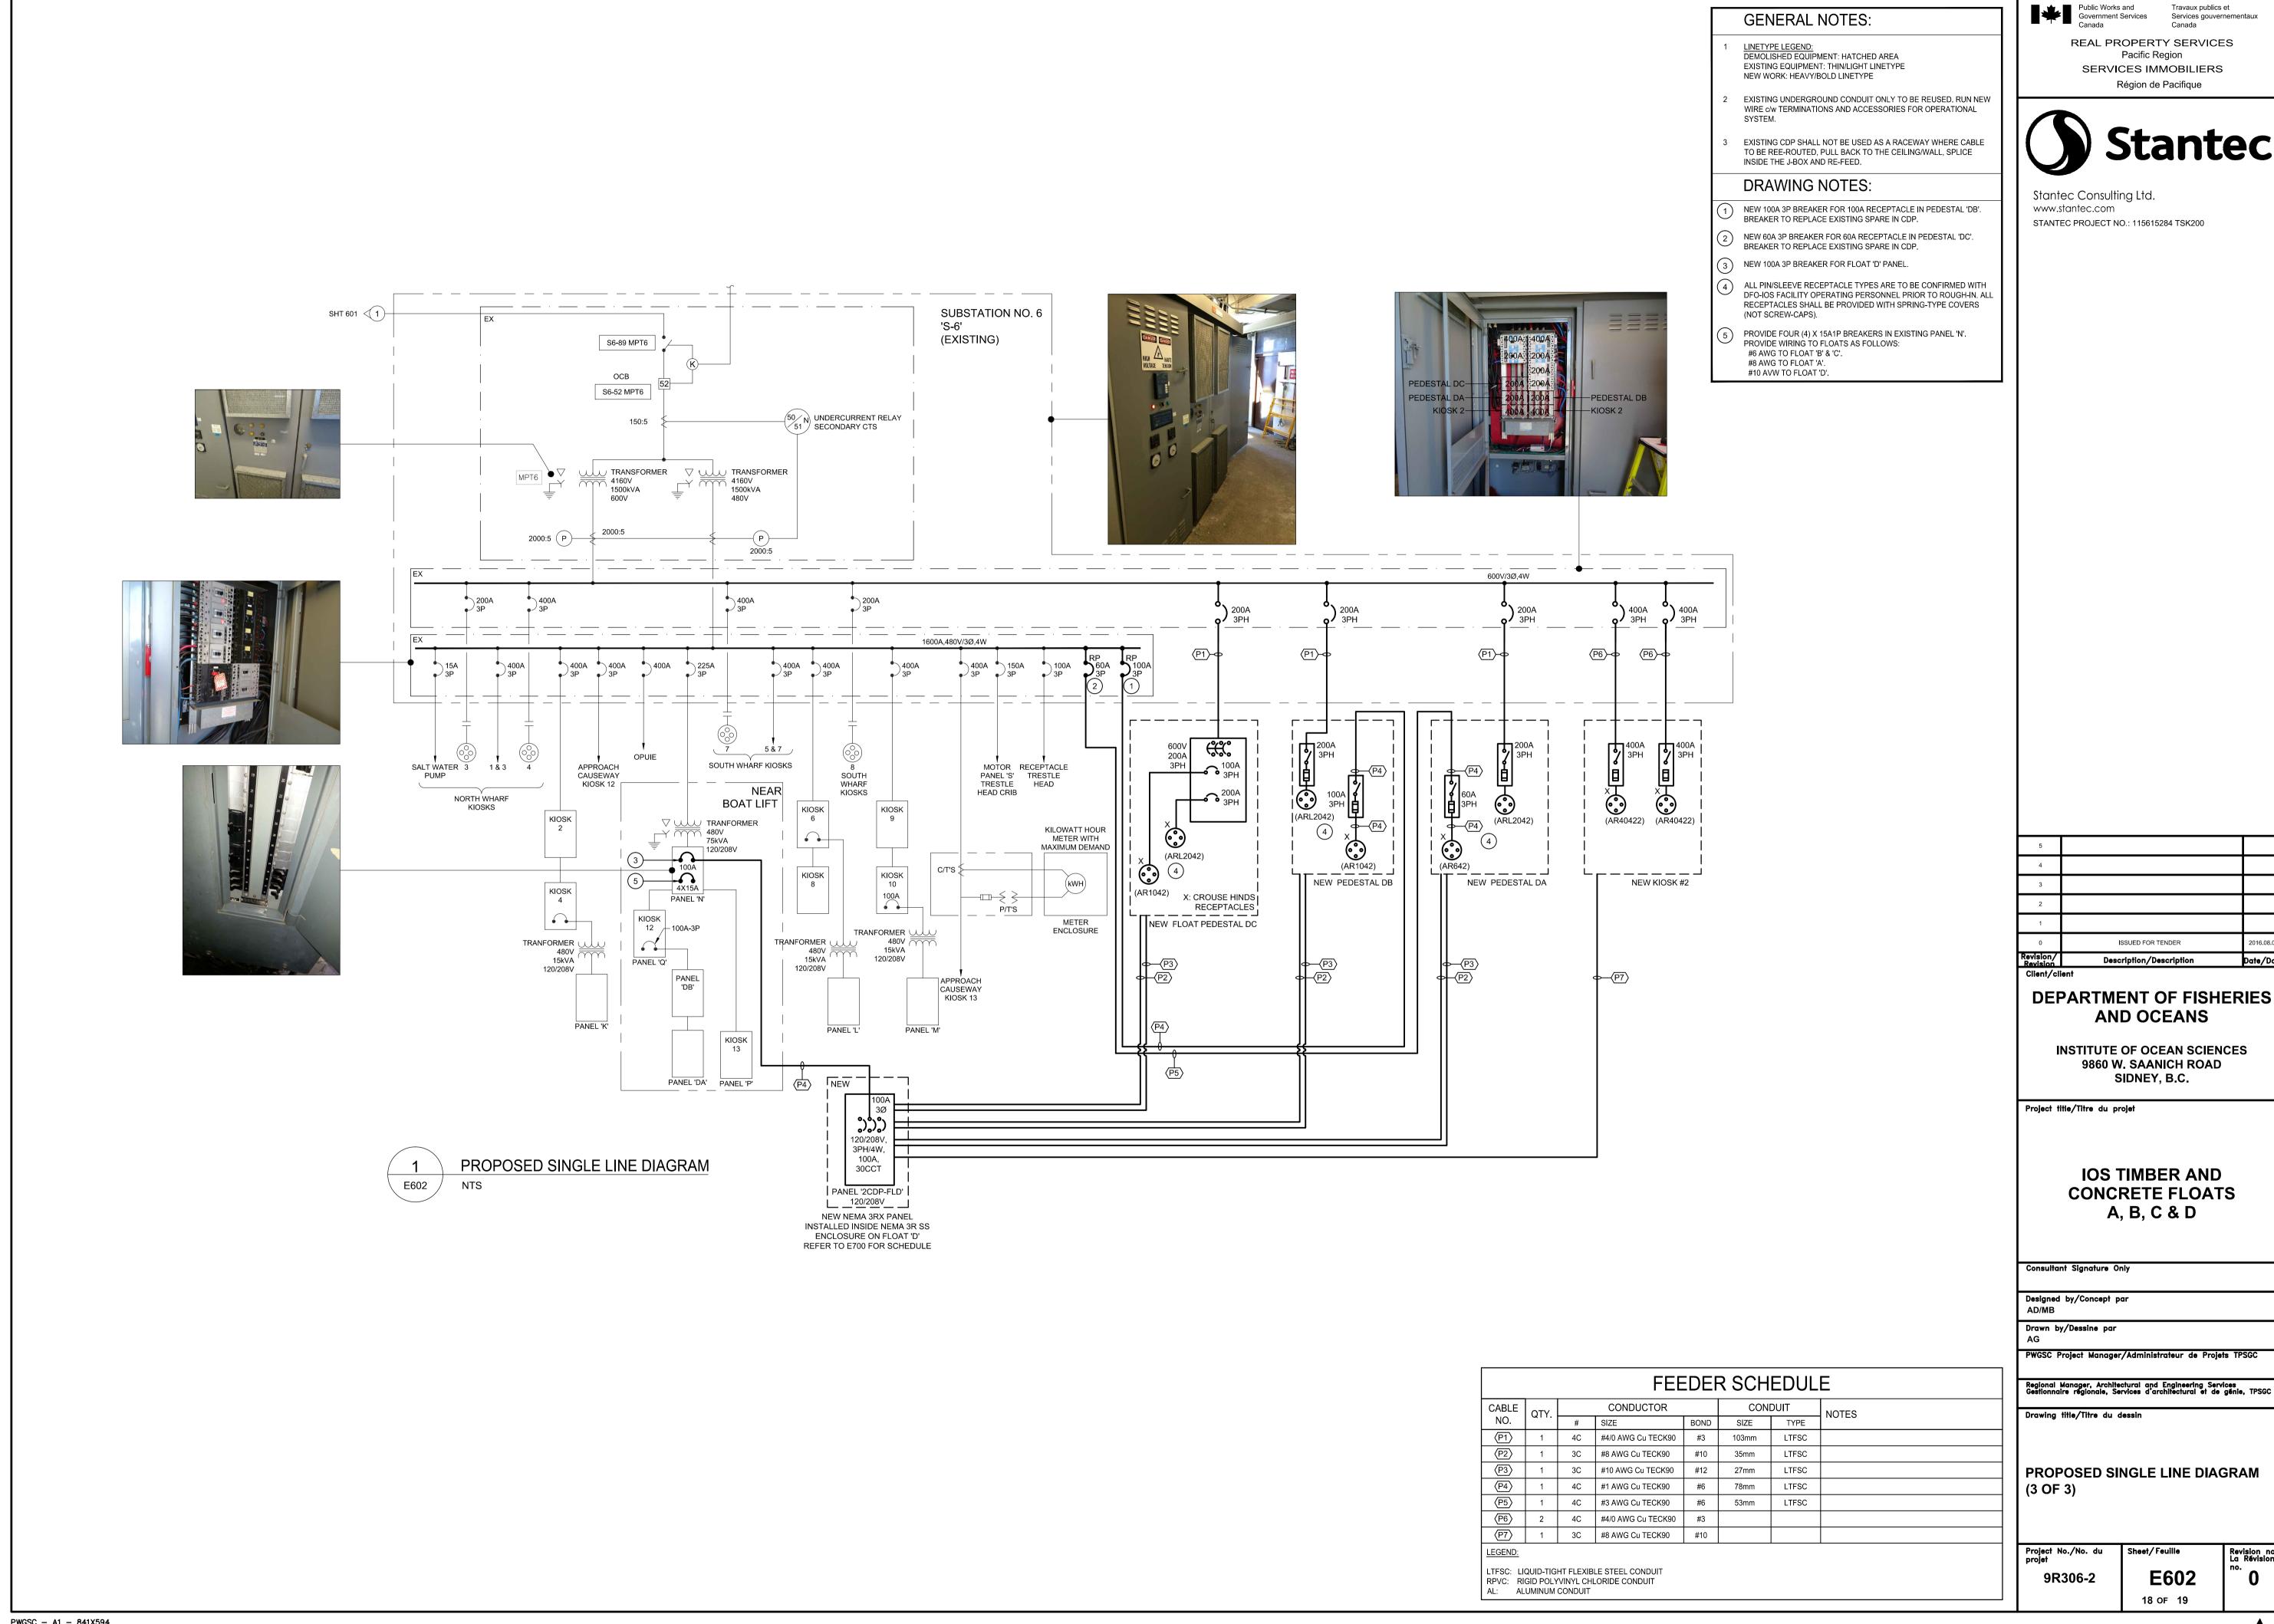
Regional Manager, Architectural and Engineering Services Gestionnaire régionale, Services d'architectural et de génie, TPSGC

Drawing title/Titre du dessin

PROPOSED SINGLE LINE DIAGRAM (2 OF 3)

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Designed by/Concept par AD/MB
Drawn by/Dessine par AG
PWGSC Project Manager/Administrateur de Projets TPSGC

AAA 1	
APPER 1	COMMENTS
AB	
AAS 1	N USE METAL COVER
ASS 1	RTIGHT BOOT COVER
2 30 120 1 x STORES STORE	ADE SS SPRING TYPE
ASS	
1	N USE METAL COVER
ACE 2 30 120 1 2 5 158 120 1 2 5 158 158 120 1 2 5 158 158 159 1 2 5 158 158 159 1 2 5 158 159 1 2 5 158 159 1 2 5 158 159 1 2 5 158 159 1 2 5 158 159 15	RTIGHT BOOT COVER
ACE	
ACE 1	
ADD 1	
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AD 3 15 120 1 2 5-158 120 1 2 5-158 120 1 3 5-158 120 1 4 5 5-158 120 1 4 5 5-158 120 1 5 5-158	ADE SS SPRING TYPE RTIGHT BOOT COVER
AD 1	
AE 2 30 120 1 x CRUSE-HINDS AR332 AR345 RTIGHT BOOT COVER	
AE 1	RTIGHT BOOT COVER
AE 1	NULSE METAL COVER
AE	
AF 2	RTIGHT BOOT COVER
AF 3	RTIGHT BOOT COVER
AF 1	NI LISE METAL COVER
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1	ADE 22 SAINO TYPE
1 100 208 1	RTIGHT BOOT COVER
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Note	ADE SS SPRING TYPE RTIGHT BOOT COVER
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BD	NI LISE MAETAL COVER
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CAT6 RJ45 LAN OUTLET	RTIGHT BOOT COVER
CA 1 60 208 1	RTIGHT BOOT COVER
CA 2 30 120 1 X CROUSE-HINDS AR332 3 15 120 1 X 5-15R C/W WP WHILE IN 1 X 3W (GROUNDED) 3-PRONG MARINE GRADE C/W MARINE GRADE SS SCREW-ON TELEPHONE PLUG GASKETED WATERTING 1 X CAT6 RJ45 LAN OUTLET GASKETED WATERTING 1 100 208 1 X CROUSE-HINDS PIN & SLEEVE ADR1044 1 60 208 1 X CROUSE-HINDS PIN & SLEEVE ADR6023 2 30 120 1 X CROUSE-HINDS PIN & SLEEVE ADR6023 3 15 120 1 X 5-15R C/W WP WHILE IN 1 X 3W (GROUNDED) 3-PRONG MARINE GRADE GASKETED WATERTING 1 X 3W (GROUNDED) 3-PRONG MARINE GRADE GASKETED WATERTING 1 X CAT6 RJ45 LAN OUTLET GASKETED WATERTING 1 100 208 1 X CROUSE-HINDS PIN & SLEEVE ADR1044 CAT6 RJ45 LAN OUTLET GASKETED WATERTING 1 60 208 1 X CROUSE-HINDS PIN & SLEEVE ADR1044 1 60 208 1 X CROUSE-HINDS PIN & SLEEVE ADR1044 2 30 120 1 X CROUSE-HINDS PIN & SLEEVE ADR6023 2 30 120 1 X CROUSE-HINDS PIN & SLEEVE ADR6023 3 15 120 1 X CROUSE-HINDS PIN & SLEEVE ADR6023 3 15 120 1 X CROUSE-HINDS PIN & SLEEVE ADR6023 3 15 120 1 X CROUSE-HINDS PIN & SLEEVE ADR6023 3 15 120 1 X CROUSE-HINDS PIN & SLEEVE ADR6023 3 15 120 1 X CROUSE-HINDS PIN & SLEEVE ADR6023 3 15 120 1 X CROUSE-HINDS PIN & SLEEVE ADR6023 3 15 120 1 X CROUSE-HINDS PIN & SLEEVE ADR6023 3 15 120 1 X CROUSE-HINDS PIN & SLEEVE ADR6023 3 15 120 1 X CROUSE-HINDS PIN & SLEEVE ADR6023 3 15 120 1 X CROUSE-HINDS PIN & SLEEVE ADR6023 3 15 120 1 X CROUSE-HINDS PIN & SLEEVE ADR6023 3 15 120 1 X CROUSE-HINDS PIN & SLEEVE ADR6023 4 R332 C/W WP WHILE IN C/W WP WHILE IN C/W WARINE GRADE C/W MARINE GRADE C/W WARINE GRADE C/W WAR	
1	
SS SCREW-ON TELEPHONE PLUG GASKETED WATERTING	N USE METAL COVER ADE SS SPRING TYPE
CAT6 RJ45 LAN OUTLET GASKETED WATERTING	RTIGHT BOOT COVER
1	ADE SS SPRING TYPE RTIGHT BOOT COVER
CB 2 30 120 1	
CB 3 15 120 1	
1	N USE METAL COVER
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CAT6 RJ45 LAN OUTLET GASKETED WATERTIC 1 100 208 1	ADE SS SPRING TYPE
1 60 208 1	RTIGHT BOOT COVER
CC 3 15 120 1 x 5-15R C/W WP WHILE IN 1 x 3W (GROUNDED) 3-PRONG MARINE GRADE C/W MARINE GRADE SS SCREW-ON TELEPHONE PLUG GASKETED WATERTIC 1 X CAT6 RJ45 LAN OUTLET GASKETED WATERTIC	
1 X 3W (GROUNDED) 3-PRONG MARINE GRADE C/W MARINE GRADE SS SCREW-ON TELEPHONE PLUG GASKETED WATERTING C/W MARINE GRADE C/W MARINE C/W MARI	N USE METAL COVER
1 X CAT6 RJ45 LAN OUTLET C/W MARINE GRAD	ADE SS SPRING TYPE
X CAT6 RJ45 LAN OUTLET GASKETED WATERTIN	RTIGHT BOOT COVER ADE SS SPRING TYPE
	RTIGHT BOOT COVER
1 100 208 1 × CROUSE-HINDS PIN & SLEEVE ADR1044 1 60 208 1 × CROUSE-HINDS PIN & SLEEVE ADR6023	
2 30 120 1 x CROUSE-HINDS AR332	
	N USE METAL COVER
TI X 3W (GROUNDED) 3-PRONG MARINE GRADE C/W MARINE GRAL	ADE SS SPRING TYPE RTIGHT BOOT COVER
1 _x C/W MARINE GRAD	ADE SS SPRING TYPE
CAT6 RJ45 LAN OUTLET GASKETED WATERTING 1 200 208 3 X CROUSE-HINDS PIN & SLEEVE ARL2042	RTIGHT BOOT COVER
1 100 208 1 x CROUSE-HINDS PIN & SLEEVE ADR1044	
1 60 208 1 x CROUSE-HINDS PIN & SLEEVE ADR6023 2 30 120 1 x CROUSE-HINDS AR332	
CE 3 15 120 1 x 5-15R C/W WP WHILE IN	N USE METAL COVER
1 X 3W (GROUNDED) 3-PRONG MARINE GRADE C/W MARINE GRADE SS SCREW-ON TELEPHONE PLUG GASKETED WATERTIG	ADE SS SPRING TYPE RTIGHT BOOT COVER

CAT6 RJ45 LAN OUTLET

C/W MARINE GRADE SS SPRING TYPE GASKETED WATERTIGHT BOOT COVER

							PEDESTAL RECEPTACLE &	
							DATA/TELECOM.OUTLET	
							SCHEDULE	
		1	100	208	1	X	CROUSE-HINDS PIN & SLEEVE	ADR1044
С	G	1	60	208	1	X	CROUSE-HINDS PIN & SLEEVE	ADR6023
		2	30	120	1	X	CROUSE-HINDS	AR332
		1	200	600	3	X	CROUSE-HINDS PIN & SLEEVE	ARL2042
		1	60	480	3	Х	CROUSE-HINDS PIN & SLEEVE	AR642
	L							
)A	2	30	120	1	_	CROUSE-HINDS	AR332
7	,,,	3	15	120	1	X	5-15R	C/W WP WHILE IN USE METAL COVER
		1	-	-	-	X	3W (GROUNDED) 3-PRONG MARINE GRADE	C/W MARINE GRADE SS SPRING TYPE
	L						SS SCREW-ON TELEPHONE PLUG	GASKETED WATERTIGHT BOOT COVER
		1	-	-	-	X		C/W MARINE GRADE SS SPRING TYPE
							CAT6 RJ45 LAN OUTLET	GASKETED WATERTIGHT BOOT COVER
		1	200	600	3	X	CROUSE-HINDS PIN & SLEEVE	ARL2042
		1	100	480	3	X	CROUSE-HINDS PIN & SLEEVE	AR1042
	L							
	ов	2	30	120	1	X	CROUSE-HINDS	AR332
ר ו	,,,	3	15	120	1	X	5-15R	C/W WP WHILE IN USE METAL COVER
		1	_	-	-	X	3W (GROUNDED) 3-PRONG MARINE GRADE	C/W MARINE GRADE SS SPRING TYPE
	L						SS SCREW-ON TELEPHONE PLUG	GASKETED WATERTIGHT BOOT COVER
		1	-	-	-	X		C/W MARINE GRADE SS SPRING TYPE
							CAT6 RJ45 LAN OUTLET	GASKETED WATERTIGHT BOOT COVER
		1	200	600	3	X	CROUSE-HINDS PIN & SLEEVE	ARL2042
		1	100	600	3	X	CROUSE-HINDS PIN & SLEEVE	AR1042
		2	30	120	1	X	CROUSE-HINDS	AR332
\dashv $\overline{}$		3	15	120	1	X	5-15R	C/W WP WHILE IN USE METAL COVER
D		1	-	-	-	X	3W (GROUNDED) 3-PRONG MARINE GRADE	C/W MARINE GRADE SS SPRING TYPE
	I						SS SCREW-ON TELEPHONE PLUG	GASKETED WATERTIGHT BOOT COVER
	1	1	-	-	-	X		C/W MARINE GRADE SS SPRING TYPE
							CAT6 RJ45 LAN OUTLET	GASKETED WATERTIGHT BOOT COVER
		2	400	600	3	X	CROUSE-HINDS PIN & SLEEVE	AR40422
_		2	15	120	1	X	5-15R	C/W WP WHILE IN USE METAL COVER
	t	1	-	-	-	_	3W (GROUNDED) 3-PRONG MARINE GRADE	
KIO	SK 2						SS SCREW-ON TELEPHONE PLUG	GASKETED WATERTIGHT BOOT COVER
	- 1	1	-	-	-	X		C/W MARINE GRADE SS SPRING TYPE
							CAT6 RJ45 LAN OUTLET	GASKETED WATERTIGHT BOOT COVER

. ALL PIN/SLEEVE RECEPTACLE TYPES ARE TO BE CONFIRMED WITH DFO-IOS FACILITY OPERATING PERSONNEL PRIOR TO ROUGH-IN. ALL ECEPTACLES SHALL BE PROVIDED WITH SPRING-TYPE COVERS (NOT SCREW-CAPS).
. CONTRACTOR TO CONFIRM ALL CROUSE-HINDS RECEPTACLES WITH THE OWNER PRIOR TO ORDER.

PANEL: 2CDP-FLD								LOCATION: FLOAT 'D'				
NOTE	LOAD	TYPE	DESCRIPTION	BRKR	- - - - -	PHASE	CCT	BRKR	DESCRIPTION	TYPE	LOAD	NOTE
		Ť	RECEPTACLE	20A1P	1	A	2		PEDESTAL 'DB'	\dashv		一
			RECEPTACLE	20A1P	3	В	4	20A1P	PEDESTAL 'DB'			
			SPARE	30A2P	5	С	6		PEDESTAL 'DC'			
					7	Α	8		PEDESTAL 'DC'	$\square \square$		_
		_	SPARE	30A2P	9	В	10		PEDESTAL 'DB'	\perp		_
					11	С	12		PEDESTAL 'DB'	\longrightarrow		₩
		_	SPARE	30A2P	13	A	14		PEDESTAL 'DA'	\dashv		┷
		-	DEGERTAGI E	00445	15	В	16		PEDESTAL 'DA'	\longrightarrow		+
			RECEPTACLE	20A1P	17	С	18		PEDESTAL 'DA'	\longrightarrow		_
			RECEPTACLE	20A1P	19	A	20		PEDESTAL 'DA'	\longrightarrow		_
		_	PEDESTAL 'DC'	15A1P	21	В	22		PEDESTAL 'DB'	\longrightarrow		_
			PEDESTAL 'DC'	15A1P	23	С	24	15A1P	PEDESTAL 'DB'	\longrightarrow		_
		_	KIOSK #2	15A1P	25	A	26		SPACE	\longrightarrow		_
			KIOSK #2	15A1P	27	В	28		SPACE	\longrightarrow		\perp
			SPARE	15A1P	29	С	30		SPACE			
			LOAD BREAKDOWN	CONNEC	CTED		DERA	ΓED	PANEL DESCRIPTI	ON		
	LIGHTIN			0		100%		0	VOLTAGE	:	208	\
	COOLIN			0		80% 80%		0	PHASE	<u>:</u>	3	
H HEATING:		0	0		0		AMPERAGE	:	0			
M MECHANICAL:		0	0		80%		PANEL AMPACITY	<u>:</u>	225	Α		
R GENERAL RECEPTACLES:		0	0			0	MAIN BREAKER	:	N/A			
E OWNER EQUIPMENT:		0	0			0	# OF TUBS	:	1			
TOTAL:		0	0 W 0			0						
					NOTE	DESCR	IPTIO	N				
1												
2												
3												_

LUMINAIRE SCHEDULE									
TYPE	DESCRIPTION	MODEL NO.	LAMPS	VOLTS	MOUNTING	REMARKS			
AA	OUTDOOR ROADWAY LED LUMINAIRE	SVS-35W16LED4K-T-LE3-	36W LED /	120	REFER TO DETAIL '5\E500'	CSA/cUL APPROVED, IP66 RATED C/W PHOTOELECTRIC			
	PHILIPS LUMEC MINIVIEW SERIES	UNIV-DMG-RC-WC10-GY3	HEA D		FOR MOUNTING DETAILS	CELL.			
	OR A PPROVED EQUAL	ACC-SVS-UNIV-PH8							

Public Works and Travaux publics et
Government Services Services gouvernementaux
Canada Canada

REAL PROPERTY SERVICES
Pacific Region
SERVICES IMMOBILIERS
Région de Pacifique



Stantec Consulting Ltd. www.stantec.com STANTEC PROJECT NO.: 115615284 TSK200

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DEPARTMENT OF FISHERIES AND OCEANS

INSTITUTE OF OCEAN SCIENCES 9860 W. SAANICH ROAD SIDNEY, B.C.

Project title/Titre du projet

IOS TIMBER AND CONCRETE FLOATS A, B, C & D

Designed by/Concept par
AD/MB

Drawn by/Dessine par
AG

PWGSC Project Manager/Administrateur de Projets TPSGC

Regional Manager, Architectural and Engineering Services Gestionnaire régionale, Services d'architectural et de génie, TPSGC

Drawing title/Titre du dessin

Consultant Signature Only

SCHEDULES

Project No./No. du projet

9R306-2

E700

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