


KEY PLAN

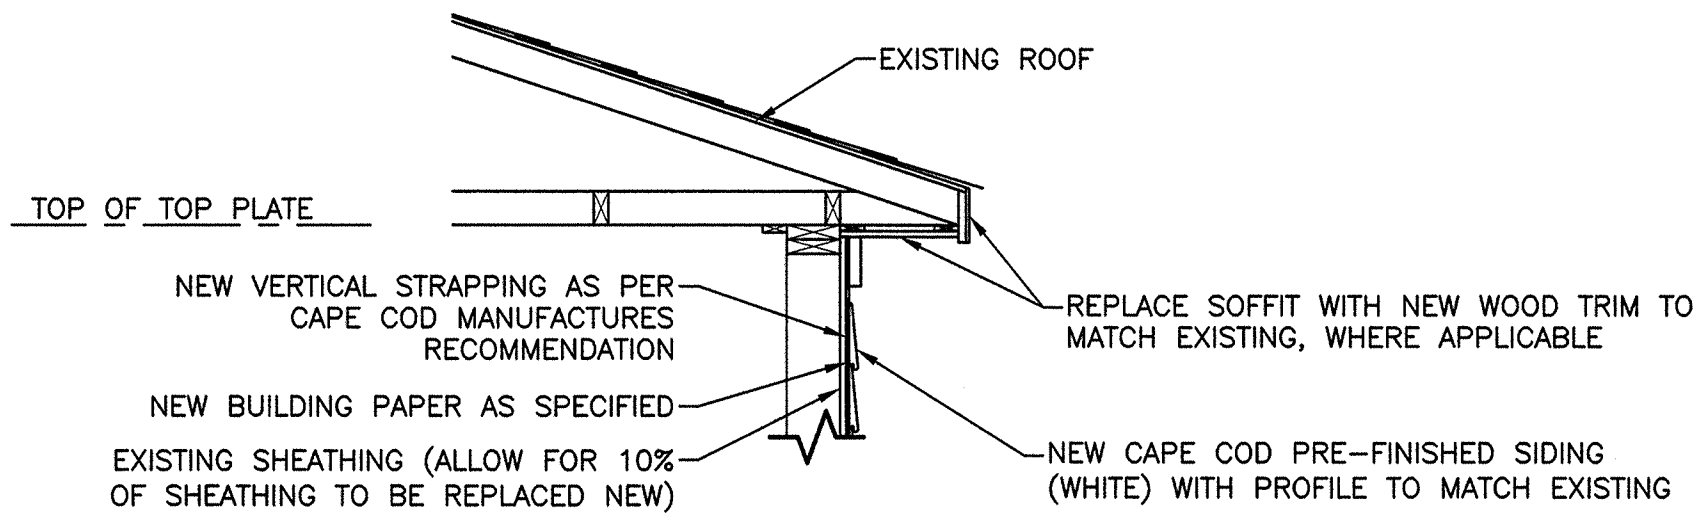


TYP. DETAIL - NEW SIDING

SCALE : N.T.S.


NOTES:

1. USE CONTINUOUS VINYL COATED FIBERGLASS INSECT SCREEN ALONG ENTIRE VENTED AREA BEHIND NEW CAPE COD SIDING.
2. REPLACE/REPAIR ANY EXISTING VAPOUR AIR BARRIER THAT MAY BE DAMAGED BY REMOVAL OF EXISTING CLADDING AND STRAPPING.
3. USE PRE-FINISHED SKIRT BOARD AT BASE OF NEW SIDING (ENSURE CONSISTENT GAP AT TOP AND BOTTOM OF NEW SIDING TO PROMOTE DRAINAGE AND AIR CIRCULATION. ALL SIDING TO BE INSTALLED USING BEST MANAGEMENT PRACTICES AS RECOMMENDED BY CAPE COD SUPPLIER.

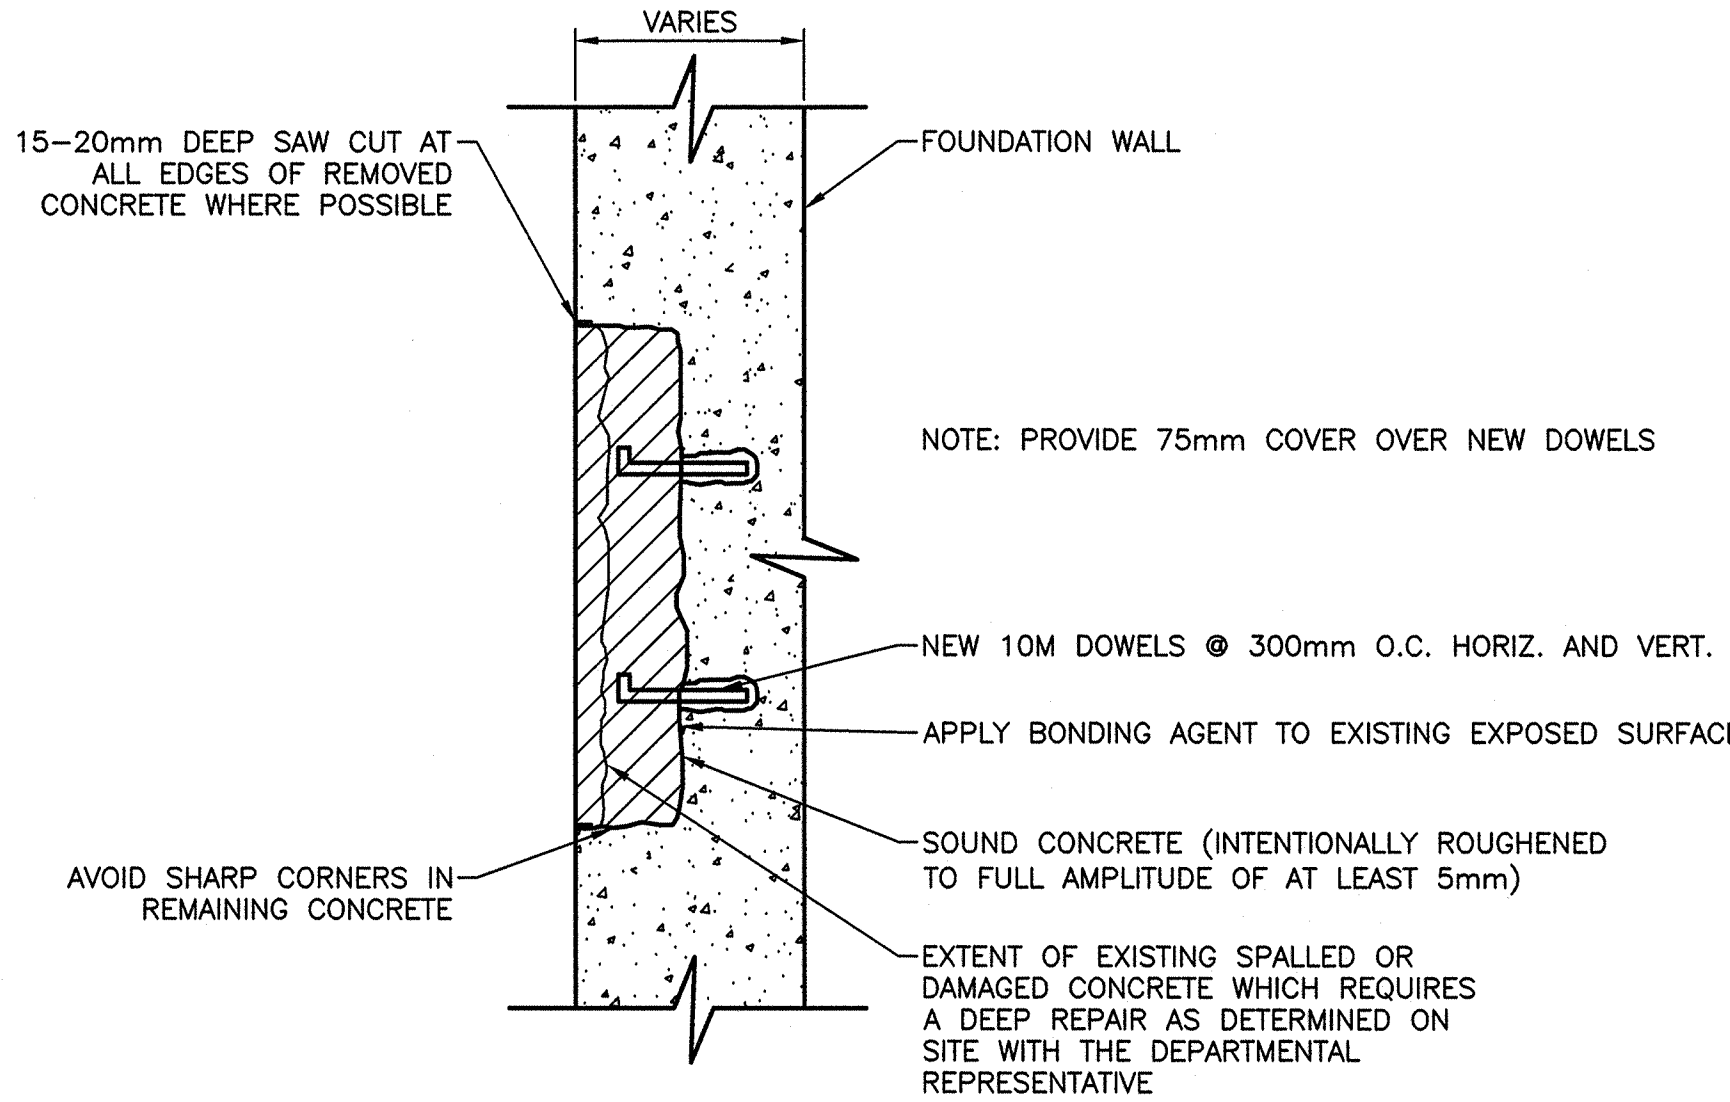

DEEP REPAIR

SCALE : N.T.S.

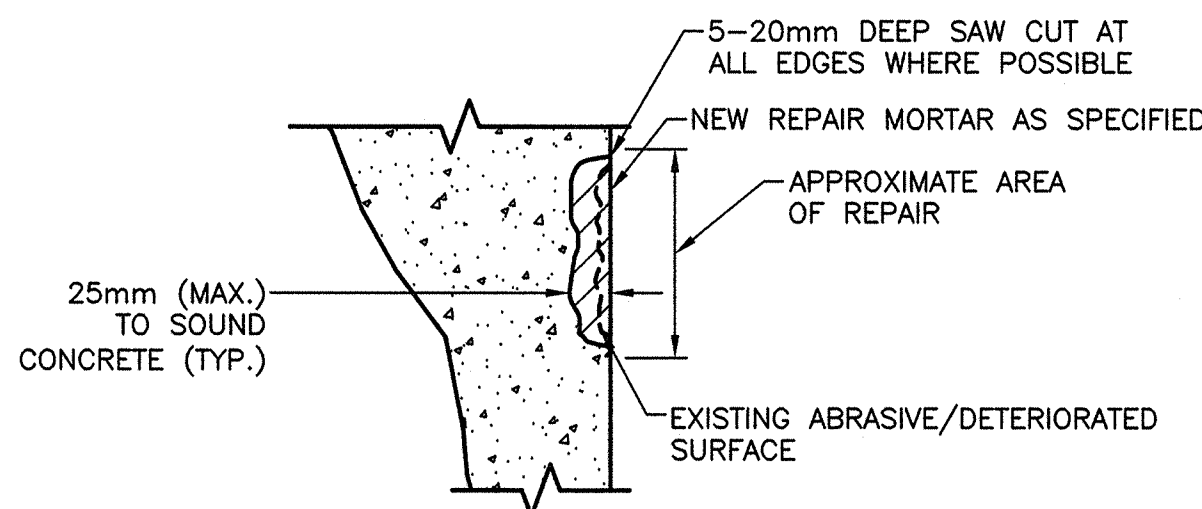


SHALLOW REPAIR

SCALE : N.T.S.


NOTES:

1. VISIT SITE TO CONFIRM ALL CRITICAL DIMENSIONS. DIMENSIONS SHOWN ARE IN MILLIMETRES AND ARE APPROXIMATE.
2. HIGH PRESSURE WASH AND/OR SAND BLAST THE EXTERIOR FOUNDATION WALL TO REMOVE ALL PAINT DOWN TO BARE CONCRETE. NO EXISTING PAINT IS TO REMAIN ON THE EXTERIOR OF THE FOUNDATION WALL. IMPLEMENT HOARDING TO ENSURE CONTAINMENT OF LEAD DUST.
3. CARRY OUT DEEP AND SHALLOW CONCRETE REPAIRS AS DETAILED ON THIS PAGE. FOR SHALLOW REPAIRS, USE MASTER EMACO N425 (OR APPROVED EQUIVALENT) IN ACCORDANCE WITH MANUFACTURER'S INSTRUCTIONS. ALLOW REPAIRS TO CURE.
4. ONCE REPAIRS HAVE CURED, PRESSURE WASH THE ENTIRE EXTERIOR FOUNDATION WALL TO REMOVE ALL CONTAMINANTS THAT MAY BE ON THE SURFACE.
5. APPLY 2 COATS OF MASTERPROTECT EL750 ELASTOMERIC COATING (OR APPROVED EQUIVALENT) TO THE ENTIRE EXTERIOR FOUNDATION WALL. APPLY AS PER MANUFACTURER'S WRITTEN INSTRUCTIONS.

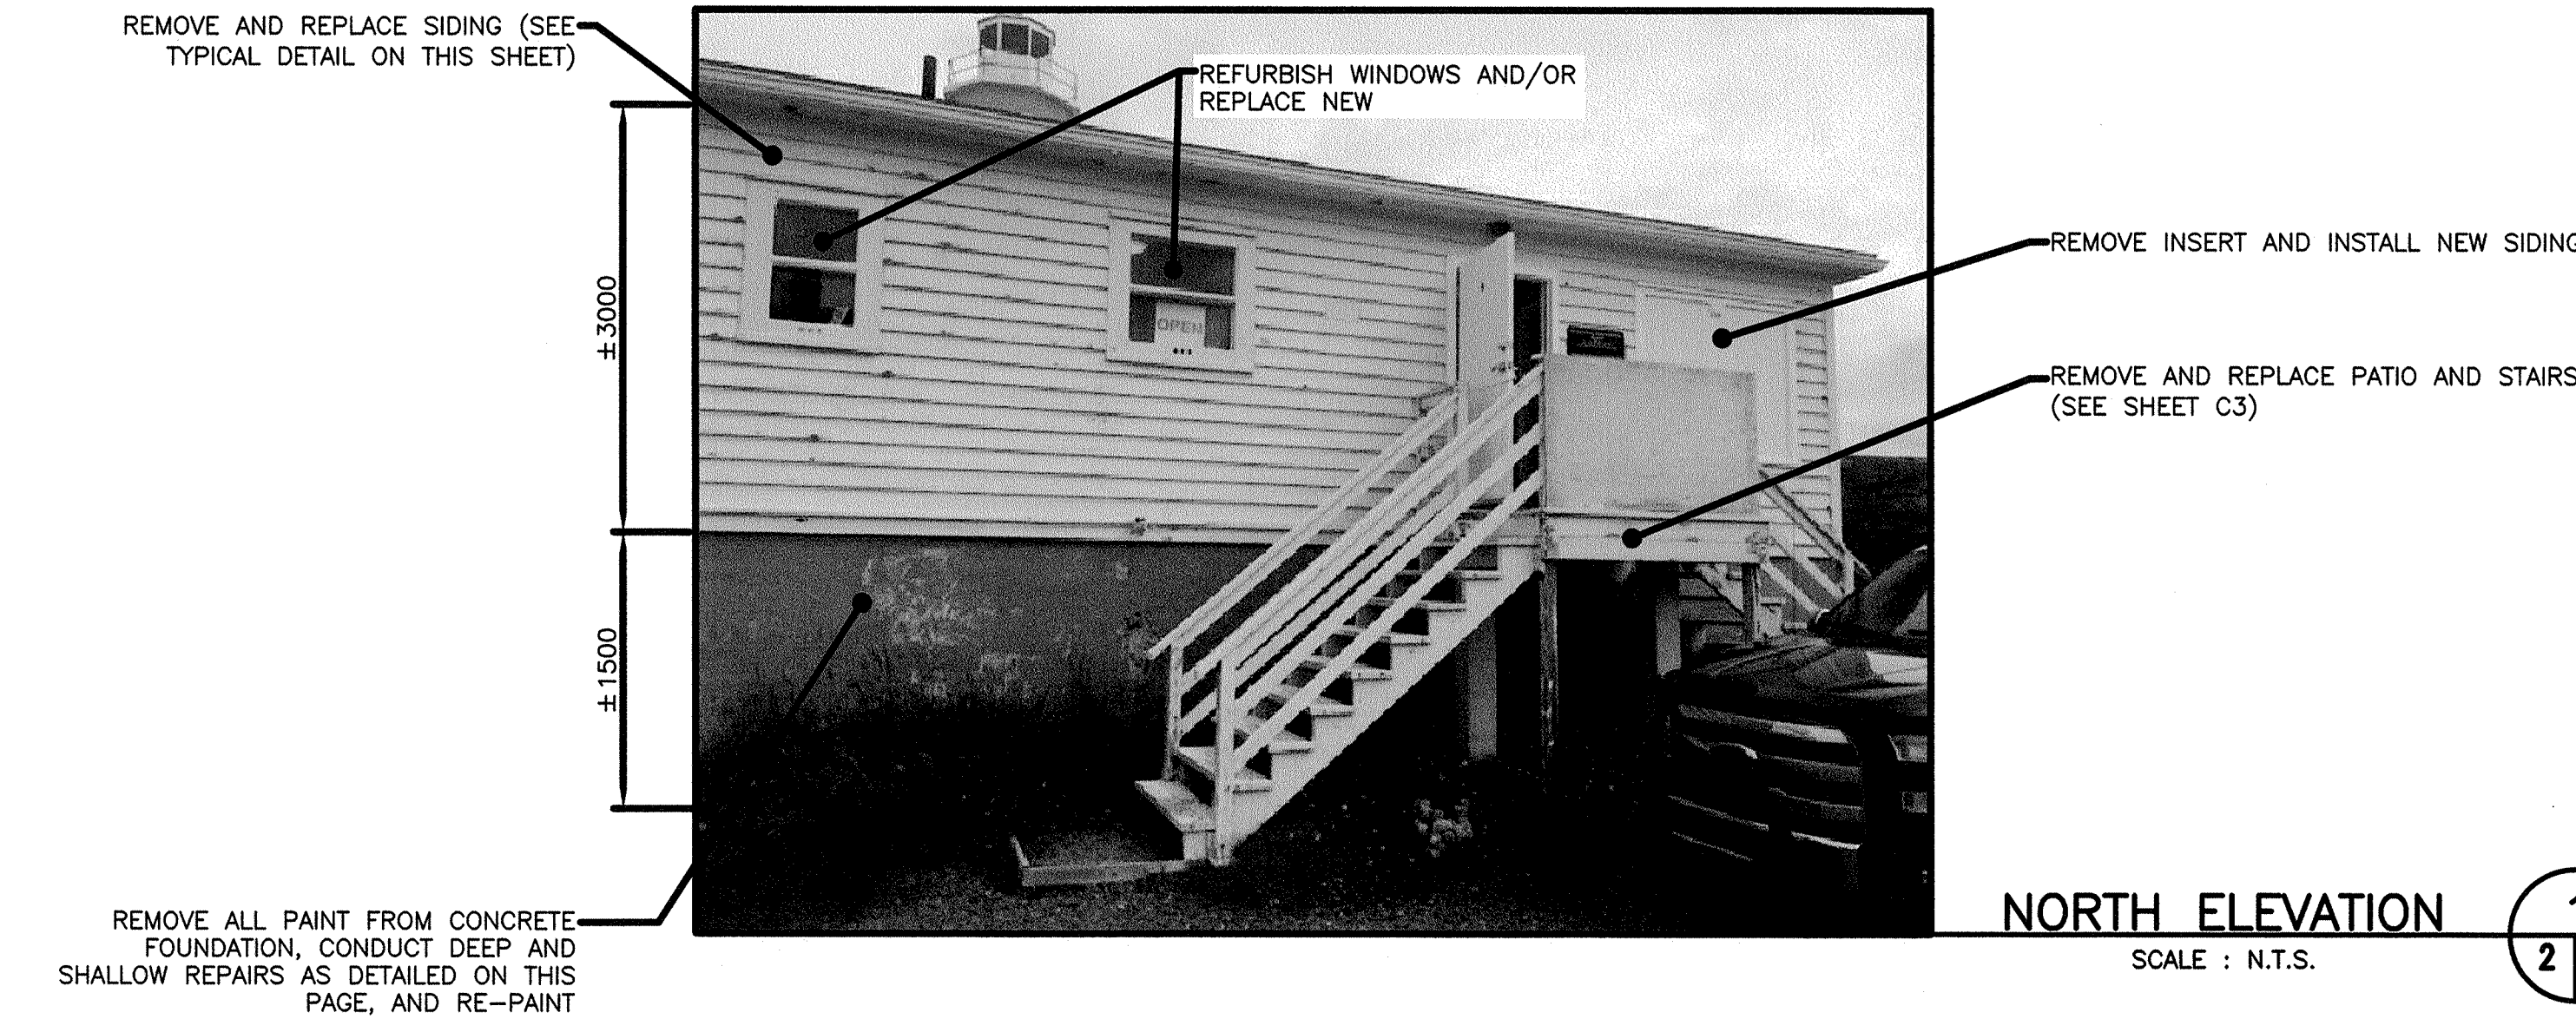

NORTH ELEVATION

SCALE : N.T.S.

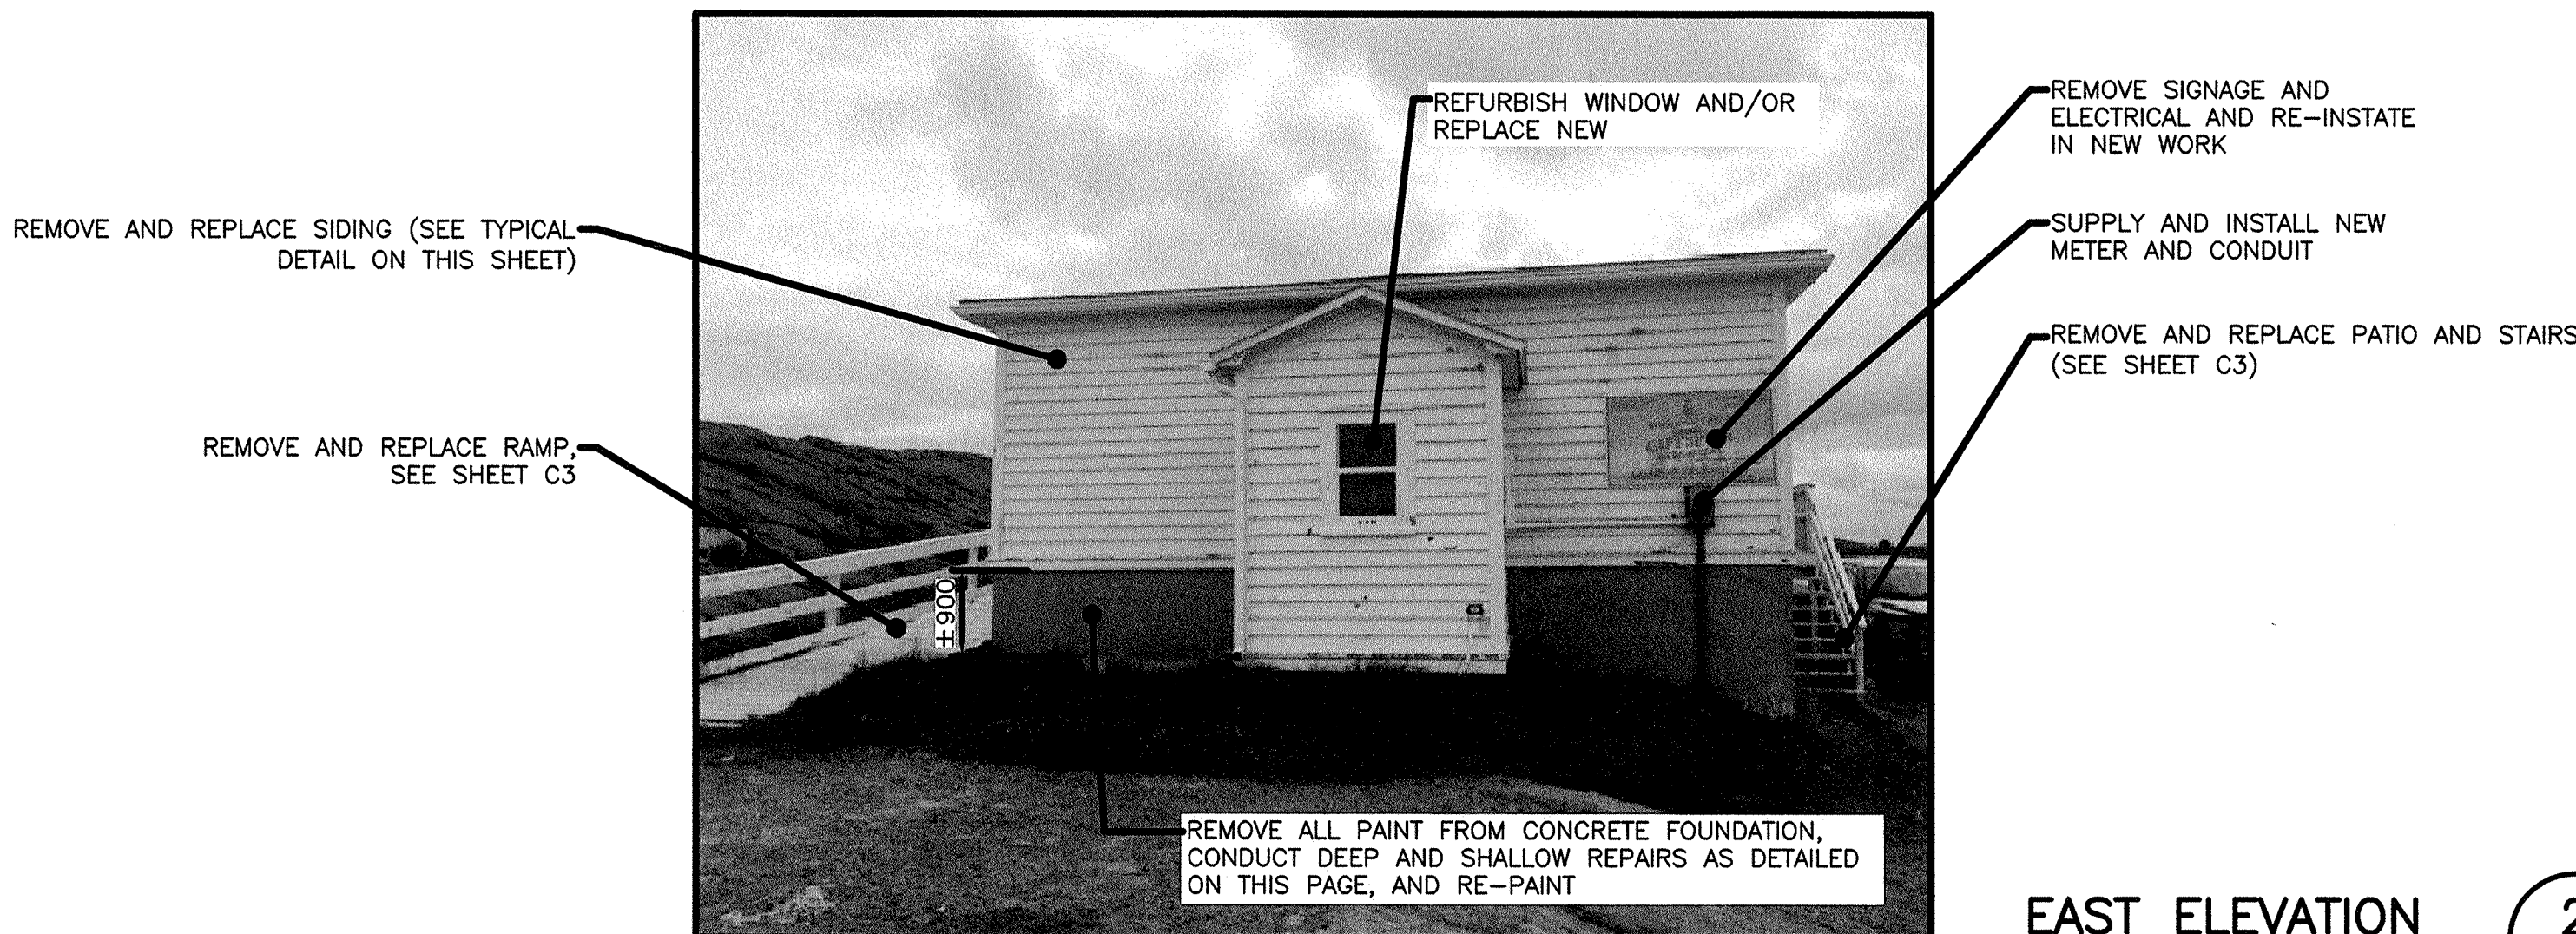

EAST ELEVATION

SCALE : N.T.S.



SOUTH ELEVATION

SCALE : N.T.S.



WEST ELEVATION

SCALE : N.T.S.

B	ISSUED FOR TENDER	09/26/16
A	ISSUED FOR REVIEW	06/21/16
revisions		date
project		project

CAPE SPEAR
LIGHTSTATION
REMEDIATION/RISK
MANAGEMENT

ALUMNI BUILDING

designed	N.H.	conçu
date	SEPTEMBER 26, 2016	
drawn	P.H.	dessiné
date	SEPTEMBER 26, 2016	
approved		approuvé
date		
Tender	Neil Hunt	Soumission
PWGSC Project Manager	Administrateur de projets TPSCC	
project number	R.082643.015	no. du projet
drawing no.	C2	no. du dessin