


NOTE:
WORK ON THIS SHEET APPLIES TO
WASHROOMS #2 ONLY. LOCATION
CIRCLED ON KEY PLAN BELOW.

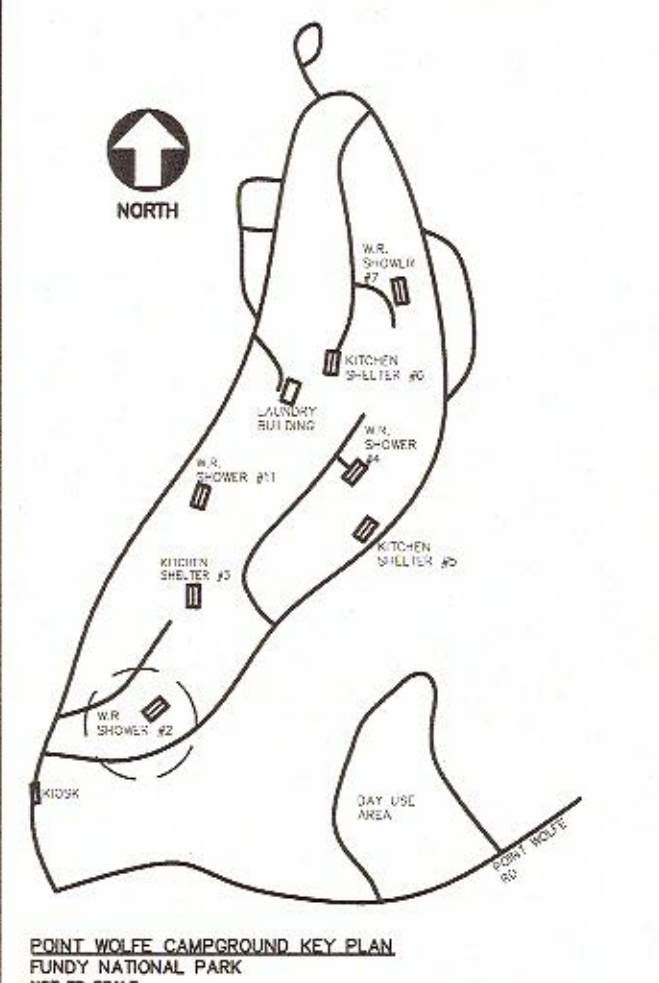


D	RE-ISSUED FOR TENDER	SEPT 30 2016
C	ISSUED FOR TENDER	SEPT 13 2016
B	ISSUED FOR 99% REVIEW	JULY 28 2016
A	ISSUED FOR REVIEW	MAY 2016
revisions		date

project
**POINT WOLF
SERVICE BUILDINGS
FUNDY NATIONAL PARK
ALMA, NB**
ALBERT COUNTY, NB

drawing
**FLOOR PLANS
& ELEVATIONS
-BARRIER FREE W.R.**


designed A. MALENFANT	conçu
date MAY 2016	
drawn J. ADAMCZYK	dessiné
date MAY 2016	
approved	approuvé
date	
Tender	Soumission
PWSC Project Manager	Administrateur de projets TPSCC
project number	no. du projet
R.075852.001	
drawing no.	no. du dessin
A2 OF 10	

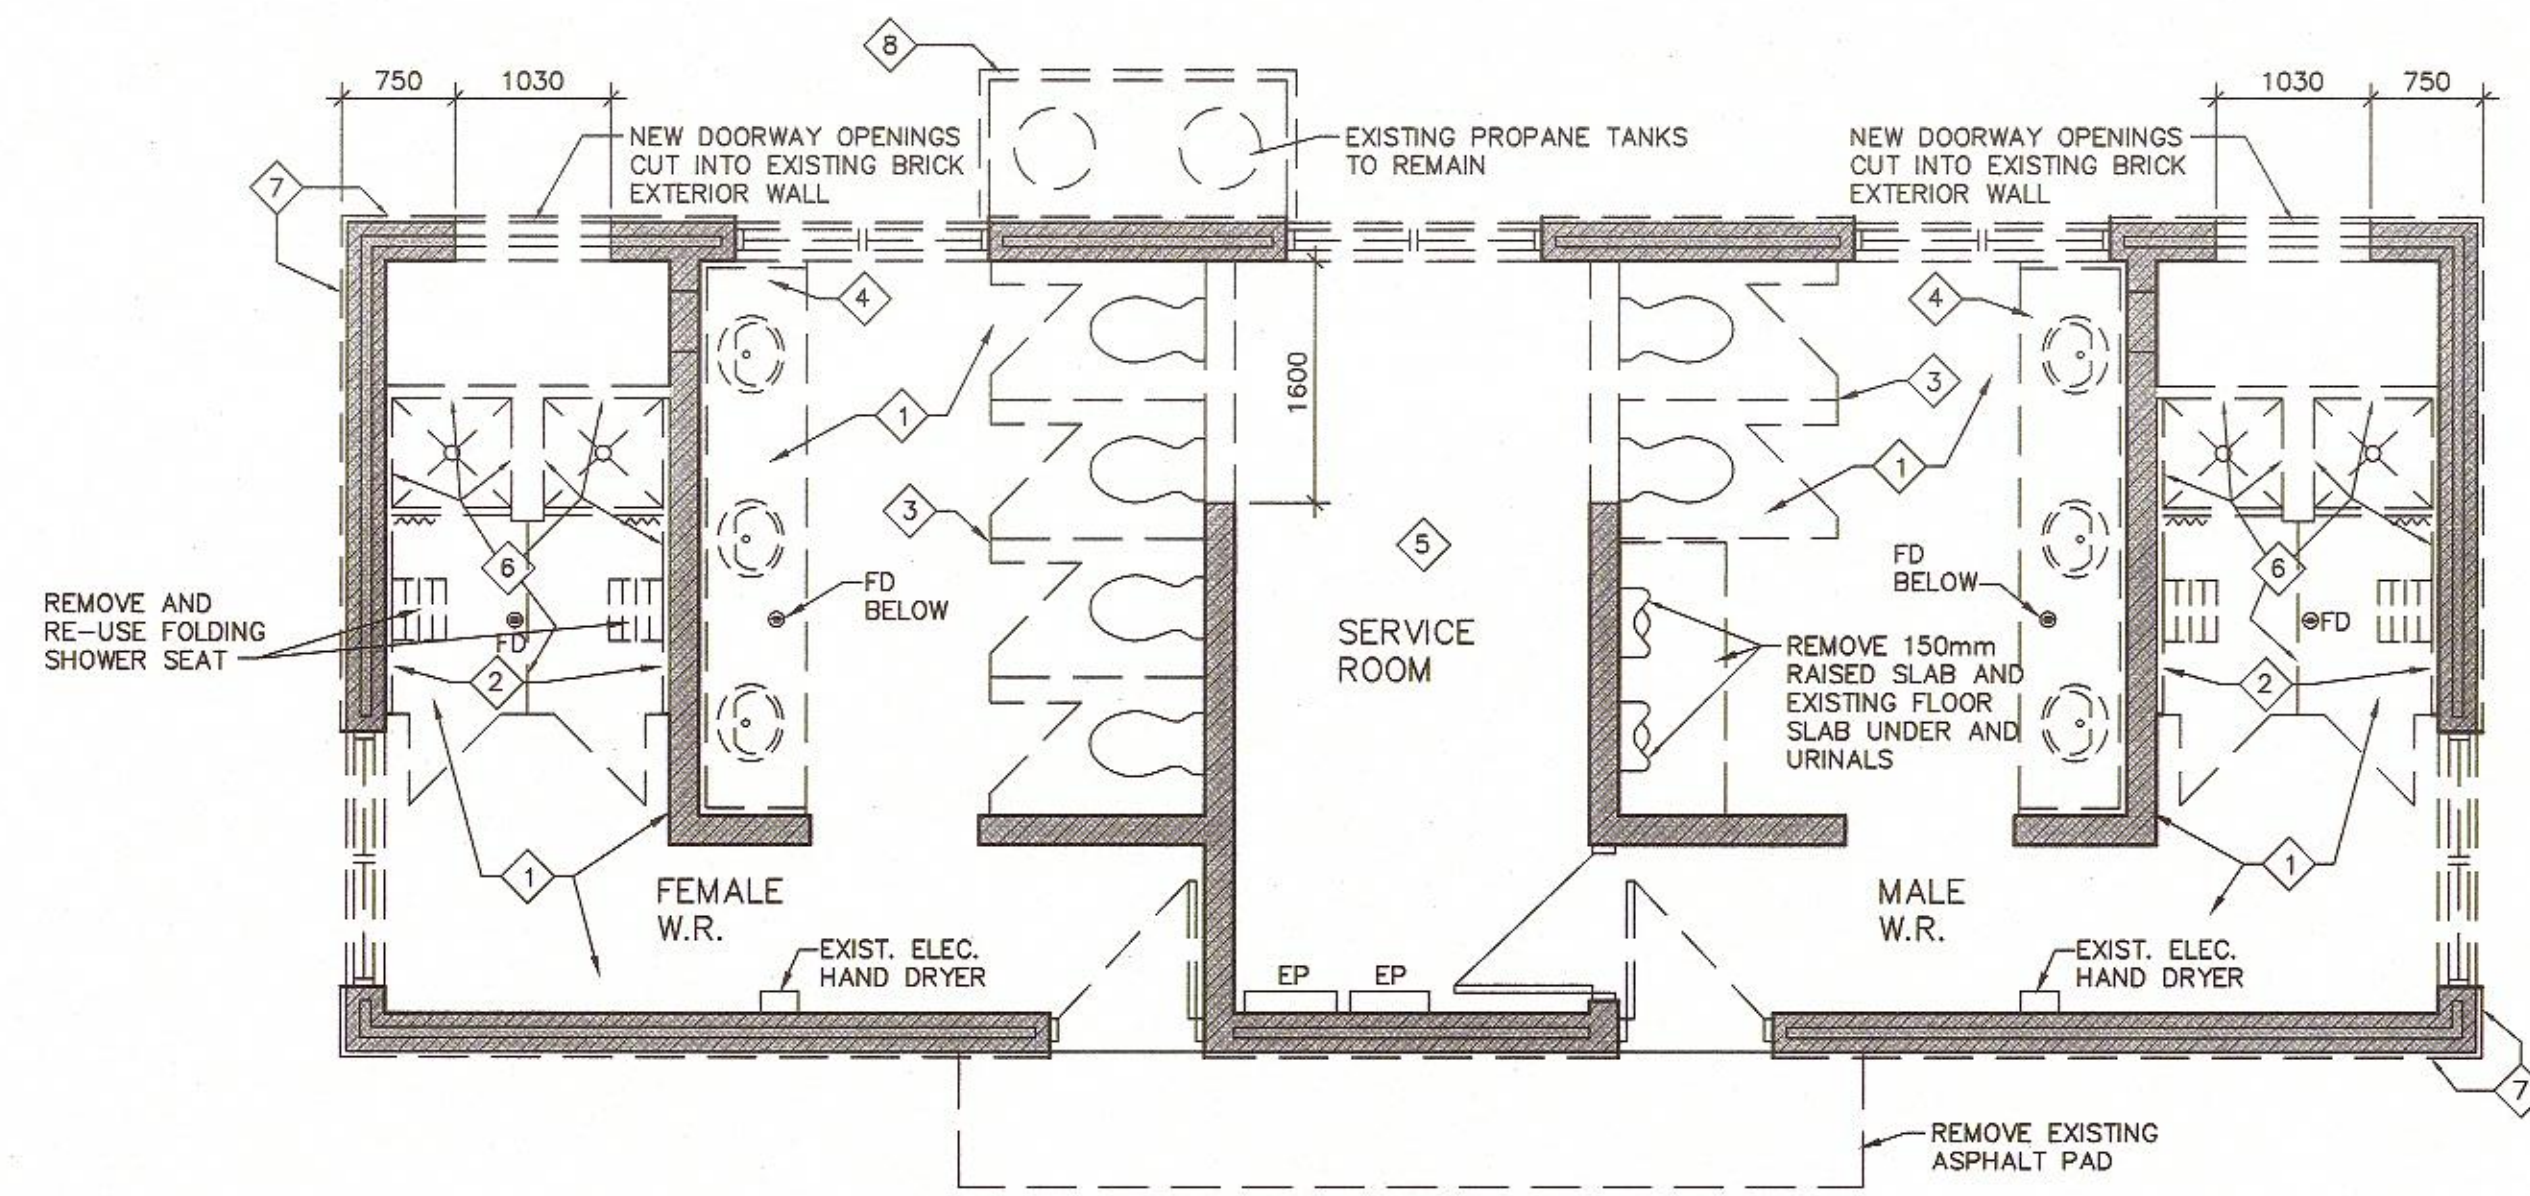

DEMOLITION FLOOR PLAN - W.R. #2

SCALE: 1:50

TOP OF NEW 150mm
CONCRETE SLAB TO BE
FLUSH WITH GRADE
(DOWEL SLAB TO EXISTING
CONCRETE WALL USING
400mmLGx15M REBAR AT
400mm o/c, MINIMUM
150mm EMBED INTO
EXISTING CONCRETE WALL)
PROVIDE 200mm
COMPACTED GRANULAR
FILL UNDER CONCRETE
SLAB

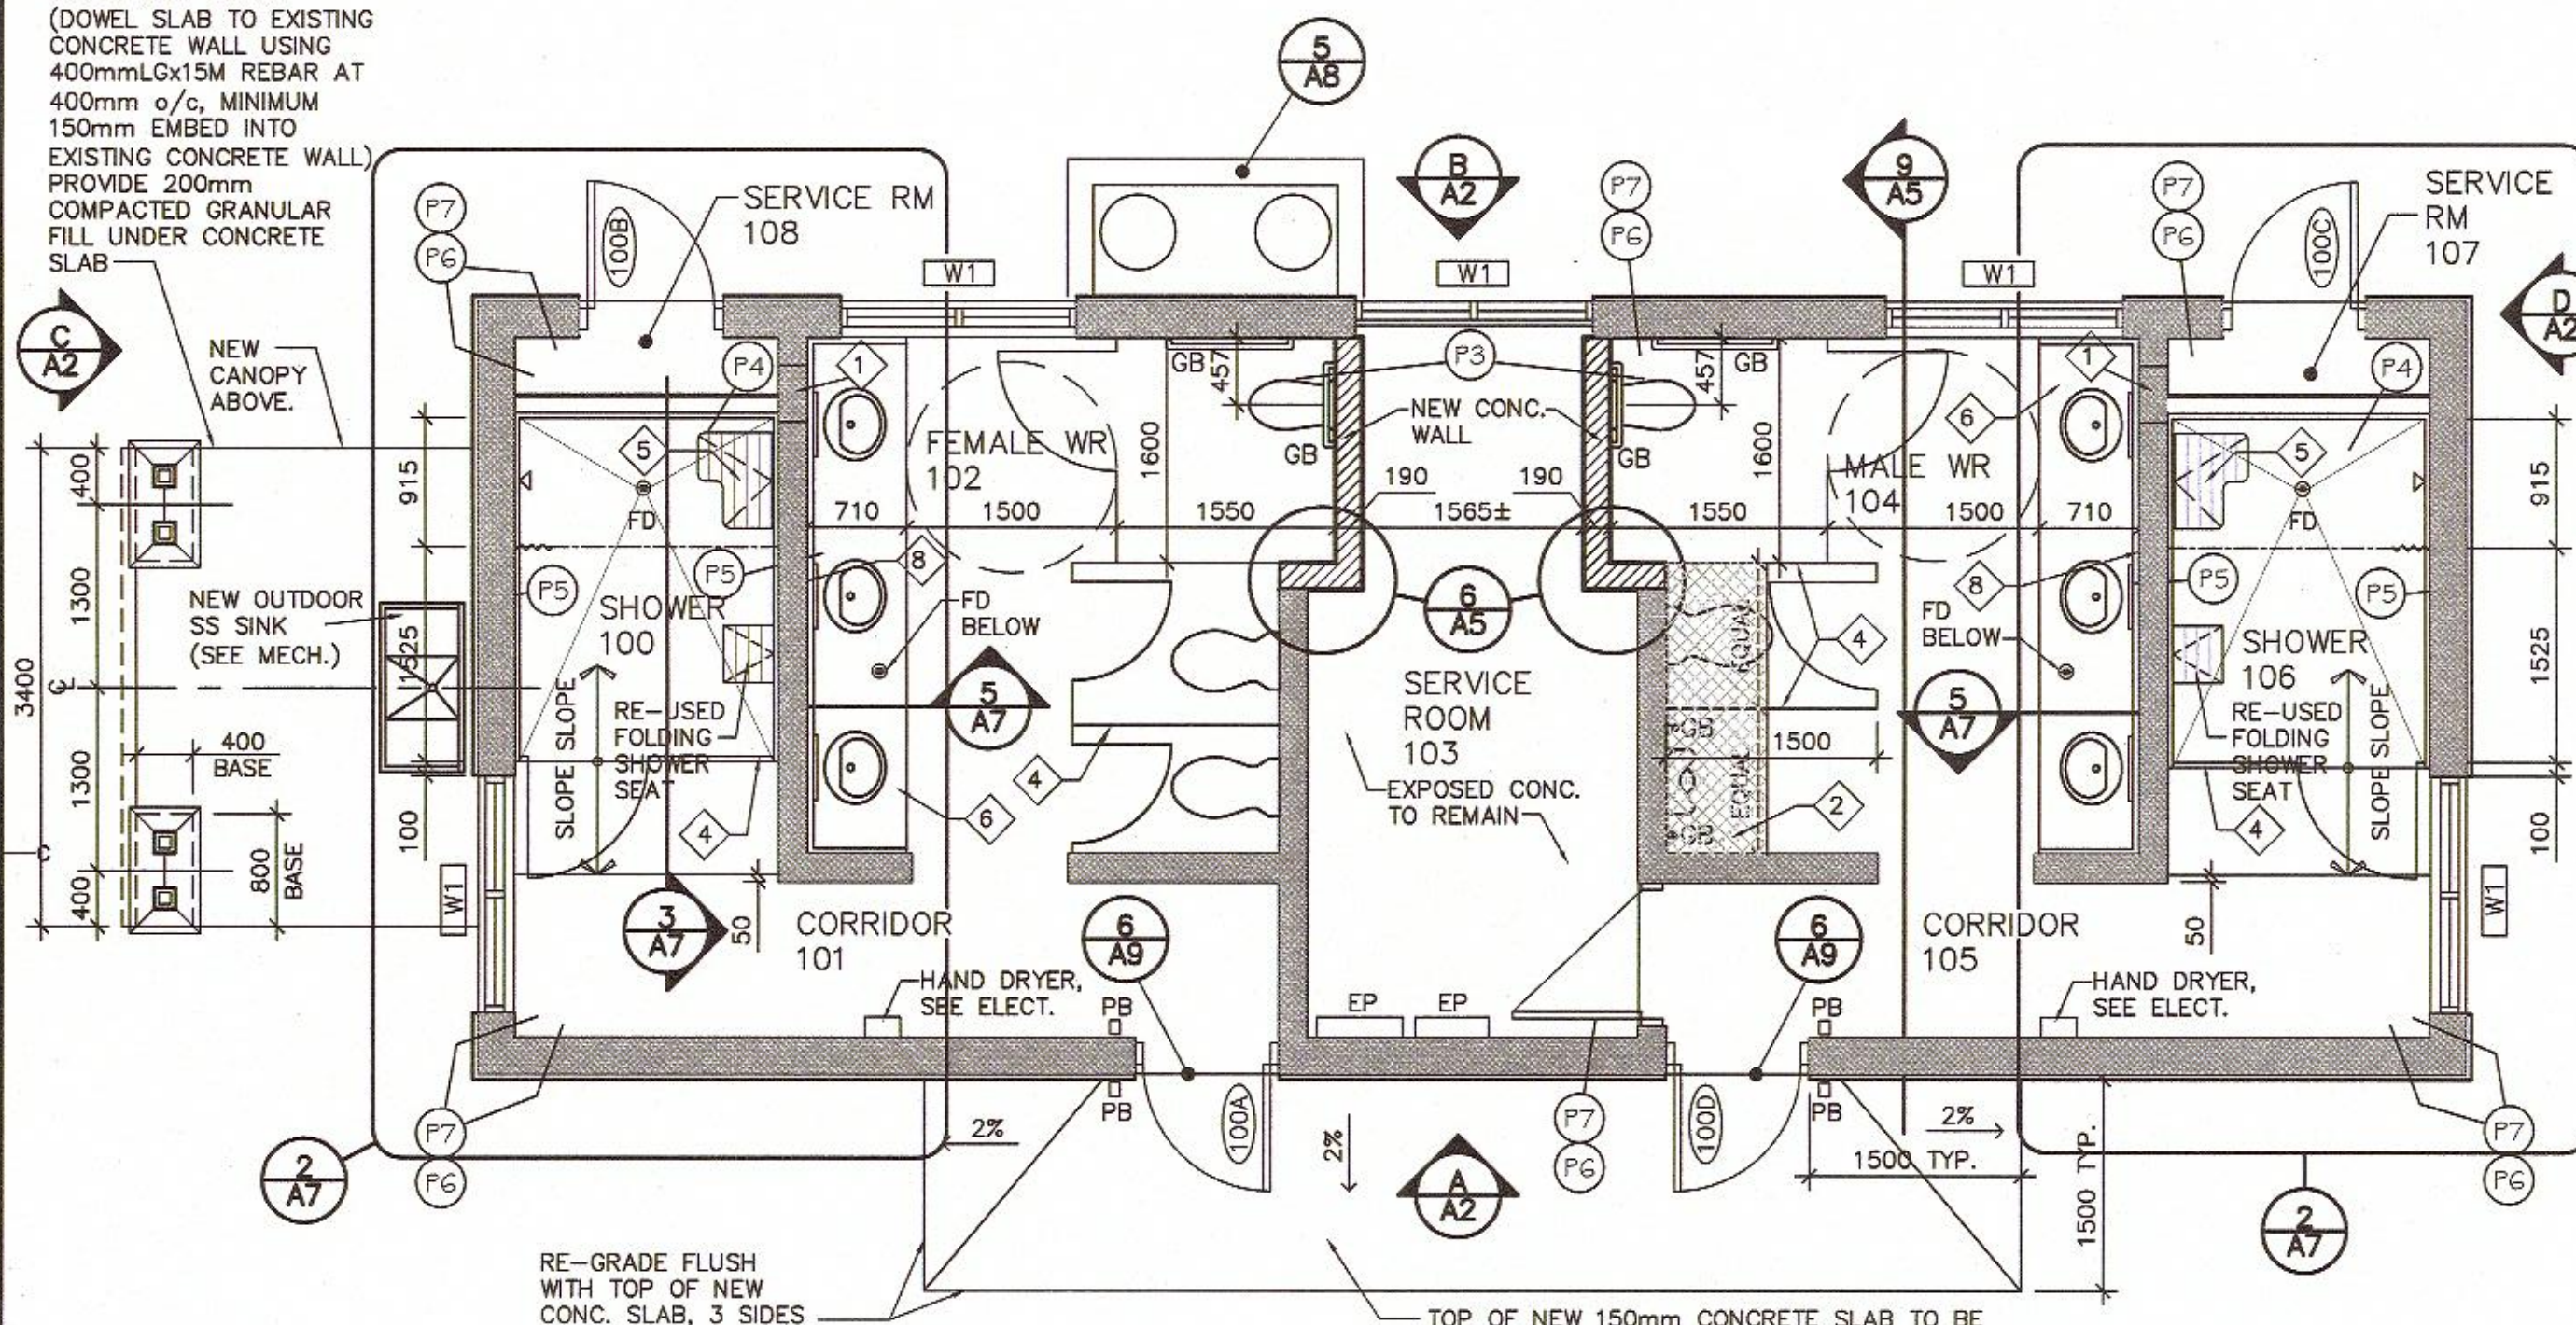

NEW FLOOR PLAN - W.R. #2

SCALE: 1:50

TOP OF NEW 150mm CONCRETE SLAB TO BE
FLUSH AT DOORWAYS FOR BARRIER FREE
ENTRANCE (DOWEL SLAB TO EXISTING
CONCRETE WALL USING 400mmLGx15M
REBAR AT 400mm o/c, MINIMUM 150mm
EMBED INTO EXISTING CONCRETE WALL)
PROVIDE 200mm COMPACTED GRANULAR
FILL UNDER CONCRETE SLAB

GENERAL NOTES

1. REPORT ALL EXPOSED INTERIOR BRICK JOINTS TO
NEW CONCAVE MORTAR JOINTS, PAINT ALL BRICK
WITH EPOXY PAINT, REPLACE/REPAIR ALL DAMAGED,
LOOSE OR MISSING BRICK TO MATCH EXISTING
2. INSTALL NEW METAL ROOFING, WOOD SIDING AND
APPLIED STONE AS SHOWN ON ELEVATIONS ON THIS
SHEET.

DEMOLITION PLAN LEGEND:

- EXISTING WALL TO REMAIN.
- EXISTING CONSTRUCTION
SHALL BE REMOVED

SPECIFIC NOTES - DEMOLITION:

1. REMOVE ALL EXISTING FLOOR AND
WALL TILE BASE, CLEAN AND PREP.
SURFACES AS REQUIRED TO RECEIVE
NEW TROWELED ON EPOXY FLOORING
AND FLASH COVE BASE.
2. REMOVE EXISTING F.R.P. PANELING
AND ALL ASSOCIATED FRAMING DOWN
TO BRICK, CLEAN AND PREP.
SURFACE TO RECEIVE NEW TILE.
3. REMOVE EXISTING TOILET PARTITIONS
4. REMOVE EXISTING SINK, COUNTERTOP,
SUB-STRUCTURE AND TILE
BACKSPLASH
5. EXISTING FLOOR & CEILING FINISHES
TO REMAIN
6. REMOVE EXISTING SHOWER STALLS
AND FRP WALL FINISH OVER, CLEAN/
PREP SURFACES AS REQUIRED TO
RECEIVE NEW SHOWER INSTALLATION.
7. REMOVE EXISTING WOOD LAP SIDING
AND TRIM BOARD, WINDOWS,
EXTERIOR DOORS (LEAVE EXISTING
WOOD STRAPPING SIDING BACKUP)
8. REMOVE EXISTING WOOD FRAMED
TANK ENCLOSURE

PLAN LEGEND:

- EXISTING WALL TO REMAIN.
- NEW WALL CONSTRUCTION,
SEE WALL TYPES
- PB PUSH BUTTON (POWER DOOR OPERATOR)
- GB GRAB BARS SEE DET. 11/A5
- FRP FIBER-REINFORCED PLASTIC

SPECIFIC NOTES - NEW:

1. INFILL EXISTING UNDER COUNTER
ACCESS OPENING IN EXISTING BRICK
WALL WITH NEW 190mm CONCRETE
BLOCK
2. PROVIDE NEW 100mm CONCRETE
SLAB AT REMOVED RAISED
CONCRETE URINAL BASE, DOWEL
NEW SLAB TO EXISTING AT 300mm
o/c ALL AROUND UNIT
150x200mmLG REBAR, MIN. 100mm
EMBED INTO EXISTING SLAB
3. NOT USED.
4. NEW PHENOLIC TOILET AND SHOWER
PARTITIONS, SEE SPECS
5. NEW FOLD DOWN SHOWER SEATS,
(1) PER SHOWER.
6. NEW SOLID SURFACE COUNTERTOPS
AND BACKSPLASH, SEE DETAIL
7. NEW SOLID SURFACE WALL PANELING
8. REMOVE EXISTING F.R.P. PANEL
FINISH ABOVE VANITIES, CLEAN
BRICK FACE OF PANEL
GLUE/FASTENERS, RE-POINT BRICK
WITH CONCAVE JOINTS AND
PRIM/PAINT FINISH

NEW CEILING PLAN LEGEND:


- NEW LIGHT FIXTURE, SEE ELECT.
- NEW DIFFUSER, SEE MECH

GENERAL NOTES

1. SEE MECHANICAL AND ELECTRICAL
DRAWINGS FOR EXTENT OF THEIR WORK


SPECIFIC NOTES - NEW:

1. REMOVE EXIST. F.R.P. PANEL CEILING
AND AT DROP WOOD BEAM COVER
FINISH, CLEAN AND PREP EXISTING
SUBSTRATE SURFACE, INSTALL NEW
13mm GLASSWAT SHEETING OVER
SUBSTRATE CEILING AND BEAMS,
TAPED AND FILLED, AND PAINT
FINISH

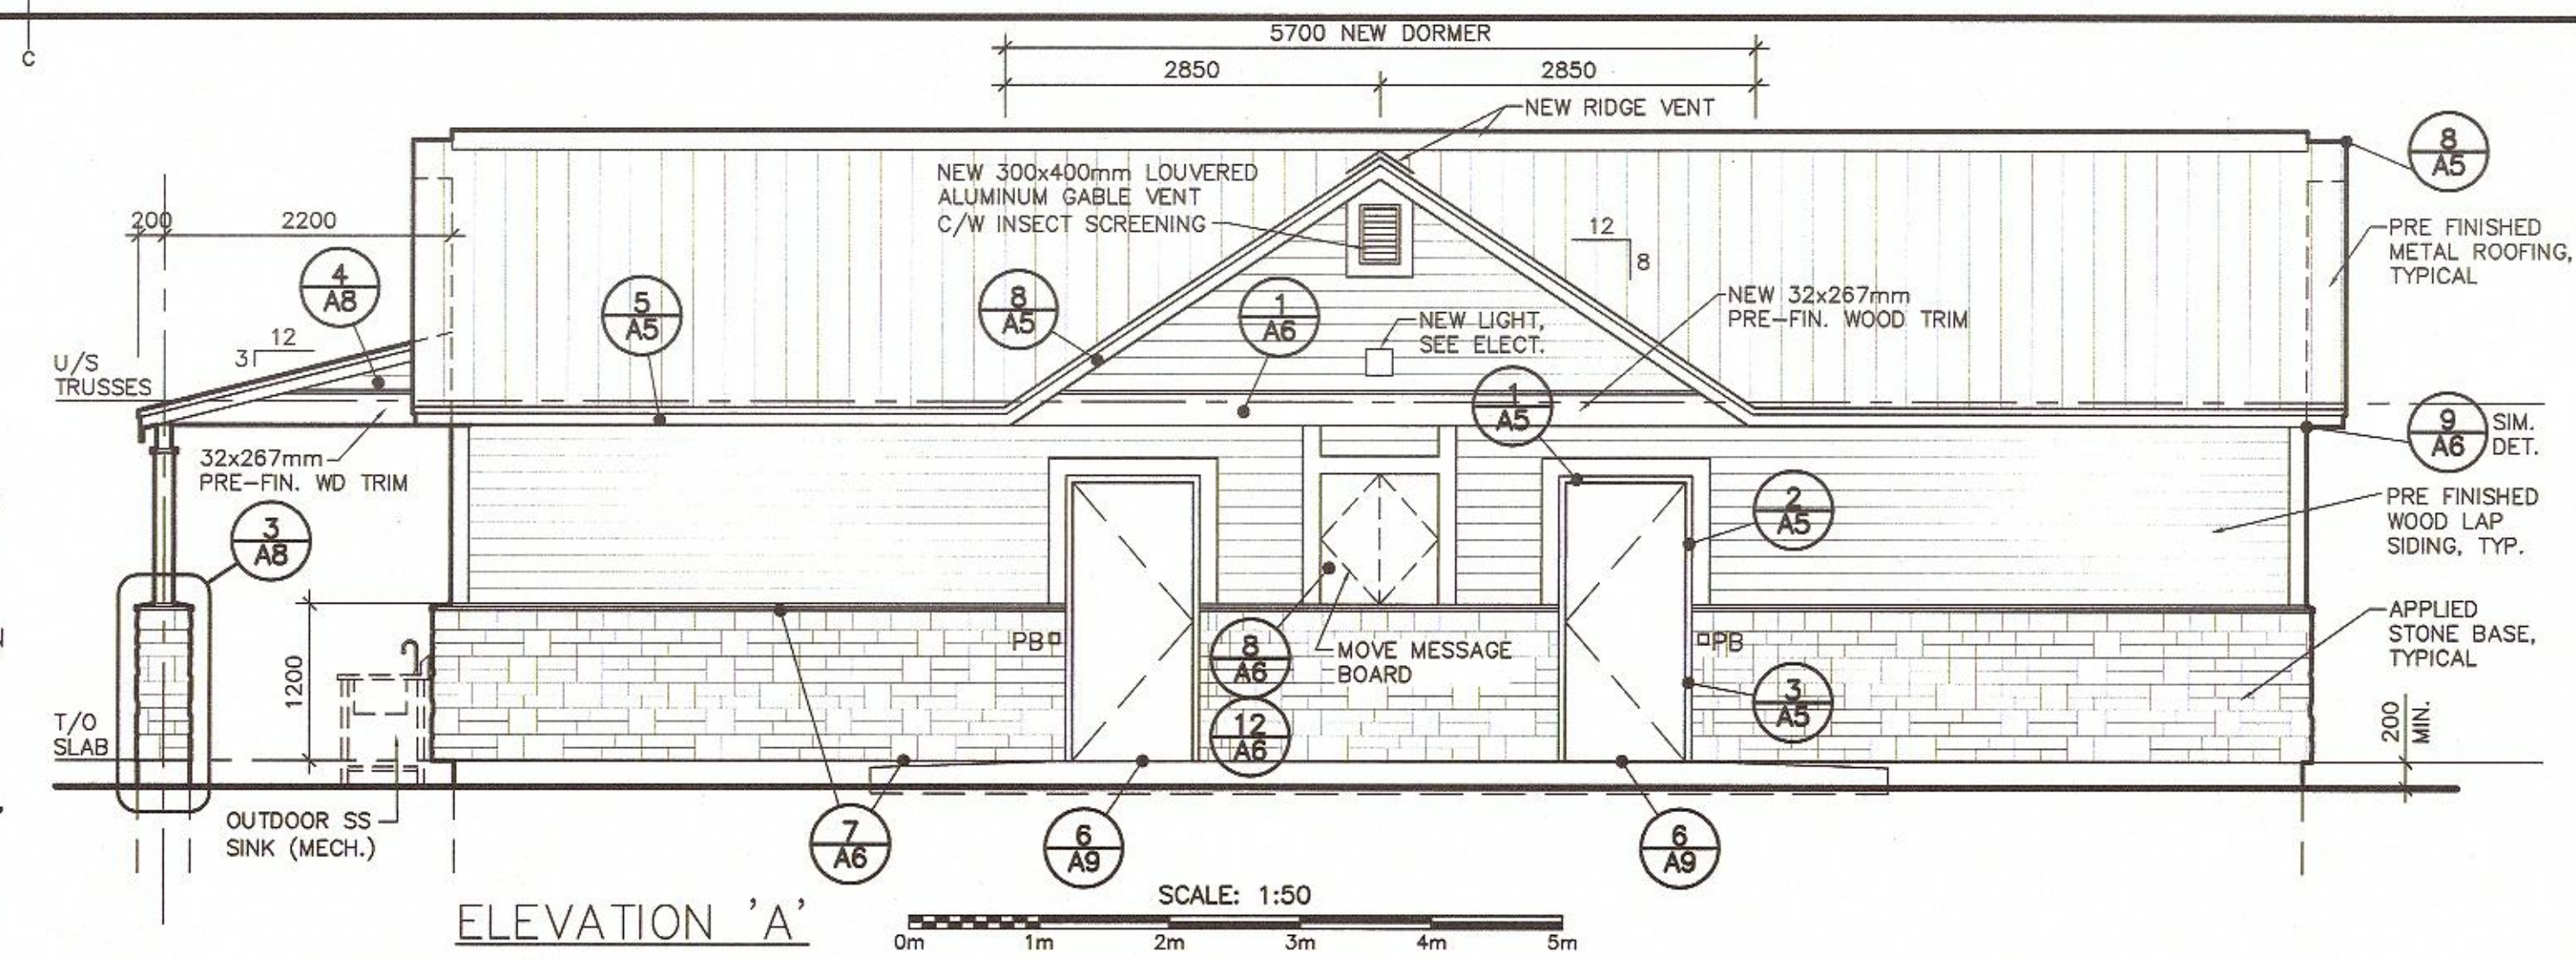


ELEVATION 'A'

SCALE: 1:50

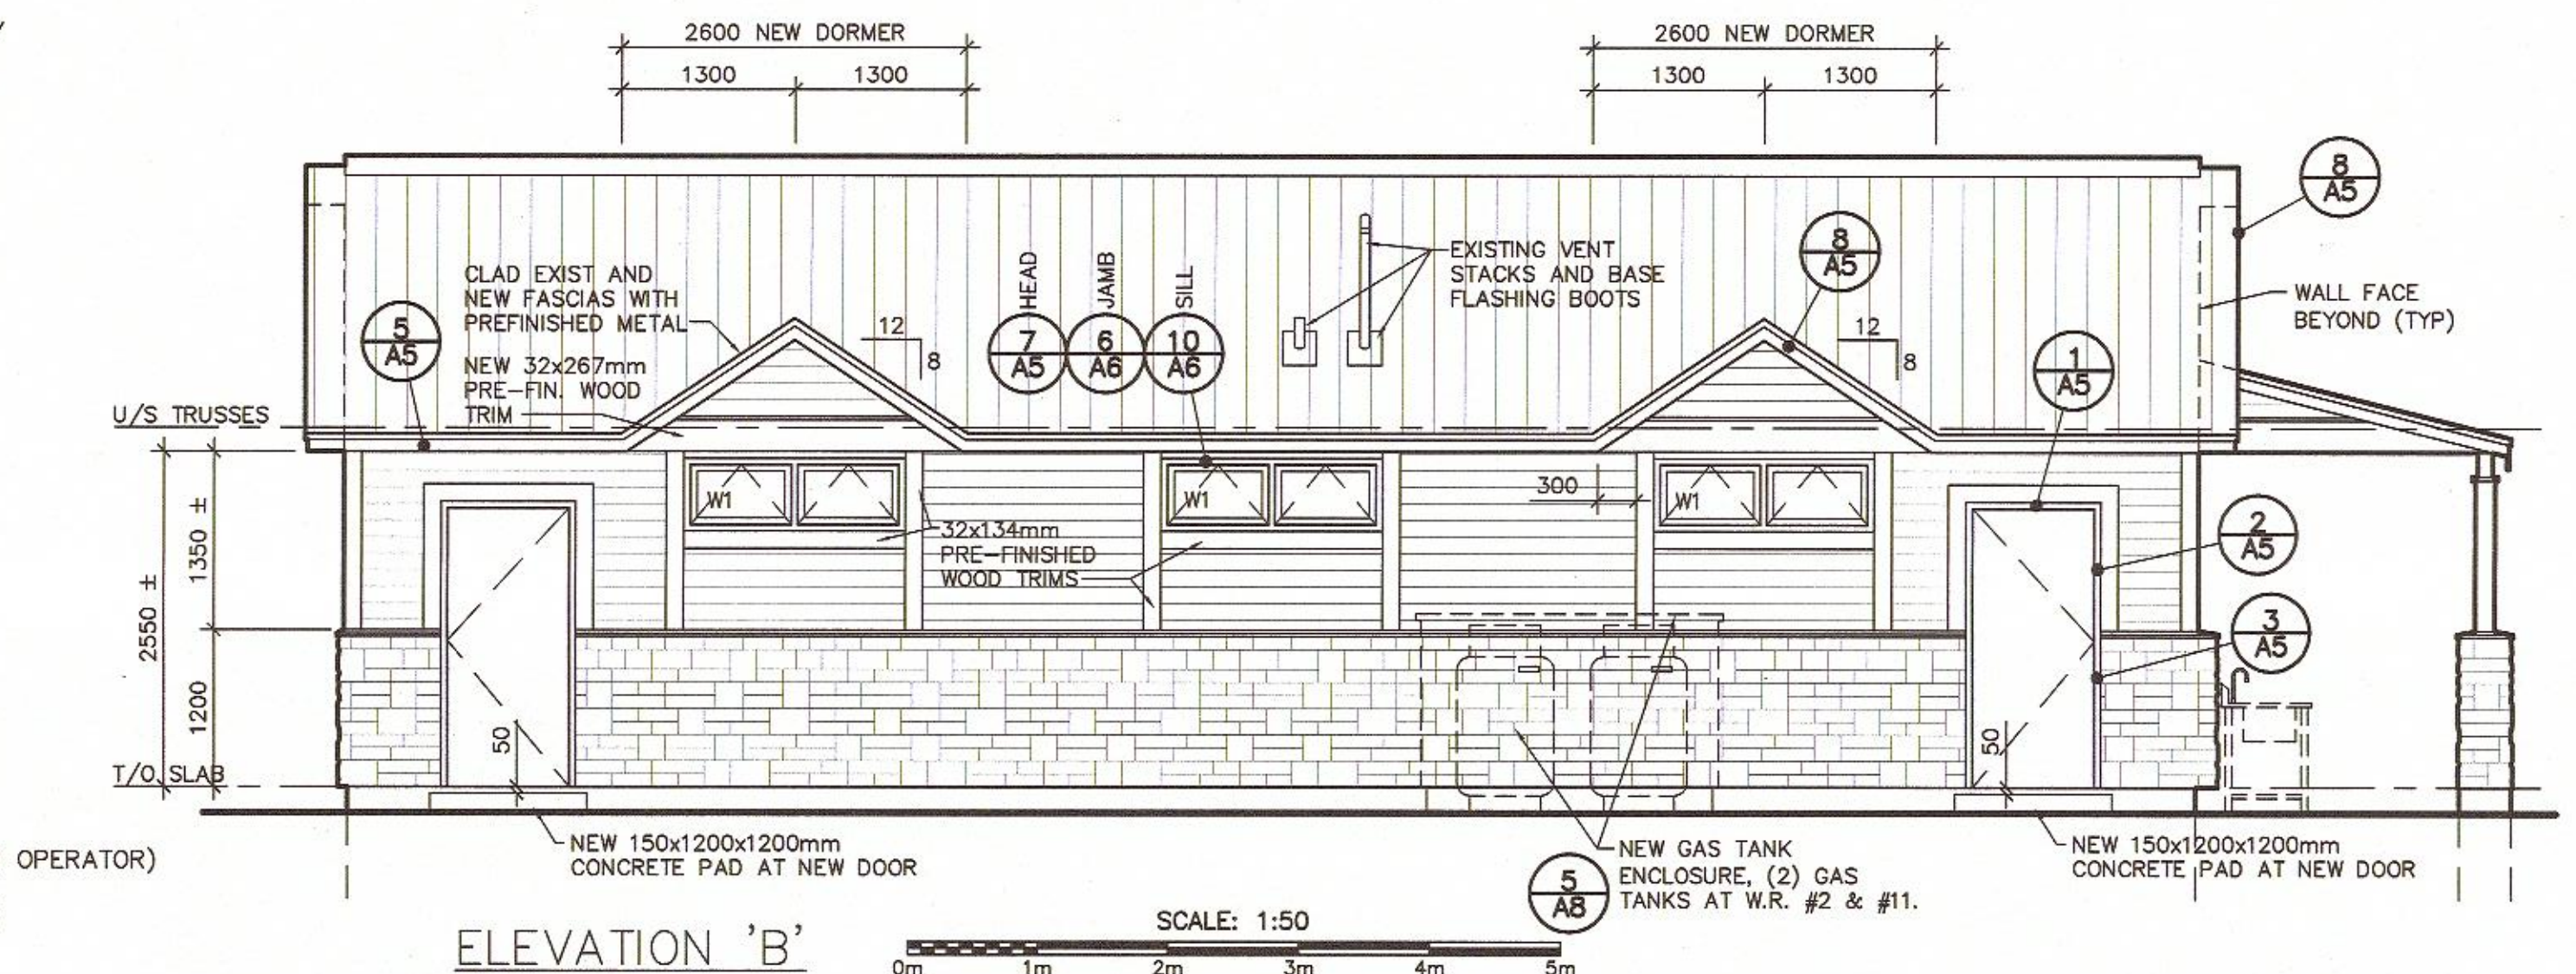

ELEVATION 'B'

SCALE: 1:50

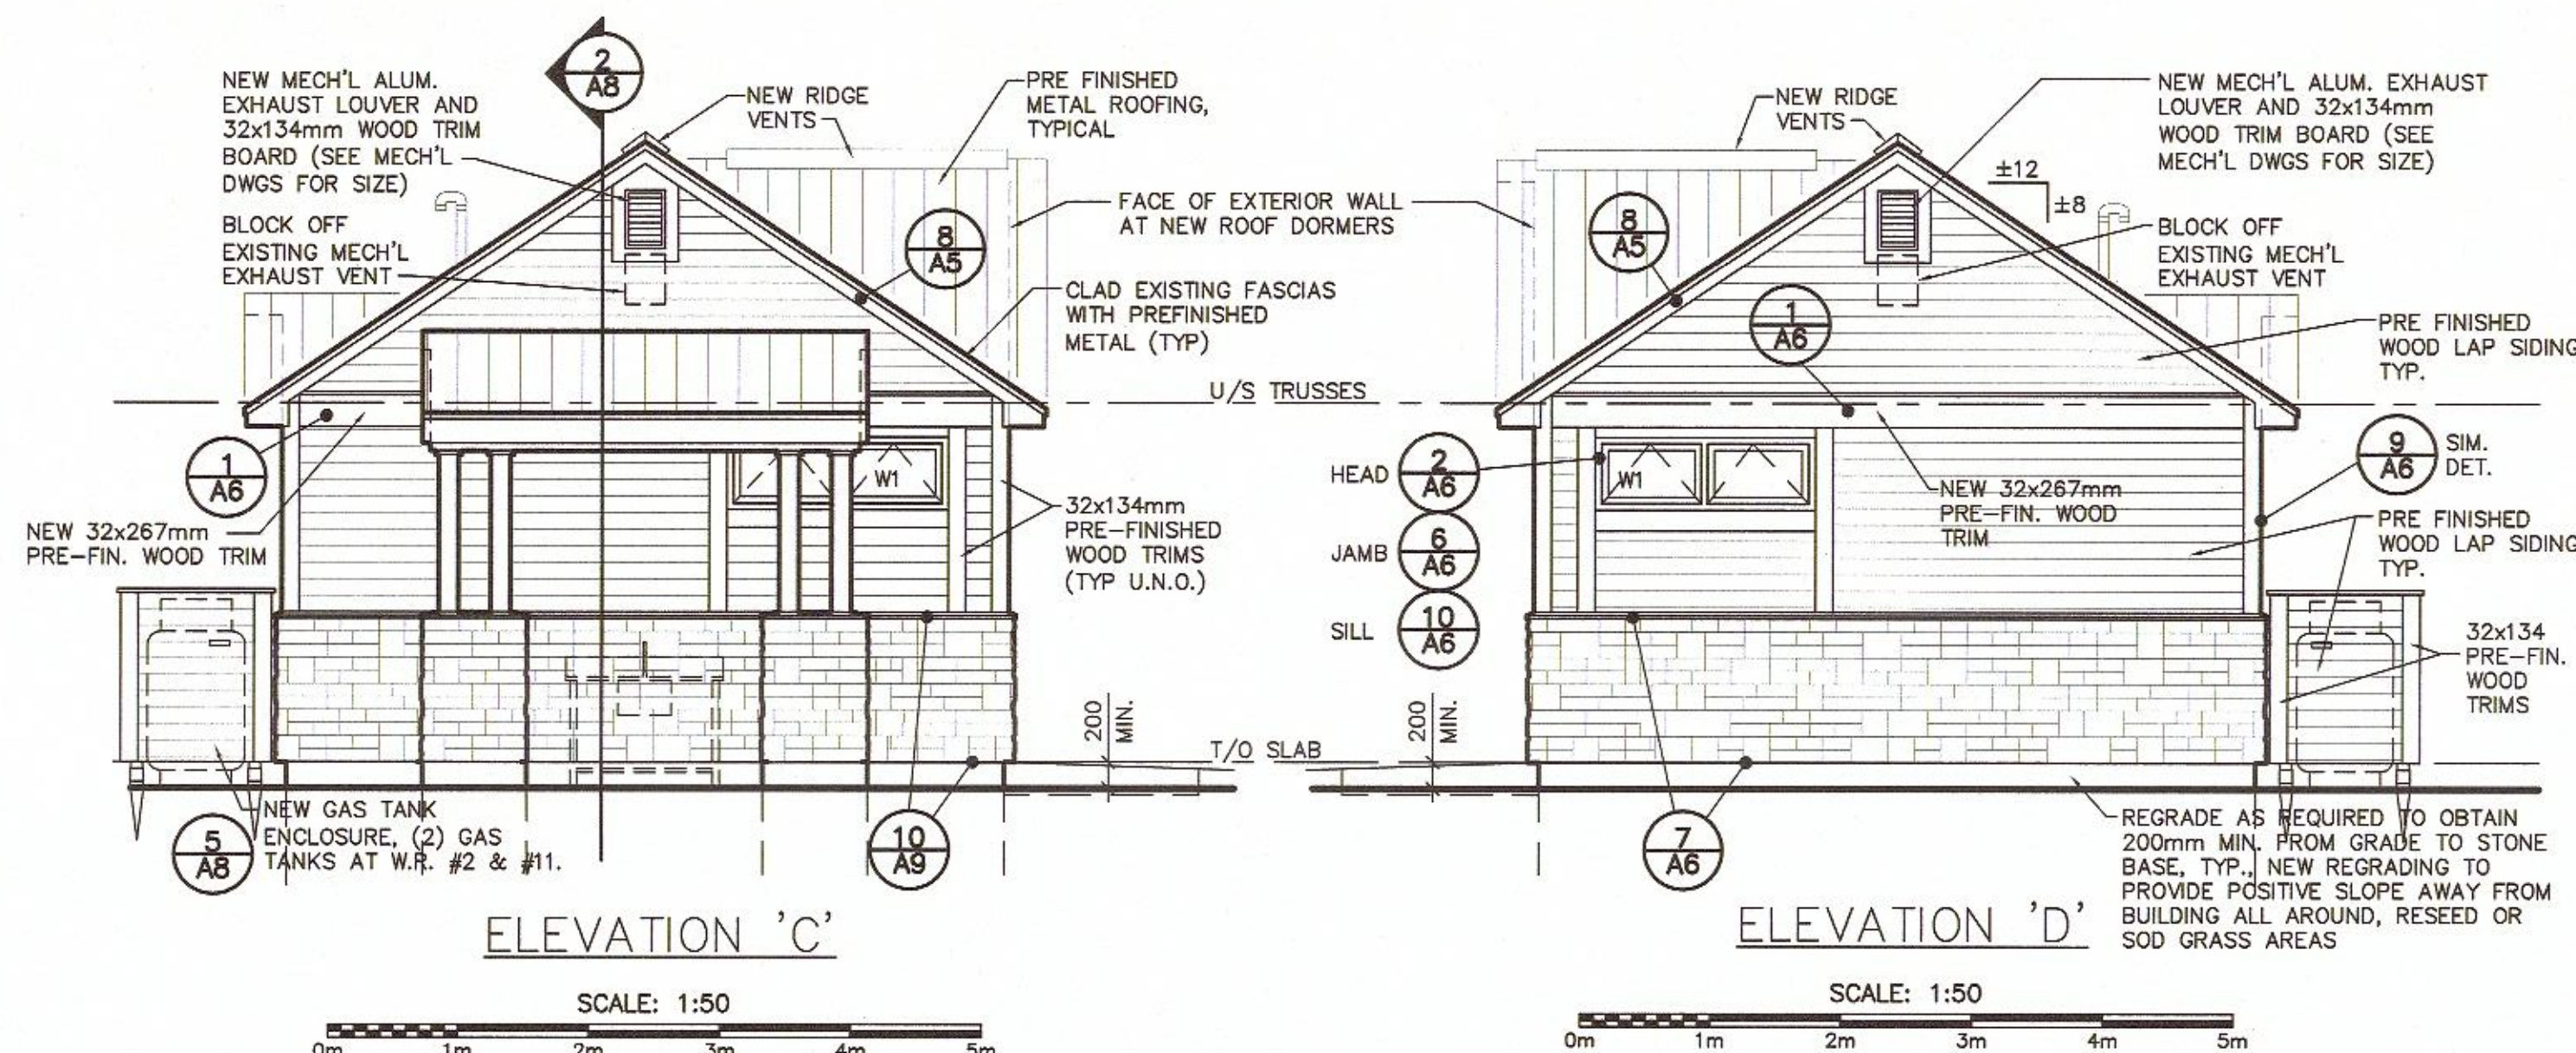


ELEVATION 'C'

SCALE: 1:50


ELEVATION 'D'

SCALE: 1:50

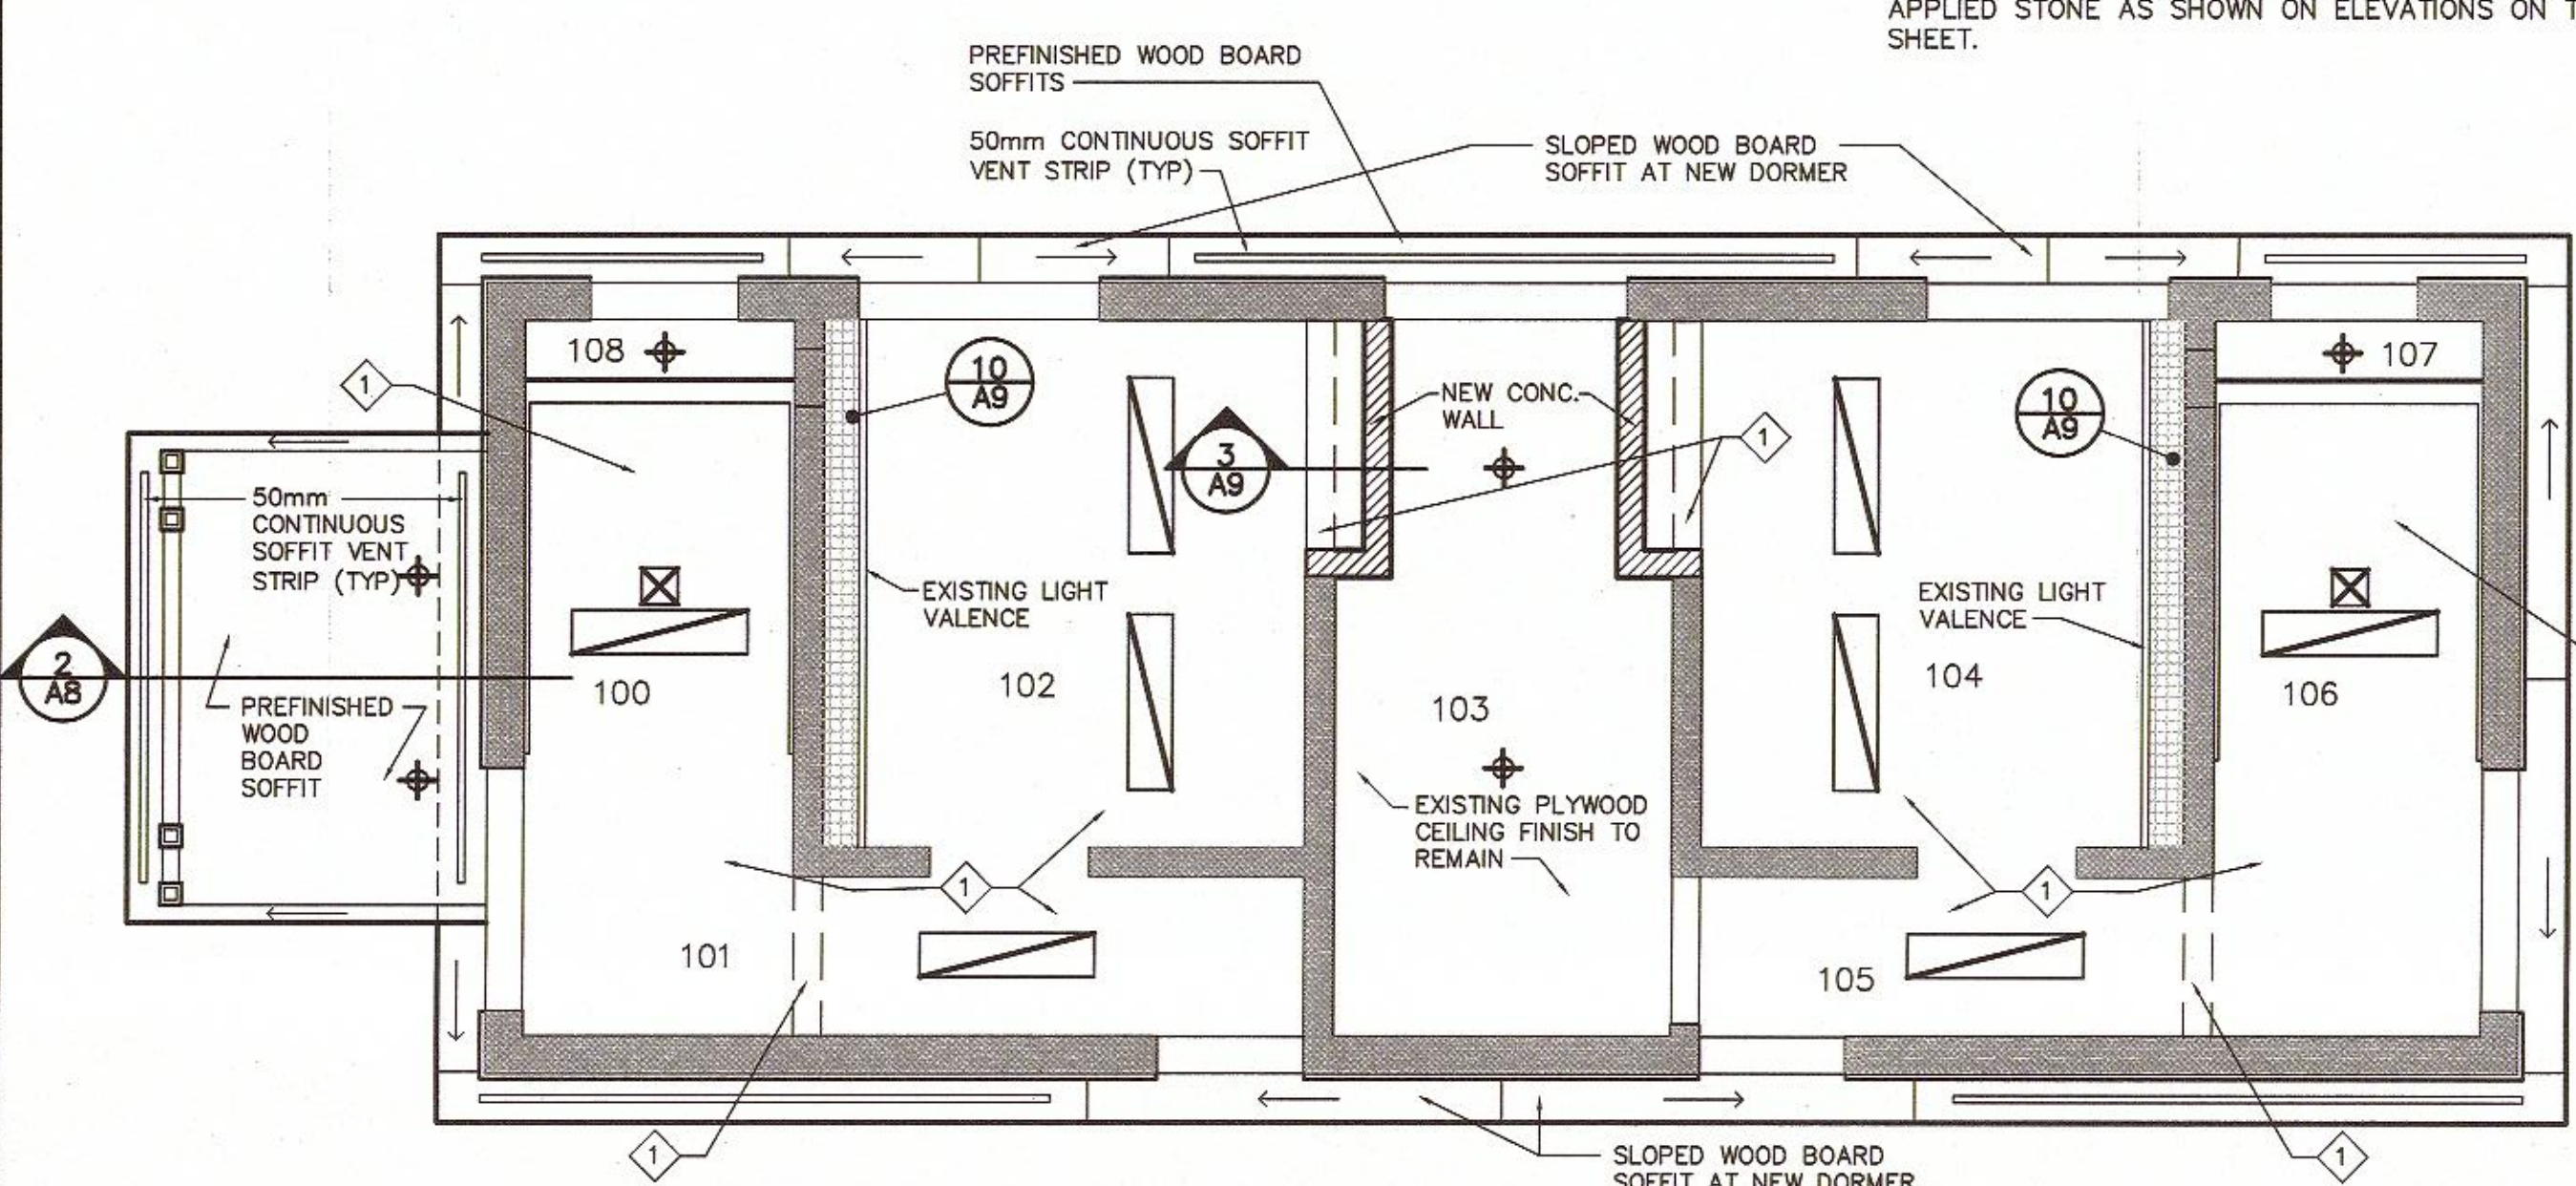

NEW REFLECTED CEILING PLAN - W.R. #2

SCALE: 1:50

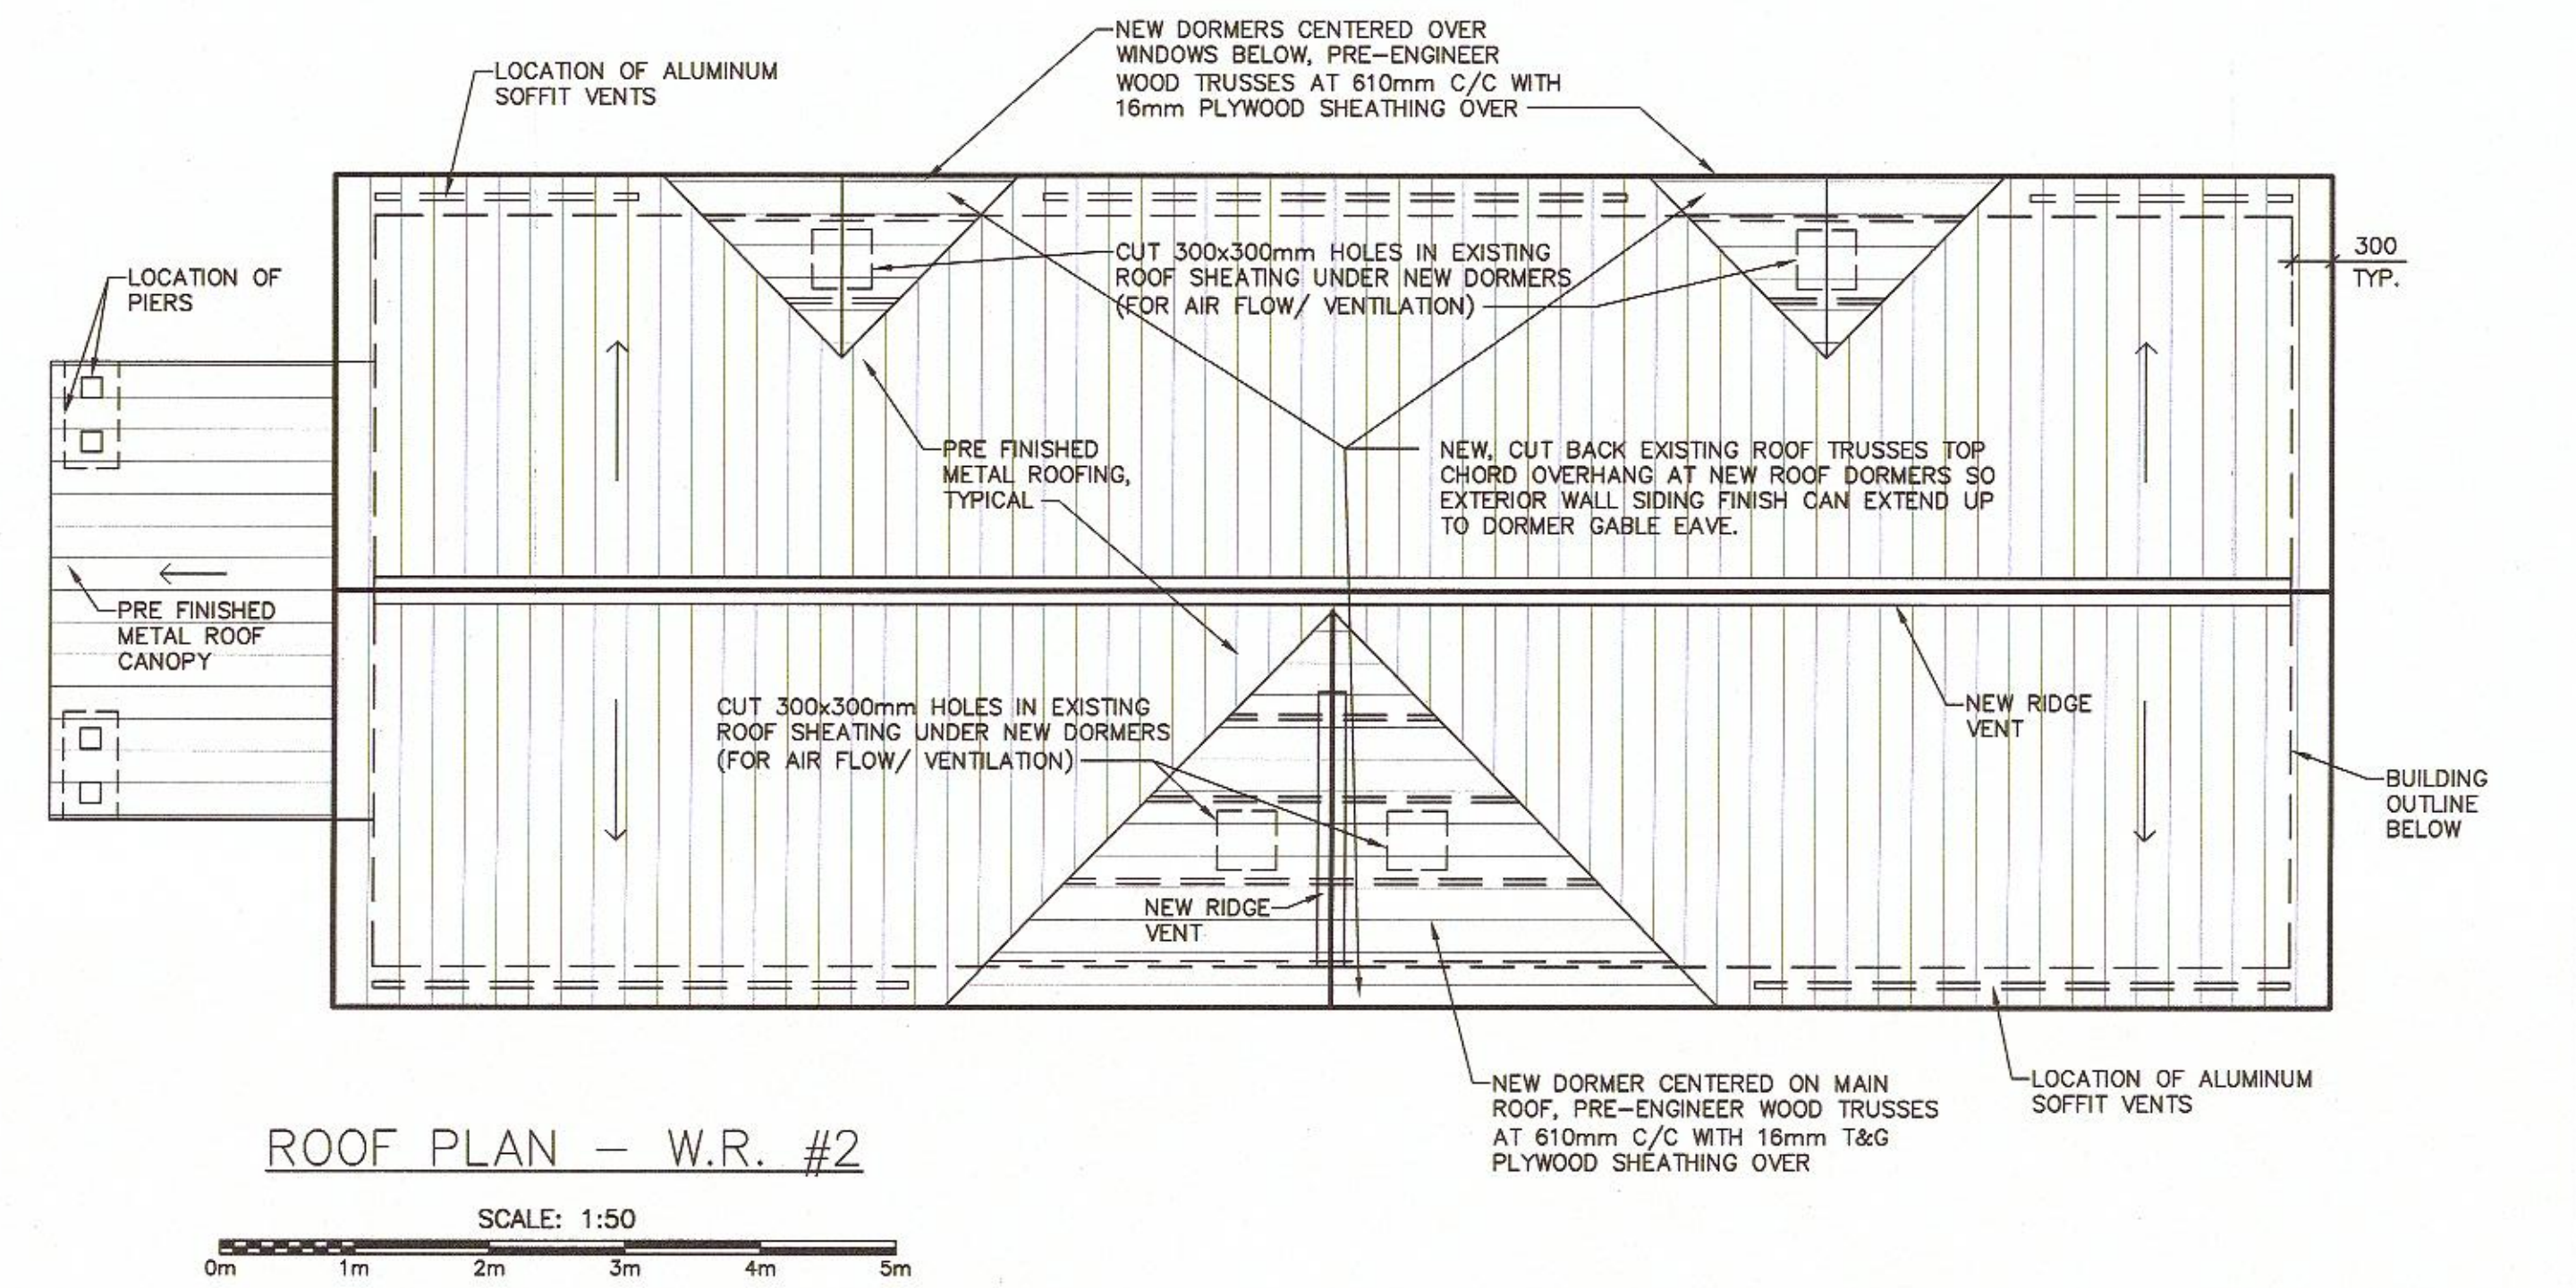

ROOF PLAN - W.R. #2

SCALE: 1:50