



FLOOR PLAN – W.R. #2

SCALE: 1:50
0m 1m 2m 3m 4m 5m

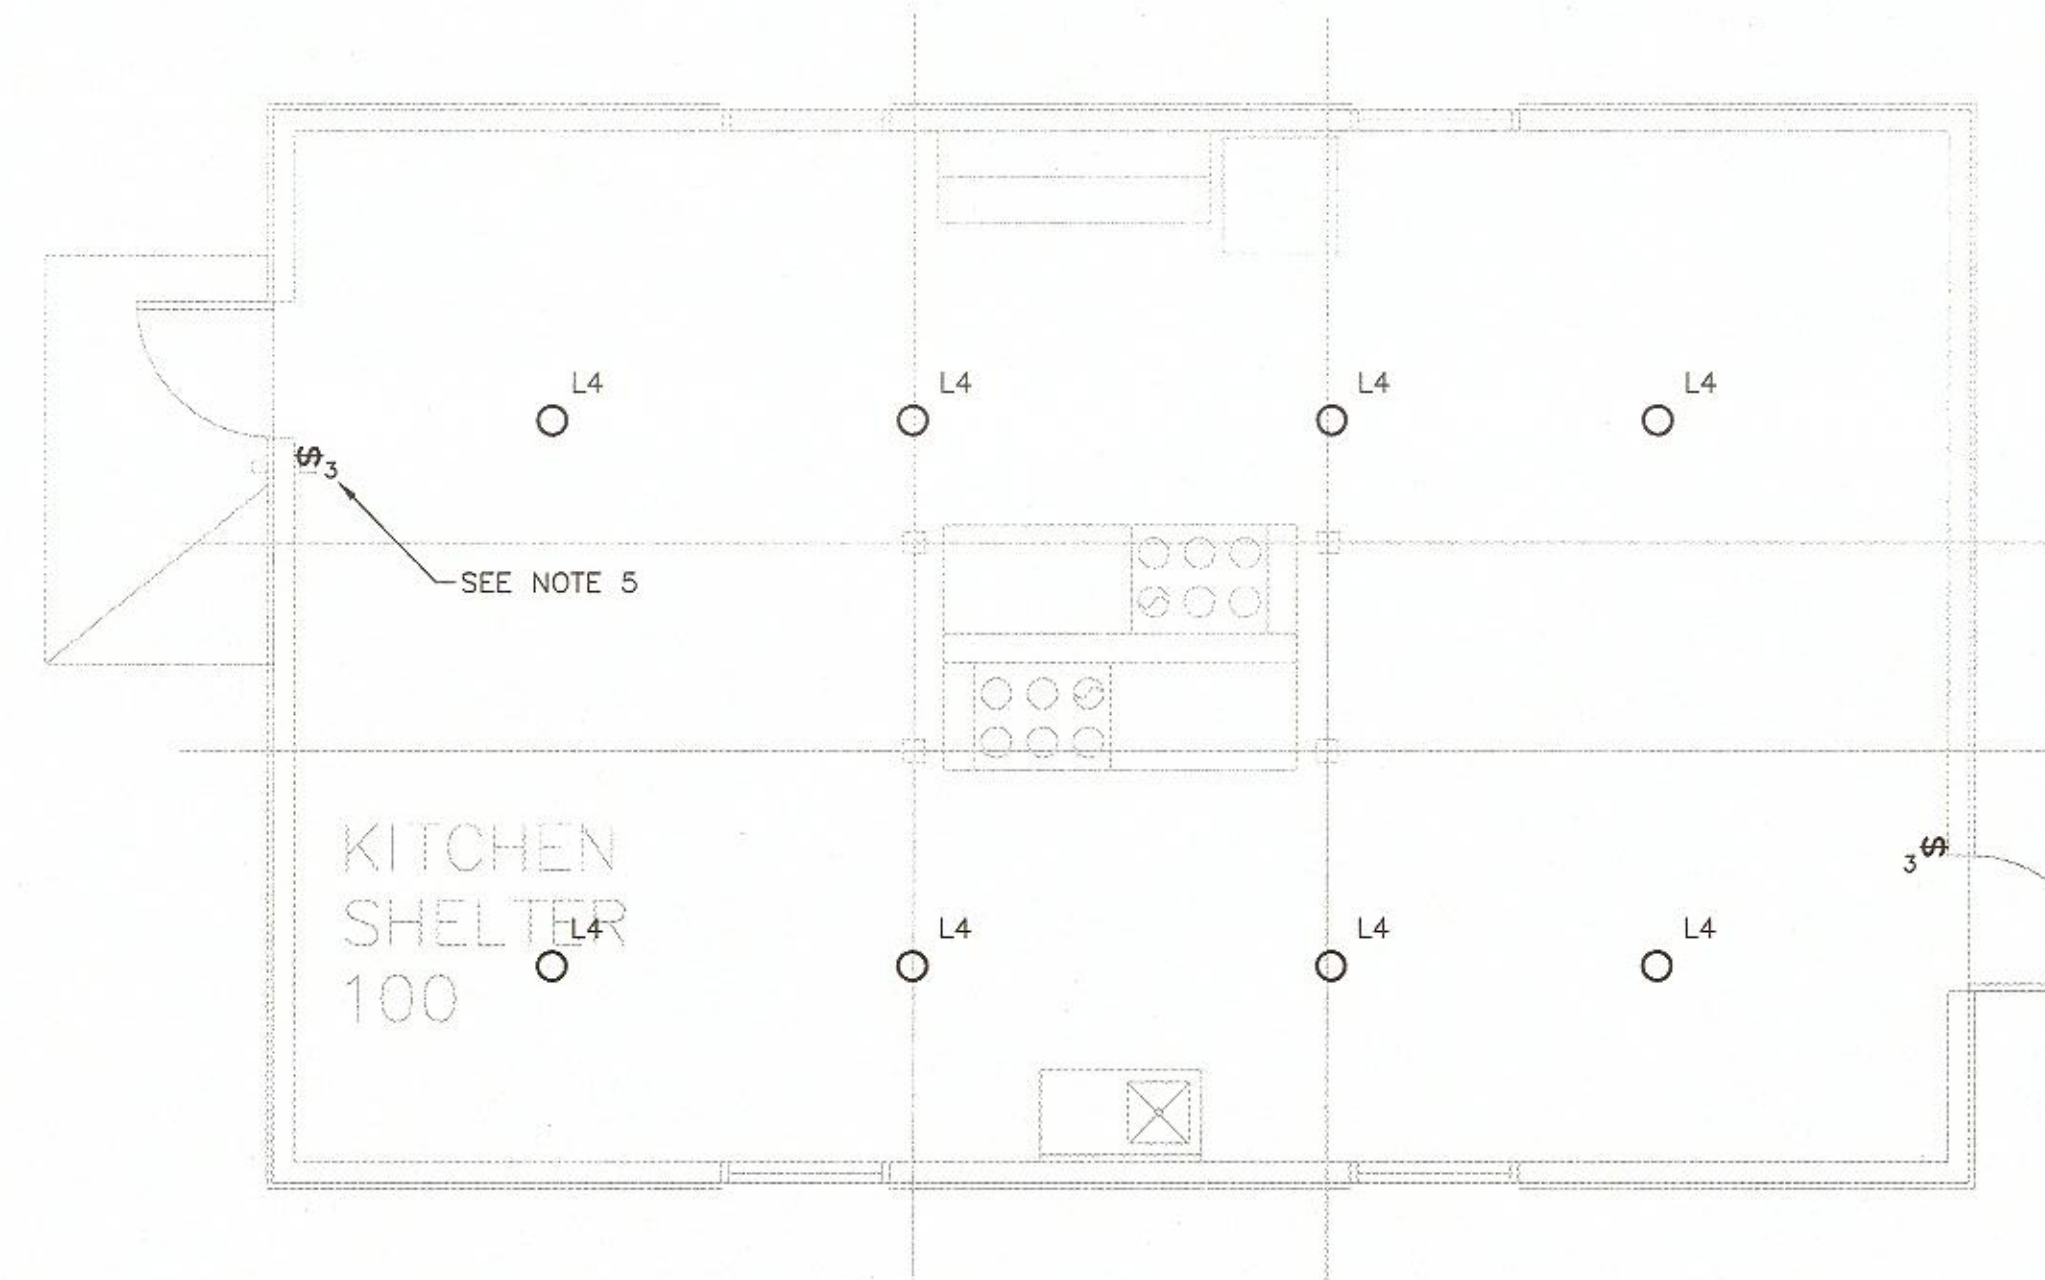


FLOOR PLAN – KITCHEN SHELTER #3

SCALE: 1:50
0m 1m 2m 3m 4m 5m

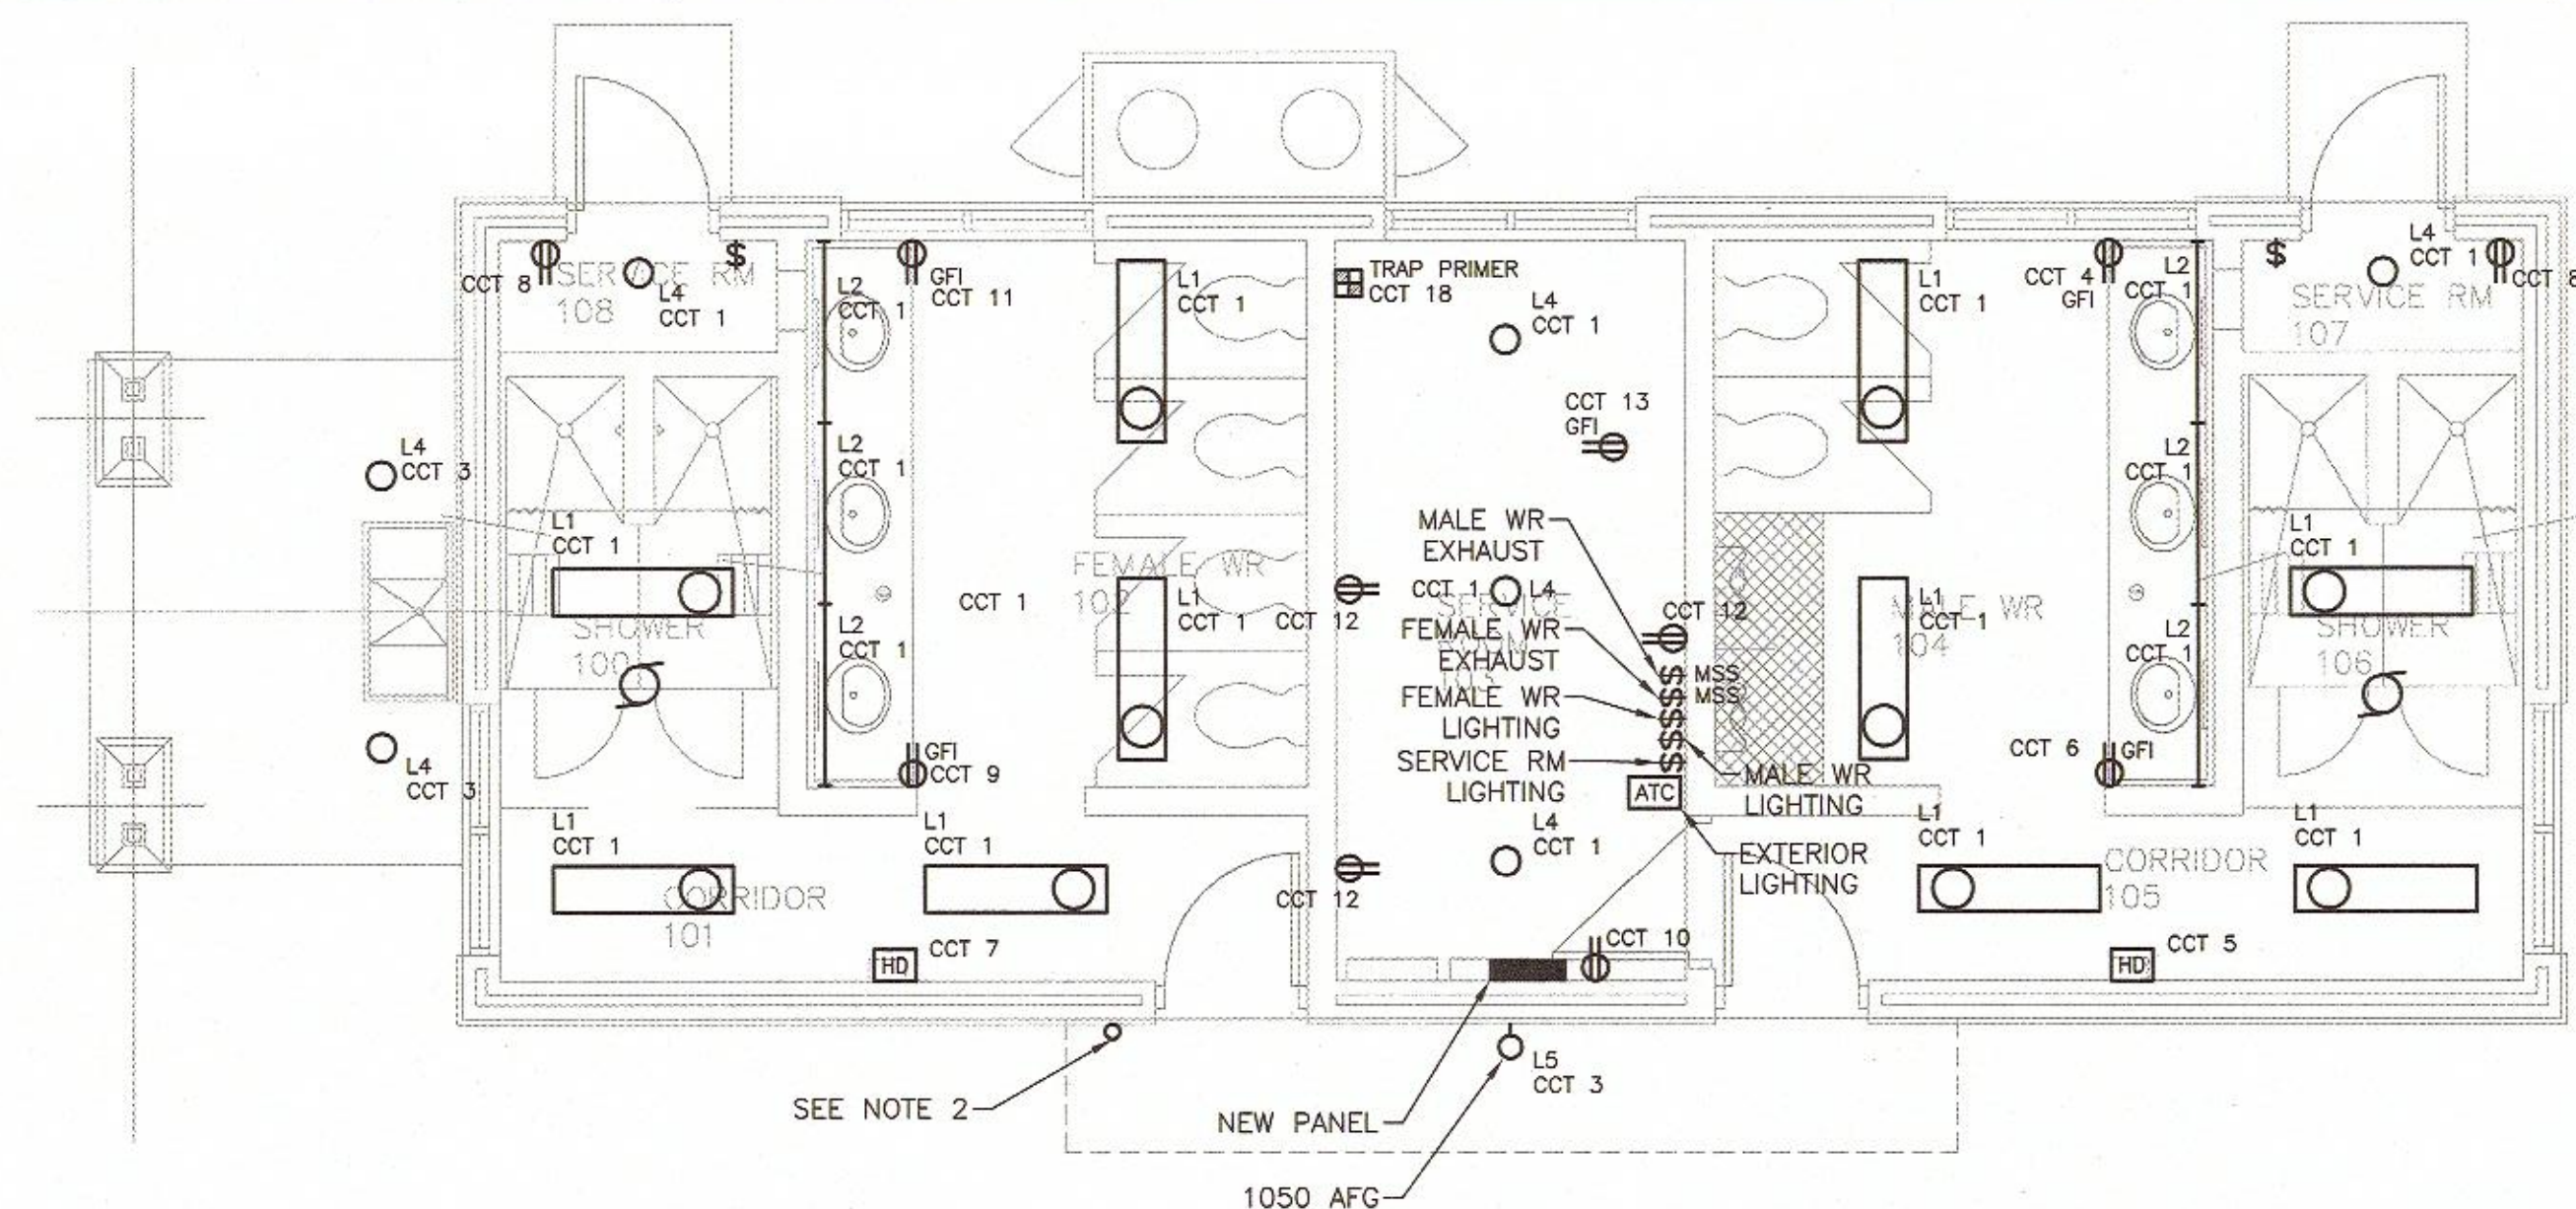


TYP. FLOOR PLAN – W.R. #4, 7 & 11

SCALE: 1:50
0m 1m 2m 3m 4m 5m

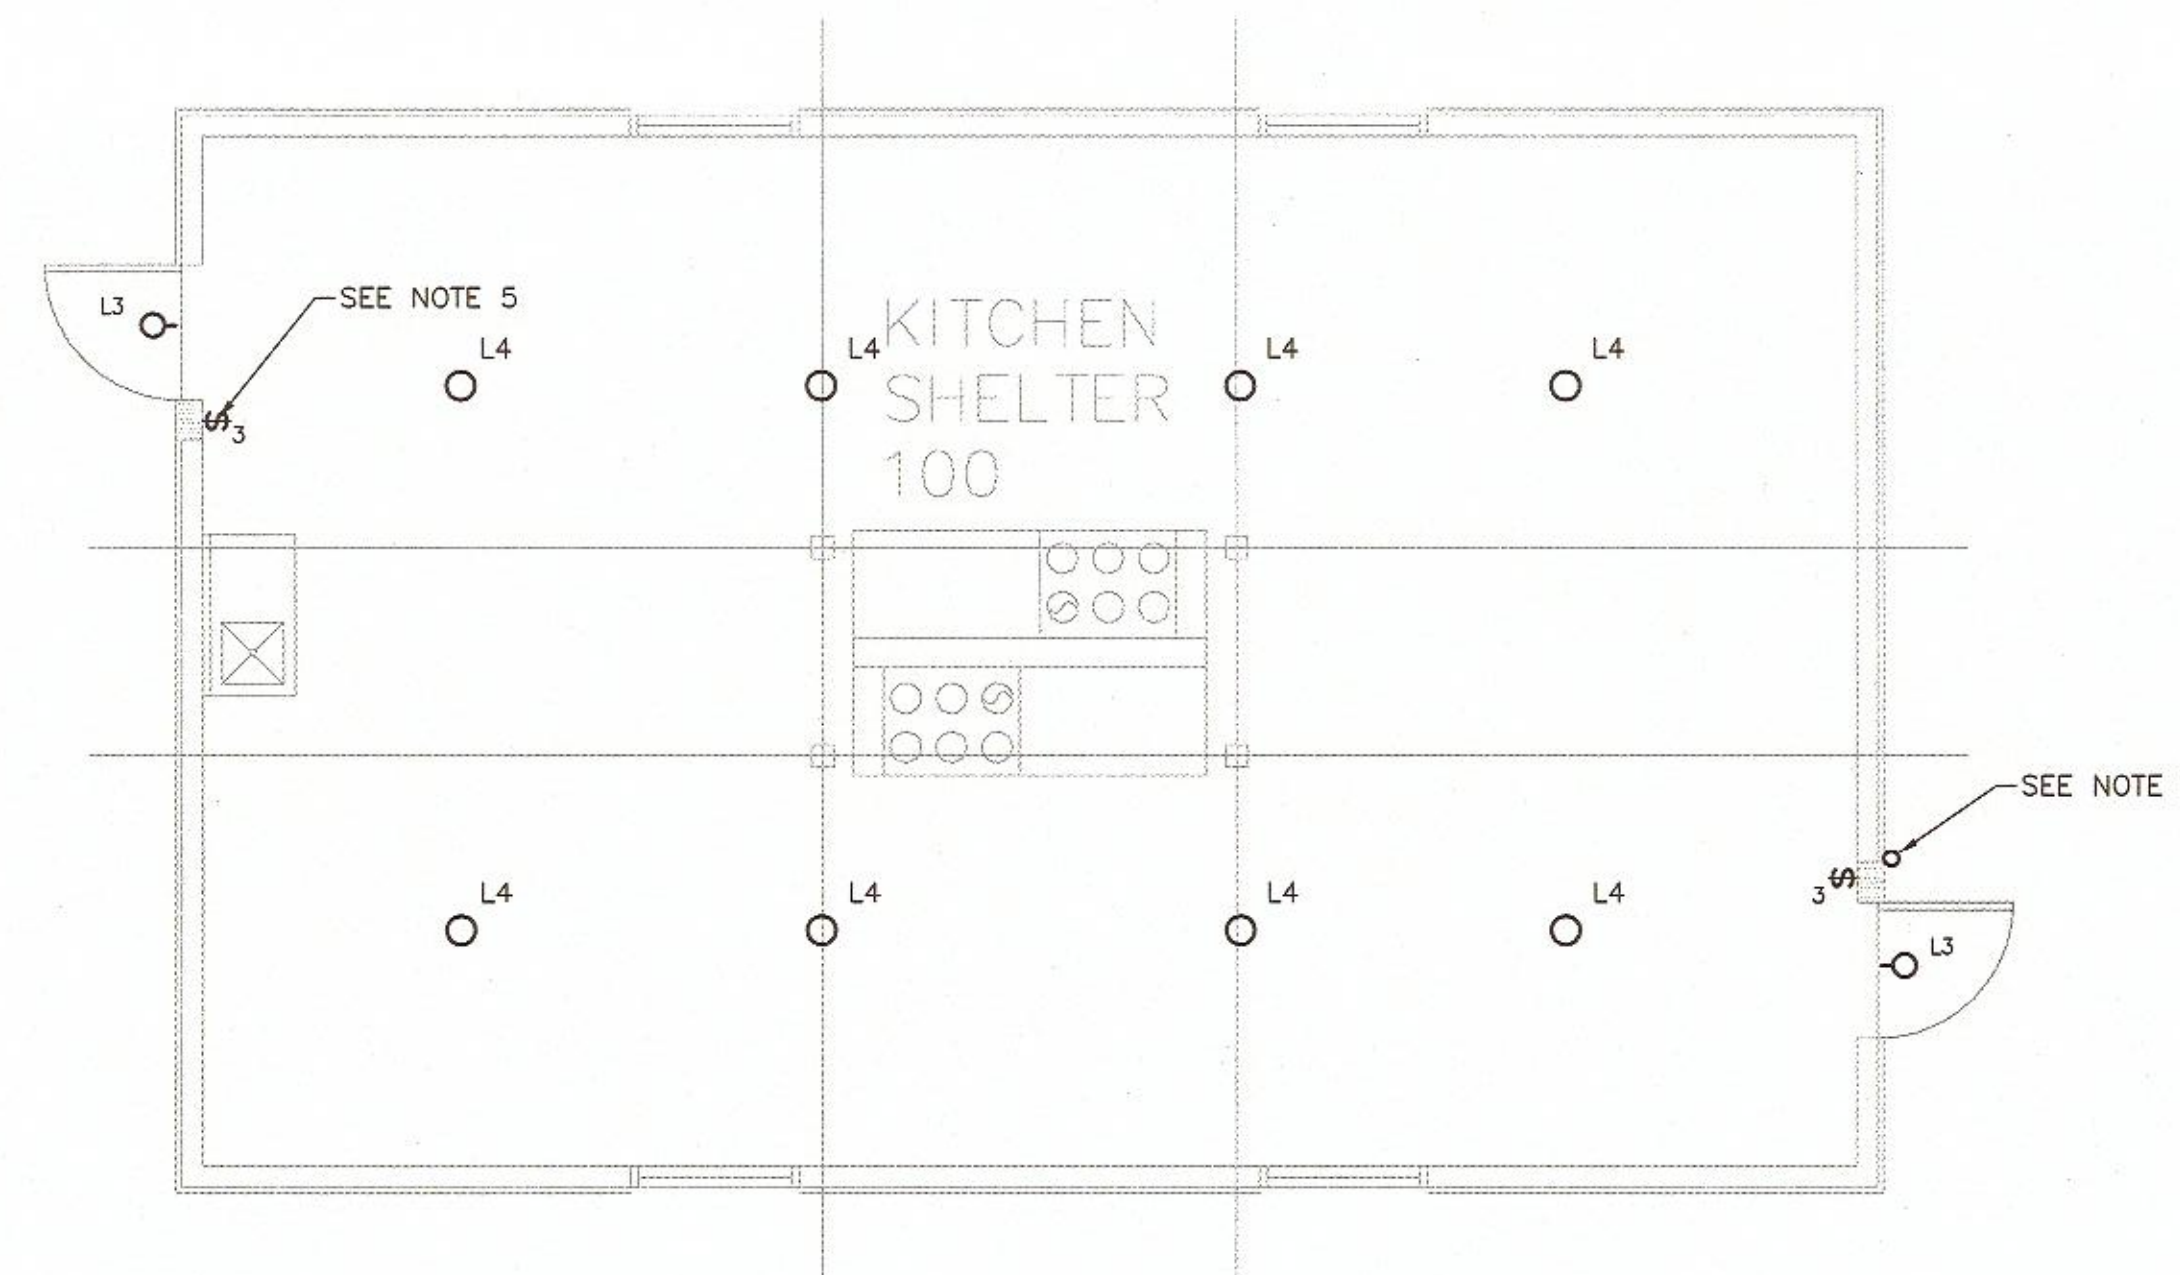

FLOOR PLAN – KITCHEN SHELTER #5 & 6

SCALE: 1:50
0m 1m 2m 3m 4m 5m

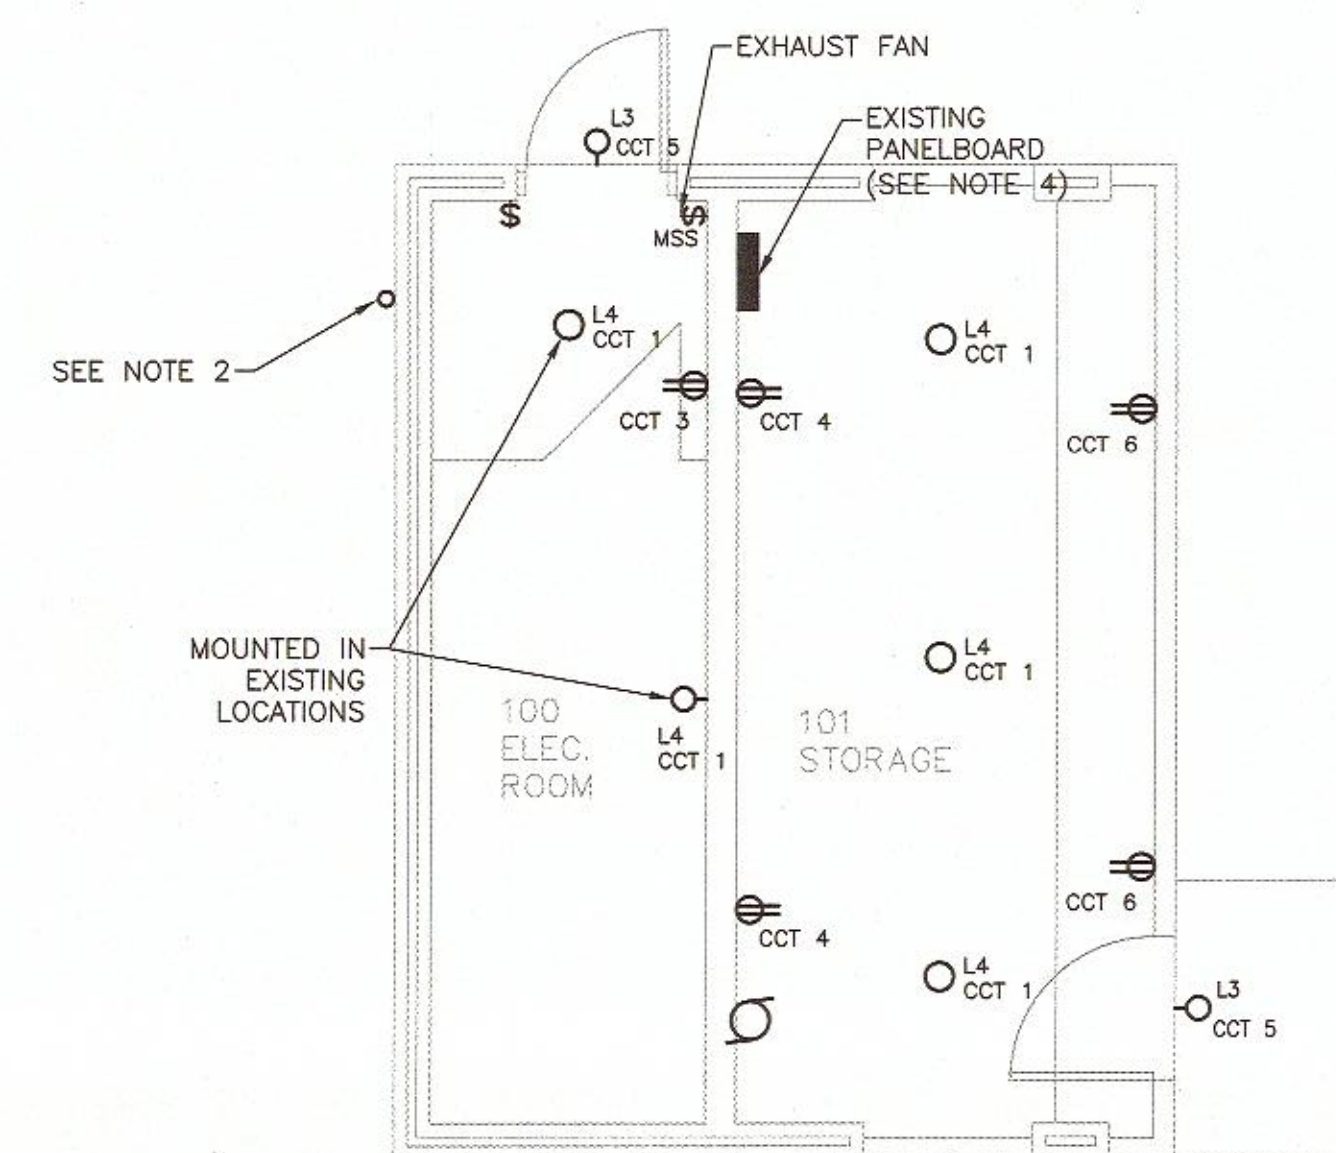

NEW FLOOR PLAN – LAUNDRY


SCALE: 1:50
0m 1m 2m 3m 4m 5m

LEGEND:

	CEILING SURFACE MOUNTED LINEAR LUMINAIRE
	CEILING SURFACE MOUNTED ROUND LUMINAIRE
	WALL SURFACE MOUNTED LUMINAIRE
	CEILING SURFACE MOUNTED LINEAR STRIP
	SINGLE RECEPTACLE
	DUPLEX RECEPTACLE
	SPECIAL RECEPTACLE
	DIRECT CONNECTION TO EQUIPMENT
	DOOR OPERATOR
	PUSHBUTTON
	ASTRONOMIC ELECTRONIC TIME CLOCK
	PANELBOARD
	ELECTRIC HAND DRYER
	20A, 120V TOGGLE-TYPE LIGHT SWITCH
	EXISTING EQUIPMENT TO BE REMOVED
	EXISTING EQUIPMENT TO REMAIN
	EXISTING EQUIPMENT TO BE REPLACED
	GROUND FAULT CIRCUIT INTERRUPTER
	ABOVE FINISHED GRADE

NOTES:

- REPAIR ANY DAMAGE DONE TO EXISTING FINISHES THAT ARE TO REMAIN AS A RESULT OF ELECTRICAL WORK.
- REMOVE AND REINSTALL EXISTING SURFACE MOUNTED CONDUITS AS REQUIRED TO FACILITATE CONSTRUCTION OF NEW WALLS.
- ENSURE SERVICE FEEDER TO THE LAUNDRY BUILDING IS DE-ENERGIZED AND LOCKED/TAGGED OUT WHEN WORKING ADJACENT EXPOSED ELECTRICAL EQUIPMENT.
- EXISTING PANELBOARD IS A 200A, 120/240V, 1 ϕ , 3W SQUARE D TYPE NQO PANELBOARD. REMOVE ALL BREAKERS AND INSTALL NEW BREAKERS TO FEED CIRCUITS AS INDICATED. UPDATE PANEL SCHEDULE.
- UTILIZE EXISTING LIGHTING CIRCUIT IN KITCHEN SHELTERS. BRANCH CIRCUIT WIRING IS TO BE REPLACED FROM THE MAIN LIGHTING JUNCTION BOX TO EACH FIXTURE AND CONTROLS.
- PROVIDE NEW BRANCH CIRCUIT WIRING THROUGHOUT WASHROOM BUILDINGS AND LAUNDRY BUILDING.

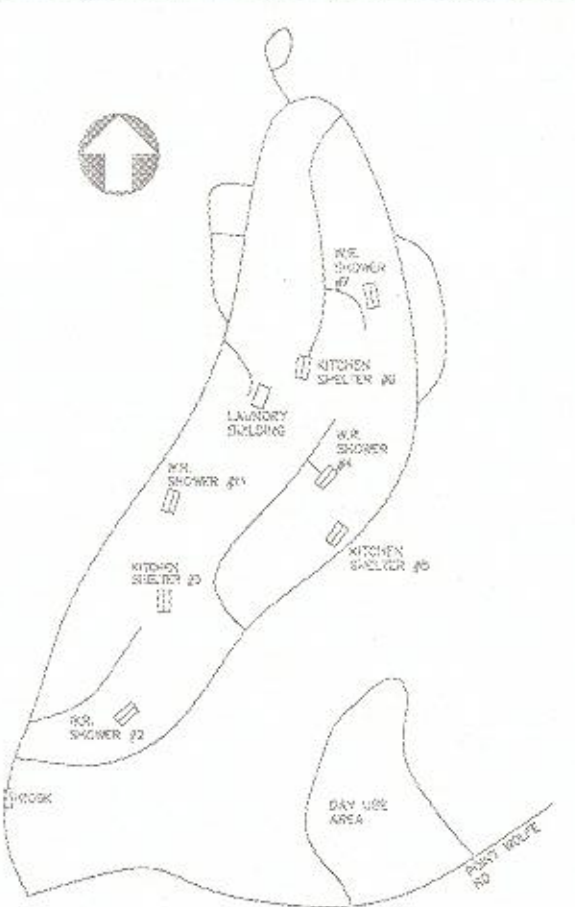

POINT WOLFE COMPOUND KEY PLAN
FUNDY NATIONAL PARK
NOT TO SCALE



1	ISSUED FOR TENDER	SEP 13 2016
revisions		date

project **POINT WOLFE SERVICE BUILDINGS**
FUNDY NATIONAL PARK
ALMA, NB
ALBERT COUNTY, NB

drawing **ELECTRICAL**
REVISED FLOOR PLANS

designed	M. MELANSON	conçu
date	JULY 2016	
drawn	M. MELANSON	dessiné
date	JULY 2016	
approved		approuvé
date		
Tender		Soumission
PWOSC Project Manager	Administrateur de projet TPSGC	
project number	R.075852.001	no. du projet
drawing no.	E-2.0	no. du dessin