

10605

NOTES:

- CONDUIT FOR CABLING SHALL BE MINIMUM 21mm EMT C/W WEATHERPROOF COUPLINGS & CONNECTORS WITH BLANK PLATE AND TERMINATE IN 102mm x 102mm DEEP CAST ALUMINIUM WEATHERPROOF JUNCTION BOX & TAMPERPROOF SCREWS. FROM JUNCTION BOX TO CAMERA PROVIDE 21mm FLEXIBLE RACEWAY C/W PVC JACKET. GROUPING OF CAMERA FEEDERS IS ACCEPTABLE. CONTRACTOR SHALL RESIZE CONDUIT AS REQUIRED.
- PROVIDE 915mm WIDE x 1050mm DEEP x 2100mm HIGH SERVER RACK
- PROVIDE 30A 208V/1Ø TWIST LOCK RECEPTACLE.
- PROVIDE TELEPHONE OUTLET TO COMM ROOM 227 C/W 21mm CONDUIT & 1-CAT6 CABLE FOR OWNERS TERMINATION.
- CEILING MOUNT C/W SWIVELLING TELESCOPIC MOUNTING ARM. MOUNTING ELEVATION SHALL BE CONFIRMED ON SITE.
- WALL MOUNT BRACKET.
- PARAPET MOUNT BRACKET.
- SOLID CEILING MOUNT UNDER CANOPY.
- REFER TO DETAIL 7/E6.0 FOR TYPICAL LOW POLE.



DO NOT SCALE DRAWINGS

Revision/Revisions	Description/Description	Date/Date
0	ISSUED FOR CONSTRUCTION	2016/11/02

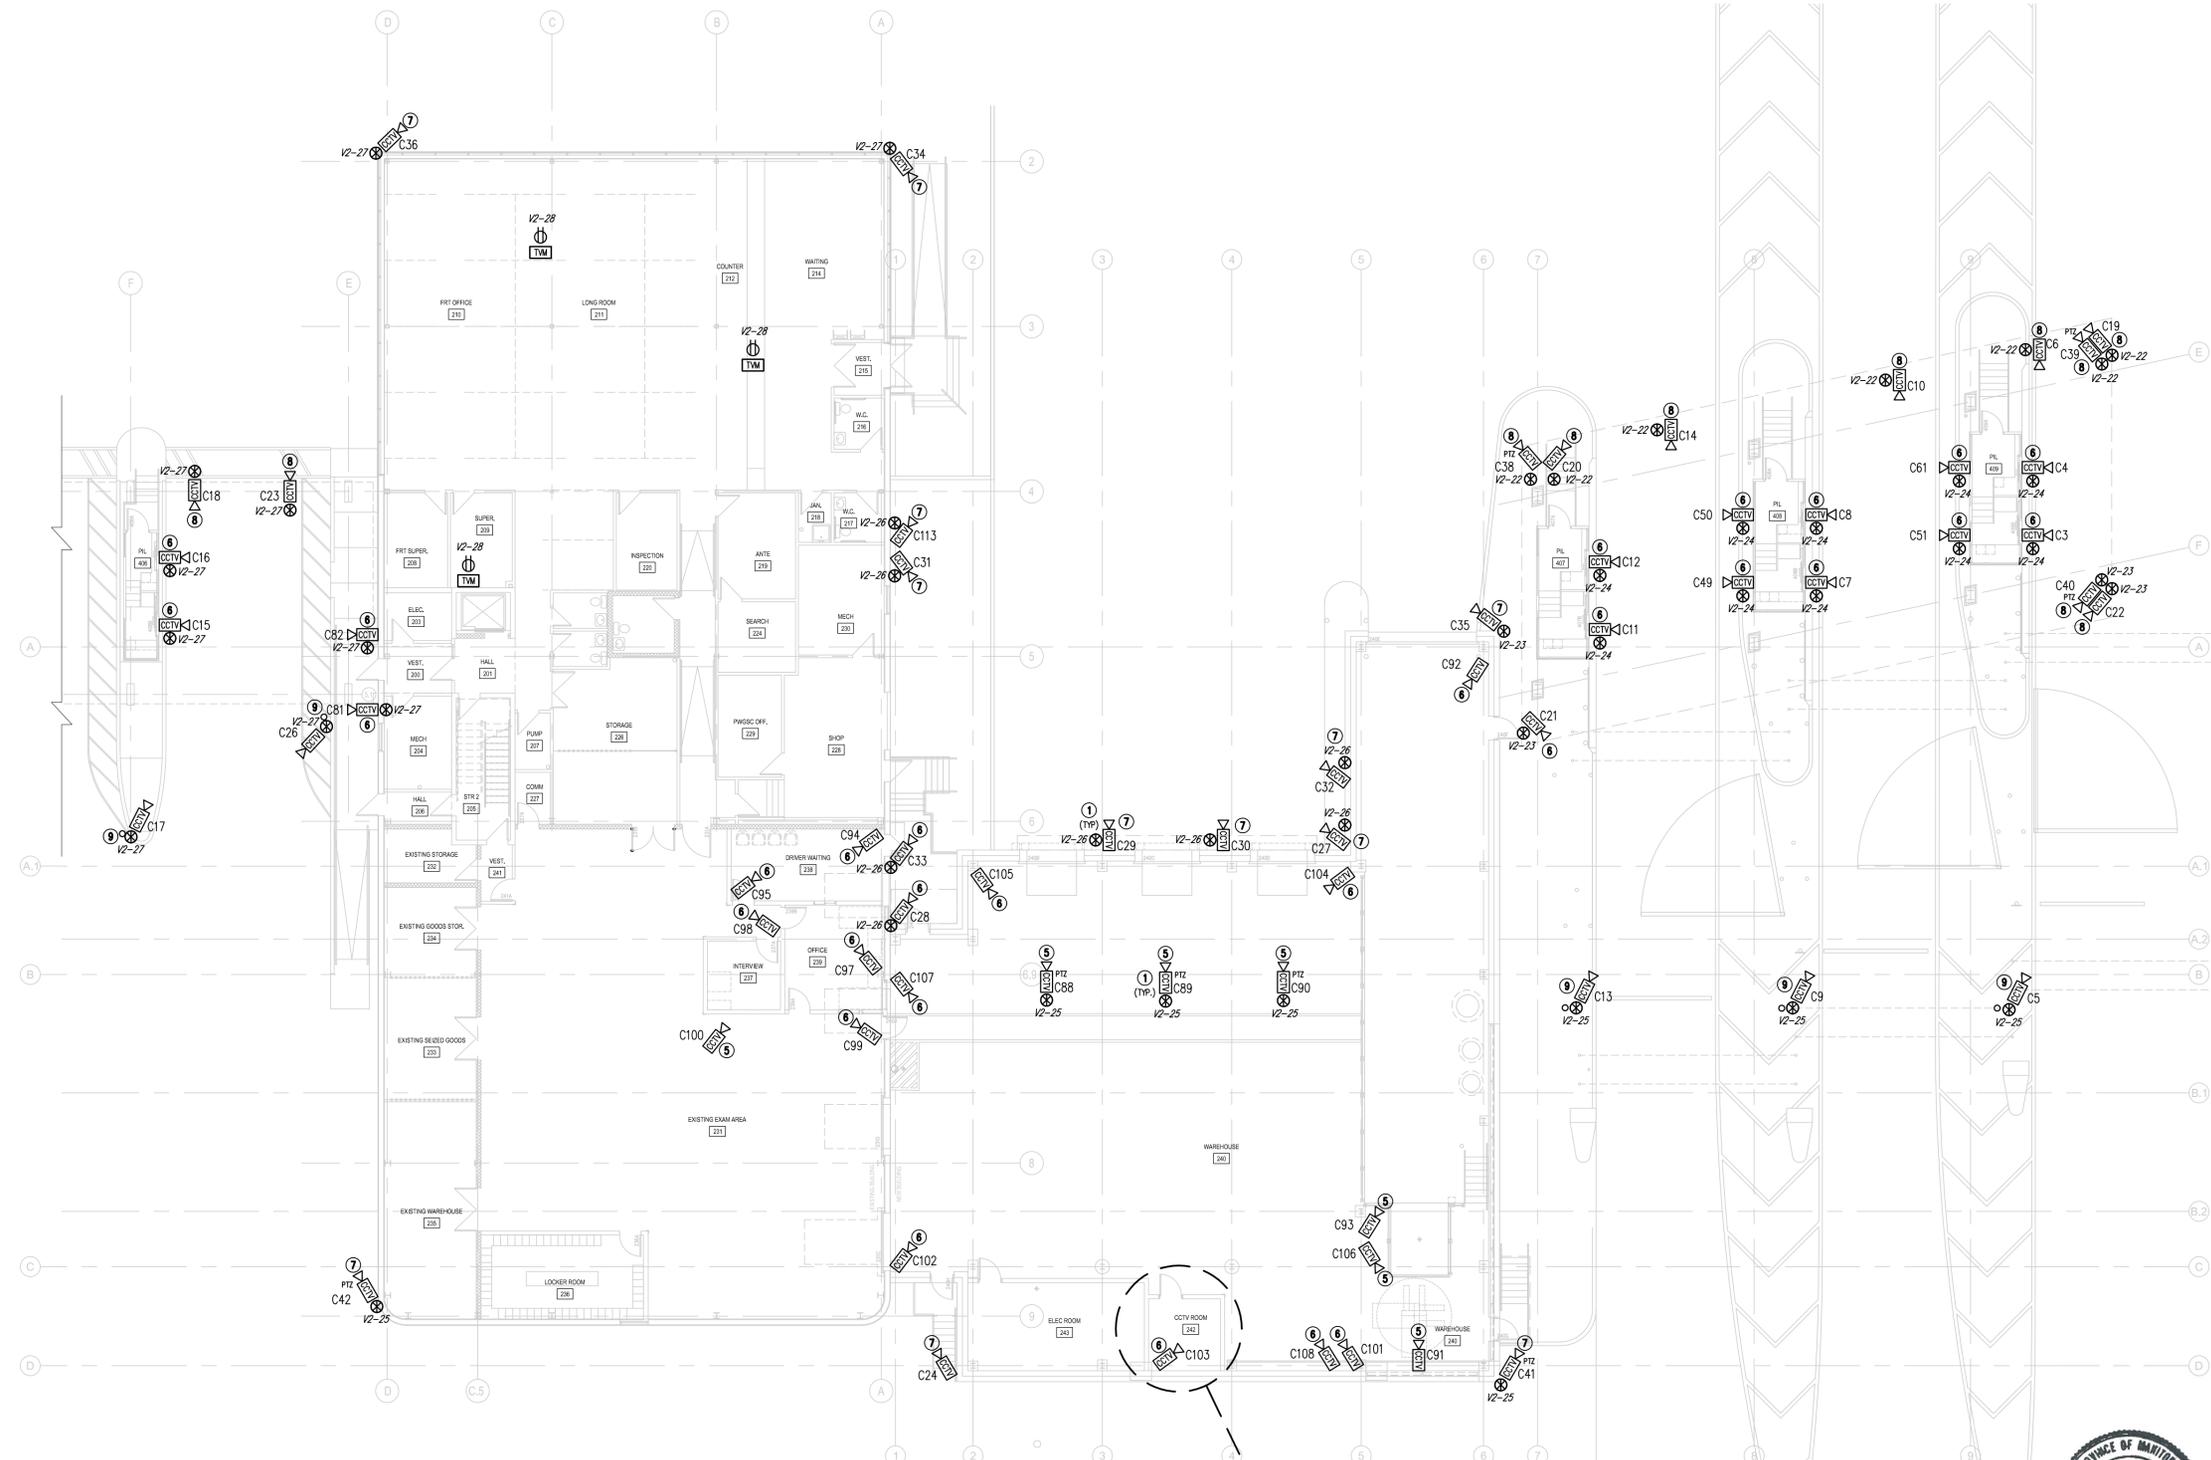
Client/client
PUBLIC WORKS AND GOVERNMENT SERVICES AGENCY

Project title/Titre du projet
EMERSON, MANITOBA HIGHWAY 75, UNITED STATES BORDER
EXPANSION AND REDEVELOPMENT OF THE EMERSON PORT OF ENTRY


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Ressources Architectural et de Directeur d'ingénierie, TPSCC
Client/client

Drawing title/Titre du dessin
COMMERCIAL BUILDING FLOOR PLAN - CCTV LAYOUT


Project No./No. du projet R.068431.001	Sheet/Feuille EC2.1 of 26	Revision no./La Révision no. 0
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2 COMMERCIAL BUILDING FLOOR PLAN - CCTV LAYOUT
SCALE: 1:150



3 ENLARGED DATA ROOM LAYOUT
SCALE: 1:50

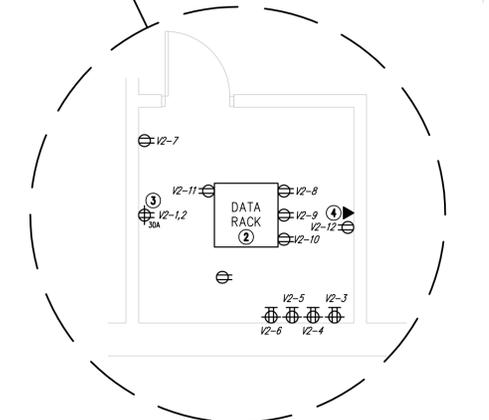

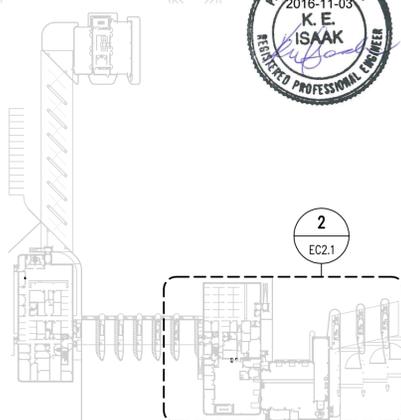1 KEY PLAN
SCALE: N.T.S.