

10605

NOTES:

1. PROVIDE PATHWAY FOR F.A.S.T. LANE CONTROL SYSTEM. COORDINATE WITH PROVIDER PRIOR TO ROUGH-IN.
2. PROVIDE WEATHERPROOF CONDUIT C/W PULL STRING ON GANTRY TO SIGNAL LIGHT LOCATION FROM UNDERGROUND JUNCTION BOX. COORDINATE WITH SIGNAL LIGHT PROVIDER.
3. PROVIDE 35mm CONDUIT C/W PULL STRING FROM JUNCTION BOX TO TRAFFIC CONTROL UNIT.
4. PROVIDE 53mm CONDUIT C/W PULL STRING FROM UNDERGROUND JUNCTION BOXES TO TRAFFIC CONTROL UNIT.
5. UNDERGROUND JUNCTION BOXES SHALL BE INSTALLED IN RECESSED HIGH JUMBO BOX FLUSH TO SURFACE C/W A SCREW DOWN COVER.
6. LOCATE JUNCTION BOX ON PIL BOOTH FOR ACCESSIBILITY.
7. PROVIDE 27mm CONDUIT C/W PULL STRING FROM CANOPY TRAFFIC CONTROL SIGN TO JUNCTION BOX LOCATED IN PIL BOOTH UNDER COUNTER.
8. PROVIDE 21mm CONDUIT C/W PULL STRING FROM JUNCTION BOX TO JUNCTION BOX & TO PUSHBUTTONS.
9. WIRE & CONNECT CIRCUIT TO TRAFFIC CONTROL UNIT AS SUPPLIED BY OTHERS.



DO NOT SCALE DRAWINGS

Revision/Revisions	Description/Description	Date/Date
0	ISSUED FOR CONSTRUCTION	2016/11/02

Client/client  
**PUBLIC WORKS AND GOVERNMENT SERVICES AGENCY**

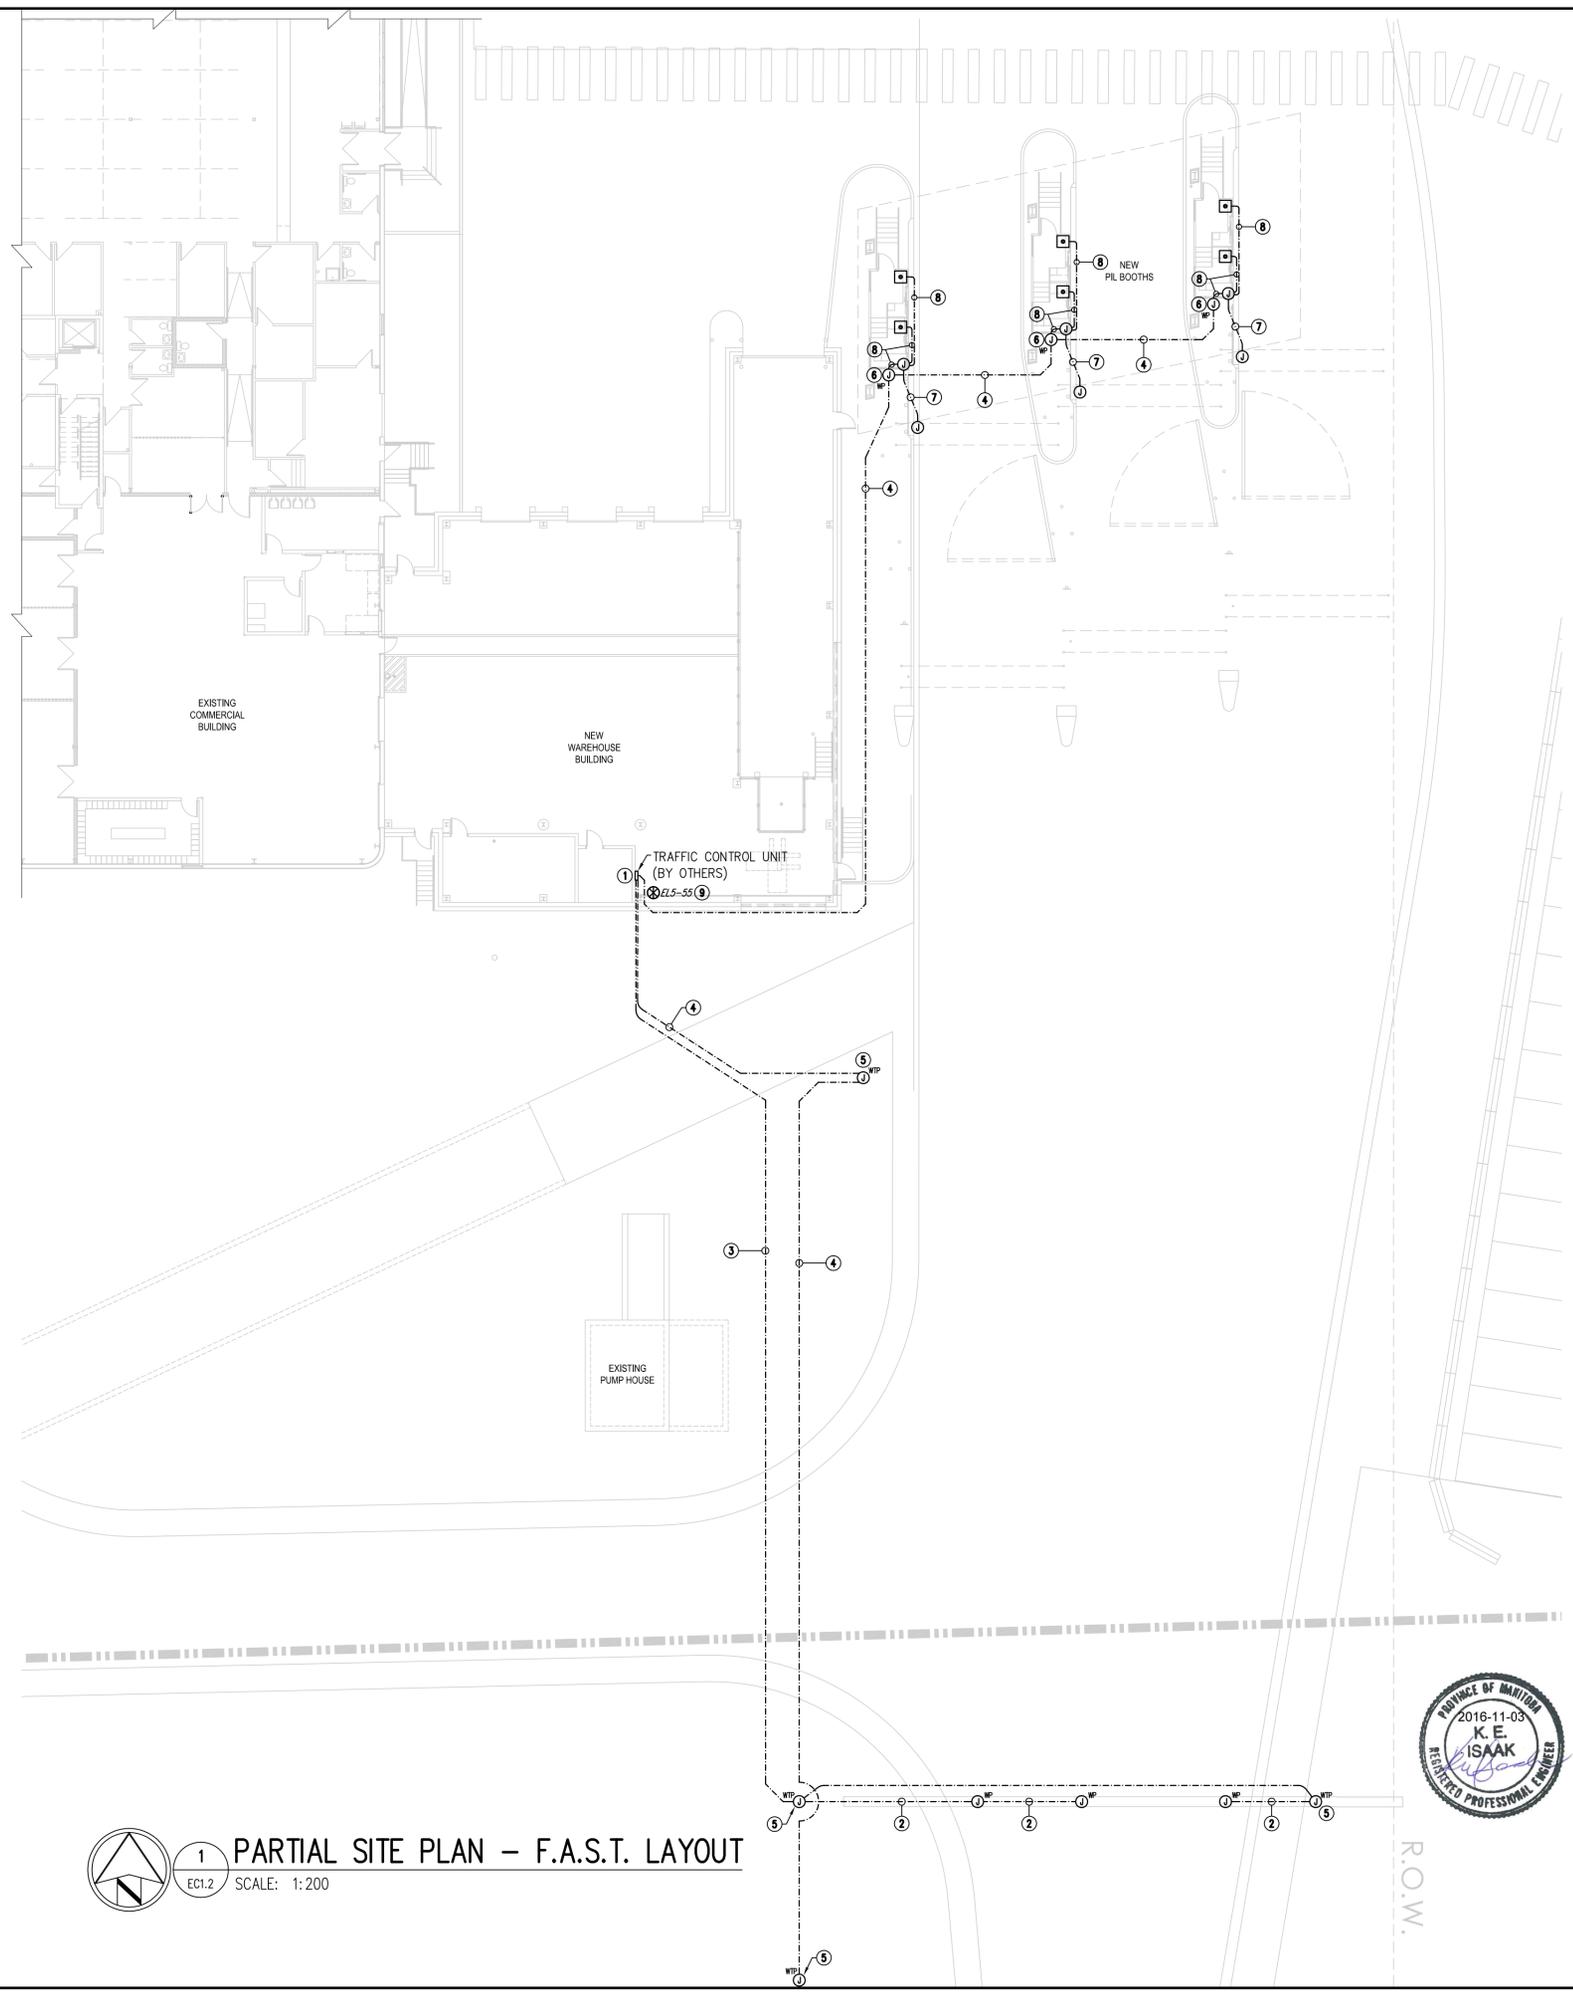
Project title/Titre du projet  
**EMERSON, MANITOBA HIGHWAY 75, UNITED STATES BORDER  
EXPANSION AND REDEVELOPMENT OF THE EMERSON PORT OF ENTRY**

Approved by/Approve par  
**KEI**  
Designed by/Concept par  
**GD**  
Drawn by/Dessine par  
**GA**

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Client/client  
Drawing title/Titre du dessin  
**SITE PLAN - F.A.S.T. LAYOUT**

Project No./No. du projet <b>R.068431.001</b>	Sheet/Feuille <b>EC2.6</b> of 26	Revision no./La Révision no. <b>0</b>
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1 PARTIAL SITE PLAN - F.A.S.T. LAYOUT  
EC1.2 SCALE: 1:200

