

- NOTES:
- CONDUIT FOR CABLING SHALL BE MINIMUM 21mm EMT C/W WEATHERPROOF COUPLINGS & CONNECTORS & TERMINATE IN 102mm x 102mm DEEP CAST ALUMINIUM WEATHERPROOF BOX WITH BLANK PLATE & TAMPERPROOF SCREWS. FROM JUNCTION BOX TO CAMERA PROVIDE 21mm FLEXIBLE RACEWAY C/W PVC JACKET. GROUPING OF CAMERA FEEDERS IS ACCEPTABLE. CONTRACTOR SHALL RESIZE CONDUIT AS REQUIRED.
 - PROVIDE FIBRE CABLE IN 53mm CONDUIT FROM TERTIARY EXAM 400 TO COMPUTER 116. PROVIDE PULL BOX EVERY 30 METERS. RUN CONDUIT ON UNDER SIDE OF CANOPY.
 - PROVIDE 21mm CONDUIT FROM MONITOR TO CCTV.
 - CEILING MOUNT C/W SWIVELLING TELESCOPIC MOUNTING ARM. MOUNTING ELEVATION SHALL BE CONFIRMED ON SITE.
 - WALL MOUNT BRACKET.
 - PARAPET MOUNT BRACKET.



APEN
Certificate of Authorization
MCW/AGE Consulting Professional Engineers
No. 589 Expiry: April 30, 2017

DO NOT SCALE DRAWINGS

Revision/Revisión	Description/Description	Date/Date
0	ISSUED FOR CONSTRUCTION	2016/11/02

Client/client
PUBLIC WORKS AND GOVERNMENT SERVICES AGENCY

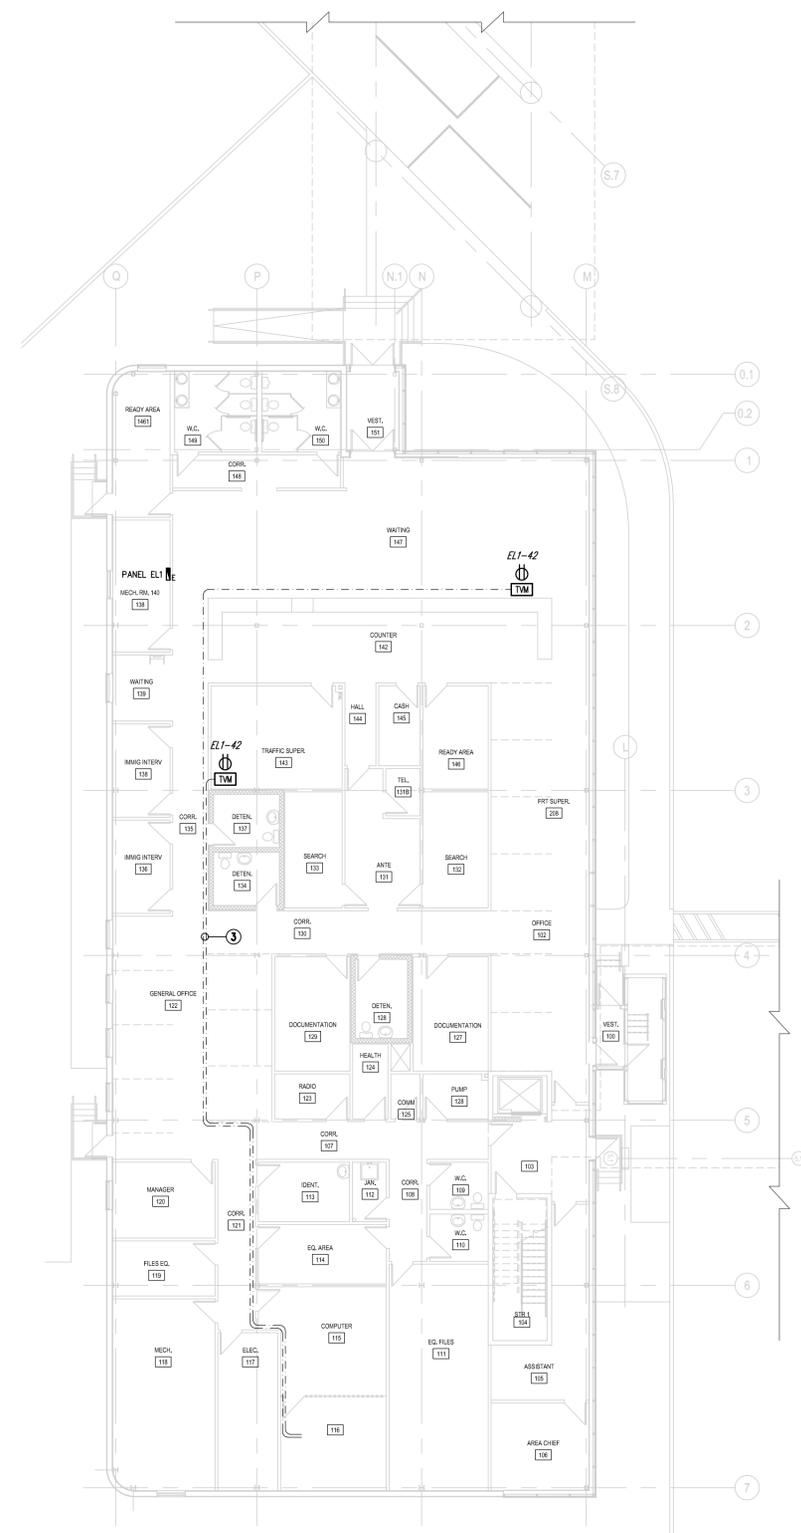
Project title/Titre du projet
EMERSON, MANITOBA HIGHWAY 75, UNITED STATES BORDER
EXPANSION AND REDEVELOPMENT OF THE EMERSON PORT OF ENTRY

Approved by/Approve par
KEI
Designed by/Concept par
GD
Drawn by/Dessine par
GA


PWSSC Project Manager/Administrateur de Projets TPSSC
JAMES HUTCHINGS
PWSSC, Architectural and Engineering Resources Manager / Ressources Architectural et de Directeur d'Ingénierie, TPSSC

Client/client
Drawing title/Titre du dessin
EXISTING TRAVELERS BUILDING FLOOR PLAN - CCTV LAYOUT


Project No./No. du projet R.068431.001	Sheet/Feuille EC2.2 of 26	Revision no./La Révision no. 0
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2 EXISTING TRAVELERS BUILDING FLOOR PLAN - CCTV LAYOUT
EC2.2 SCALE: 1:150



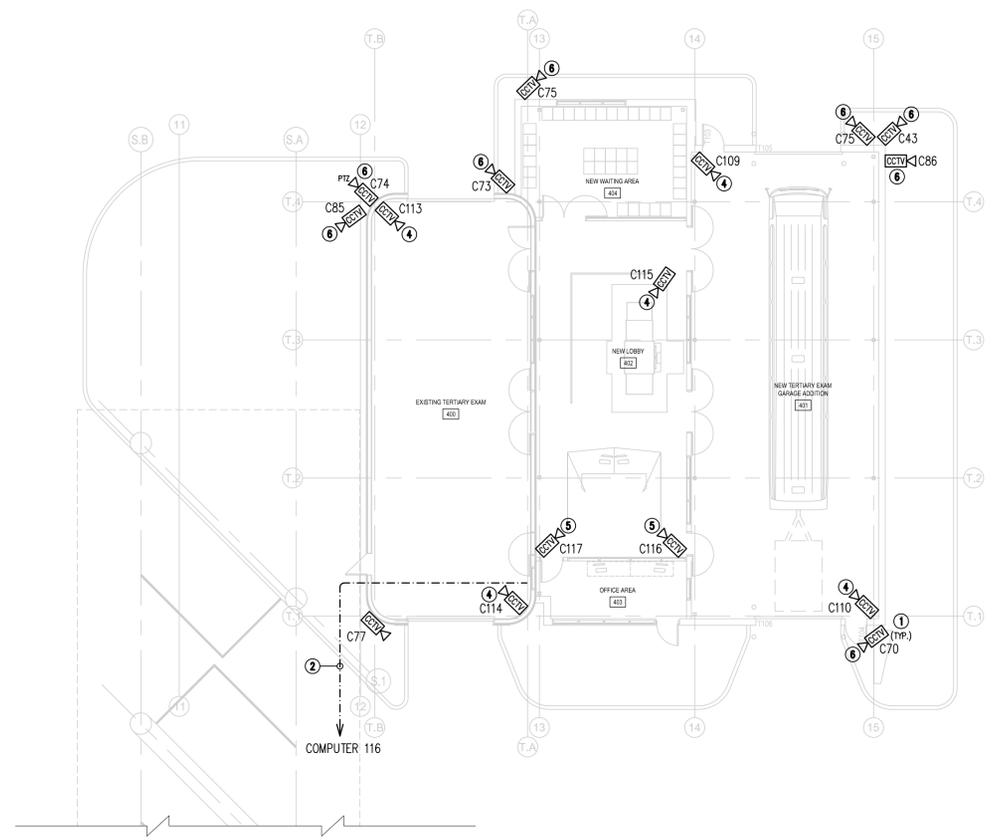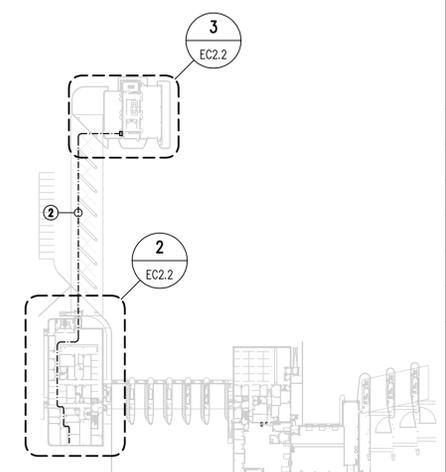3 TERTIARY GARAGE FLOOR PLAN - CCTV LAYOUT
EC2.2 SCALE: 1:150



1 KEY PLAN
EC2.2 SCALE: N.T.S.