

CIP CONCRETE PAVING NOTES


1. SANDBLAST FINISH
2. SEE LAYOUT PLAN FOR SAWCUT JOINT PATTERN AND BAND WIDTH
3. EXP. JOINTS @6M O.C. MAX (PLUMB, STRAIGHT AND SQUARE)
(AT CHANGES IN MATERIALS, FURNISHINGS, CURB EDGES - SPACING TO COINCIDE WITH PATTERN)
4. CONTROL JOINTS @ 1.5M O.C. (5'0") O.C. MAX (PLUMB, STRAIGHT AND SQUARE)
5. FINAL LOCATION FOR JOINTS AND SAW CUTS TO BE CONFIRMED ON SITE WITH DEPARTMENTAL REPRESENTATIVE.
6. ALL PAVING TO BE VEHICULAR RATED.
7. FOR ALL HC ACCESSIBLE ROUTES ENSURE SAW CUT JOINTS RATHER THAN CONVEX TOOLED JOINTS.

EXISTING DIKE WORK NOTES


1. ALL EXISTING INFORMATION APPROXIMATE ONLY. CONTRACTOR TO VERIFY AND REPORT ANY DISCREPANCIES PRIOR TO PROCEEDING WITH WORK.
2. ENSURE DIKE INTEGRITY PROTECTED PER CITY OF RICHMOND GUIDELINES AND PROVINCIAL/MUNICIPAL DIKING AUTHORITY REQUIREMENTS.
3. EXISTING ELEMENTS TO BE PROTECTED THROUGHOUT THE DURATION OF CONSTRUCTION INCLUDE (BUT ARE NOT LIMITED TO): GULF OF GEORGIA CANNERY BUILDING, STINKEROO, AND PLAZA SCULPTURES.
4. ALL MATERIALS TO BE REMOVED FROM SITE AND DISPOSED OF PER CITY OF RICHMOND AND INDUSTRY REQUIREMENTS.

HARDSCAPE NOTES


1. ENGINEERED SHOP DRAWINGS REQUIRED FOR CIP CONCRETE PAVING REINFORCEMENT DETAILS.
2. REQUIRED SUBMITTALS INCLUDE:
A. DIKE COMPACTION TESTING
B. ON GRADE COMPACTION TESTING
C. GRANULAR BASE COURSE COMPACTION TESTING
D. CIP CONCRETE PAVING COMPRESSIVE STRENGTH TESTING
3. WHERE SUBMITTALS DO NOT MEET SPECIFICATION CONTRACTOR TO REPAIR OR PROPOSE ALTERNATE SOLUTION WHICH MEETS STRUCTURAL INTEGRITY FOR APPROVAL BY DEPARTMENTAL REPRESENTATIVE.

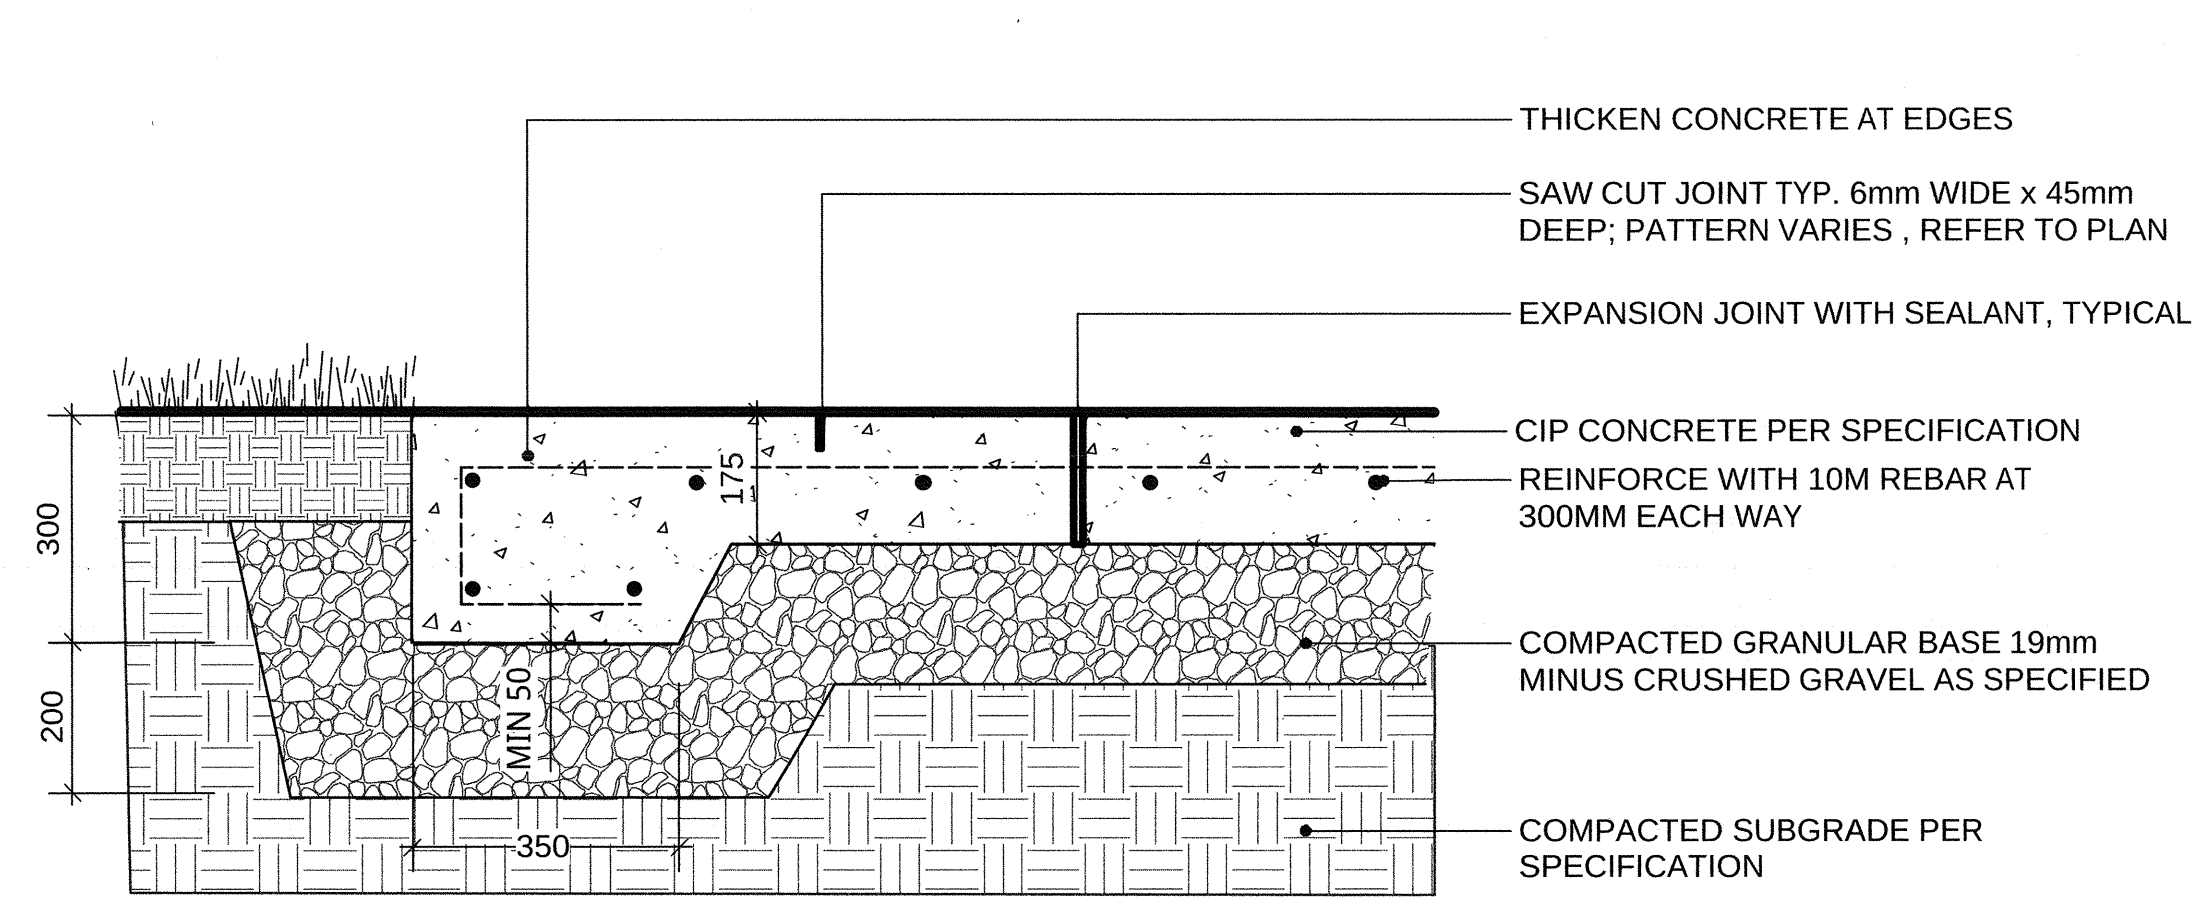


1 CIP CONCRETE ON GRADE (TYPICAL)
Scale: 1:10

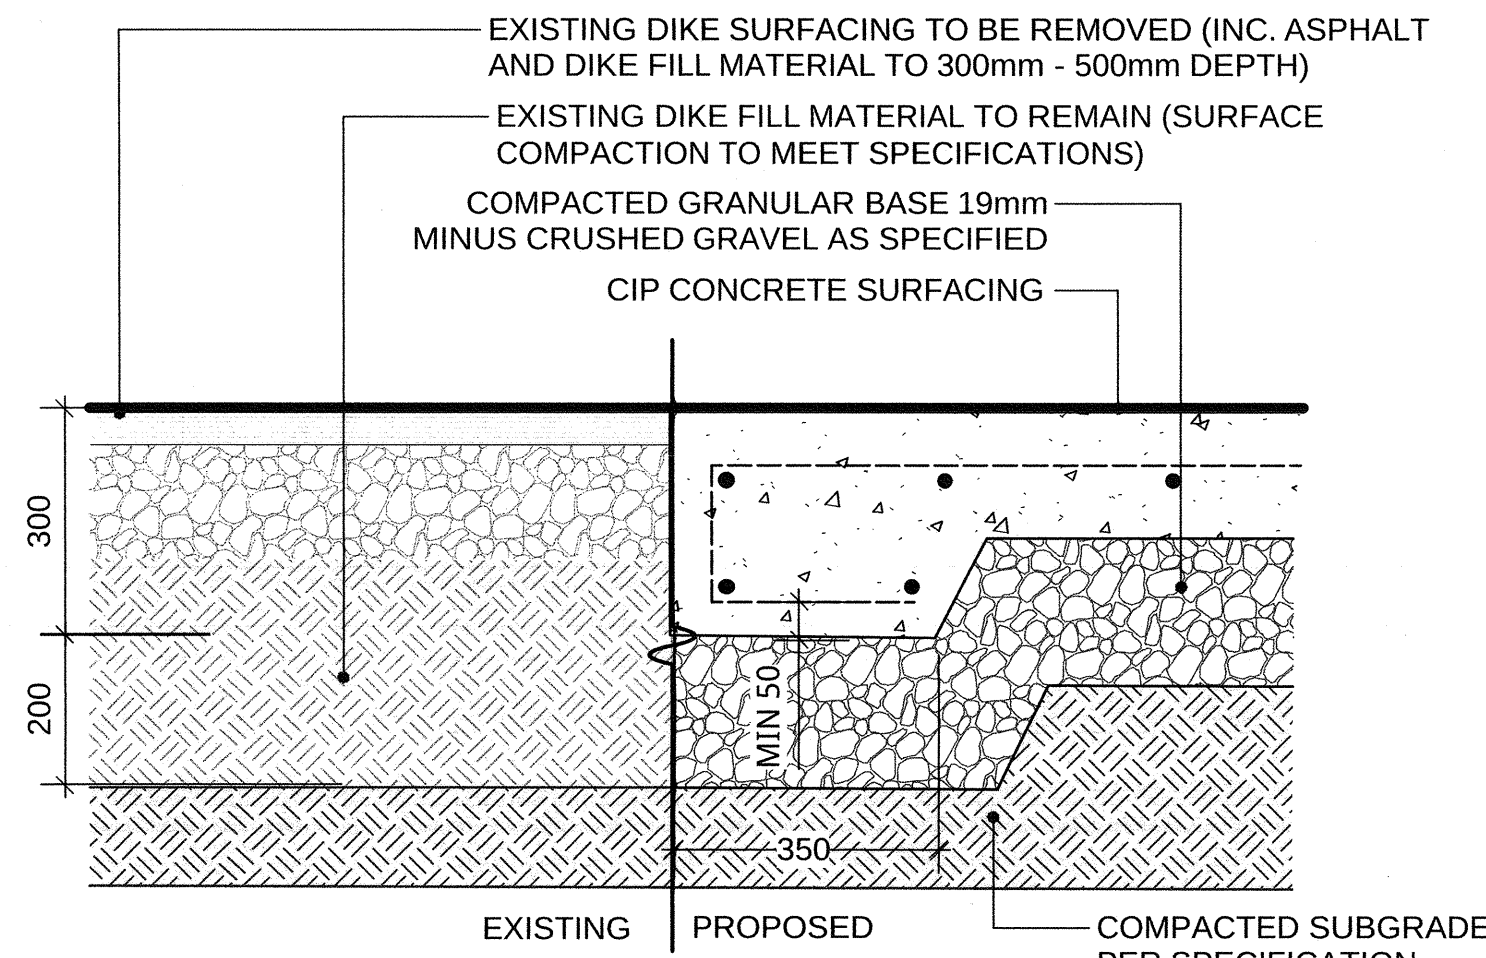


2 CIP CONCRETE ON EXISTING DIKE (TYPICAL)
Scale: 1:10

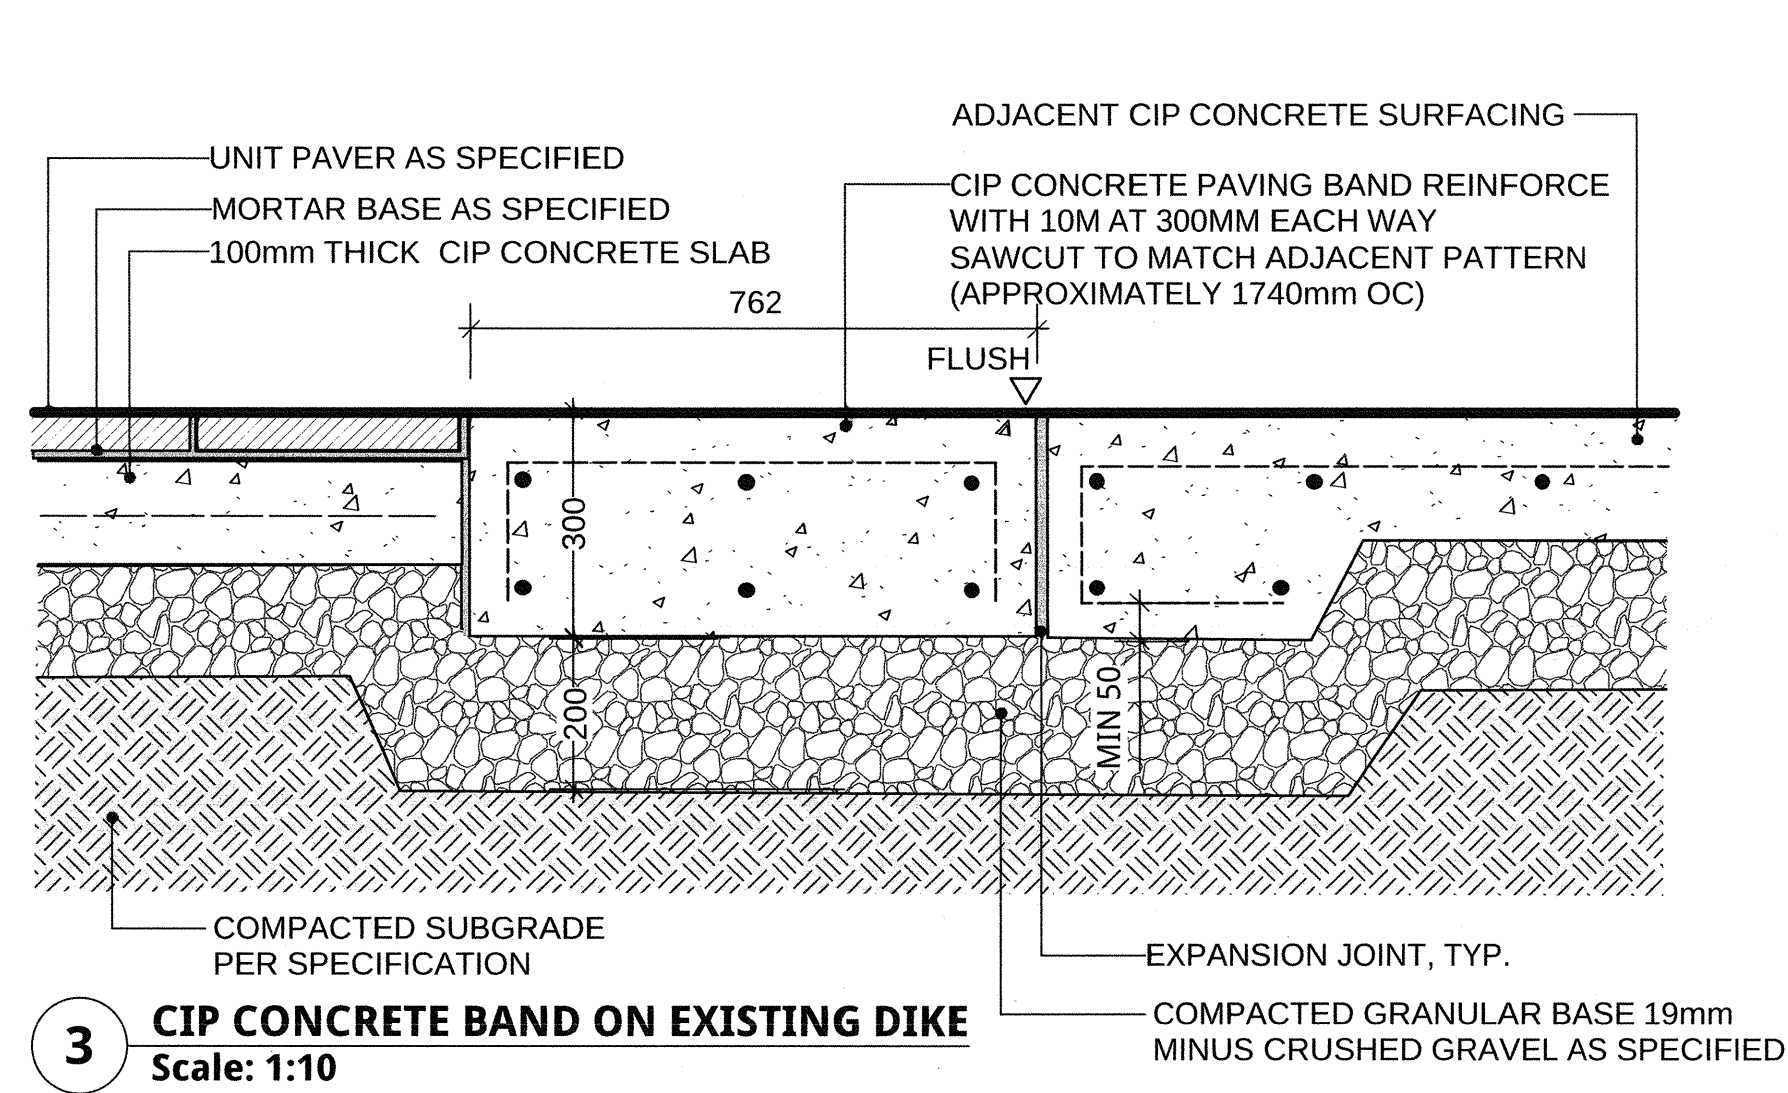


3 CIP CONCRETE BAND ON EXISTING DIKE
Scale: 1:10

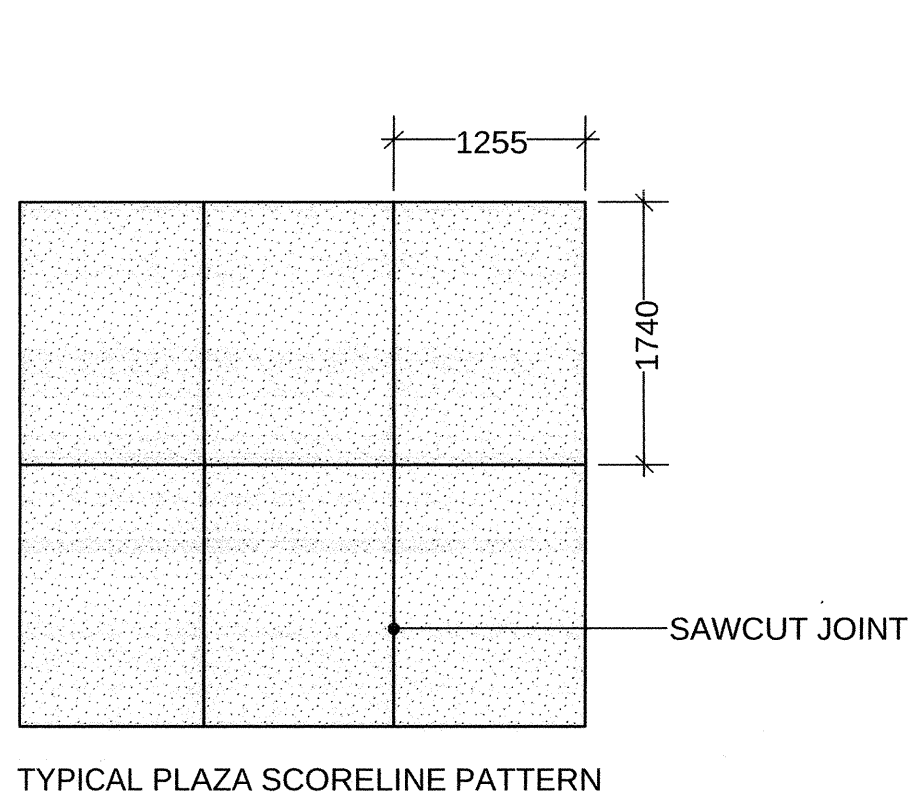

TYPICAL PLAZA SCORELINE PATTERN

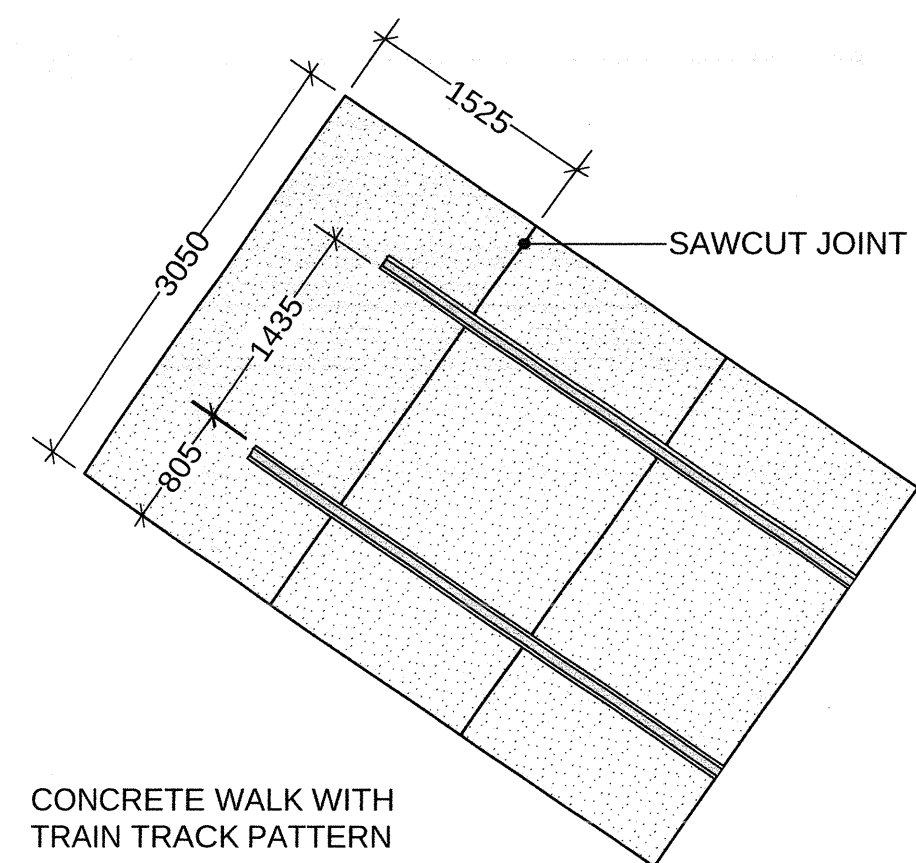


CONCRETE WALK WITH
TRAIN TRACK PATTERN

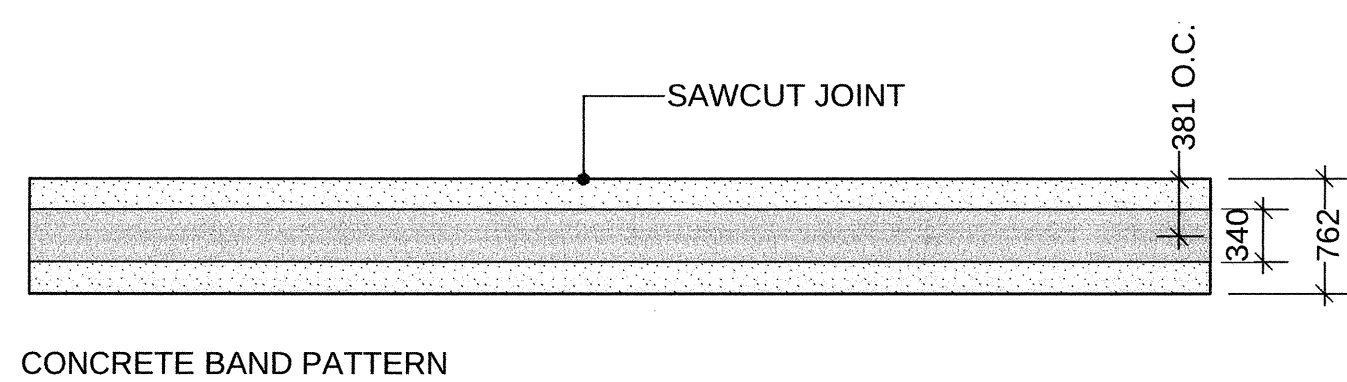


CONCRETE BAND PATTERN


4 CIP CONCRETE SCORELINE PATTERNS (PLAN ENLARGEMENTS)
Scale: 1:50

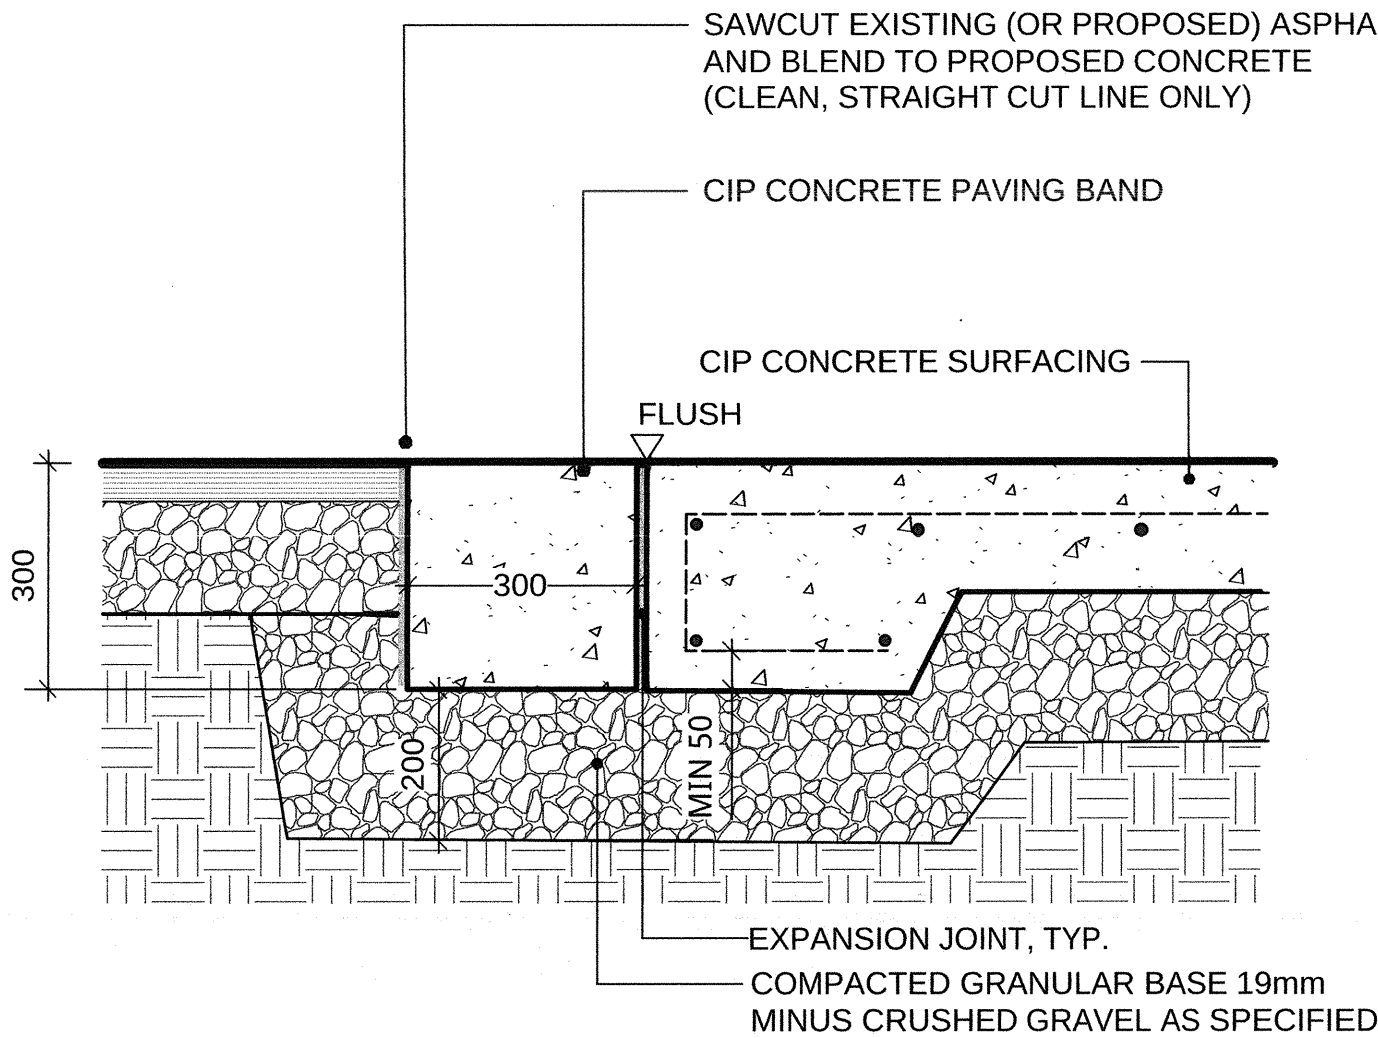


5 CIP CONCRETE AT TRANSITION TO ASPHALT
Scale: 1:10

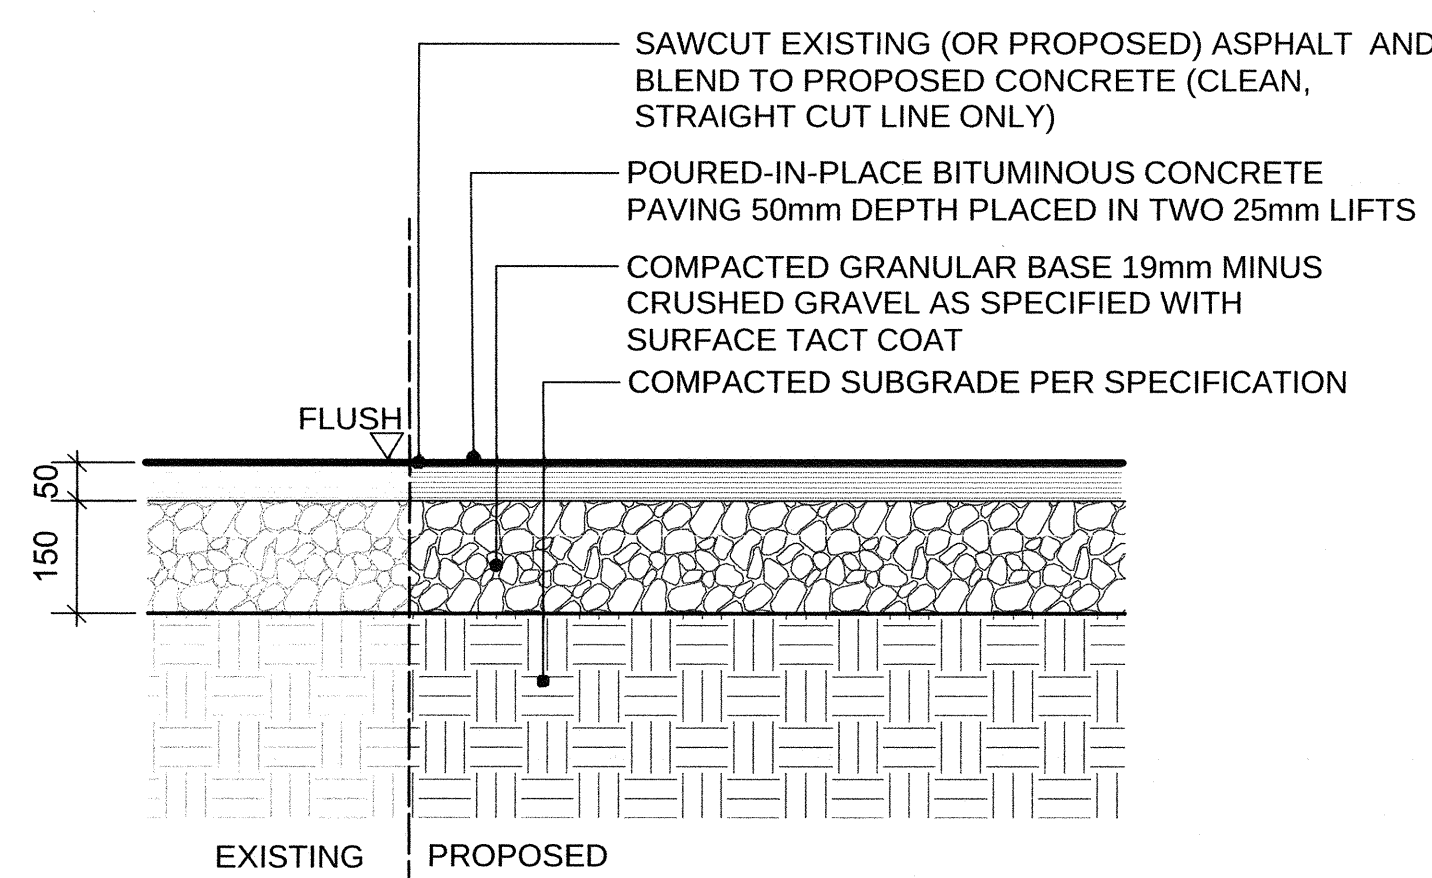


6 PROPOSED ASPHALT AT TRANSITION TO EXISTING
Scale: 1:10

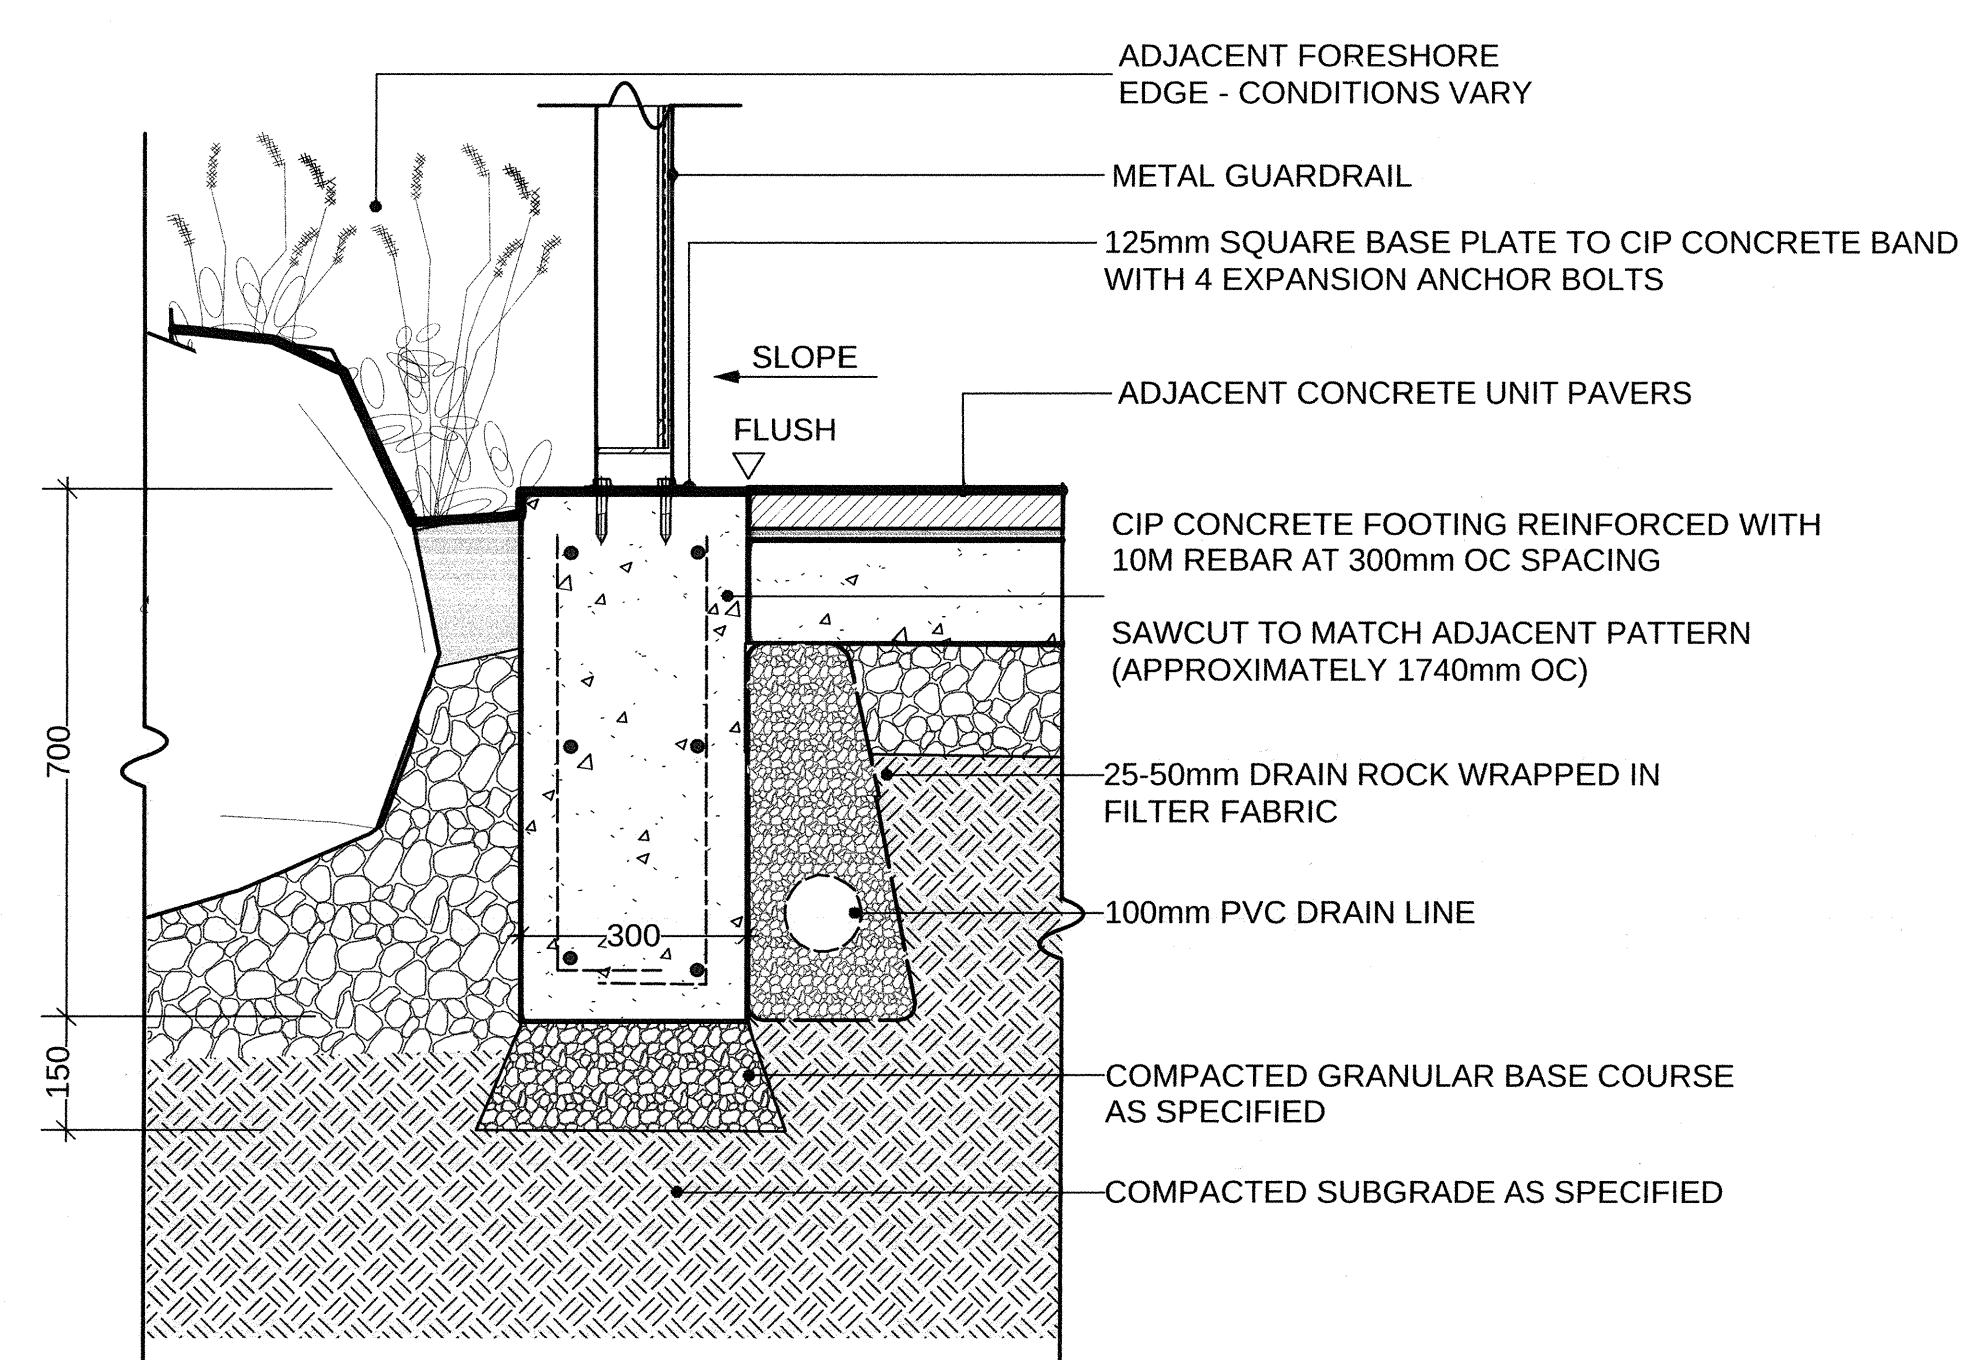

7 CIP CONCRETE BAND AT WATER EDGE
Scale: 1:10

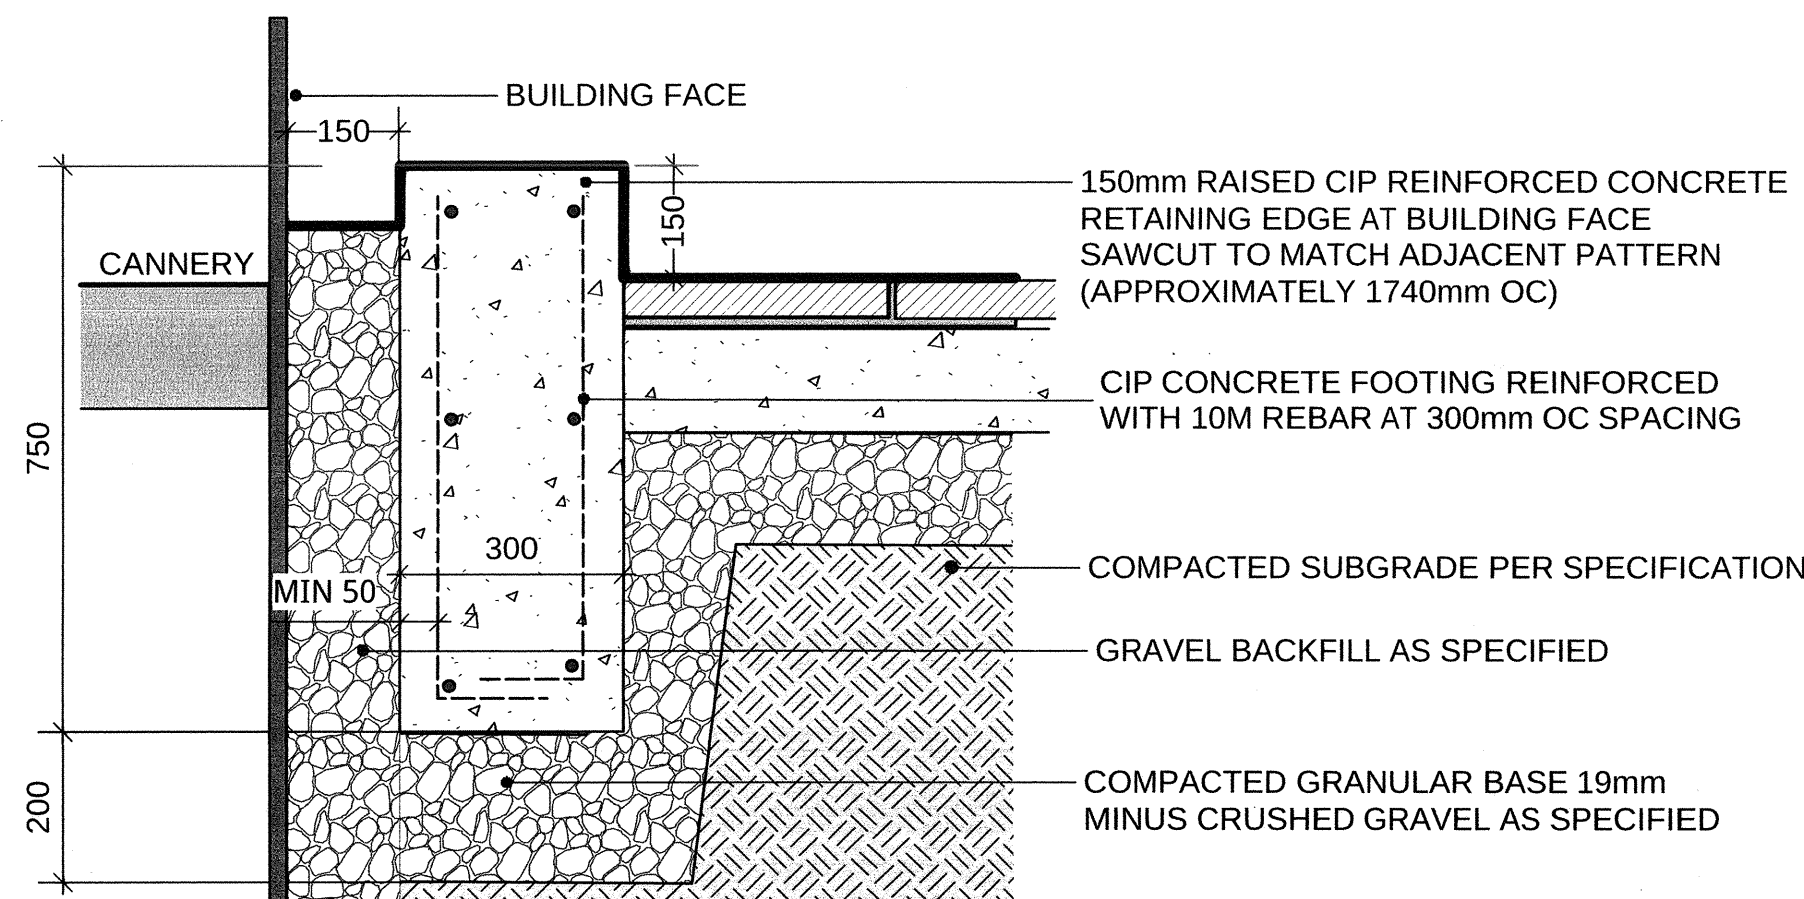

8 CIP CONCRETE EDGE AT BUILDING FACE
Scale: 1:10

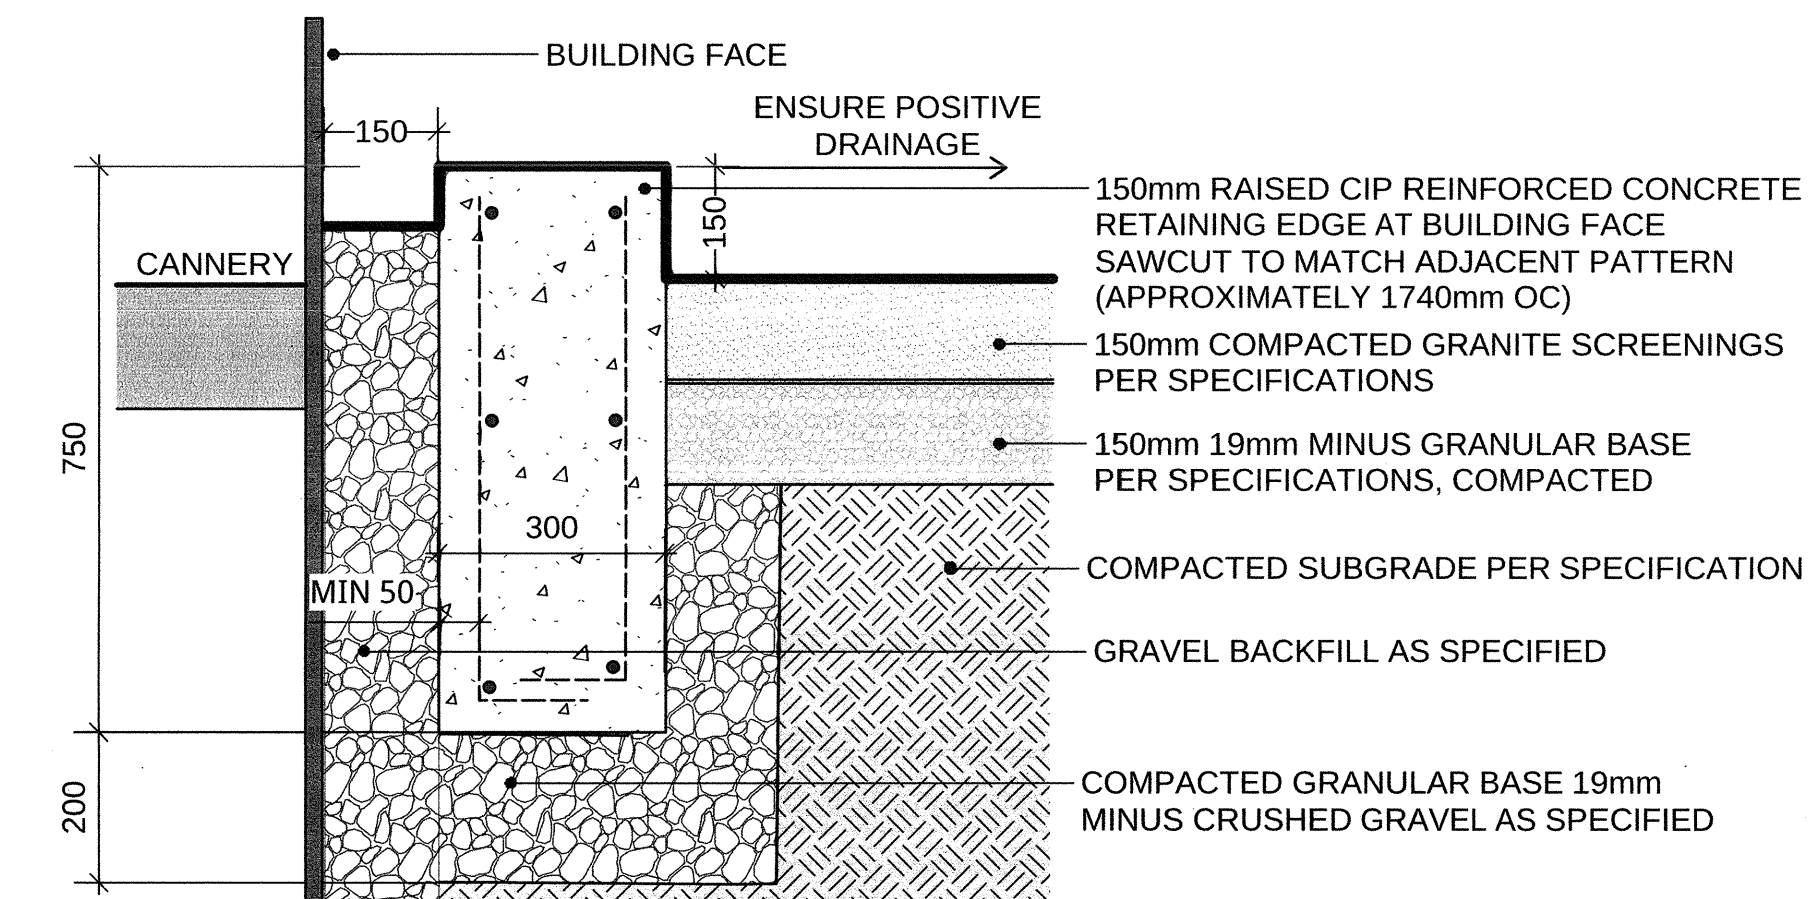

9 GRANULAR PATH AT ELECTRICAL ROOM
Scale: 1:10



5		
4		
3		
2		
1		
0	Issued for Tender	16-11-14
Revision/	Description/Description	Date/Date
Revision		
Client/client		

GULF OF GEORGIA
CANNERY
RICHMOND, BC
12138 FOURTH AVENUE
GULF OF GEORGIA CANNERY

Project title/Titre du projet
RICHMOND, BC
12138 FOURTH AVENUE
GULF OF GEORGIA CANNERY
GULF OF GEORGIA
CANNERY
NATIONAL HISTORIC SITE
Building Site Rehabilitation

Consultant Signature Box Only

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Drawing title/Titre du dessin

DETAILS: TYPICAL PAVING

Scale / Échelle

AS SHOWN

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06-476

PWGSC Project No./No. du projet

R060702.001

Sheet/ Feuille

L5.0

8 OF 16

Revision no./

La Révision

no.

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