


**STAGE LIGHTING PLAN**

SCALE: 1:50

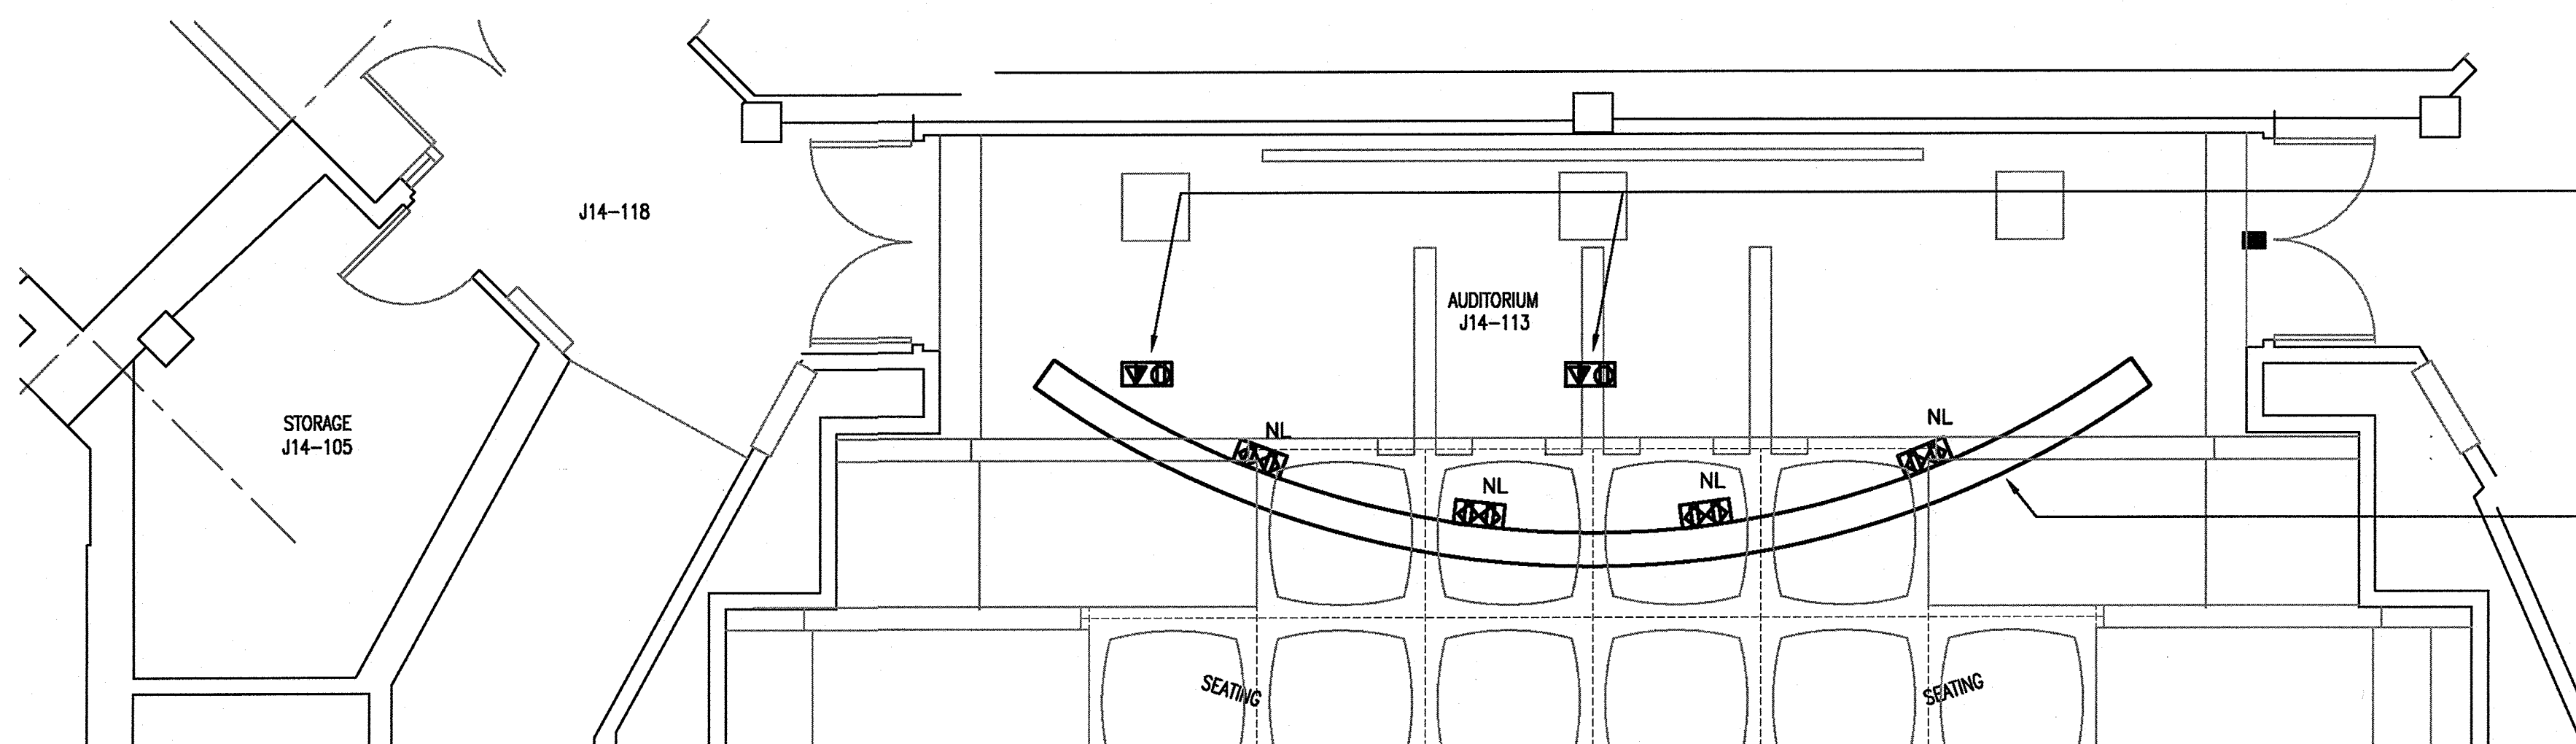

NEW OVERHEAD LIGHTING TRUSS TO BE SUSPENDED FROM STRUCTURE. MOUNTING METHOD TO BE SIGNED AND STAMPED BY A PEGNL LICENSED PROFESSIONAL STRUCTURAL ENGINEER. TRUSS TO BE SUPPLIED AND INSTALLED BY ELECTRICAL DIVISION. SEE SPECIFICATION SECTION 26 50 00. SEE STAGE LIGHTING RISER ON THIS DRAWING FOR CIRCUIT DETAILS.





**STAGE POWER PLAN**

SCALE: 1:50



RECESSED MOUNTED MULTIMEDIA OUTLETS. SUPPLY AND INSTALL NEW 15A, 120V BRANCH CIRCUIT (2 SUCH) AND NEW 15A 1P CIRCUIT BREAKER (2 SUCH) FROM NEAREST PANEL WITH SPARE CAPACITY. IC RATING TO MATCH. 2#12RW90 + 1#12 TW GROUND IN 21MM EMT CONDUIT PER CIRCUIT. PROVIDE 2 SPARE 27mm CONDUIT C/W PULL ROPE FOR EACH MULTIMEDIA OUTLET. CONDUIT TO BE RUN IN CONCRETE FLOOR. SPARE CONDUIT TO BE STUBBED INTO CEILING SPACE OF CORRIDOR J14-118. ALL CONDUIT TO BE CONCEALED.

NEW OVERHEAD LIGHTING TRUSS TO BE SUSPENDED FROM STRUCTURE. MOUNTING METHOD TO BE SIGNED AND STAMPED BY A PEGNL LICENSED PROFESSIONAL STRUCTURAL ENGINEER. TRUSS TO BE SUPPLIED AND INSTALLED BY ELECTRICAL DIVISION. SEE SPECIFICATION SECTION 26 50 00. SEE STAGE LIGHTING RISER ON THIS DRAWING FOR CIRCUIT DETAILS.

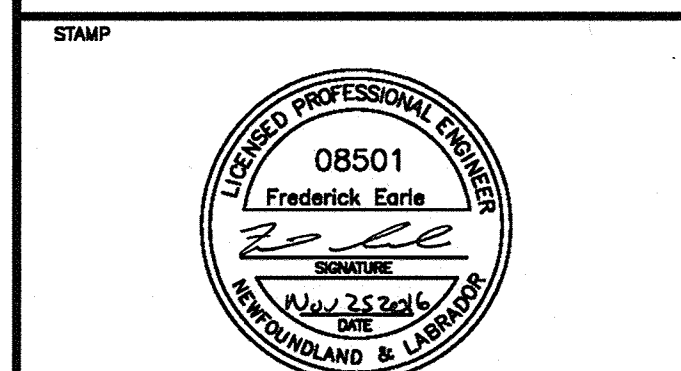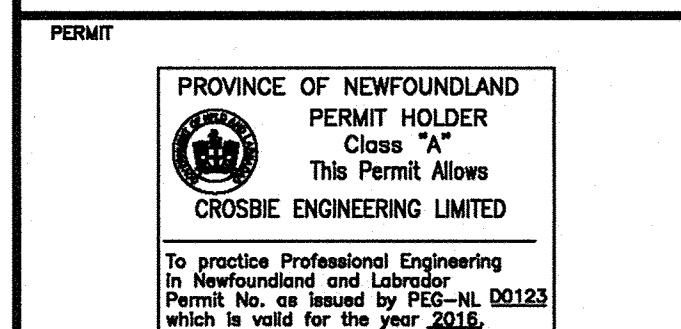


O	ISSUED FOR TENDER	11/18 2016
B	ISSUED FOR PRE-TENDER REVIEW	11/01 2016
A	ISSUED FOR REVIEW	10/28 2016
revisions		date
project		project

**NORTHWEST ATLANTIC  
FISHERIES CENTRE  
ST. JOHN'S, NL  
AUDITORIUM UPGRADES**



**STAGE LIGHTING,  
POWER & DETAILS**

designed	F.E.	conçu
date	November 2016	
drawn	B.C.	dessiné
date	November 2016	
approved	F.E.	approuvé
date	November 2016	
Tender	2016-11-30	Soumission
PWGSC Project Manager	Administrateur de projets TPSC	
project number		no. du projet
	R.081909.001	
drawing no.		no. du dessin
	E4	

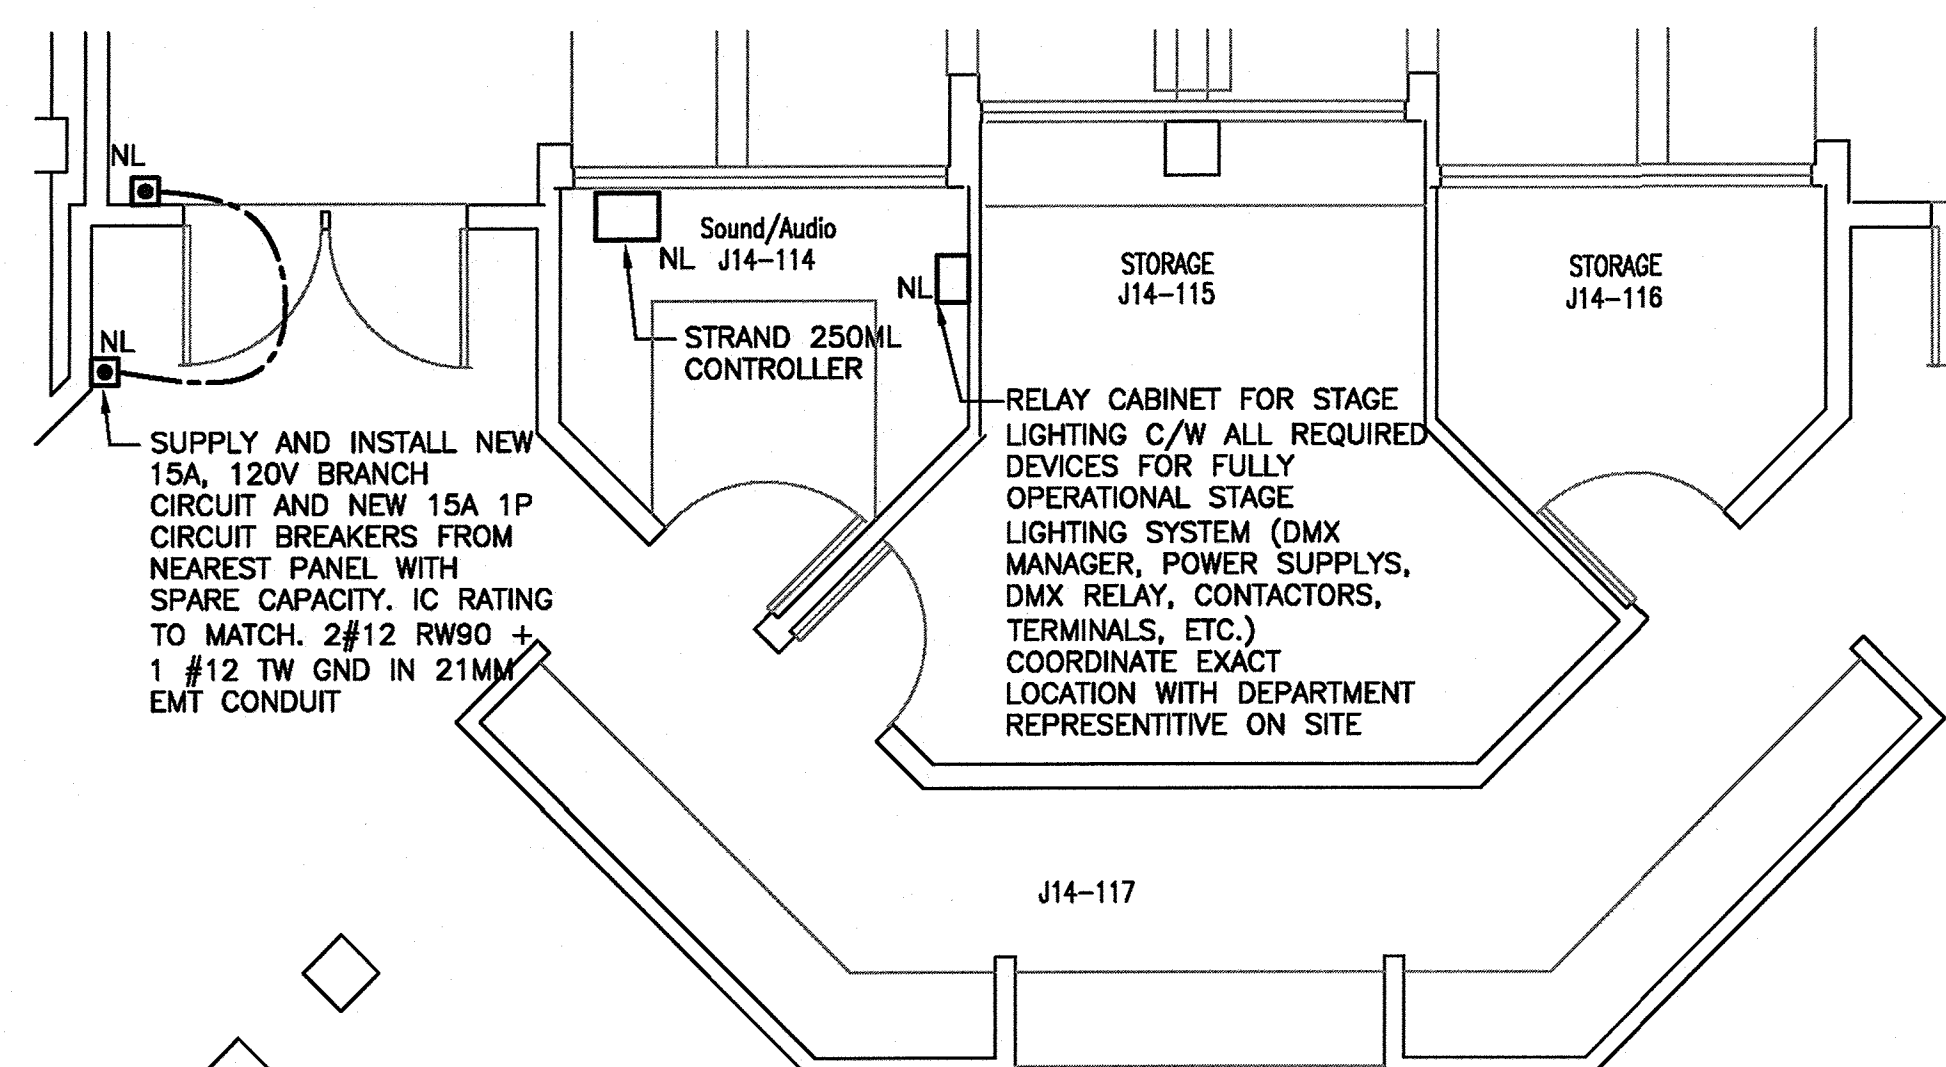

**LIGHTING AND DOOR CONTROL  
EQUIPMENT LAYOUT**

SCALE: 1:50

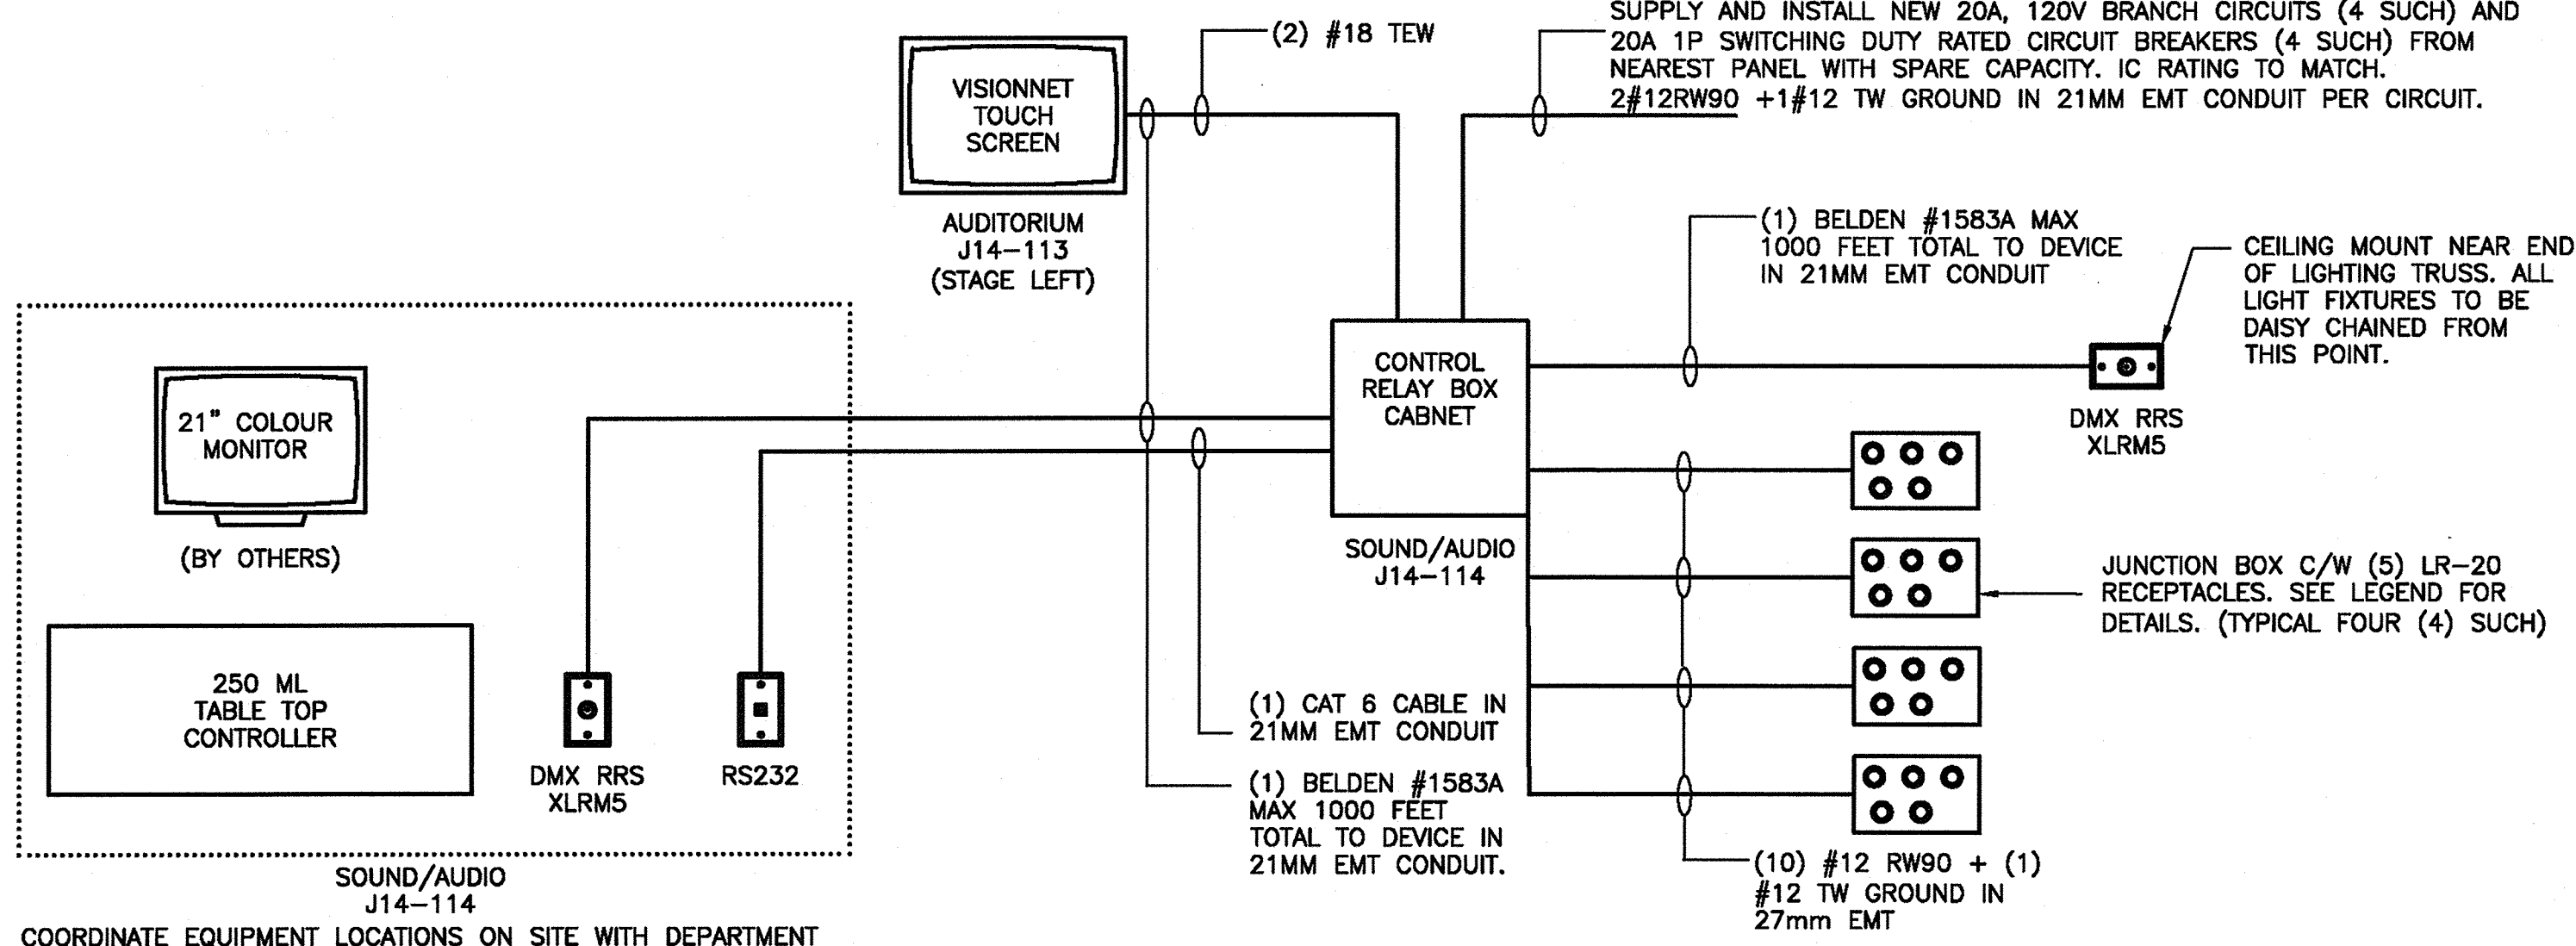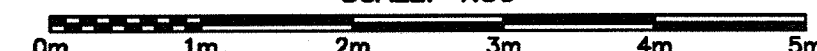

**STAGE LIGHTING RISER**  
N.T.S.