



BROKEN LINE INDICATES EXISTING DEVICE. SOLID LINE INDICATES NEW.

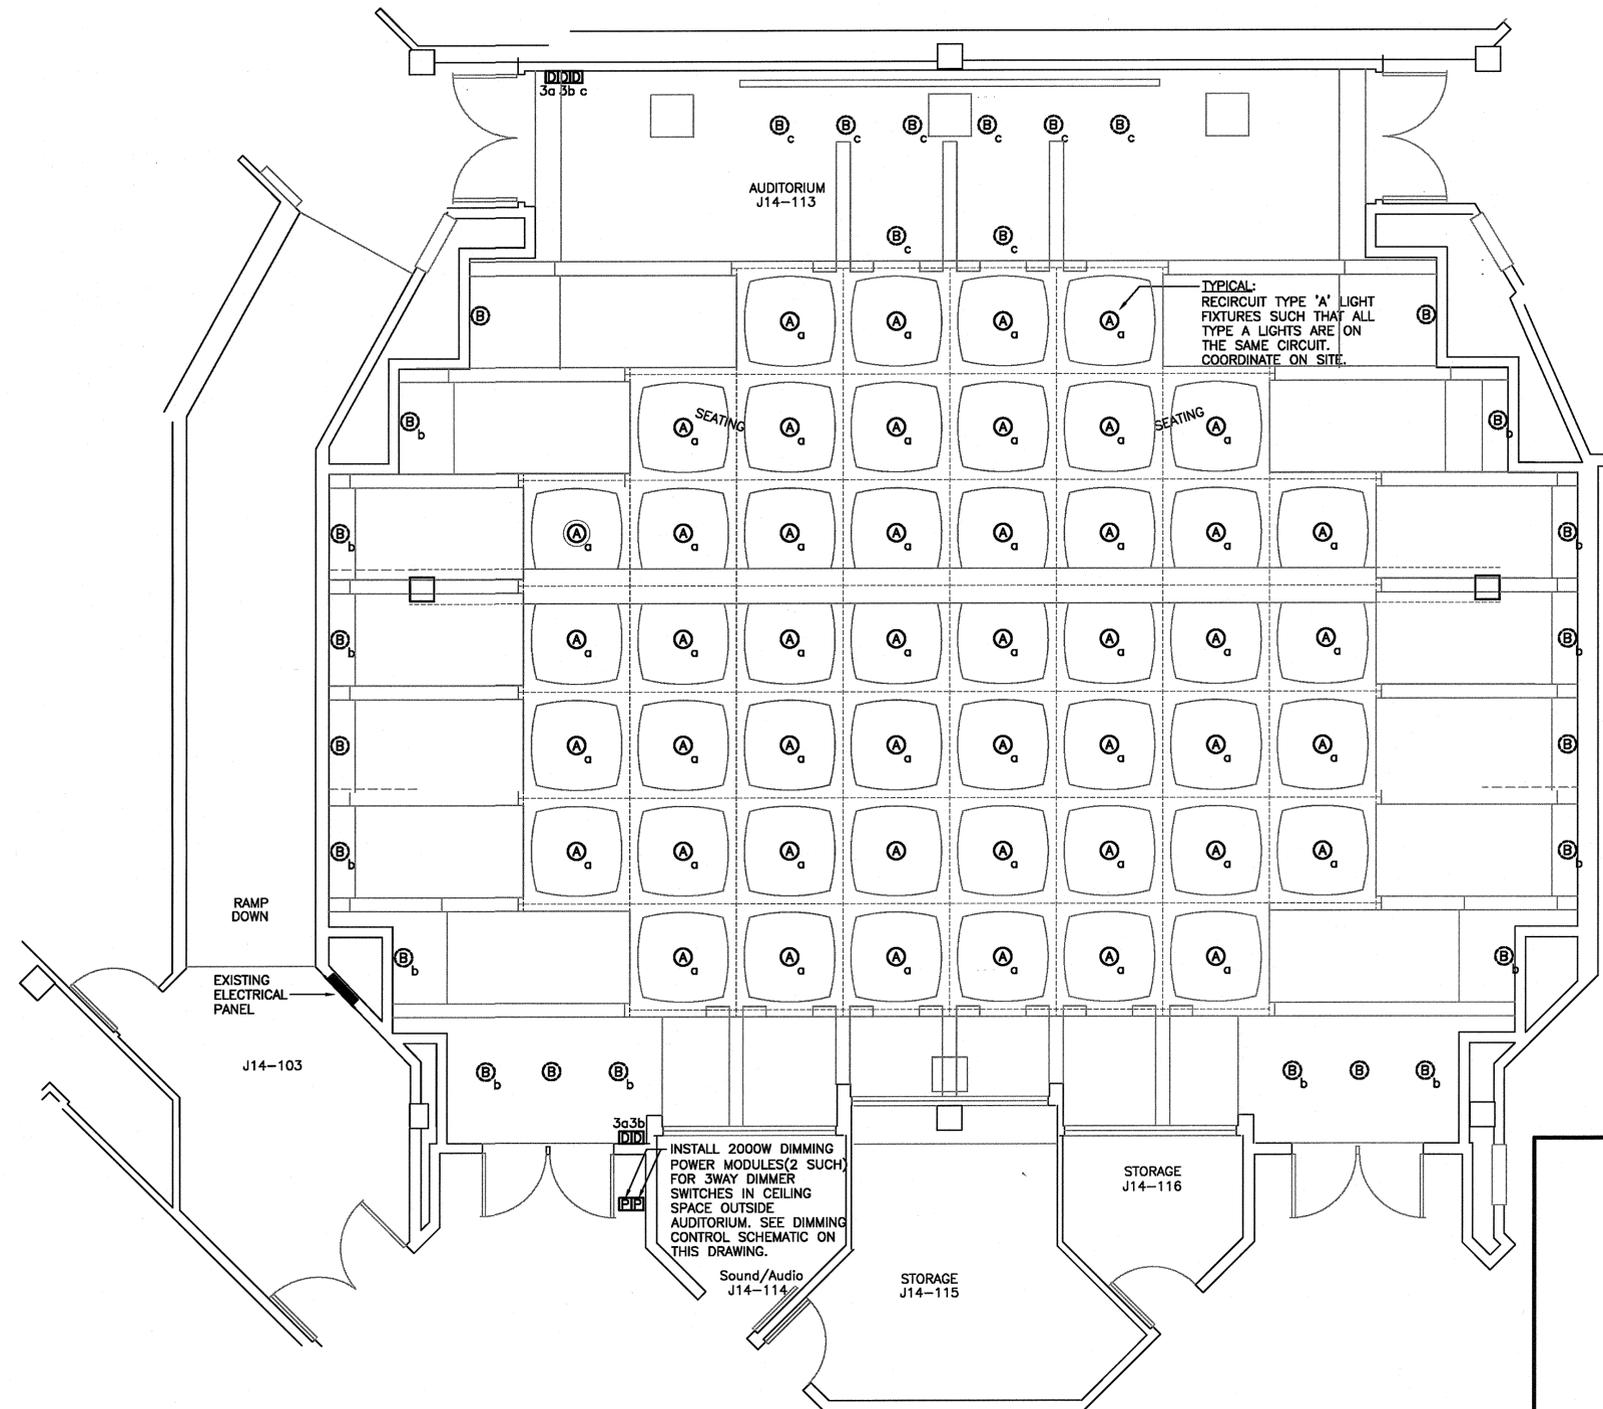


TYPICAL: RECURRING TYPE 'A' LIGHT FIXTURES SUCH THAT ALL TYPE 'A' LIGHTS ARE ON THE SAME CIRCUIT. COORDINATE ON SITE.

INSTALL 2000W DIMMING POWER MODULES (2 SUCH) FOR 3WAY DIMMER SWITCHES IN CEILING SPACE OUTSIDE AUDITORIUM. SEE DIMMING CONTROL SCHEMATIC ON THIS DRAWING.

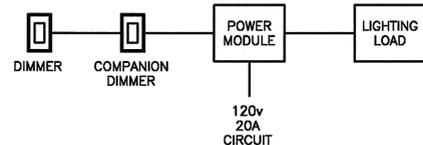


SUPPLY AND INSTALL NEW 20A, 120V BRANCH CIRCUIT AND NEW 20A 1P CIRCUIT BREAKER FROM NEAREST PANEL WITH SPARE CAPACITY. IC RATING TO MATCH. 2#12RW90 +1#12 TW GROUND IN 27MM EMT CONDUIT

LIGHTING PLAN  
SCALE: 1:50

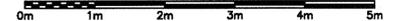

PERMIT  
PROVINCE OF NEWFOUNDLAND  
PERMIT HOLDER  
Class "A"  
This Permit Allows  
CROSBIE ENGINEERING LIMITED  
To practice Professional Engineering in Newfoundland and Labrador  
Permit No. as issued by PEG-AL 00123  
which is valid for the year 2016.

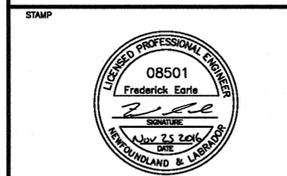

revisions	date	project
0	ISSUED FOR TENDER	11/18 2016
B	ISSUED FOR PRE-TENDER REVIEW	11/01 2016
A	ISSUED FOR REVIEW	10/28 2016

NORTHWEST ATLANTIC FISHERIES CENTRE  
ST. JOHN'S, NL  
AUDITORIUM UPGRADES

drawing dessin

LIGHTING PLAN & DETAILS

designed F.E.	conçu
date November 2016	
drawn B.C.	dessiné
date November 2016	
approved F.E.	approuvé
date November 2016	
Tender 2016-11-30	Soumission
PWGS/Project Manager	Administrateur ds. projets TPSGC
project number	no. du projet
<b>R.081909.001</b>	
drawing no.	no. du dessin
<b>E3</b>	