

Staff Housing - Waterton Lakes National Park

PHASE 2

DEMOLITION SITE
MUNICIPAL ADDRESS: WATERTON LAKES NATIONAL PARK
LEGAL ADDRESS: 1 COMPOUND RD., WATERTON, WATERTON LAKES NATIONAL PARK, AB
ZONING: N/A

LOTS 20 & 21
MUNICIPAL ADDRESS: 102 & 104 WIND FLOWER AVENUE, WATERTON, WATERTON LAKES NATIONAL PARK
LEGAL ADDRESS: LOTS 20 & 21 BLOCK 42 PLAN 5854DK
ZONING: INSTITUTIONAL



RENDERING IS A CONCEPT ONLY, REFER DRAWINGS FOR INFORMATION REGARDING CONSTRUCTION AND FINISHES

ISSUED FOR : BUILDING PERMIT/TENDER
ISSUE DATE: DECEMBER 08, 2016

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GEOTECHNICAL




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ENVIRONMENTAL




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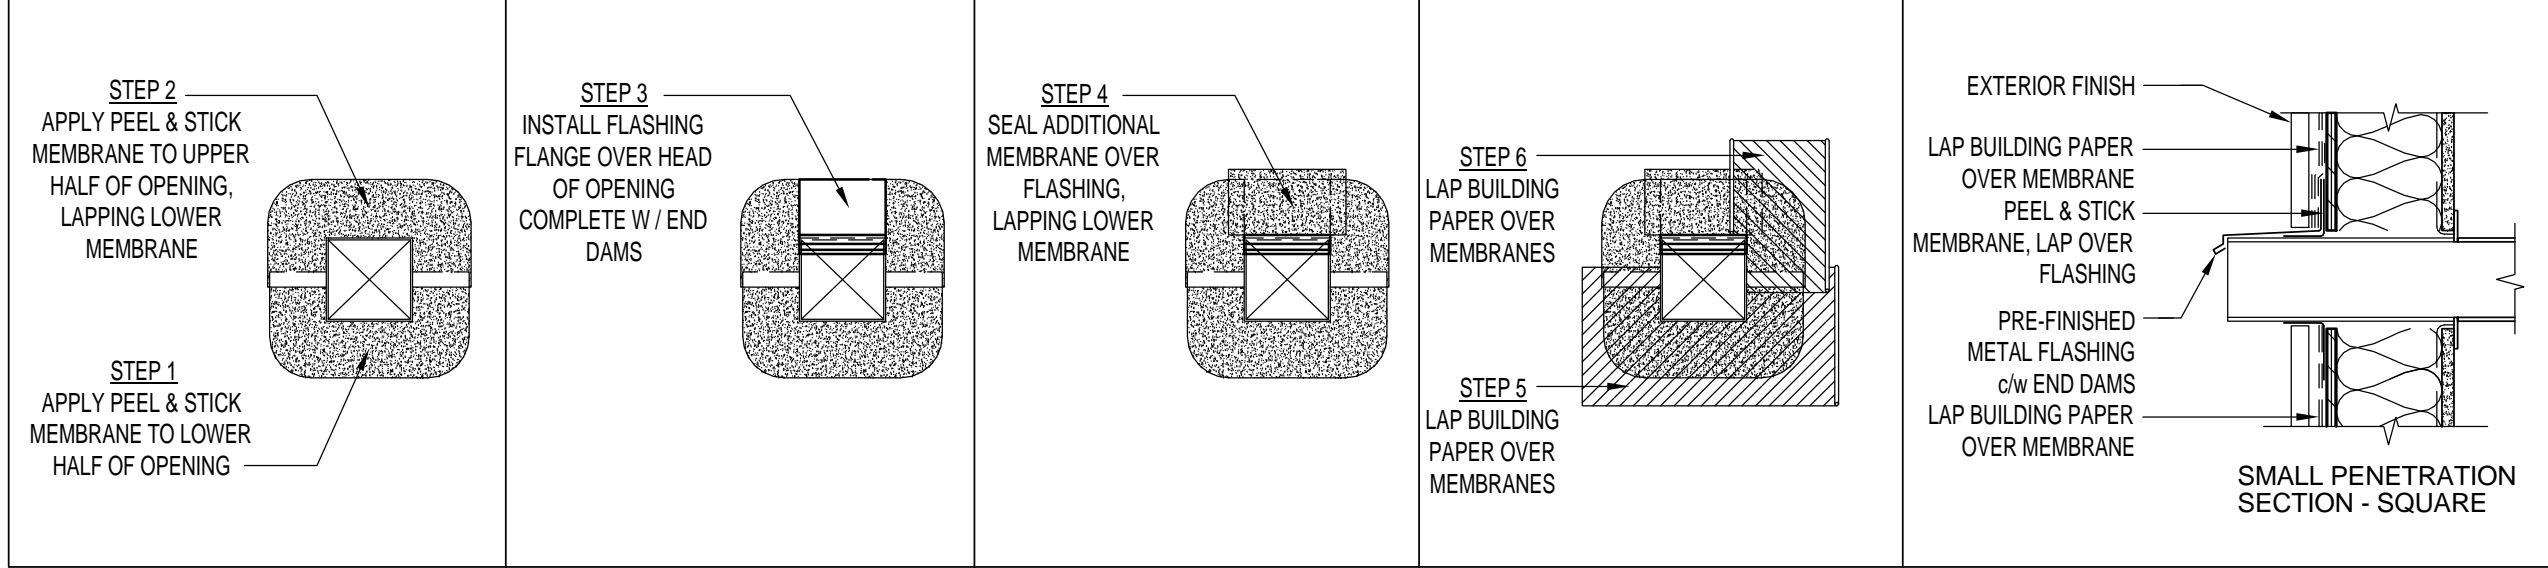
ABBREVIATIONS

ABV.	Above	LAV.	Lavatory
ACOUST.	Acoustical	L.P.	Low Point
ACT.	Acoustic Tiles on T-bar	MAS'Y	Masonry
A.F.F.	Above Finished Floor	MAX.	Maximum
ALUM./AL.	Aluminum	M.C.W.	Metal Clad Wood
ARCH.	Architectural	MECH.	Mechanical
A.T.O.	Above Trench Drain	MET.	Metal
A.V.B.	Air Vapour Barrier	MFD.	Manufactured
BD.	Board	MFR.	Manufacturer
BLK.	Block	M.I.	Metal Insulated
BM.	Beam	MIN.	Minimum
BOT.	Bottom	MIR.	Minor
CAB.	Cabinet	MISC.	Miscellaneous
C.C.	Center to Center	M.R.D.	Metal Roof Deck
CEIL./CLG.	Ceiling	MTD	Mounted
CER./C.T.	Ceramic Tile	MTL.	Material(s)
CHAN.	Channel	MWK.	Milwork
CHT.	Ceiling Height	N.I.C.	Not in Contract
C.I.P.	Cast in Place	NO. or #	Number
C.J.	Control Joint	N.T.S.	Not to Scale
CL.	Centerline	O.C.	On Center
CMU	Concrete Masonry Unit	O.H	Overhead
COL.	Column	OPNG.	Opening
CONC.	Concrete	O.S.B.	Oriented Strand Board
CONSTR.	Construction	PERIM.	Perimeter
CONT.	Continuous	PL.	Plate
CONTR.	Contractor	P.LAM.	Plastic Laminate
CORR.	Corridor	PLN.	Panel
C.S.	Computer Station	PLY.	Plywood
C.W.	Complete With	POL.Y.	Polyethylene
D	Depth	PREFIN.	Prefinished
DET.	Detail	P.T.	Pressure Treated
D.F.	Drinking Fountain	PTD.	Painted
DIA.	Diameter	PVC.	Polyvinyl Chloride
DIM.	Dimension	P.W.	Pressed Wood
DN.	Down	R	Riser
DR.	Drain	R./RAD.	Radius
DWG.	Drawing	R.D.	Roof Drain
E.I.F.S.	Ext. Insulation Finish System	RE:	Reference, Refer to
E.J.	Expansion Joint	REINFMNT	Reinforcement
ELE./ELEV.	Elevations	REQD	Required
ELECT.	Electrical	REV.	Reverse
ENT.	Entrance	R.W.L.	Rain Water Leader
EQ.	Equal	RESIST.	Resistant
EOP.	Equipment	R.O.	Rough Opening
E.P.	Electrical Panelboard	RM.	Room
EXP.	Expansion	SAN.	Sanitary
EXT.	Exterior	SCHED.	Schedule
F.A.P.	Fire Alarm Panelboard	S.C.W.	Solid Core Wood
F.D.	Floor Drain	SEAL.	Sealant
FDN.	Foundation	SECT.	Section
F.E.C.	Fire Extinguisher Cabinet	SHR.	Shower
F.F.D.	Funnel Floor Drain	SHT.	Sheet
F.H.C.	Fire Hose Cabinet	SHTG.	Sheeting
FIN.	Finish	SIM.	Similar
FL./FLR.	Floor	SPECS.	Specifications
FLG.	Flashing	S.S.	Stainless Steel
F.O.	Face Of	STD.	Standard
F.O.C.	Face Of Concrete	STL.	Steel
F.O.F.	Face Of Finish	STOR.	Storage
F.O.M.	Face Of Masonry	STRUC.	Structural
F.O.S.	Face Of Stud	S.U.	Sealed Unit
F.R.P.	Fibre Reinforced Plastic	SUSP.	Suspended
FTG.	Footing	S.V.	Sheet Vinyl
F.T.P.	Floor Transition Pattern	SYM.	Symmetrical
F.T.S.	Floor Transition Strip	T.	Tread
FUR.	Furring	THK.	Thick
GA.	Gauge	THRES.	Threshold
GALV.	Galvanised	T.O.	Top of
G.B.	Grab Bar	T.O.C.	Top of Concrete
G.C.	General Contractor	T.O.D.	Top of Deck
G.I.S.	Good One Side	T.O.F.	Top of Framing
GL.	Glass	T.O.M.	Top of Masonry
G.S.	Galvanized Steel	T.O.P.	Top of Parapet
GW.B.	Gypsum Board	T.O.S.	Top of Slab
G.2.S.	Good Two Side	T.O.W.	Top of Wall
H.	High	T.T.B.	Telephone Terminal Board
Hc.	Handicapped	TYP.	Typical
H.C.W.	Hollow Core Wood	U.N.O.	Unless Noted Otherwise
H.D.	High Density	U/S	Underside
H.M.	Hollow Metal	V.	Vent
H.M.I.	Hollow Metal Insulated	V.B.	Vapour Barrier
H.O.B.	Handicap Operator Button	VENT.	Ventilation
HOR.	Horizontal	VERT.	Vertical
H.P.	High Point	VEST	Vestibule
HR.	Hour	V.O.S.	Verify on Site
H.S.S.	Hollow Structural Section	W.	Width
HT.	Height	W/	With
I.S.M.	Inside Measurement	W.C.	Water Closet
INSUL.	Insulation	WD.	Wood
INT.	Interior	WDW.	Window
ITC.	Intercom	W.GL.	Wire Glass
JAN.	Janitor	W/O	Without
JT.	Joint	WP.	Waterproof
KIT.	Kitchen	W.P.T.	Work Point
K.P.	Kick Plate	WR.	Washroom
LAM.	Laminate		

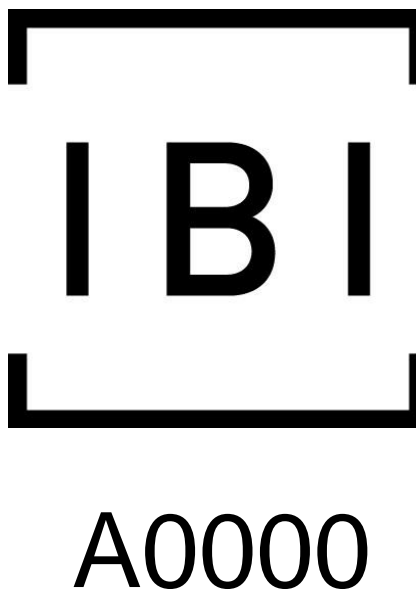DRAWING REFERENCE SYMBOLS



SMALL PENETRATION IN EXTERIOR WALL - SQUARE

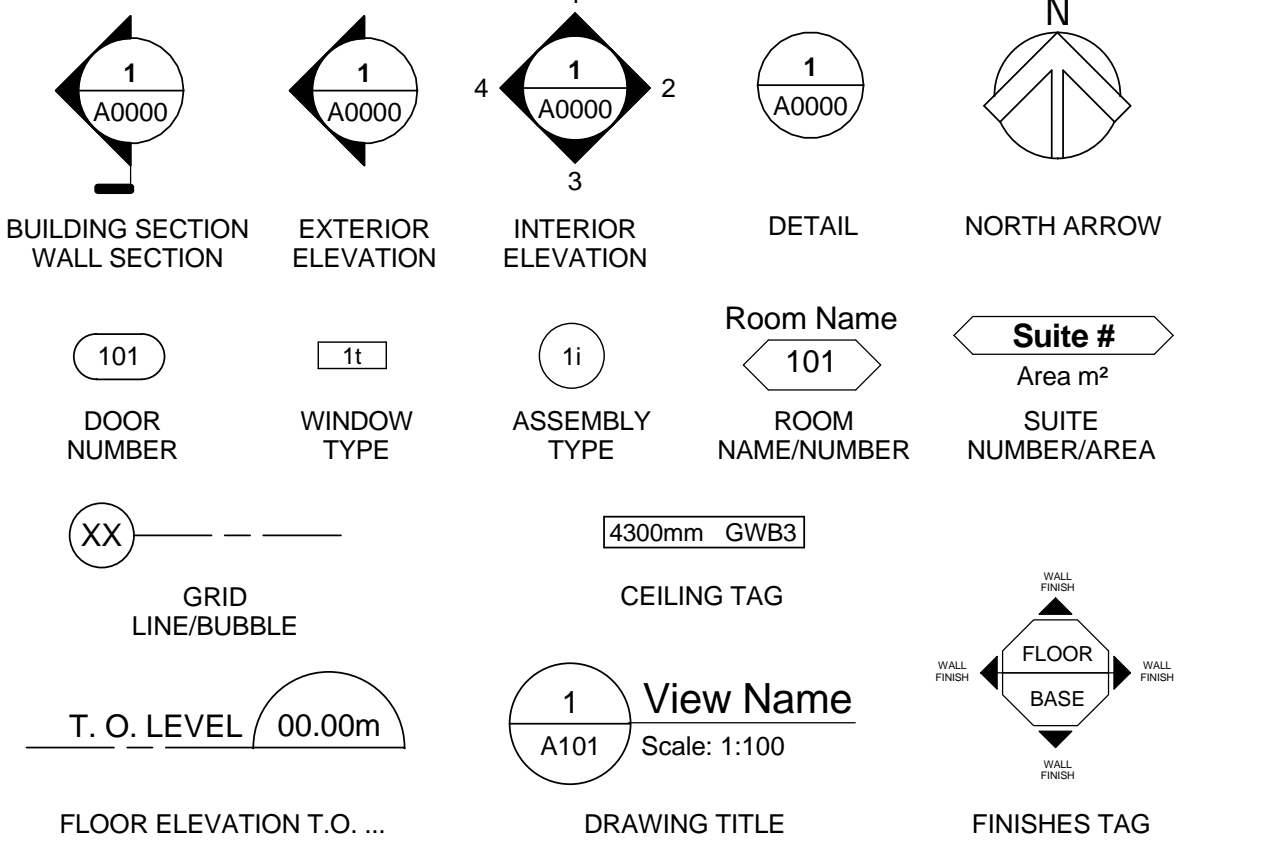

BUILDING CODE N.B.C. 2015 SUMMARY

BUILDING CODE REVIEW - NBC 2015

BUILDING AREA	860.20 sq. m.	9,259.10 sq. ft.
BUILDING CLASSIFICATION	GROUP C - Residential Section 3.2.2.53, up to 3 Storeys	
	• The building is 2 Storeys in Heights facing 3 Streets (Fountain Avenue, Windflower Avenue & Lane)	
	• The building is less than 1,350 sq. m. in area	
	• The building is of Combustible Construction with Floor Assemblies as fire separations with a fire resistance rating of 45 min.	
APPLICABLE CODE SECTIONS	3.3.1.9 Corridors - The minimum width of a public corridor shall be 1100 mm.	
	3.3.1.4 Corridors - a public corridor shall be separated from the remainder of the storey by a fire separation not less than 45 min.	
	3.3.1.22 Common Laundry Rooms - in a building of residential occupancy, a laundry room in a floor area that is not within a dwelling units shall be separated from the remainder of the building by a fire separation having a fire-resistance rating not less than 1 h, which is reduced to 45 min. in Sentence (2).	
	3.3.4.2 Fire Separations - Suites of residential occupancy shall be separated from each other and the remainder of the floor area by a fire separation having a fire resistance rating not less than 1 hr, which is reduced to 45 min. in Sentence (2).	
	3.3.4.3 Storage Rooms - Sprinklers shall be installed in a storage room provided for the use of tenants in a residential occupancy within a floor area but not contained within a suite.	
	3.4.2.1 Every floor area intended for occupancy shall be served by at least 2 exits.	
	3.4.4.1 Fire Resistance Rating of Exit Separations - every exit shall be separated from the remainder of the building by a fire separation having a fire-resistance rating not less than that required by Subsection 3.2.2, but not less than 45-min.	
	3.6.2.1 Service Rooms - Mechanical and Electrical rooms shall be separated from the remainder of the building by fire separations having a fire-resistance rating not less than 1h.	
	3.6.3.1 Vertical Service Spaces and Service Spaces - shall be separated from all other portions of each adjacent storey by a fire resistance separation having a fire resistance rating conforming to tables 3.6.3.1 for the fire resistance rating required by Subsection 3.2.2.	
	3.6.4.4 Attic or Roof Space Access - an attic or roof space more than 600 mm high shall be provided with access from the floor immediately below by a hatchway not less than 550 mm by 900 mm or by a stairway.	
	3.8.1 The requirements for Barrier Free Design does not apply to boarding houses.	
	5.9.1.2 Dwelling units to be separated from the rest of building by assemblies with an STC 50.	

ENERGY CODE COMPLIANCE - NECB 2015

Part 3	Building Envelope Design	Perscriptive Compliance
Part 4	Lighting Design	Perscriptive Compliance
Part 5	HVAC Design	Perscriptive Compliance
Part 6	Service Water Heating Design	Perscriptive Compliance
Part 7	Electrical Power Systems & Motors	Perscriptive Compliance


GENERAL NOTES

- THE REQUIREMENTS OF THE NBC 2015 SHALL FORM AN INTEGRAL PART OF THESE DRAWINGS. ALL CONSTRUCTION MATERIALS AND PROCEDURES SHALL CONFORM TO THIS STANDARD.
- THESE DRAWINGS ARE TO BE READ IN CONJUNCTION W/ LANDSCAPE, STRUCTURAL, MECHANICAL, ELECTRICAL, CIVIL & BUILDING ENVELOPE DRAWINGS. IN THE EVENT OF ANY DISCREPANCY, THE ARCHITECT SHALL BE NOTIFIED BEFORE WORK COMMENCES.
- THE CONTRACTOR SHALL CHECK & VERIFY DIMENSIONS & DETAILS FOR COMPATIBILITY W/ ALL CONSULTANT DRAWINGS PRIOR TO COMMENCING WORK. DISCREPANCIES SHALL BE REPORTED TO THE ARCHITECT IMMEDIATELY. THE CONTRACTOR SHALL NOT SCALE THE DRAWINGS.
- ALL STANDARDS OF CONSTRUCTION SHALL COMPLY W/ THE NBC 2015 AND ANY SPECIAL REQUIREMENTS OF THE LOCAL AUTHORITIES HAVING JURISDICTION.
- ALTERNATES WHICH RESULT IN A CREDIT FOR THE OWNER SHALL BE REVIEWED BY THE ARCHITECT. HOWEVER, UNTIL A REVISION HAS BEEN ISSUED BY THE ARCHITECT, EXACT DETAILS SHOWN ON THE DRAWING MUST BE ADHERED TO; OTHERWISE CONSTRUCTION WILL BE REJECTED & THE CONTRACTOR CHARGED FOR REMEDIAL WORK & FOR INSPECTION. CONTRACTOR SHALL BE RESPONSIBLE FOR THE FULL VALUE OF THE RESULTING CHANGES.
- THE CONTRACTOR MUST VISIT & EXAMINE THE BUILDING SITES & NOTE THE EXACT NATURE OF EXISTING ELEMENTS INVOLVED IN THE WORK TO BE PERFORMED.

- a. ENSURE THE CONTINUITY OF FIRE-RATED ASSEMBLIES LOCATED BEHIND PLUMBING WALLS.
- b. PROVIDE FIBREGLASS-FACED WALL BOARD WHERE REQUIRED FOR BATHROOM TILE FINISH - REFER TO INTERIOR ELEVATION DRAWINGS. PROVIDE ADDITIONAL 13mm GYPSUM BOARD IF REQUIRED FOR CONTINUOUS WALL SURFACE.

- c. ELECTRICAL BOX HEIGHTS WILL BE MOUNTED AT 400mm A.F.F. MINIMUM. TYPICAL WHERE A CABINET EXISTS, AN ELECTRICAL PLUG WILL BE MOUNTED 300mm ABOVE THE TOP OF FINISHED COUNTER HEIGHT.
- d. PROVIDE SOLID BLOCKING BETWEEN STUDS FOR GRAB BARS, TOWEL BARS AND OTHER BATHROOM FIXTURES WHERE REQUIRED. COORDINATE LOCATIONS OF GRAB BARS WITH BATHROOM TUB AND SHOWER SUPPLIER.
- e. ELECTRICAL BOXES LOCATED IN PARTY WALLS SHALL BE INSTALLED IN SEPARATE CAVITIES ON THE OPPOSITE SIDES OF STUDS.
- f. ENSURE CONTINUITY OF FIRE RATING - PROVIDE TYPE "X" GYPSUM BOARD ASSEMBLIES.
- g. ALL DRAIN WASTE AND VENT PIPING TO BE LOCATED OUTSIDE FIRE RATED CORRIDORS WALLS, PARTY WALLS, AND EXIT ENCLOSURE WALLS.
- h. INSULATION USED IN THE EXTERIOR WALLS TO CONFORM TO CSA A101-M WITH THE MINIMUM MASS NOT LESS THAN 1.2kg/m² OF WALL SURFACE.
- i. PROVIDE CONTINUOUS ACOUSTIC CAULKING ON ALL PARTY AND CORRIDOR WALL JOINTS OR TRANSITIONS.
- j. PROVIDE SOLID BLOCKING IN THE CEILING OF ALL BEDROOMS FOR POSSIBLE FUTURE CEILING FANS. TO BE COORDINATED W/ ELECTRICAL DRAWINGS.
- k. PLAN DIMENSIONS ARE TO FACE OF STUDS AND GRIDS - U.N.O.

WINDOW INSTALLATION - SELF-ADHERING MEMBRANE SEQUENCE

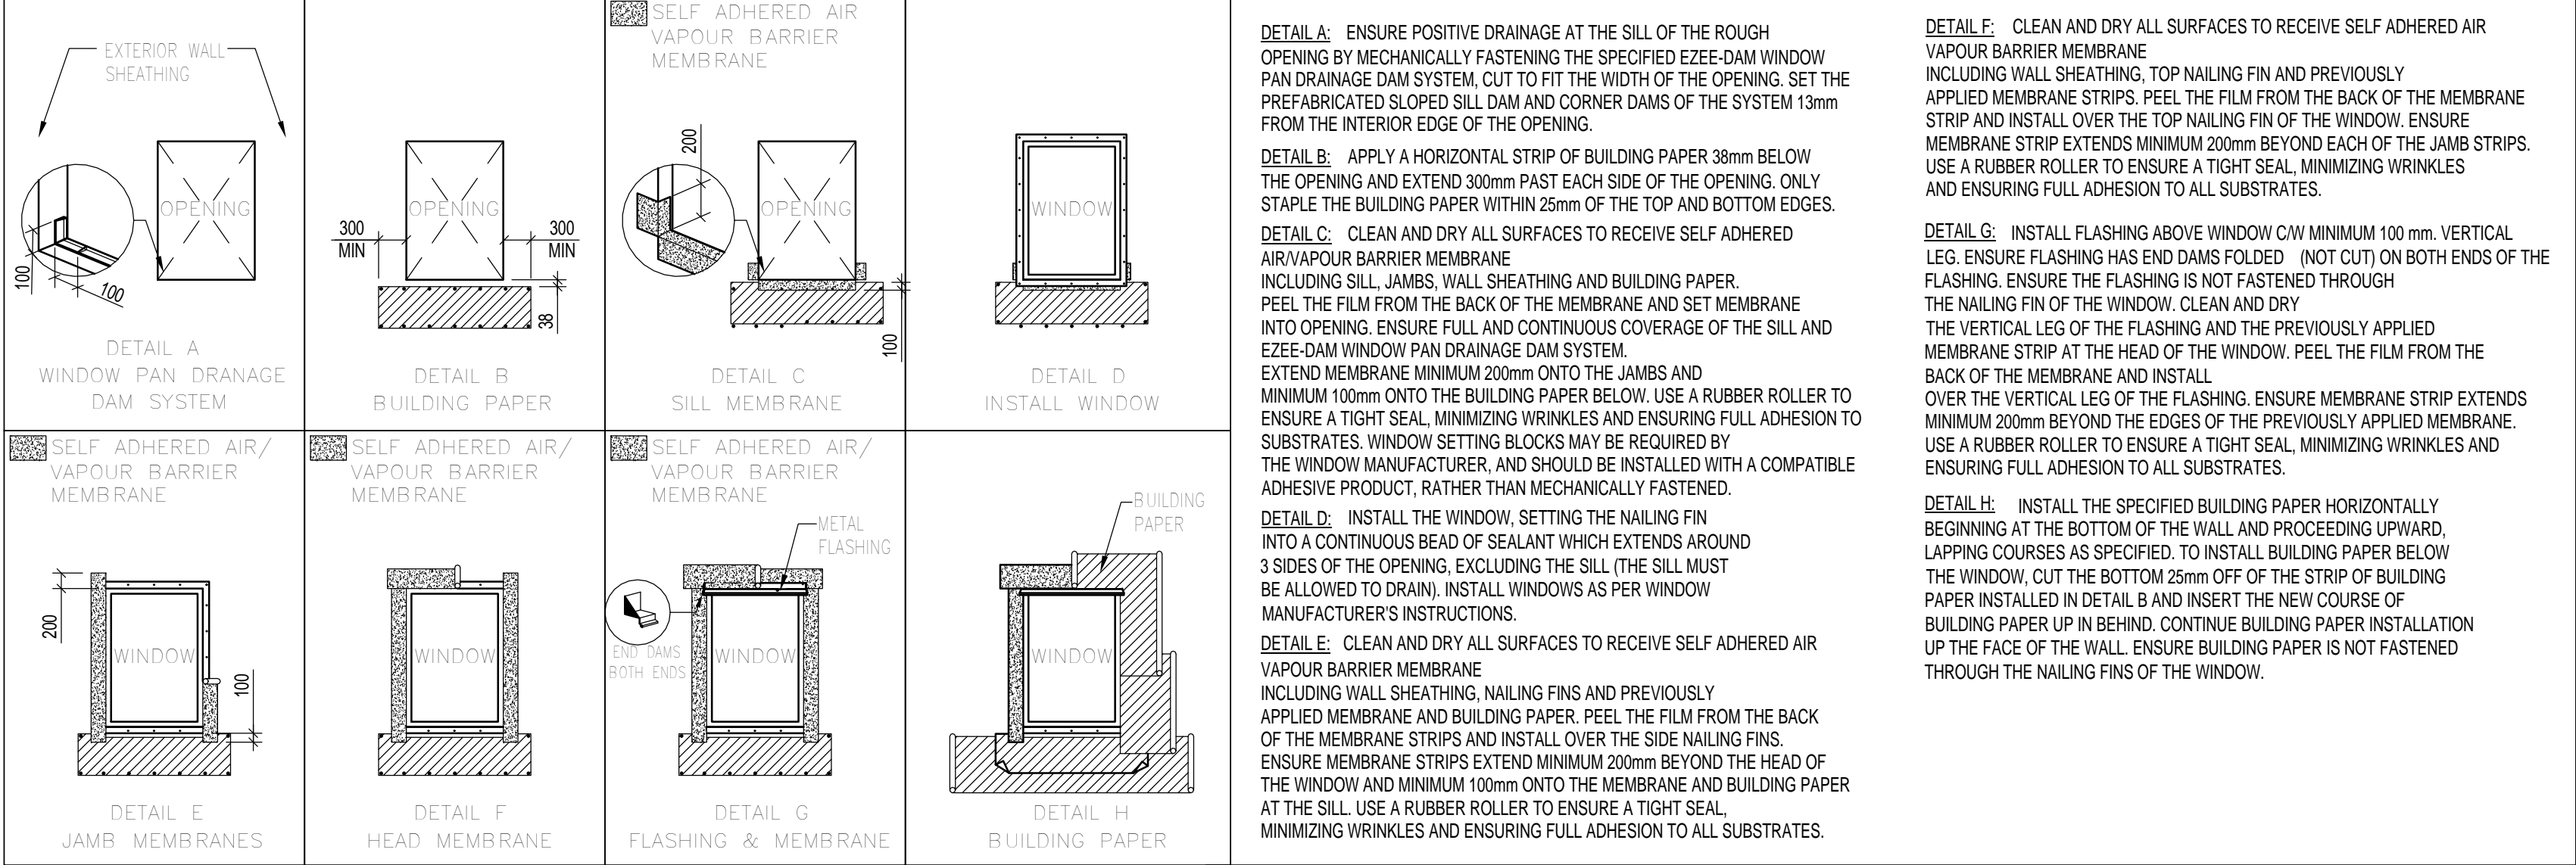

DRAWING LIST

ARCHITECTURAL

A000	COVER PAGE
A001	GENERAL INFORMATION
A011	BUILDING ASSEMBLIES
A021	FIRE SEPARATION PLANS & FIRE SEPARATION SECTIONS
A022	FIRE SEPARATION TYPICAL DETAILS
A031	WINDOW TYPES W/ WINDOW FRAME TYPES & DOOR TYPES W/ DOOR FRAME TYPES & DOOR SCHEDULE
A101	SURVEY SITE PLAN - LOTS 20 & 21
A111	SITE PLAN - NEW CONSTRUCTION LOTS 20 & 21
A121	SITE, CANOPY & RAMP DETAILS
A122	FRONT ENTRY CANOPY
A131	BUNKHOUSE DEMOLITION AND REMEDIATION SITE PLAN
A132	BUNKHOUSE DEMOLITION
A141	SITE PLAN - DEMOLITION - LOTS 20 & 21
A201	BASEMENT FLOOR PLAN & ROOF PLAN
A202	MAIN FLOOR PLAN & LOFT FLOOR PLAN
A211	ENLARGED FLOOR-FINISHES PLAN - BASEMENT LEVEL-WEST
A212	ENLARGED FLOOR-FINISHES PLAN - BASEMENT LEVEL-EAST
A213	ENLARGED FLOOR-FINISHES PLAN - MAIN LEVEL-WEST
A214	ENLARGED FLOOR-FINISHES PLAN - MAIN LEVEL-EAST
A215	ENLARGED FLOOR-FINISHES PLAN - LOFT LEVEL-WEST
A216	ENLARGED FLOOR-FINISHES PLAN - LOFT LEVEL-EAST
A221	REFLECTED CEILING PLAN - BASEMENT LEVEL
A222	REFLECTED CEILING PLAN - MAIN LEVEL & LOFT LEVEL
A301	VERTICAL CIRCULATION - STAIR 01 & STAIR 02 FLOOR PLANS, SECTIONS & STANDARD DETAILS

A401	BUILDING ELEVATIONS
A402	BUILDING ELEVATIONS - WINDOW TRIM
A501	BUILDING SECTIONS
A601	WALL SECTIONS
A602	WALL SECTIONS
A603	WALL SECTIONS
A604	WALL SECTIONS

ENVELOPE MANDATORY MEASURES

DOORS & WINDOWS: MANUFACTURERS OF FENESTRATION PRODUCTS MUST CERTIFY THAT THE PRODUCTS MEET AIR INFILTRATION & U-VALUE REQUIREMENTS OF CAN/ CSA- A440, LATEST EDITION & CANADIAN SUPPLEMENT TO NAFS-08.

UNFRAMED GLASS DOORS & FIRE DOORS ARE THE TWO EXCEPTIONS TO THESE REQUIREMENTS.

MANUFACTURED DOORS & WINDOWS MUST BE TESTED & SHOWN TO HAVE AIR INFILTRATION RATES NOT EXCEEDING 0.37 CFM/ SF OF DOOR AREA FOR SLIDING & SWING DOORS, & 1.0 CFM/ SF OF DOOR AREA FOR DOUBLE SLIDING & SWING DOORS.

JOINTS & OPENINGS: JOINTS & OTHER OPENINGS IN THE BUILDING ENVELOPE THAT ARE POTENTIAL SOURCES OF AIR LEAKAGE SHALL BE CAULKED, GASKETED, WEATHERSTRIPPED, OR OTHERWISE SEALED TO LIMIT AIR LEAKAGE INTO & OUT OF THE BUILDING. THIS APPLIES TO PENETRATIONS FOR PIPES & CONDUITS, DUCTS, VENTS, & SUCH GAPS BETWEEN WALL PANELS, AROUND DOORS & WINDOWS, & OTHER CONSTRUCTION JOINTS MUST BE WELL SEALED.

INSULATION: PER DRAWINGS.

ARCHITECTURAL (CONT.)

A701	PLAN DETAILS
A702	PLAN DETAILS
A801	SECTION DETAILS
A802	SECTION DETAILS
A803	SECTION DETAILS
A901	KITCHEN PLANS & ELEVATIONS
A902	KITCHEN PLANS & ELEVATIONS
A903	SUITE A - PLANS & ELEVATIONS
A904	BATHROOM PLANS & ELEVATIONS
A905	BATHROOM PLANS & ELEVATIONS
A906	BATHROOM / JANITOR PLANS & ELEVATIONS
A907	CABINET/INTERIOR SECTIONS & DETAILS

CIVIL

C102	STAFF HOUSING GRADING PLAN
C103	STAFF HOUSING GRADING PLAN DETAIL SHEET

STRUCTURAL

S001	GENERAL NOTES
S002	GENERAL NOTES
S003	DESIGN NOTES
S004	3D REFERENCE VIEWS
S005	ROOF LOADING PLAN
S010	TYPICAL DETAILS
S011	TYPICAL DETAILS
S012	TYPICAL DETAILS
S200	BASEMENT & MAIN FLOOR FRAMING PLAN
S201	BASEMENT PLAN -WEST
S202	BASEMENT PLAN -EAST
S203	MAIN FLOOR FRAMING -WEST
S204	MAIN FLOOR FRAMING PLAN -EAST
S210	LOFT & ROOF FRAMING PLAN
S211	LOFT FRAMING PLAN -WEST
S212	LOFT FRAMING PLAN -EAST
S213	ROOF FRAMING PLAN -WEST
S214	ROOF FRAMING PLAN -EAST
S300	SCHEDULES
S400	SECTIONS & DETAILS
S410	SECTIONS & DETAILS
S420	SECTIONS & DETAILS
S421	SECTIONS & DETAILS
S430	SECTIONS & DETAILS
S440	SECTIONS & DETAILS

MECHANICAL

M001	MECHANICAL LEGEND
M101	SITE PLAN - MECHANICAL
M201	FOUNDATION PLAN - MECHANICAL
M301	BASEMENT PLAN - MECHANICAL
M302	BASEMENT PLAN - FIRE PROTECTION
M303	MAIN FLOOR PLAN - MECHANICAL
M304	LOFT FLOOR - MECHANICAL
M305	ATTIC AND ROOF PLAN - MECHANICAL
M401	MECH. SCHEMATICS AND DETAILS
M402	MECHANICAL DETAILS
M501	MECHANICAL SCHEDULES

ELECTRICAL

E000	ELECTRICAL LEGEND AND DRAWING LIST
E100	SITE PLAN AND ELECTRICAL LAYOUT
E200	BASEMENT ELECTRICAL LAYOUT
E201	MAIN FLOOR PLAN ELECTRICAL LAYOUT
E202	LOFT FLOOR PLAN ELECTRICAL LAYOUT
E300	TYPICAL SUITE PLANS ELECTRICAL LAYOUT
E301	TYPICAL SUITE PLANS ELECTRICAL LAYOUT
E400	SINGLE LINE DIST & PANELS
E500	ELECTRICAL SCHEDULES
E600	ELECTRICAL DETAILS

LANDSCAPE

L101	LANDSCAPE PLAN
L201	LANDSCAPE DETAILS

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6	2016-12-08	ISSUED FOR TENDER			
5	2016-12-08	ISSUED FOR BUILDING PERMIT			
4	2016-09-02	ISSUED FOR 99% REVIEW			
3	2016-06-14	ISSUED FOR 66% REVIEW			
2	2016-05-09	ISSUED FOR 33% REVIEW			
1	2016-05-06	DEVELOPMENT PERMIT REVIEW			
No.	Date/Date	Description/Description	Drawn by Dessiné par	Approved Approuvé	

Revision / Revision

A detail number
numero de detail
B source drawing no.
de dessin no.
C detail on drawing no.
detail sur dessin no.

Consultant's Name
Nom de l'expert-consult

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Canada

Client/client
Parks Canada
Agence
L'Agence Parcs
Canada

Western and Northern Region
Ouest et Nord du Canada

Project title/Titre du projet

Staff Housing Phase 2
Waterton Lakes National Park

Drawing title/Titre du dessin

GENERAL INFORMATION

Surveyed by/Arpenté par	Drawn by/Dessiné par	Date/Date
	MP	2016-12-08
Designed by/Concept par	Reviewed by/Revisé par	Scale/Echelle
FVR	LS/FVR	N.T.S.

FWGSC Project Manager/Administrateur de Projets TFSGC

Client Acceptance/Acceptation du client

Approved by/Approuvé par

File Name: 2016-12-08-2016-12-08

Project No./No. du projet

Asses No./No. du-bien


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Drawing Reference No./No. de référence du dessin


A001

BUILDING ASSEMBLIES


WALL ASSEMBLIES - EXTERIOR

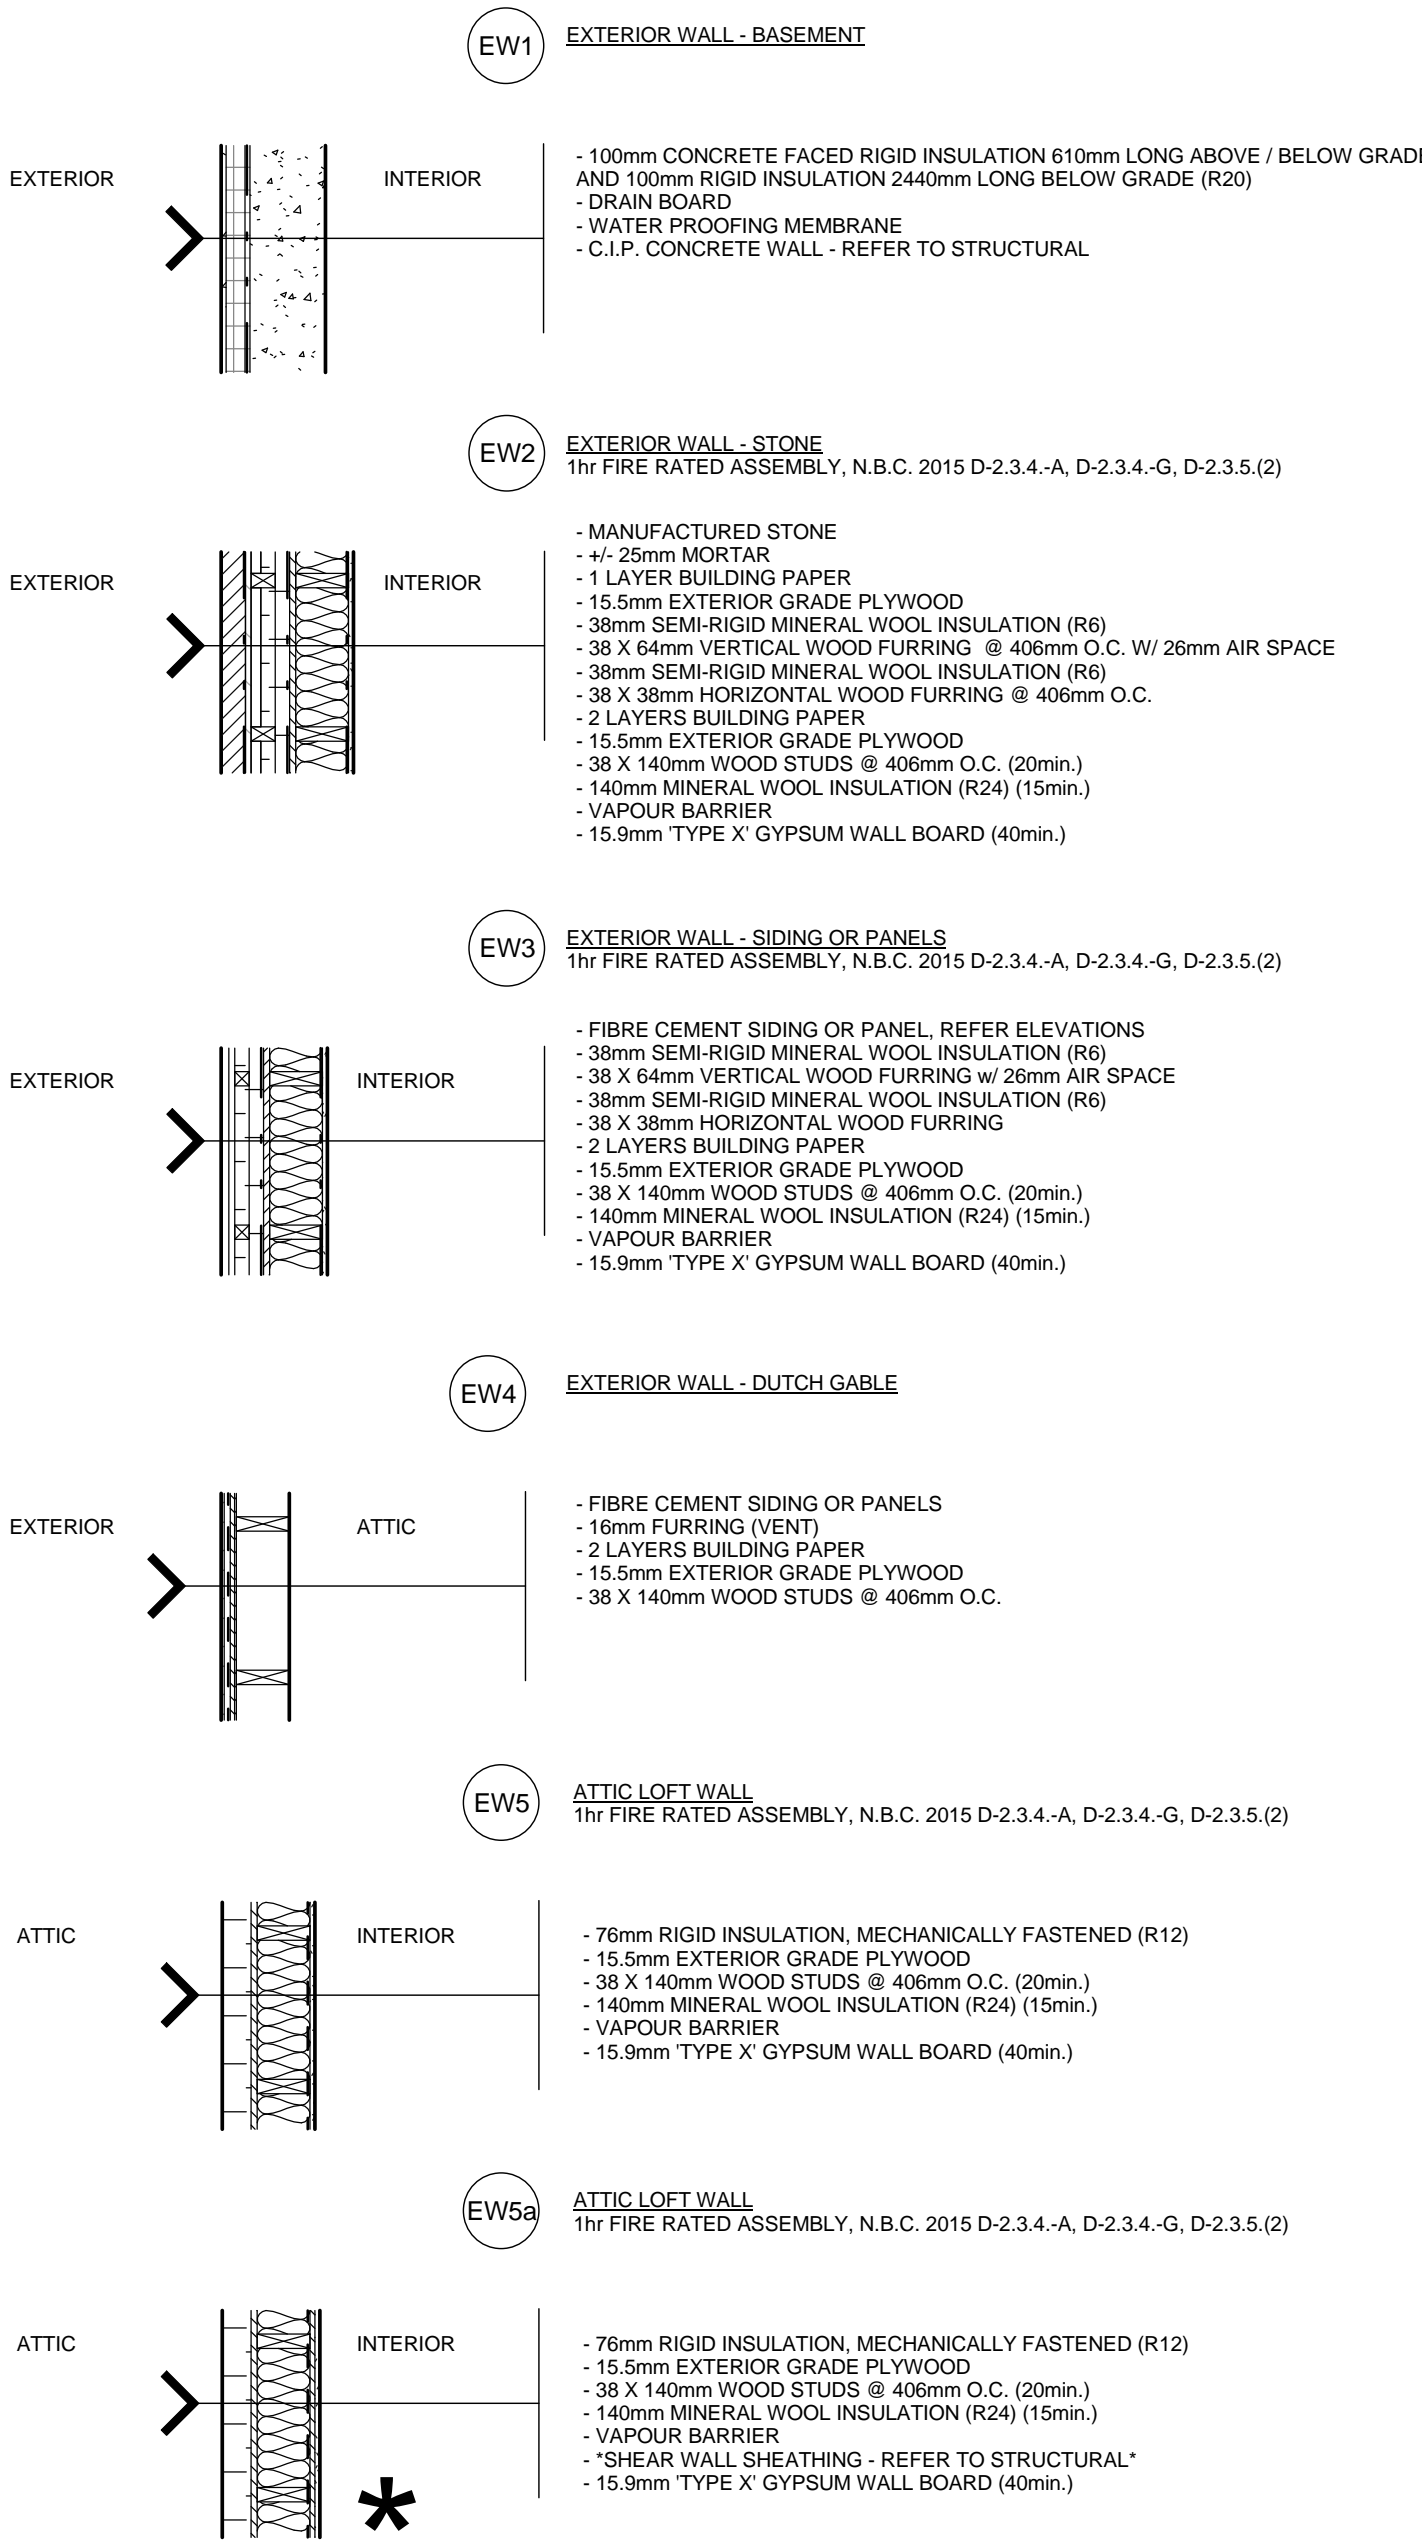


PARTITION ASSEMBLIES - INTERIOR

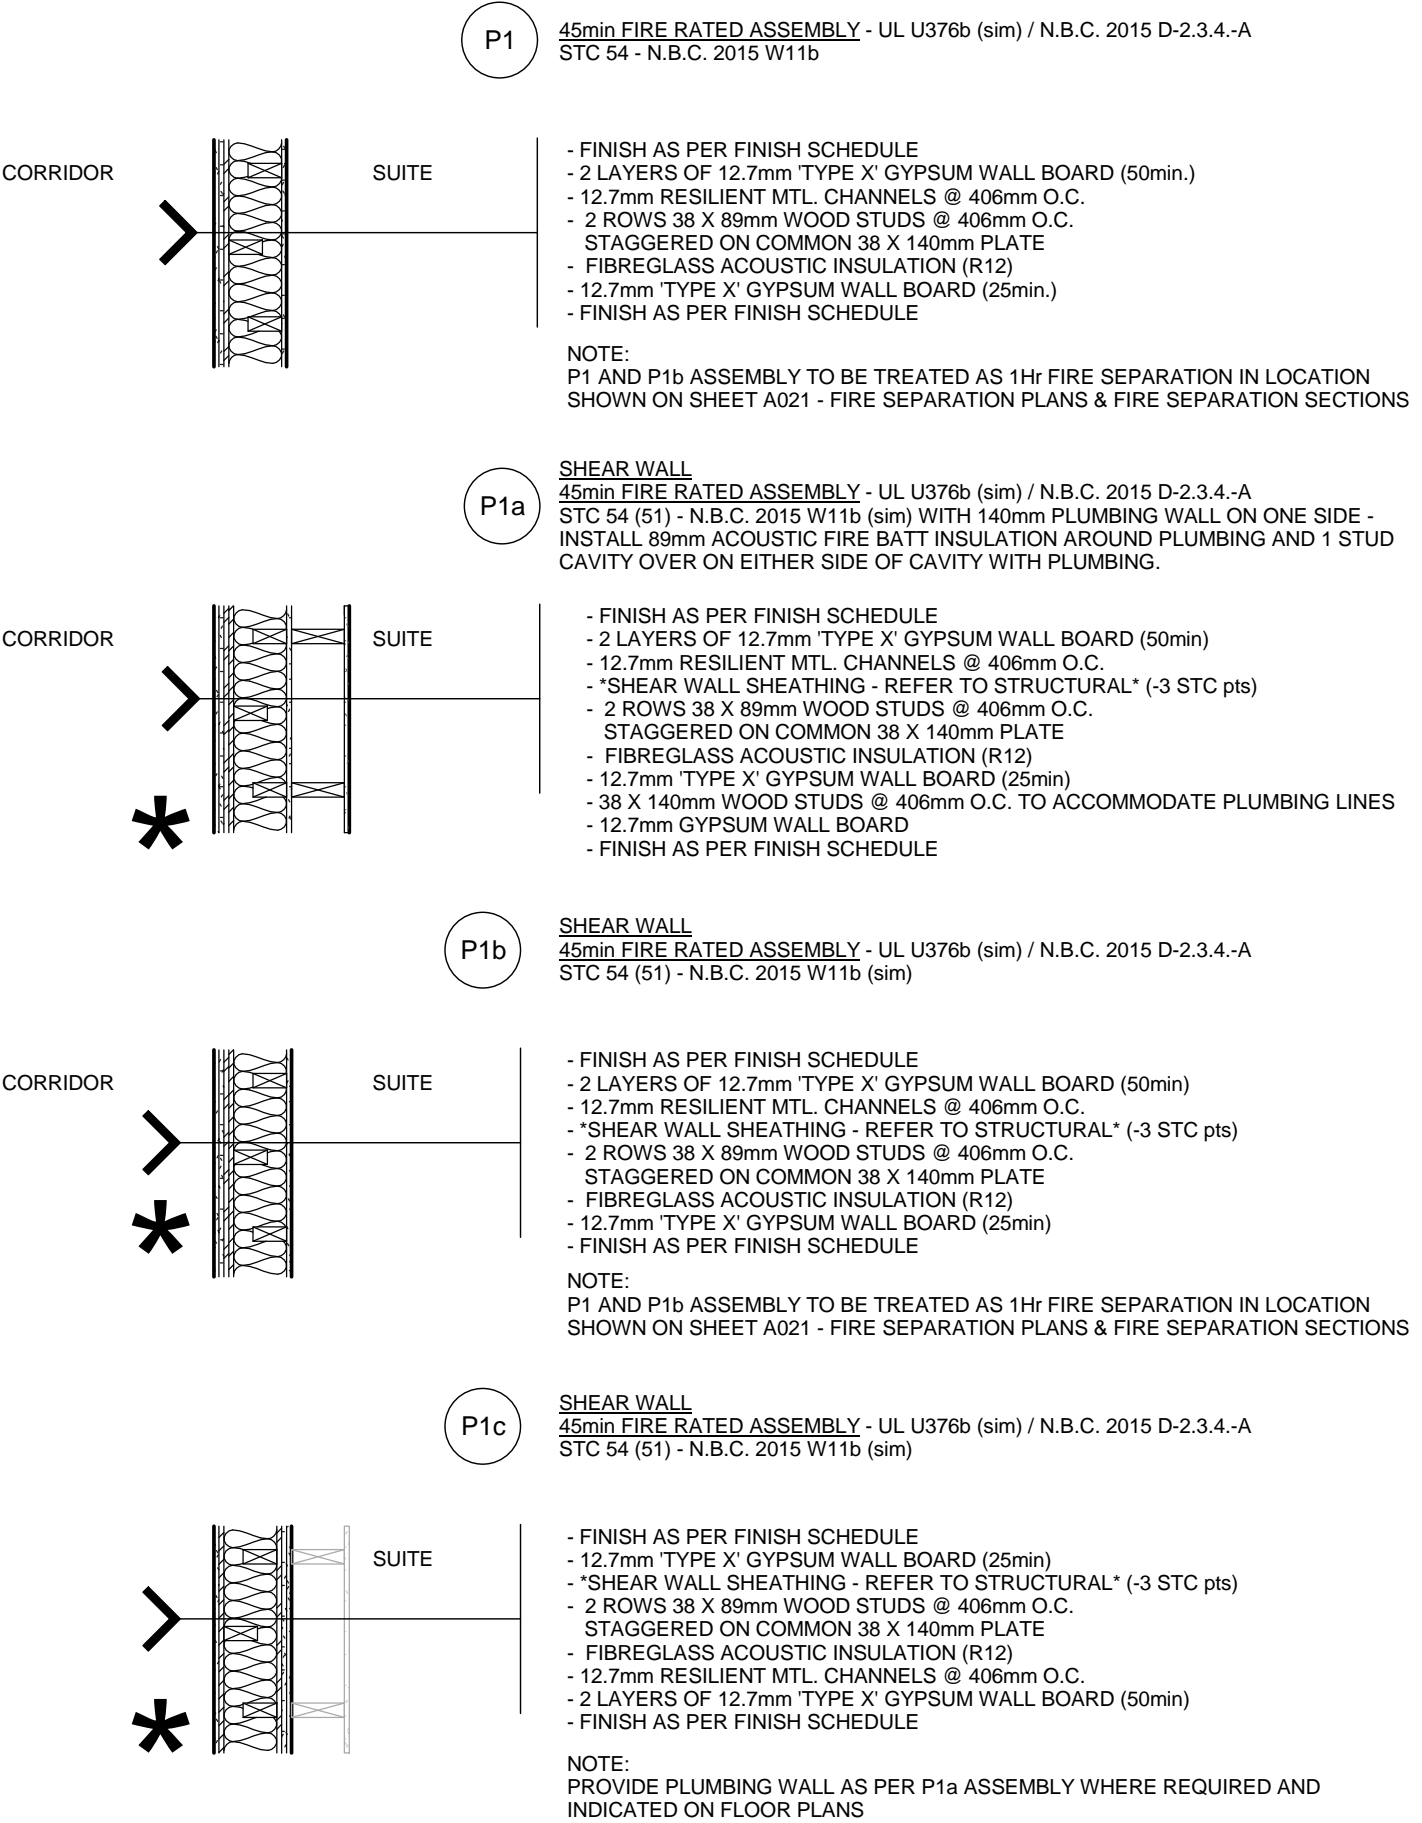


PARTITION ASSEMBLIES - INTERIOR (CONT.)

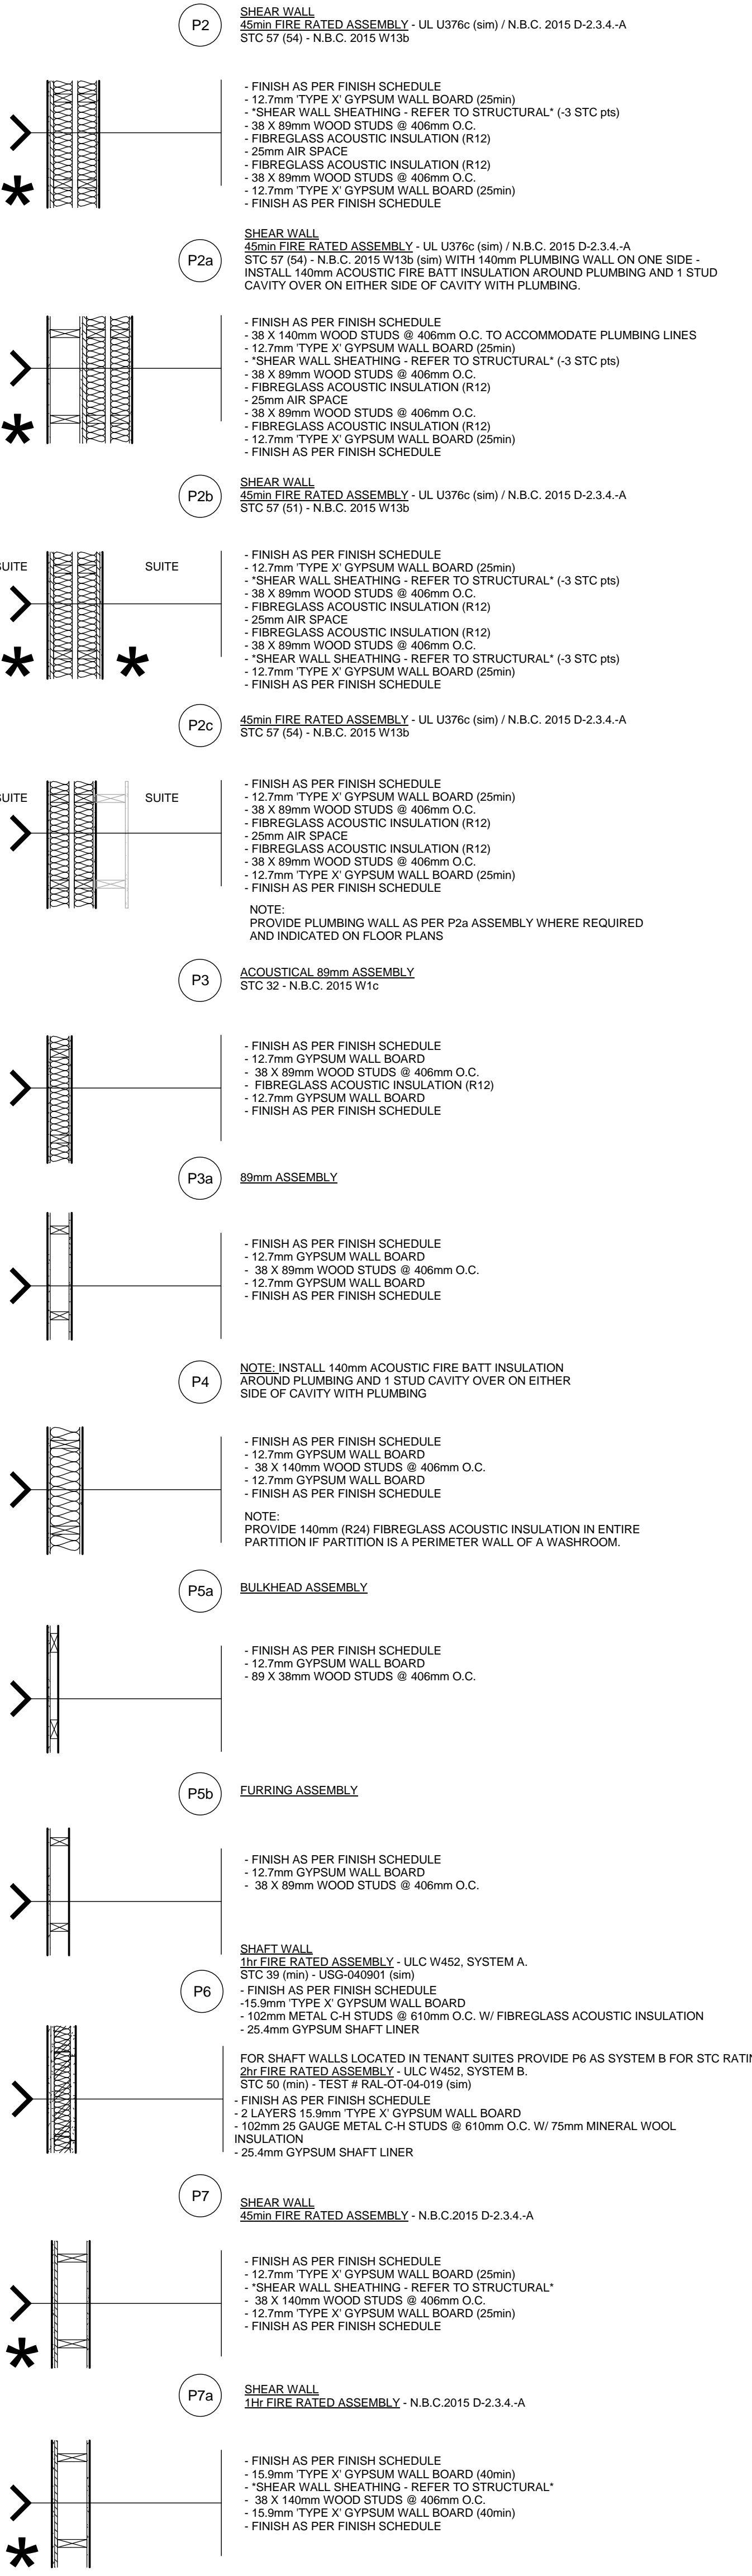

PARTITION ASSEMBLIES - INTERIOR (CONT.)

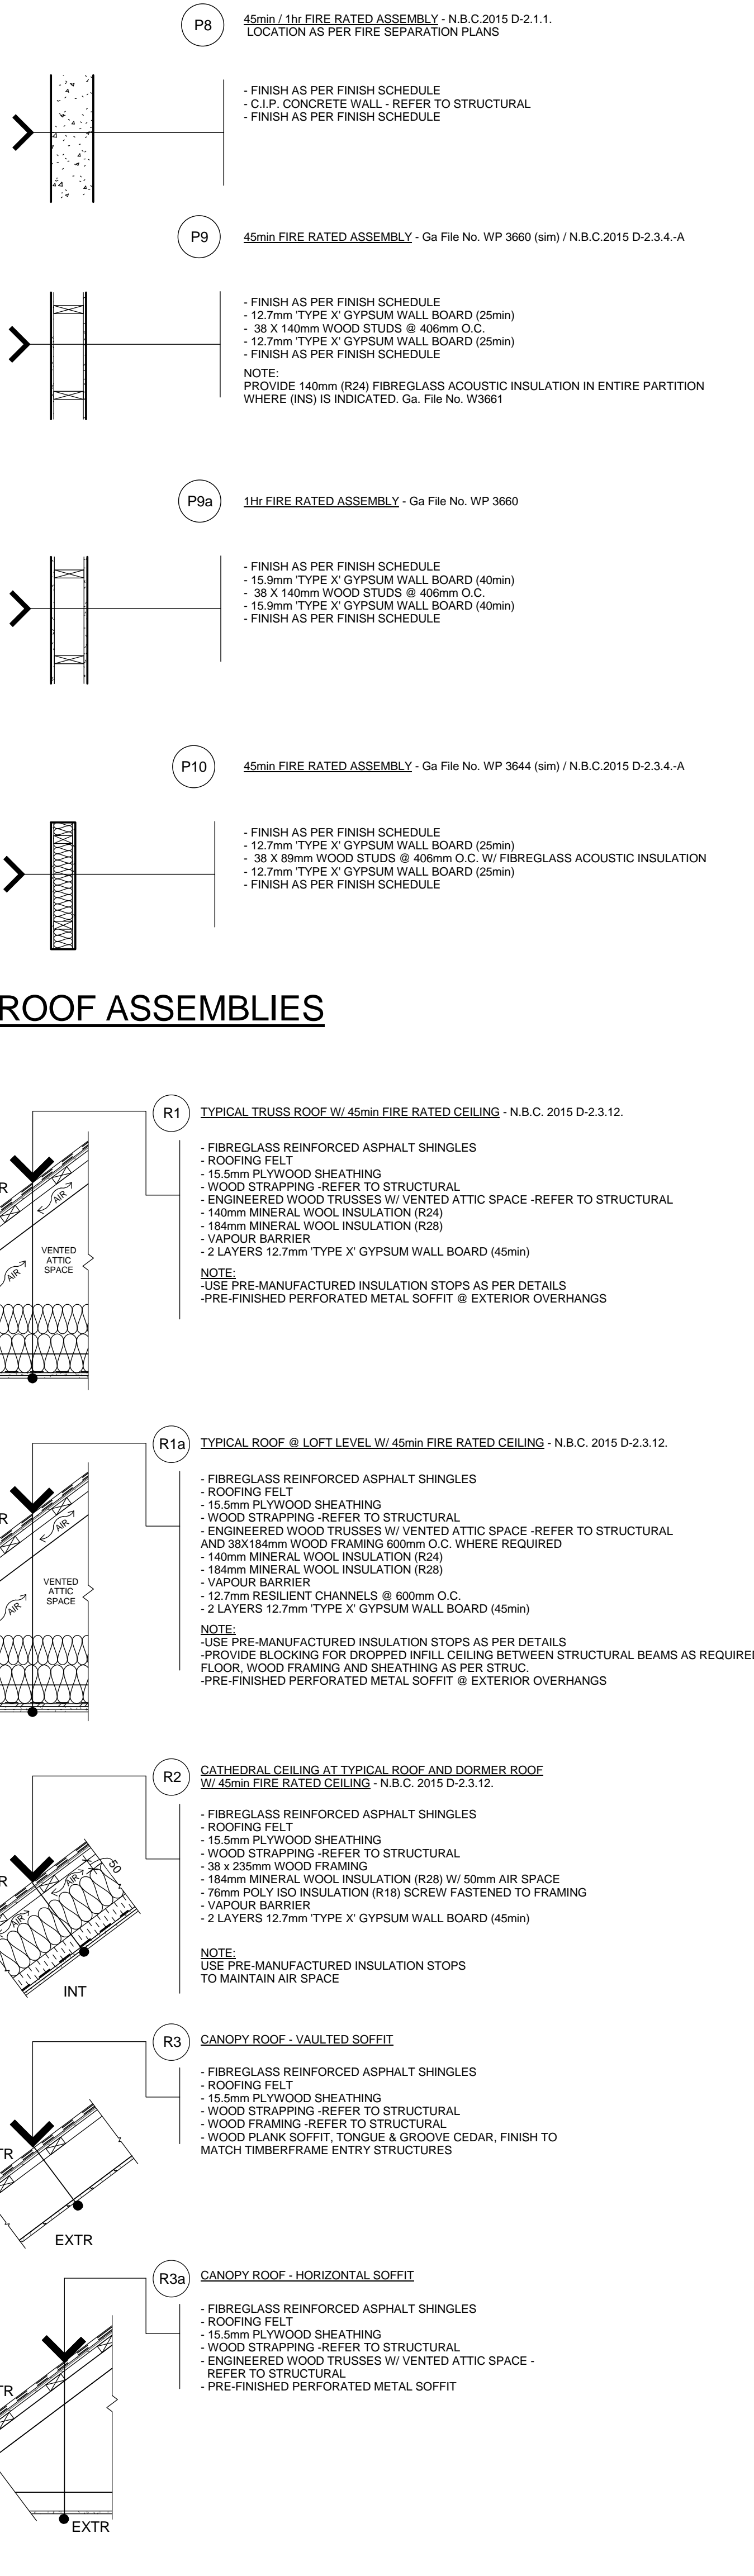

FLOOR ASSEMBLIES

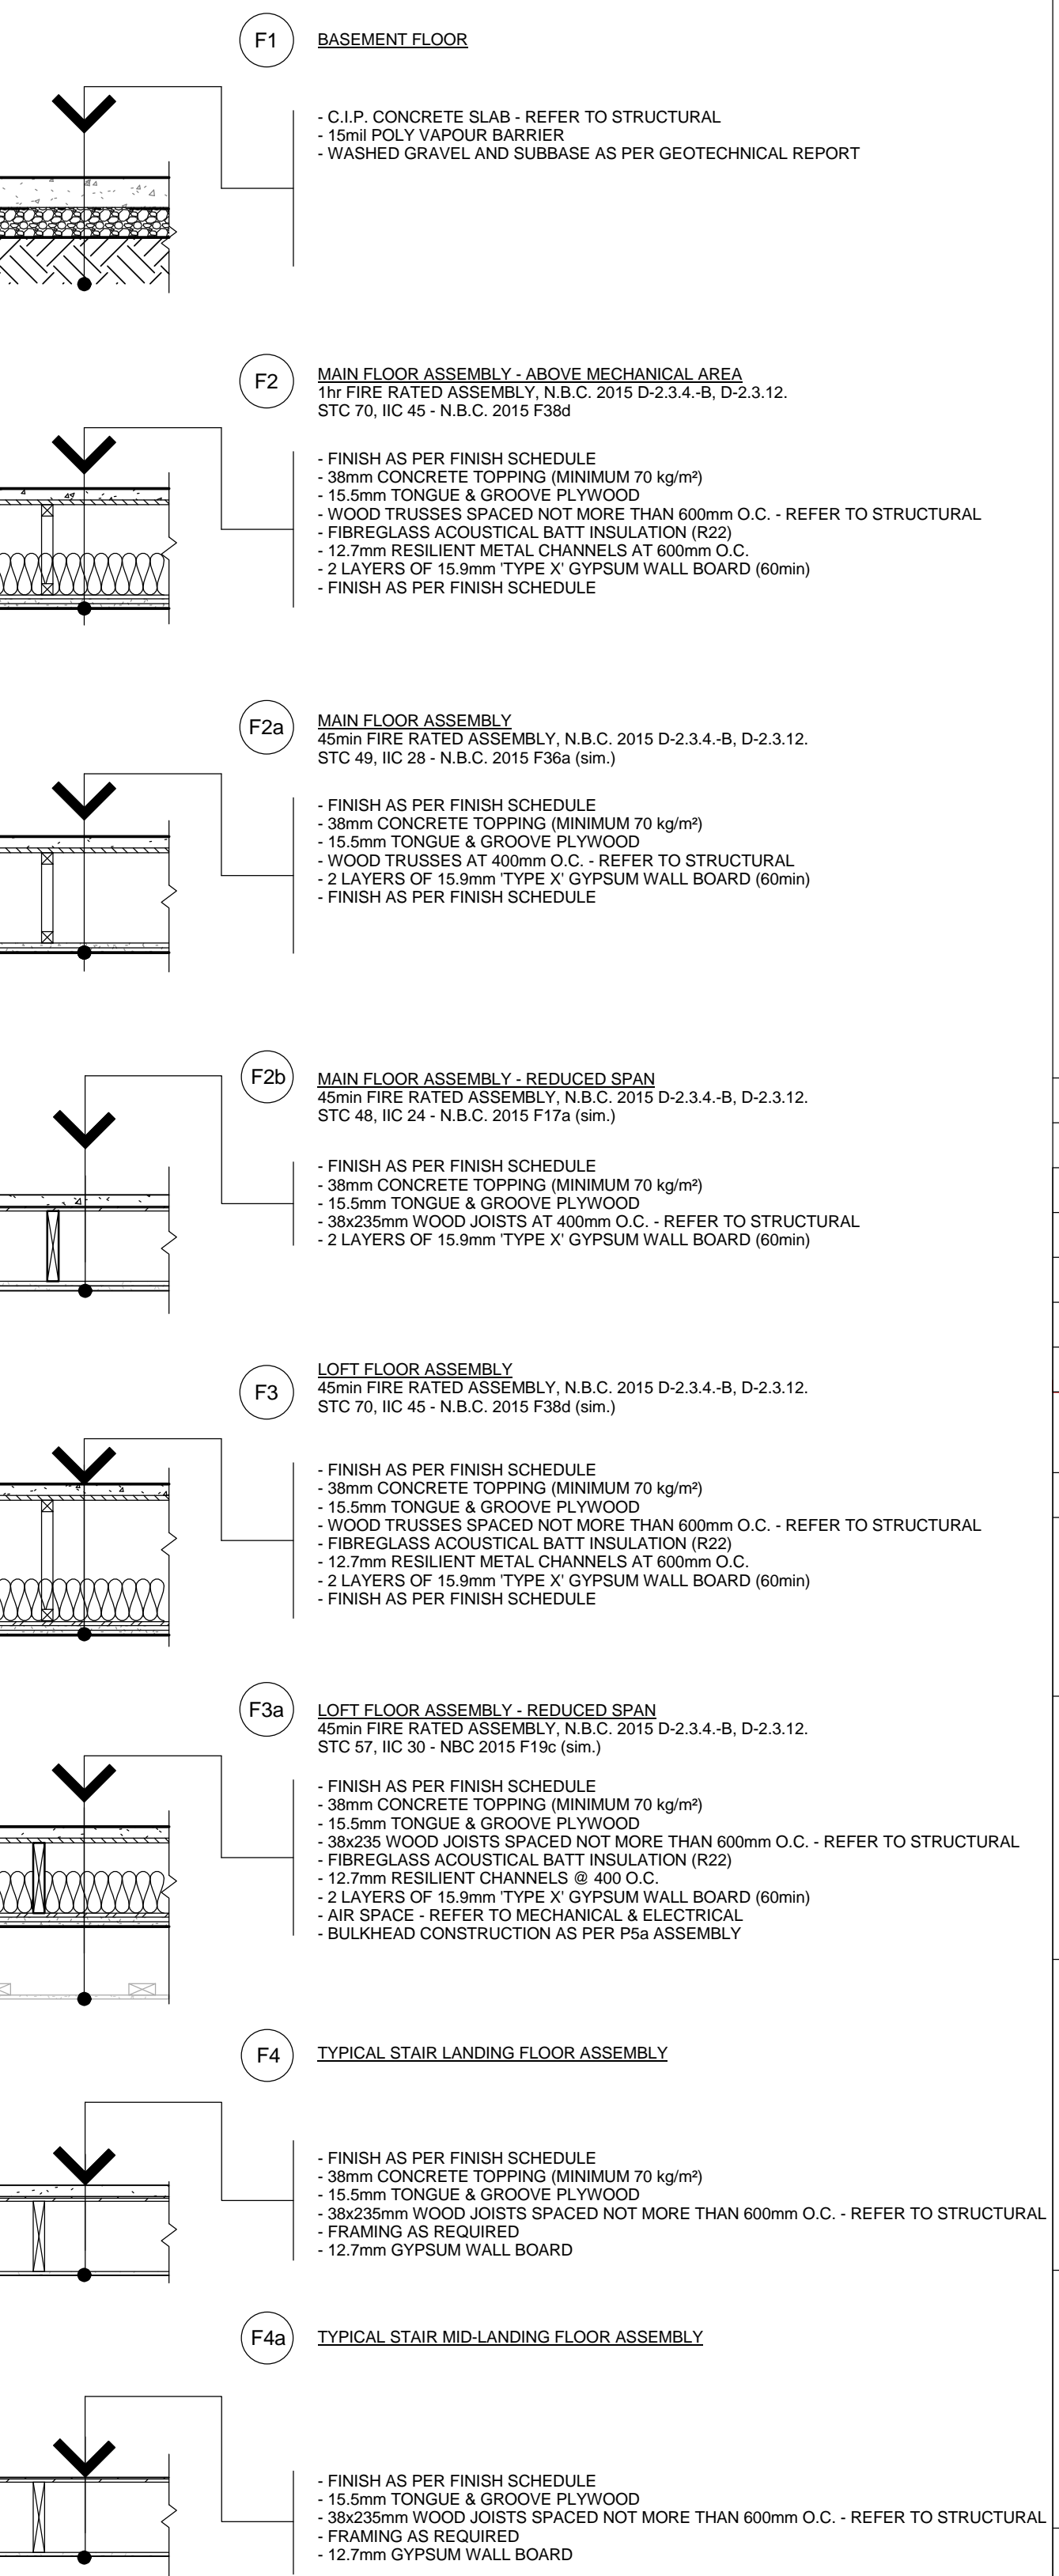

GENERAL NOTE: REFER TO INTERIOR FLOOR FINISH PLANS AND FINISH LEGEND WHEN NO FINISH SCHEDULE IS PROVIDED

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6	2016-12-08	ISSUED FOR TENDER		
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4	2016-09-02	ISSUED FOR 95% REVIEW		
3	2016-06-14	ISSUED FOR 66% REVIEW		
2	2016-05-09	ISSUED FOR 33% REVIEW		
1	2016-05-06	DEVELOPMENT PERMIT REVIEW		

Revision / Revision
A detail number
numero de detail
B source drawing no.
de dessin no.
C detail on drawing no.
detail sur dessin no.

Consultant's Name
Nom de l'expert-consult
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Public Works and Government Services Canada
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Client Services Team Southern Alberta Operations Branch
Le Client Entretien l'Équipe Alberta Méridionale Branche d'Opérations

Canada
Client/client
Parks Canada Agency
L'Agence Parcs Canada
Western and Northern Region
Ouest et Nord du Canada

Project title/Titre du projet
**Staff Housing Phase 2
Waterton Lakes National Park**

Drawing title/Titre du dessin

BUILDING ASSEMBLIES

Surveyed by/Arpenté par	Drawn by/Dessiné par	Date/Date
MP	MP	2016-12-08

Designed by/Concepté par	Reviewed by/Revisé par	Scale/Echelle
LS/FVR	LS/FVR	1 : 20

FWGSC Project Manager/Administrateur de Projets TPFGC
Randy Boldt

Client Acceptance/Acceptation du client
Approved by/Approuvé par

Project No./No. du projet
39000

Asset No./No. du bien
Fil # 945

Drawing Reference No./No. de référence du dessin

A011

1 FIRE SAFETY PLAN - BASEMENT LEVEL
A021 Scale: 1 : 200

3 FIRE SAFETY PLAN - LOFT LEVEL
A021 Scale: 1 : 200

5 FIRE SAFETY SECTION 01
A021 Scale: 1 : 200

8 FIRE SAFETY SECTION 04
A021 Scale: 1 : 200

2 FIRE SAFETY PLAN - MAIN LEVEL
A021 Scale: 1 : 200

4 ROOF VENTING/COMPARTMENT PLAN
A021 Scale: 1 : 200

7 FIRE SAFETY SECTION 03
A021 Scale: 1 : 200

FIRE SEPARATION LEGEND

--- 45 MINUTE RATED FIRE RESISTANCE RATING

----- 45 MINUTE RATED SHEAR WALL * * DENOTES SIDE OF WALL TO APPLY STRUCTURAL MEMBRANE

NOTE: SHEAR WALLS INDICATED BY "1H1" TO BE 1 HOUR RATED

_____ 1 HOUR RATED FIRE RESISTANCE RATING



NOTE:
EXTERIOR WALLS EW2, EW3 AND ATTIC LOFT WALLS EW5, EW5a TO HAVE (ON INTERIOR SIDE)
ONE LAYER 15.9mm TYPE 'X' GYPSUM WALL BOARD
FOR SHEAR WALL - STRUCTURAL MEMBRANE EXTENT -REFER TO STRUCTURAL DRAWINGS

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3	2016-06-14	ISSUED FOR 66% REVIEW		
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1	2016-05-06	DEVELOPMENT PERMIT REVIEW		
No.	Date/Date	Description/Description	Drawn by Dessine par	Approved Approuvé

	Revision / Revision	
	<p>A detail number numero de detail</p> <p>B source drawing no. de dessin no.</p> <p>C detail on drawing no. detail sur dessin no.</p>	 
Consultant's Name Nom de l'expert-conseil		Eng. Stamp Sceau de l'ingénieur
<div style="border: 2px solid black; padding: 10px; width: fit-content;">B</div> <p>IBI GROUP Suite 500 - 611 Meredith Road NE Calgary, Alberta T2E 2W5 T. (403) 270-5600 F. (403) 270-5610 ibigroup.com</p>		

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Canada 

Client/client 	Parks Canada Agency	L'Agence Parcs Canada
	Western and Northern Region	Ouest et Nord du Canada

Project title/Titre du projet

Staff Housing Phase 2 Waterton Lakes National Park

Drawing title/Titre du dessin

FIRE SEPARATION PLANS & FIRE SEPARATION SECTIONS


Surveyed by/Arpente par	Drawn by/Dessine par MP	Date/Date 2016-12-08
Designed by/Concept par LS/FVR	Reviewed by/Revise par LS/FVR	Scale/Echelle 1 : 200

PWGSC Project Manager/Administrateur de Projets TPSCG


Randy Boldt

Client Acceptance/Acceptation du client		Approved by/Approuvé par	
Park Responsible Officer/Agent Responsable		PMO/SO, Project Manager/Administrateur de Projets TPSO	
Project No./No. du projet 39000	Asset No./No. du bien FIL # 945	Sheet No./ No. de la feuille	
Drawing Reference No./No. de reference du dessin		A021	


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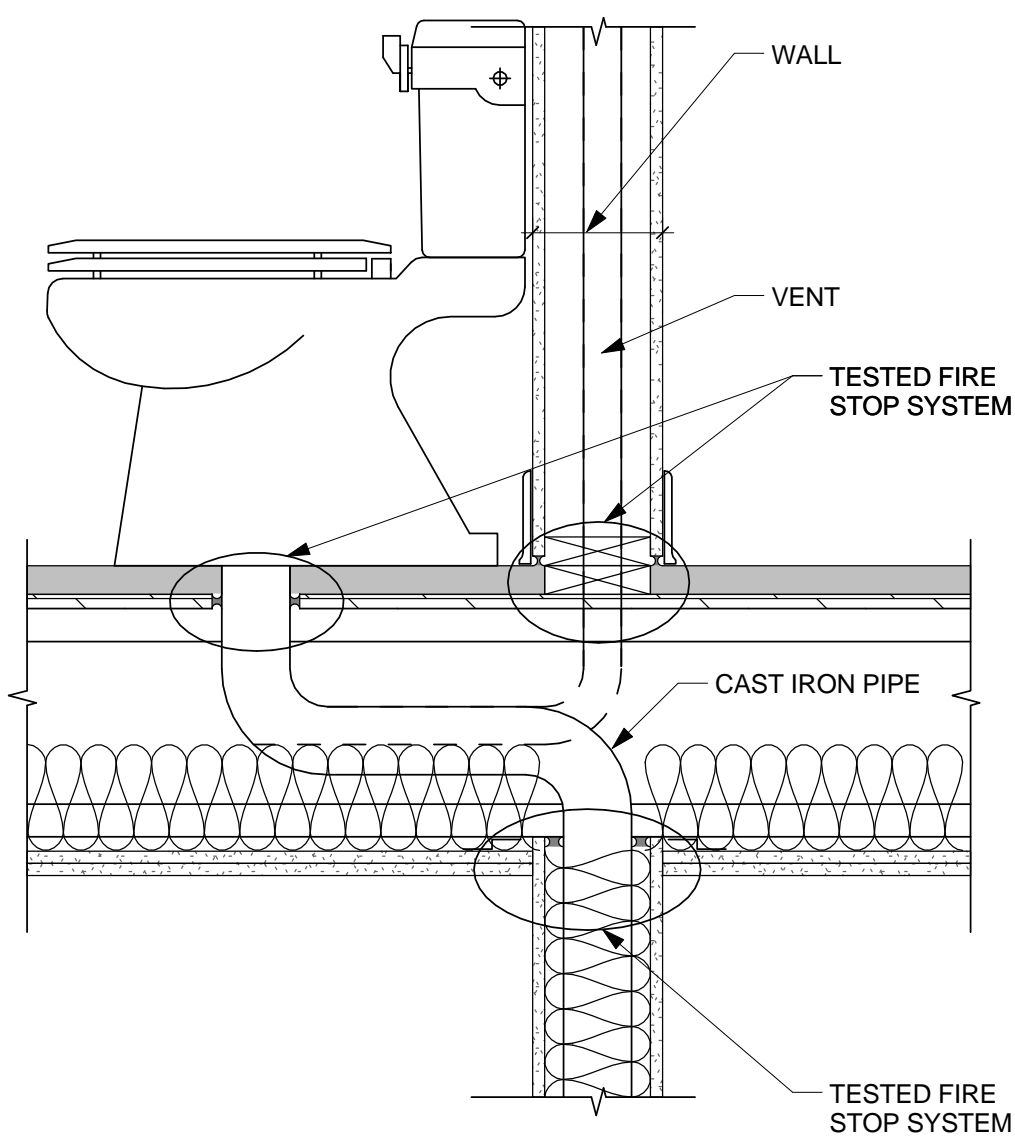
TYPICAL PARTY WALL DETAIL

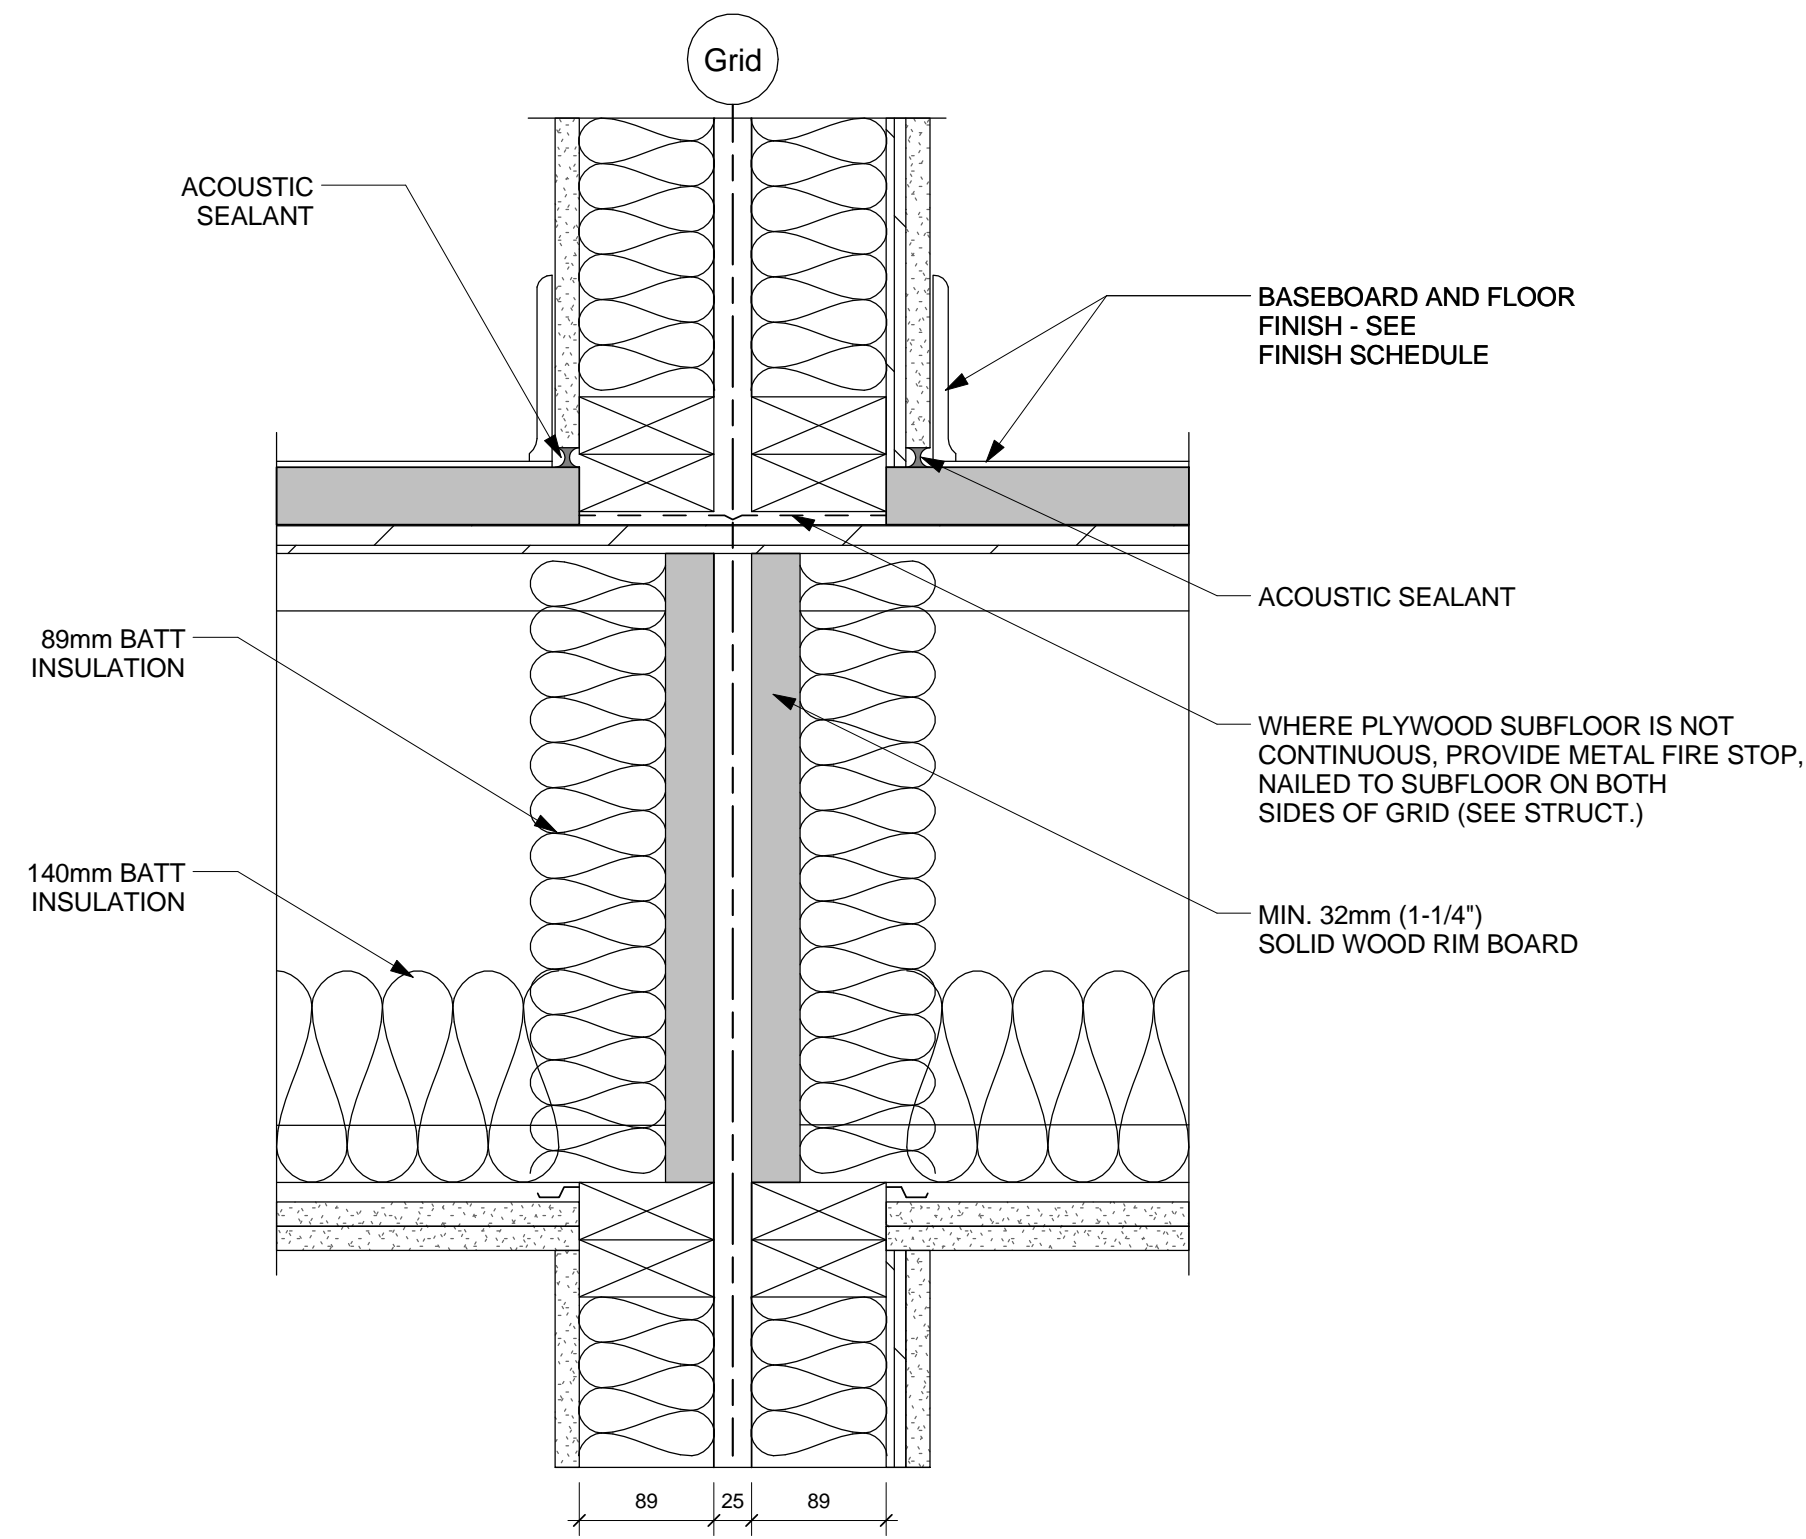


TYPICAL SUITE CORRIDOR DETAIL

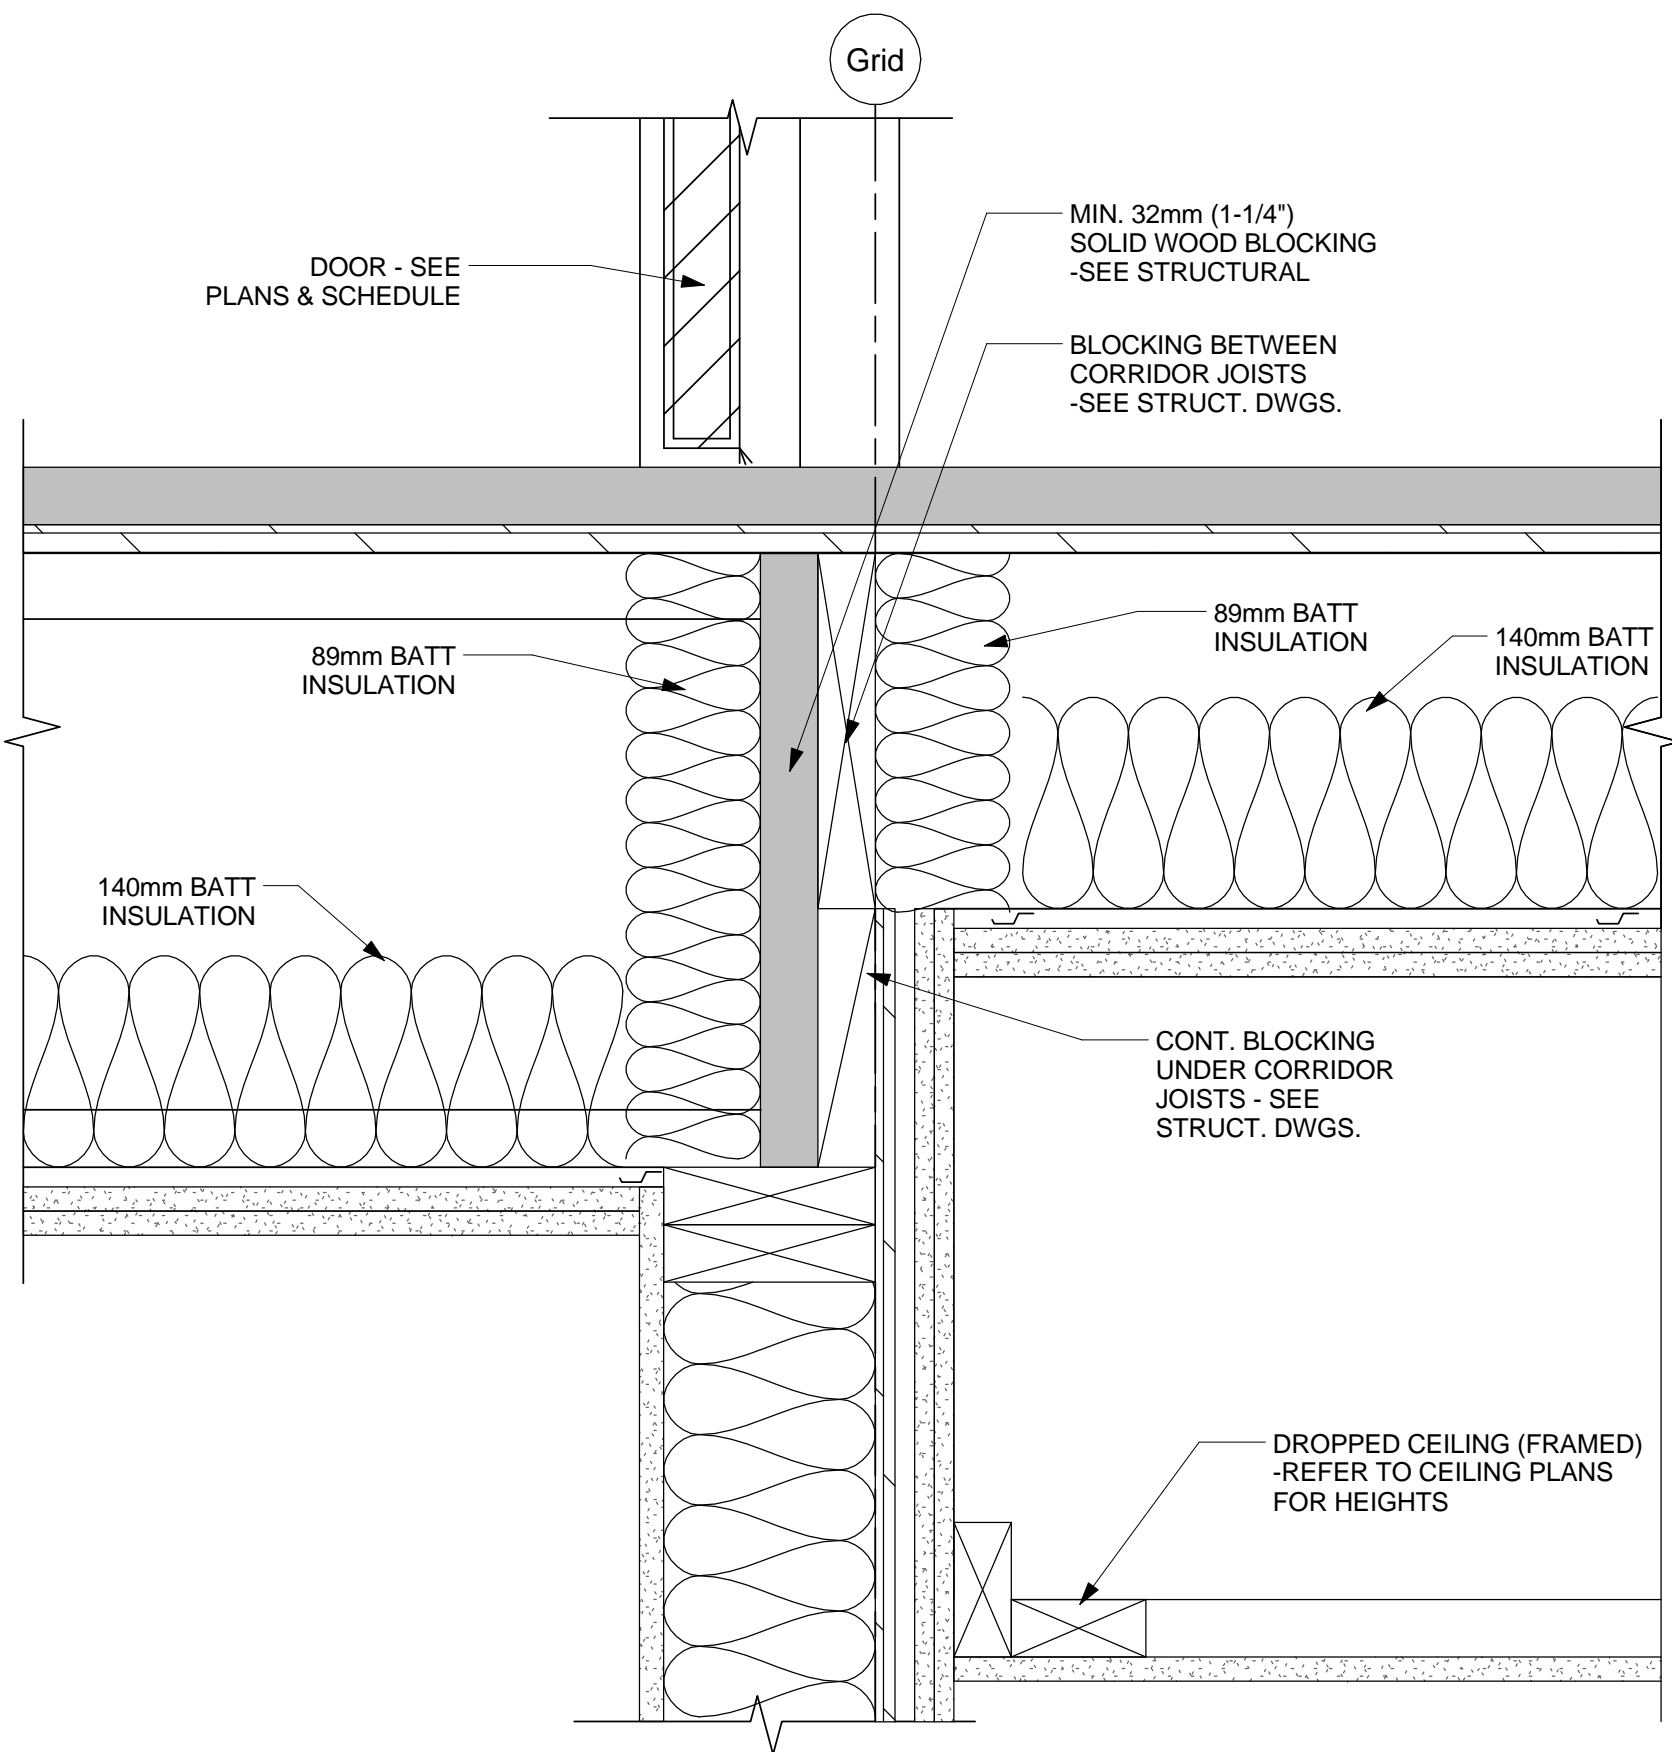


TYPICAL FIRE STOPPING
SERVICE PENETRATION DETAIL 01

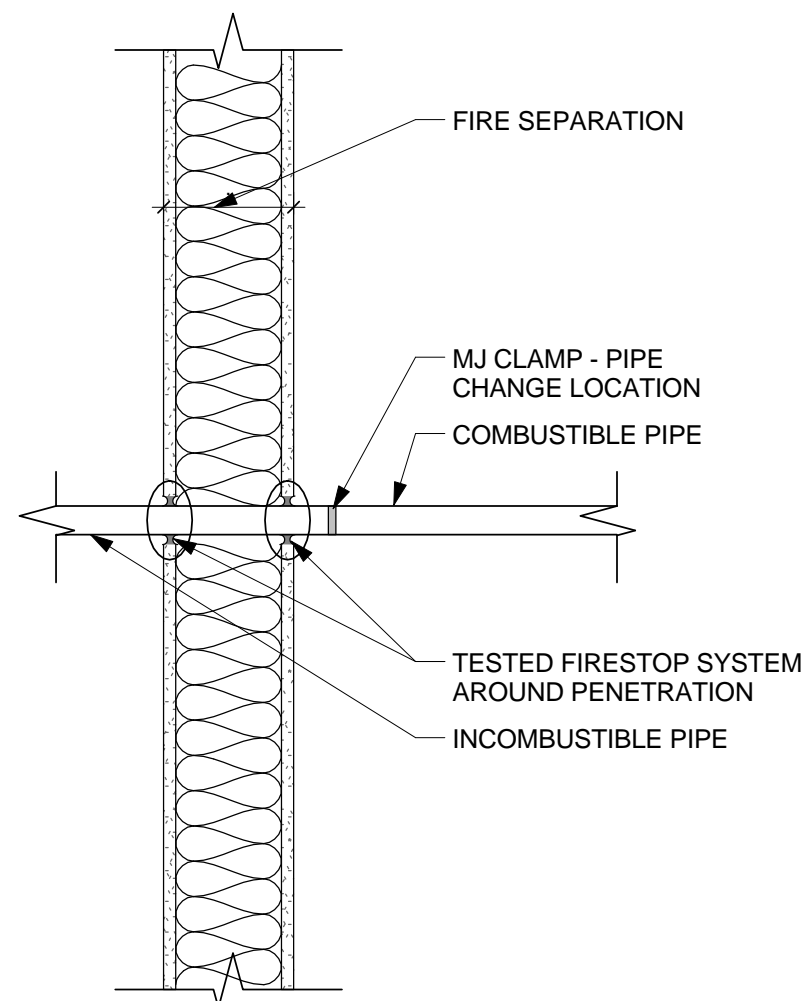


TYPICAL FIRE STOPPING
SERVICE PENETRATION DETAIL 02

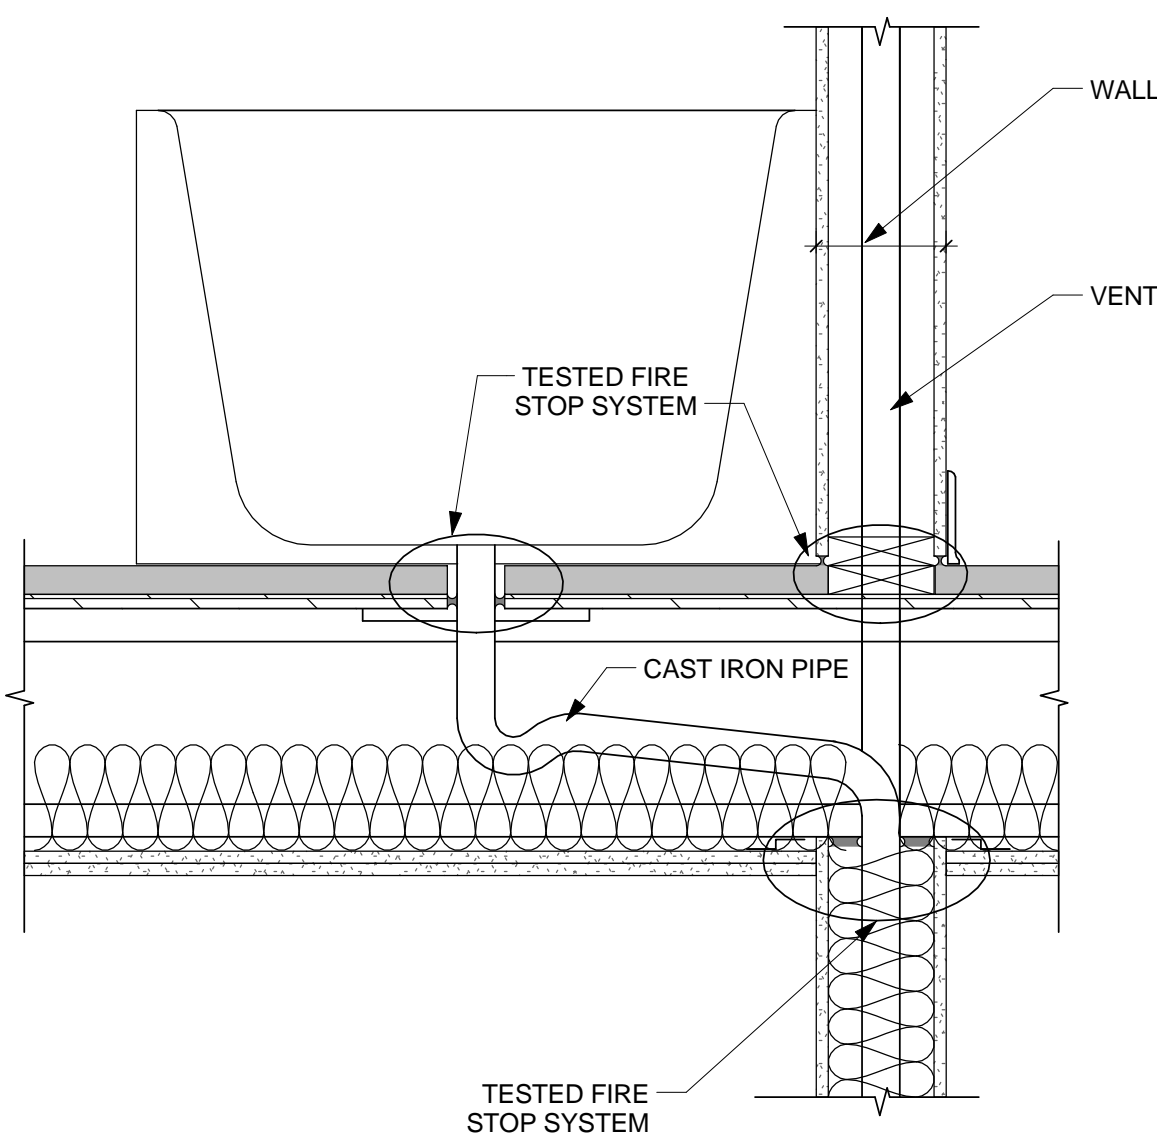

TYPICAL FIRE STOPPING
SERVICE PENETRATION DETAIL 03

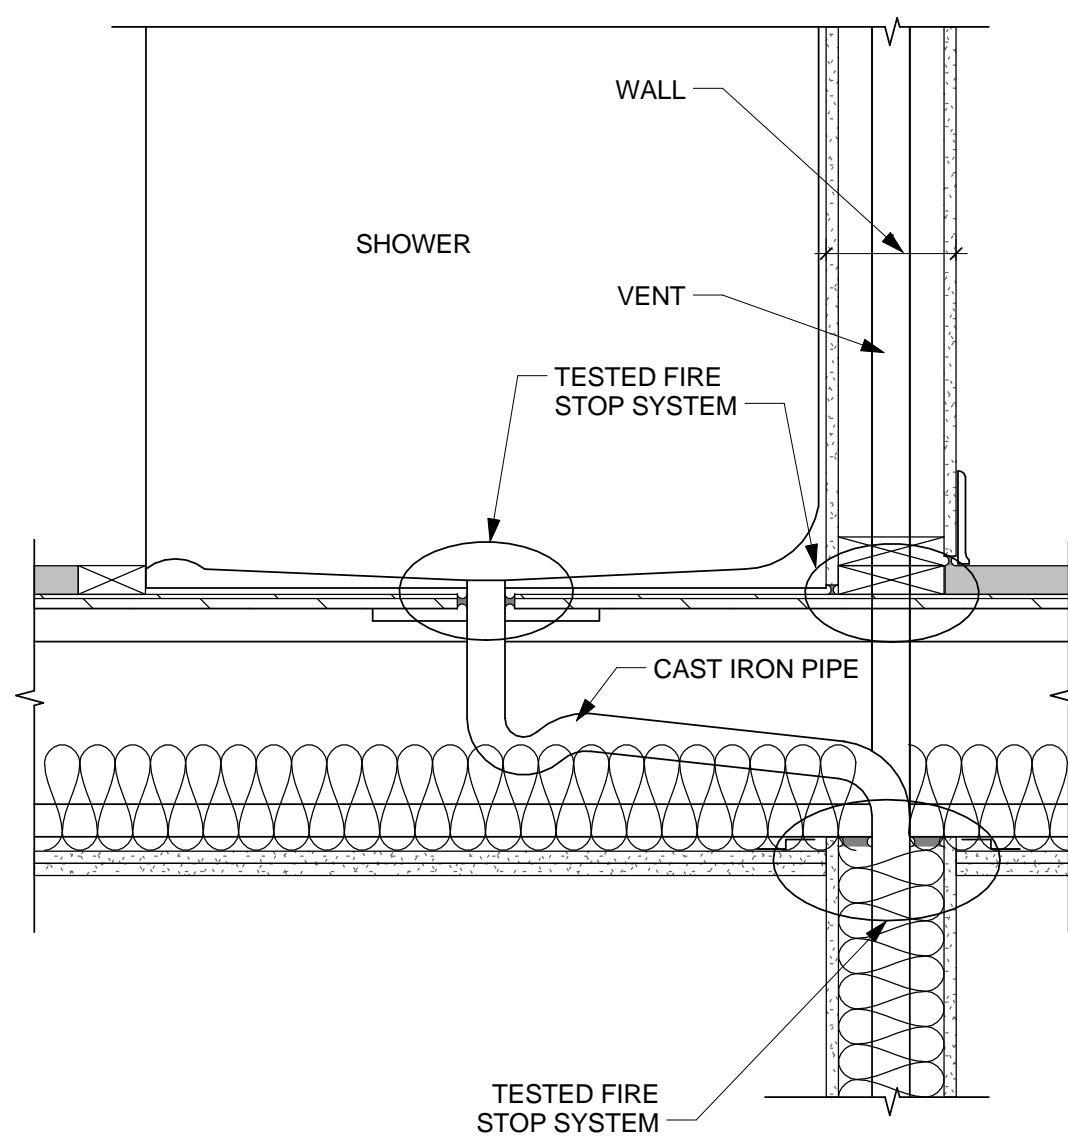


TYPICAL FIRE STOPPING
SERVICE PENETRATION DETAIL 04

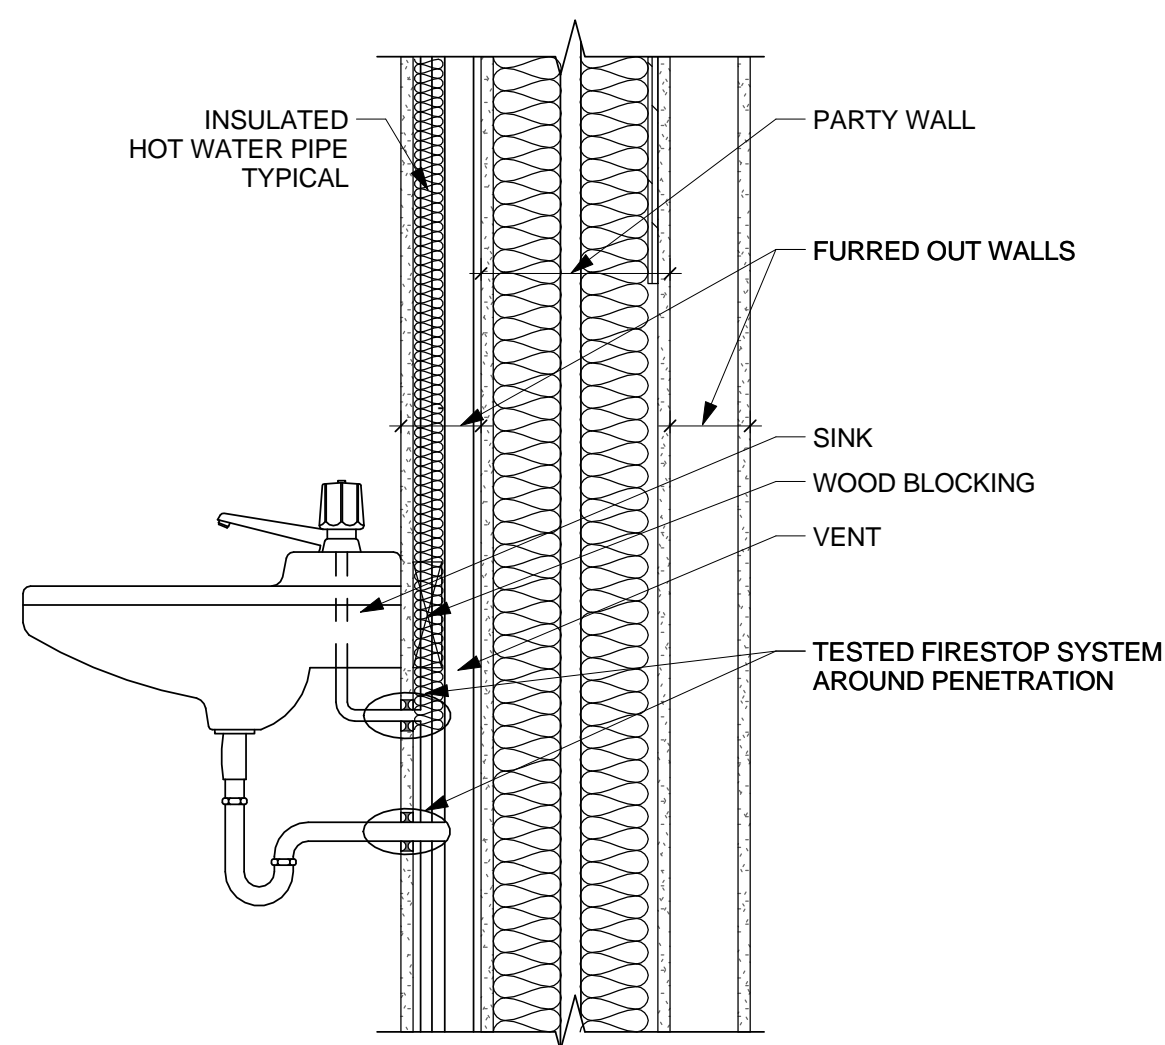


TYPICAL FIRE STOPPING
SERVICE PENETRATION DETAIL 05


NOTE: FIRE RATED STEEL COLUMNS - N.B.C. 2015 D-2.6.1, F. D-2.6.4, D-2.6.5
- FOR 1hr FIRE RATING USE 2 LAYERS 15.9mm TYPE X' GYPSUM WALL BOARD
- FOR 45min FIRE RATING USE 2 LAYERS 12.7mm TYPE X' GYPSUM WALL BOARD
- FOR LOCATION REFER TO FIRE SEPARATION PLANS ON SHEET A021
- FOR METAL STUD FRAMING USE MULTI-SLOT TOP TRACK FOR EXPANSION CONTRACTION

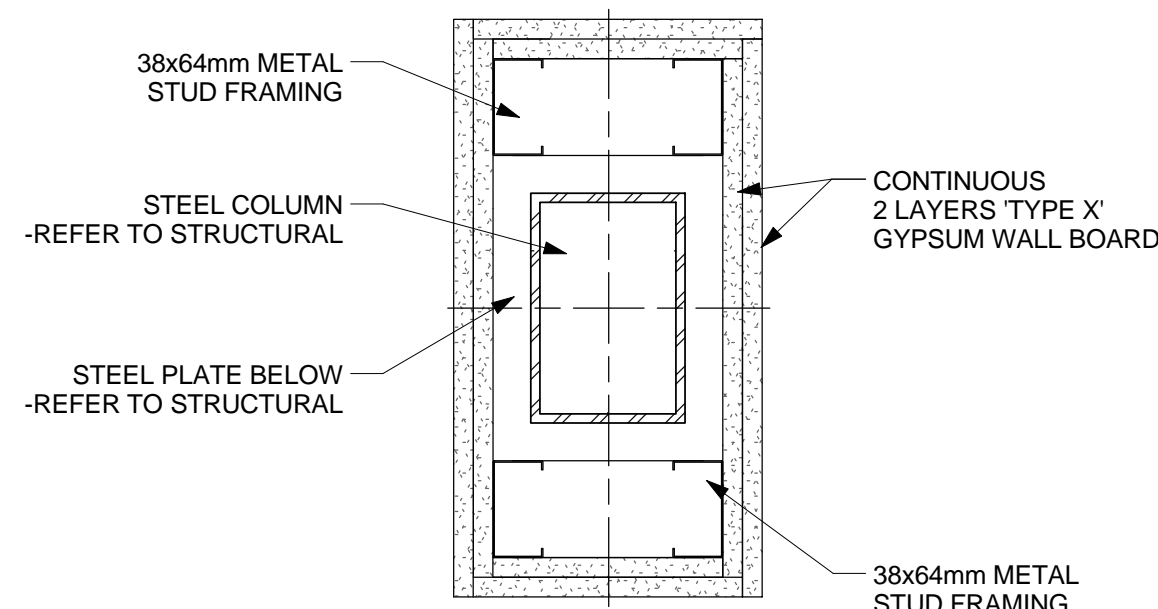

TYPICAL FIRE RATED STEEL COLUMN DETAIL

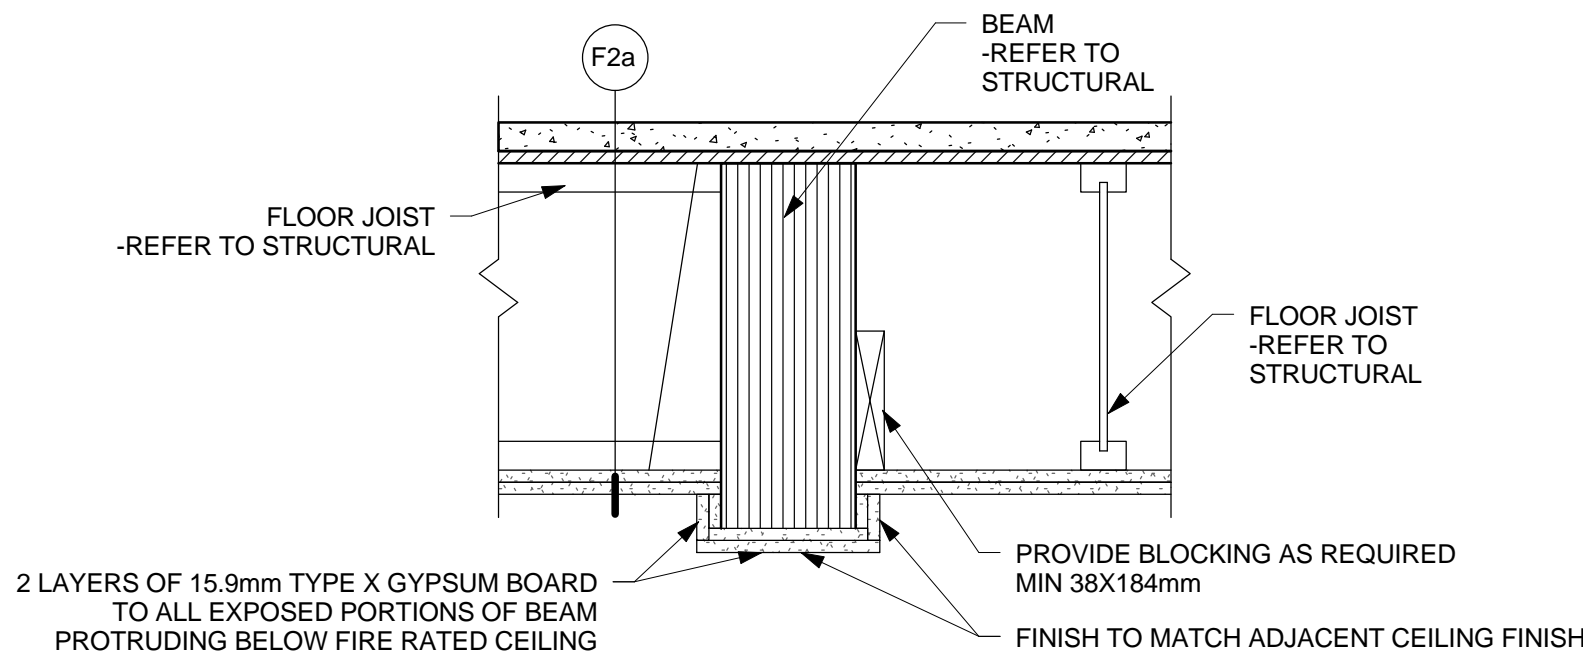

TYPICAL FIRE RATED PROTRUDING BEAM DETAIL

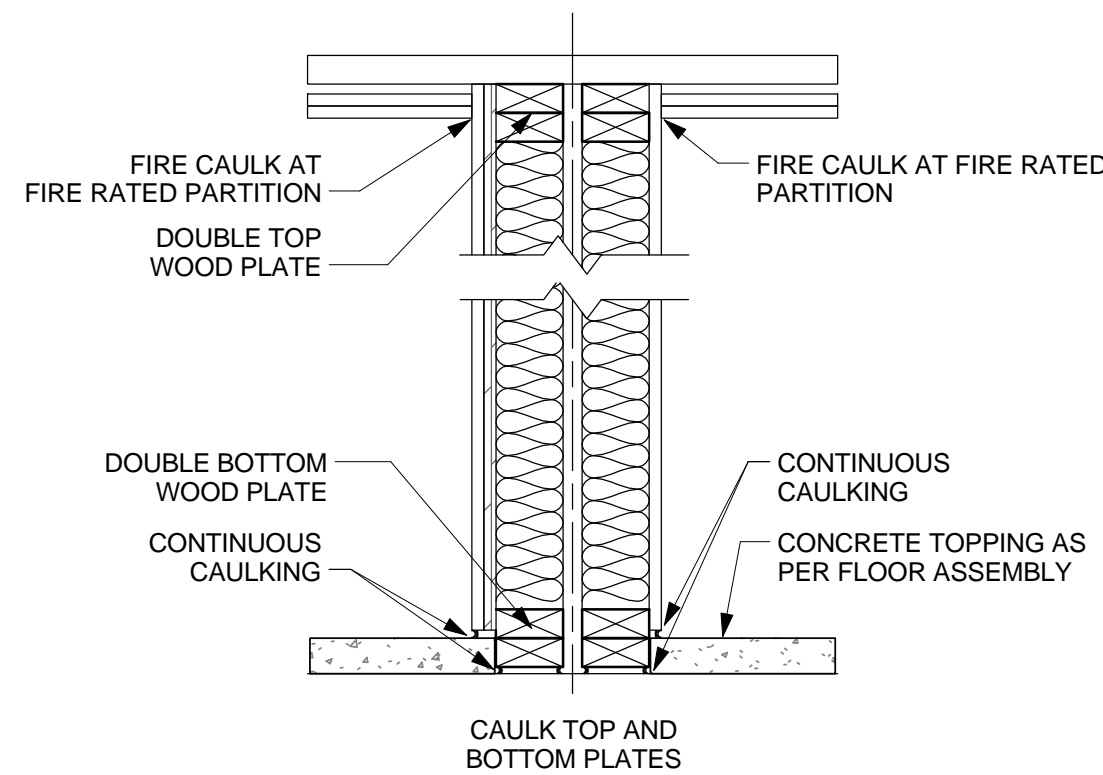

NOTE:
- REFER TO SHEET A021 FIRE SEPARATION PLANS & FIRE SEPARATION SECTIONS FOR LOCATION OF FIRE RATED WALLS AND SHEAR WALLS W/
★ DENOTES SIDE OF WALL TO APPLY STRUCTURAL MEMBRANE

NOTE:
PROVIDE SHEAR WALL BRACING AS PER STRUCTURAL DRAWINGS

TYPICAL AT TOP/BOTTOM PLATE OF WALL ASSEMBLY DETAIL
W/ ADDITION INFORMATION AS SHOWN

2 SHEAR WALL AND CAULKING
A022 Scale: 1 : 10

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Revision / Revision	
A detail number numéro de détail	A
B source drawing no. de dessin no.	B
C detail on drawing no. détail sur dessin no.	C
Consultant's Name Nom de l'expert-conseil	Eng. Stamp Sceau de l'ingénieur

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Project title/Titre du projet
**Staff Housing Phase 2
Waterton Lakes National
Park**

Drawing title/Titre du dessin
**FIRE SEPARATION TYPICAL
DETAILS**


Surveyed by/Arpenté par	Drawn by/Dessiné par	Date/Date
LS/FVR	MP	2016-12-08
Designed by/Concept par	Reviewed by/Revisé par	Scale/Echelle
LS/FVR	LS/FVR	As indicated
FWGSC Project Manager/Administrateur de Projets TPSCC Randy Boldt		
Client Acceptance/Acceptation du client		Approved by/Approuvé par
Task Responsible/Officer/Agent Responsable		Task Manager/Administrateur de Projets TPSCC
Project No./No. du projet	Asset No./No. d'actif	Sheet No./ No. de la feuille
39000	File # 945	A022
Drawing Reference No./No. de référence du dessin		

Door and Frame Schedule - Common																	
Door #	Location	Type	Door						Glazing		Frame				Fire Rating (minutes)	Hardware Group	Comments
			Material	Finish	Core	Width	Height	Thickn ess	Glazing	Thickness	Type	Material	Finish	Core			
Basement Level																	
B1	LAUNDRY	C	HM	PT	-	915	2135	45	WG	6mm	4a	PSF	PT	-	20 min	9	
B2	PCA STORAGE	A	HM	PT	-	915	2135	45	-		1	PSF	PT	-	NA	8	
B3	TENANT STORAGE	H	HM	PT	-	915	2135	45	-		4a	PSF	PT	-	20 min	8	
B4	ELEC. RM.	A	HM	PT	-	915	2135	45	-		4	PSF	PT	-	NA	8	
B5	MECHANICAL ROOM	A	HM	PT	-	915	2135	45	-		4a	PSF	PT	-	45min	8	
B6	METER RM.	A	HM	PT	-	915	2135	45	-		4	PSF	PT	-	20 min	8	
B6a	TENANT STORAGE AREA	A	HM	PT	-	915	2135	45	-		4	PSF	PT	-	20 min	8	
B6b	TENANT STORAGE AREA	A	HM	PT	-	915	2135	45	-		4a	PSF	PT	-	20 min	8	
B6c	PARKS CANADA STORAGE	A	HM	PT	-	915	2135	45	-		4	PSF	PT	-	20 min	8	
BS1	STAIR	C	HM	PT	-	915	2135	45	WG	6mm	1	PSF	PT	-	20 min	5	
BS2	STAIR	C	HM	PT	-	915	2135	45	WG	6mm	1	PSF	PT	-	20 min	5	

Main Level																	
M1a	FRONT ENTRANCE	F	FG	PREFIN	INS	915	2135	45	D-TVG	6+6mm	5	ALC	PREFIN	WD	NA	2	
M1b	VESTIBULE	D	FG	PREFIN	-	915	2135	45	S-TVG	6mm	3	WDF	PT	-	NA	4	
M2	EXIT	D	FG	PREFIN	-	915	2135	45	WG	6mm	2	PSF	PT	-	20 min	6	
M4	EXIT	C	HM	PT	-	915	2135	45	WG	6mm	4	PSF	PT	-	20min	5	
M5a	REAR ENTRANCE	G	FG	PREFIN	INS	915	2135	45	D-TVG	6+6mm	5	ALC	PREFIN	WD	NA	1	
M5b	VESTIBULE	C	FG	PREFIN	-	915	2135	45	S-TVG	6mm	3	WDF	PT	-	NA	3	
M6	JANITOR	A	HM	PT	-	915	2135	45	-	-	4	PSF	PT	-	20 min	8	
M7	ELECTRICAL	A	HM	PT	-	915	2135	45	-	-	2	PSF	PT	-	45 min	8	
Loft Level																	
L1	JANITOR	A	HM	PT	-	915	2135	45	-	-	2	PSF	PT	-	20 min	8	
L2	STORAGE	A	HM	PT	-	915	2135	45	-	-	4	PSF	PT	-	NA	8	
LS1	STAIR	C	HM	PT	-	915	2135	45	WG	6mm	1	PSF	PT	-	20 min	5	
LS2	STAIR	C	HM	PT	-	915	2135	45	WG	6mm	1	PSF	PT	-	20 min	5	

DOOR & FRAME SCHEDULE - SUITES																	
Door #	Location	Type	Door			Width	Height	Thickn ess	Glazing		Type	Frame			Fire Rating (minutes)	Hardware Group	Comments
			Material	Finish	Core				Glazing	Thickness		Material	Finish	Core			
D01	SUITE	E	SCW	PT	PBC	915	2135	45	-	-	2	PSF	PT	-	20 min	10	
D02	BEDROOM	E	HCW	PT	-	813	2135	45	-	-	3	WDF	PT	-	NA	11	
D02a	BEDROOM	E	HCW	PT	-	915	2135	45	-	-	3	WDF	PT	-	NA	11	
D03	BATHROOM	E	HCW	PT	-	762	2135	45	-	-	3	WDF	PT	-	NA	11	
D03a	BATHROOM	E	HCW	PT	-	915	2135	45	-	-	3	WDF	PT	-	NA	11	
D04	BATHROOM	E	HCW	PT	-	2135	45	-	-	-	3	WDF	PT	-	NA	11	
D05	CLOSET	E	HCW	PT	-	610	2135	45	-	-	3	WDF	PT	-	NA	12	
D05a	LAUNDRY	E	HCW	PT	-	915	2135	45	-	-	3	WDF	PT	-	NA	12	
D06	CLOSET	B	HCW	PT	-	610	2135	45	-	-	3	WDF	PT	-	NA	12	



DOOR TYPES

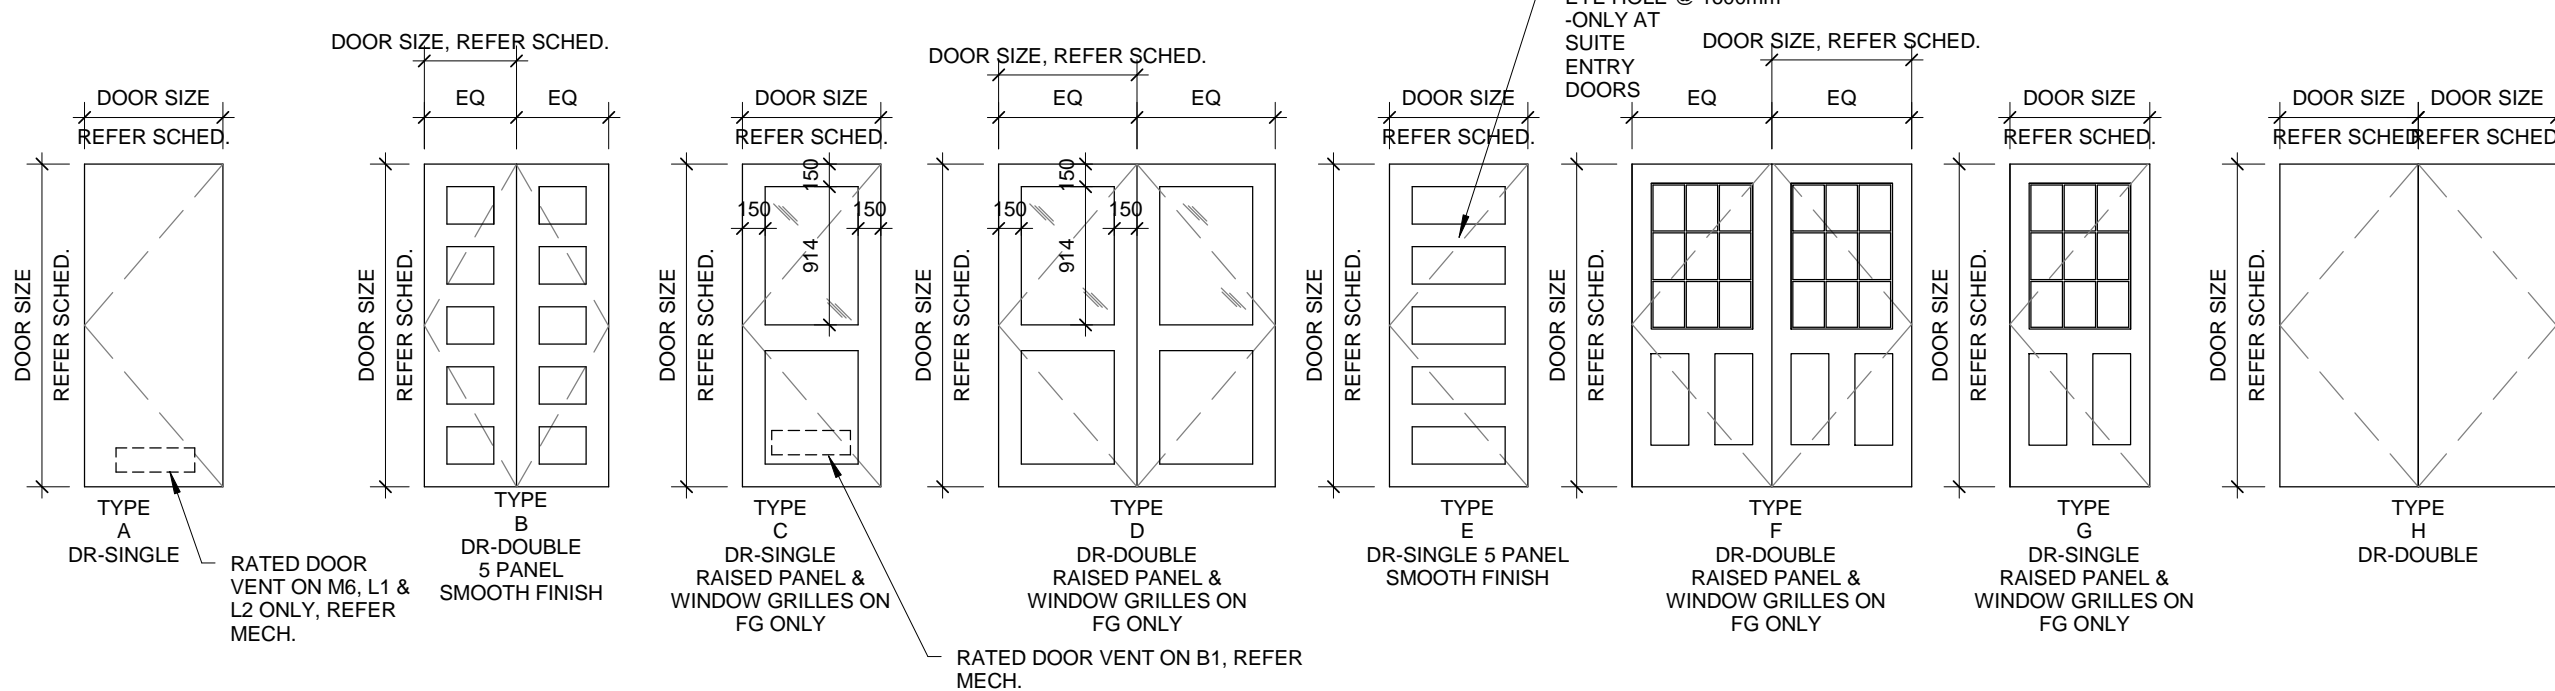

ABBREVIATION LEGEND

WG -WIRED GLASS
S-TVG -SINGLE TEMPERED VISION GLASS
D-TVG -DOUBLE TEMPERED VISION GLASS
HM -HOLLOW METAL
PSF -PRESSED STEEL FRAME
WDF -WOODFRAME
HCW -HOLLOW CORE WOOD
SCW -SOLID CORE WOOD
FG -FIBREGLASS
ALC -ALUMINUM CLAD
PBC -PARTICLE BOARD CORE
INS -INSULATION
PREFIN -PREFINISHED
PT -PAINTED
S, SPEC -SEE SPECIFICATIONS
WS -WEATHER STRIPPING
HO -HANDICAP OPERATOR
WD -WOOD



TYPICAL CORNER & DOOR DETAILS

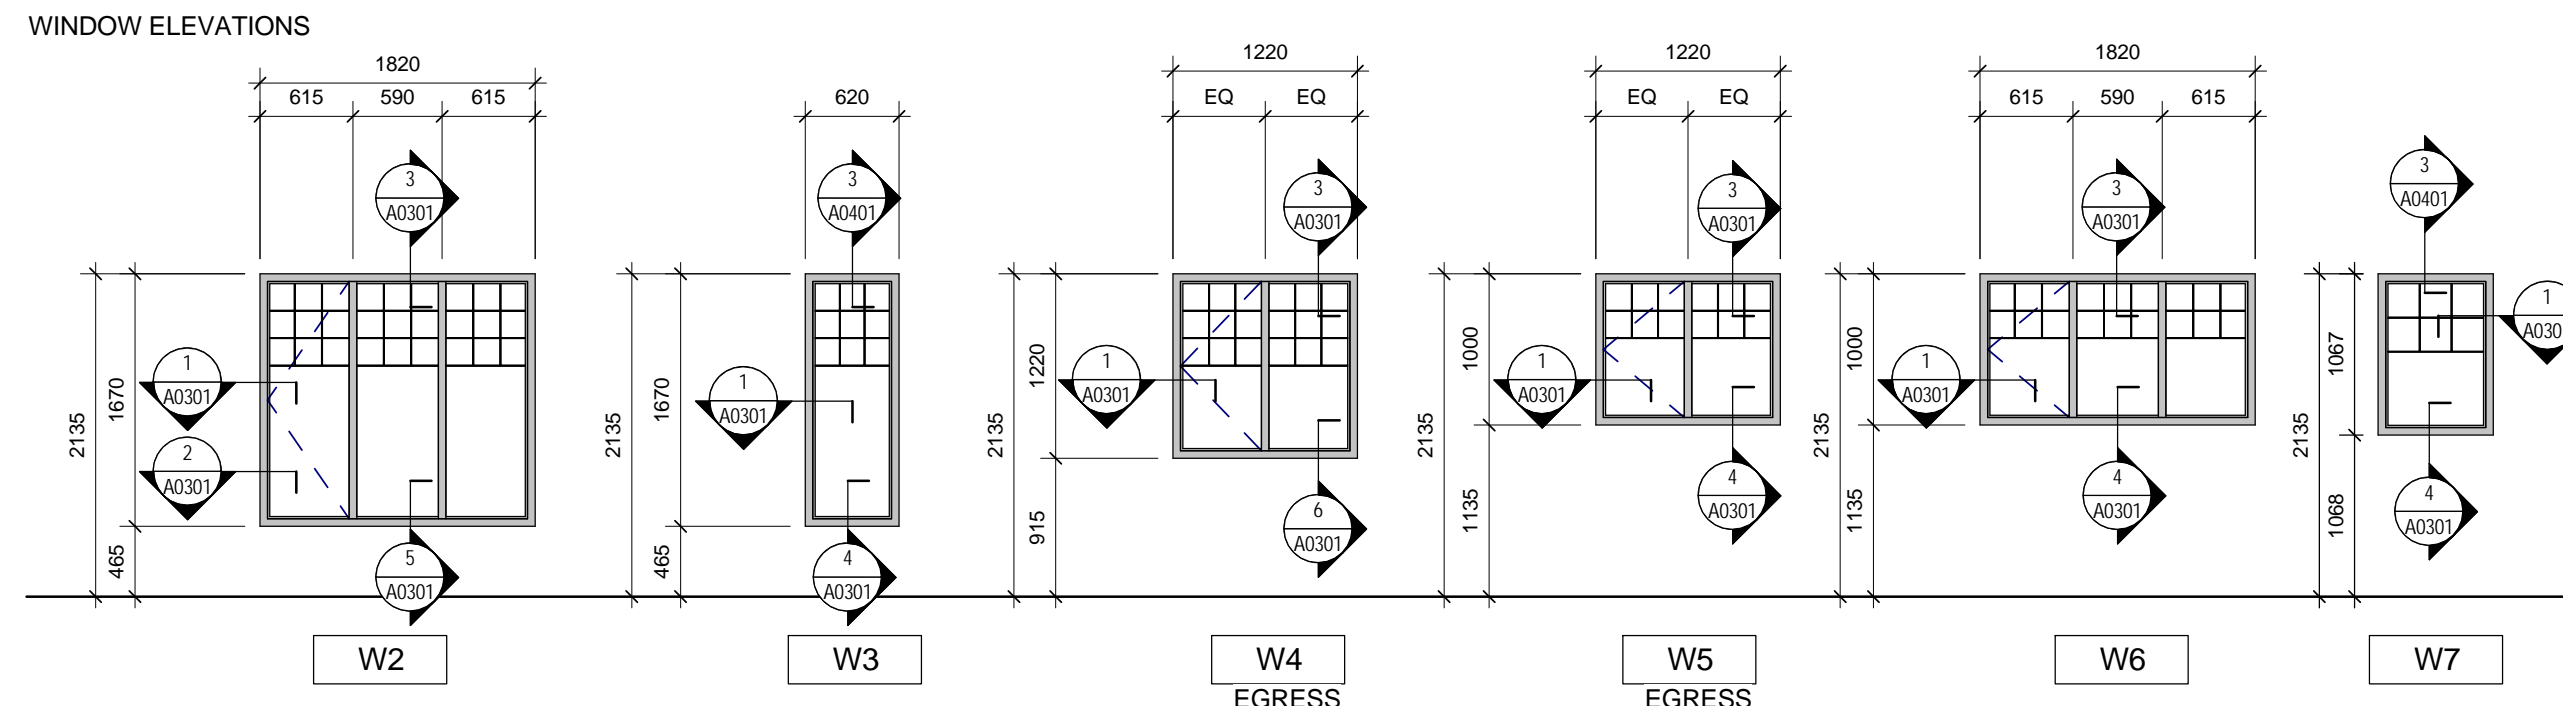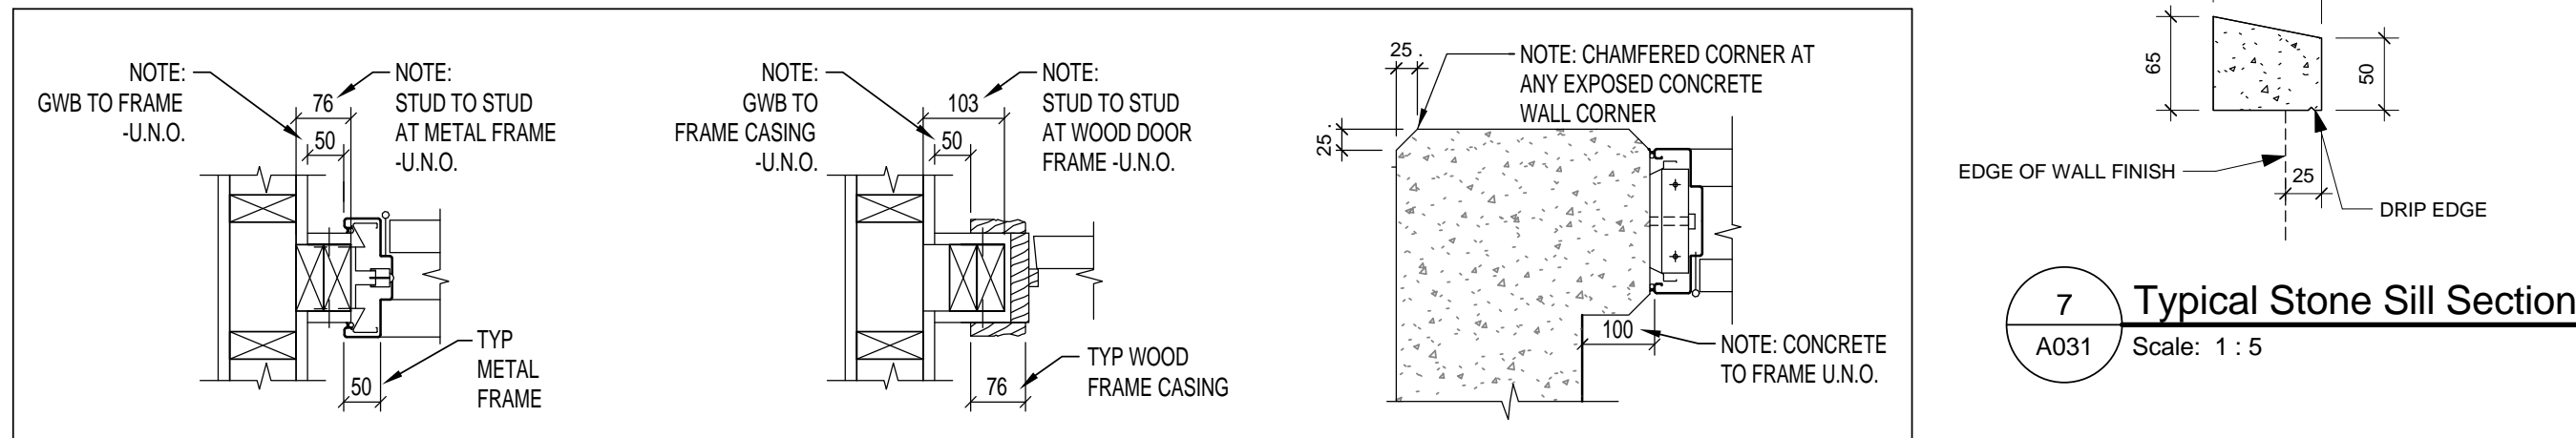

GENERAL WINDOW NOTES


GENERAL CONTRACTOR TO COORDINATE THE INSTALLATION OF ALL WINDOWS WITH ELEVATIONS AND PERTINENT EXTERIOR FINISHES.
SEE WALL ASSEMBLIES FOR WALL CONSTRUCTION. NOTIFY PRIME CONSULTANT OF ANY DISCREPANCIES.
WINDOW DETAILS TO BE READ IN CONJUNCTION WITH EXTERIOR ELEVATIONS AND WINDOW TYPES. CONFIRM LOCATIONS AND EXTENTS OF WINDOWS RELATIVE TO ADJACENT EXTERIOR FINISHES. NOTIFY THE PRIME CONSULTANT OF ANY DISCREPANCIES.
PROVIDE ON SITE INSTALLATION MOCKUP OF ALL TYPICAL WINDOW CONDITIONS FOR REVIEW BY THE PRIME CONSULTANT PRIOR TO INSTALLATION. ANY ALTERNATES TO BE SUBMITTED FOR REVIEW PRIOR TO THE ORDERING OF WINDOWS.

ALL SUBCONTRACTORS TO ENSURE GIVEN EXTERIOR SUBSTRATE SURFACES ARE PREPARED TO RECEIVE WINDOWS AND ASSOCIATED MEMBRANES, BUILDING PAPER, OR SILL DRAINAGE PAN SYSTEM - SEE INSTALLATION DETAILS.
ENSURE ROUGH OPENINGS WITH ASSOCIATED WRAPPINGS SILL DRAINAGE PAN SYSTEM AND WINDOWS ARE PROTECTED DURING AND AFTER COMPLETION OF INSTALLATION.
ARCHITECTURAL WINDOW MUNTEN BARS ARE TO BE INSIDE GLASS.

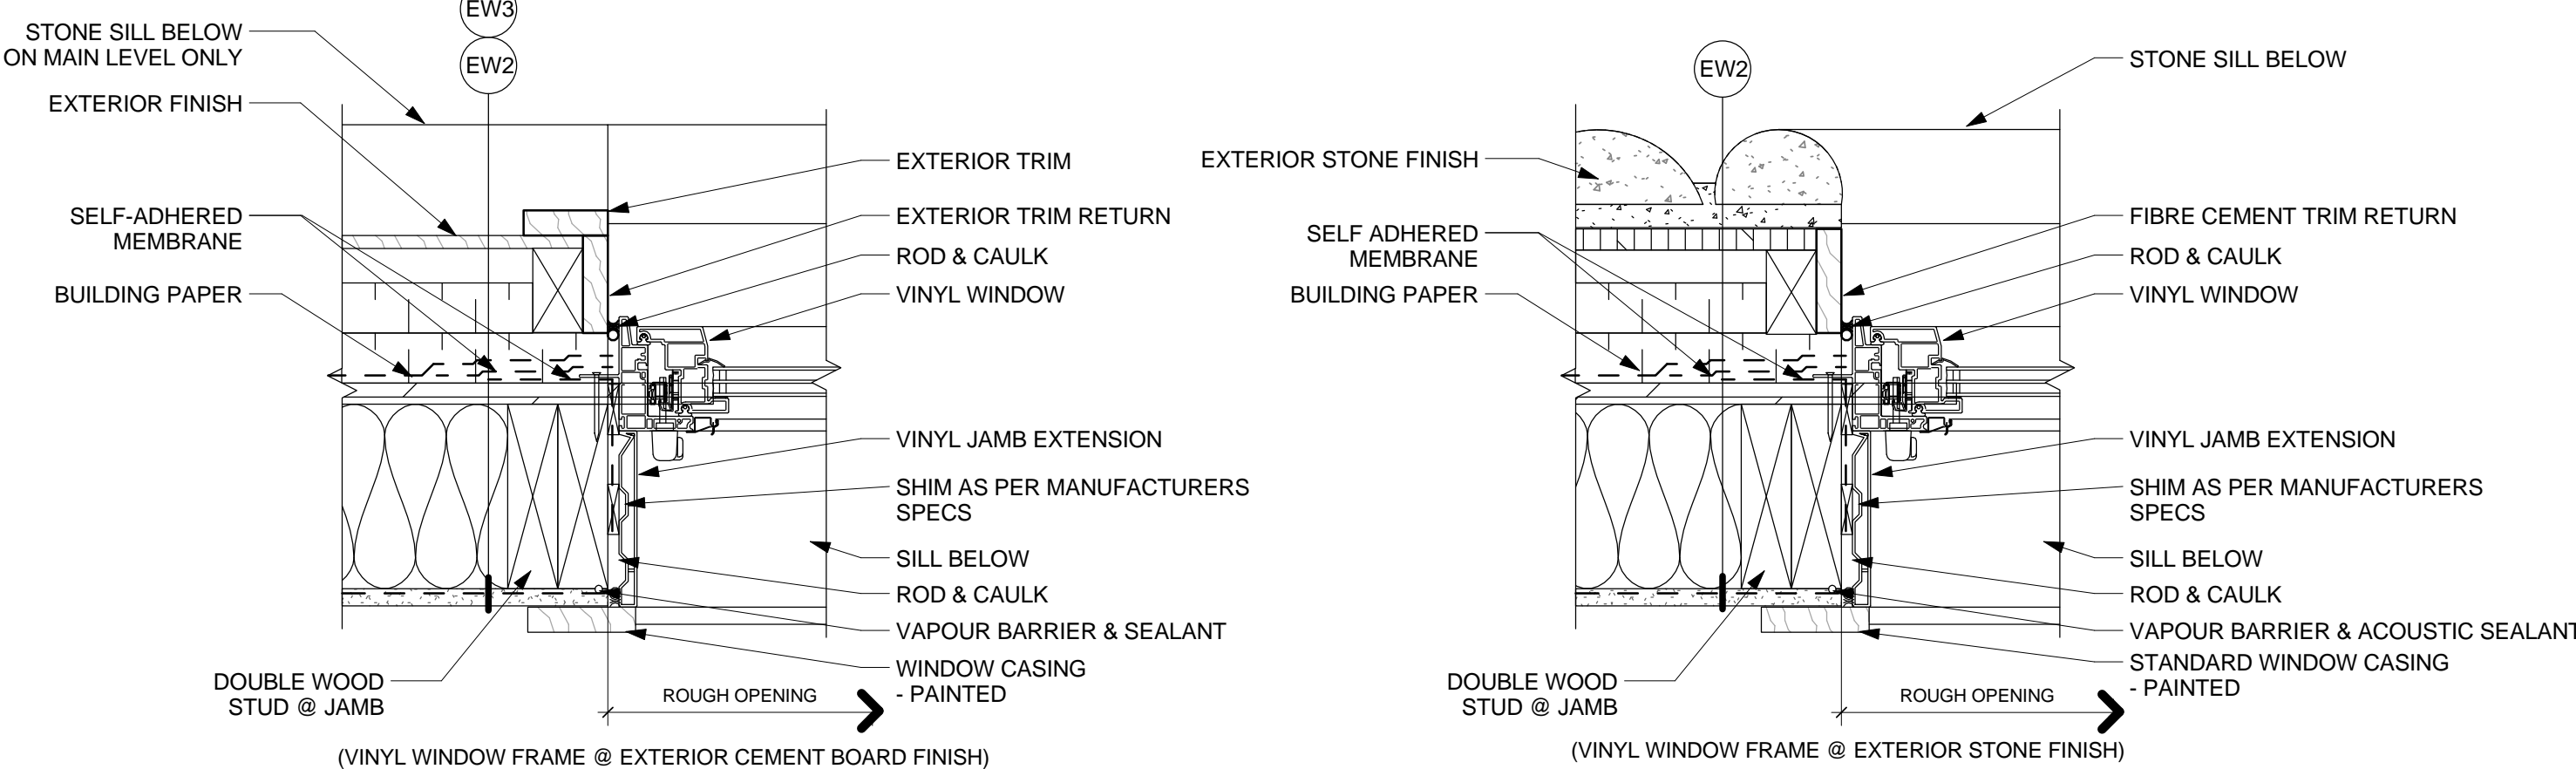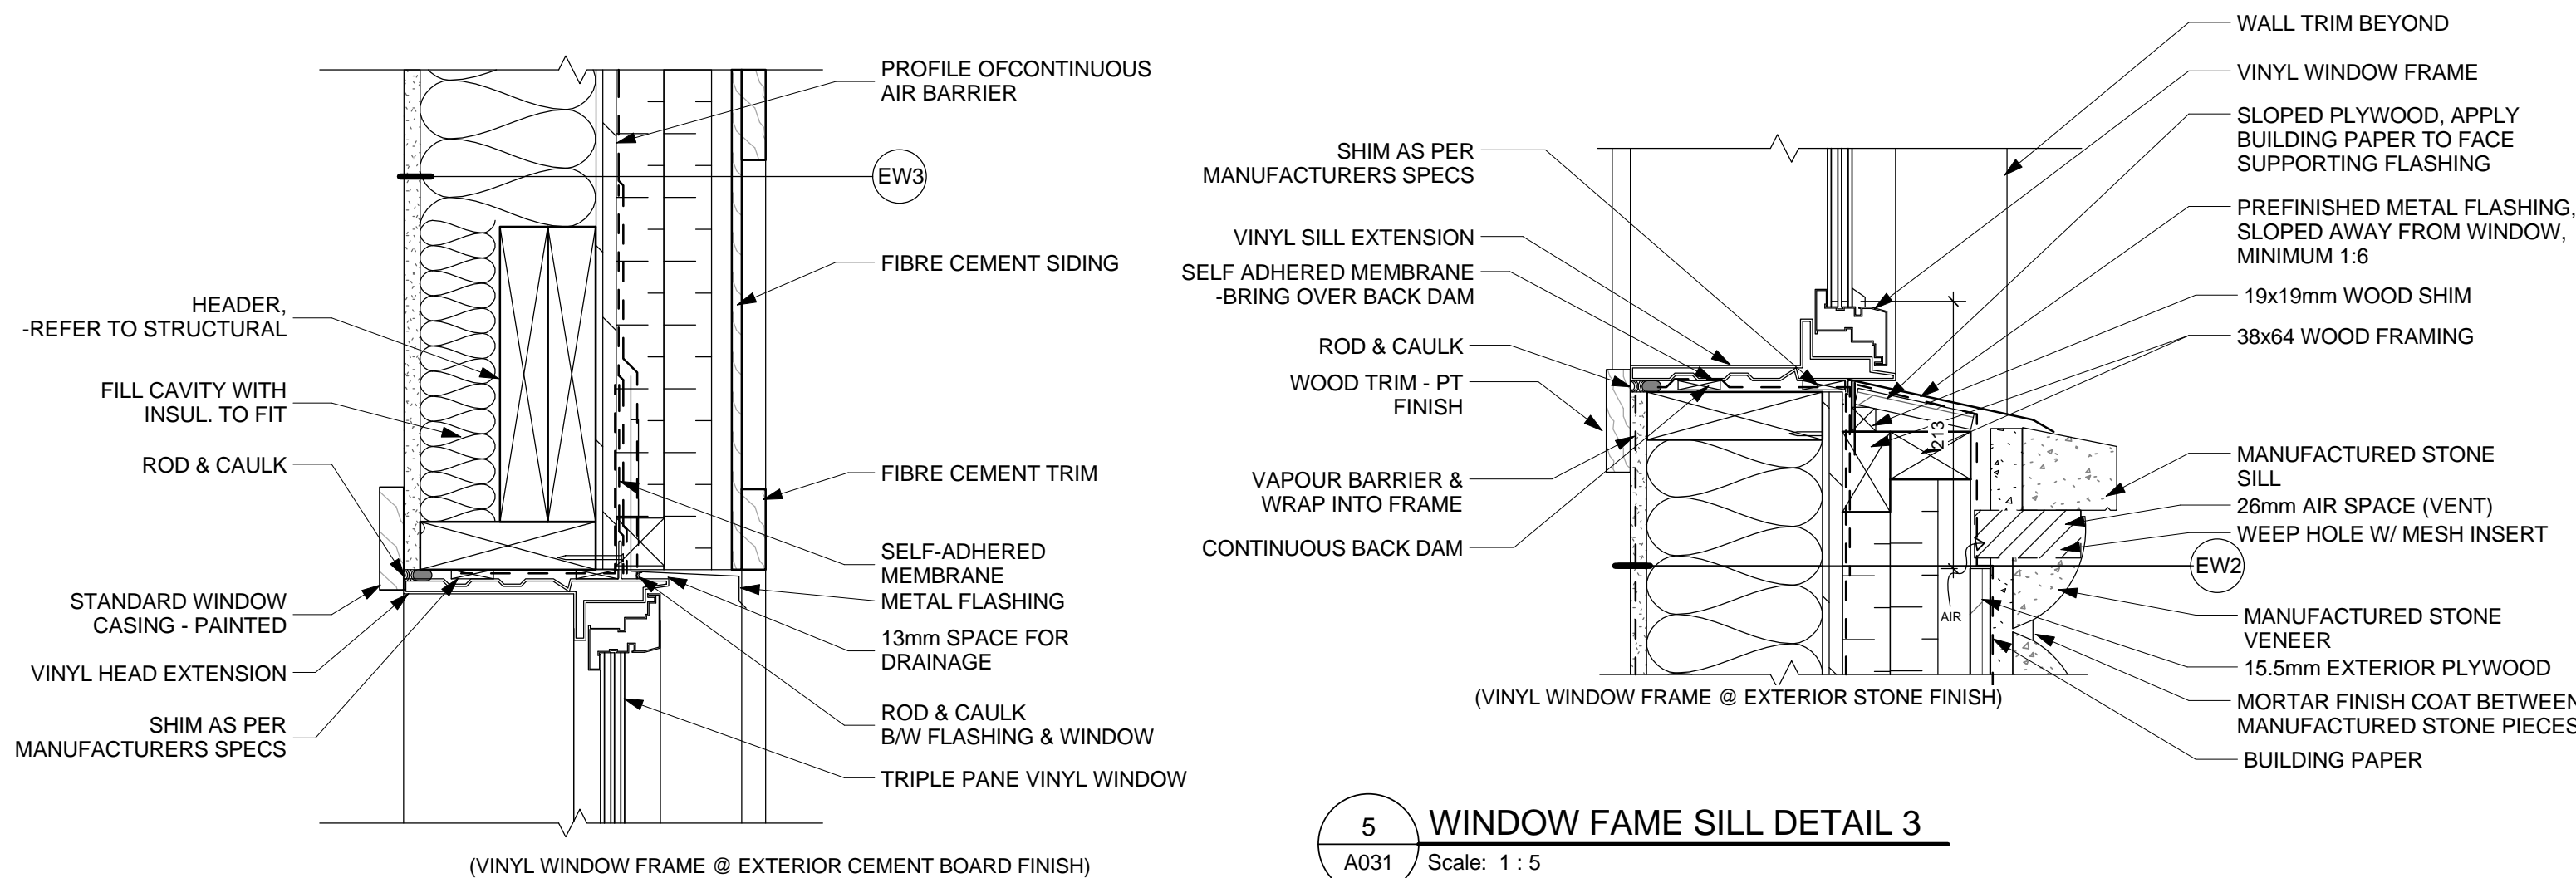

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Sheet Size: ISO B1 - 707x1000mm

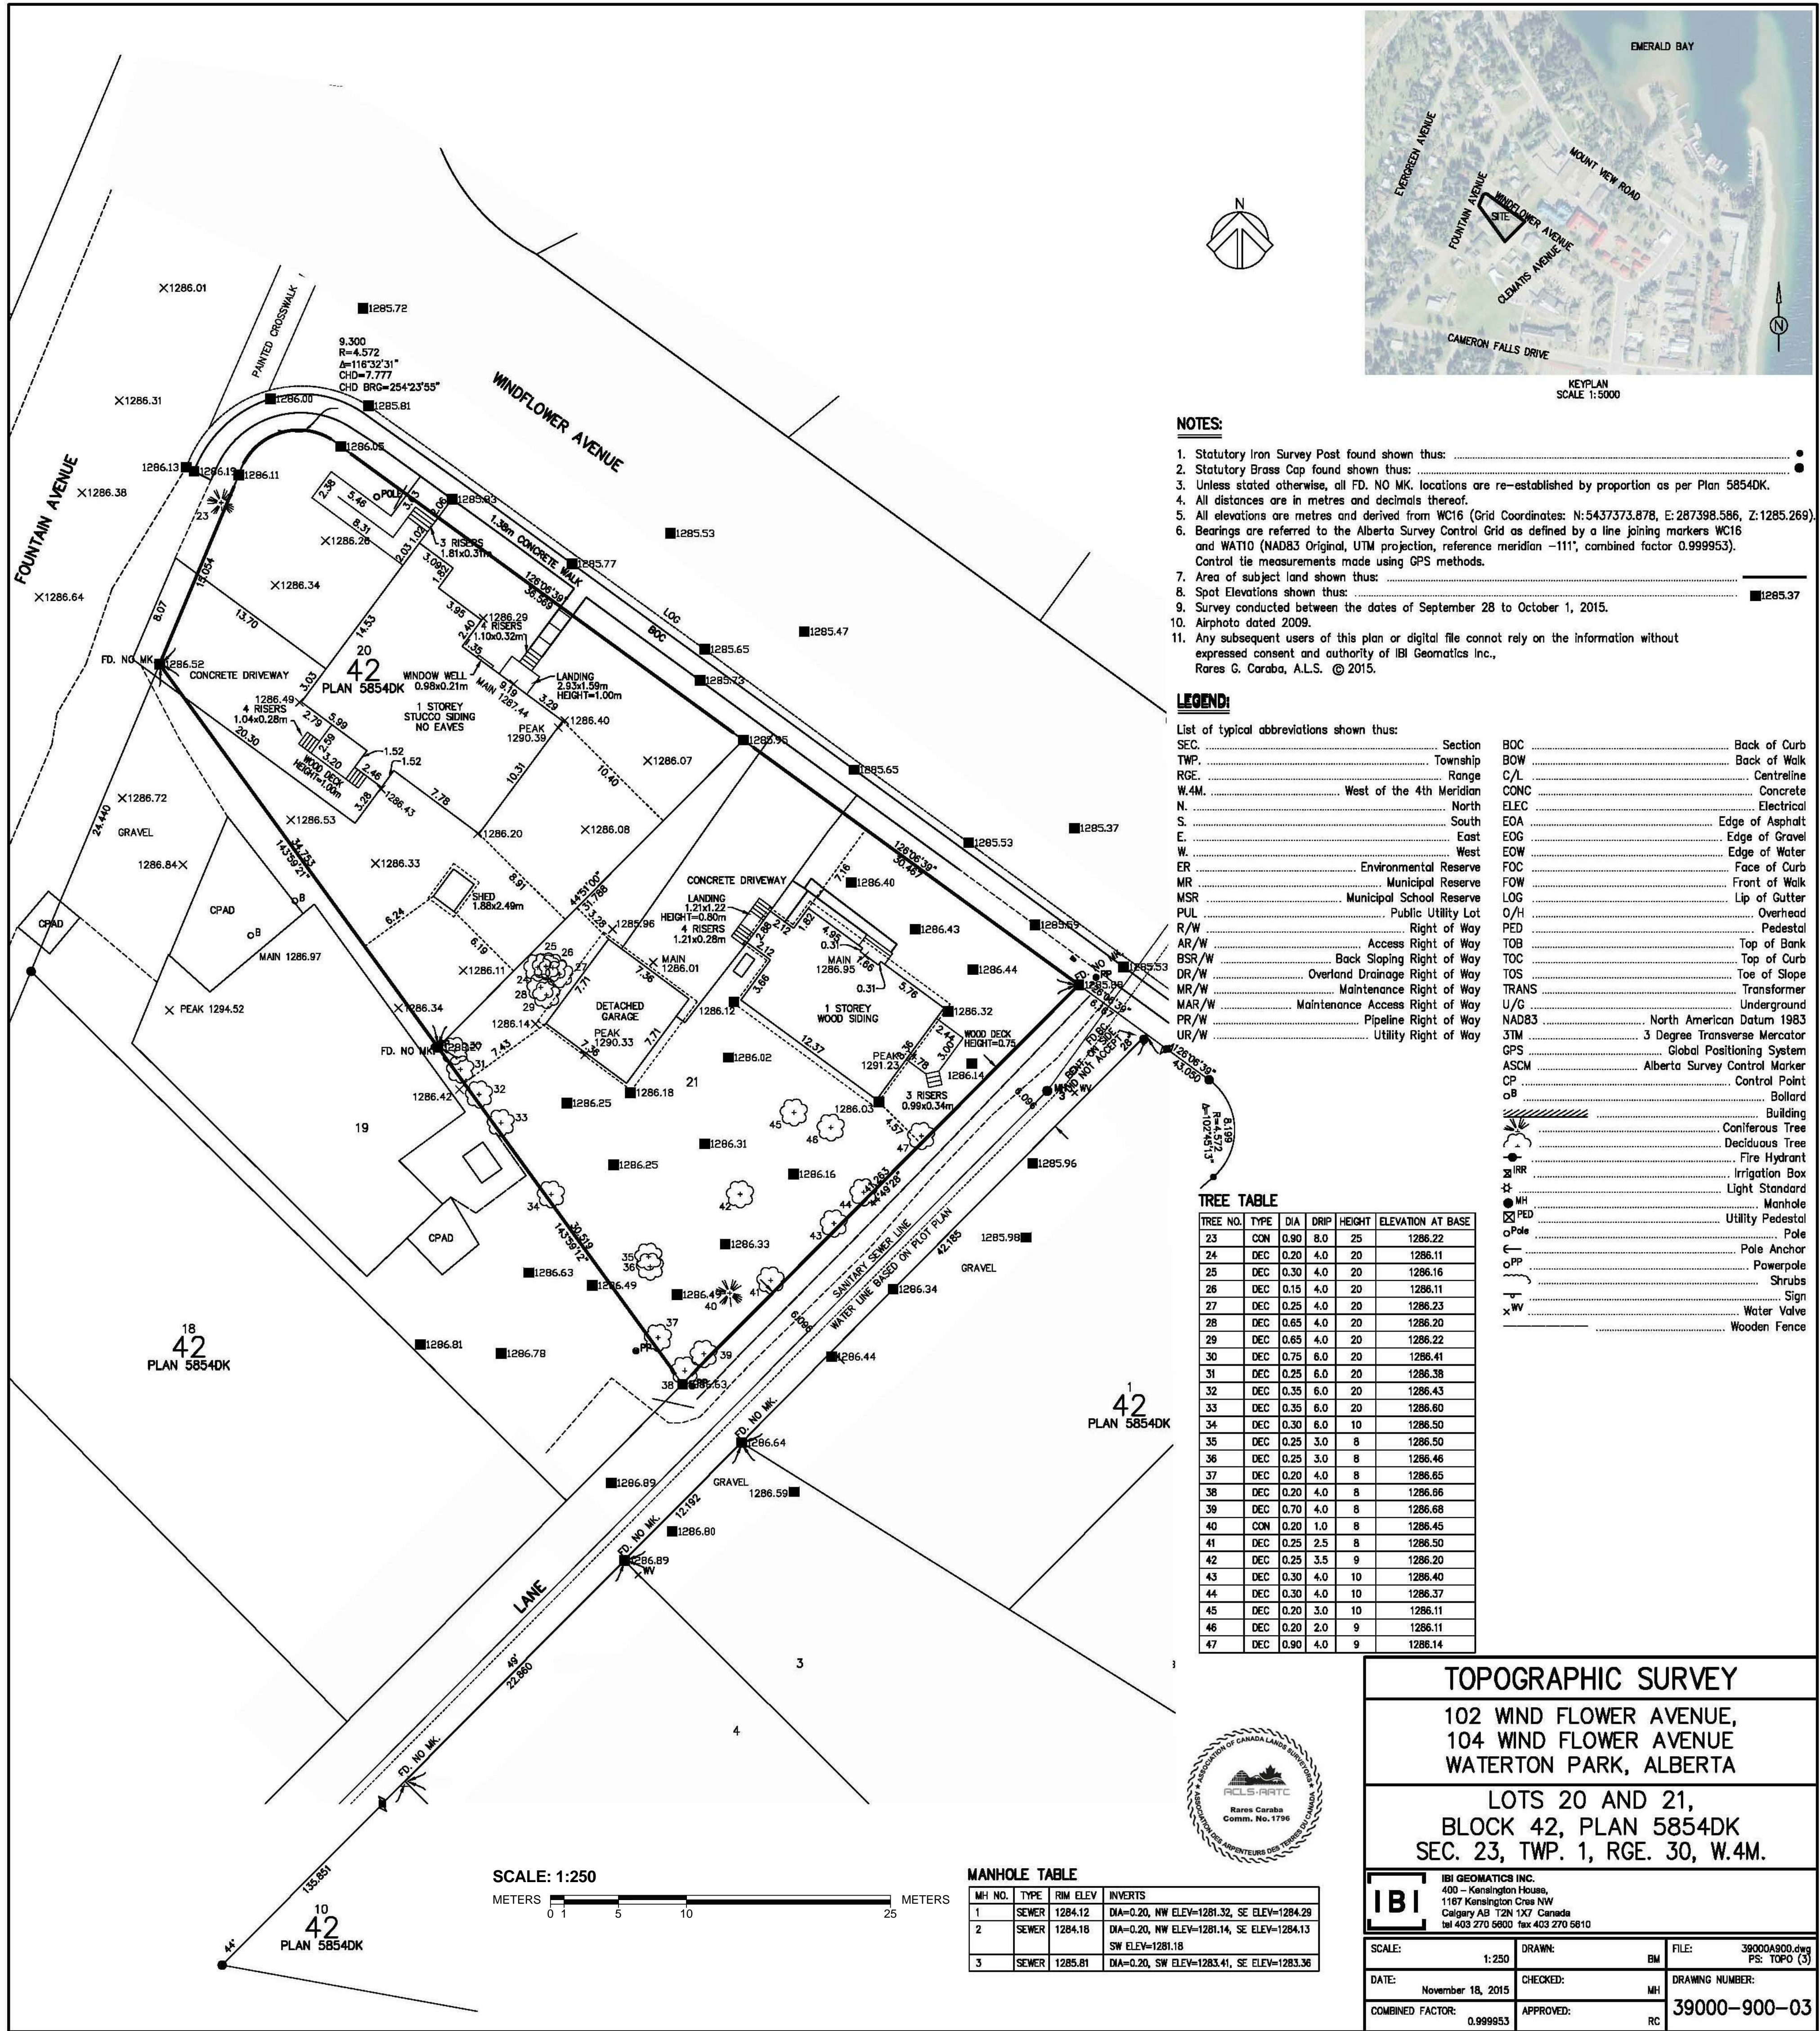

TOPOGRAPHIC SURVEY FOR REFERENCE ONLY

Key Plan



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C detail on drawing no. detail sur dessin no.	C detail on drawing no. detail sur dessin no.

Consultant's Name
Nom de l'expert-conseil

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Client Services Team Southern Alberta Operations Branch	Le Client Entretien l'Équipe Alberta Méridionale Branche d'Opérations

Canada


Client/client	Parks Canada Agence	L'Agence Parcs Canada
	Western and Northern Region	Ouest et Nord du Canada

Staff Housing Phase 2 Waterton Lakes National Park


SURVEY SITE PLAN - LOTS 20 & 21

Surveyed by/Arpenté par	Drawn by/Dessiné par	Date/Date
LS/FVR	MP/AG	2016-12-08
Designed by/Concept par	Reviewed by/Revisé par	Scale/Echelle
LS/FVR	LS/FVR	As indicated
PWGSC Project Manager/Administrateur de Projets TPSPCC		
Randy Boldt		
Client Acceptance/Acceptation du client		
Approved by/Approuvé par		
Task Responsible/Responsable de la tâche		
Task Manager/Administrateur de la tâche		
Project No./No. du projet	Asset No./No. du bien	Sheet No./ No. de la feuille
39000	File # 945	
Drawing Reference No./No. de référence du dessin		A101

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1 SITE PLAN - LOTS 20 & 21
A111 Scale: 1:100

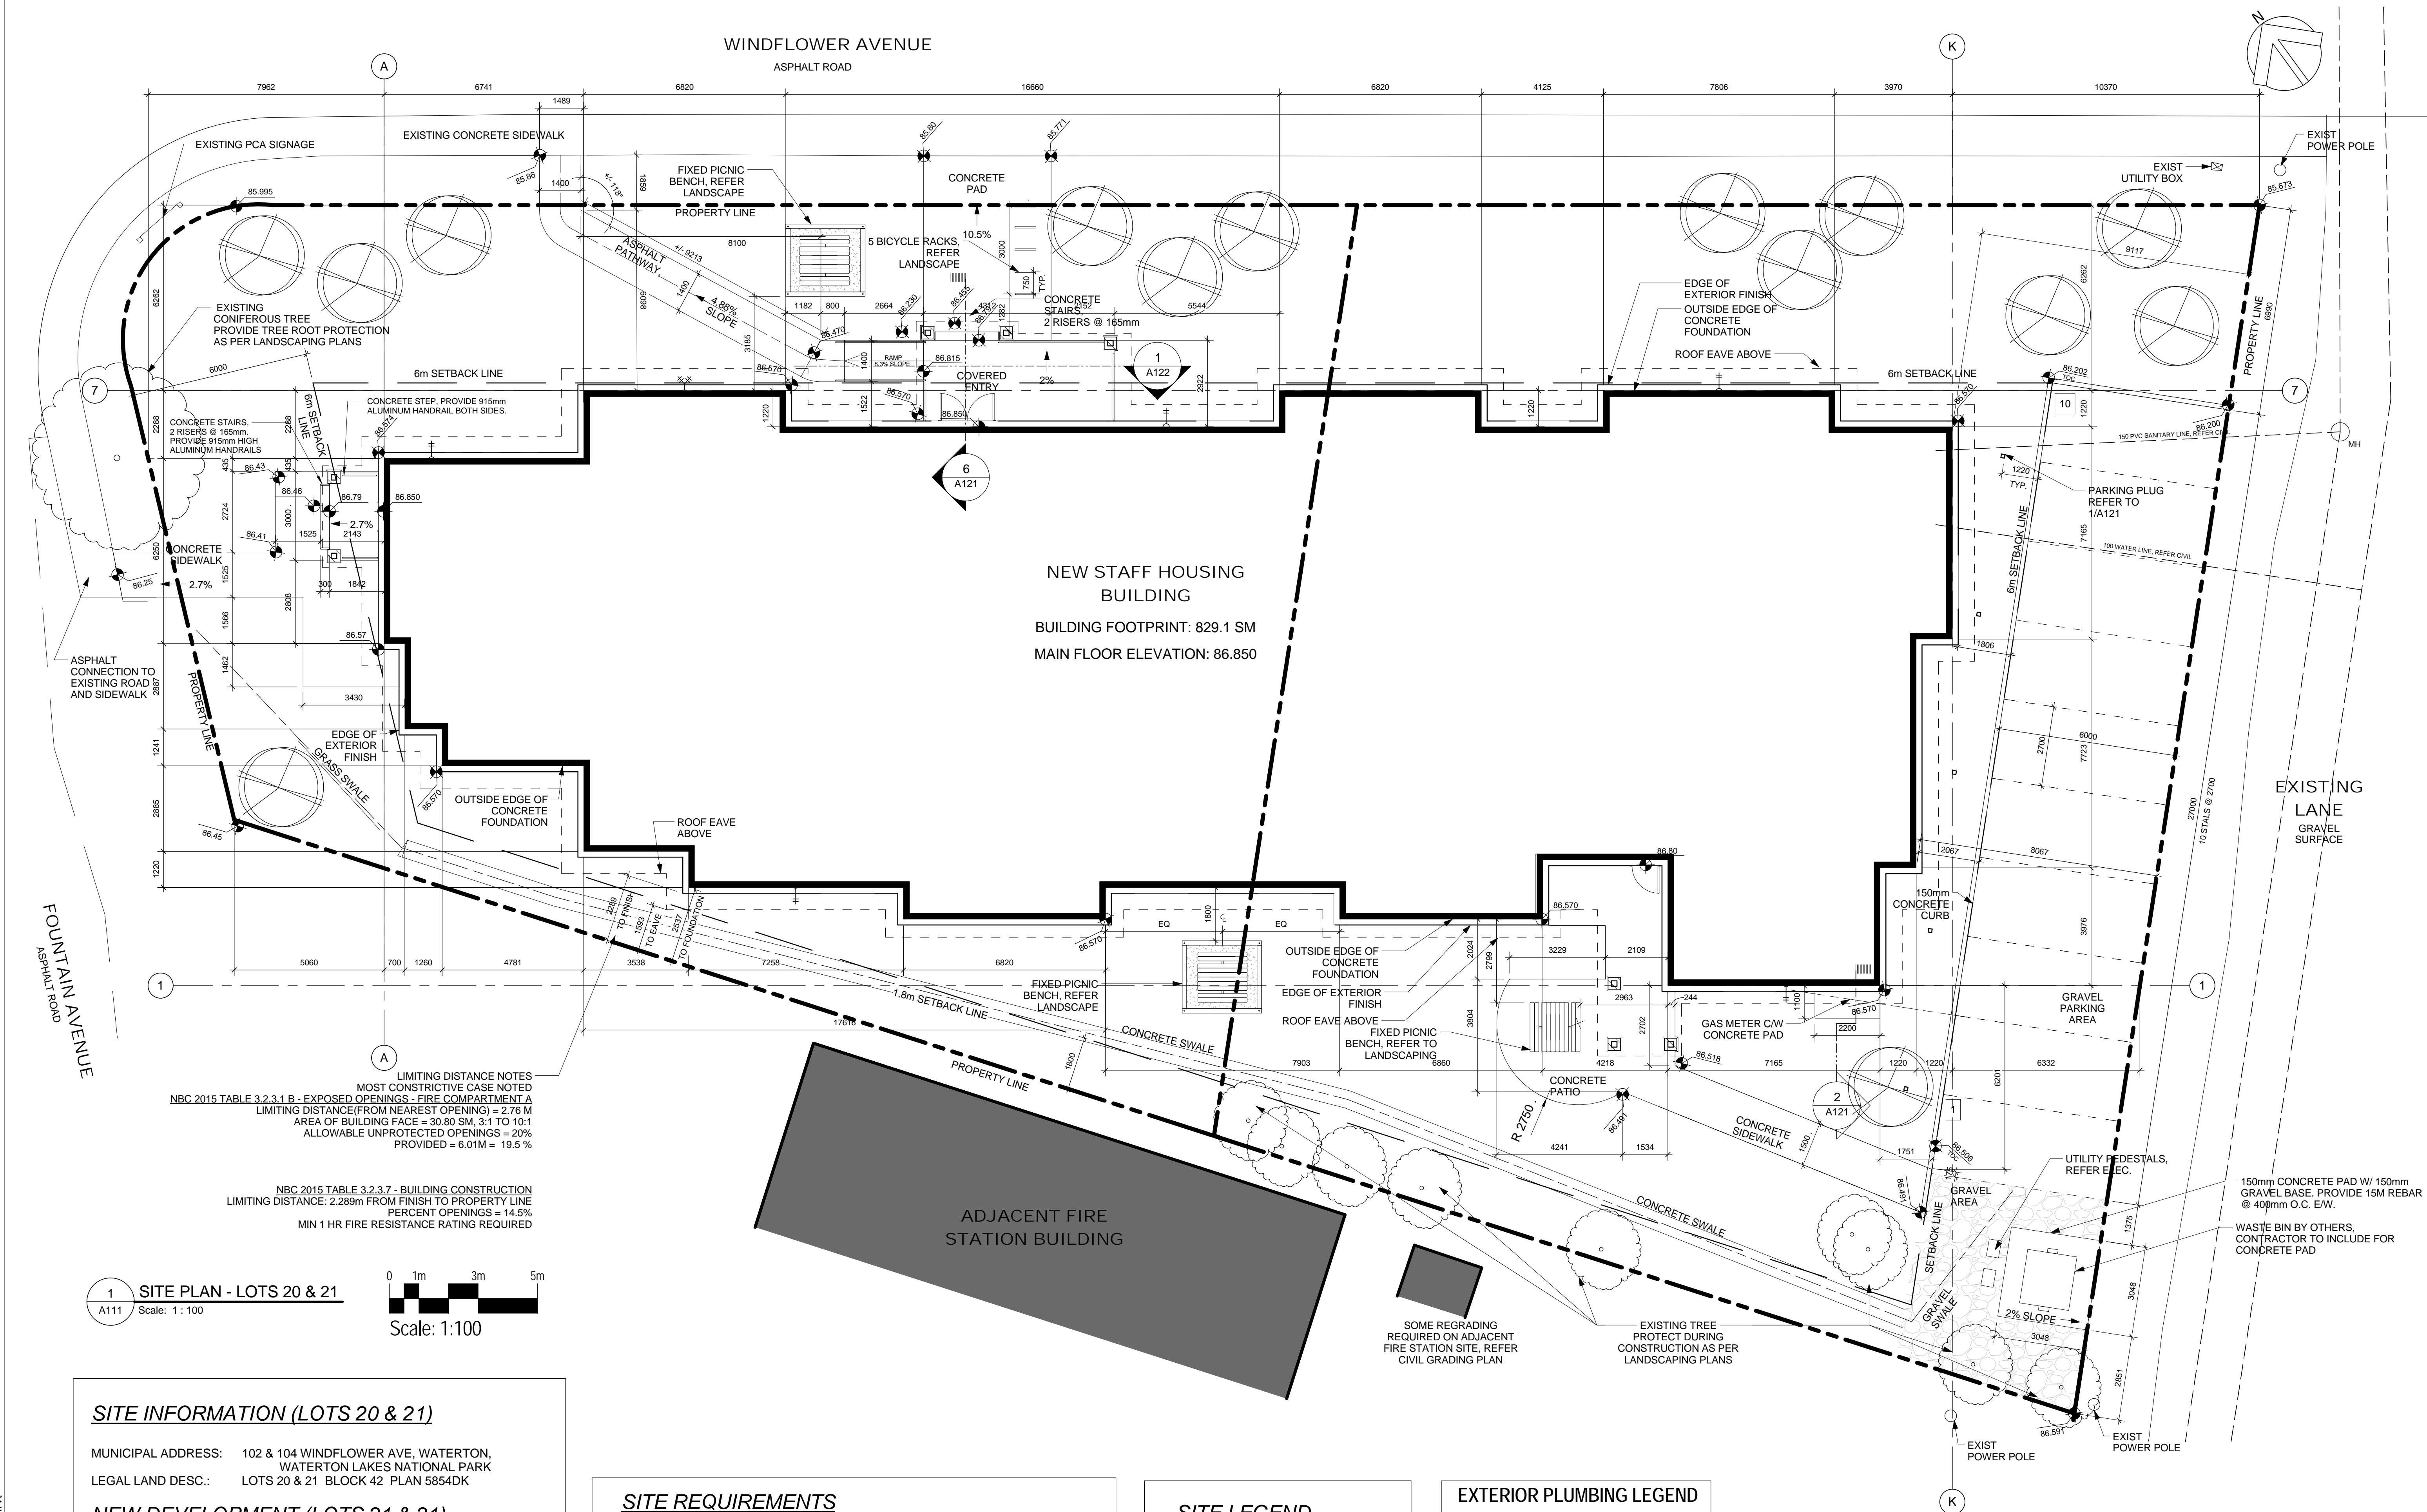

SITE INFORMATION (LOTS 20 & 21)

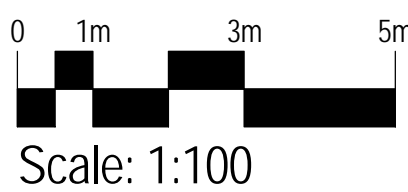MUNICIPAL ADDRESS: 102 & 104 WINDFLOWER AVE, WATERTON,
WATERTON LAKES NATIONAL PARK
LEGAL LAND DESC.: LOTS 20 & 21 BLOCK 42 PLAN 5854DK

NEW DEVELOPMENT (LOTS 21 & 21)

SITE AREA: 2082.842 m² (22,419.5 ft²)
BUILDING FOOTPRINT: 829.1 m² (8,924.4 ft²)
SITE COVERAGE: 39.8%
PROVIDED LANDSCAPING AREA: 51.0%
PROVIDED DENSITY (FAR): 0.86

PARKING STALLS PROVIDED: 10 STALLS (REMAINING STALLS
PROVIDED ON LOT 39 IN PHASE 1)

FLOOR AREA SCHEDULE

FLOOR AREAS AS DEFINED BY COMMUNITY PLAN:
(EXITS, VERTICAL CONNECTIONS & MECHANICAL & ELECTRICAL SPACES
ARE EXCLUDED)

BASEMENT: 673.8 m² (7,252.7 ft²)
MAIN FLOOR: 761.1 m² (8,192.4 ft²)
LOFT FLOOR: 357.4 m² (3,847.0 ft²)

TOTAL AREA: 1792.3 m² (19,292.2 ft²)
*LOFT FLOOR AREA IS 47.0% OF THE MAIN FLOOR AREA

GROSS CONSTRUCTED FLOOR AREAS(OUTSIDE OF WALL):

BASEMENT: 829.1 m² (8,924.4 ft²)
MAIN FLOOR: 860.2 m² (9,259.1 ft²)
LOFT FLOOR: 494.2 m² (5,319.5 ft²)

TOTAL GROSS AREA: 2,183.5 m² (23,503.0 ft²)

SITE REQUIREMENTS

LAND USE ZONING: INSTITUTIONAL
MAXIMUM SITE COVERAGE: 40%
MINIMUM LANDSCAPE AREA: 20% (NOT INCLUDING PARKING)
MAXIMUM DENSITY (FAR): 1.4
MAXIMUM HEIGHT: 10 m
MAXIMUM EAVELINE HEIGHT (STREET): 3.5m
MAXIMUM EAVELINE HEIGHT (BACK LANE): 7 m
PARKING REQUIREMENT: 2 STALLS / 3 BEDS
= 18 STALLS REQUIRED
(SOME STALLS LOCATED ON LOT 39)

UNIT COUNT

SUITE A: 1 bedroom

Main Building: 25 bedrooms

Main (17 beds)

2 - 3 Bedroom Units

5 - 2 Bedroom Units

1 - 1 Bedroom Unit

Loft (8 beds)

3 - 2 Bedroom Units

2 - 1 Bedroom Units

SITE LEGEND

0.000m NEW GRADE
0.000m EXISTING GRADE
NEW TREE
EXISTING TREE

EXTERIOR PLUMBING LEGEND

SC FIRE DEPARTMENT
SIAMMSE CONNECTION
-REFER TO DETAIL 6/A801
HB HOSE BIBB
-REFER TO MECHANICAL

NOTE: PROVIDE EAVE PROTECTION FOR MAIN
FLOOR WINDOWS AND DOORS WHERE EAVE IS
WITHIN 1.2m EITHER SIDE OF OPENING. REFER
DETAIL 1/A803

SITE GENERAL NOTES

- THE CONTRACTOR SHALL SITE VERIFY THE SURVEY INFORMATION PRIOR TO
PROCEEDING WITH THE WORK. FAILURE TO REPORT ANY DISCREPANCIES SHALL
CONSTITUTE ACCEPTANCE OF THE SITE CONDITIONS.
- ALL DIMENSIONS, INCLUDING EXISTING DIMENSIONS AND SETTING-OUT
GEOMETRIES, SHALL BE SITE VERIFIED BY THE CONTRACTOR PRIOR TO PROCEEDING
WITH THE WORK.
- UNLESS NOTED OTHERWISE, MAKE GOOD ALL AREAS DISTURBED BY
EXCAVATION AND/OR INSTALLATION OF CIVIL, MECHANICAL, AND ELECTRICAL SERVICES.
REFER TO CIVIL, MECHANICAL, AND ELECTRICAL DRAWINGS.

REFER TO A141 FOR DEMOLITION SITE PLAN

Key Plan



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6	2016-12-08	ISSUED FOR TENDER		
5	2016-12-08	ISSUED FOR BUILDING PERMIT		
4	2016-08-02	ISSUED FOR 99% REVIEW		
3	2016-06-14	ISSUED FOR 66% REVIEW		
2	2016-05-09	ISSUED FOR 33% REVIEW		
1	2016-05-06	DEVELOPMENT PERMIT REVIEW		

Revision / Revision	
A detail number numero de detail	A
B source drawing no. de dessin no.	B
C detail on drawing no. detail sur dessin no.	C

Consultant's Name
Nom de l'expert-consult

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Canada

Western and
Northern Region
Ouest et Nord
du Canada

Project title/Titre du projet

Staff Housing Phase 2
Waterton Lakes National
Park

Drawing title/Titre du dessin

SITE PLAN - NEW
CONSTRUCTION LOTS 20 & 21

Surveyed by/Arpenté par	Drawn by/Dessiné par	Date/Date
MP/AG	MP/AG	2016-12-08
Designed by/Concept par	Reviewed by/Revisé par	Scale/Echelle
LS/FVR	LS/FVR	As indicated

PWOSC Project Manager/Administrateur de Projet TPSCC

Client Acceptance/Acceptation du client

Approved by/Approuvé par

Task Responsible/Responsable de la tâche




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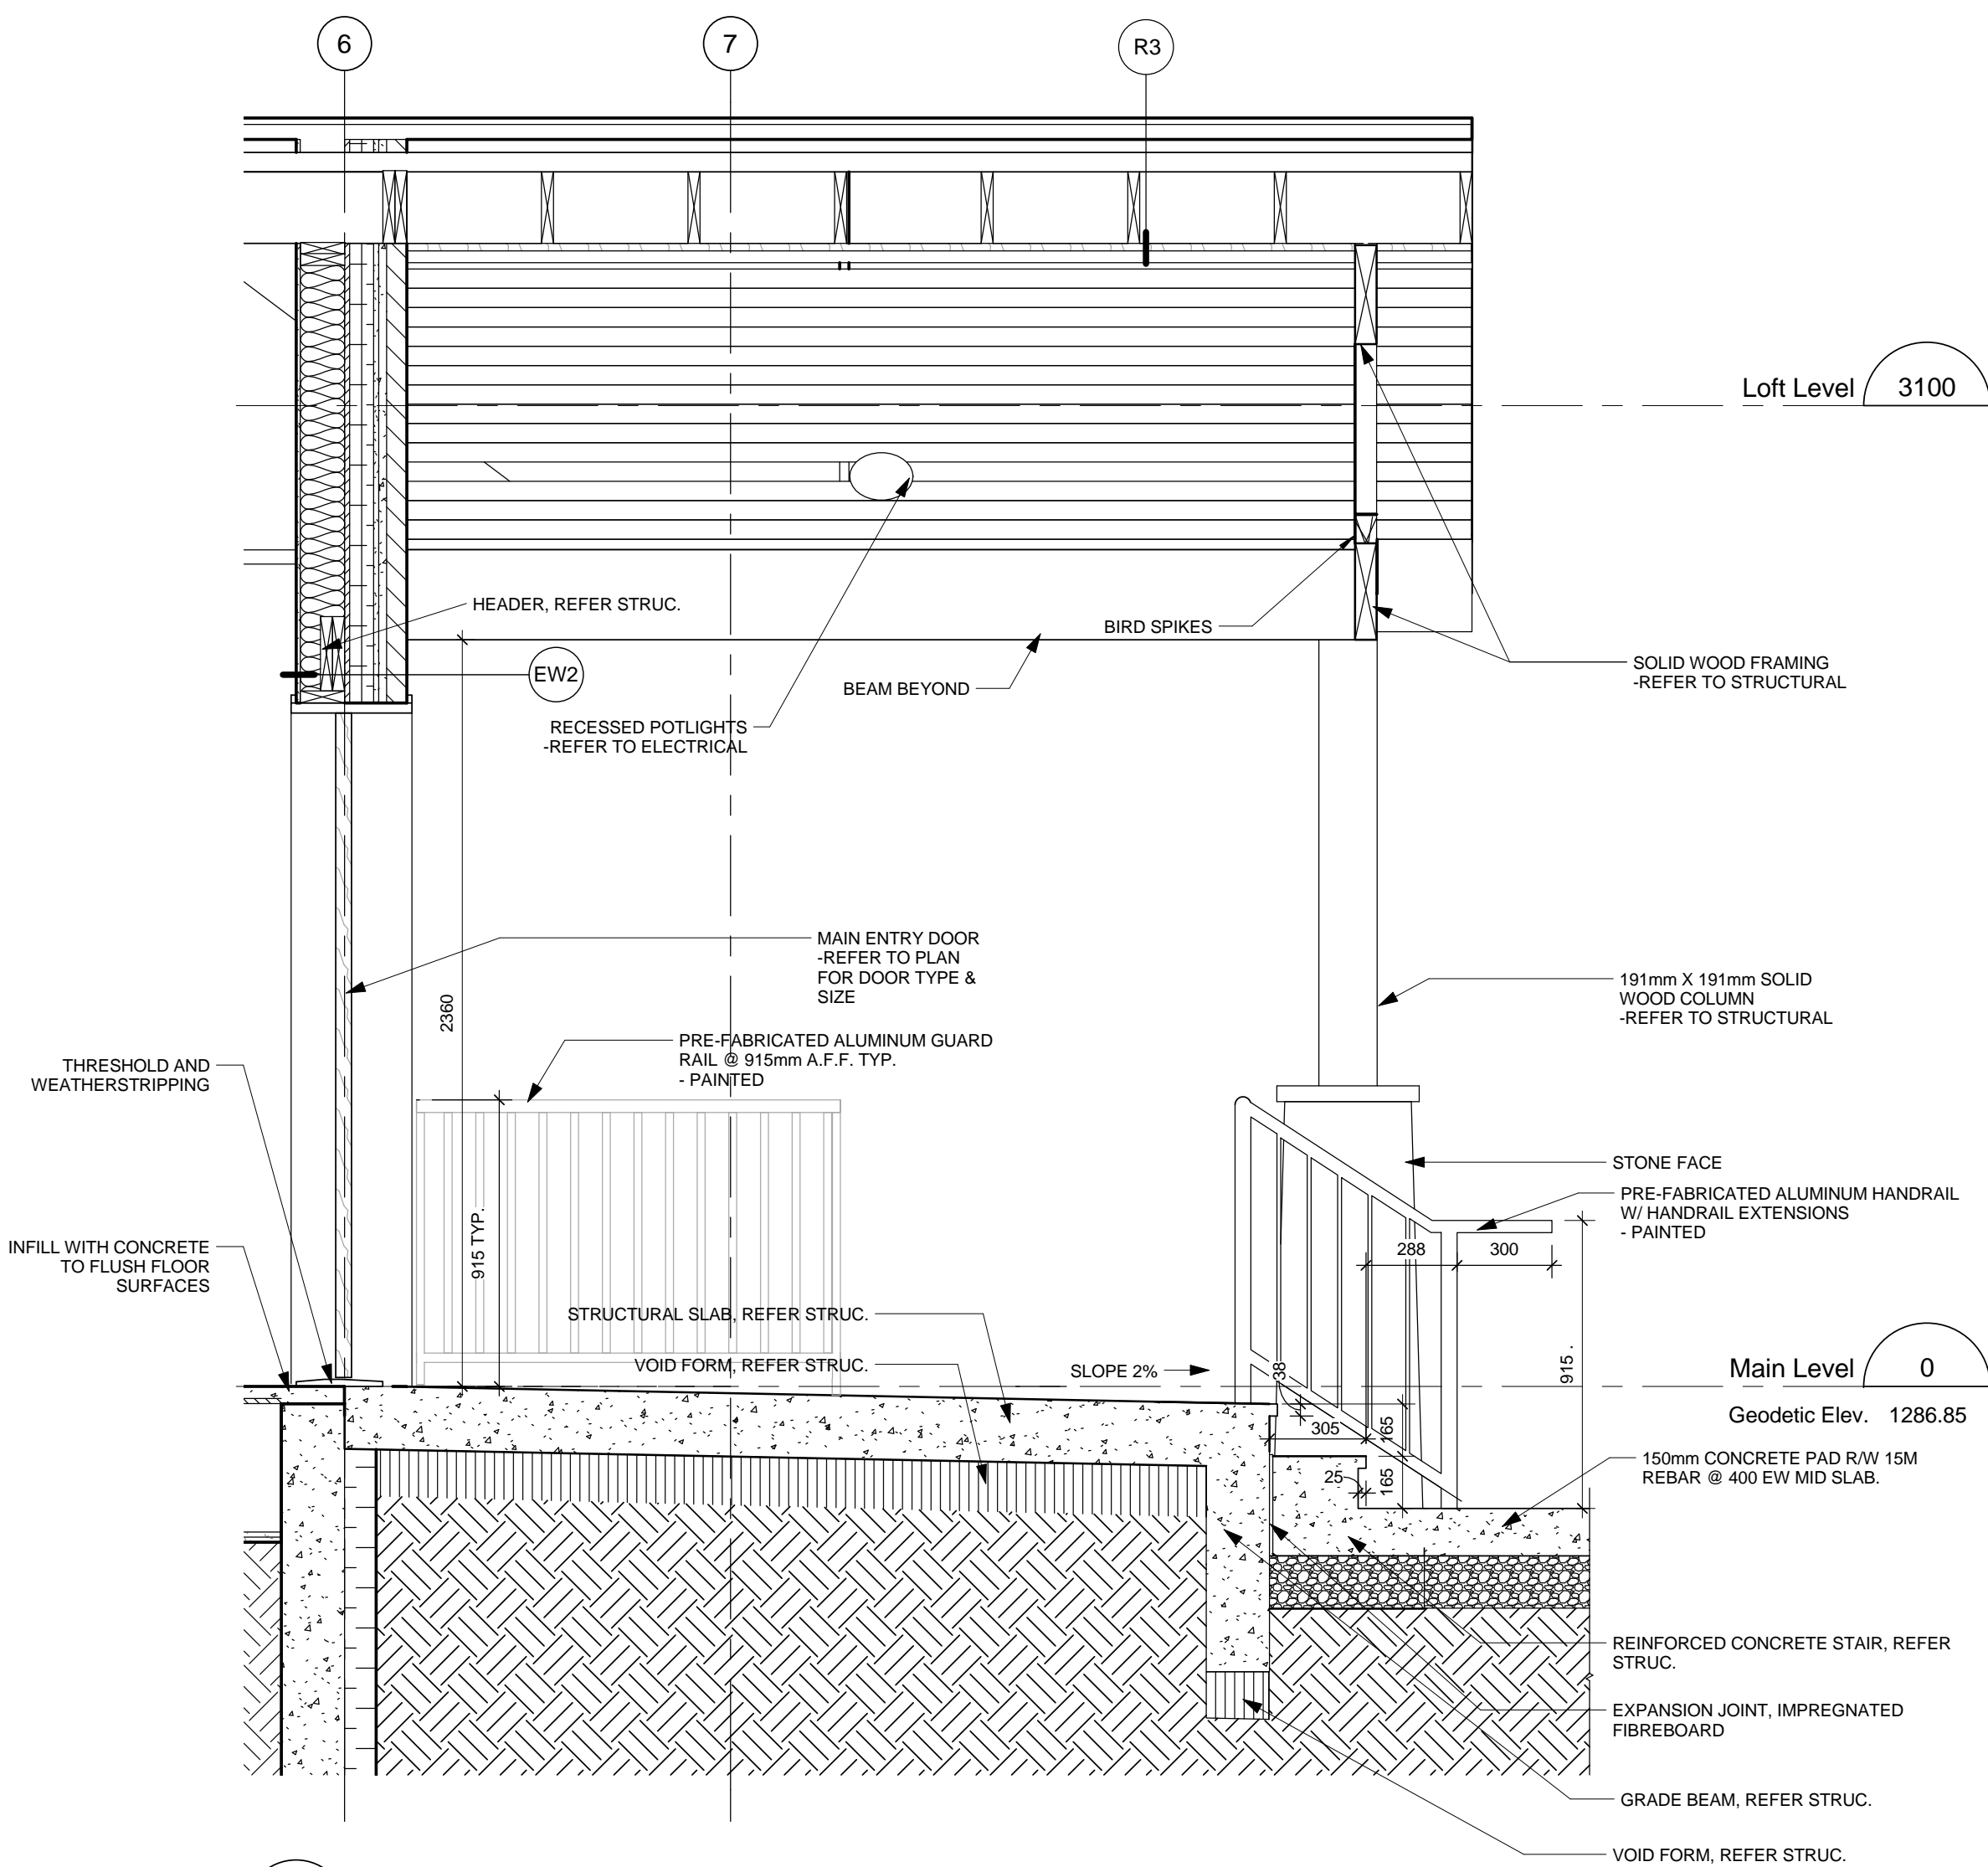
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No. de la feuille

Drawing Reference No./No. de référence du dessin


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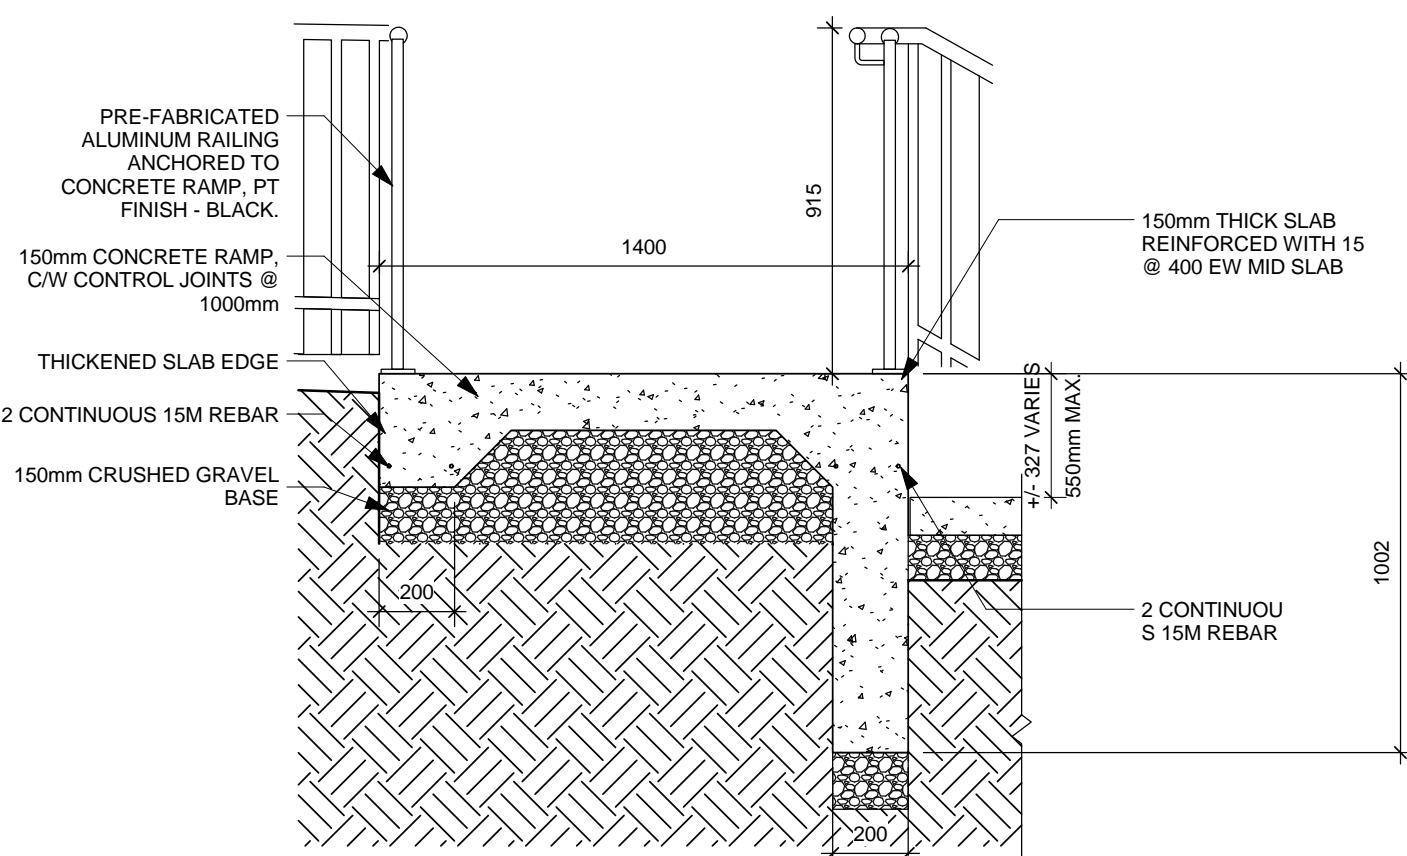
1 PARKING LOT ELECTRICAL DETAIL
Scale: 1 : 10




6 SECTION THROUGH FRONT ENTRY PAD
Scale: 1 : 20

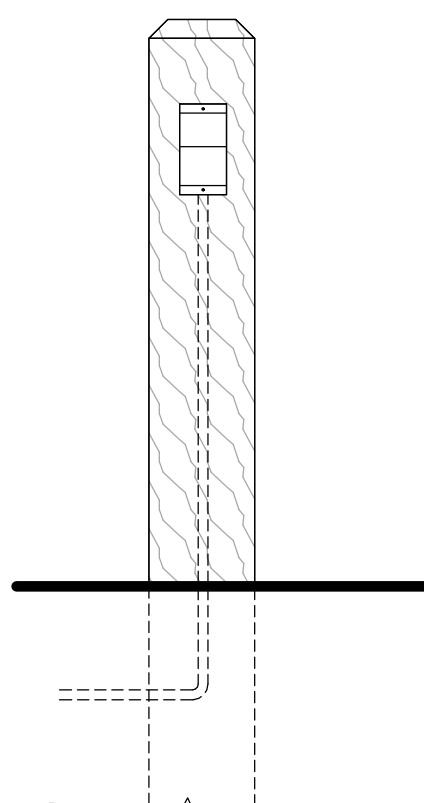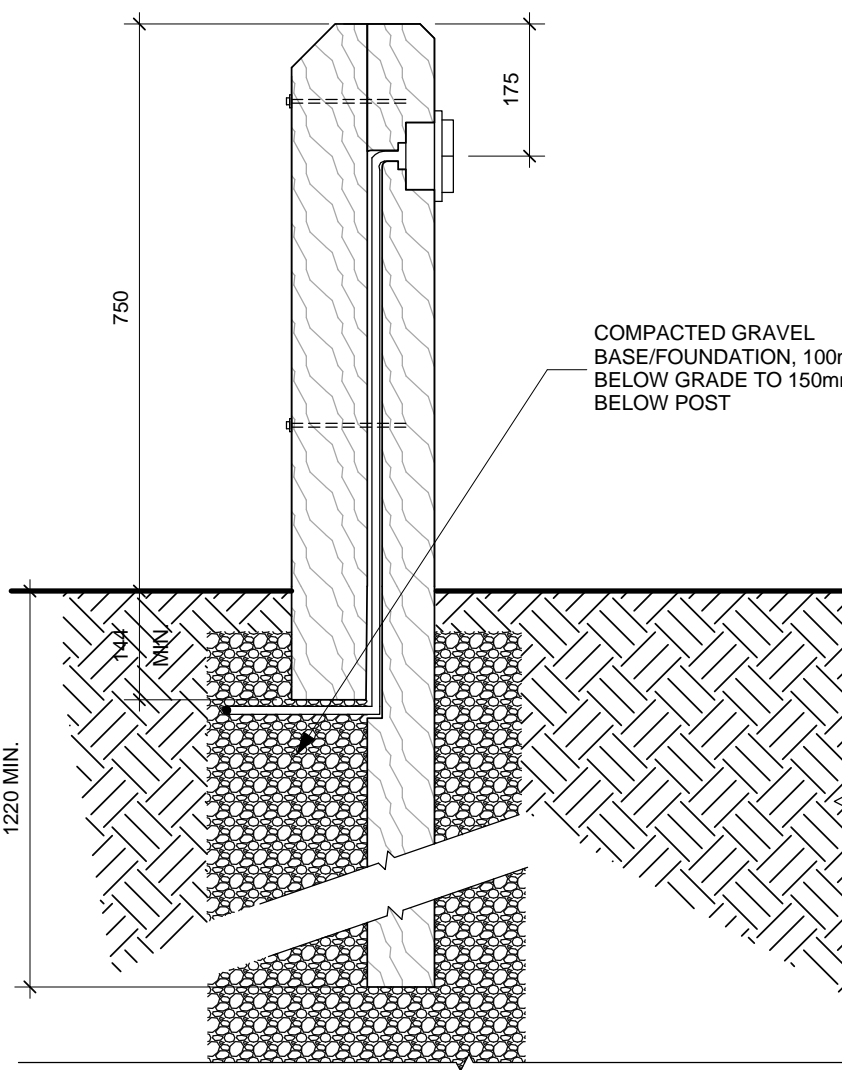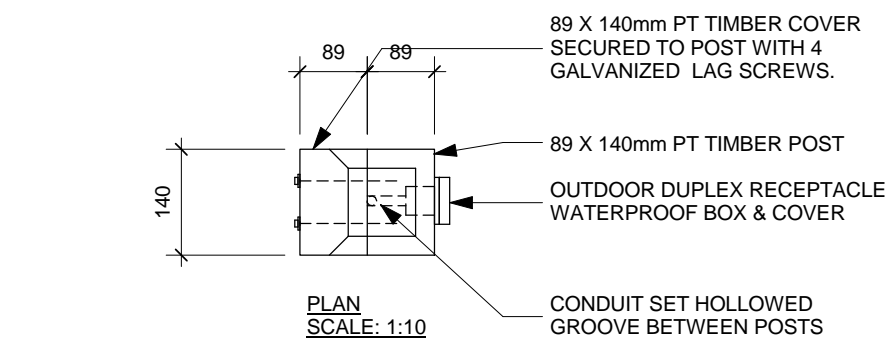


4 RAMP SECTION A
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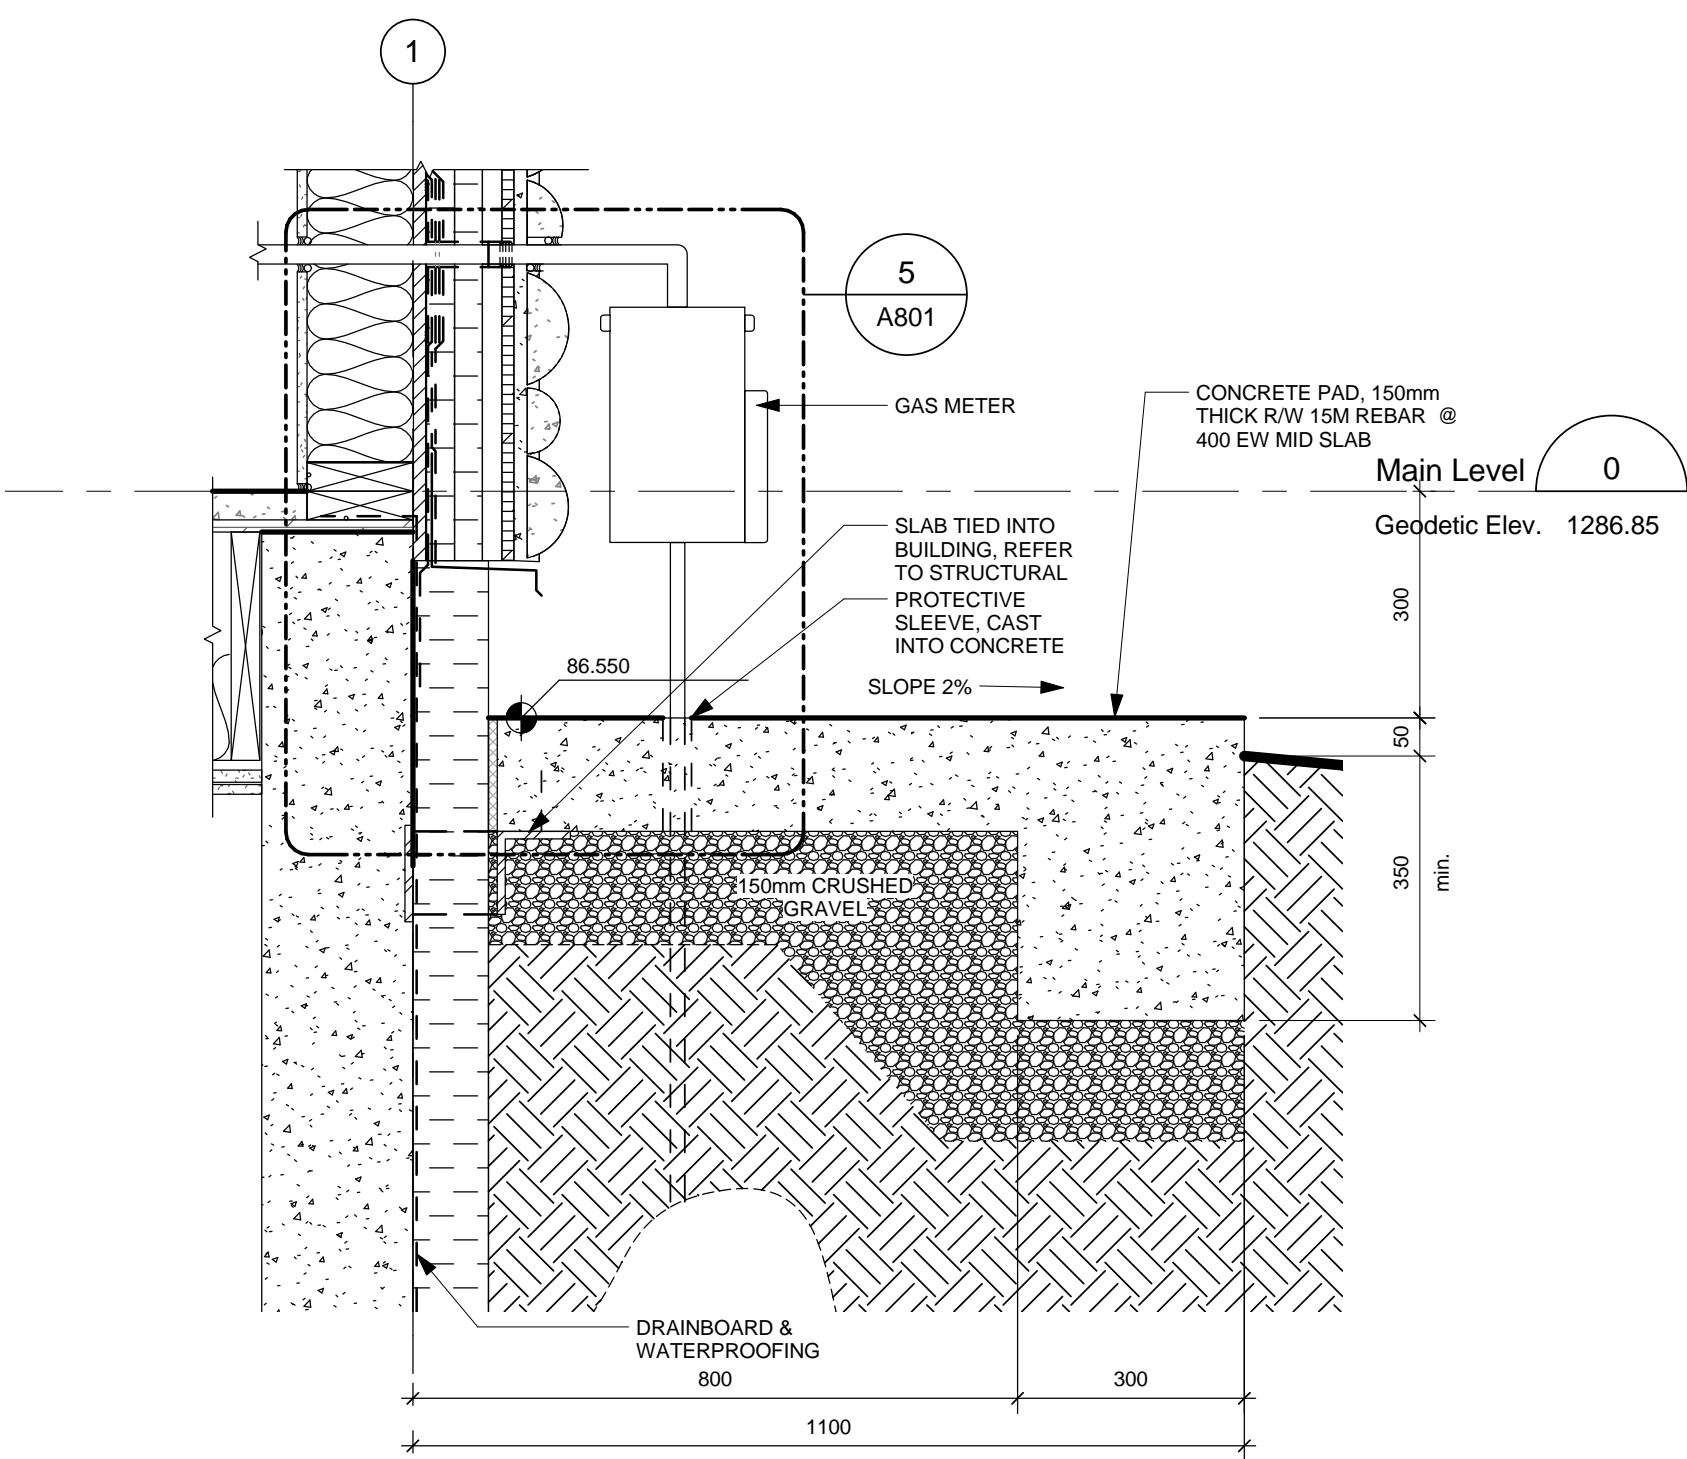
5 RAMP SECTION B
Scale: 1 : 20

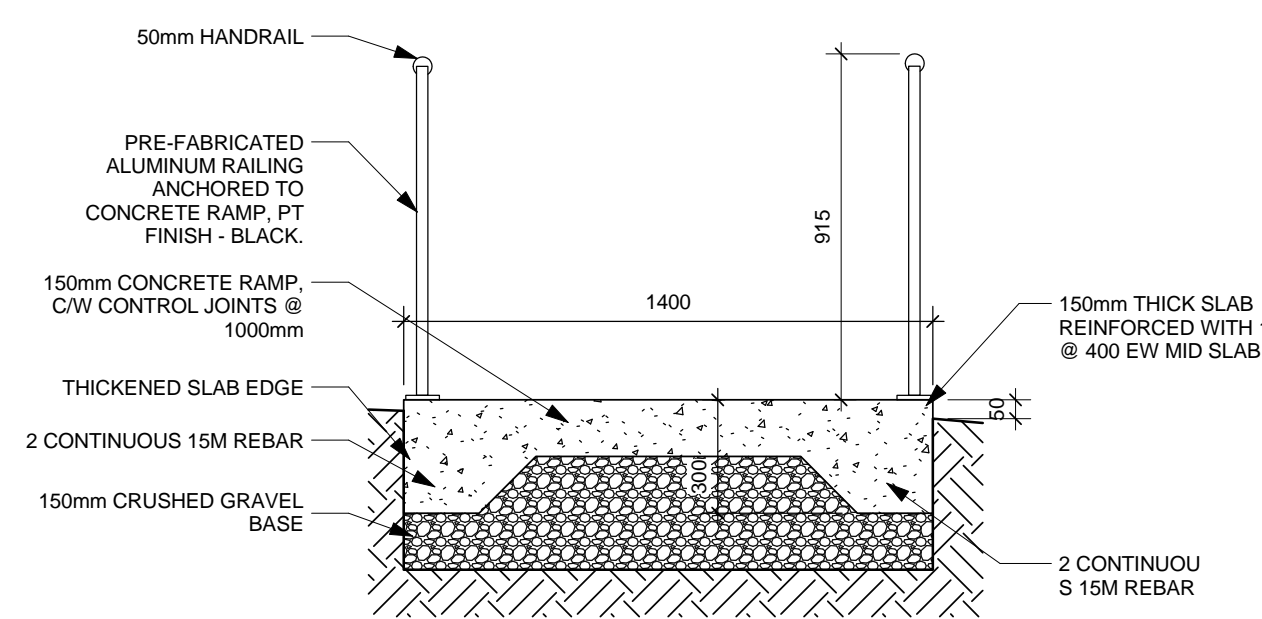

9 BIRD SPIKE DETAIL
Scale: 1 : 5

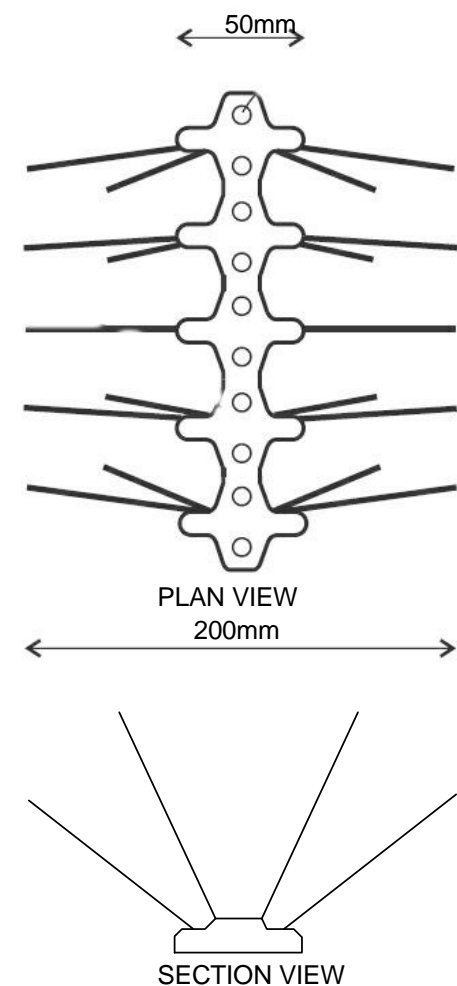

8 FRONT ENTRY COLUMN DETAIL
Scale: 1 : 5

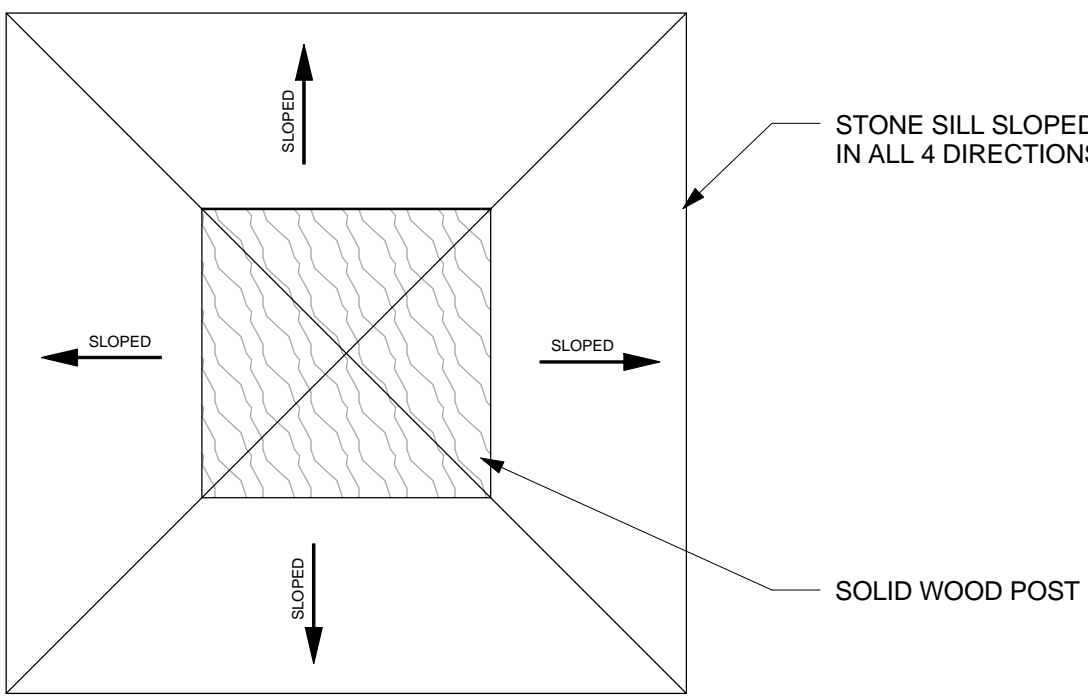

2 GAS METER SLAB SECTION DETAIL
Scale: 1 : 10

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1	2016-05-06	DEVELOPMENT PERMIT REVIEW		

Revision / Revision	
A	detail number numero de detail
B	source drawing no. de dessin no.
C	detail on drawing no. detail sur dessin no.
Consultant's Name Nom de l'expert-consult	
Eng. Stamp Sceau de l'ingénieur	


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Le Client Entretien l'Équipe Alberta Méridional Branche d'Opérations

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Western and Northern Region
Ouest et Nord du Canada

Project title/Titre du projet
Staff Housing Phase 2
Waterton Lakes National Park

Drawing title/Titre du dessin		
SITE, CANOPY & RAMP DETAILS		
Surveyed by/Arpenté par	Drawn by/Dessiné par	Date/Date
	AG	2016-12-08
Designed by/Concept par	Reviewed by/Revisé par	Scale/Echelle
LS/FVR	LS/FVR	As indicated
PWGSC Project Manager/Administrateur de Projets IPSCG		
Randy Boldt		
Client Acceptance/Acceptation du client	Approved by/Approuvé par	
Task Responsible/Officer/Agent Responsable		
PWGSC Project Manager/Administrateur de Projets IPSCG		
Project No./No. du projet	Asset No./No. du bien	Sheet No./No. de la feuille
39000	FI# 945	A121
Drawing Reference No./No. de référence du dessin		

Drawing Reference No./No. de référence du dessin: **A122**

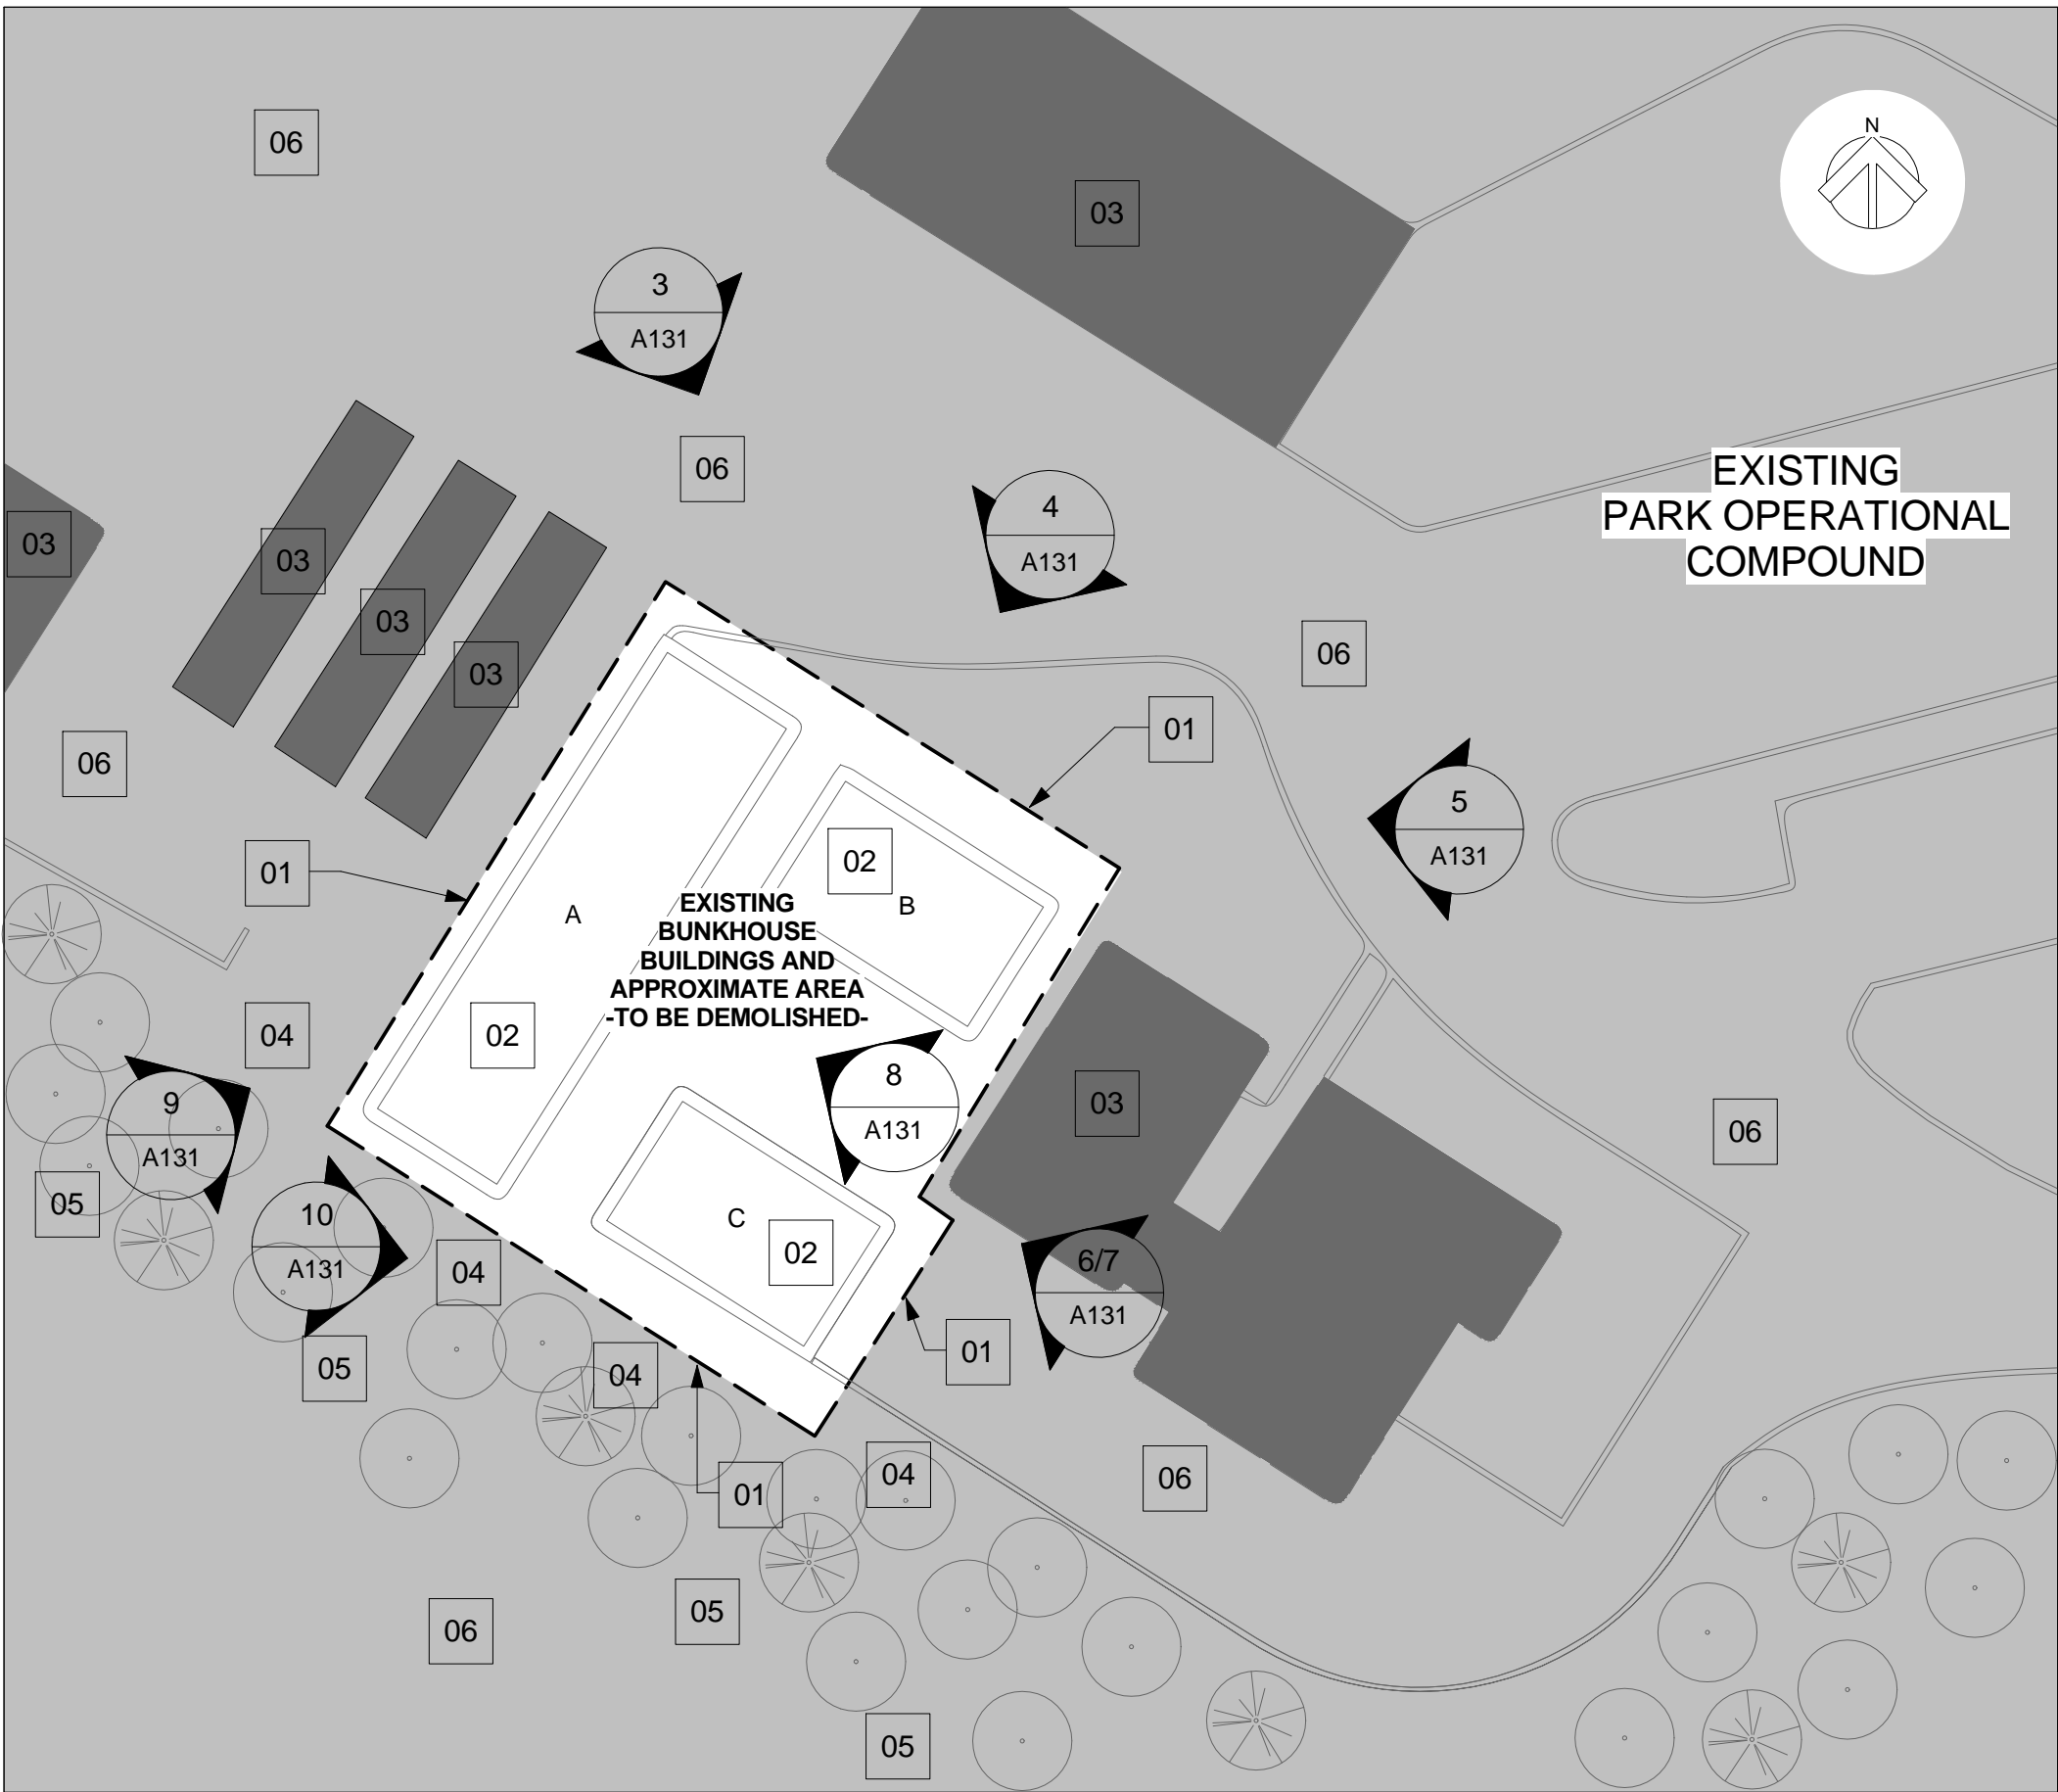


DEMOLITION KEY NOTES

- 01 - APPROXIMATE AREA OF DEMOLITION WORK
- PROVIDE PROTECTIVE BARRIER AROUND DEMOLITION AREA
- 02 - EXISTING BUNKHOUSE BUILDINGS TO BE REMOVED
- INCLUDING ALL FOUNDATIONS AND ATTACHED PATIO/STAIR STRUCTURES
- 03 - ADJACENT EXISTING BUILDING
- TO REMAIN AND TO BE PROTECTED FROM DEMOLITION WORK
- 04 - EXISTING TREES
- PROVIDE PROTECTIVE BARRIER FOR PROTECTION FROM DEMOLITION WORK
- 05 - EXISTING POWER POLES
- PROVIDE PROTECTIVE BARRIER FROM DEMOLITION WORK AS REQUIRED. PROVIDE AWARENESS SIGNAGE FOR POWER LINES ABOVE UNTIL ALL WORK IS COMPLETE IN THE SURROUNDING AREA
- 06 - EXISTING SITE FEATURES AND LANDSCAPE AREAS ARE APPROXIMATE
- TO BE CONFIRMED ON SITE

1 BUNKHOUSE DEMOLITION SITE PLAN

A131 Scale: 1 : 400

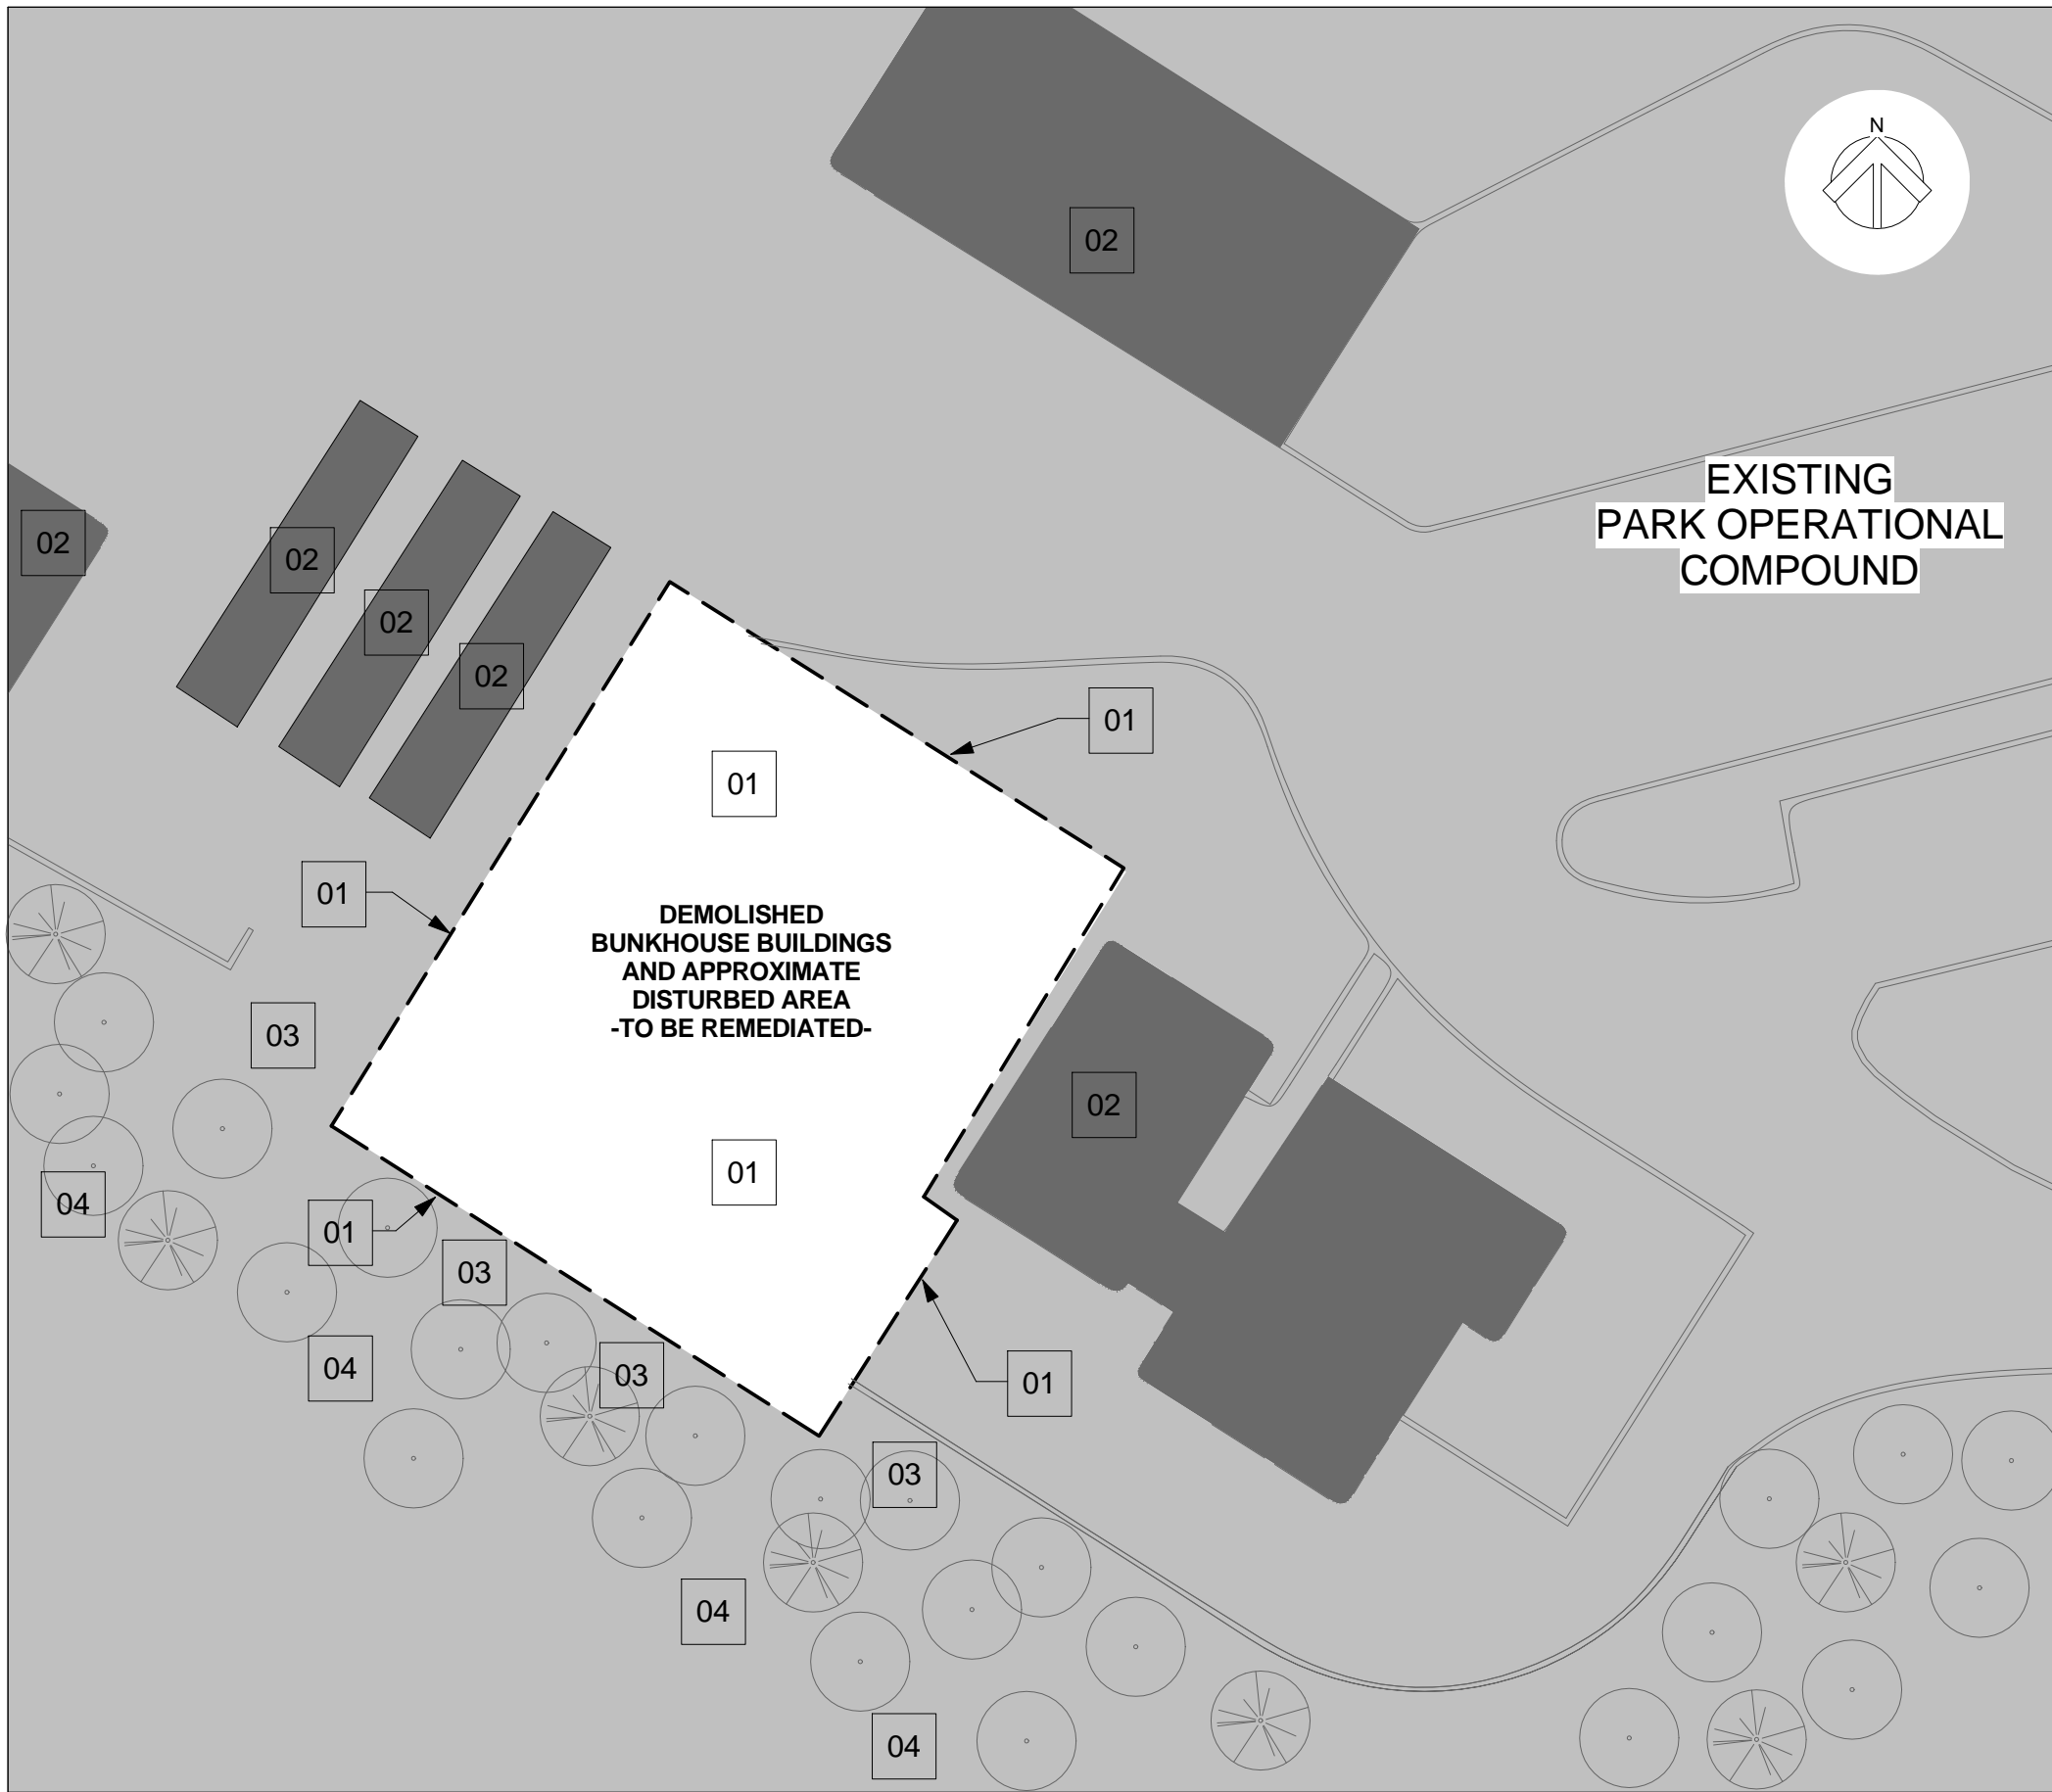

REMEDICATION KEY NOTES

- 01 - APPROXIMATE AREA OF DISTURBED GROUND
- FILL DISTURBED AREA WITH CLEAN FILL AND FINISH AREA WITH GRAVEL. MATCH SURROUNDING UNDISTURBED GRADES AND FINISHES.
- 02 - ADJACENT EXISTING BUILDING
- TO BE EXAMINED FOR ANY DAMAGES DONE FROM DEMOLITION AND REMEDIATION WORK. CONTRACTOR TO BE RESPONSIBLE TO PATCH AND MAKE GOOD AT NO ADDITIONAL COST TO CANADA PARKS AGENCY.
- 03 - EXISTING TREES
- 04 - EXISTING POWER POLES

2 BUNKHOUSE REMEDIATION SITE PLAN

A131 Scale: 1 : 400



LOCATION MAP



SITE PLAN LEGEND

- AREA OF DEMOLITION
- EXISTING BUILDINGS
- LOCATION OF TAKEN PICTURE
- EXISTING TREES (NOT ALTERED)

DEMOLITION INFORMATION

DEMOLITION SITE LOCATION
MUNICIPAL ADDRESS: 1 COMPOUND ROAD, WATERTON, WATERTON LAKES NATIONAL PARK, AB
ZONING: N/A

APPROXIMATE EXISTING AREAS:
APPROXIMATE EXISTING BUNKHOUSE SITE AREA - TO BE SITE VERIFIED 1038.26m² 11176 sq. ft.

EXISTING BUILDINGS TO BE DEMOLISHED AREAS - REFER TO SHEET A132 FOR REFERENCE - TO BE SITE VERIFIED


DEMOLITION GENERAL NOTES

- ENSURE ALL WORK IS PERFORMED IN COMPLIANCE WITH ALL APPLICABLE PROVINCIAL REGULATIONS. REFER TO SPECIFICATIONS FOR HAZARDOUS MATERIALS INFORMATION.
- NOTIFY AND OBTAIN APPROVAL OF UTILITY COMPANIES BEFORE STARTING DEMOLITION.
- INSPECT SITE WITH DEPARTMENT REPRESENTATIVE AND VERIFY EXTENT AND LOCATION OF ITEMS DESIGNATED FOR REMOVAL, DISPOSAL, ALTERNATIVE DISPOSAL, RECYCLING, SALVAGE AND ITEMS TO REMAIN.
- DO NOT INTERFERE WITH USE OF ADJACENT EXISTING BUILDINGS TO REMAIN IN USE. MAINTAIN FREE AND SAFE PASSAGE TO AND FROM OCCUPIED BUILDINGS.
- CARRY OUT DEMOLITION IN AN ORDERLY AND CAREFUL MANNER USING TRADESMEN QUALIFIED TO PERFORM DEMOLITION AND REMOVAL WORK.
- COMPLETELY DEMOLISH THE ITEMS INDICATED AND AS REQUIRED TO ACCOMMODATE NEW WORK, AND REMOVE ALL RESULTING MATERIALS FROM THE PREMISES. EXCEPT AS NOTED OTHERWISE.
- SELLING OR BURNING MATERIALS ON SITE IS NOT PERMITTED.
- WHERE UNEXPECTED CONDITIONS AND/OR HAZARDOUS MATERIAL ARE ENCOUNTERED DURING DEMOLITION, STOP WORK IN THE AREA IMMEDIATELY AND CONSULT THE DEPARTMENT REPRESENTATIVE AND FOLLOW ALL INSTRUCTIONS.
- REMOVE ALL PIPING, ELECTRICAL WIRING AND FOUNDATIONS. COMPLETELY REMOVE EXISTING BUILDING AS INDICATED.
- UTILITIES TO BE CAPPED TWO METERS AWAY FROM BUILDINGS DEMOLISHED AT PARKS OPERATIONAL COMPOUND SITE AND UTILITIES TO BE CAPPED AT PROPERTY LINE AT IN TOWN SITE (102 & 104 WINDFLOWER AVE) - LOTS 20 & 21 BLOCK 42 PLAN 5854DK.
- DEMOLISH FOUNDATION WALLS AND FOOTINGS, AND CONCRETE FLOORS BELOW OR ON GRADE TO MAKE WAY FOR NEW CONSTRUCTION.
- DO NOT USE PIECES OF CONCRETE OR MASONRY AS BACKFILL.

PHOTOGRAPHS OF BUILDINGS TO BE DEMOLISHED




3 NORTH-WEST ELEVATION OF EXISTING BUILDINGS TO BE DEMOLISHED
A131

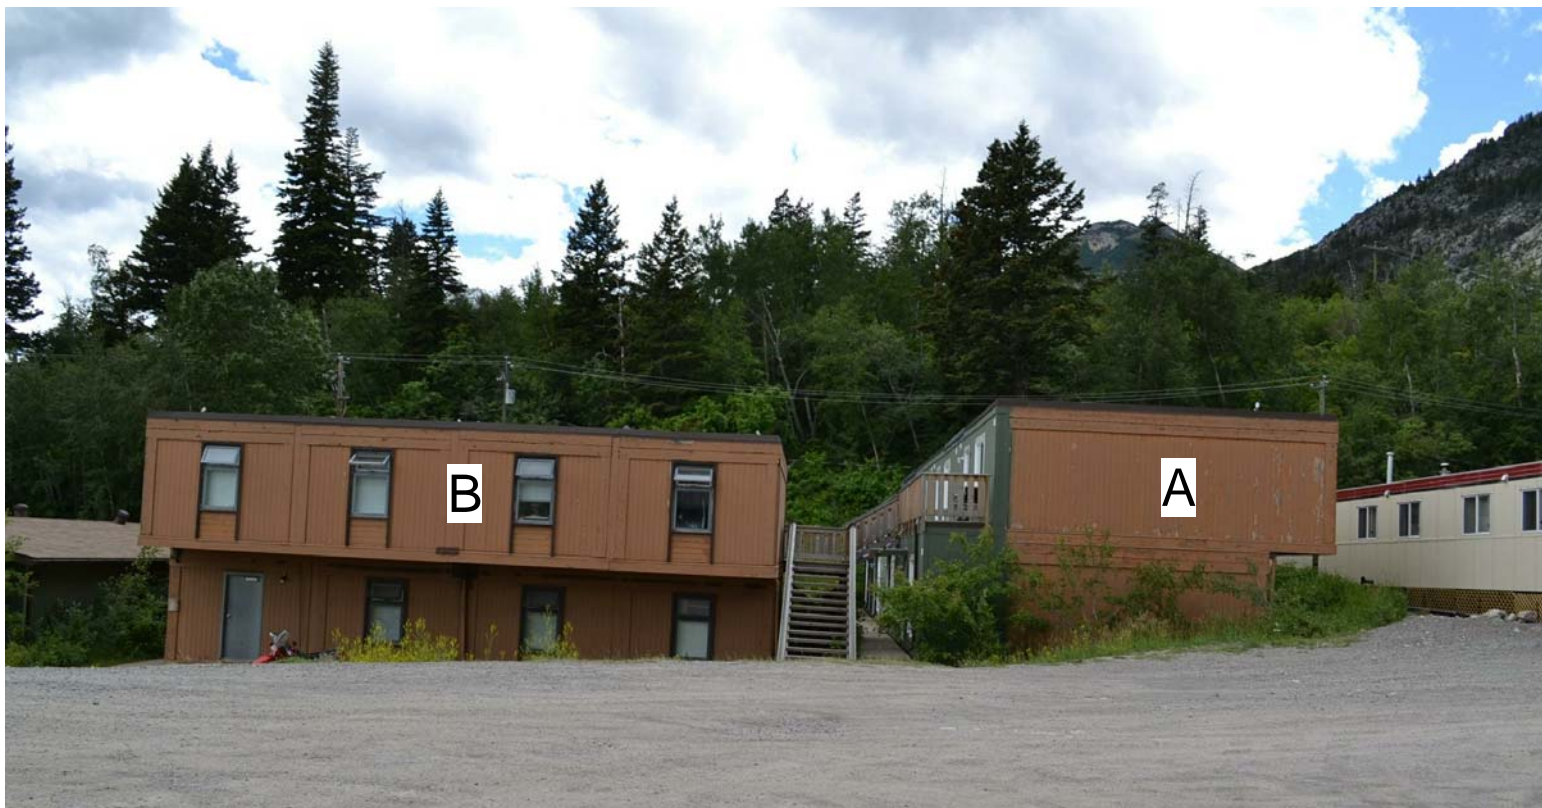


4 NORTH ELEVATION OF EXISTING BUILDINGS TO BE DEMOLISHED
A131




5 COURTYARD SOUTH-EAST ELEVATION OF EXISTING BUILDINGS TO BE DEMOLISHED
A131

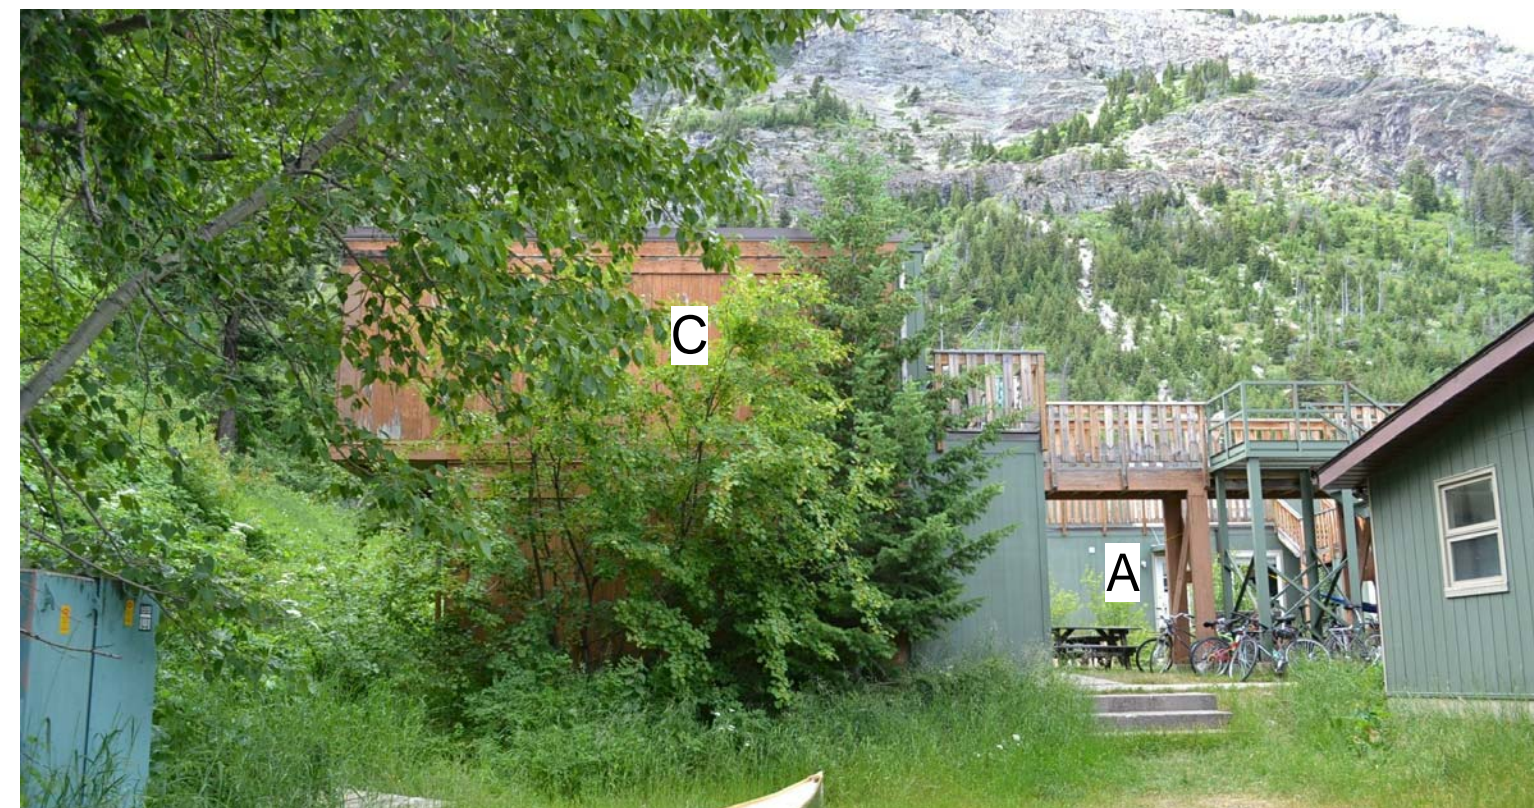

6 COURTYARD SOUTH-EAST ELEVATION OF EXISTING BUILDINGS TO BE DEMOLISHED
A131

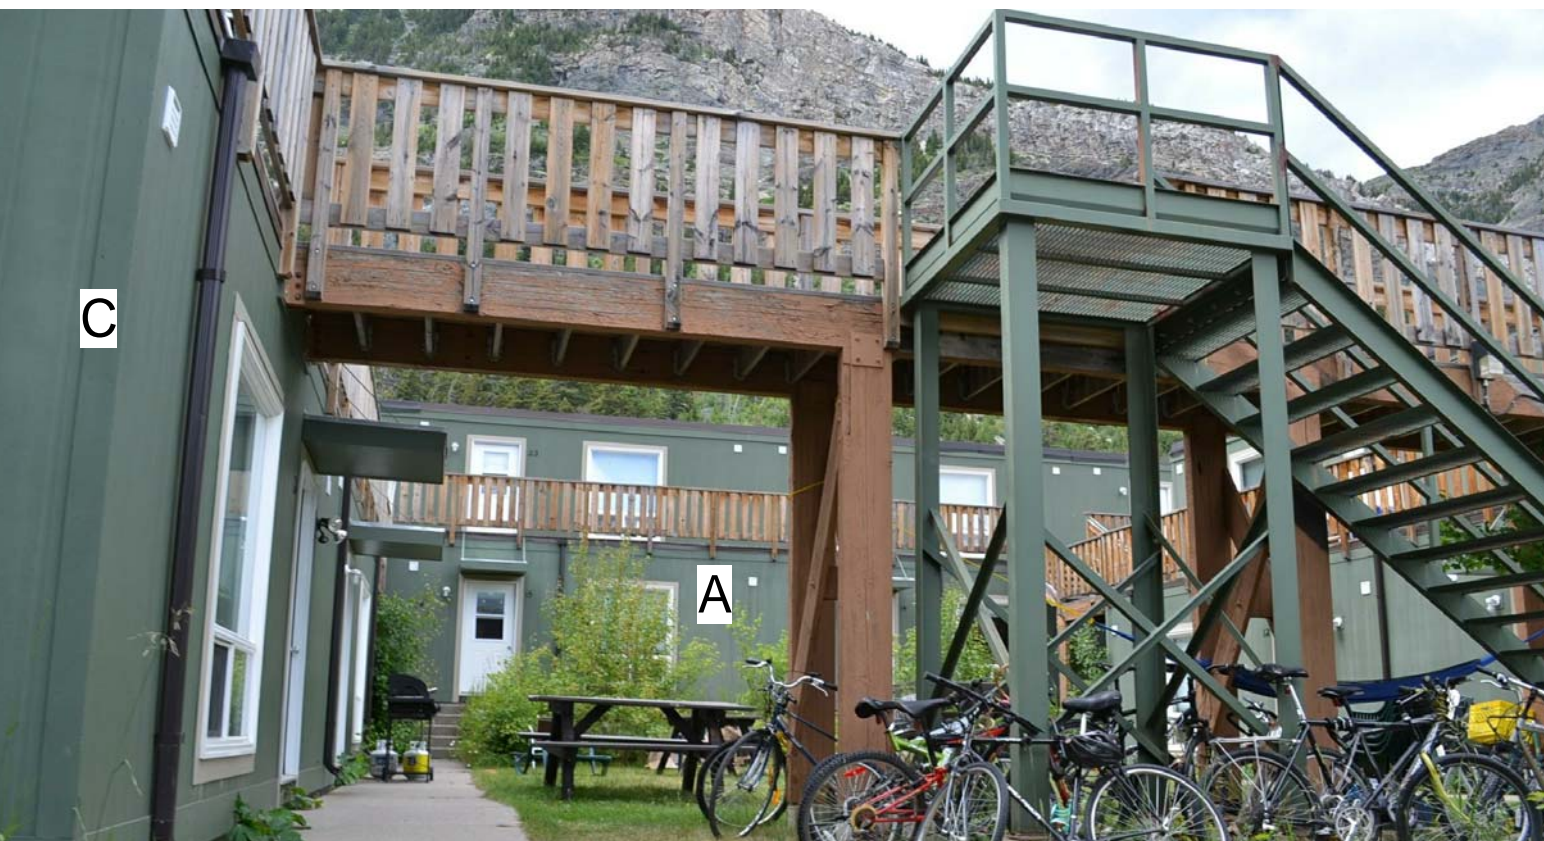

7 COURTYARD SOUTH-EAST ELEVATION OF EXISTING BUILDINGS TO BE DEMOLISHED
A131

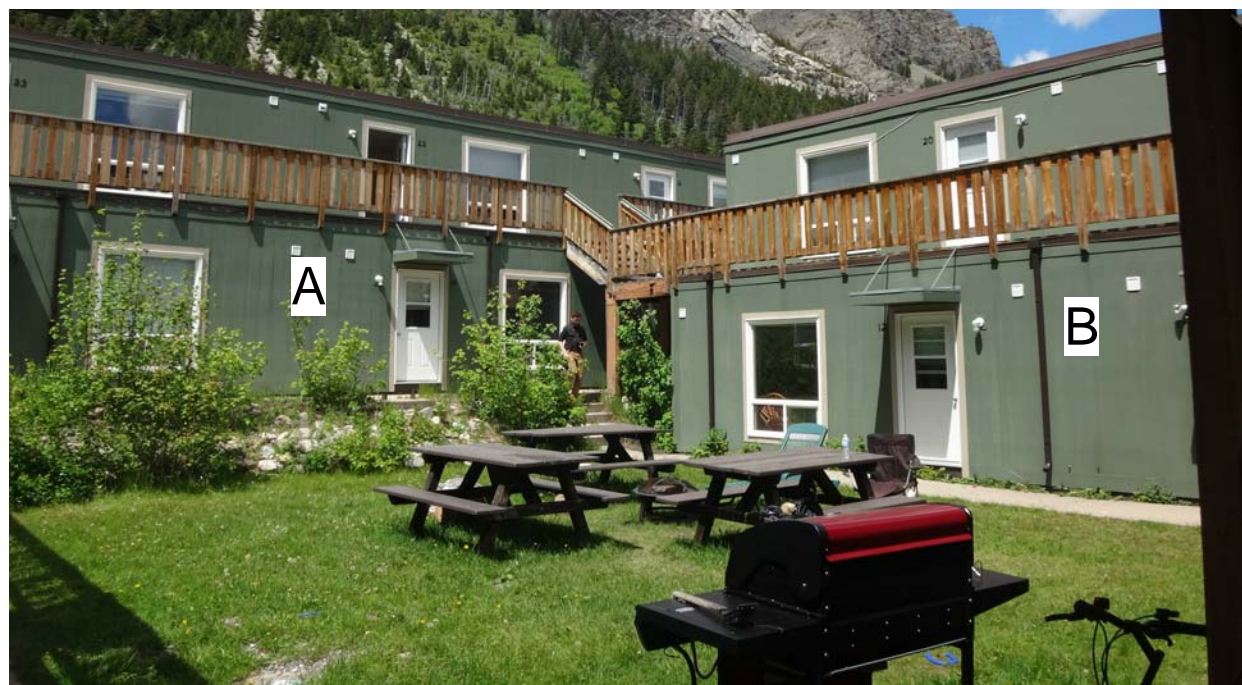

8 COURTYARD SOUTH-EAST ELEVATION OF EXISTING BUILDINGS TO BE DEMOLISHED
A131



9 COURTYARD SOUTH-EAST ELEVATION OF EXISTING BUILDINGS TO BE DEMOLISHED
A131



10 COURTYARD SOUTH-EAST ELEVATION OF EXISTING BUILDINGS TO BE DEMOLISHED
A131

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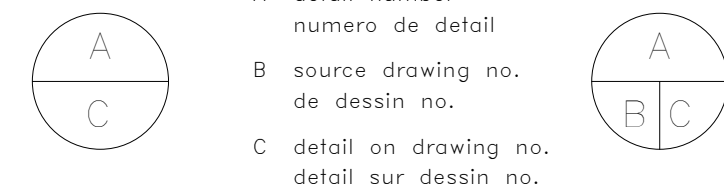
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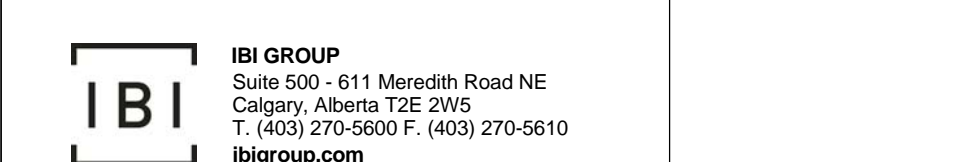
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1	2016-09-02	ISSUED FOR 99% REVIEW		

No.	Date/Date	Description/Description	Drawn by Dessiné par	Approved Approuvé
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Revision / Revision



Consultant's Name
Nom de l'expert-conseil



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Client Services Team Southern Alberta Operations Branch
Le Client Entretien d'Équipe Alberta Méridionale Branche d'Opérations

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Client/client
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L'Agence Parcs Canada

Western and Northern Region
Ouest et Nord du Canada

Project title/Titre du projet

Staff Housing Phase 2 Waterton Lakes National Park

Drawing title/Titre du dessin

BUNKHOUSE DEMOLITION AND REMEDIATION SITE PLAN

Surveyed by/Arpenté par LS/FVR	Drawn by/Dessiné par MP	Date/Date 2016-12-08
Designed by/Concept par LS/FVR	Reviewed by/Revisé par LS/FVR	Scale/Echelle As indicated

PWGSC Project Manager/Administrateur de Projets TPSCG

Client Acceptance/Acceptation du client

Approved by/Approuvé par

Project No./No. du projet
39000


Asset No./No. du bien
Fil # 945

Sheet No./No. de la feuille
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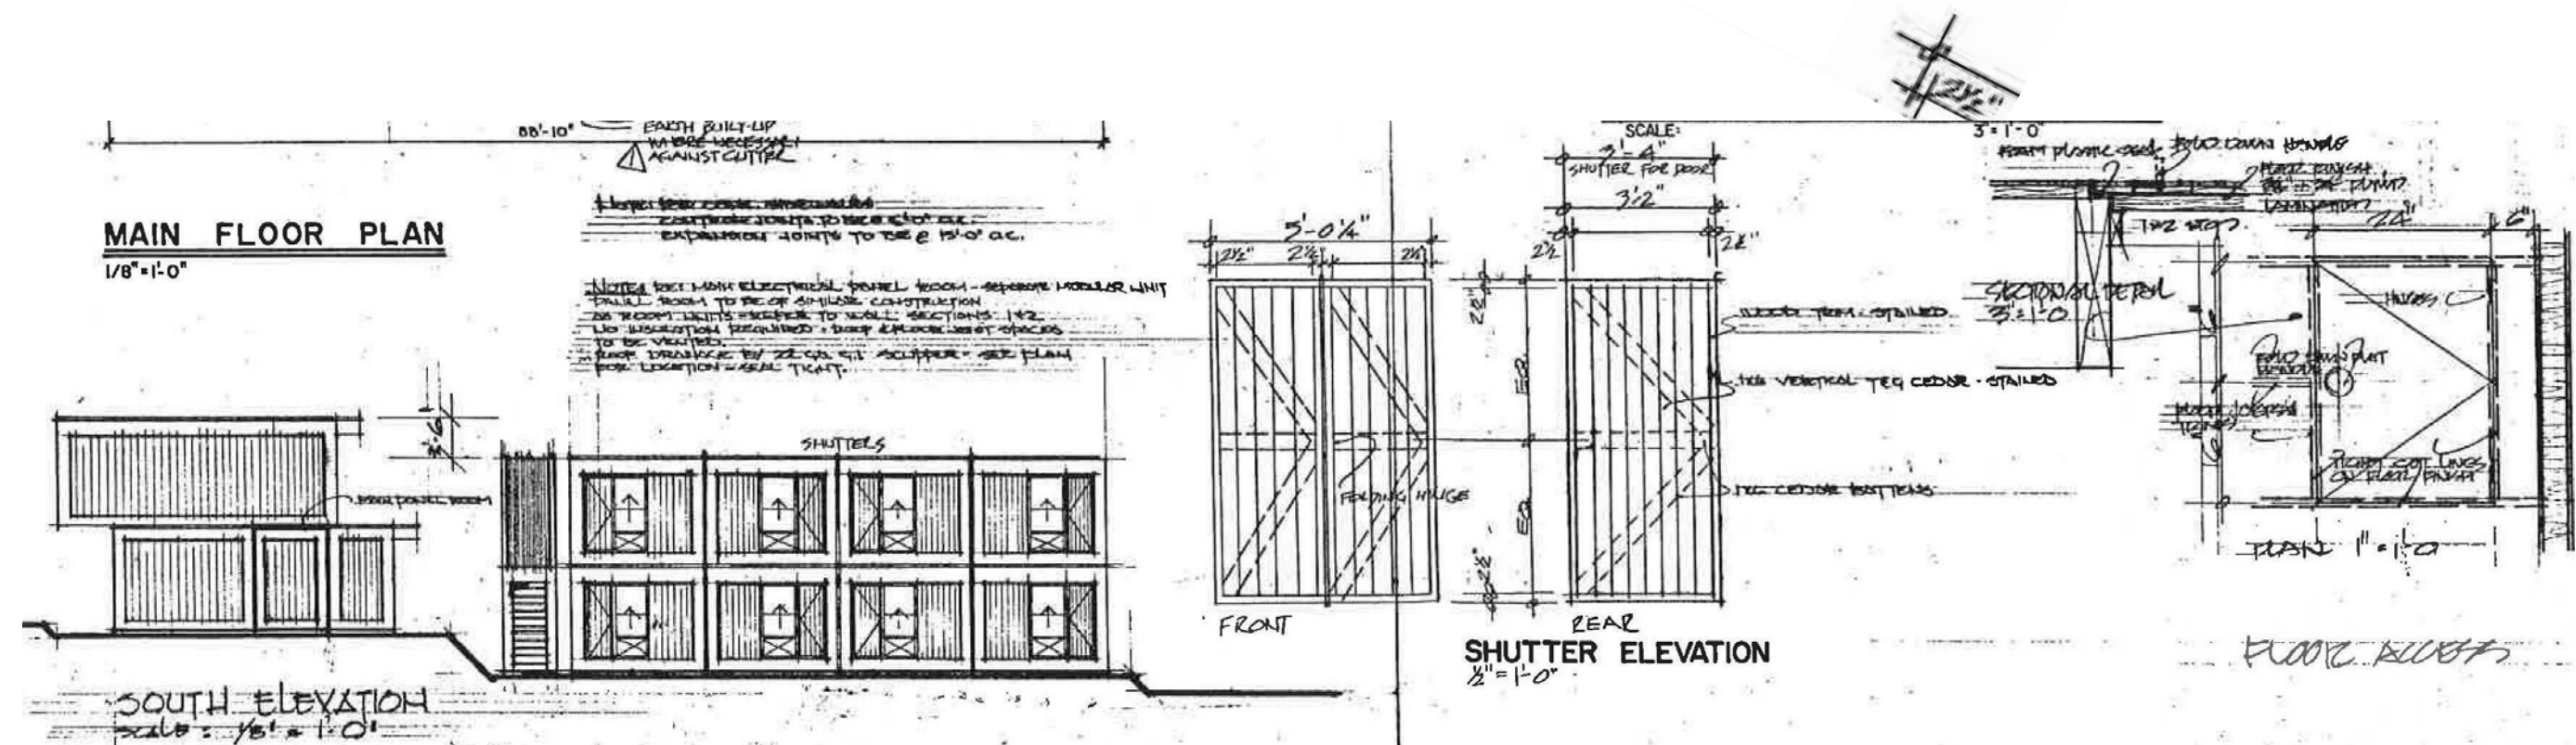
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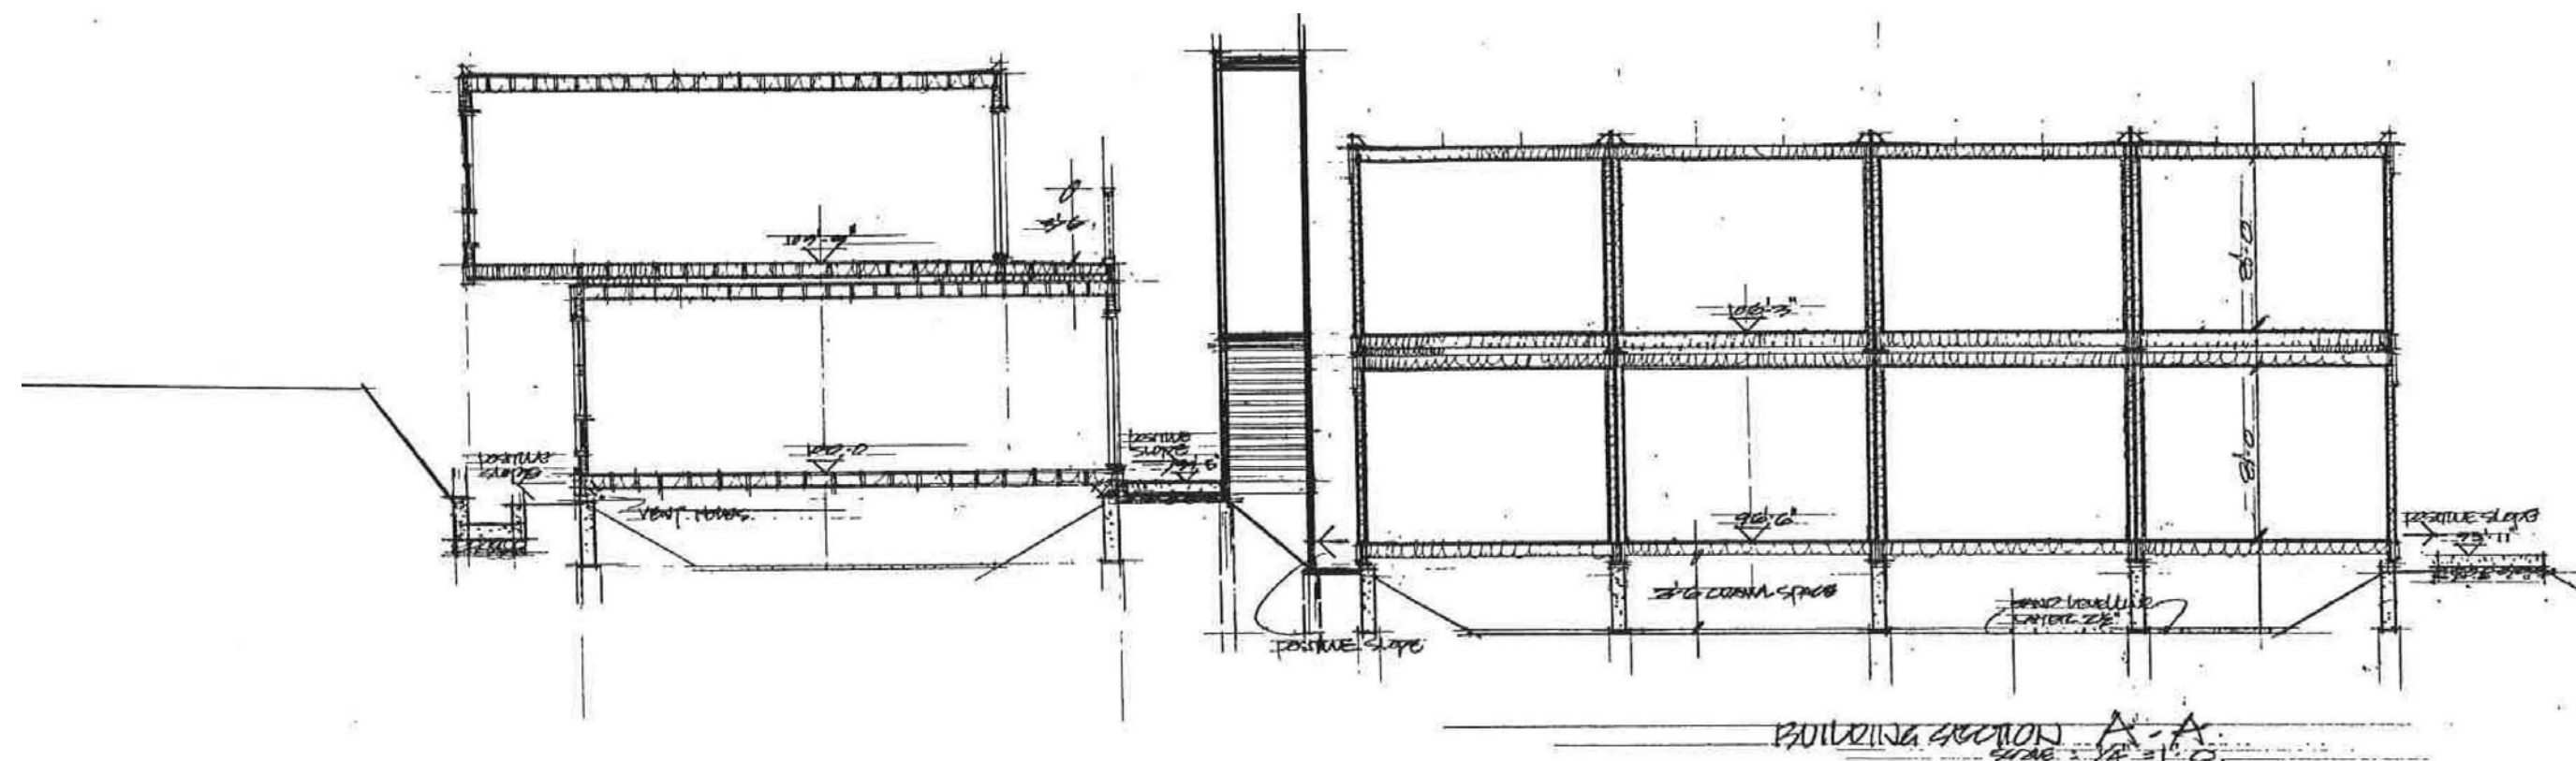
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FOR REFERENCE ONLY - MAY NOT BE EXACTLY AS SHOWN



LOCATION MAP N↑ N.T.S.

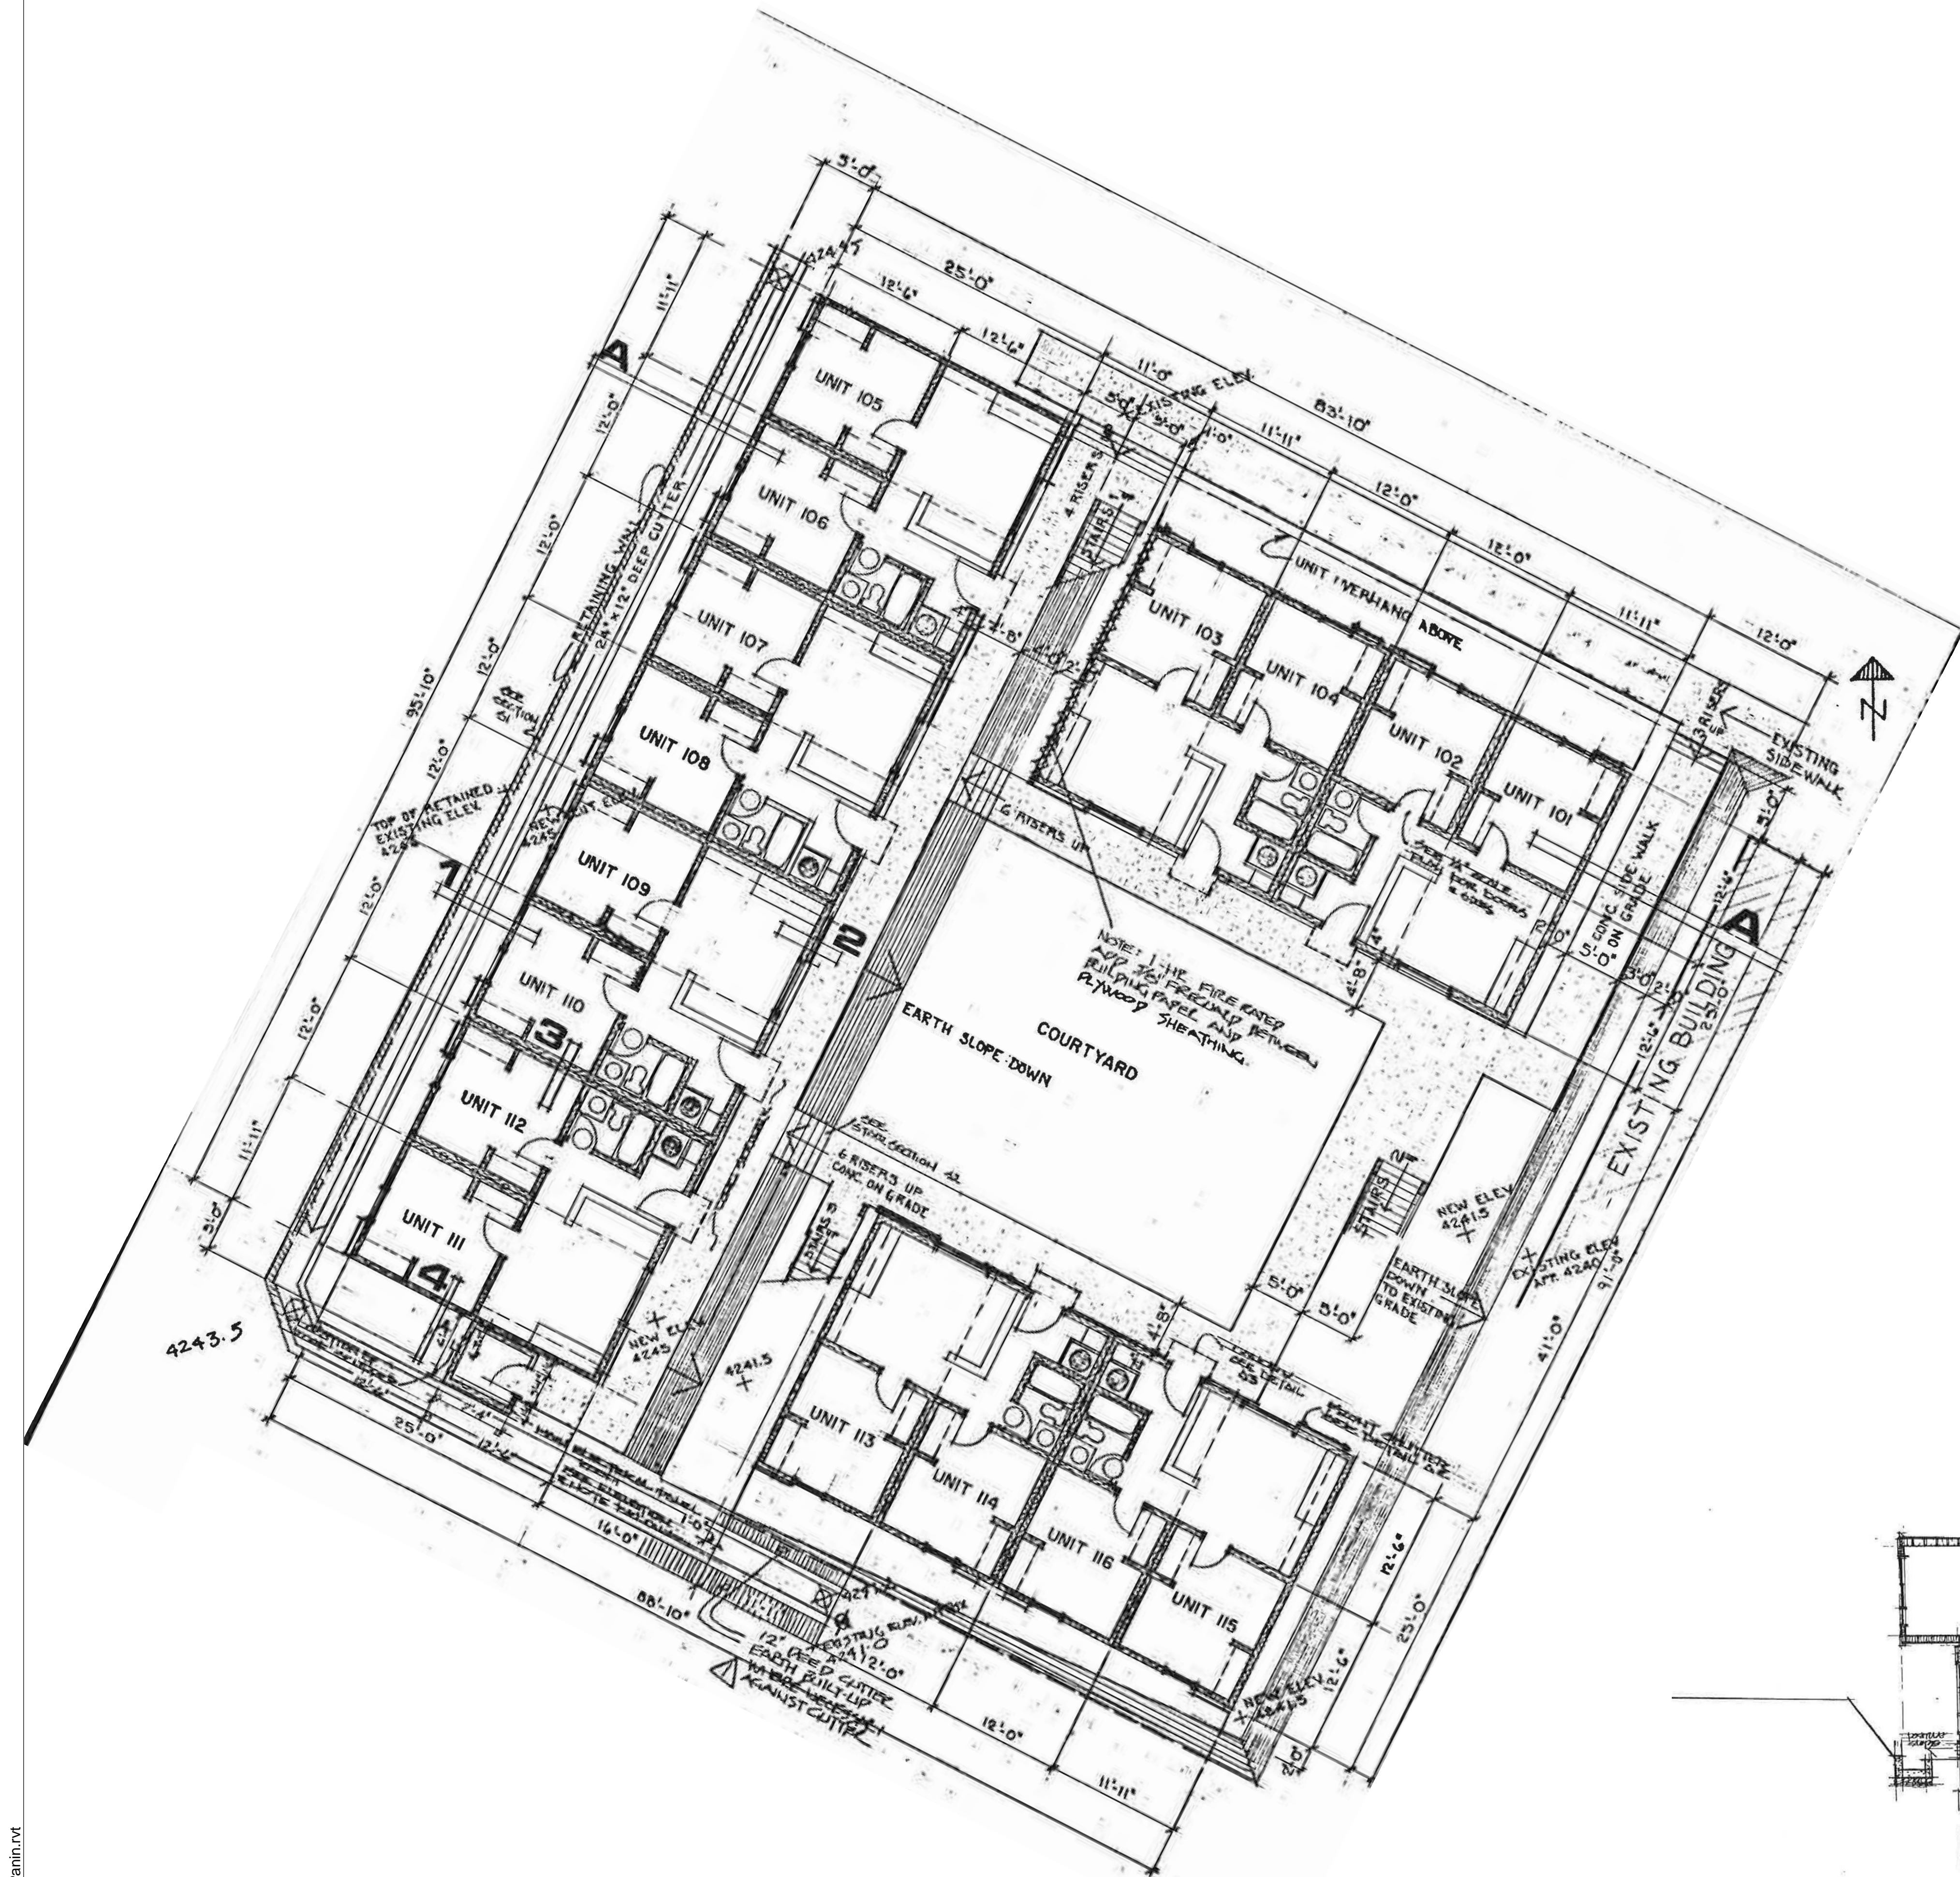

FOR REFERENCE ONLY - MAY NOT BE EXACTLY AS SHOWN



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5	2016-12-08	ISSUED FOR BUILDING PERMIT		
4	2016-08-02	ISSUED FOR 99% REVIEW		
3	2016-06-14	ISSUED FOR 86% REVIEW		
2	2016-05-09	ISSUED FOR 33% REVIEW		
1	2016-05-06	DEVELOPMENT PERMIT REVIEW		

Revision / Revision

A

C

A

B

C

A detail number
numéro de détail
B source drawing no.
de dessin no.
C detail on drawing no.
détail sur dessin no.

Consultant's Name
Nom de l'expert-consult

Eng. Stamp
Sceau de l'ingénieur

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du Canada

Project title/Titre du projet

Staff Housing Phase 2
Waterton Lakes National
Park

Drawing title/Titre du dessin

BUNKHOUSE DEMOLITION

Surveyed by/Arpenté par

Designed by/Concept par

LS/FVR

Drawn by/Dessiné par

MP

Reviewed by/Revisé par

LS/FVR

Date/Date

2016-12-08

Scale/Echelle

N.T.S.

PWGSC Project Manager/Administrateur de Projets TPSGC

Randy Boldt

Client Acceptance/Acceptation du client

Approved by/Approuvé par

Project No./No. du projet

39000


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Fil # 945

Sheet No./No. de la feuille

A132

Drawing Reference No./No. de référence du dessin

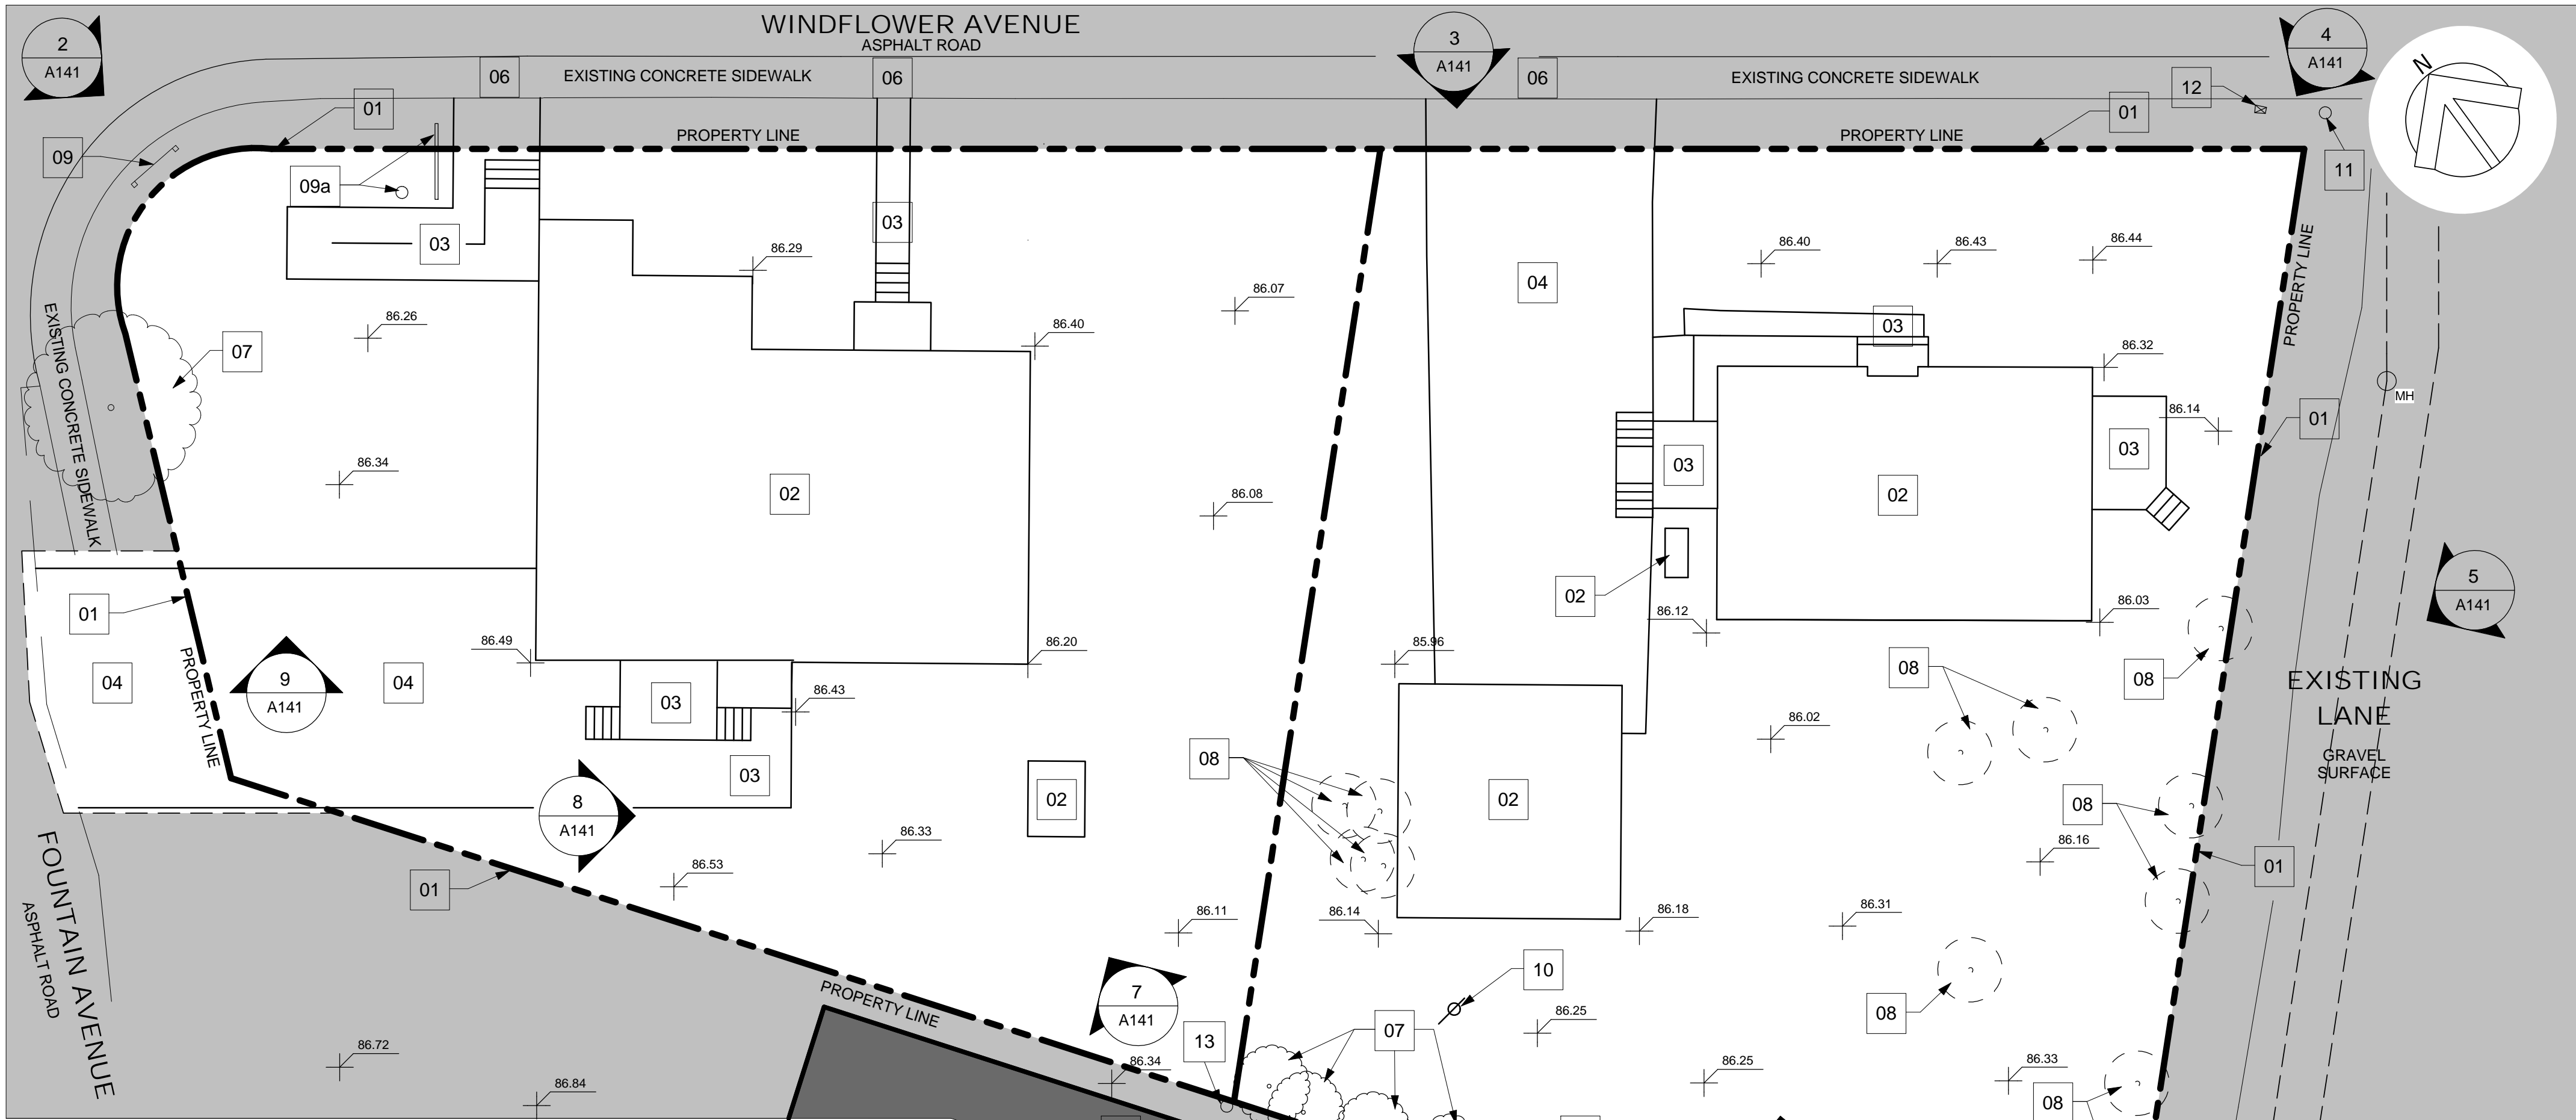

- DEMOLITION KEY NOTES**

 - 01 - APPROXIMATE AREA OF DEMOLITION WORK
- PROVIDE PROTECTIVE BARRIER AT PROPERTY LINE/AROUND DEMOLITION AREA
 - 02 - EXISTING STRUCTURE TO BE REMOVED
- CONTRACTOR TO REMOVE ALL ABOVE GRADE STRUCTURE AND BELOW GRADE FOUNDATIONS
 - 03 - EXISTING DECK/PATIO/STAIR/RAMP/WALK
- TO BE REMOVED INCLUDING ALL FOUNDATIONS
 - 04 - EXISTING DRIVEWAY
- TO BE REMOVED
 - 05 - ADJACENT EXISTING BUILDINGS
- TO REMAIN AND TO BE PROTECTED FROM DEMOLITION WORK
- TO BE EXAMINED FOR ANY DAMAGES DONE FROM DEMOLITION. CONTRACTOR TO BE RESPONSIBLE TO PATCH AND MAKE GOOD AT NO ADDITIONAL COST TO CANADA PARKS AGENCY
 - 06 - ADJACENT EXISTING SIDEWALK
- TO REMAIN AND BE PROTECTED
- TO BE PATCHED AND MADE GOOD AS REQUIRED
 - 07 - EXISTING TREES
- TO REMAIN. PROVIDE PROTECTIVE BARRIER FOR PROTECTION FROM DEMOLITION WORK
- PROVIDE TREE ROOT PROTECTION AS PER LANDSCAPING PLANS
 - 08 - EXISTING TREES CUT DOWN BY OTHERS. SITE VERIFY.
- CONTRACTOR TO REMOVE REMAINING STUMPS AND ROOTS AS REQUIRED
 - 09 - EXISTING PCA SIGNAGE
- TO REMAIN. PROVIDE PROTECTIVE BARRIER FOR PROTECTION FROM DEMOLITION WORK
 - 09a - EXISTING SIGNAGE AND FLAGPOLE TO BE REMOVED AND TURNED OVER TO DEPARTMENTAL REPRESENTATIVE.
- CONTRACTOR TO REMOVE ALL FOUNDATIONS.
 - 10 - EXISTING EXPOSED CAPPED PVC LINE
- TO BE REMOVED
 - 11 - EXISTING POWER POLES
- PROVIDE PROTECTIVE BARRIER FROM DEMOLITION WORK AS REQUIRED. PROVIDE AWARENESS SIGNAGE FOR POWER LINES ABOVE UNTIL ALL WORK IS COMPLETE IN THE SURROUNDING AREA
 - 12 - EXISTING UTILITY BOX
- TO REMAIN. PROVIDE PROTECTIVE BARRIER FOR PROTECTION FROM DEMOLITION WORK
 - 13 - EXISTING POWER POLE TO BE REMOVED
- REMOVE ANY SECONDARY POWER SUPPLIES AND LINES. CONTRACTOR TO COORDINATE WITH APPROPRIATE UTILITIES PROVIDER WHERE NECESSARY.

1 DEMOLITION SITE PLAN - LOTS 20 & 21
A141 Scale: 1 : 150

PHOTOGRAPHS OF BUILDINGS TO BE DEMOLISHED



2 NORTH-WEST ELEVATION OF EXISTING BUILDINGS TO BE DEMOLISHED
A141



3 NORTH ELEVATION OF EXISTING BUILDINGS TO BE DEMOLISHED
A141



4 NORTH-EAST ELEVATION OF EXISTING BUILDINGS TO BE DEMOLISHED
A141




5 EAST ELEVATION OF EXISTING BUILDINGS TO BE DEMOLISHED
A141



6 SOUTH-EAST ELEVATION OF EXISTING BUILDINGS TO BE DEMOLISHED
A141



7 SOUTH ELEVATION OF EXISTING BUILDINGS TO BE DEMOLISHED
A141

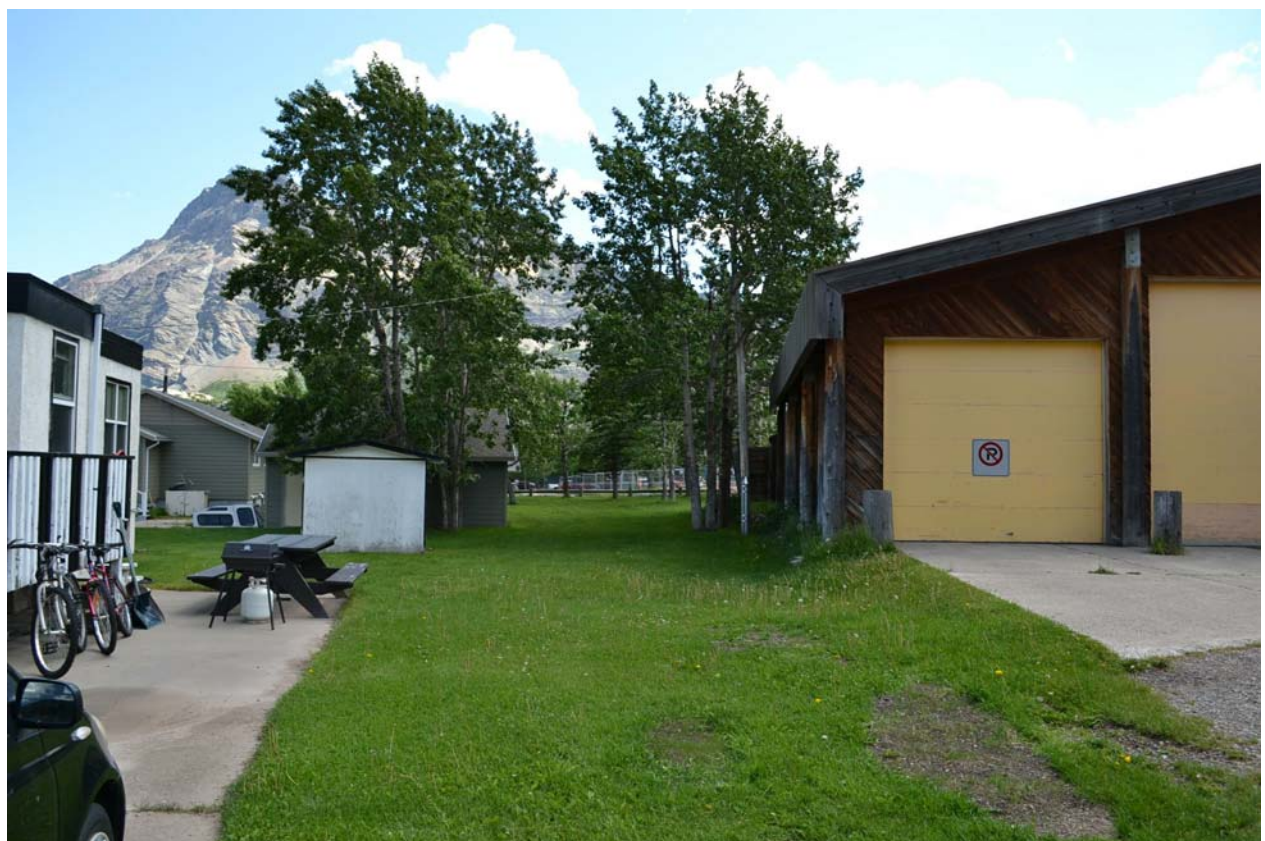

8 SOUTH ELEVATION OF EXISTING BUILDINGS TO BE DEMOLISHED
A141



9 SOUTH-WEST ELEVATION OF EXISTING BUILDINGS TO BE DEMOLISHED
A141



LOCATION MAP N ↑ N.T.S.

- SITE PLAN LEGEND**
- AREA OF DEMOLITION
 - EXISTING BUILDINGS
 - LOCATION OF TAKEN PICTURE
 - EXISTING TREES (NOT ALTERED)

DEMOLITION INFORMATION

DEMOLITION SITE LOCATION
MUNICIPAL ADDRESS: 102 & 104 WINDFLOWER AVE, WATERTON, WATERTON LAKES NATIONAL PARK
LEGAL ADDRESS: LOTS 20 & 21 BLOCK 42 PLAN 5854DK
ZONING: INSTITUTIONAL

EXISTING AREAS:
SITE AREA 2082.842m² 22419.5 ft²

EXISTING BUILDINGS TO BE DEMOLISHED AREAS - TO BE SITE VERIFIED

- DEMOLITION GENERAL NOTES**
- ENSURE ALL WORK IS PERFORMED IN COMPLIANCE WITH ALL APPLICABLE PROVINCIAL REGULATIONS. REFER TO SPECIFICATIONS FOR HAZARDOUS MATERIALS INFORMATION.
 - NOTIFY AND OBTAIN APPROVAL OF UTILITY COMPANIES BEFORE STARTING DEMOLITION.
 - INSPECT SITE WITH DEPARTMENT REPRESENTATIVE AND VERIFY EXTENT AND LOCATION OF ITEMS DESIGNATED FOR REMOVAL, DISPOSAL, ALTERNATIVE DISPOSAL, RECYCLING, SALVAGE AND ITEMS TO REMAIN.
 - DO NOT INTERFERE WITH USE OF ADJACENT EXISTING BUILDINGS TO REMAIN IN USE. MAINTAIN FREE AND SAFE PASSAGE TO AND FROM OCCUPIED BUILDINGS.
 - CARRY OUT DEMOLITION IN AN ORDERLY AND CAREFUL MANNER USING TRADESMEN QUALIFIED TO PERFORM DEMOLITION AND REMOVAL WORK.
 - COMPLETELY DEMOLISH THE ITEMS INDICATED AND AS REQUIRED TO ACCOMMODATE NEW WORK, AND REMOVE ALL RESULTING MATERIALS FROM THE PREMISES, EXCEPT AS NOTED OTHERWISE.
 - SELLING OR BURNING MATERIALS ON SITE IS NOT PERMITTED.
 - WHERE UNEXPECTED CONDITIONS AND/OR HAZARDOUS MATERIAL ARE ENCOUNTERED DURING DEMOLITION, STOP WORK IN THE AREA IMMEDIATELY AND CONSULT THE DEPARTMENT REPRESENTATIVE AND FOLLOW ALL INSTRUCTIONS.
 - REMOVE ALL PIPING, ELECTRICAL WIRING AND FOUNDATIONS. COMPLETELY REMOVE EXISTING BUILDING AS INDICATED.
 - UTILITIES TO BE CAPPED TWO METERS AWAY FROM BUILDINGS DEMOLISHED AT PARKS OPERATIONAL COMPOUND SITE AND UTILITIES TO BE CAPPED AT PROPERTY LINE AT IN TOWN SITE (102 & 104 WINDFLOWER AVE) - LOTS 20 & 21 BLOCK 42 PLAN 5854DK.
 - DEMOLISH FOUNDATION WALLS AND FOOTINGS, AND CONCRETE FLOORS BELOW OR ON GRADE TO MAKE WAY FOR NEW CONSTRUCTION.
 - DO NOT USE PIECES OF CONCRETE OR MASONRY AS BACKFILL.

Key Plan



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3	2016-12-08	ISSUED FOR TENDER		
2	2016-12-08	ISSUED FOR BUILDING PERMIT		
1	2016-09-02	ISSUED FOR 99% REVIEW		

Revision / Revision	
A detail number numero de detail	A
B source drawing no. de dessin no.	B
C detail on drawing no. detail sur dessin no.	C
Consultant's Name Nom de l'expert-consult	Eng. Stamp Sceau de l'ingénieur
IBI GROUP Suite 500 - 611 Meredith Road NE Calgary, Alberta T2E 2W5 T: (403) 270-5600 F: (403) 270-5610 ibigroup.com	


Public Works and Government Services Canada
Travaux publics et Services gouvernementaux Canada
Client Services Team Southern Alberta Operations Branch
Le Client Entretien l'Équipe Alberta Méridionale Branche d'Opérations

Canada
Client/client Parks Canada Agency
L'Agence Parcs Canada
Western and Northern Region
Ouest et Nord du Canada

Staff Housing Phase 2
Waterton Lakes National Park


SITE PLAN - DEMOLITION - LOTS 20 & 21

Surveyed by/Arpenté par LS/FVR	Drawn by/Dessiné par MP	Date/Date 2016-12-08
Designed by/Concept par LS/FVR	Reviewed by/Revisé par LS/FVR	Scale/Echelle As indicated
PWGSC Project Manager/Administrateur de Projets TPWGC Randy Boldt		
Client Acceptance/Acceptation du client		Approved by/Approuvé par
Project No./No. du projet 39000		
Asset No./No. d'actif Fil # 945		Sheet No./No. de la feuille A141
Drawing Reference No./No. de référence du dessin		

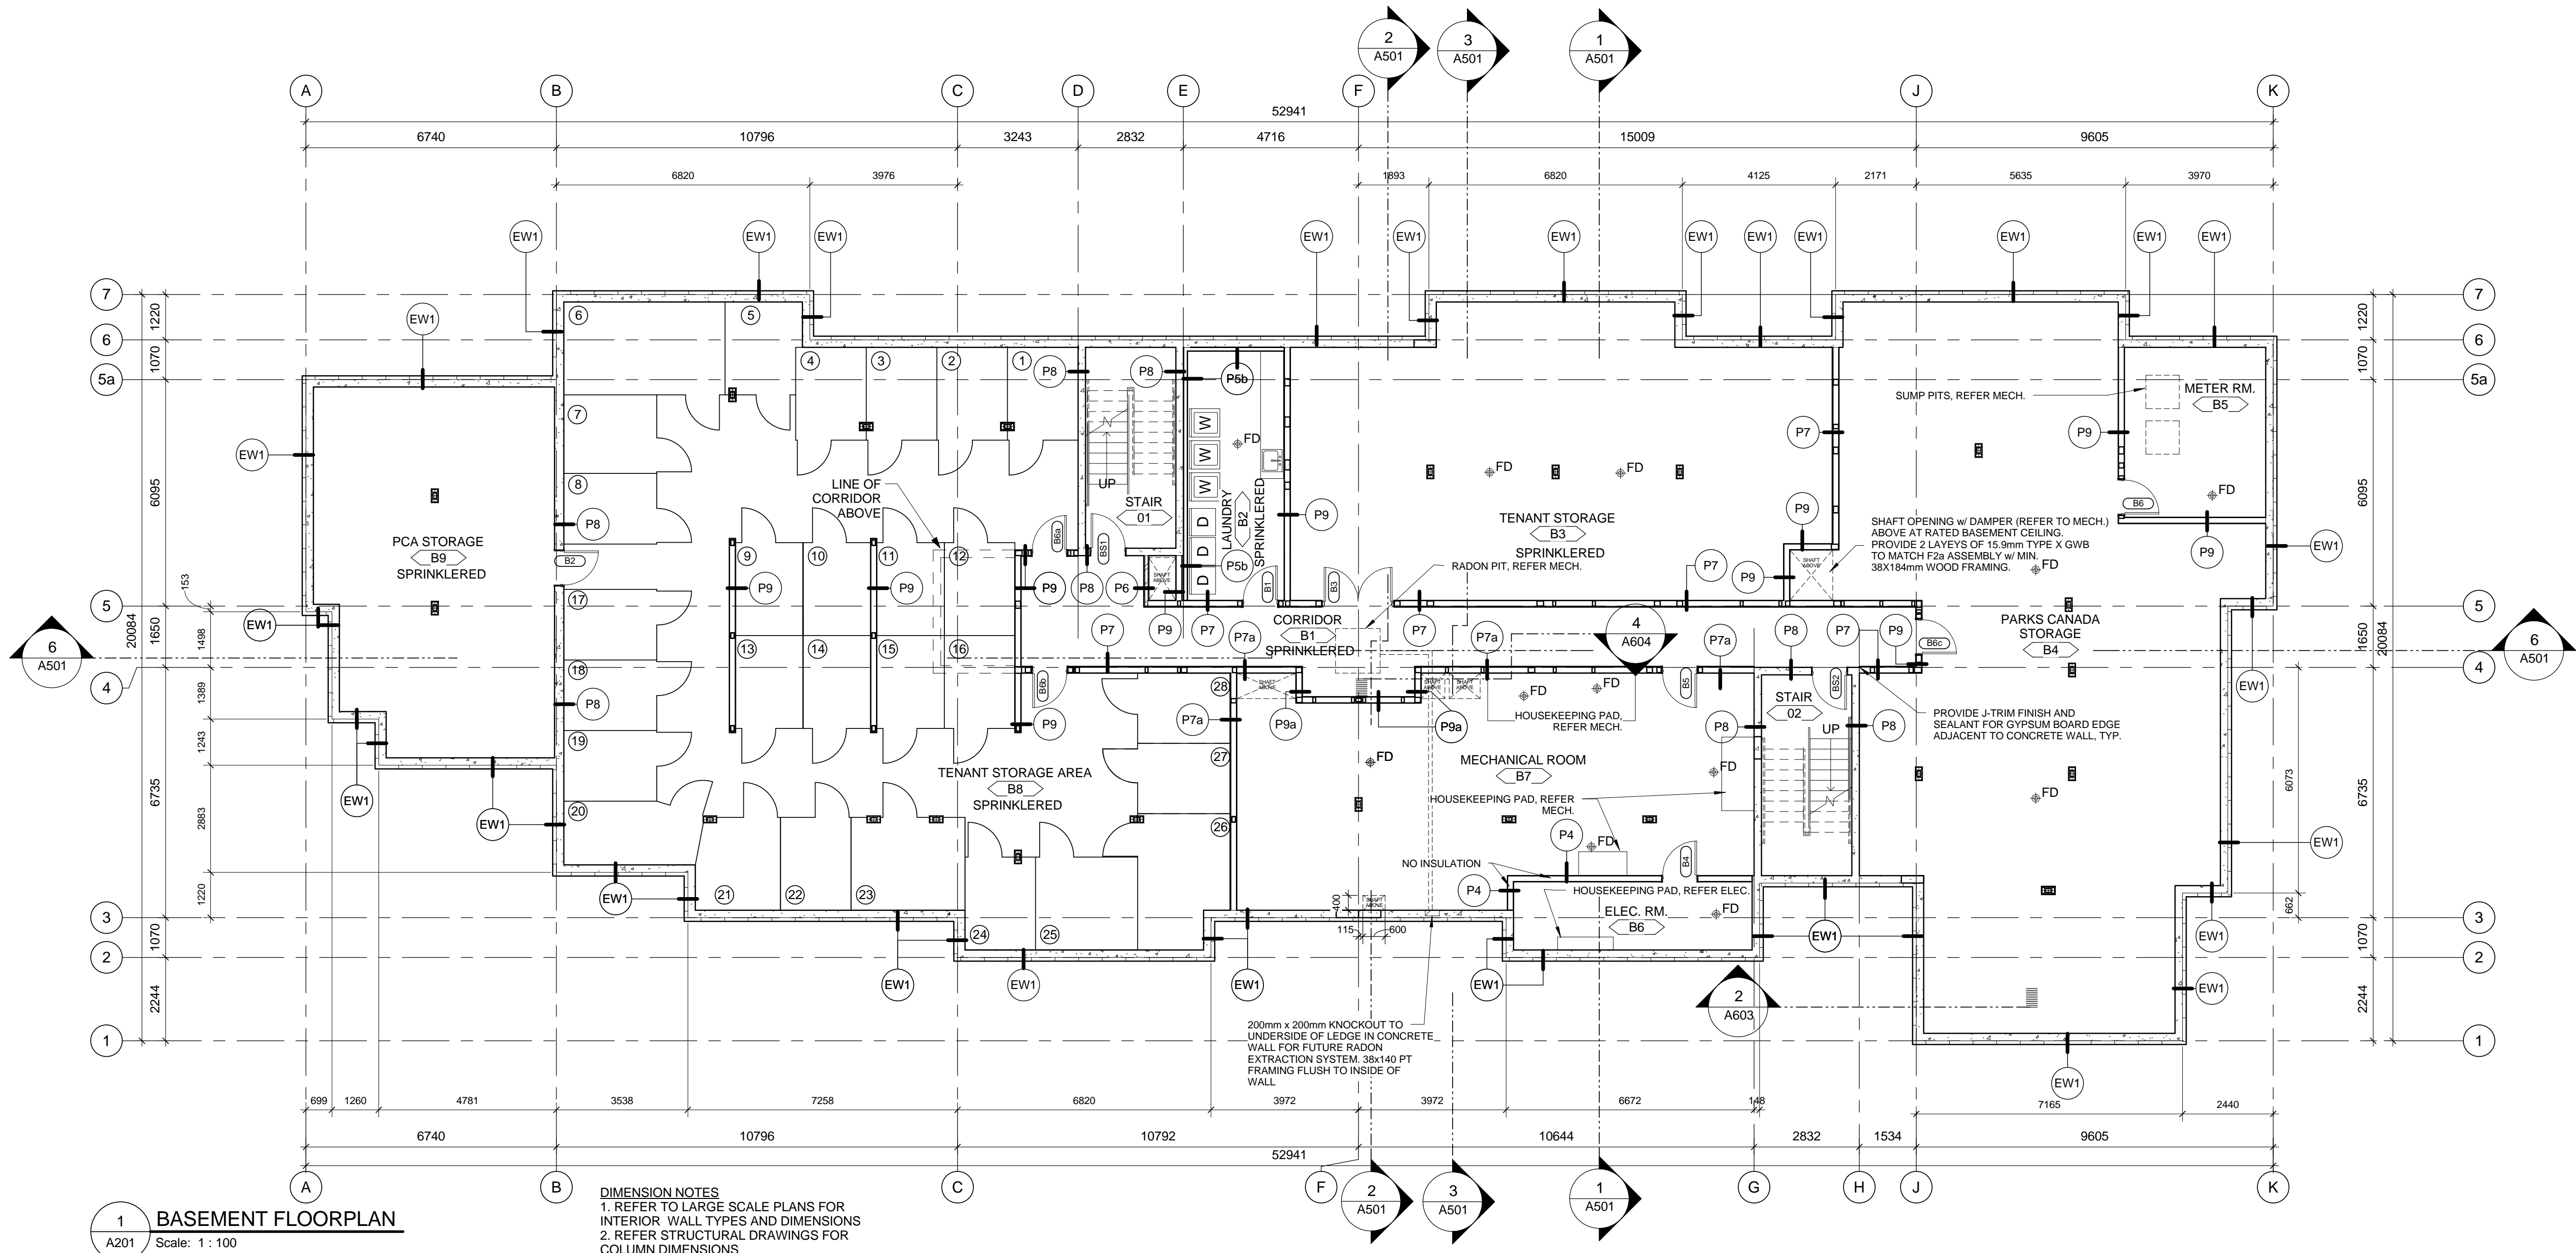

1 BASEMENT FLOORPLAN
A201 Scale: 1:100

DIMENSION NOTES
1. REFER TO LARGE SCALE PLANS FOR INTERIOR WALL TYPES AND DIMENSIONS
2. REFER STRUCTURAL DRAWINGS FOR COLUMN DIMENSIONS

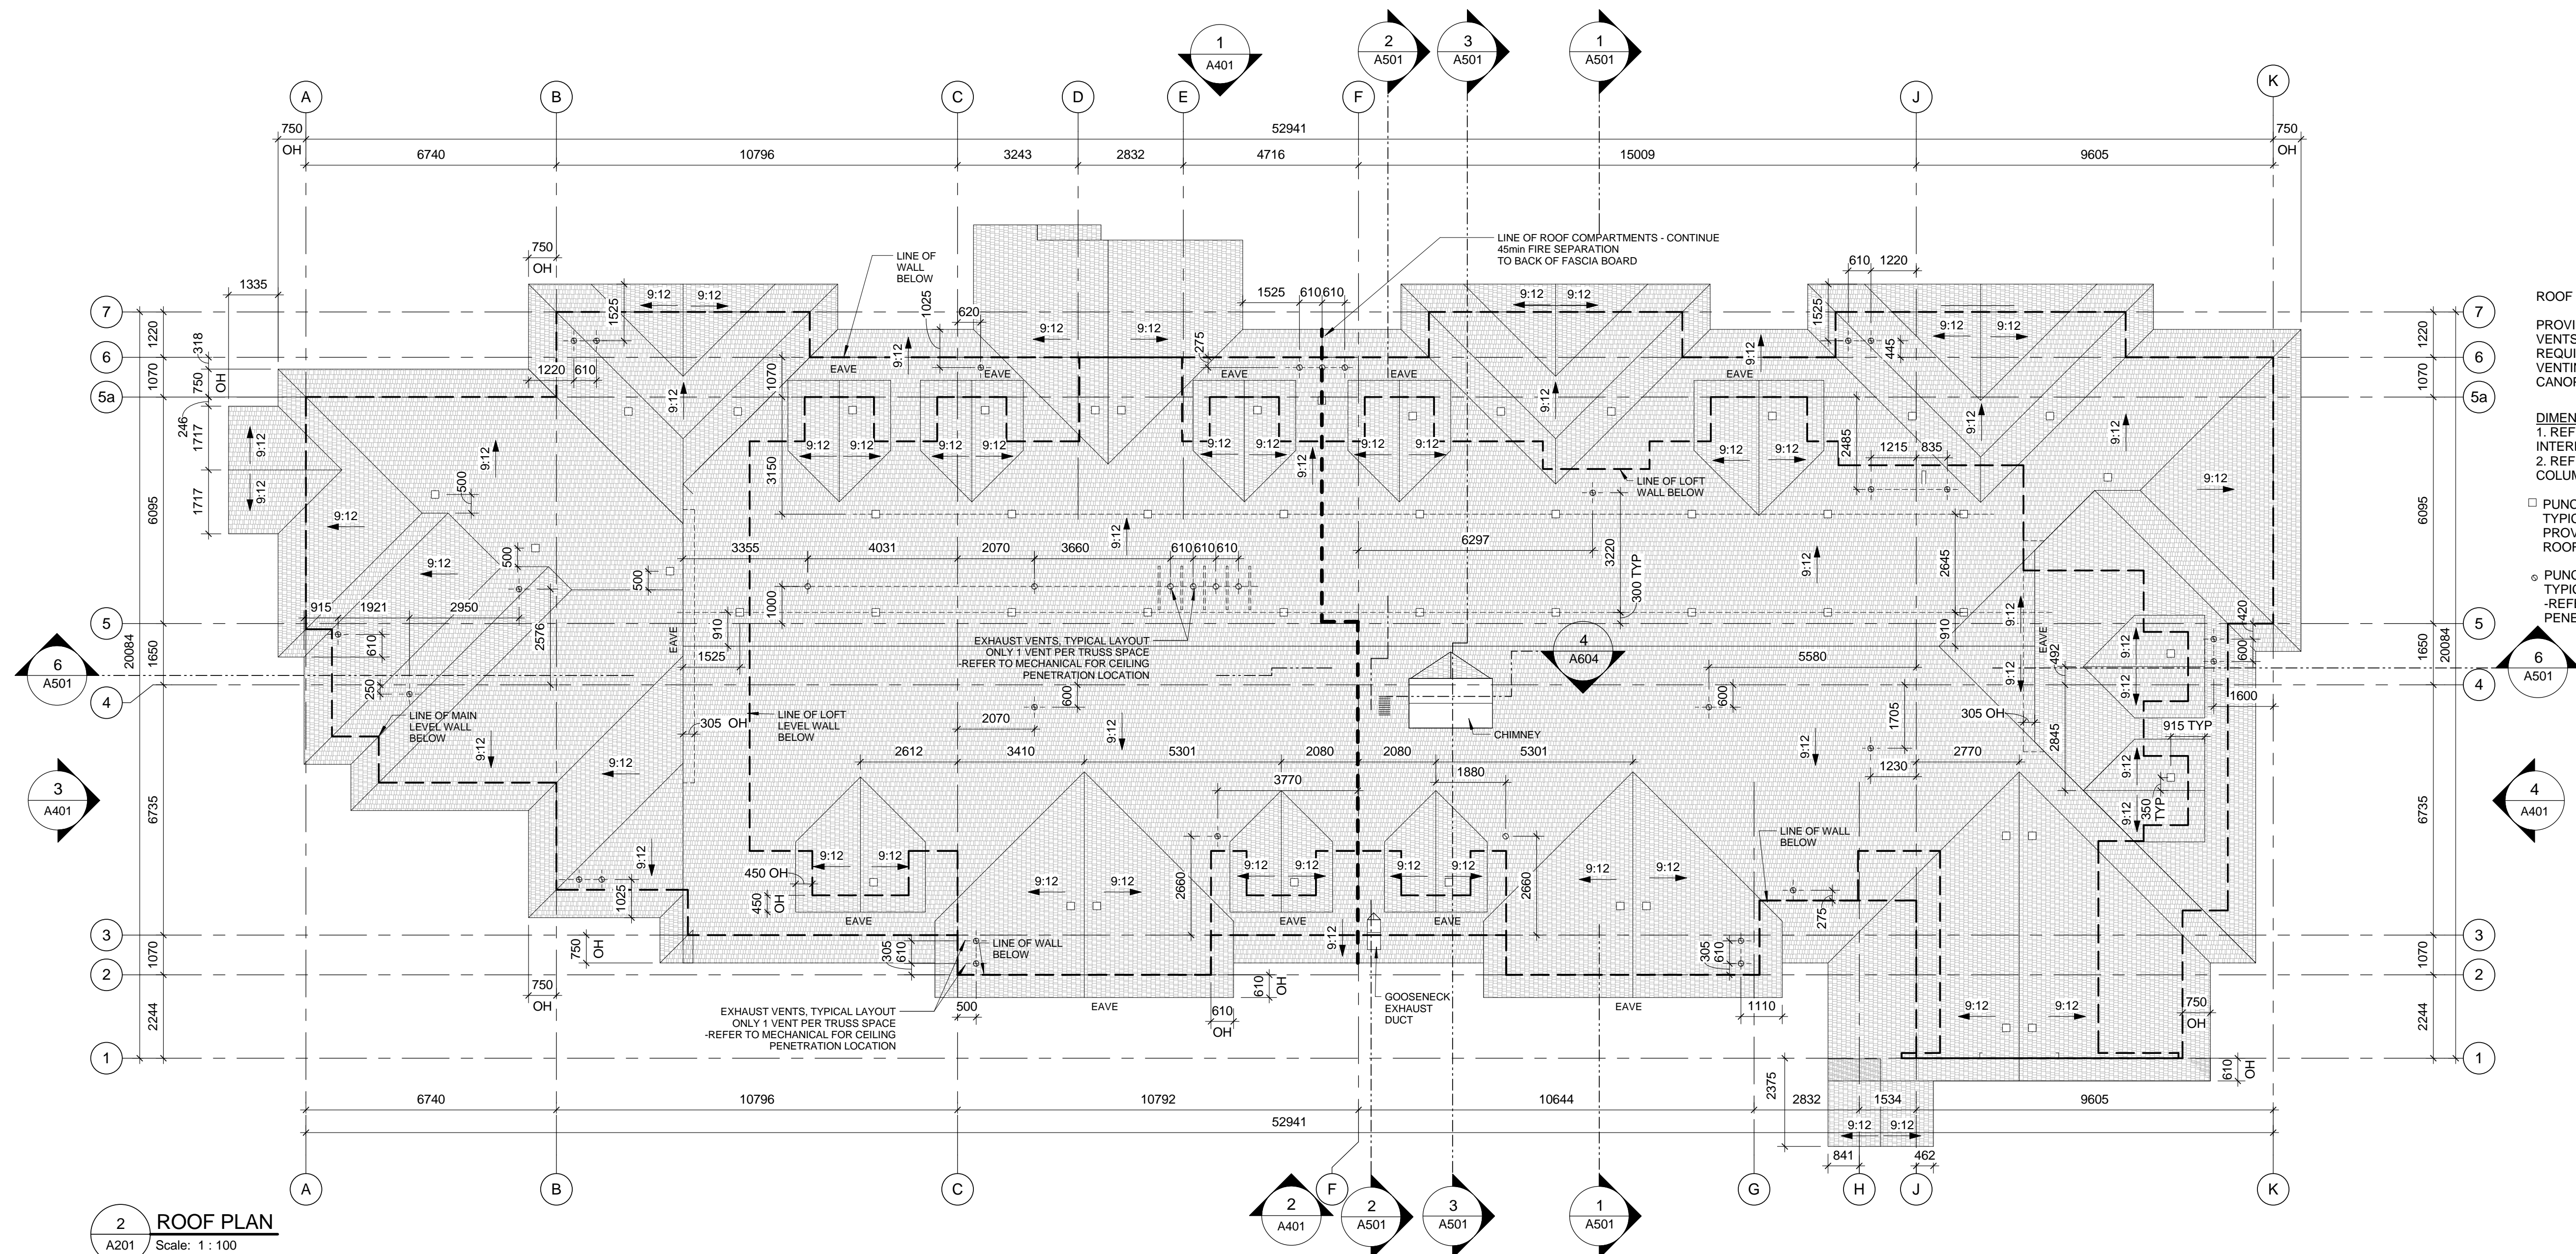

2 ROOF PLAN
A201 Scale: 1:100

ROOF NOTE:
PROVIDE MINIMUM 60 PUNCHED ROOF VENTS AS PER ROOF PLAN LAYOUT AS REQUIRED FOR VENTING. PROVIDE VENTING FOR ALL DORMERS AND CANOPIES.

DIMENSION NOTES
1. REFER TO LARGE SCALE PLANS FOR INTERIOR WALL TYPES AND DIMENSIONS
2. REFER STRUCTURAL DRAWINGS FOR COLUMN DIMENSIONS
PUNCHED ROOF VENTS - VENTILATION TYPICAL LAYOUT ONLY 1 VENT PER TRUSS SPACE PROVIDE EVEN SPACING, VENTS TO ALIGN ON ROOF
PUNCHED ROOF VENT - EXHAUST VENTS TYPICAL LAYOUT ONLY 1 VENT PER TRUSS SPACE REFER TO MECHANICAL FOR CEILING PENETRATION LOCATION

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3	2016-06-14	ISSUED FOR 66% REVIEW		
2	2016-05-09	ISSUED FOR 33% REVIEW		
1	2016-05-06	DEVELOPMENT PERMIT REVIEW		

Revision / Revision	
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B	source drawing no. de dessin no.
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Consultant's Name Nom de l'expert-consult	
Eng. Stamp Sceau de l'ingénieur	
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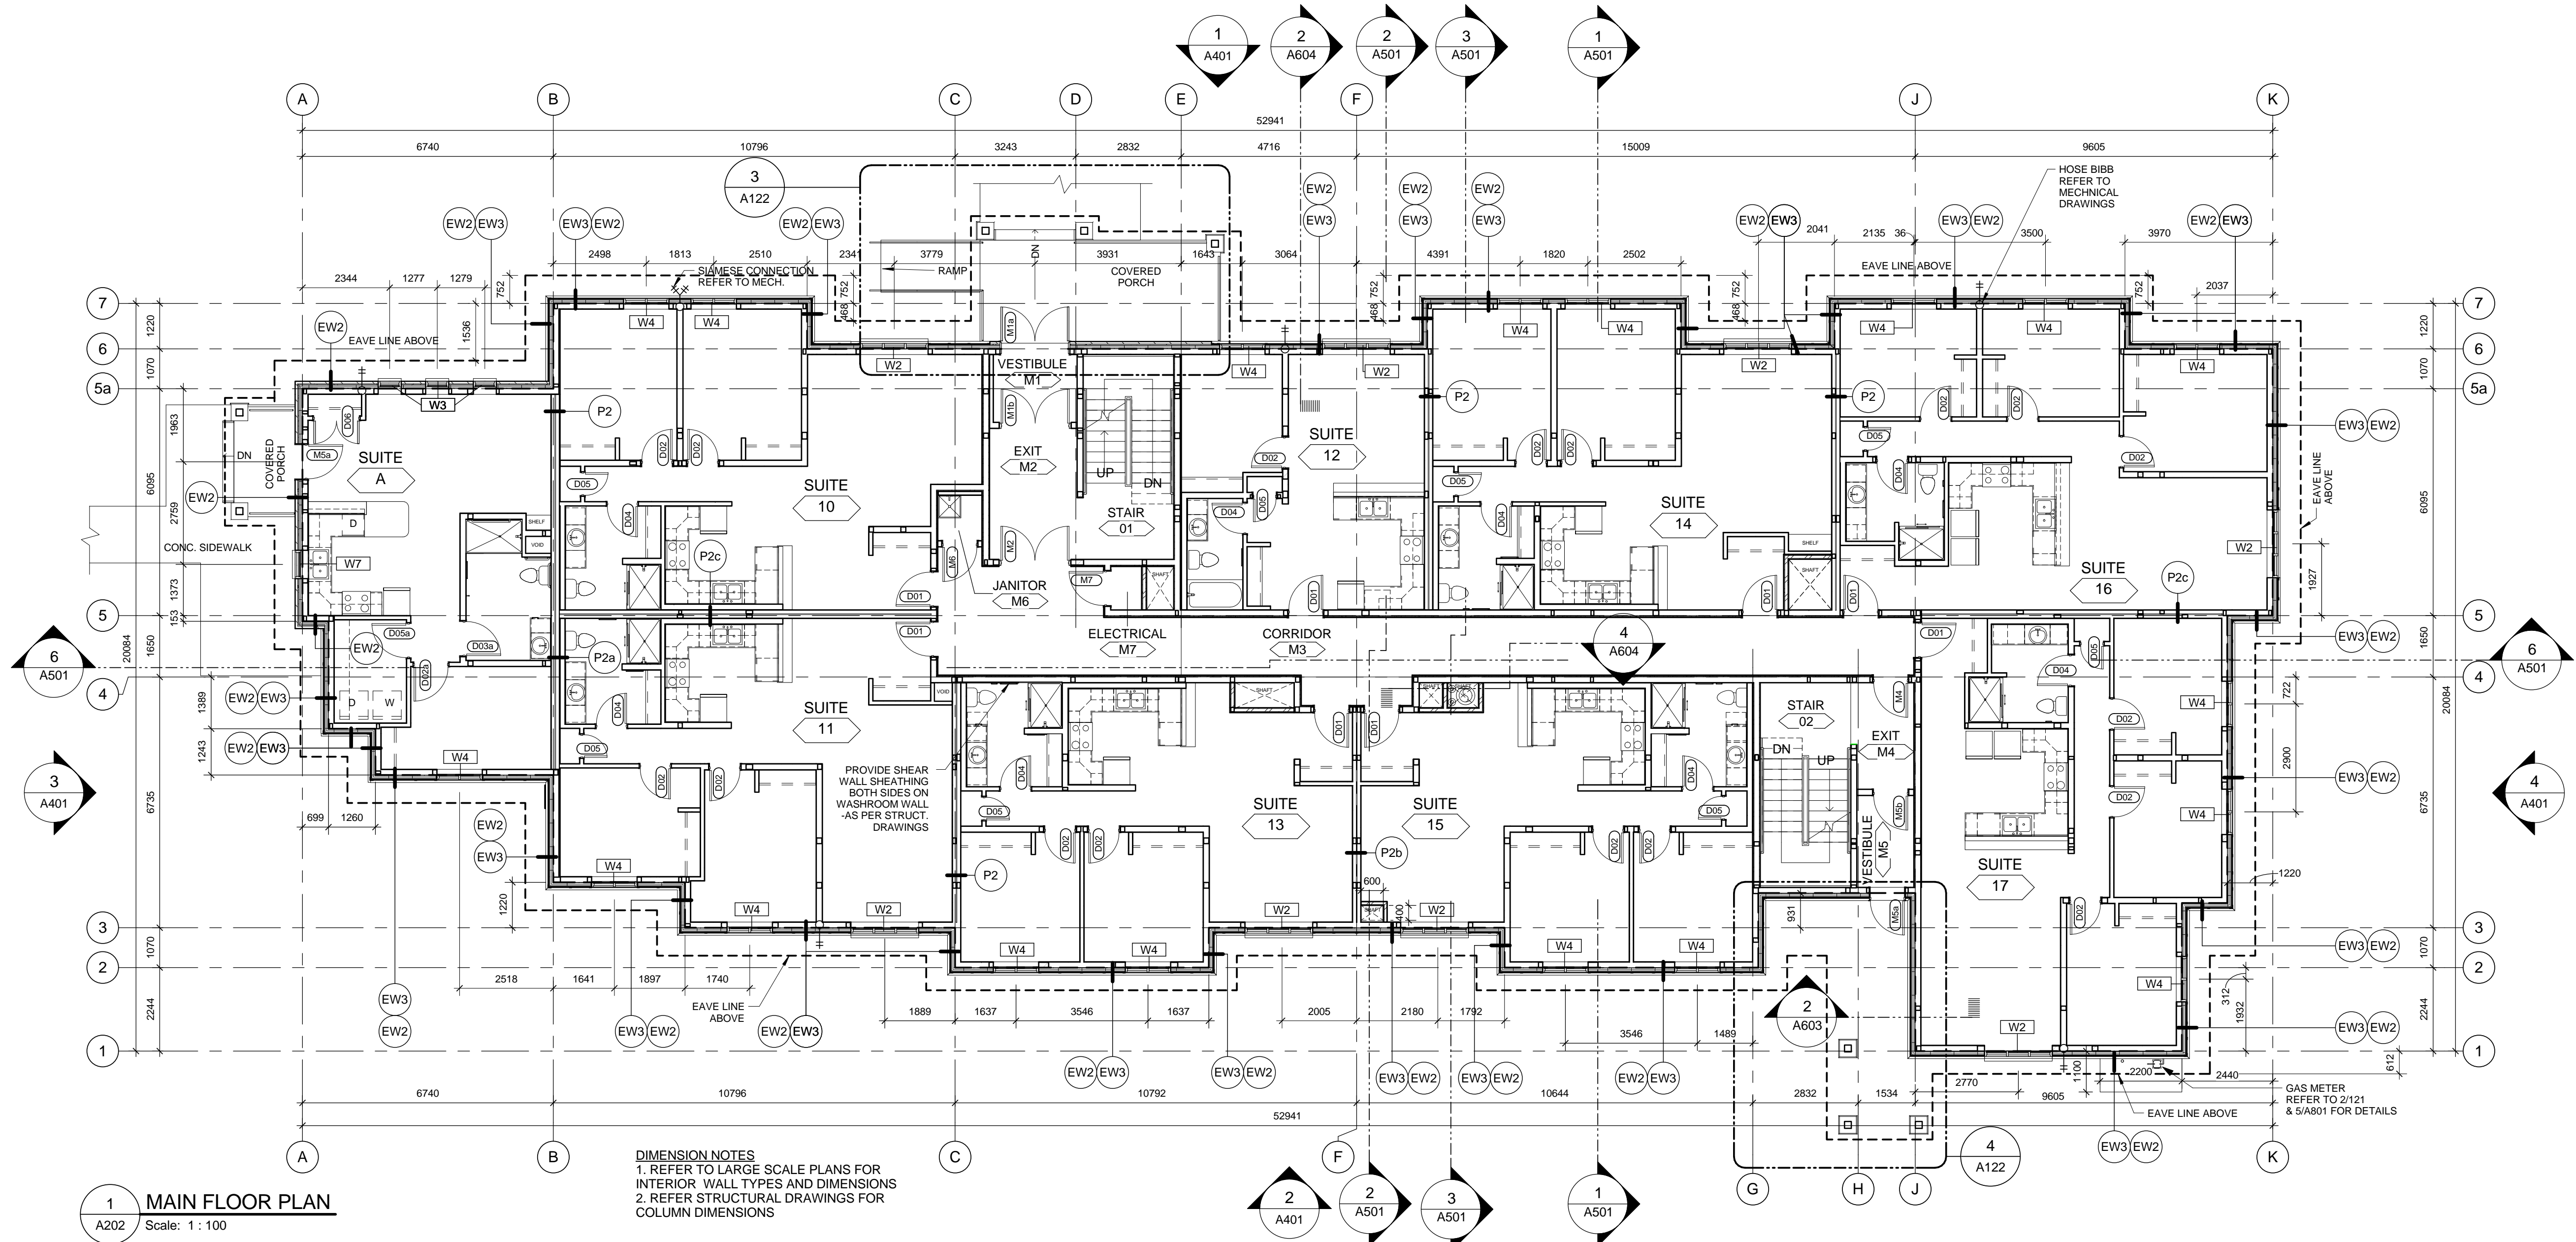
Canada

Client/client	Parks Canada Agence	L'Agence Parcs Canada
	Western and Northern Region	Ouest et Nord du Canada

Project title/Titre du projet
**Staff Housing Phase 2
Waterton Lakes National
Park**

Drawing title/Titre du dessin
**BASEMENT FLOOR PLAN &
ROOF PLAN**

Surveyed by/Arpenté par	Drawn by/Dessiné par	Date/Date
LS/FVR	MP/AG	2016-12-08
Designed by/Concept par	Reviewed by/Revisé par	Scale/Echelle
LS/FVR	LS/FVR	1:100
PWGSC Project Manager/Administrateur de Projets TPSCG Randy Boldt		
Client Acceptance/Acceptation du client Approved by/Approuvé par		
Task Responsible/Officer/Agent Responsable		
Project No./No. du projet	Asset No./No. d'actif	Sheet No./ No. de la feuille
39000	File # 945	A201
Drawing Reference No./No. de référence du dessin		




EXTERIOR PLUMBING LEGEND

- SC FIRE DEPARTMENT
SIAMESE CONNECTION
-REFER TO DETAIL 6/A801
- HB HOSE BIBB
-REFER TO MECHANICAL

NOTE: PROVIDE EAVE PROTECTION FOR MAIN FLOOR WINDOWS AND DOORS WHERE EAVE IS WITHIN 1.2m EITHER SIDE OF OPENING. REFER DETAIL 1/A803

DIMENSION NOTES
1. REFER TO LARGE SCALE PLANS FOR INTERIOR WALL TYPES AND DIMENSIONS
2. REFER STRUCTURAL DRAWINGS FOR COLUMN DIMENSIONS

1 MAIN FLOOR PLAN
Scale: 1 : 100

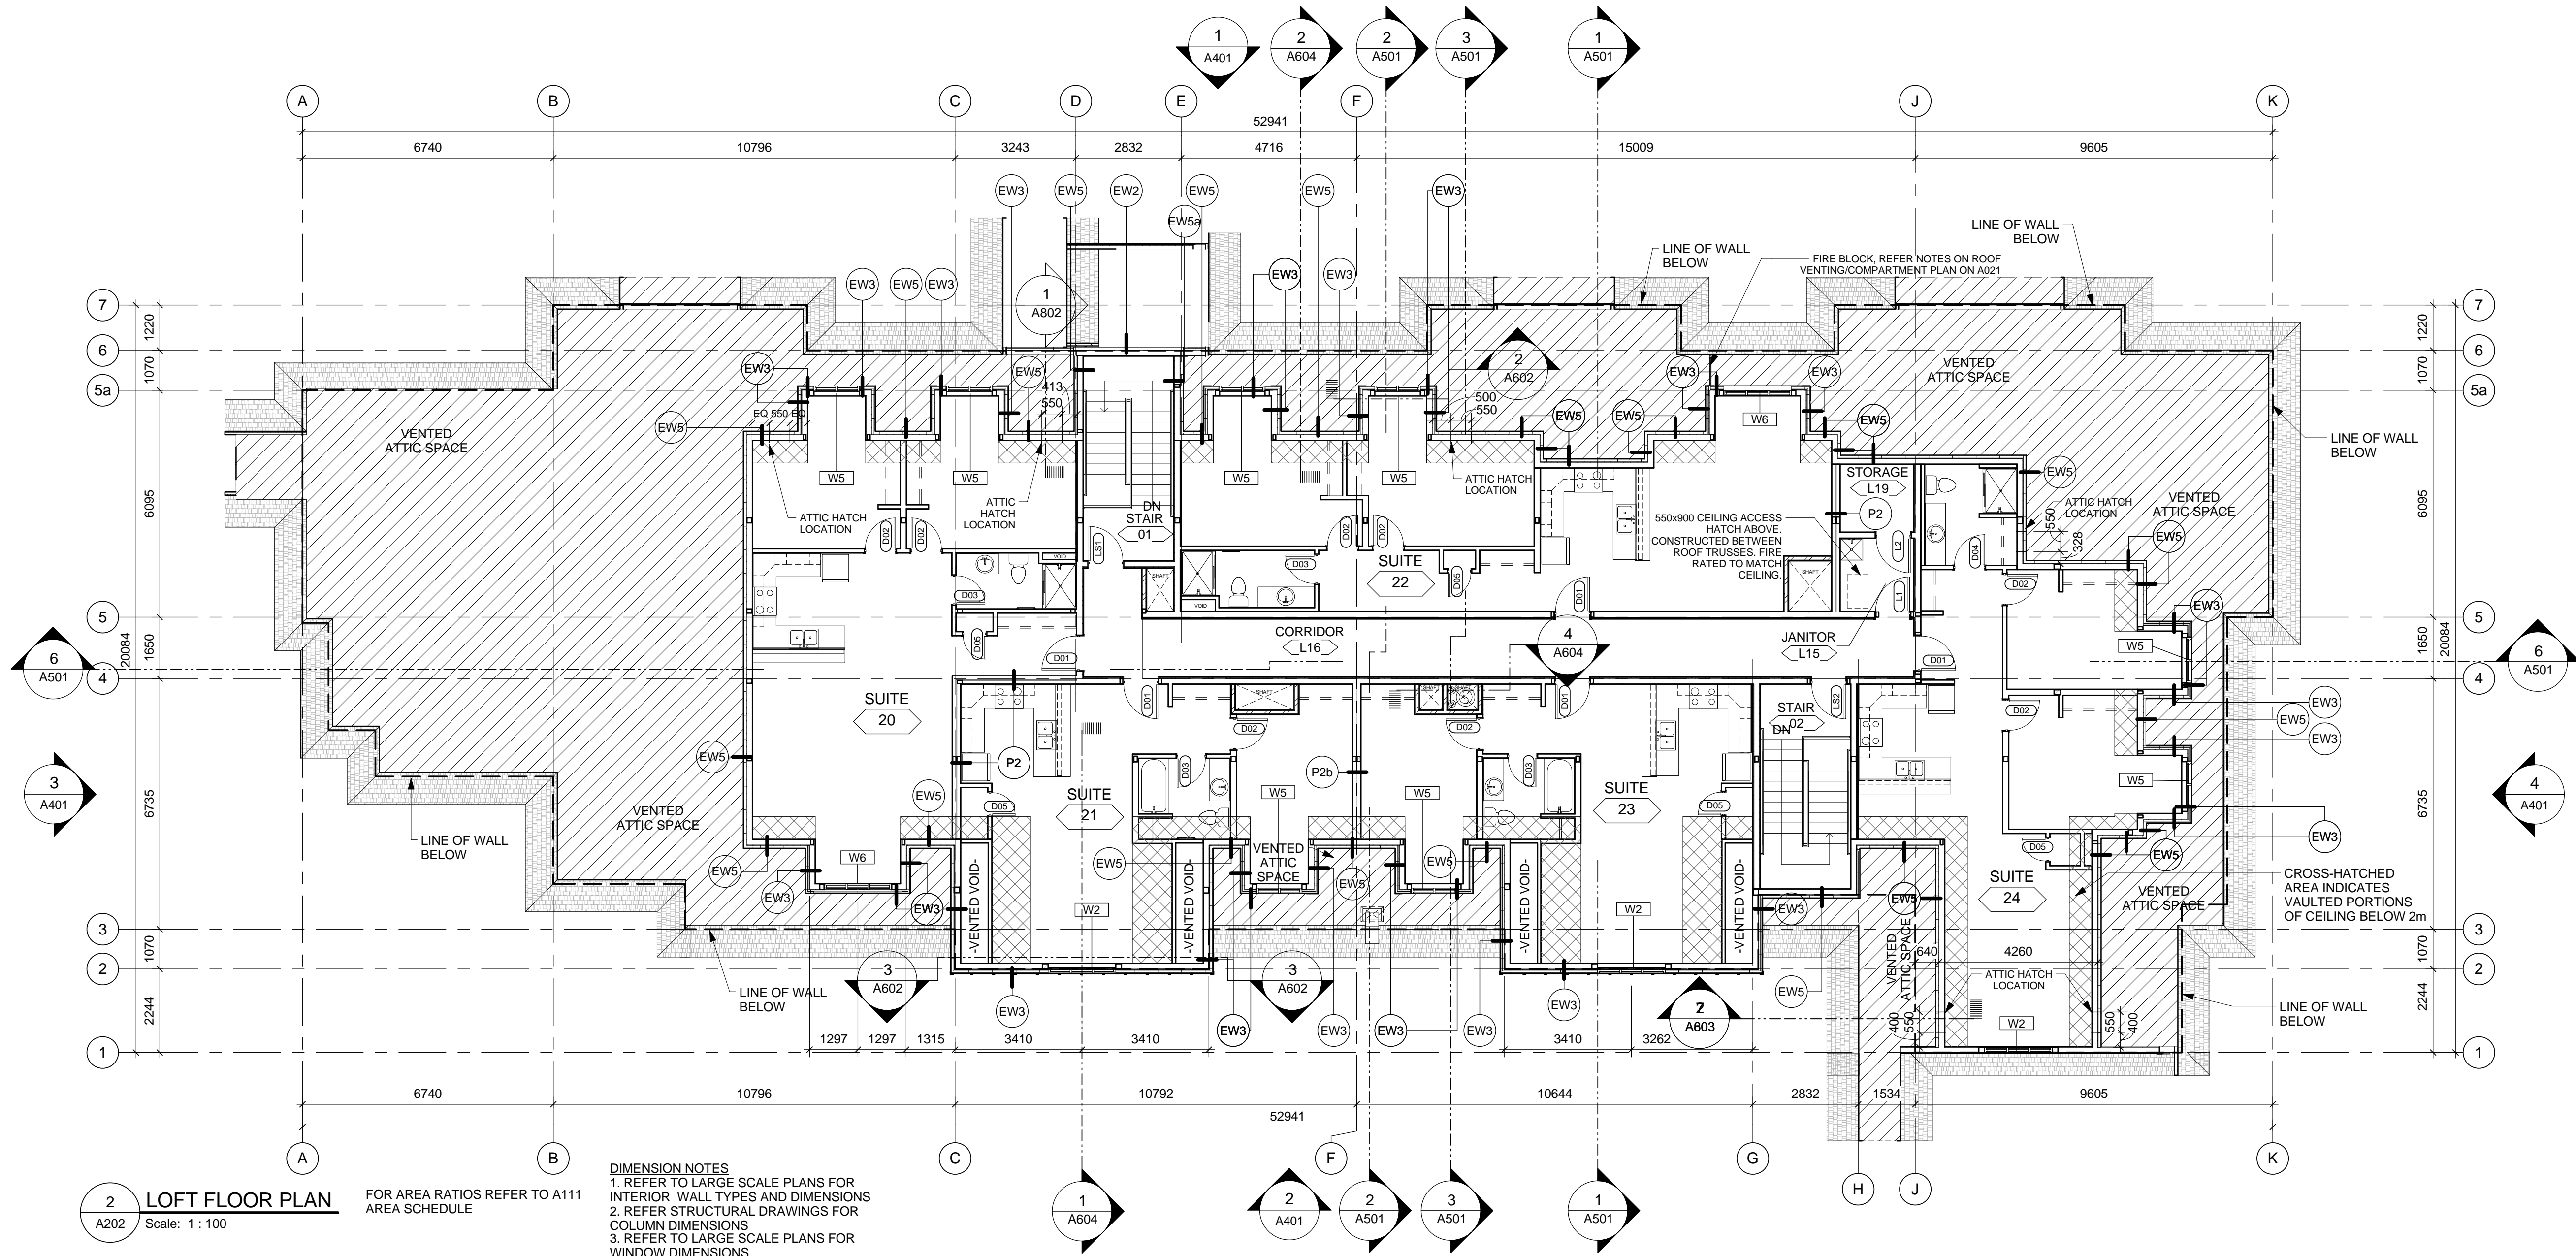


DIMENSION NOTES
1. REFER TO LARGE SCALE PLANS FOR INTERIOR WALL TYPES AND DIMENSIONS
2. REFER STRUCTURAL DRAWINGS FOR COLUMN DIMENSIONS
3. REFER TO LARGE SCALE PLANS FOR WINDOW DIMENSIONS

2 LOFT FLOOR PLAN
Scale: 1 : 100

FOR AREA RATIOS REFER TO A111 AREA SCHEDULE

<

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1
A211
ENLARGED-FINISHES PLAN - BASEMENT LEVEL-WEST
Scale: 1:50

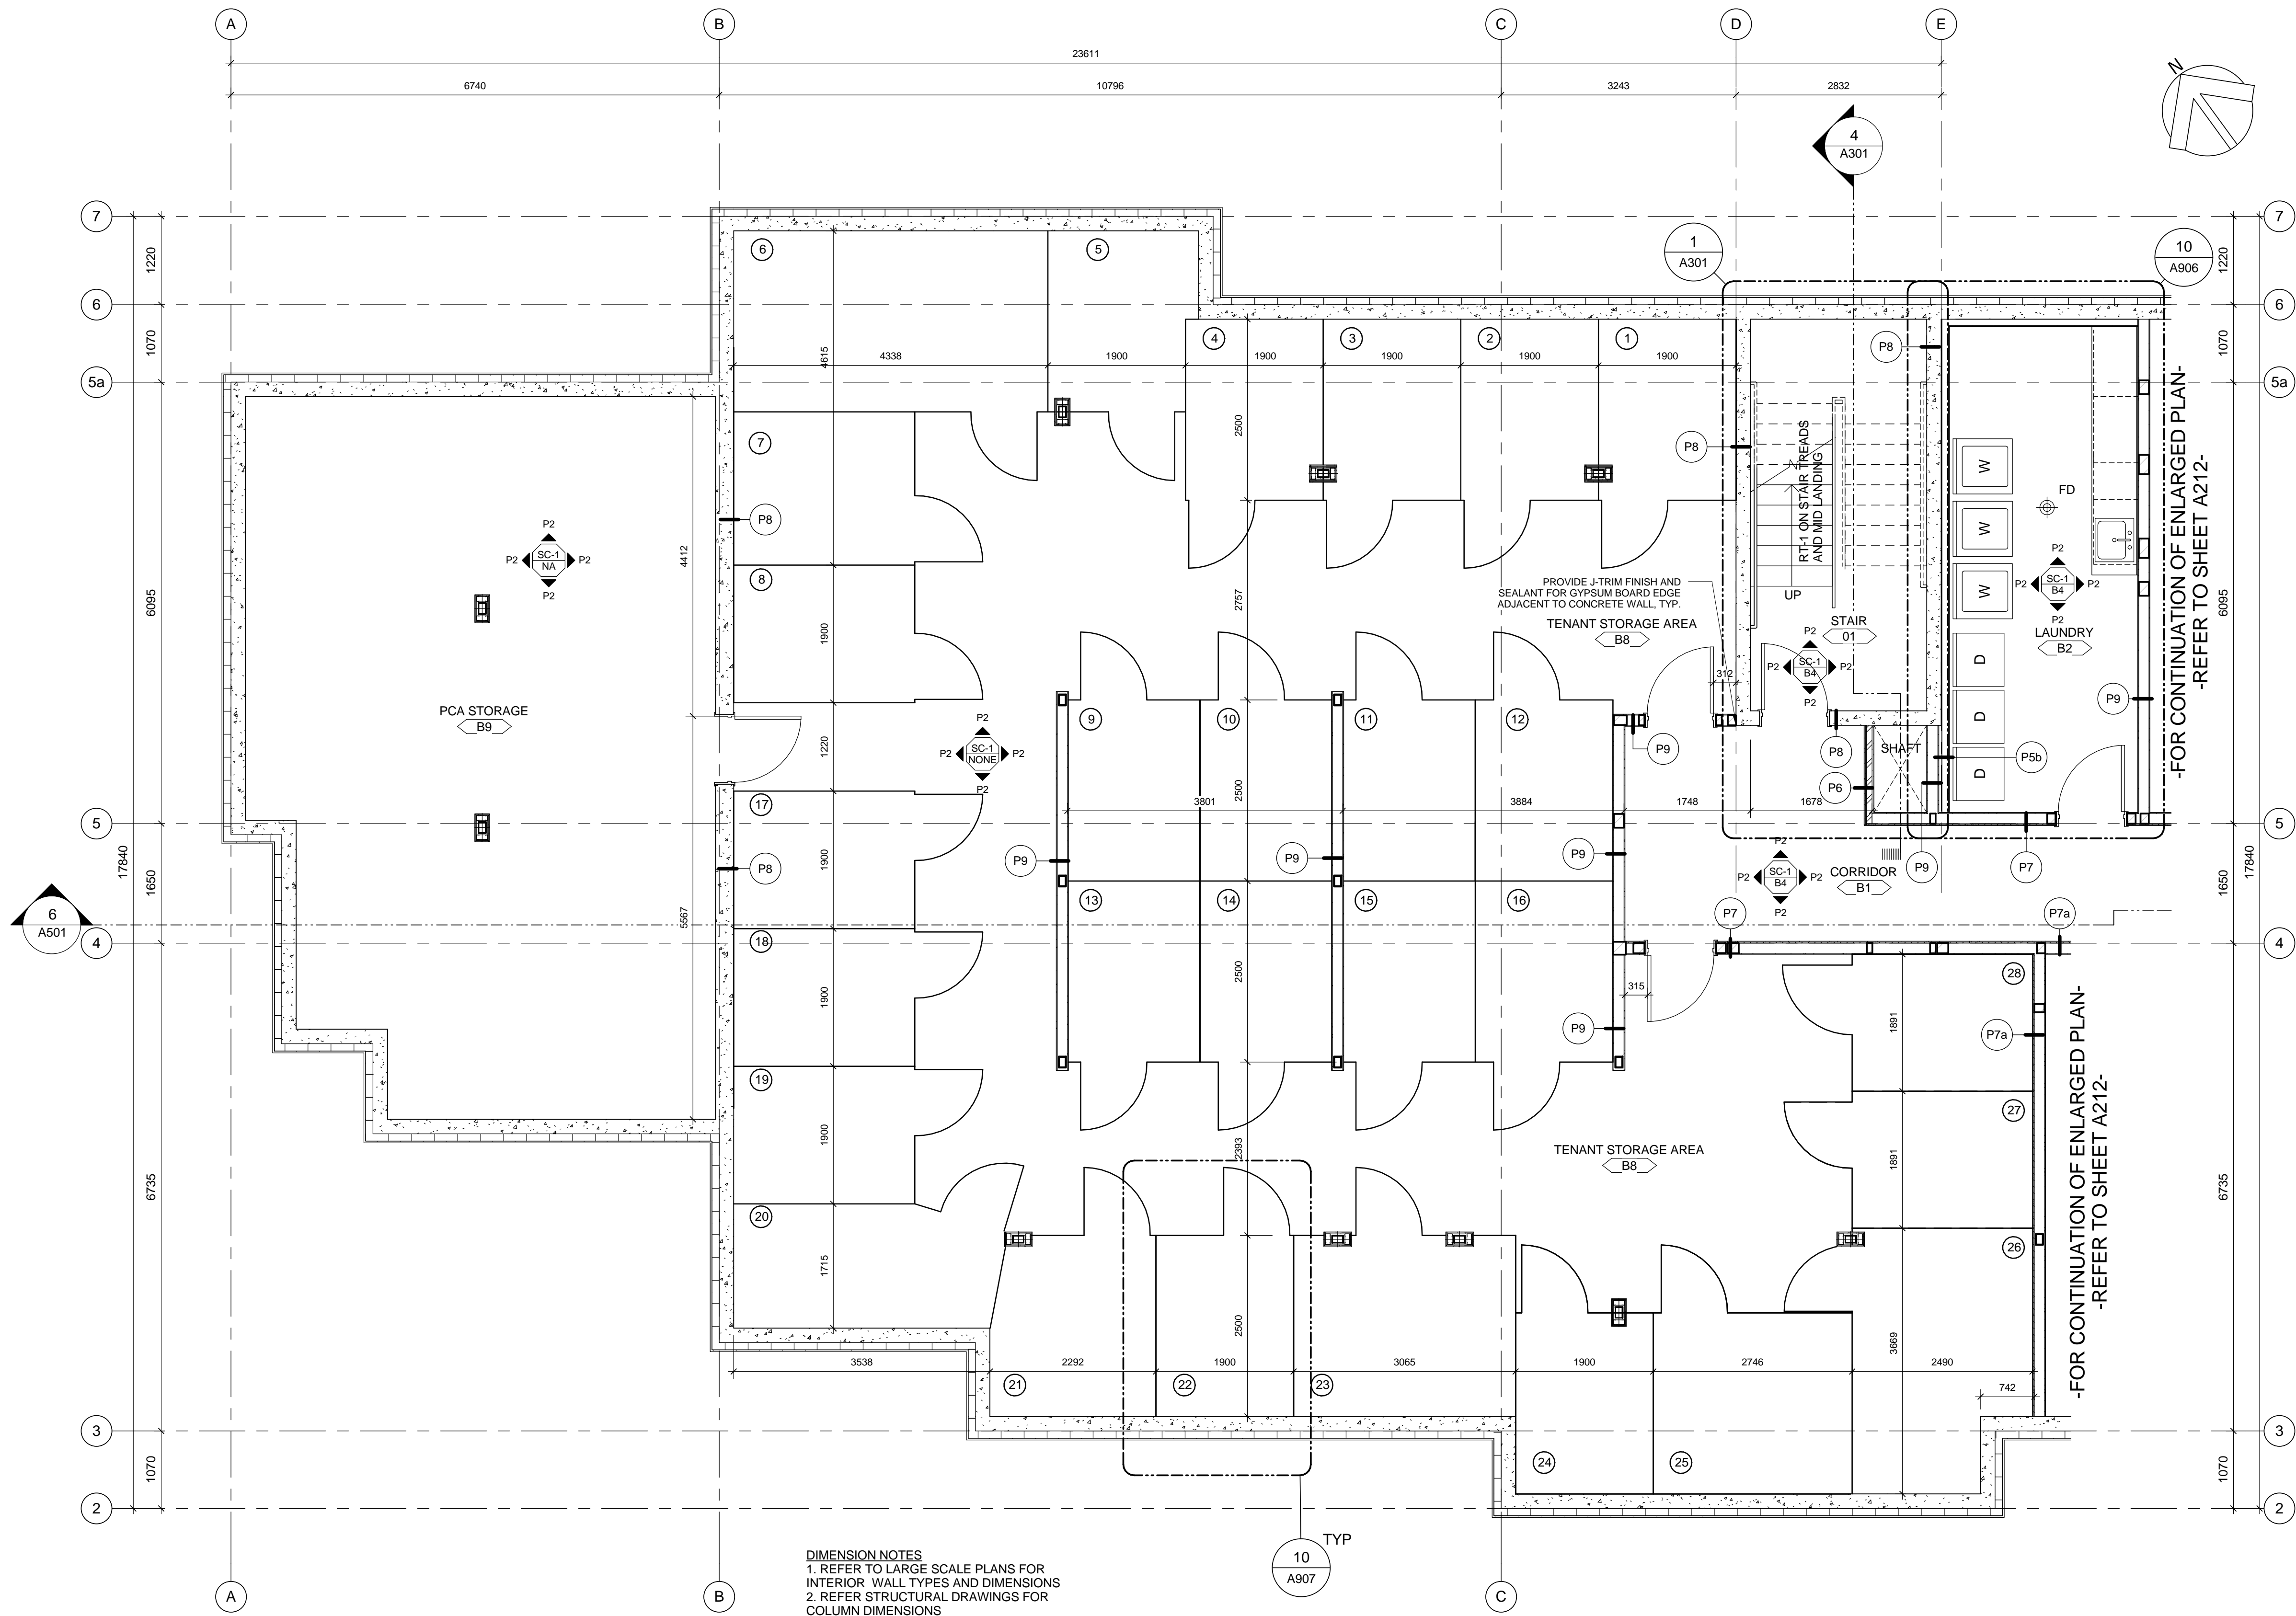DIMENSION NOTES
1. REFER TO LARGE SCALE PLANS FOR
INTERIOR WALL TYPES AND DIMENSIONS
2. REFER STRUCTURAL DRAWINGS FOR
COLUMN DIMENSIONS

TYP

FINISH SCHEDULE

FLOOR FINISHES

- LVT-1 RESILIENT FLOORING - TYPE 1**
PRODUCT: LUXURY VINYL PLANK
COLOUR: LIGHT BROWN, WOOD LOOK
- LVT-2 RESILIENT FLOORING - TYPE 2**
PRODUCT: LUXURY VINYL PLANK
COLOUR: LIGHT BEIGE, WOOD LOOK
- VF-1 RESILIENT FLOORING - TYPE 3**
PRODUCT: VINYL SHEET FLOORING
COLOUR: TBD
- RT-1 RESILIENT FLOORING - TYPE 4**
PRODUCT: RUBBER TREADS & MATCHING
RUBBER TILE MID LANDING
COLOUR: TBD
- SC-1 SEALED CONCRETE FLOOR**

BASE

- B1 WALL BASE - UNITS**
PRODUCT: 100mm x 12.9mm MDF TRIM, PRIMED & PAINTED
COLOUR: P5
- B2 WALL BASE**
PRODUCT: 140mm x 12.9mm MDF TRIM, PRIMED & PAINTED
COLOUR: P4
- B3 WALL "CHAIR" RAIL @ 1000mm A.F.F.**
PRODUCT: 100mm X 12.9mm MDF TRIM, PRIMED & PAINTED
COLOUR: P4
- B4 RUBBER BASE**
PRODUCT: RUBBER BASE
COLOUR: GREY

WALL FINISHES

- WT-1 WALL TILE - BACKPLASH/SHOWER SURROUND**
PRODUCT: CERAMIC TILE: 150mm x 150mm
COLOUR: WHITE
- NO FINISH**


PAINT COLOURS

- P1 PAINT COLOUR 1 - UNITS**
TYPE: EGGSHELL
COLOUR: TBD
- P2 PAINT COLOUR 2 - CORRIDORS**
TYPE: EGGSHELL
COLOUR: TBD
- P3 PAINT COLOUR 3 - ACCENT - UNITS**
TYPE: EGGSHELL
COLOUR: TBD
- P4 PAINT COLOUR 4 - TRIM - UNITS**
TYPE: SEMI-GLOSS
COLOUR: TBD
- P5 PAINT COLOUR 4 - DOORS & TRIM - CORRIDOR**
TYPE: SEMI-GLOSS
COLOUR: TBD
- P6 CEILING:**
TYPE: FLAT
COLOUR: TBD

CEILING FINISH

- C1 GYPSUM, SMOOTH FINISH**
PAINT FINISH: P6

NOTE:
CONTRACTOR TO COORDINATE TO EXTEND SUBSTRATES AS REQUIRED
TO ACHIEVE CONTINUOUS WALL FINISH.

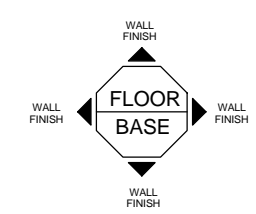

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5	2016-12-08	ISSUED FOR BUILDING PERMIT		
4	2016-09-02	ISSUED FOR 99% REVIEW		
3	2016-06-14	ISSUED FOR 66% REVIEW		
2	2016-05-09	ISSUED FOR 33% REVIEW		
1	2016-05-06	DEVELOPMENT PERMIT REVIEW		

Revision / Revision	
A detail number numéro de détail	A
B source drawing no. de dessin no.	B
C detail on drawing no. détail sur dessin no.	C

Consultant's Name Nom de l'expert-conseil	IBI GROUP Suite 500 - 611 Meredith Road NE Calgary, Alberta T2E 2W5 T: (403) 270-5600 F: (403) 270-5610 ibigroup.com	Eng. Stamp Sceau de l'ingénieur
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Canada

Client/client Parks Canada Agency	L'Agence Parcs Canada
Western and Northern Region	Ouest et Nord du Canada

Project title/Titre du projet
**Staff Housing Phase 2
Waterton Lakes National
Park**

Drawing title/Titre du dessin
**ENLARGED FLOOR-FINISHES
PLAN - BASEMENT
LEVEL-WEST**

Surveyed by/Arpenté par LS/FVR	Drawn by/Dessiné par MPI/AG	Date/Date 2016-12-08
Designed by/Concept par LS/FVR	Reviewed by/Revisé par LS/FVR	Scale/Echelle 1:50

PWGSC Project Manager/Administrateur de Projets TPSCGC

Randy Boldt

Client Acceptance/Acceptation du client

Approved by/Approuvé par

TPSCGC Project Manager/Administrateur de Projets TPSCGC

Project No./No. du projet


Asset No./No. du bien

Sheet No./
No. de la feuille

Drawing Reference No./No. de référence du dessin

A211

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FINISH SCHEDULE

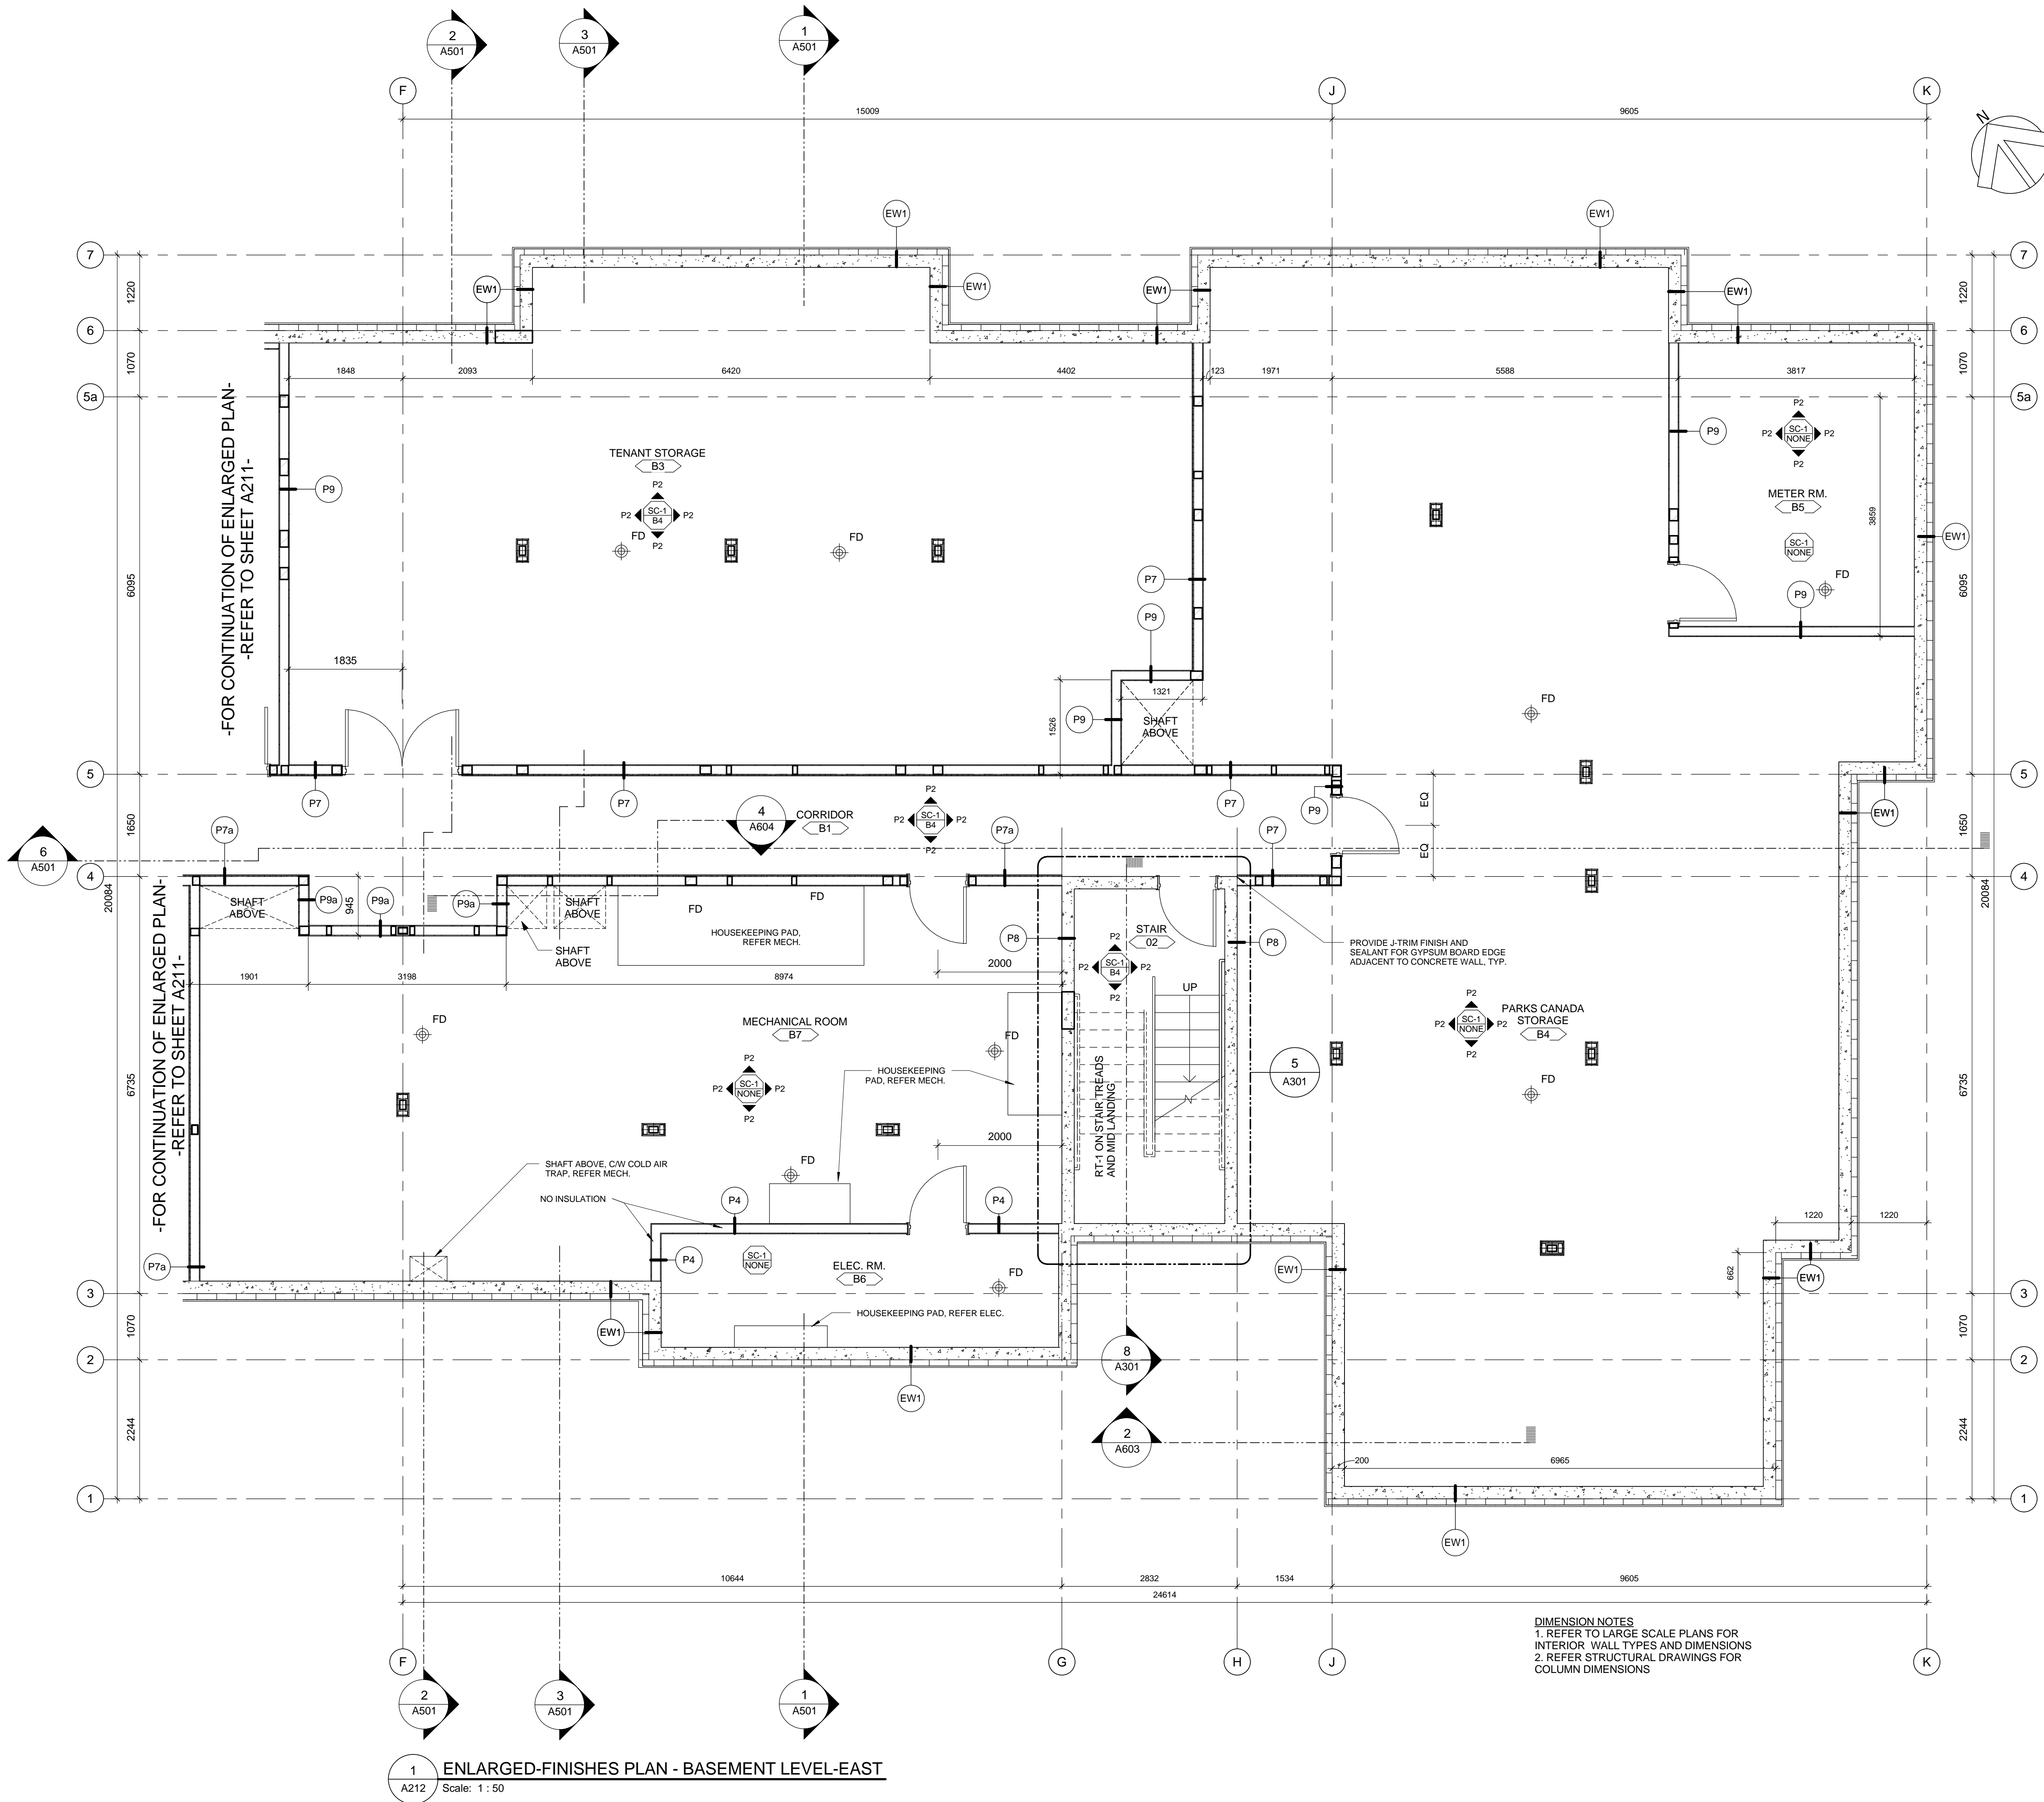FLOOR FINISHES

- LVT-1 RESILIENT FLOORING - TYPE 1**
PRODUCT: LUXURY VINYL PLANK
COLOUR: LIGHT BROWN, WOOD LOOK
- LVT-2 RESILIENT FLOORING - TYPE 2**
PRODUCT: LUXURY VINYL PLANK
COLOUR: LIGHT BEIGE, WOOD LOOK
- VF-1 RESILIENT FLOORING - TYPE 3**
PRODUCT: VINYL SHEET FLOORING
COLOUR: TBD
- RT-1 RESILIENT FLOORING - TYPE 4**
PRODUCT: RUBBER TREADS & MATCHING RUBBER TILE MID LANDING
COLOUR: TBD
- SC-1 SEALED CONCRETE FLOOR**

BASE

- B1 WALL BASE - UNITS**
PRODUCT: 100mm x 12.9mm MDF TRIM, PRIMED & PAINTED
COLOUR: P5
- B2 WALL BASE**
PRODUCT: 140mm x 12.9mm MDF TRIM, PRIMED & PAINTED
COLOUR: P4
- B3 WALL "CHAIR" RAIL @ 1000mm A.F.F.**
PRODUCT: 100mm X 12.9mm MDF TRIM, PRIMED & PAINTED
COLOUR: P4
- B4 RUBBER BASE**
PRODUCT: RUBBER BASE
COLOUR: GREY

WALL FINISHES

- WT-1 WALL TILE - BACKSPLASH/SHOWER SURROUND**
PRODUCT: CERAMIC TILE: 150mm x 150mm
COLOUR: WHITE
- NO FINISH**


PAINT COLOURS

- P1 PAINT COLOUR 1 - UNITS**
TYPE: EGGSHELL
COLOUR: TBD
- P2 PAINT COLOUR 2 - CORRIDORS**
TYPE: EGGSHELL
COLOUR: TBD
- P3 PAINT COLOUR 3 - ACCENT - UNITS**
TYPE: EGGSHELL
COLOUR: TBD
- P4 PAINT COLOUR 4 - TRIM - UNITS**
TYPE: SEMI-GLOSS
COLOUR: TBD
- P5 PAINT COLOUR 4 - DOORS & TRIM - CORRIDOR**
TYPE: SEMI-GLOSS
COLOUR: TBD
- P6 CEILING**
TYPE: FLAT
COLOUR: TBD

CEILING FINISH

- C1 GYPSUM, SMOOTH FINISH**
PAINT FINISH: P6

NOTE:
CONTRACTOR TO COORDINATE TO EXTEND SUBSTRATES AS REQUIRED TO ACHIEVE CONTINUOUS WALL FINISH.

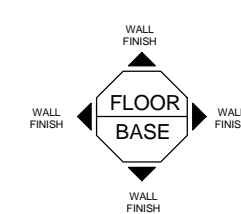

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5	2016-12-08	ISSUED FOR BUILDING PERMIT		
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3	2016-06-14	ISSUED FOR 66% REVIEW		
2	2016-05-09	ISSUED FOR 33% REVIEW		
1	2016-05-06	DEVELOPMENT PERMIT REVIEW		

Revision / Revision	
A detail number numero de detail	
B source drawing no. de dessin no.	
C detail on drawing no. detail sur dessin no.	

Consultant's Name Nom de l'expert-conseil	Eng. Stamp Sceau de l'ingénieur
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Client Services Team Southern Alberta Operations Branch	Le Client Entretien l'Équipe Alberta Méridionale Branche d'Opérations

Canada

Client/client	Parks Canada Agency	L'Agence Parcs Canada
	Western and Northern Region	Ouest et Nord du Canada

Project title/Titre du projet
**Staff Housing Phase 2
Waterton Lakes National Park**

Drawing title/Titre du dessin
**ENLARGED FLOOR-FINISHES
PLAN - BASEMENT
LEVEL-EAST**

Surveyed by/Arpenté par	Drawn by/Dessiné par	Date/Date
	MP/AG	2016-12-08
Designed by/Concept par	Reviewed by/Revisé par	Scale/Echelle
LS/FVR	LS/FVR	1:50

PWGSC Project Manager/Administrateur de Projets TPSCG
Randy Boldt

Client Acceptance/Acceptation du client	Approved by/Approuvé par

Task Responsible/Officer/Agent Responsable

Project No./No. du projet

Asset No./No. du bien


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Drawing Reference No./No. de référence du dessin

A212

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Sheet Size: ISO B1 - 707x1000mm



FINISH SCHEDULE

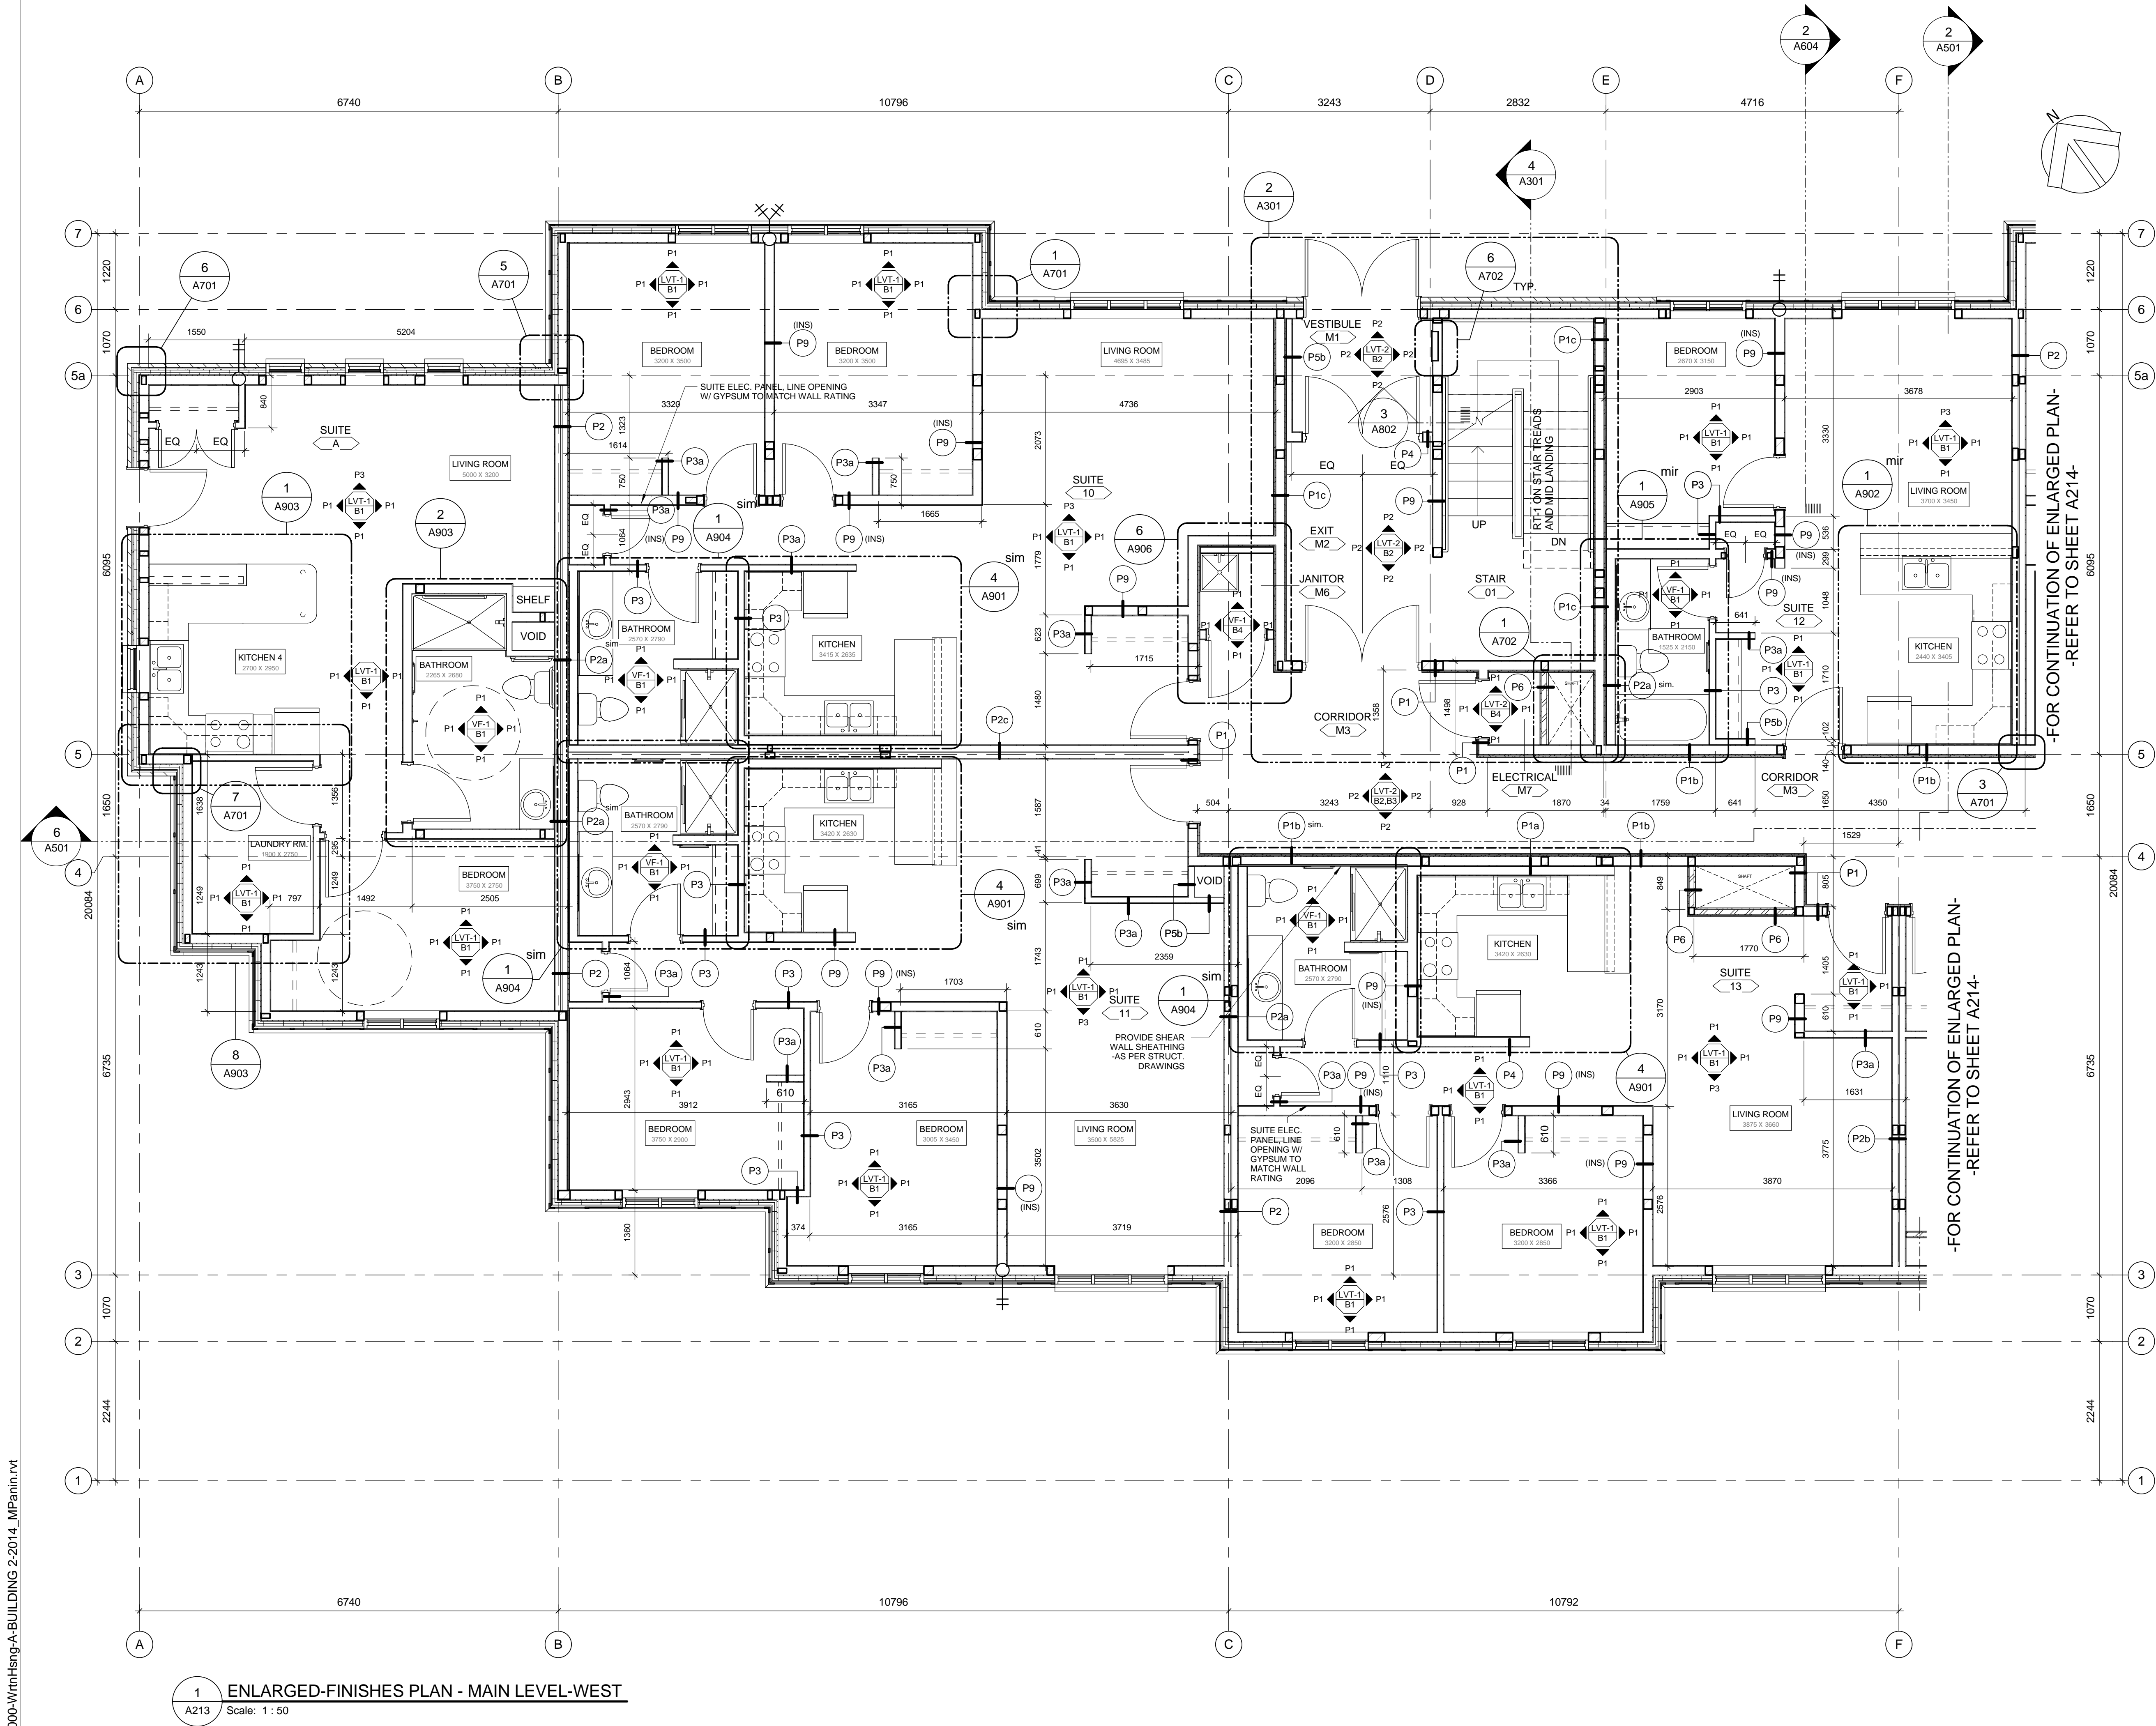FLOOR FINISHES

- LVT-1 RESILIENT FLOORING - TYPE 1**
PRODUCT: LUXURY VINYL PLANK
COLOUR: LIGHT BROWN, WOOD LOOK
- LVT-2 RESILIENT FLOORING - TYPE 2**
PRODUCT: LUXURY VINYL PLANK
COLOUR: LIGHT BEIGE, WOOD LOOK
- VF-1 RESILIENT FLOORING - TYPE 3**
PRODUCT: VINYL SHEET FLOORING
COLOUR: TBD
- RT-1 RESILIENT FLOORING - TYPE 4**
PRODUCT: RUBBER TREADS & MATCHING
RUBBER TILE MID LANDING
COLOUR: TBD
- SC-1 SEALED CONCRETE FLOOR**

BASE

- B1 WALL BASE - UNITS**
PRODUCT: 100mm x 12.9mm MDF TRIM, PRIMED & PAINTED
COLOUR: P5
- B2 WALL BASE**
PRODUCT: 140mm x 12.9mm MDF TRIM, PRIMED & PAINTED
COLOUR: P4
- B3 WALL "CHAIR" RAIL @ 1000mm A.F.F.**
PRODUCT: 100mm X 12.9mm MDF TRIM, PRIMED & PAINTED
COLOUR: P4
- B4 RUBBER BASE**
PRODUCT: RUBBER BASE
COLOUR: GREY

WALL FINISHES

- WT-1 WALL TILE - BACKPLASH/SHOWER SURROUND**
PRODUCT: CERAMIC TILE: 150mm x 150mm
COLOUR: WHITE
- NO FINISH**


PAINT COLOURS

- P1 PAINT COLOUR 1 - UNITS**
TYPE: EGGSHELL
COLOUR: TBD
- P2 PAINT COLOUR 2 - CORRIDORS**
TYPE: EGGSHELL
COLOUR: TBD
- P3 PAINT COLOUR 3 - ACCENT - UNITS**
TYPE: EGGSHELL
COLOUR: TBD
- P4 PAINT COLOUR 4 - TRIM - UNITS**
TYPE: SEMI-GLOSS
COLOUR: TBD
- P5 PAINT COLOUR 4 - DOORS & TRIM - CORRIDOR**
TYPE: SEMI-GLOSS
COLOUR: TBD
- P6 CEILING**
TYPE: FLAT
COLOUR: TBD


CEILING FINISH

- C1 GYPSUM, SMOOTH FINISH**
PAINT FINISH: P6

NOTE:
CONTRACTOR TO COORDINATE TO EXTEND SUBSTRATES AS REQUIRED
TO ACHIEVE CONTINUOUS WALL FINISH.

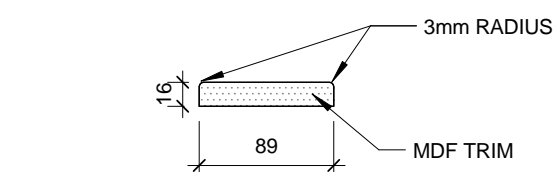

2 WINDOW / DOOR TRIM
A213 Scale: 1:5

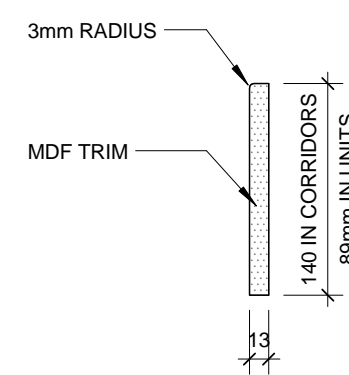

3 WALL BASE
A213 Scale: 1:5

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3	2016-06-14	ISSUED FOR 66% REVIEW		
2	2016-05-09	ISSUED FOR 33% REVIEW		
1	2016-05-06	DEVELOPMENT PERMIT REVIEW		

Revision / Revision	
A detail number numero de detail	
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C detail on drawing no. detail sur dessin no.	

Consultant's Name
Nom de l'expert-consult

IBI GROUP
Suite 500 - 611 Meredith Road NE
Calgary, Alberta T2E 2W5
T: (403) 270-5600 F: (403) 270-5610
ibigroup.com

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Canada

Travaux publics et
Services gouvernementaux
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Client Services Team
Southern Alberta
Operations Branch

Le Client Entretien l'Équipe
Alberta Méridionale
Branche d'Opérations

Canada

Client/client
Parks Canada
Agence

Western and
Northern Region

Ouest et Nord
du Canada

Project title/Titre du projet
**Staff Housing Phase 2
Waterton Lakes National
Park**

Drawing title/Titre du dessin
**ENLARGED FLOOR-FINISHES
PLAN - MAIN LEVEL-WEST**

Surveyed by/Arpenté par LS/FVR	Drawn by/Dessiné par MPI/AG	Date/Date 2016-12-08
Designed by/Concept par LS/FVR	Reviewed by/Revisé par LS/FVR	Scale/Echelle As indicated


PWGSC Project Manager/Administrateur de Projets TPSCGC
Randy Boldt

Client Acceptance/Acceptation du client
Approved by/Approuvé par

Task Responsible/Officer/Agent Responsable
PWGSC Project Manager/Administrateur de Projets TPSCGC

Project No./No. du projet 39000	Asset No./No. du bien Fil # 945	Sheet No./ No. de la feuille A213
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Drawing Reference No./No. de référence du dessin

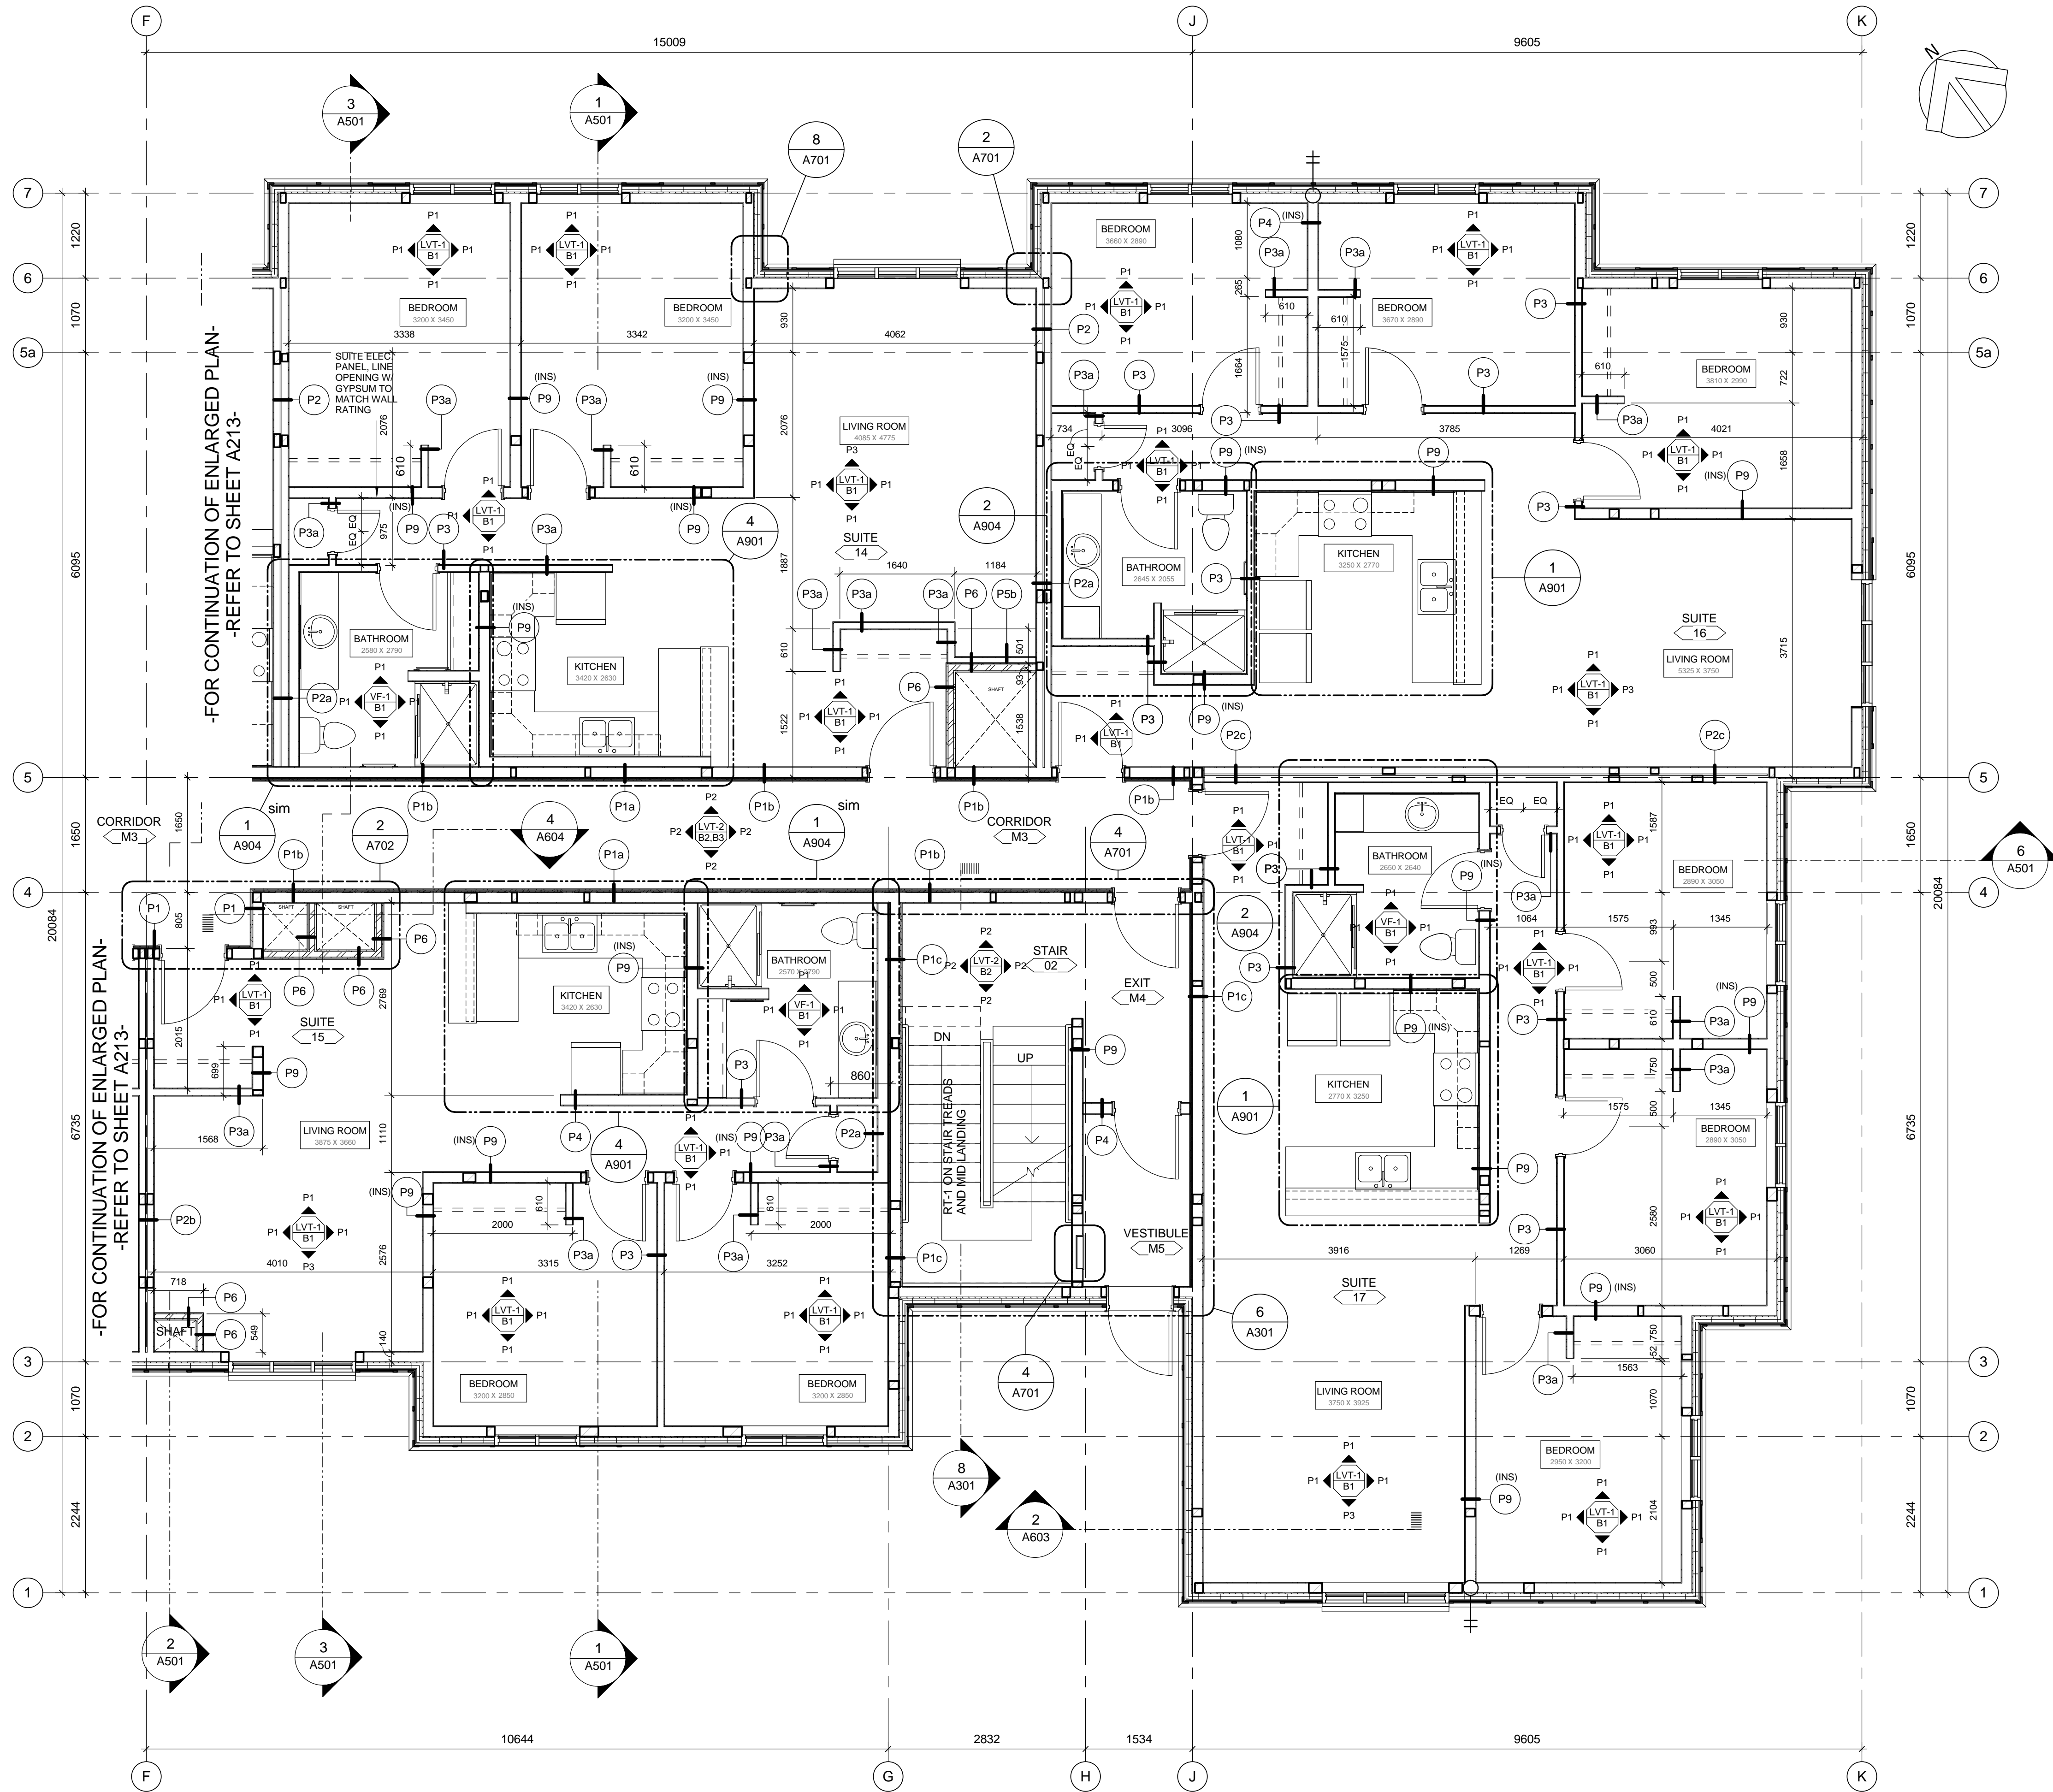

1 ENLARGED-FINISHES PLAN - MAIN LEVEL-EAST
Scale: 1 : 50

FINISH SCHEDULE

FLOOR FINISHES

- LVT-1 RESILIENT FLOORING - TYPE 1**
PRODUCT: LUXURY VINYL PLANK
COLOUR: LIGHT BROWN, WOOD LOOK
- LVT-2 RESILIENT FLOORING - TYPE 2**
PRODUCT: LUXURY VINYL PLANK
COLOUR: LIGHT BEIGE, WOOD LOOK
- VF-1 RESILIENT FLOORING - TYPE 3**
PRODUCT: VINYL SHEET FLOORING
COLOUR: TBD
- RT-1 RESILIENT FLOORING - TYPE 4**
PRODUCT: RUBBER TREADS & MATCHING
RUBBER TILE MID LANDING
COLOUR: TBD
- SC-1 SEALED CONCRETE FLOOR**

BASE

- B1 WALL BASE - UNITS**
PRODUCT: 100mm x 12.9mm MDF TRIM, PRIMED & PAINTED
COLOUR: P5
- B2 WALL BASE**
PRODUCT: 140mm x 12.9mm MDF TRIM, PRIMED & PAINTED
COLOUR: P4
- B3 WALL "CHAIR" RAIL @ 1000mm A.F.F.**
PRODUCT: 100mm X 12.9mm MDF TRIM, PRIMED & PAINTED
COLOUR: P4
- B4 RUBBER BASE**
PRODUCT: RUBBER BASE
COLOUR: GREY

WALL FINISHES

- WT-1 WALL TILE - BACKPLASH/SHOWER SURROUND**
PRODUCT: CERAMIC TILE: 150mm x 150mm
COLOUR: WHITE
- NO FINISH**

PAINT COLOURS


- P1 PAINT COLOUR 1 - UNITS**
TYPE: EGGSHELL
COLOUR: TBD
- P2 PAINT COLOUR 2 - CORRIDORS**
TYPE: EGGSHELL
COLOUR: TBD
- P3 PAINT COLOUR 3 - ACCENT - UNITS**
TYPE: EGGSHELL
COLOUR: TBD
- P4 PAINT COLOUR 4 - TRIM - UNITS**
TYPE: SEMI-GLOSS
COLOUR: TBD
- P5 PAINT COLOUR 4 - DOORS & TRIM - CORRIDOR**
TYPE: SEMI-GLOSS
COLOUR: TBD
- P6 CEILING:**
TYPE: FLAT
COLOUR: TBD

CEILING FINISH

- C1 GYPSUM, SMOOTH FINISH**
PAINT FINISH: P6

NOTE:
FOR WINDOW / DOOR TRIM AND
WALL BASE DETAILS REFER TO SHEET A213

NOTE:
CONTRACTOR TO COORDINATE TO EXTEND SUBSTRATES AS REQUIRED
TO ACHIEVE CONTINUOUS WALL FINISH.

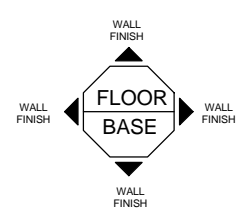

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6	2016-12-08	ISSUED FOR TENDER		
5	2016-12-08	ISSUED FOR BUILDING PERMIT		
4	2016-09-02	ISSUED FOR 99% REVIEW		
3	2016-06-14	ISSUED FOR 66% REVIEW		
2	2016-05-09	ISSUED FOR 33% REVIEW		
1	2016-05-06	DEVELOPMENT PERMIT REVIEW		

Revision / Revision	
A detail number numéro de détail	A
B source drawing no. de dessin no.	B
C detail on drawing no. détail sur dessin no.	C

Consultant's Name Nom de l'expert-conseil	IBI GROUP Suite 500 - 611 Meredith Road NE Calgary, Alberta T2E 2W5 T: (403) 270-5600 F: (403) 270-5610 ibigroup.com	Eng. Stamp Sceau de l'ingénieur
--	--	------------------------------------

Public Works and Government Services Canada	Travaux publics et Services gouvernementaux Canada
Client Services Team Southern Alberta Operations Branch	Le Client Entretien l'Équipe Alberta Méridionale Branche d'Opérations

Canada

Client/client	Parks Canada Agence	L'Agence Parcs Canada
	Western and Northern Region	Ouest et Nord du Canada

Project title/Titre du projet
**Staff Housing Phase 2
Waterton Lakes National
Park**

Drawing title/Titre du dessin
**ENLARGED FLOOR-FINISHES
PLAN - MAIN LEVEL-EAST**

Surveyed by/Arpenté par LS/FVR	Drawn by/Dessiné par MPI/AG	Date/Date 2016-12-08
Designed by/Concept par LS/FVR	Reviewed by/Revisé par LS/FVR	Scale/Echelle 1:50

PWGSC Project Manager/Administrateur de Projets TPSPCC

Randy Boldt

Client Acceptance/Acceptation du client

Approved by/Approuvé par

Task Responsible/Responsable de la tâche

Project No./No. du projet

Asset No./No. du bien


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No. de la feuille

Drawing Reference No./No. de référence du dessin

A214


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Sheet Size: ISO B1 - 707x1000mm

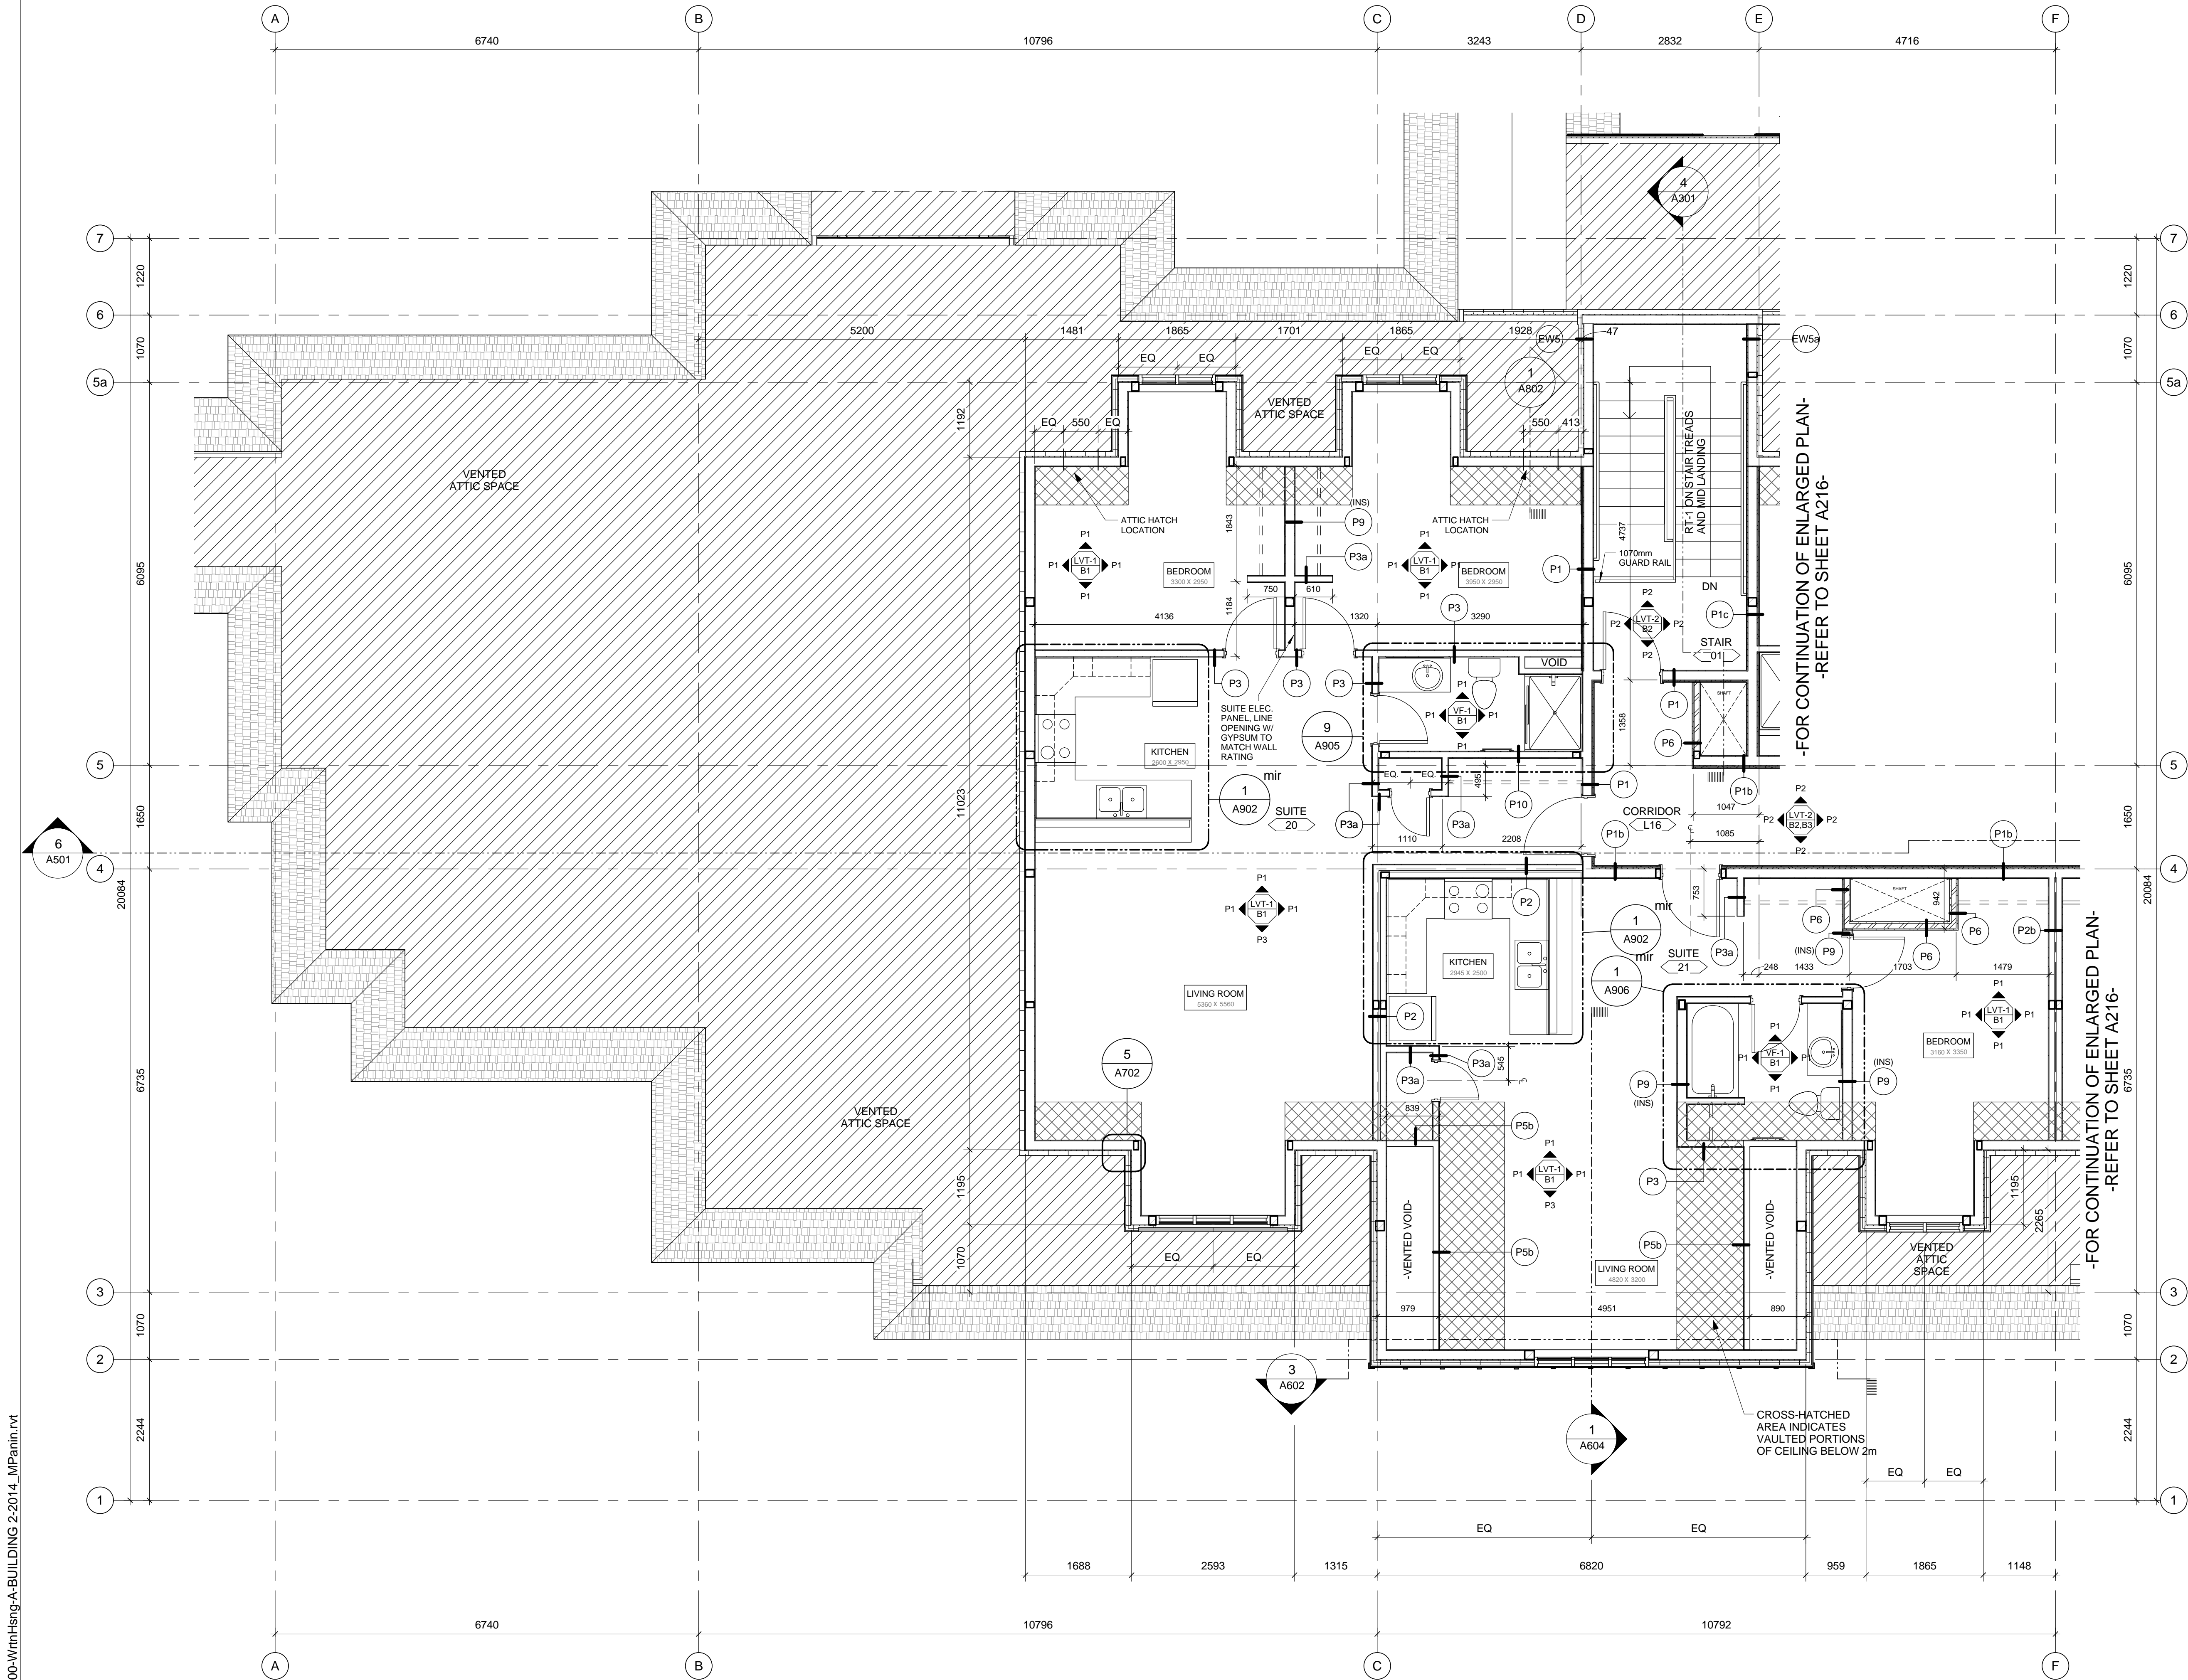

1 ENLARGED-FINISHES PLAN - LOFT LEVEL-WEST
A215 Scale: 1 : 50

FINISH SCHEDULE

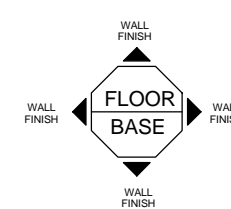

FLOOR FINISHES

- LVT-1 RESILIENT FLOORING - TYPE 1**
PRODUCT: LUXURY VINYL PLANK
COLOUR: LIGHT BROWN, WOOD LOOK
- LVT-2 RESILIENT FLOORING - TYPE 2**
PRODUCT: LUXURY VINYL PLANK
COLOUR: LIGHT BEIGE, WOOD LOOK
- VF-1 RESILIENT FLOORING - TYPE 3**
PRODUCT: VINYL SHEET FLOORING
COLOUR: TBD
- RT-1 RESILIENT FLOORING - TYPE 4**
PRODUCT: RUBBER TREADS & MATCHING RUBBER TILE MID LANDING
COLOUR: TBD
- SC-1 SEALED CONCRETE FLOOR**

BASE

- B1 WALL BASE - UNITS**
PRODUCT: 100mm x 12.9mm MDF TRIM, PRIMED & PAINTED
COLOUR: P5
- B2 WALL BASE**
PRODUCT: 140mm x 12.9mm MDF TRIM, PRIMED & PAINTED
COLOUR: P4
- B3 WALL "CHAIR" RAIL @ 1000mm A.F.F.**
PRODUCT: 100mm X 12.9mm MDF TRIM, PRIMED & PAINTED
COLOUR: P4
- B4 RUBBER BASE**
PRODUCT: RUBBER BASE
COLOUR: GREY

WALL FINISHES

- WT-1 WALL TILE - BACKPLASH/SHOWER SURROUND**
PRODUCT: CERAMIC TILE: 150mm x 150mm
COLOUR: WHITE
- NO FINISH**

PAINT COLOURS

- P1 PAINT COLOUR 1 - UNITS**
TYPE: EGGSHELL
COLOUR: TBD
- P2 PAINT COLOUR 2 - CORRIDORS**
TYPE: EGGSHELL
COLOUR: TBD
- P3 PAINT COLOUR 3 - ACCENT - UNITS**
TYPE: EGGSHELL
COLOUR: TBD
- P4 PAINT COLOUR 4 - TRIM - UNITS**
TYPE: SEMI-GLOSS
COLOUR: TBD
- P5 PAINT COLOUR 4 - DOORS & TRIM - CORRIDOR**
TYPE: SEMI-GLOSS
COLOUR: TBD
- P6 CEILING**
TYPE: FLAT
COLOUR: TBD

CEILING FINISH

- C1 GYPSUM, SMOOTH FINISH**
PAINT FINISH: P5

NOTE:
FOR WINDOW / DOOR TRIM AND
WALL BASE DETAILS REFER TO SHEET A213

NOTE:
CONTRACTOR TO COORDINATE TO EXTEND SUBSTRATES AS REQUIRED
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2	2016-05-09	ISSUED FOR 33% REVIEW		
1	2016-05-06	DEVELOPMENT PERMIT REVIEW		

Revision / Revision	
A	detail number numéro de détail
B	source drawing no. de dessin no.
C	detail on drawing no. détail sur dessin no.

Consultant's Name
Nom de l'expert-consult

IBI GROUP
Suite 500 - 611 Meredith Road NE
Calgary, Alberta T2E 2W5
T: (403) 270-5600 F: (403) 270-5610
ibigroup.com

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Sceau de l'ingénieur

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Government Services
Canada

Travaux publics et
Services gouvernementaux
Canada

Client Services Team
Southern Alberta
Operations Branch

Le Client Entretien l'Équipe
Alberta Méridionale
Branche d'Opérations

Canada

Client/client
Parks Canada
Agence

Western and
Northern Region

L'Agence Parcs
Canada
Ouest et Nord
du Canada

Project title/Titre du projet
**Staff Housing Phase 2
Waterton Lakes National
Park**

Drawing title/Titre du dessin
**ENLARGED FLOOR-FINISHES
PLAN - LOFT LEVEL-WEST**

Surveyed by/Arpenté par LS/FVR	Drawn by/Dessiné par MPI/AG	Date/Date 2016-12-08
Designed by/Concept par LS/FVR	Reviewed by/Revisé par LS/FVR	Scale/Echelle 1:50

PWGC Project Manager/Administrateur de Projets TPSCG

Randy Boldt

Client Acceptance/Acceptation du client

Approved by/Approuvé par

Task Responsible Officer/Agent Responsable

Task Responsible Officer/Agent Responsable


Project No./No. du projet
39000

Asset No./No. du bien
Fil # 945

Sheet No./
No. de la feuille
A215

Drawing Reference No./No. de référence du dessin

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1 ENLARGED-FINISHES PLAN - LOFT LEVEL-EAST
A216 Scale: 1:50

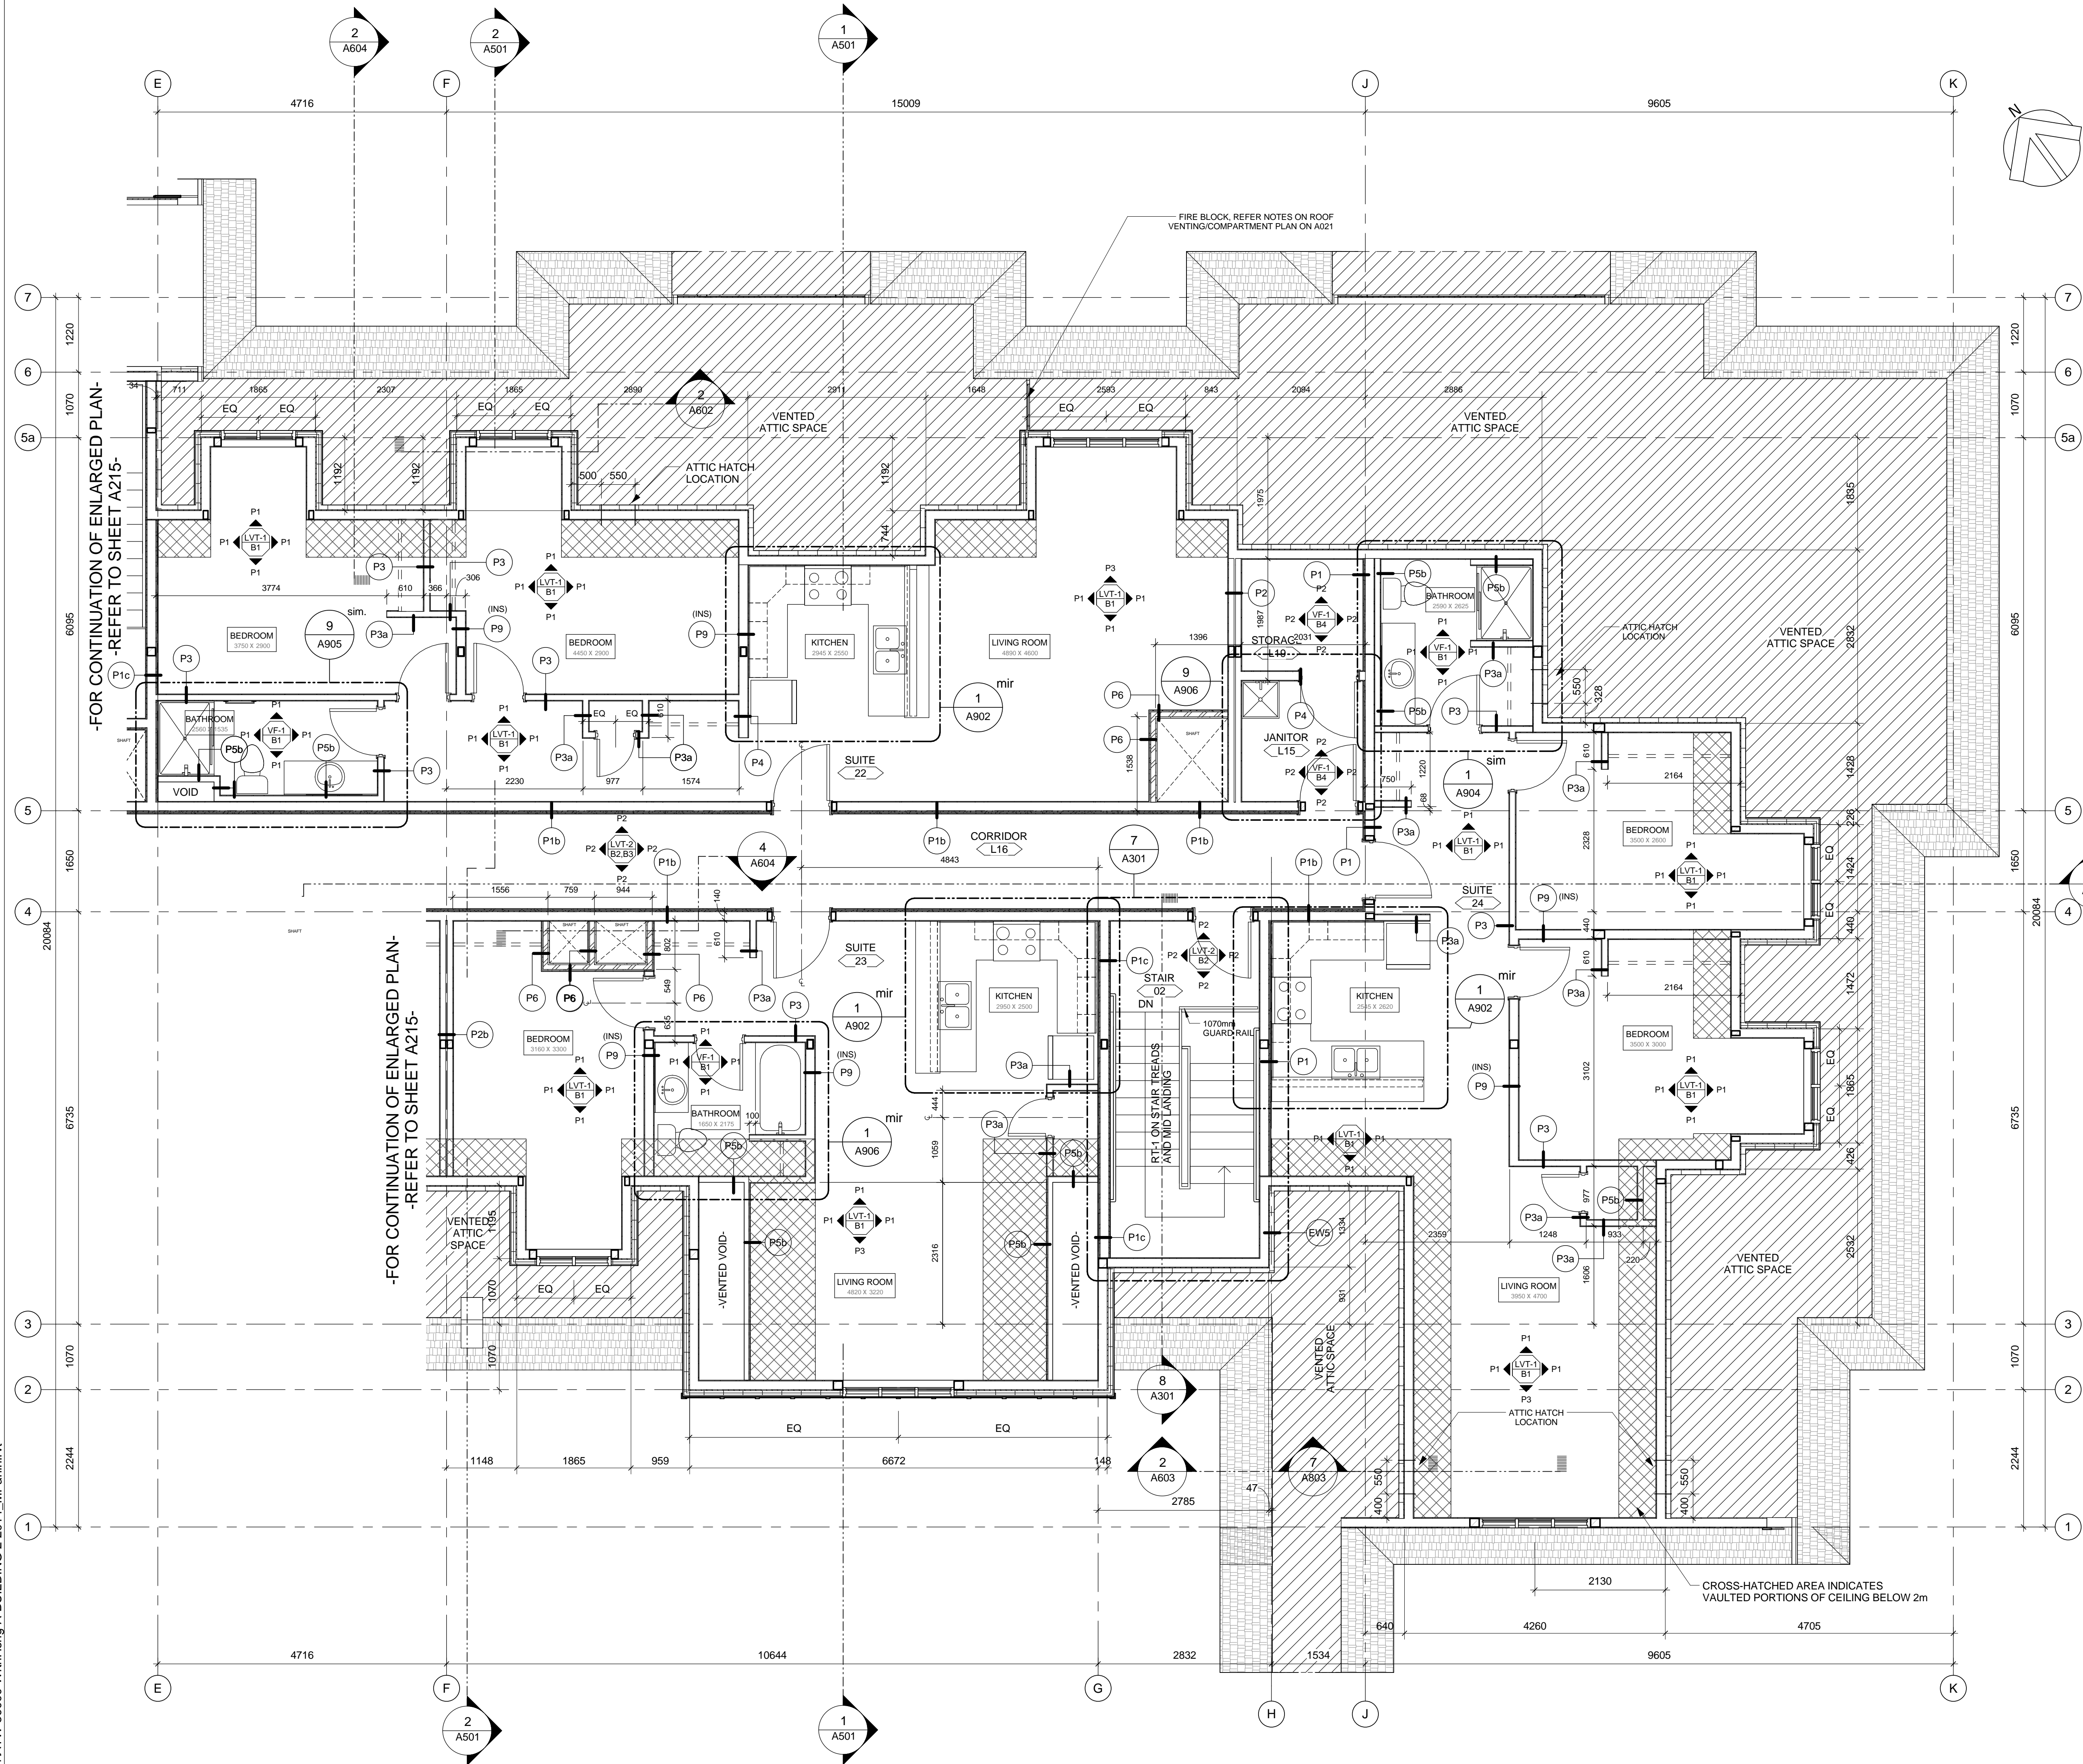FINISH SCHEDULE

FLOOR FINISHES

- LVT-1 RESILIENT FLOORING - TYPE 1**
PRODUCT: LUXURY VINYL PLANK
COLOUR: LIGHT BROWN, WOOD LOOK
- LVT-2 RESILIENT FLOORING - TYPE 2**
PRODUCT: LUXURY VINYL PLANK
COLOUR: LIGHT BEIGE, WOOD LOOK
- VF-1 RESILIENT FLOORING - TYPE 3**
PRODUCT: VINYL SHEET FLOORING
COLOUR: TBD
- RT-1 RESILIENT FLOORING - TYPE 4**
PRODUCT: RUBBER TREADS & MATCHING
RUBBER TILE MID LANDING
COLOUR: TBD
- SC-1 SEALED CONCRETE FLOOR**

BASE

- B1 WALL BASE - UNITS**
PRODUCT: 100mm x 12.9mm MDF TRIM, PRIMED & PAINTED
COLOUR: P5
- B2 WALL BASE**
PRODUCT: 140mm x 12.9mm MDF TRIM, PRIMED & PAINTED
COLOUR: P4
- B3 WALL "CHAIR" RAIL @ 1000mm A.F.F.**
PRODUCT: 100mm X 12.9mm MDF TRIM, PRIMED & PAINTED
COLOUR: P4
- B4 RUBBER BASE**
PRODUCT: RUBBER BASE
COLOUR: GREY

WALL FINISHES

- WT-1 WALL TILE - BACKSPLASH/SHOWER SURROUND**
PRODUCT: CERAMIC TILE: 150mm x 150mm
COLOUR: WHITE
- NO FINISH**

PAINT COLOURS


- P1 PAINT COLOUR 1 - UNITS**
TYPE: EGGSHELL
COLOUR: TBD
- P2 PAINT COLOUR 2 - CORRIDORS**
TYPE: EGGSHELL
COLOUR: TBD
- P3 PAINT COLOUR 3 - ACCENT - UNITS**
TYPE: EGGSHELL
COLOUR: TBD
- P4 PAINT COLOUR 4 - TRIM - UNITS**
TYPE: SEMI-GLOSS
COLOUR: TBD
- P5 PAINT COLOUR 4 - DOORS & TRIM - CORRIDOR**
TYPE: SEMI-GLOSS
COLOUR: TBD
- P6 CEILING**
TYPE: FLAT
COLOUR: TBD

CEILING FINISH

- C1 GYPSUM, SMOOTH FINISH**
PAINT FINISH: P5

NOTE:
FOR WINDOW / DOOR TRIM AND
WALL BASE DETAILS REFER TO SHEET A213

NOTE:
CONTRACTOR TO COORDINATE TO EXTEND SUBSTRATES AS REQUIRED
TO ACHIEVE CONTINUOUS WALL FINISH.

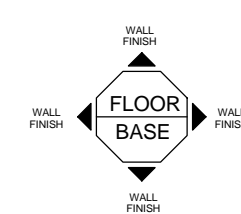

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5	2016-12-08	ISSUED FOR BUILDING PERMIT		
4	2016-09-02	ISSUED FOR 99% REVIEW		
3	2016-06-14	ISSUED FOR 66% REVIEW		
2	2016-05-09	ISSUED FOR 33% REVIEW		
1	2016-05-06	DEVELOPMENT PERMIT REVIEW		

Revision / Revision	
A detail number numero de detail	A
B source drawing no. de dessin no.	B
C detail on drawing no. detail sur dessin no.	C

Consultant's Name Nom de l'expert-conseil	Eng. Stamp Sceau de l'ingénieur
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Client Services Team Southern Alberta Operations Branch	Le Client Entretien l'Équipe Alberta Méridionale Branche d'Opérations

Canada


Client/client Parks Canada Agency	L'Agence Parcs Canada
Western and Northern Region	Ouest et Nord du Canada

Staff Housing Phase 2 Waterton Lakes National Park


ENLARGED FLOOR-FINISHES PLAN - LOFT LEVEL-EAST

Surveyed by/Arpenté par LS/FVR	Drawn by/Dessiné par MPI/AG	Date/Date 2016-12-08
Designed by/Concept par LS/FVR	Reviewed by/Revisé par LS/FVR	Scale/Echelle 1:50
FWGSC Project Manager/Administrateur de Projets TFSGC Randy Boldt		
Client Acceptance/Acceptation du client		Approved by/Approuvé par
Task Responsible/Responsable de la tâche		
Project No./No. du projet 39000	Asset No./No. d'actif Fil # 945	Sheet No./ No. de la feuille A216
Drawing Reference No./No. de référence du dessin		


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1 REFLECTED CEILING PLAN - MAIN LEVEL
A222 Scale: 1 : 100

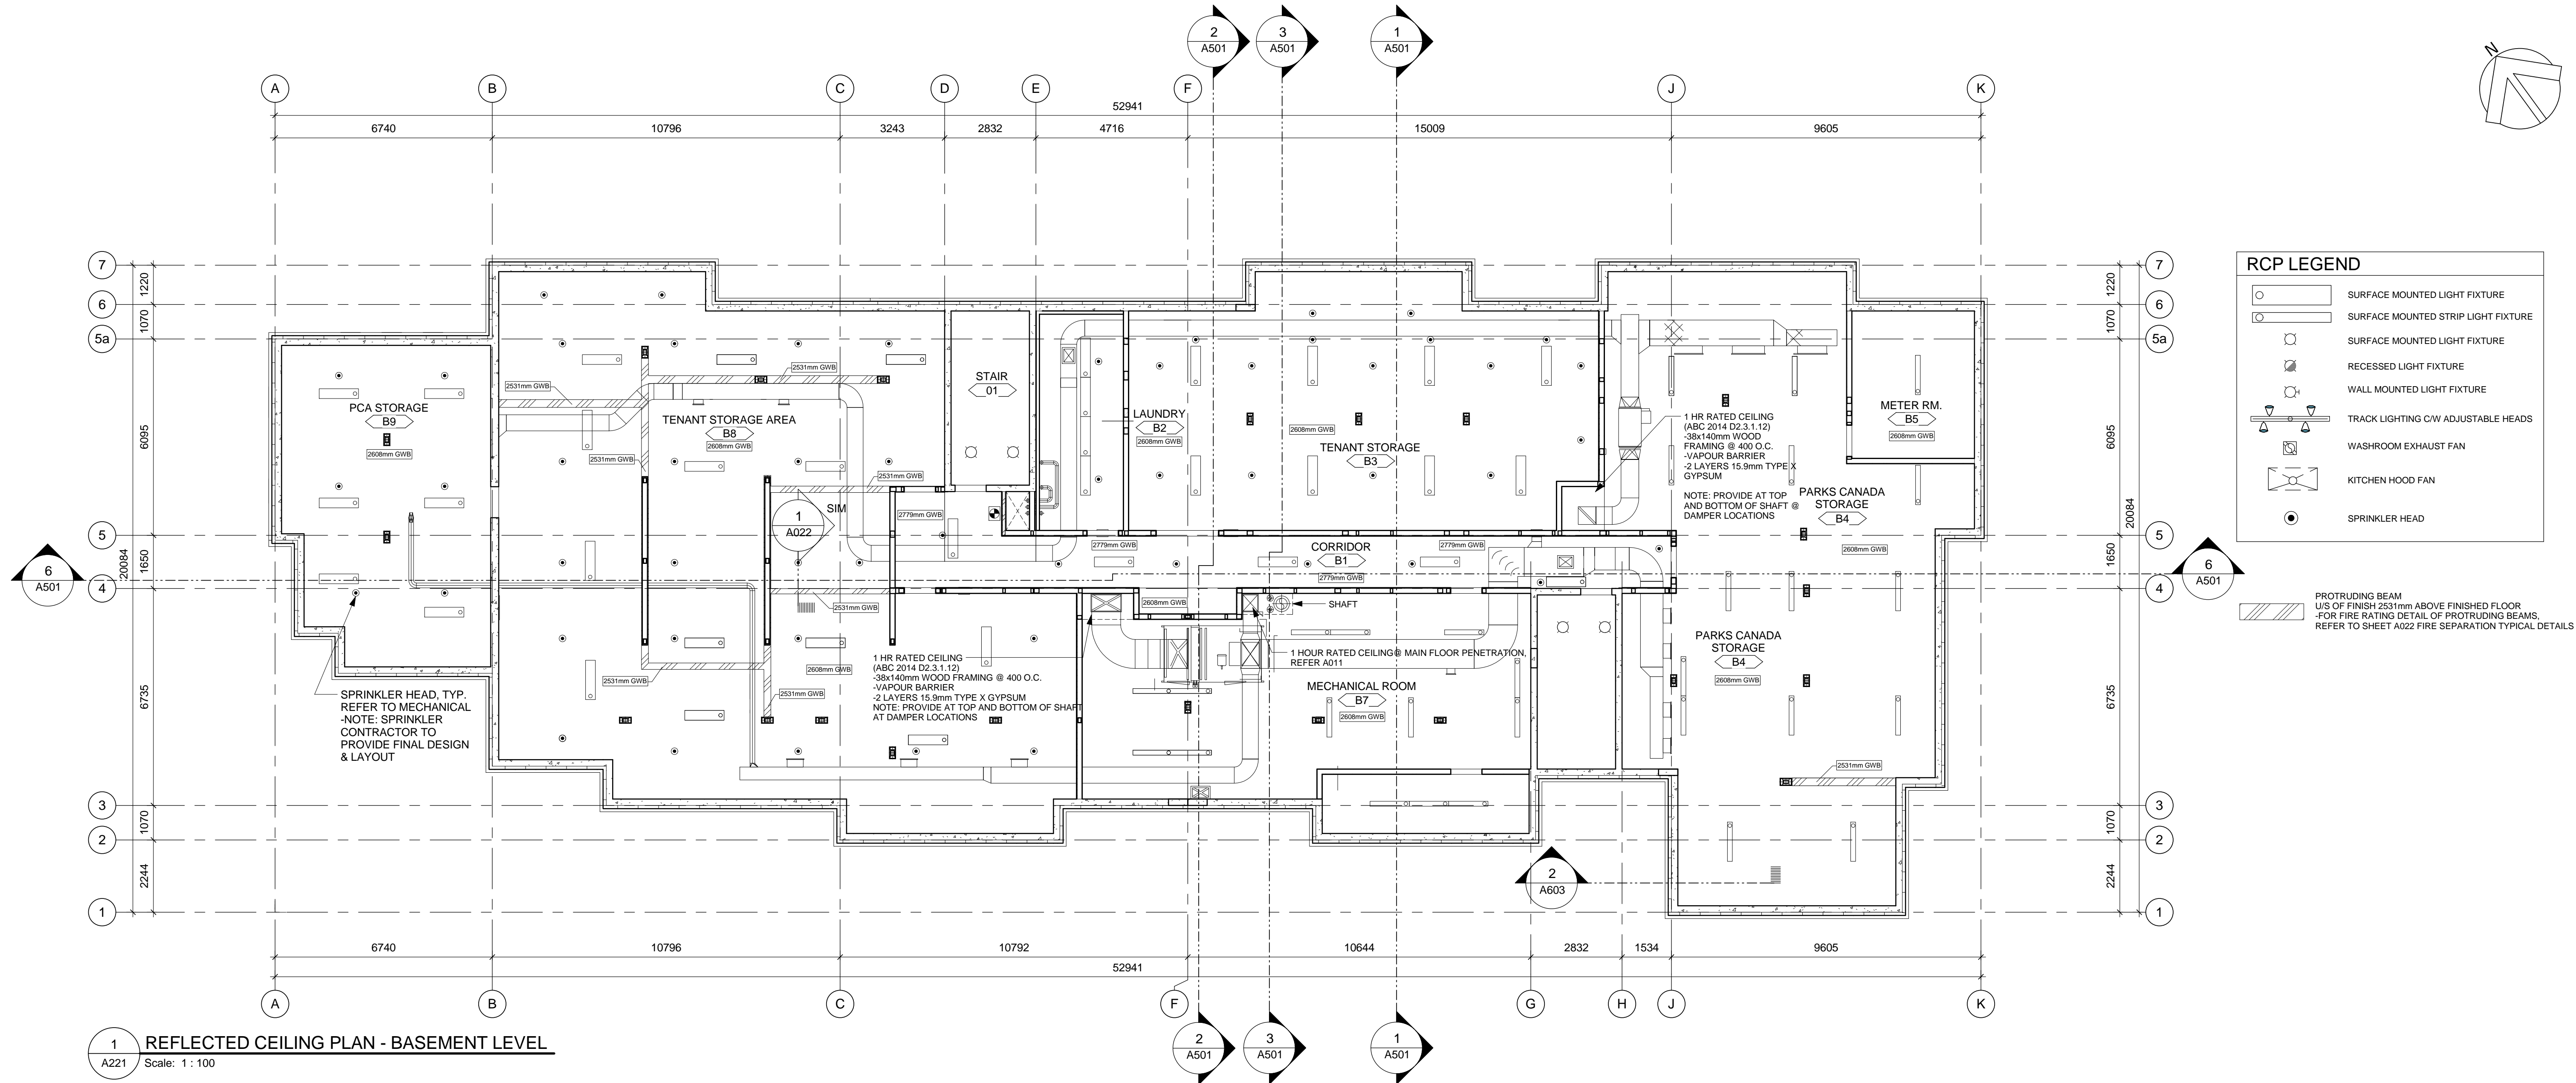

2 REFLECTED CEILING PLAN - LOFT LEVEL
A222 Scale: 1 : 100

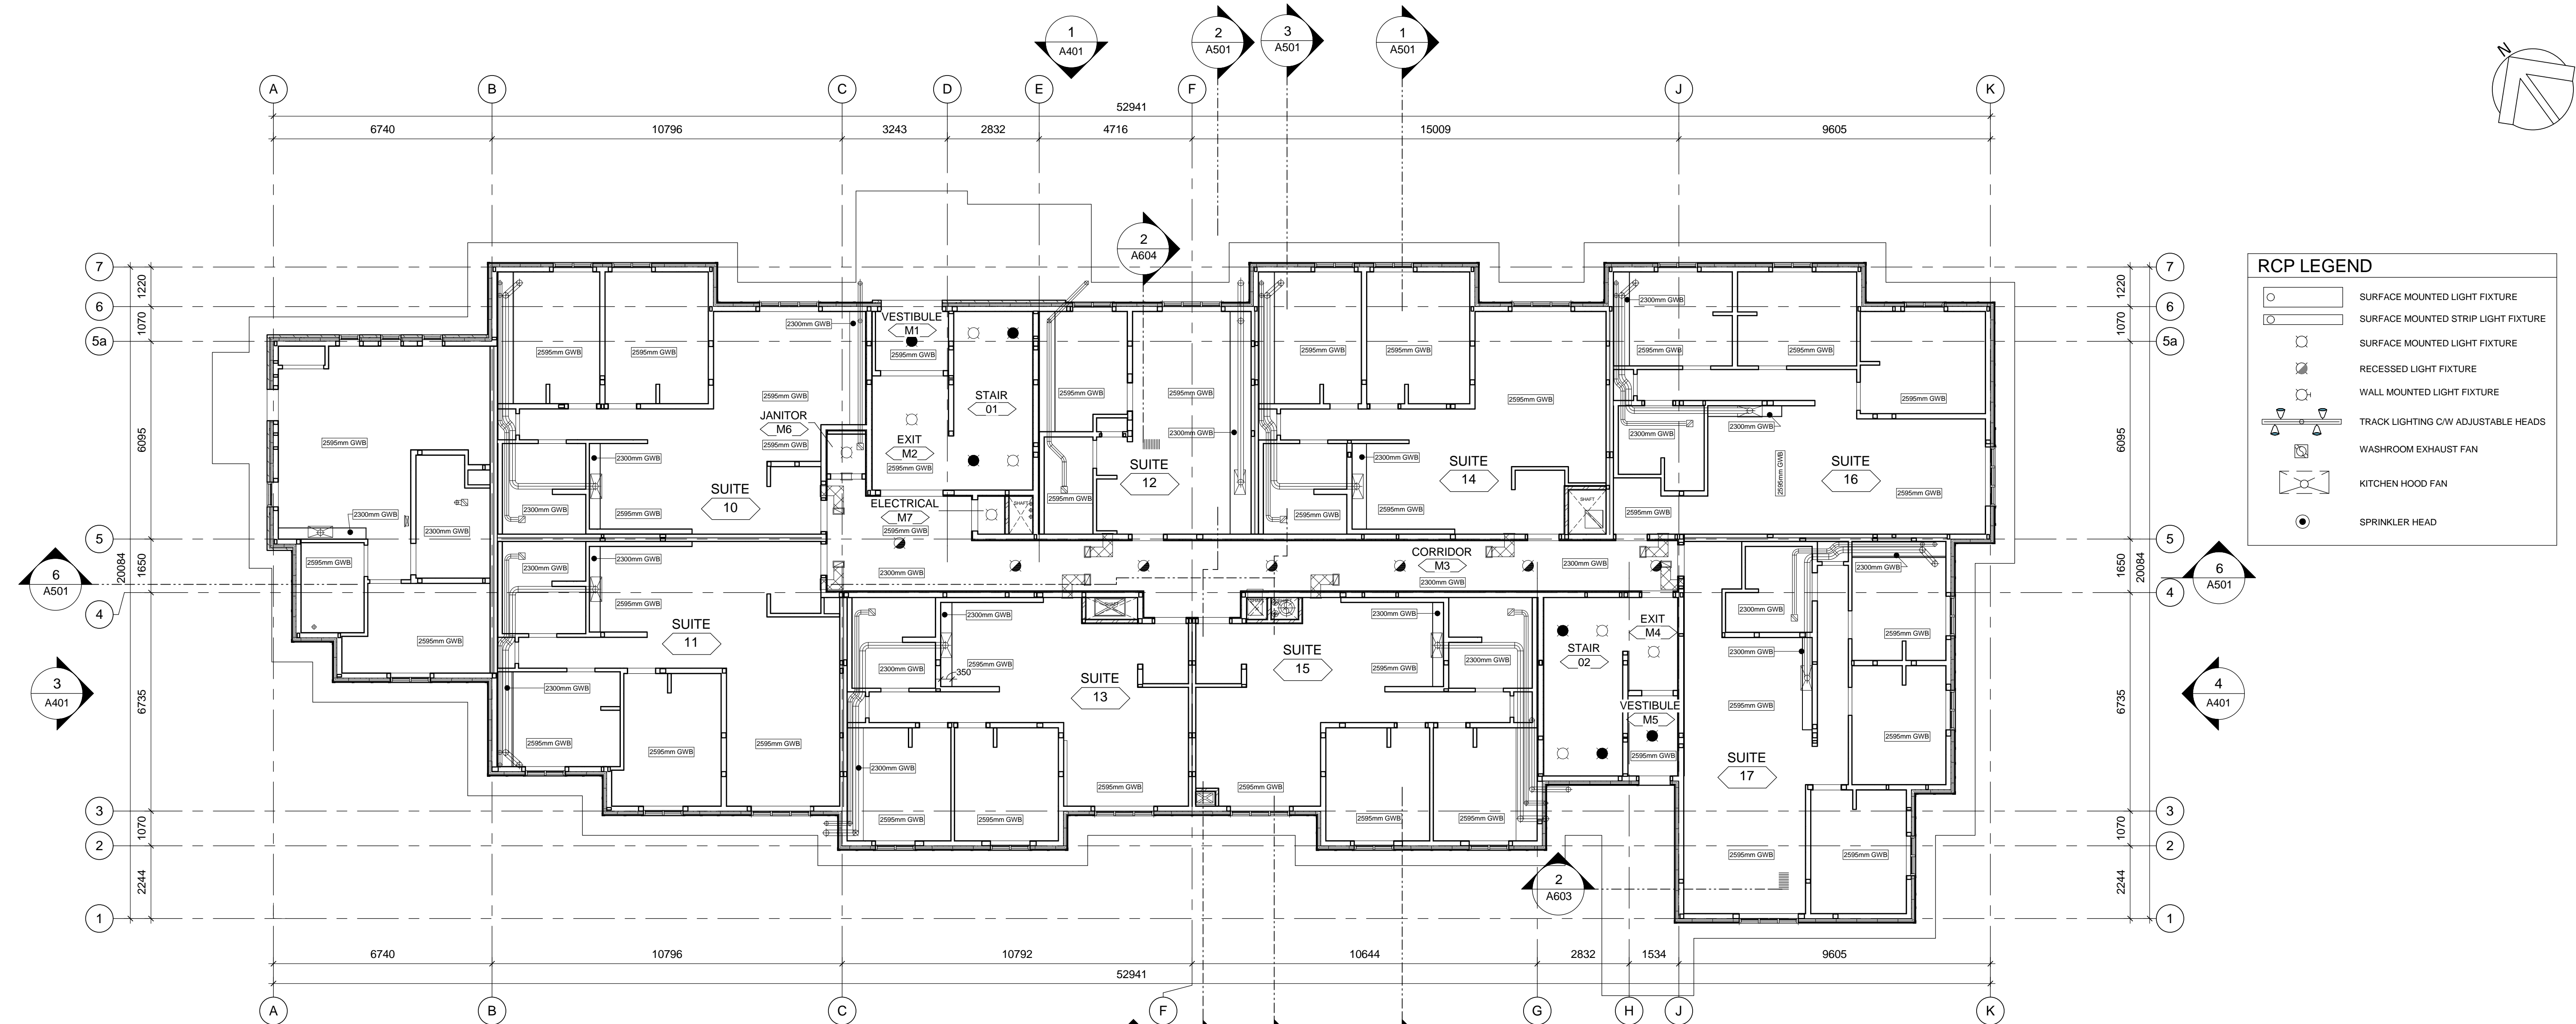RCP LEGEND	
	SURFACE MOUNTED LIGHT FIXTURE
	SURFACE MOUNTED STRIP LIGHT FIXTURE
	RECESSED LIGHT FIXTURE
	WALL MOUNTED LIGHT FIXTURE
	TRACK LIGHTING CW ADJUSTABLE HEADS
	WASHROOM EXHAUST FAN
	KITCHEN HOOD FAN
	SPRINKLER HEAD

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Revision / Revision	
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Consultant's Name Nom de l'expert-conseil	
Eng. Stamp Sceau de l'ingénieur	
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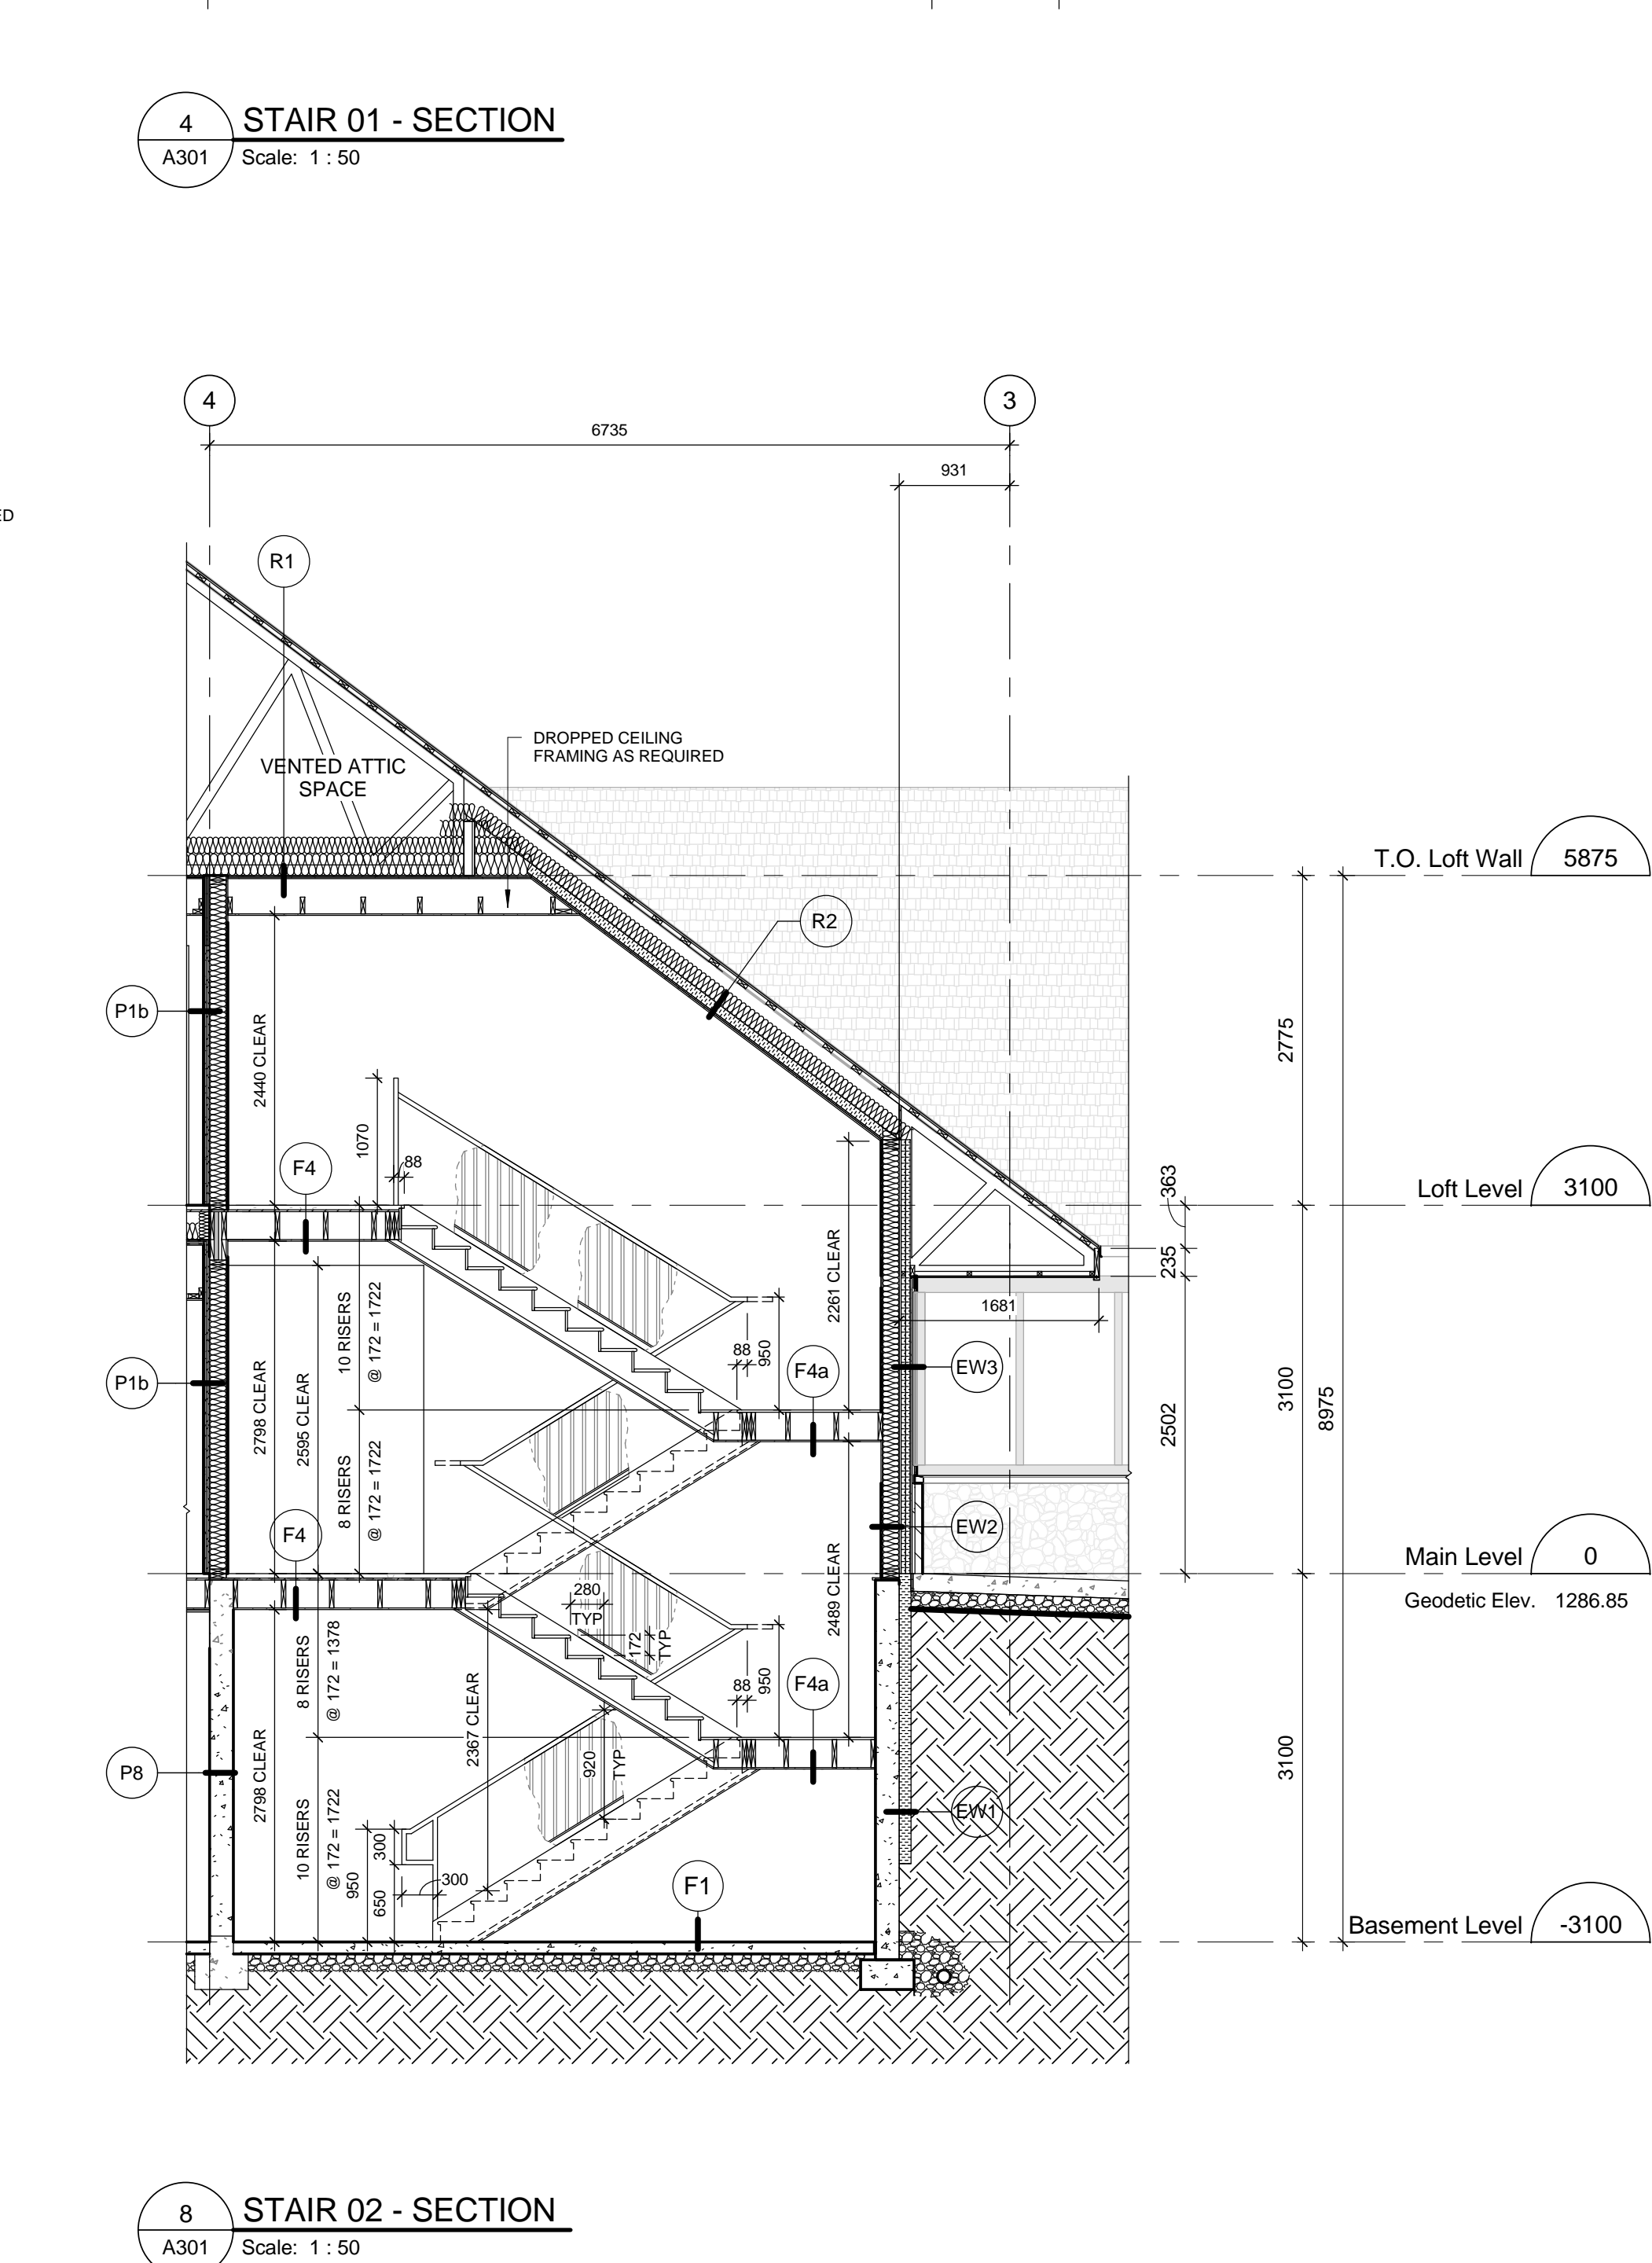
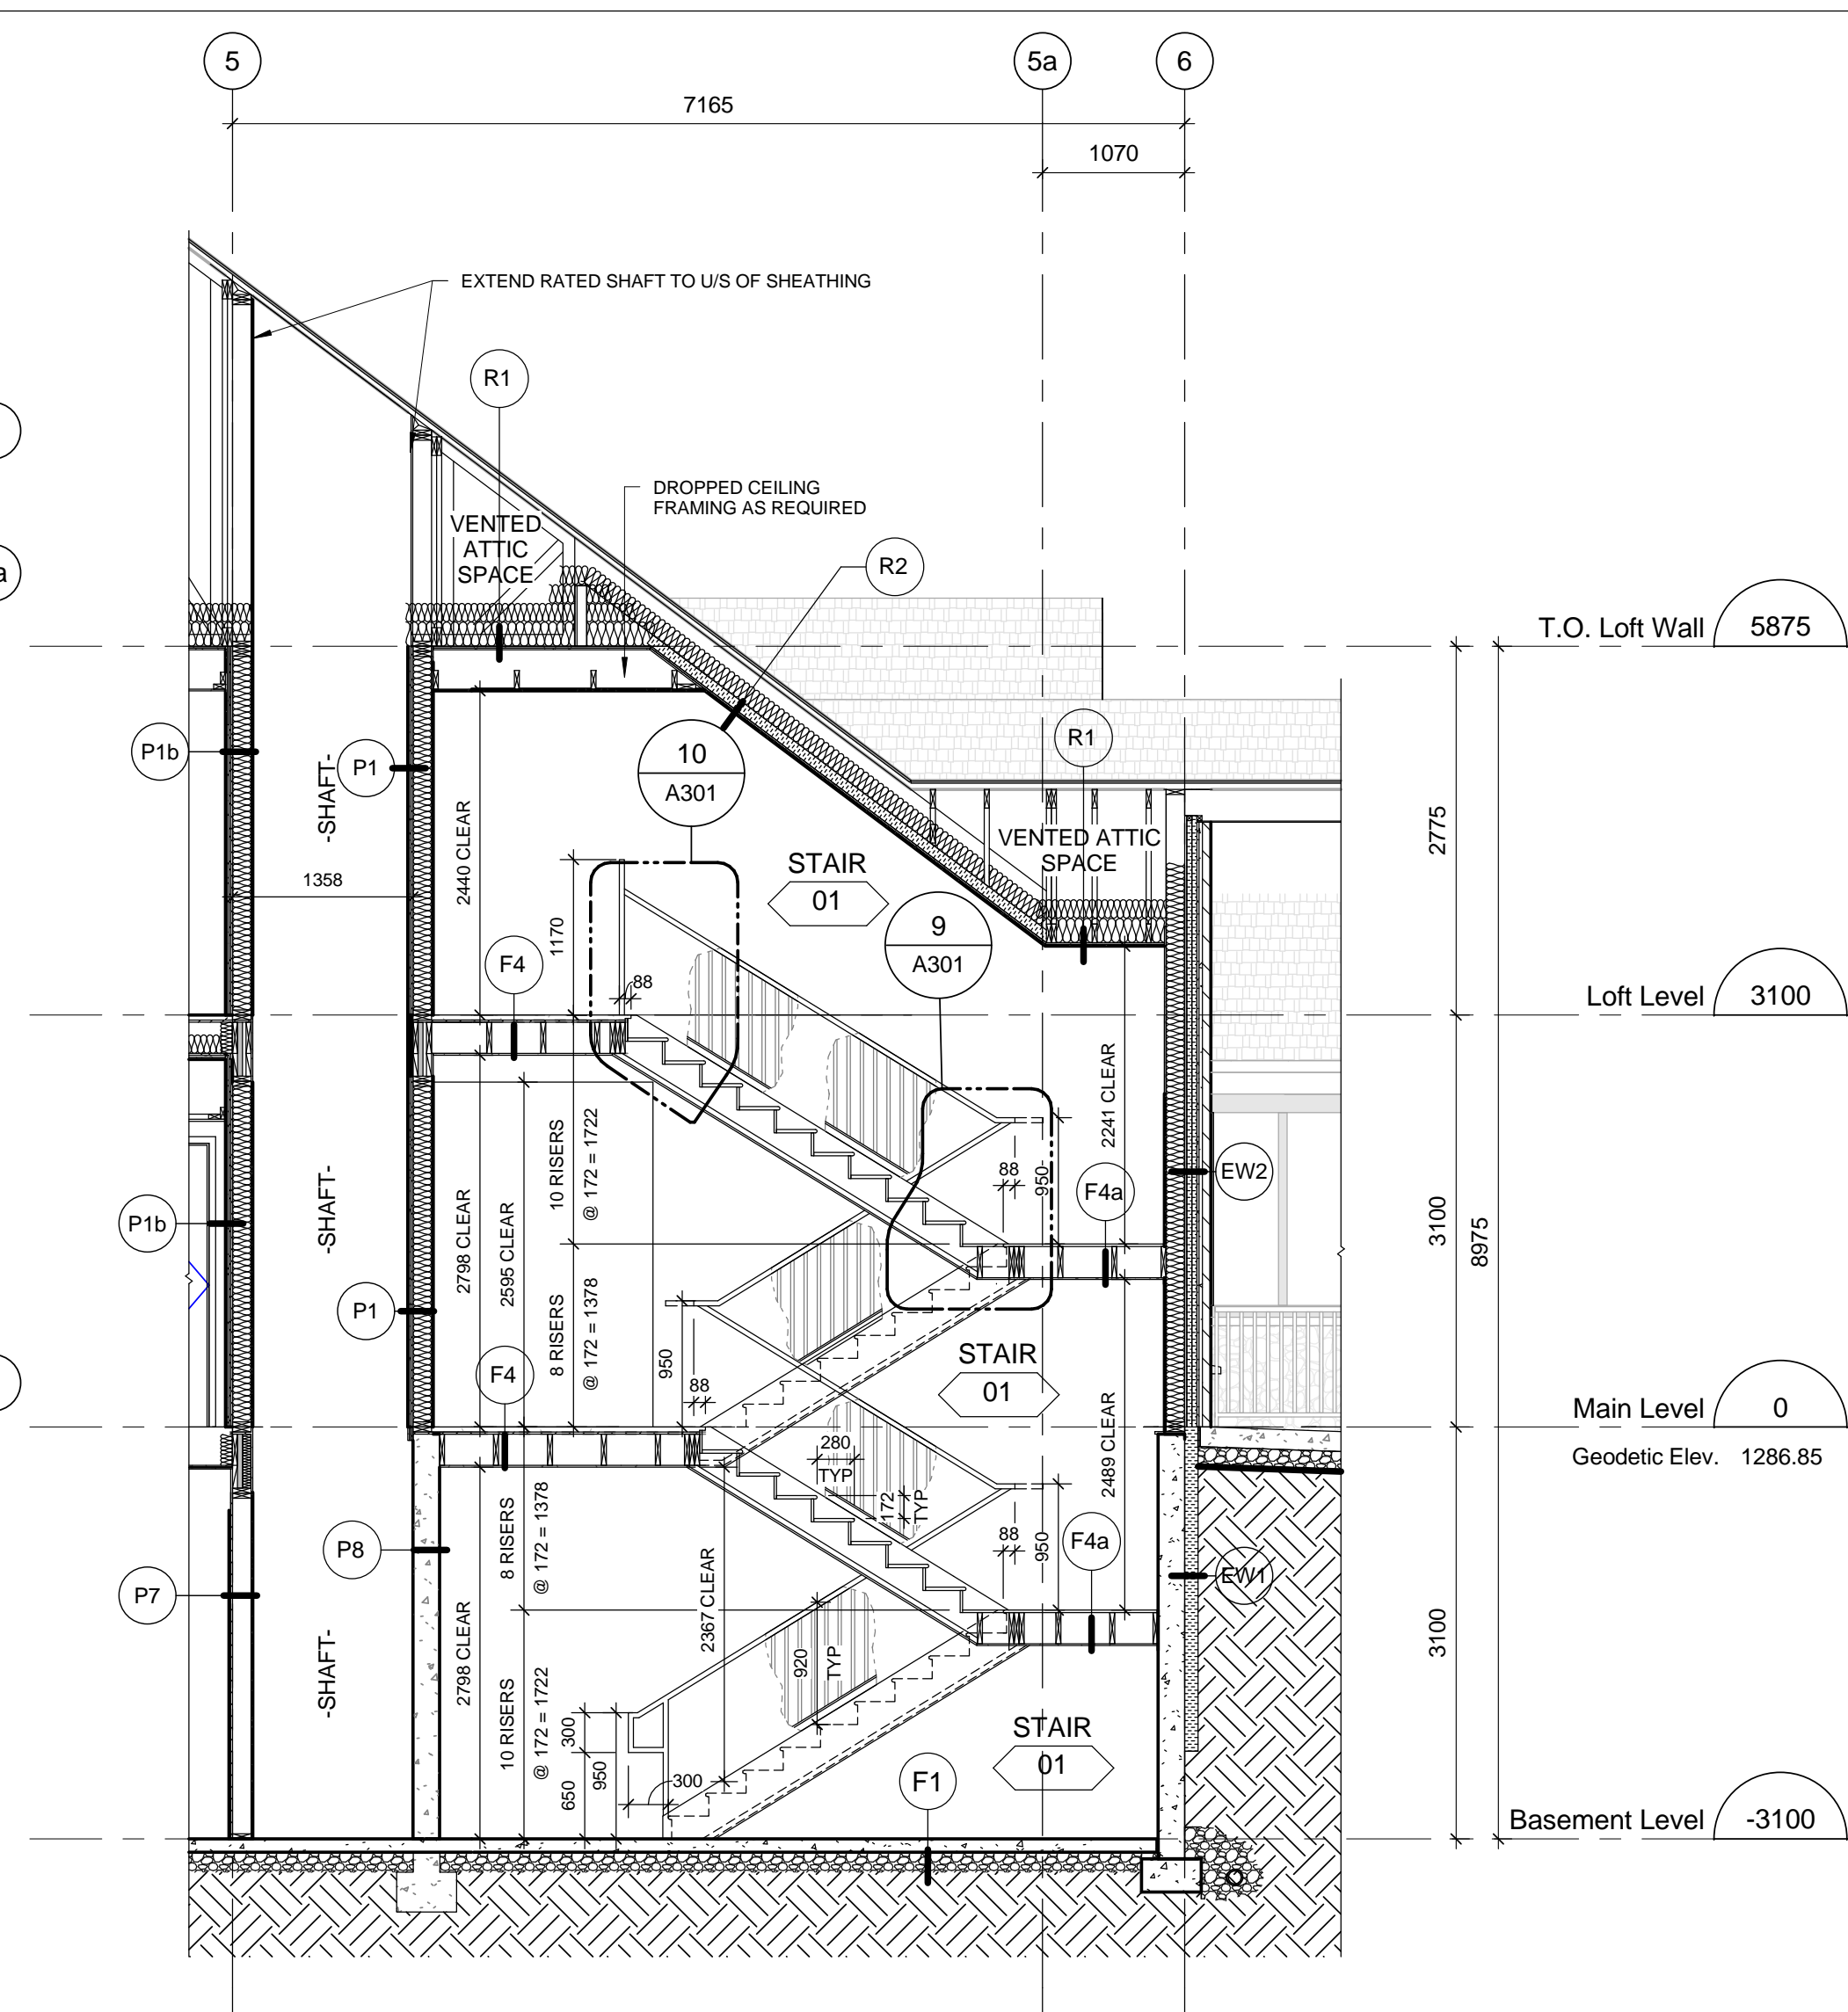
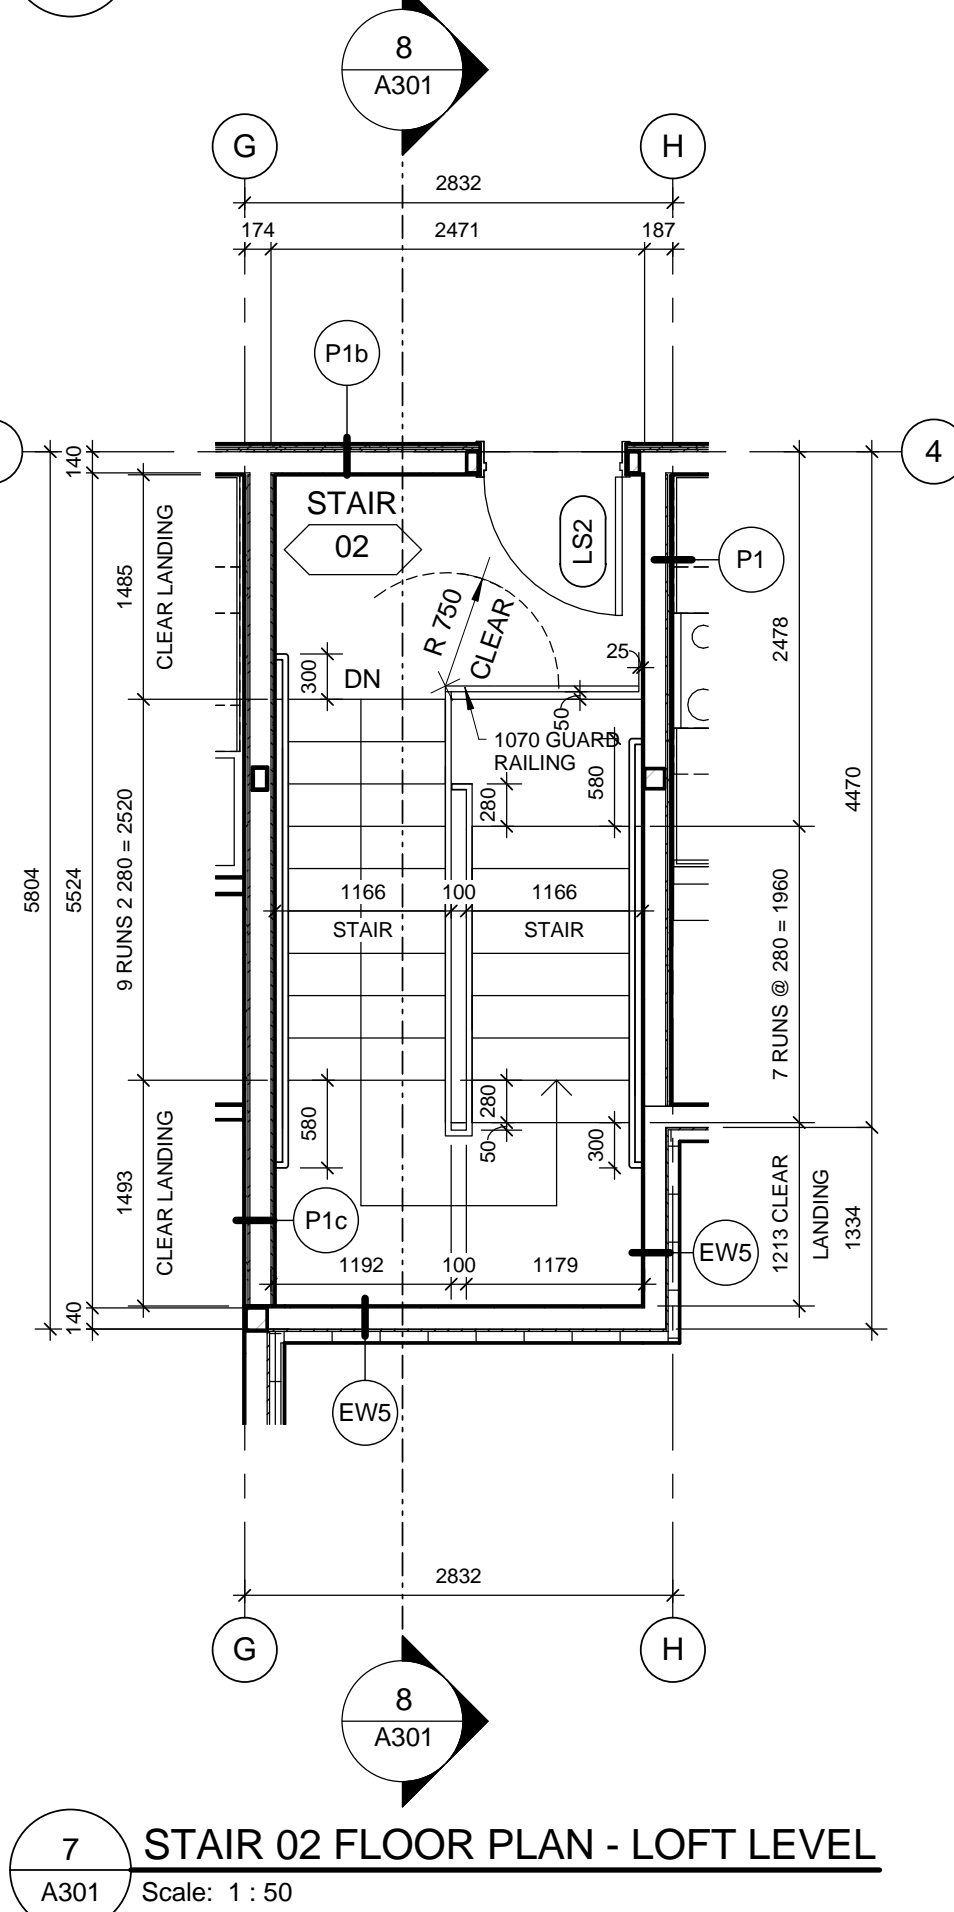
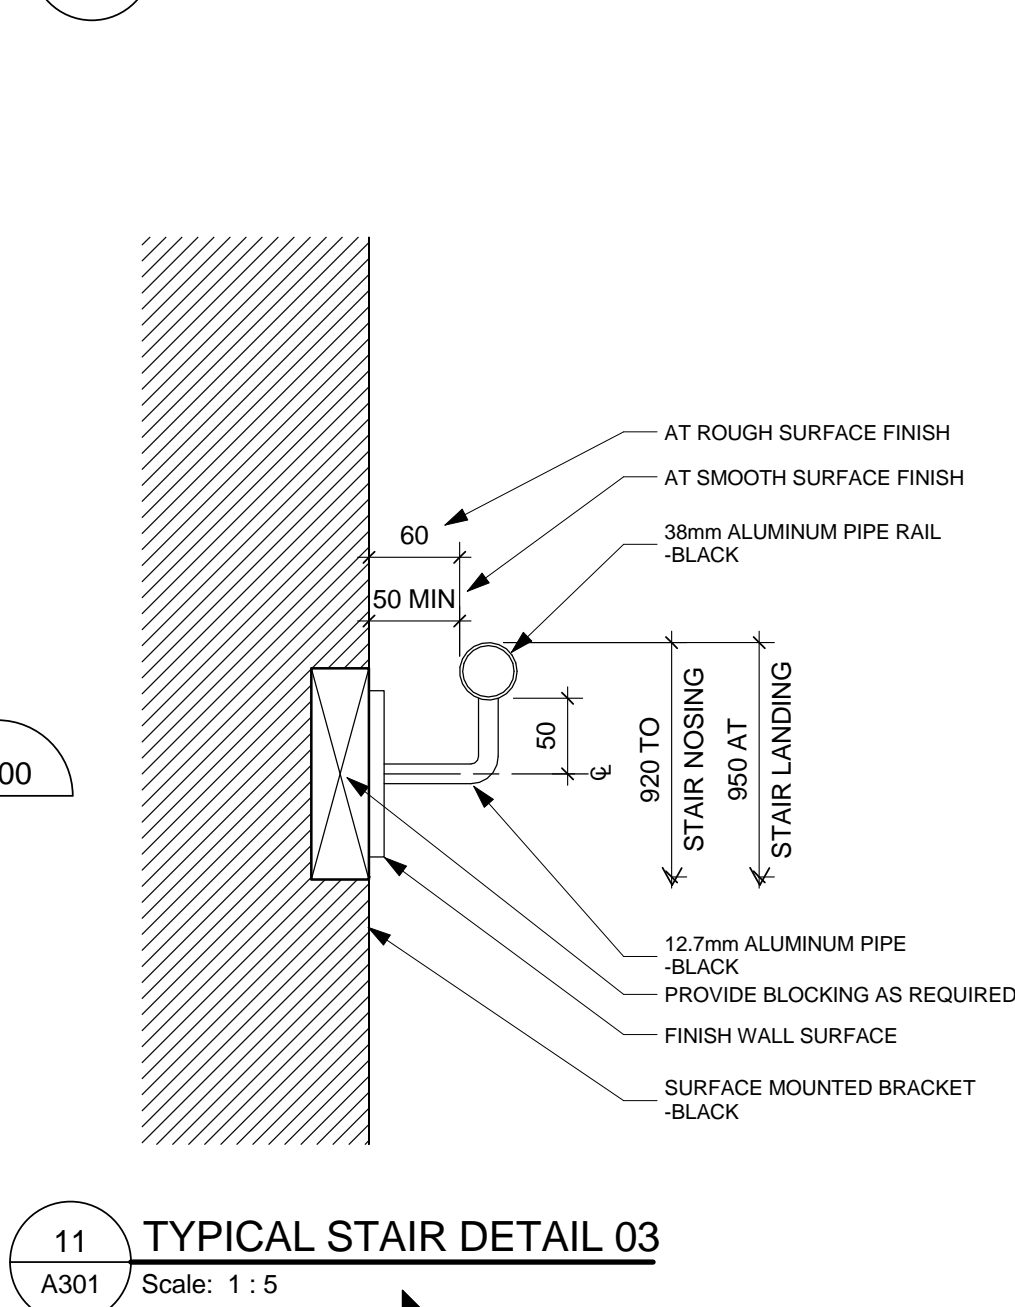
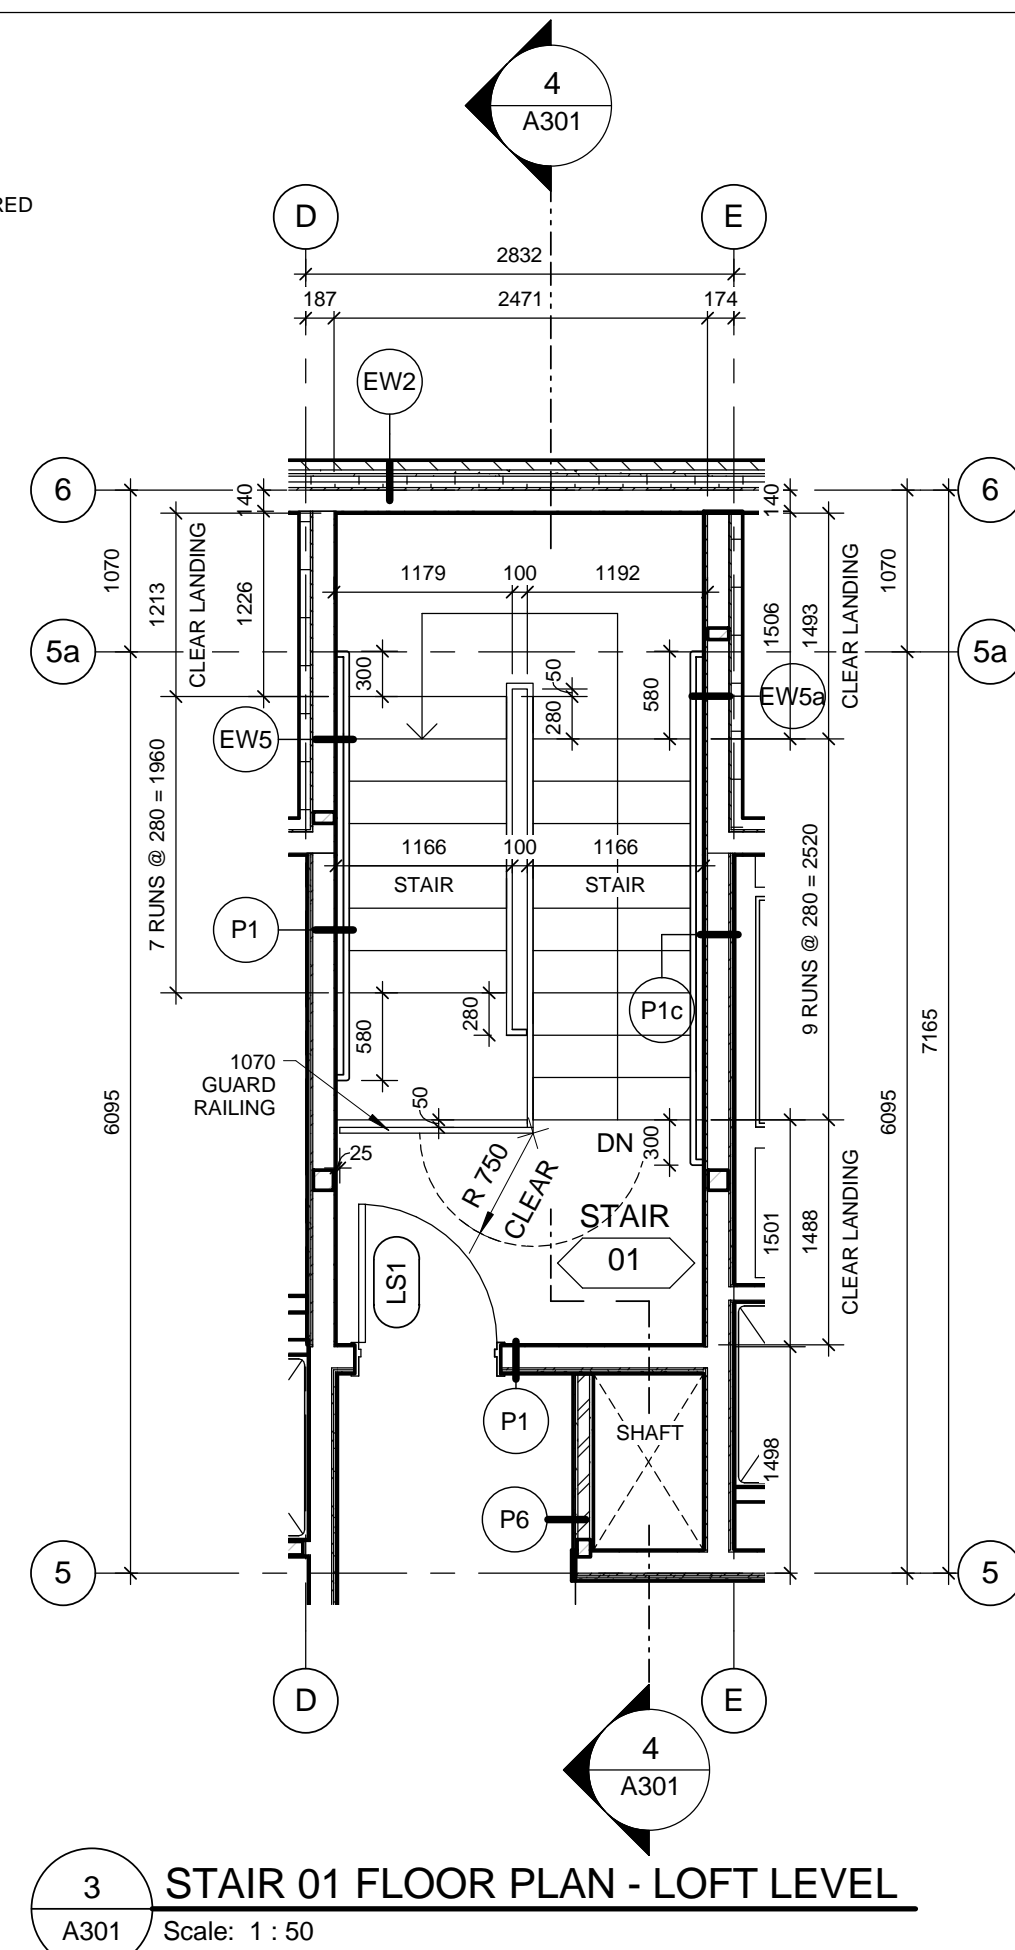
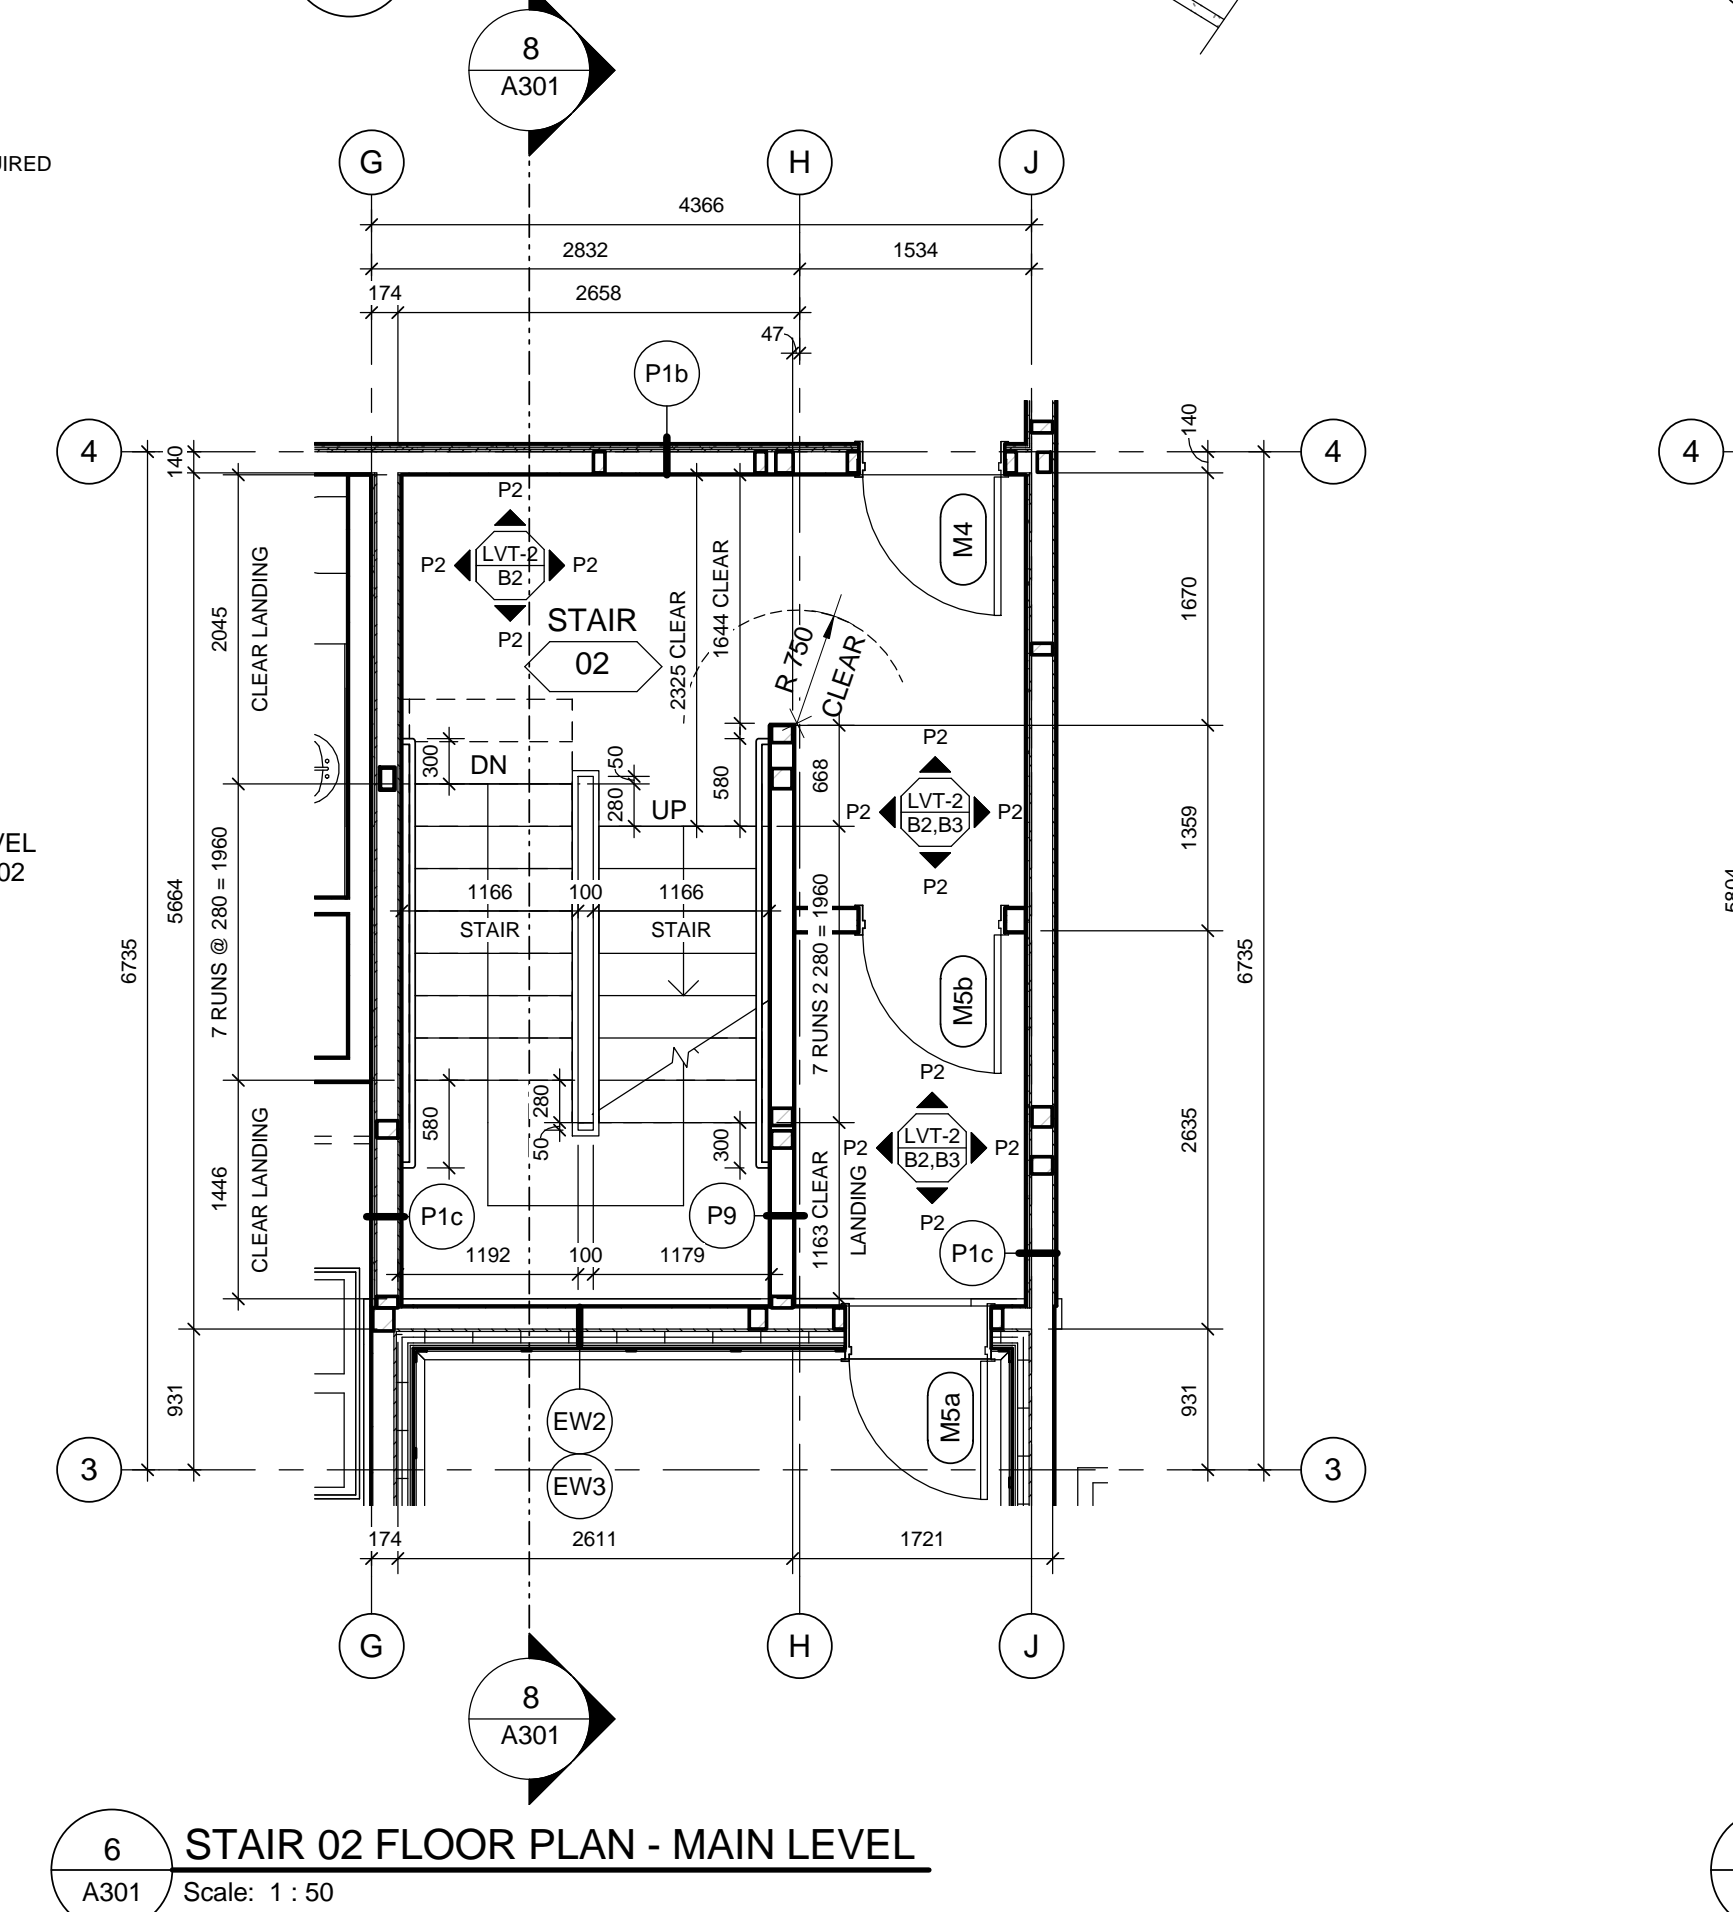
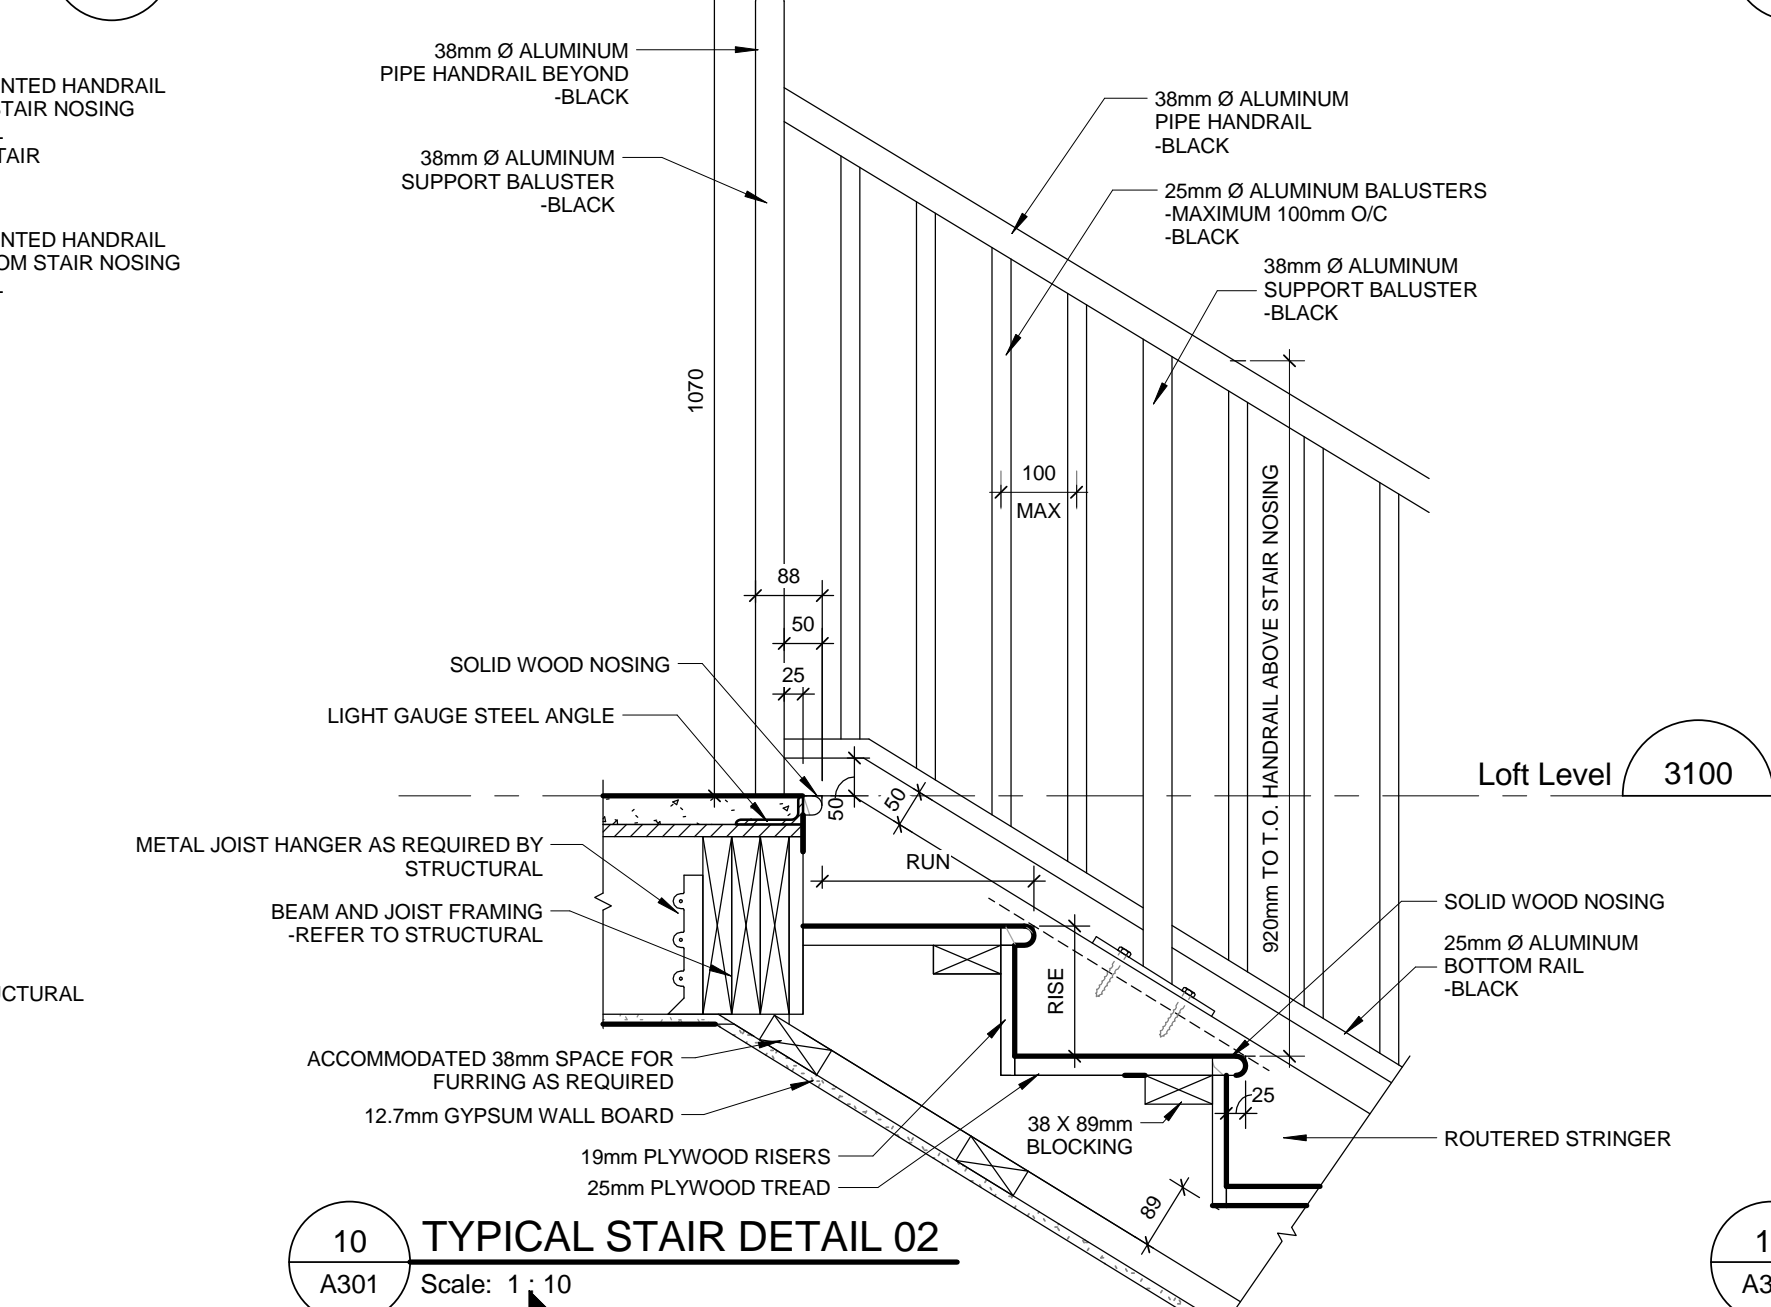
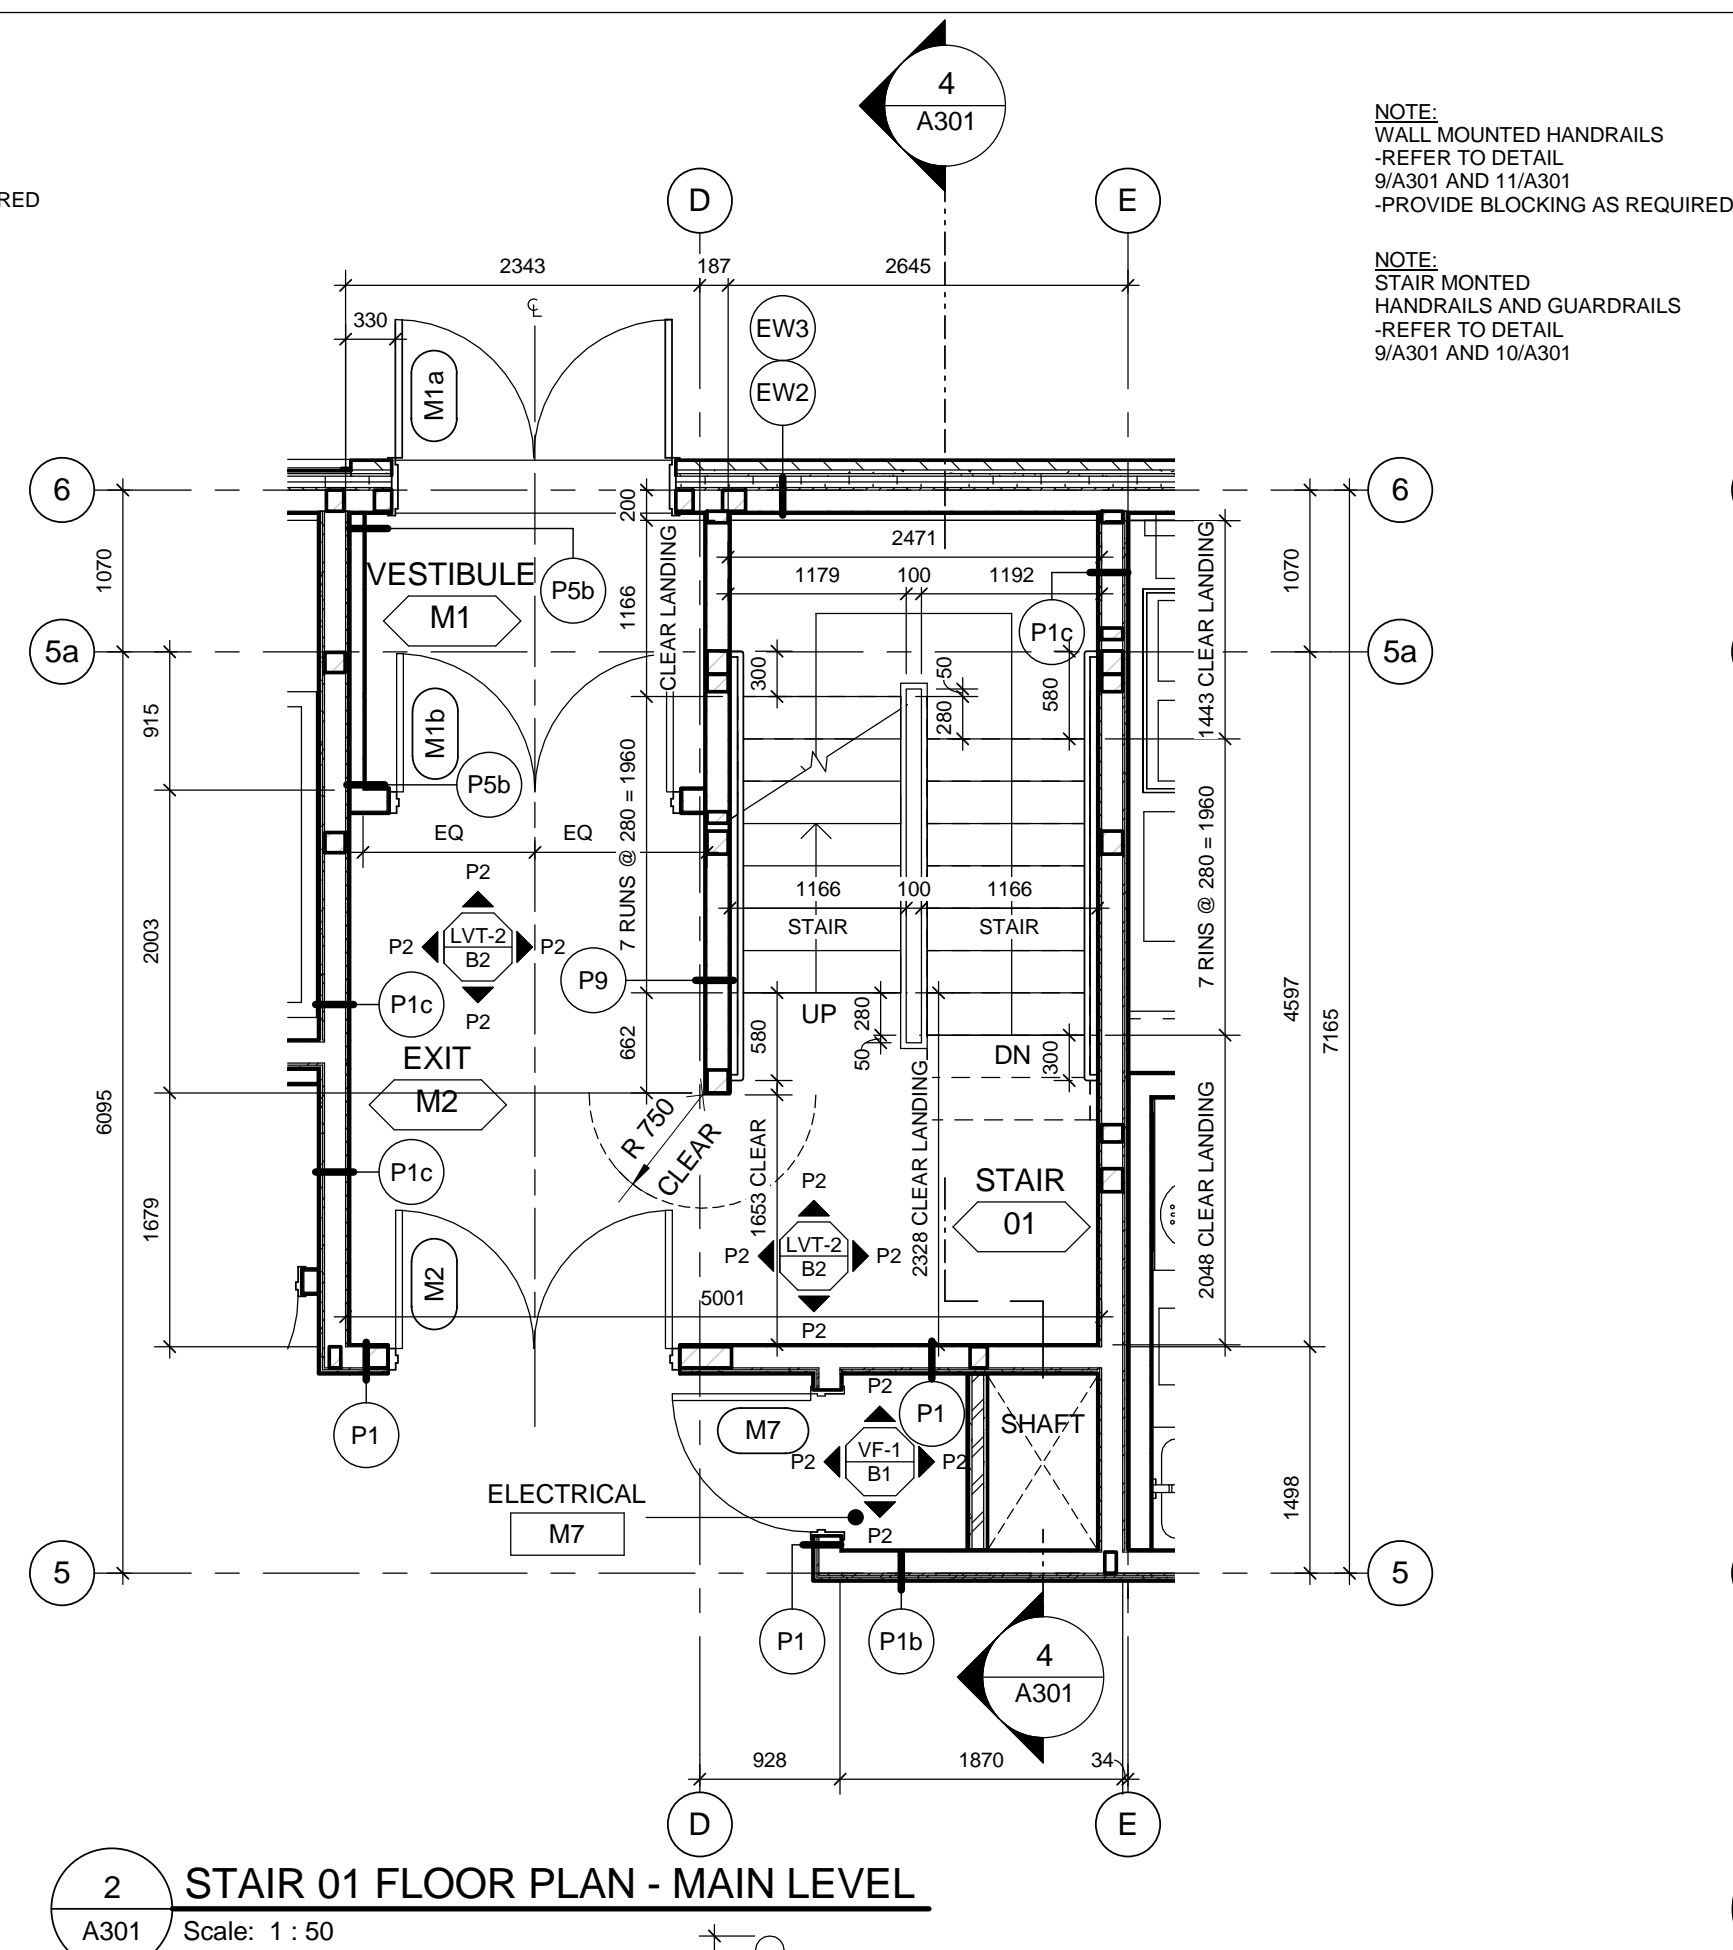
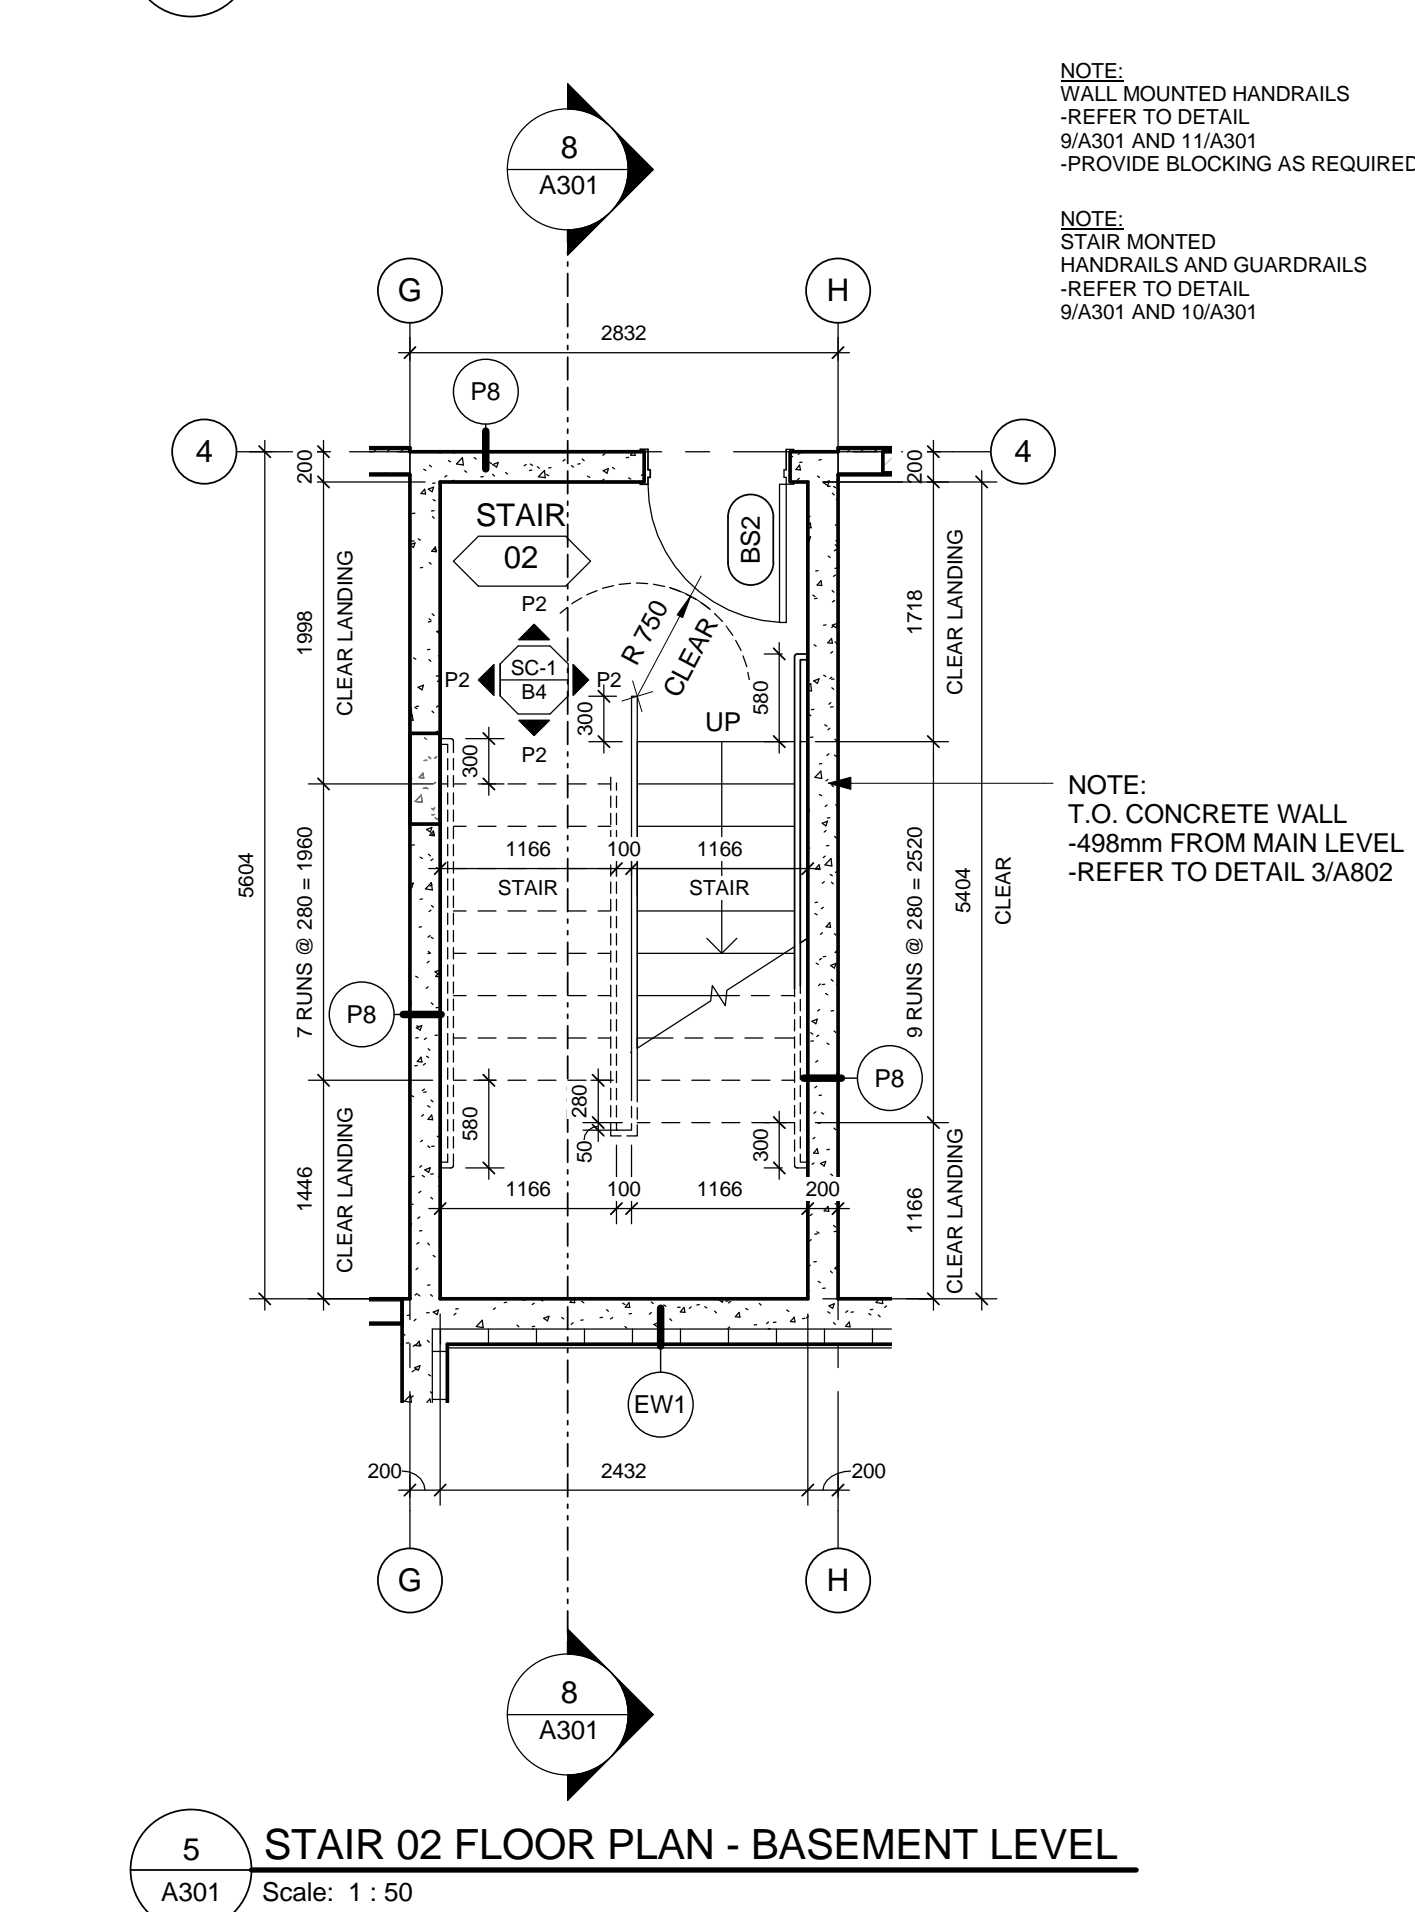
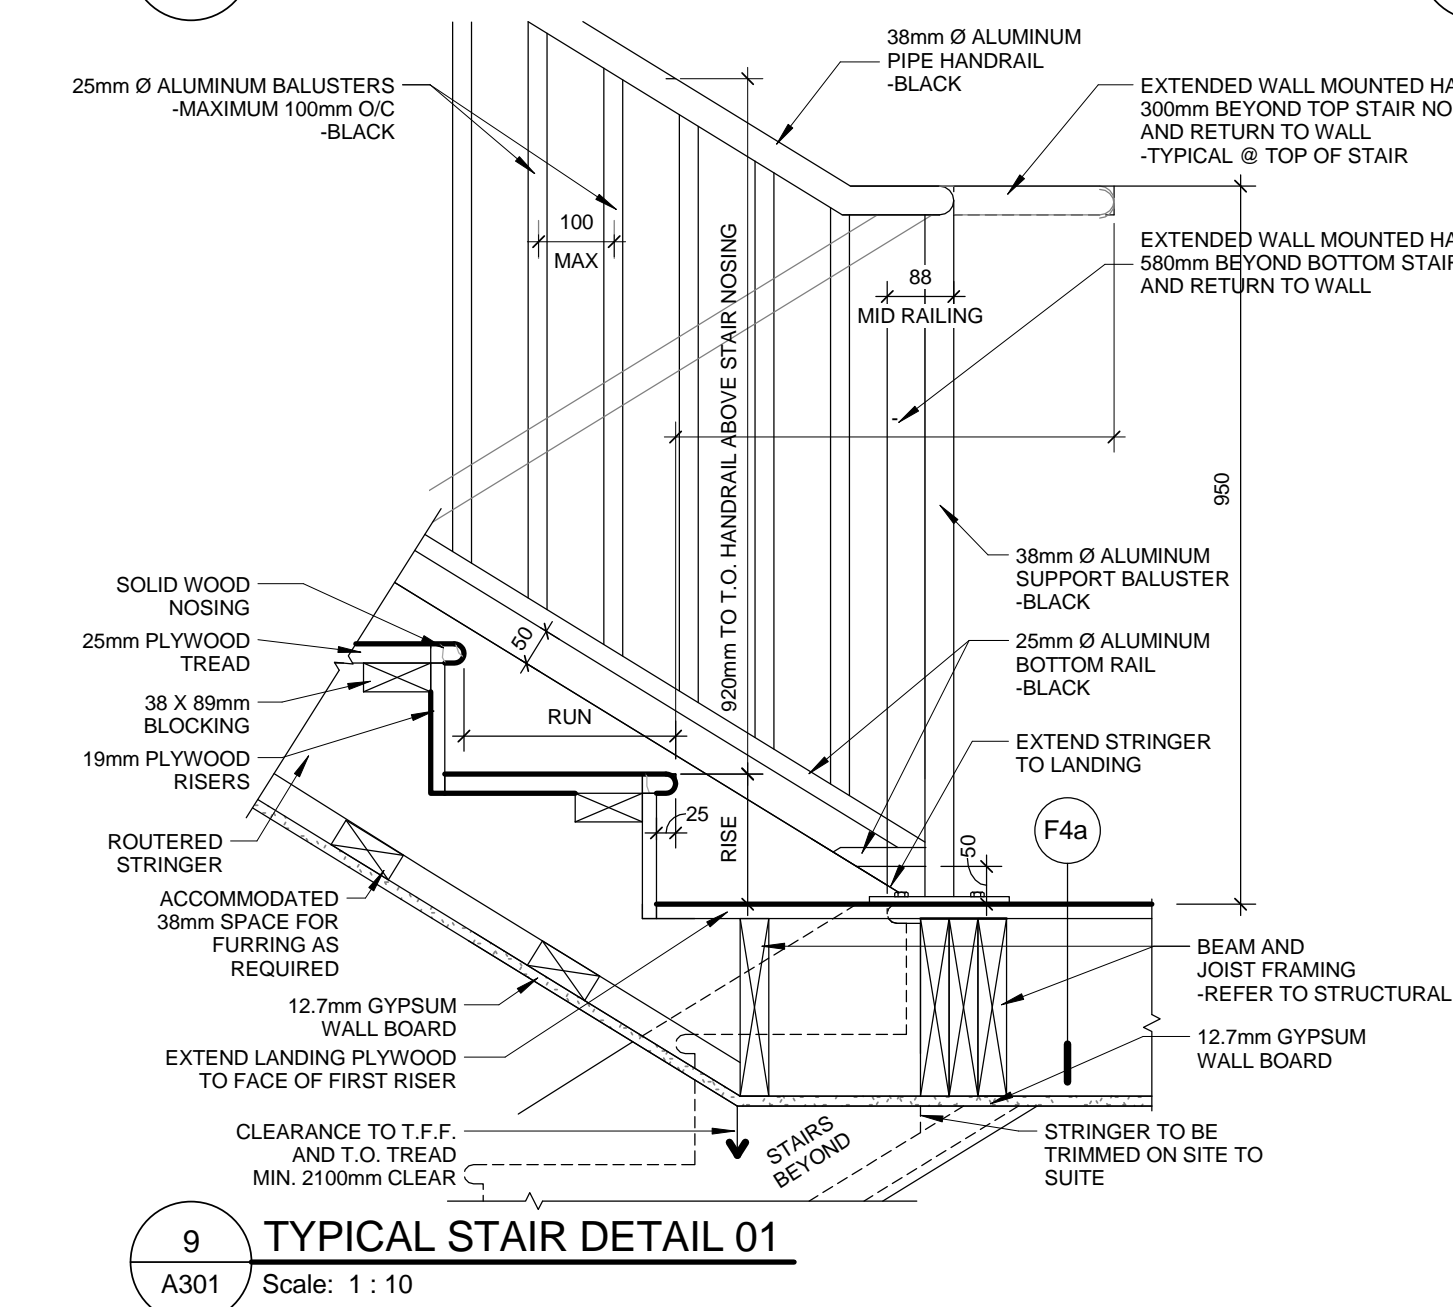
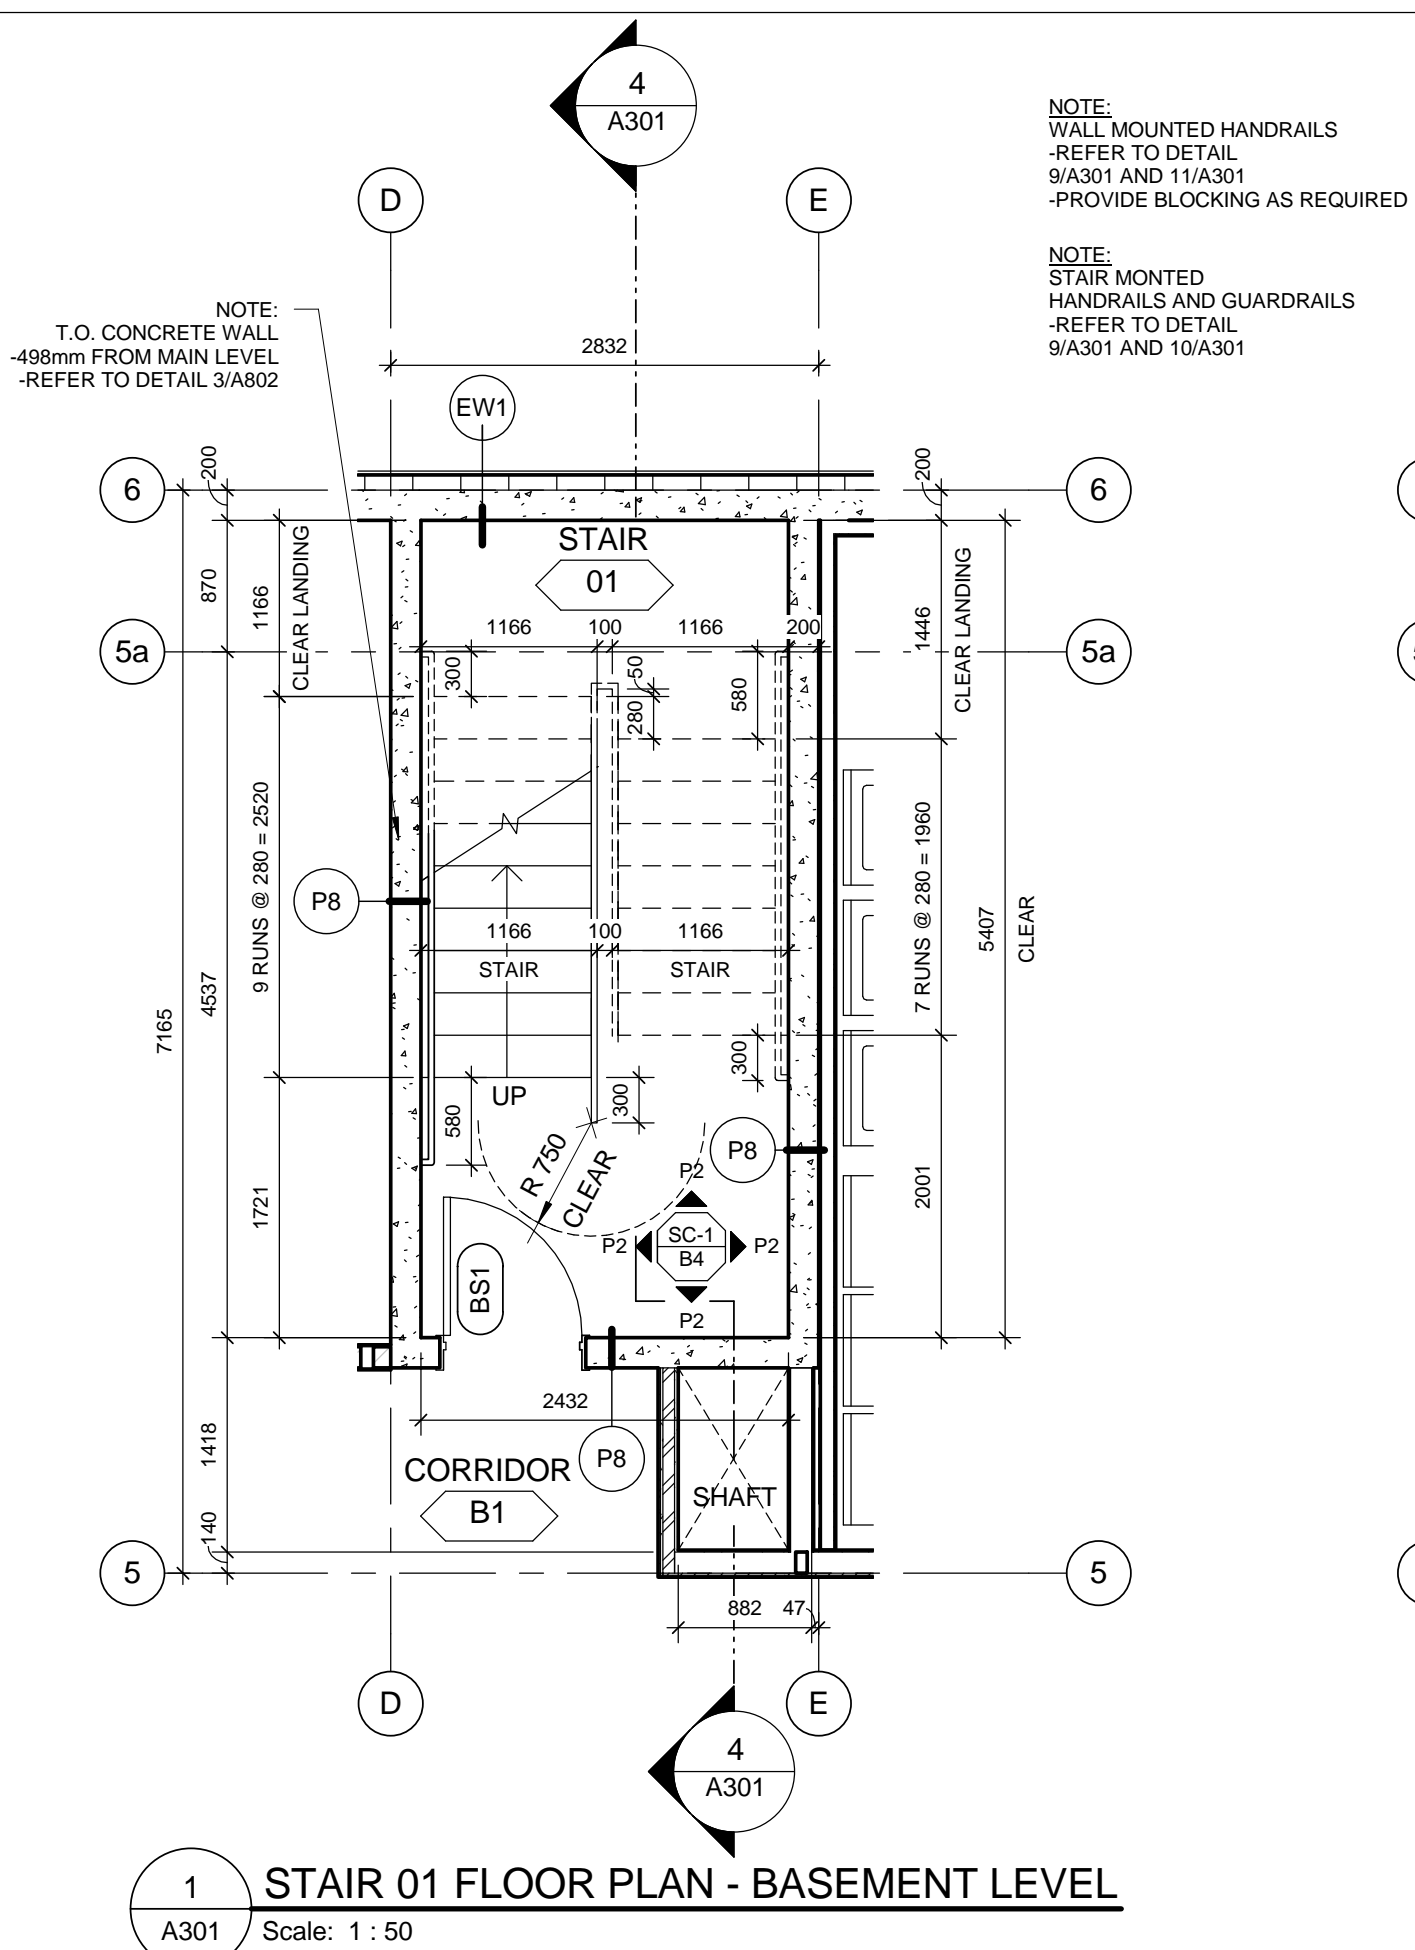
Public Works and Government Services Canada	Travaux publics et Services gouvernementaux Canada
Client Services Team Southern Alberta Operations Branch	Le Client Entretien l'Équipe Alberta Méridional Branche d'Opérations

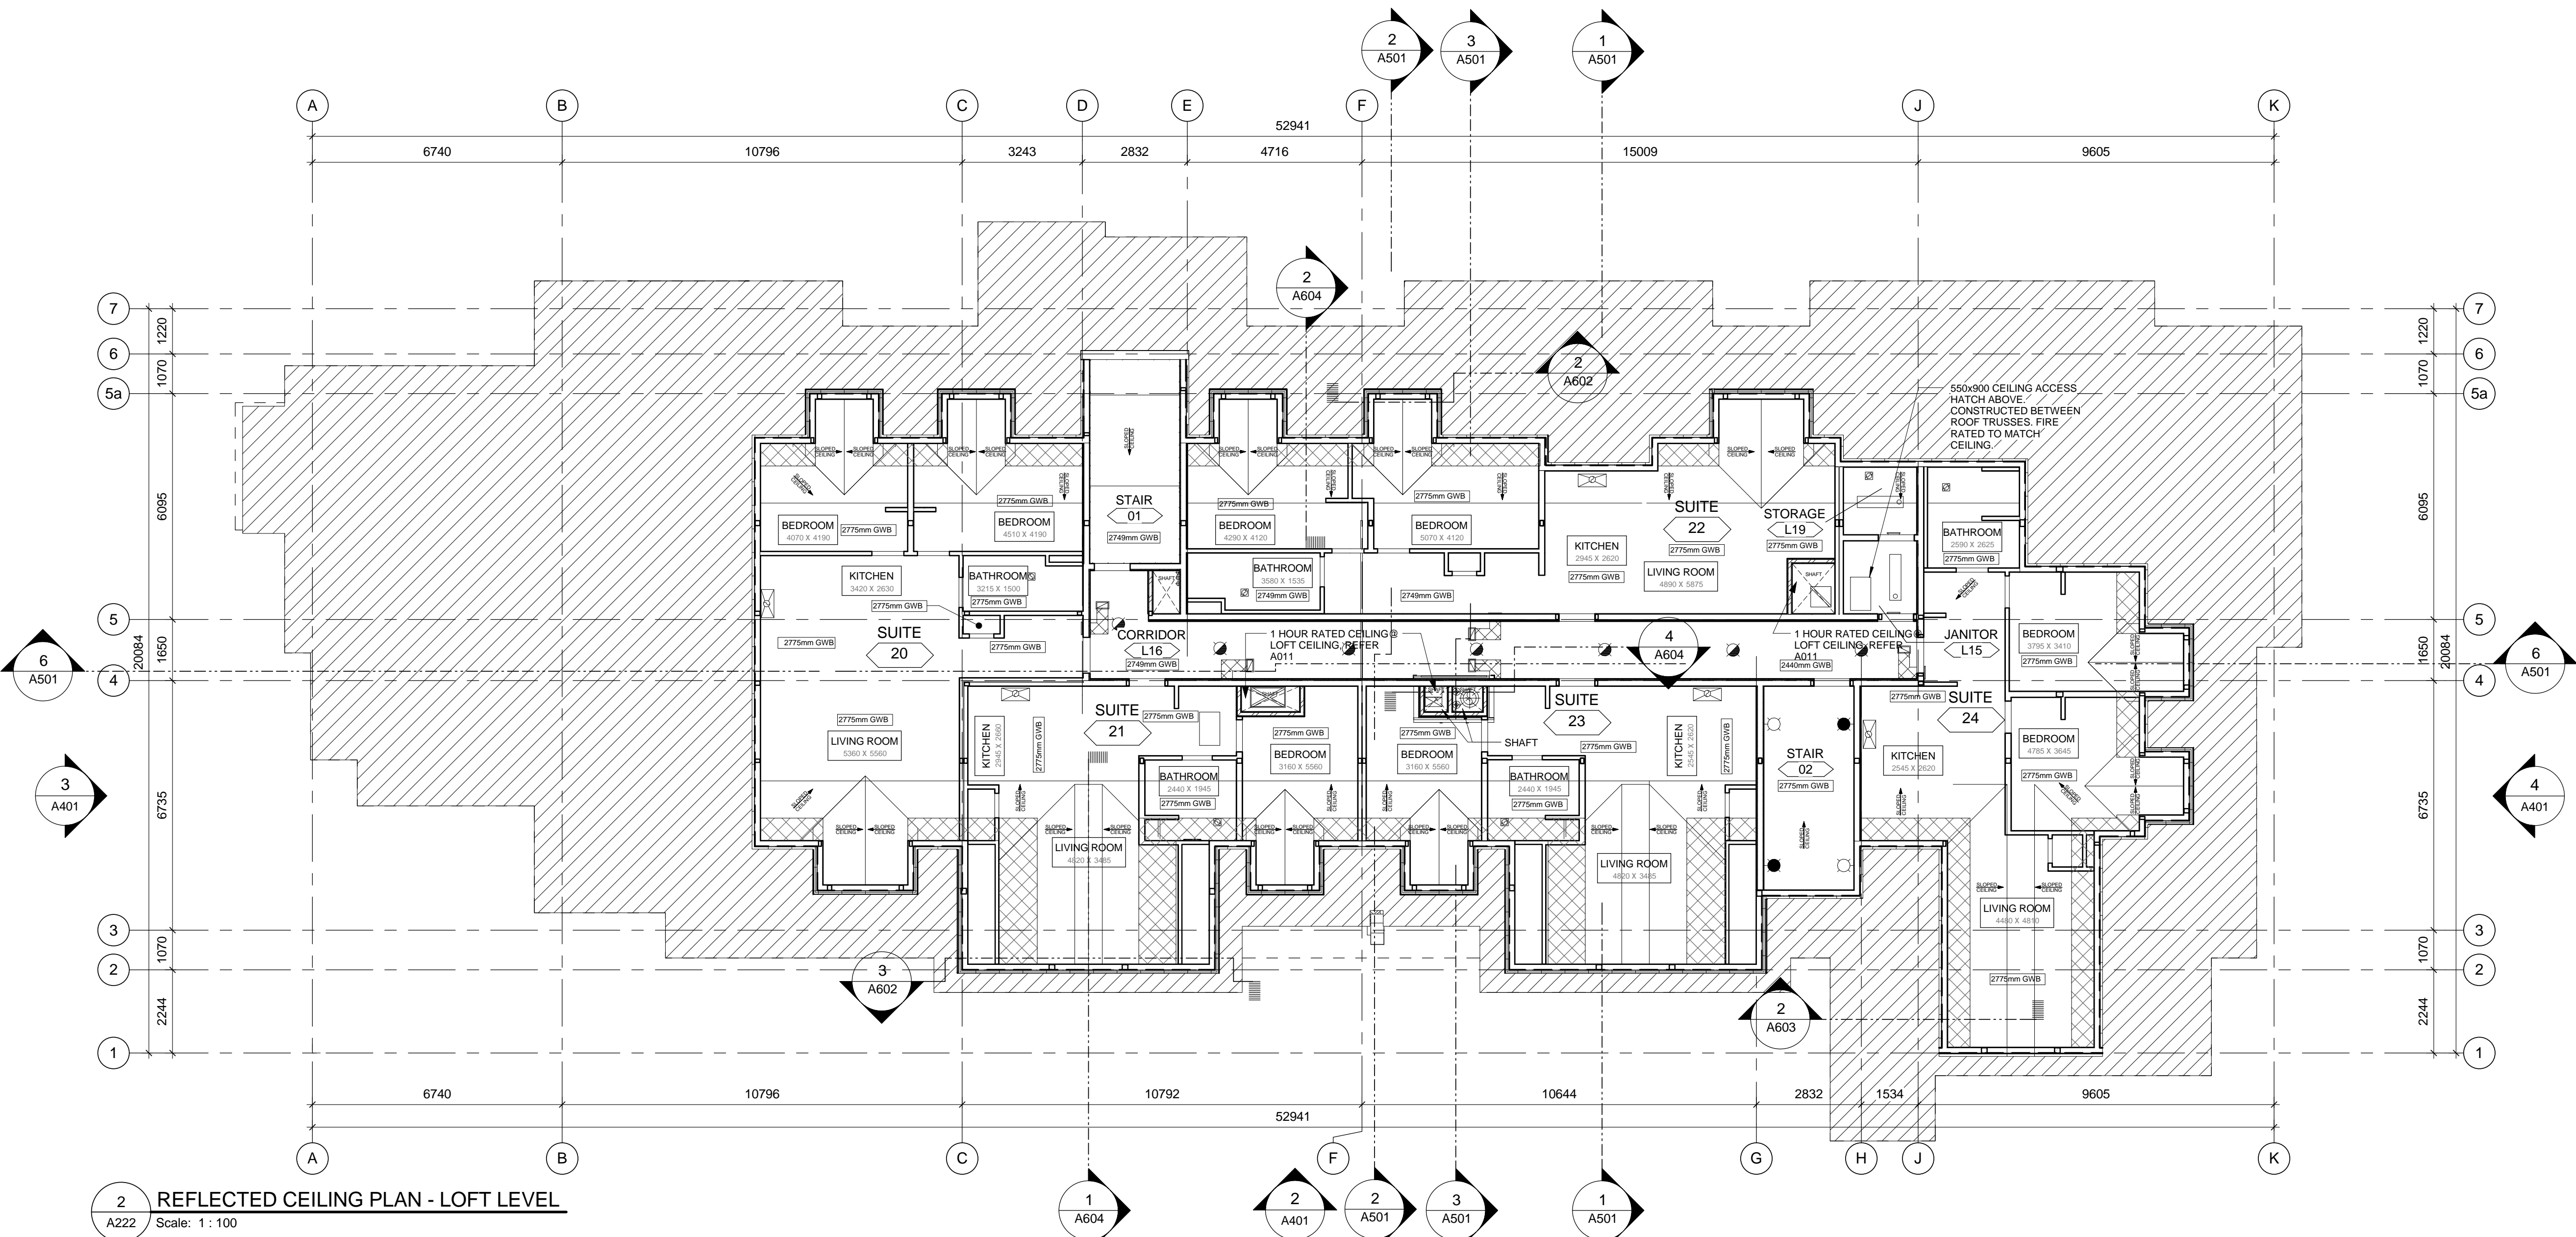Client/client	Parks Canada Agence	L'Agence Parcs Canada
	Western and Northern Region	Ouest et Nord du Canada

Project title/Titre du projet
**Staff Housing Phase 2
Waterton Lakes National
Park**

Drawing title/Titre du dessin
**REFLECTED CEILING PLAN -
MAIN LEVEL & LOFT LEVEL**

Surveyed by/Arpenté par	Drawn by/Dessiné par	Date/Date
LS/FVR	MP/AG	2016-12-08
Designed by/Concept par	Reviewed by/Revisé par	Scale/Echelle
LS/FVR	LS/FVR	1:100
PWGSC Project Manager/Administrateur de Projets TPSCG Randy Boldt		
Client Acceptance/Acceptation du client Approved by/Approuvé par		
Task Responsible Officer/Agent Responsable		
Task Responsible Officer/Agent Responsable		
Project No./No. du projet	Asset No./No. du bien	Sheet No./ No. de la feuille
39000	Fil # 945	A222
Drawing Reference No./No. de référence du dessin		





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1	2016-05-06	DEVELOPMENT PERMIT REVIEW		

No.	Date/Date	Description/Description	Drawn by Dessine par	Approved Approuvé
Revision / Revision				
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Consultant's Name Nom de l'expert-conseil	Eng. Stamp Sceau de l'ingénieur
 IBI GROUP Suite 500 - 611 Meredith Road NE Calgary, Alberta T2E 2W5 T. (403) 270-5600 F. (403) 270-5610 ibigroup.com	

	Public Works and Government Services Canada	Travaux publics et Services gouvernementaux Canada
	Client Services Team Southern Alberta Operations Branch	Le Client Entretien l'Équipe Alberta Méridional Branche d'Opérations

Canada

Client/client 	Parks Canada Agency	L'Agence Parcs Canada
	Western and Northern Region	Ouest et Nord du Canada

Project title/Titre du projet

Staff Housing Phase 2 Waterton Lakes National Park

Drawing title/Titre du dessin

**VERTICAL CIRCULATION -
STAIR 01 & STAIR 02 FLOOR
PLANS, SECTIONS &
STANDARD DETAILS**

Surveyed by/Arpente par	Drawn by/Dessine par MP	Date/Date 2016-12-08
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Designed by/Concept par LS/FVR	Reviewed by/Revise par LS/FVR	Scale/Echelle As indicated
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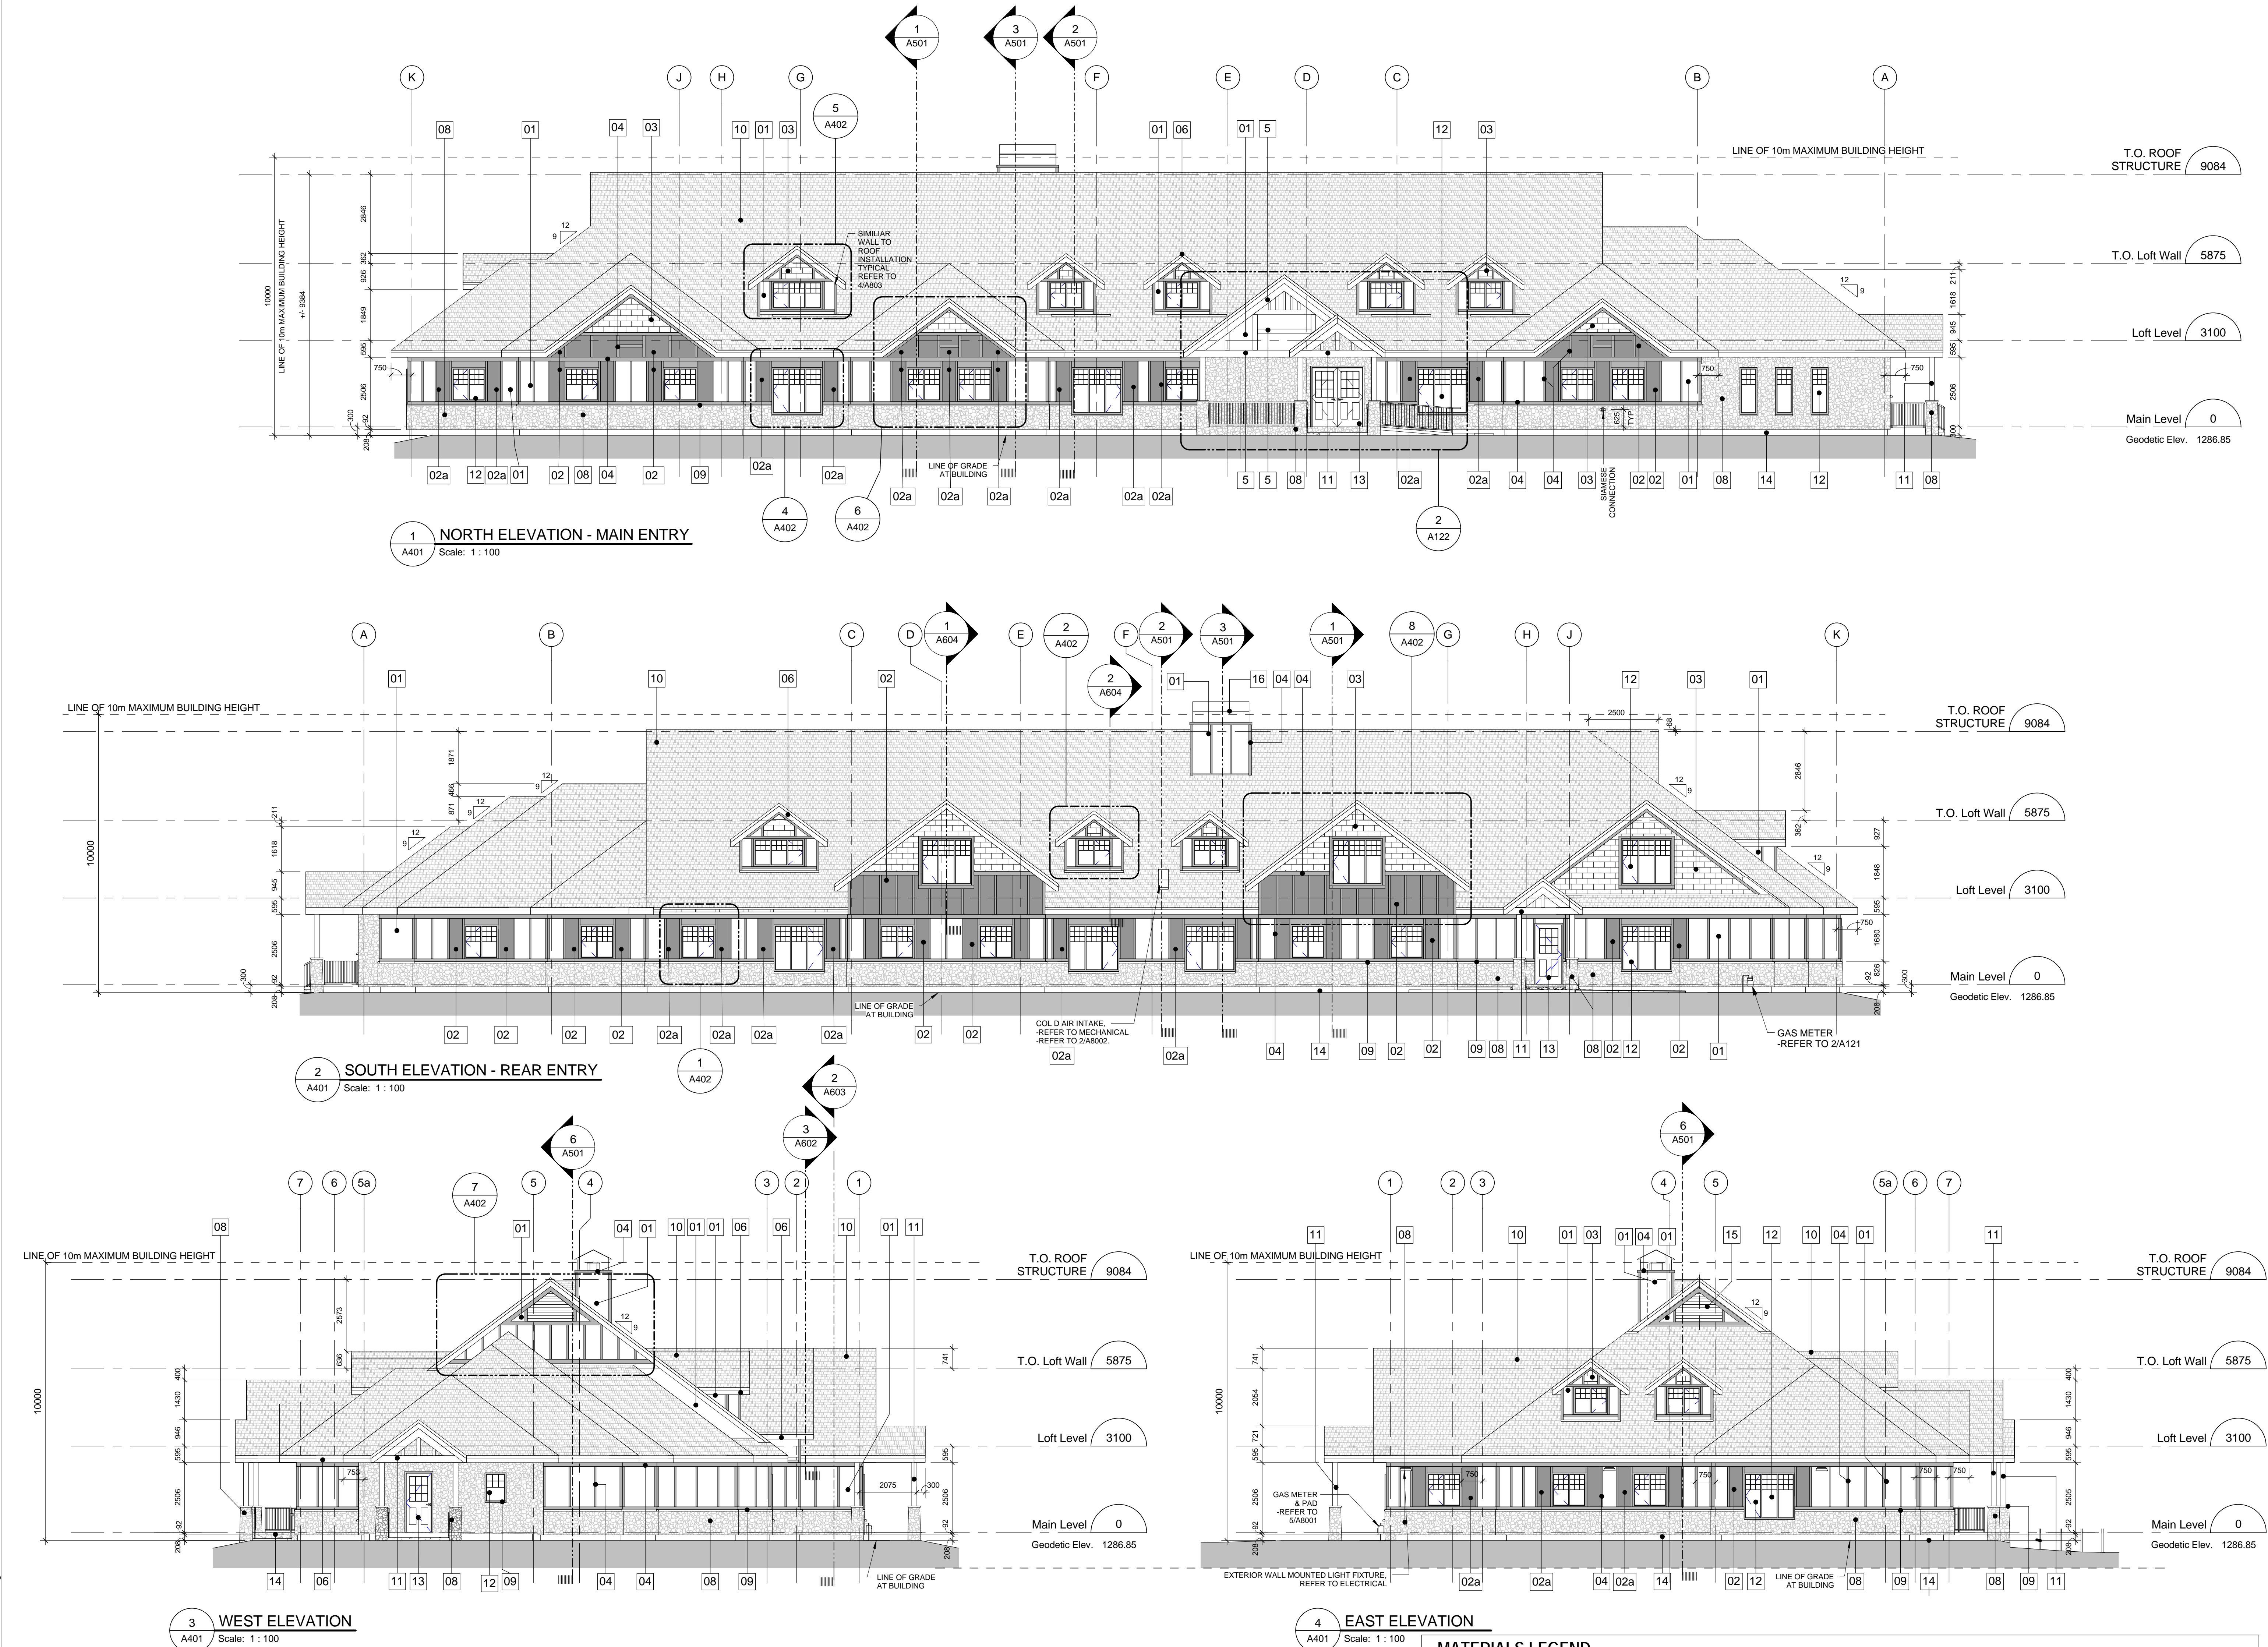
PWGSC Project Manager/Administrateur de Projets TPSGC

Randy Boldt	
Client Acceptance/Acceptation du client	Approved by/Approuvé par

Park Responsible Officer/Agent Responsable	PMOSC Project Manager/Administrateur de Projets TPSC
--	--

Project No./No. du projet 39000	Asset No./No. du bien FII # 945	Sheet No./ No. de la feuille
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1	2016-05-06	DEVELOPMENT PERMIT REVIEW		

Revision / Revision
A detail number
B source drawing no.
C detail on drawing no.

Consultant's Name
Nom de l'expert-conseil

Eng. Stamp
Sceau de l'ingénieur

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Calgary, Alberta T2E 2W5
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Le Client Entretien l'Équipe Alberta Méridionale Branche d'Opérations

Canada

Client/client
Parks Canada Agency
L'Agence Parcs Canada

Western and Northern Region
Ouest et Nord du Canada

Project title/Titre du projet
**Staff Housing Phase 2
Waterton Lakes National Park**

Drawing title/Titre du dessin
BUILDING ELEVATIONS

Surveyed by/Arpenté par
AG

Designed by/Concept par
LS/FVR





FWGSC Project Manager/Administrateur de Projets TPSCG
Randy Boldt

Client Acceptance/Acceptation du client
Approved by/Approuvé par

Project No./No. du projet
39000


Asset No./No. d'actif
Fil # 945

Sheet No./No. de la feuille
A401

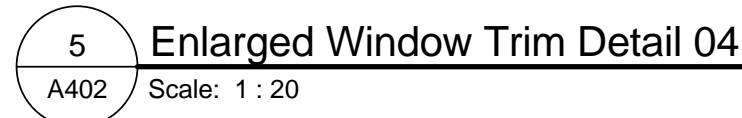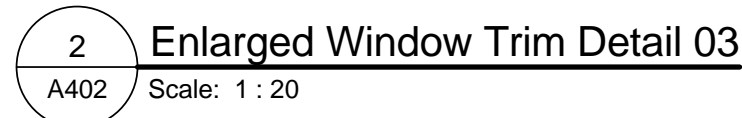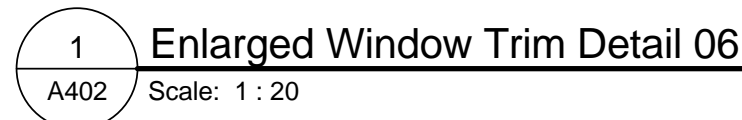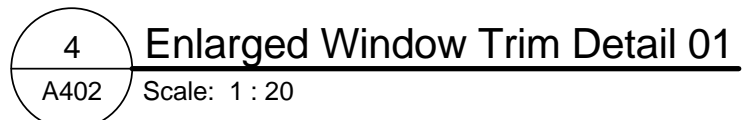


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1	CEMENT BOARD SIDING - Smooth Panel	COBBLESTONE	9	CULTURED STONE CAP	GRAY
2	CEMENT BOARD SIDING - Smooth Panel	MOUNTAIN SAGE	10	FIBERGLASS REINFORCED ASPHALT SHINGLES	DRIFTWOOD
2a	CEMENT BOARD SIDING - Smooth Panel	COUNTRY RED	11	CEDAR TIMBER POSTS AND BEAMS	CLEAR WOOD PRESERVATIVE
3	STAINED FIBER CEMENT SHAKE SIDING	MAHOAGNY	12	VINYL WINDOW	WICKER
4	CEMENT BOARD TRIM	KHAKI BROWN	13	FIBERGLASS ENTRY DOOR	PAINT COLOUR - TO MATCH COUNTRY LANE RED
5	CEMENT BOARD TRIM STAINED	MAHOAGNY	14	PRE-PARGED INSULATION BOARD	
6	METAL FASCIA	PEBBLE KHAKI	15	PREFINISHED MECHANICAL LOUVER	BLACK ANODIZED
7	METAL SOFFIT - Vented	WICKER	16	METAL CHIMNEY CANOPY	PEBBLE KHAKI
8	CULTURED STONE - Stream Stone	SPRING	17	PREFINISHED METAL FLASHING	TO MATCH ROOF


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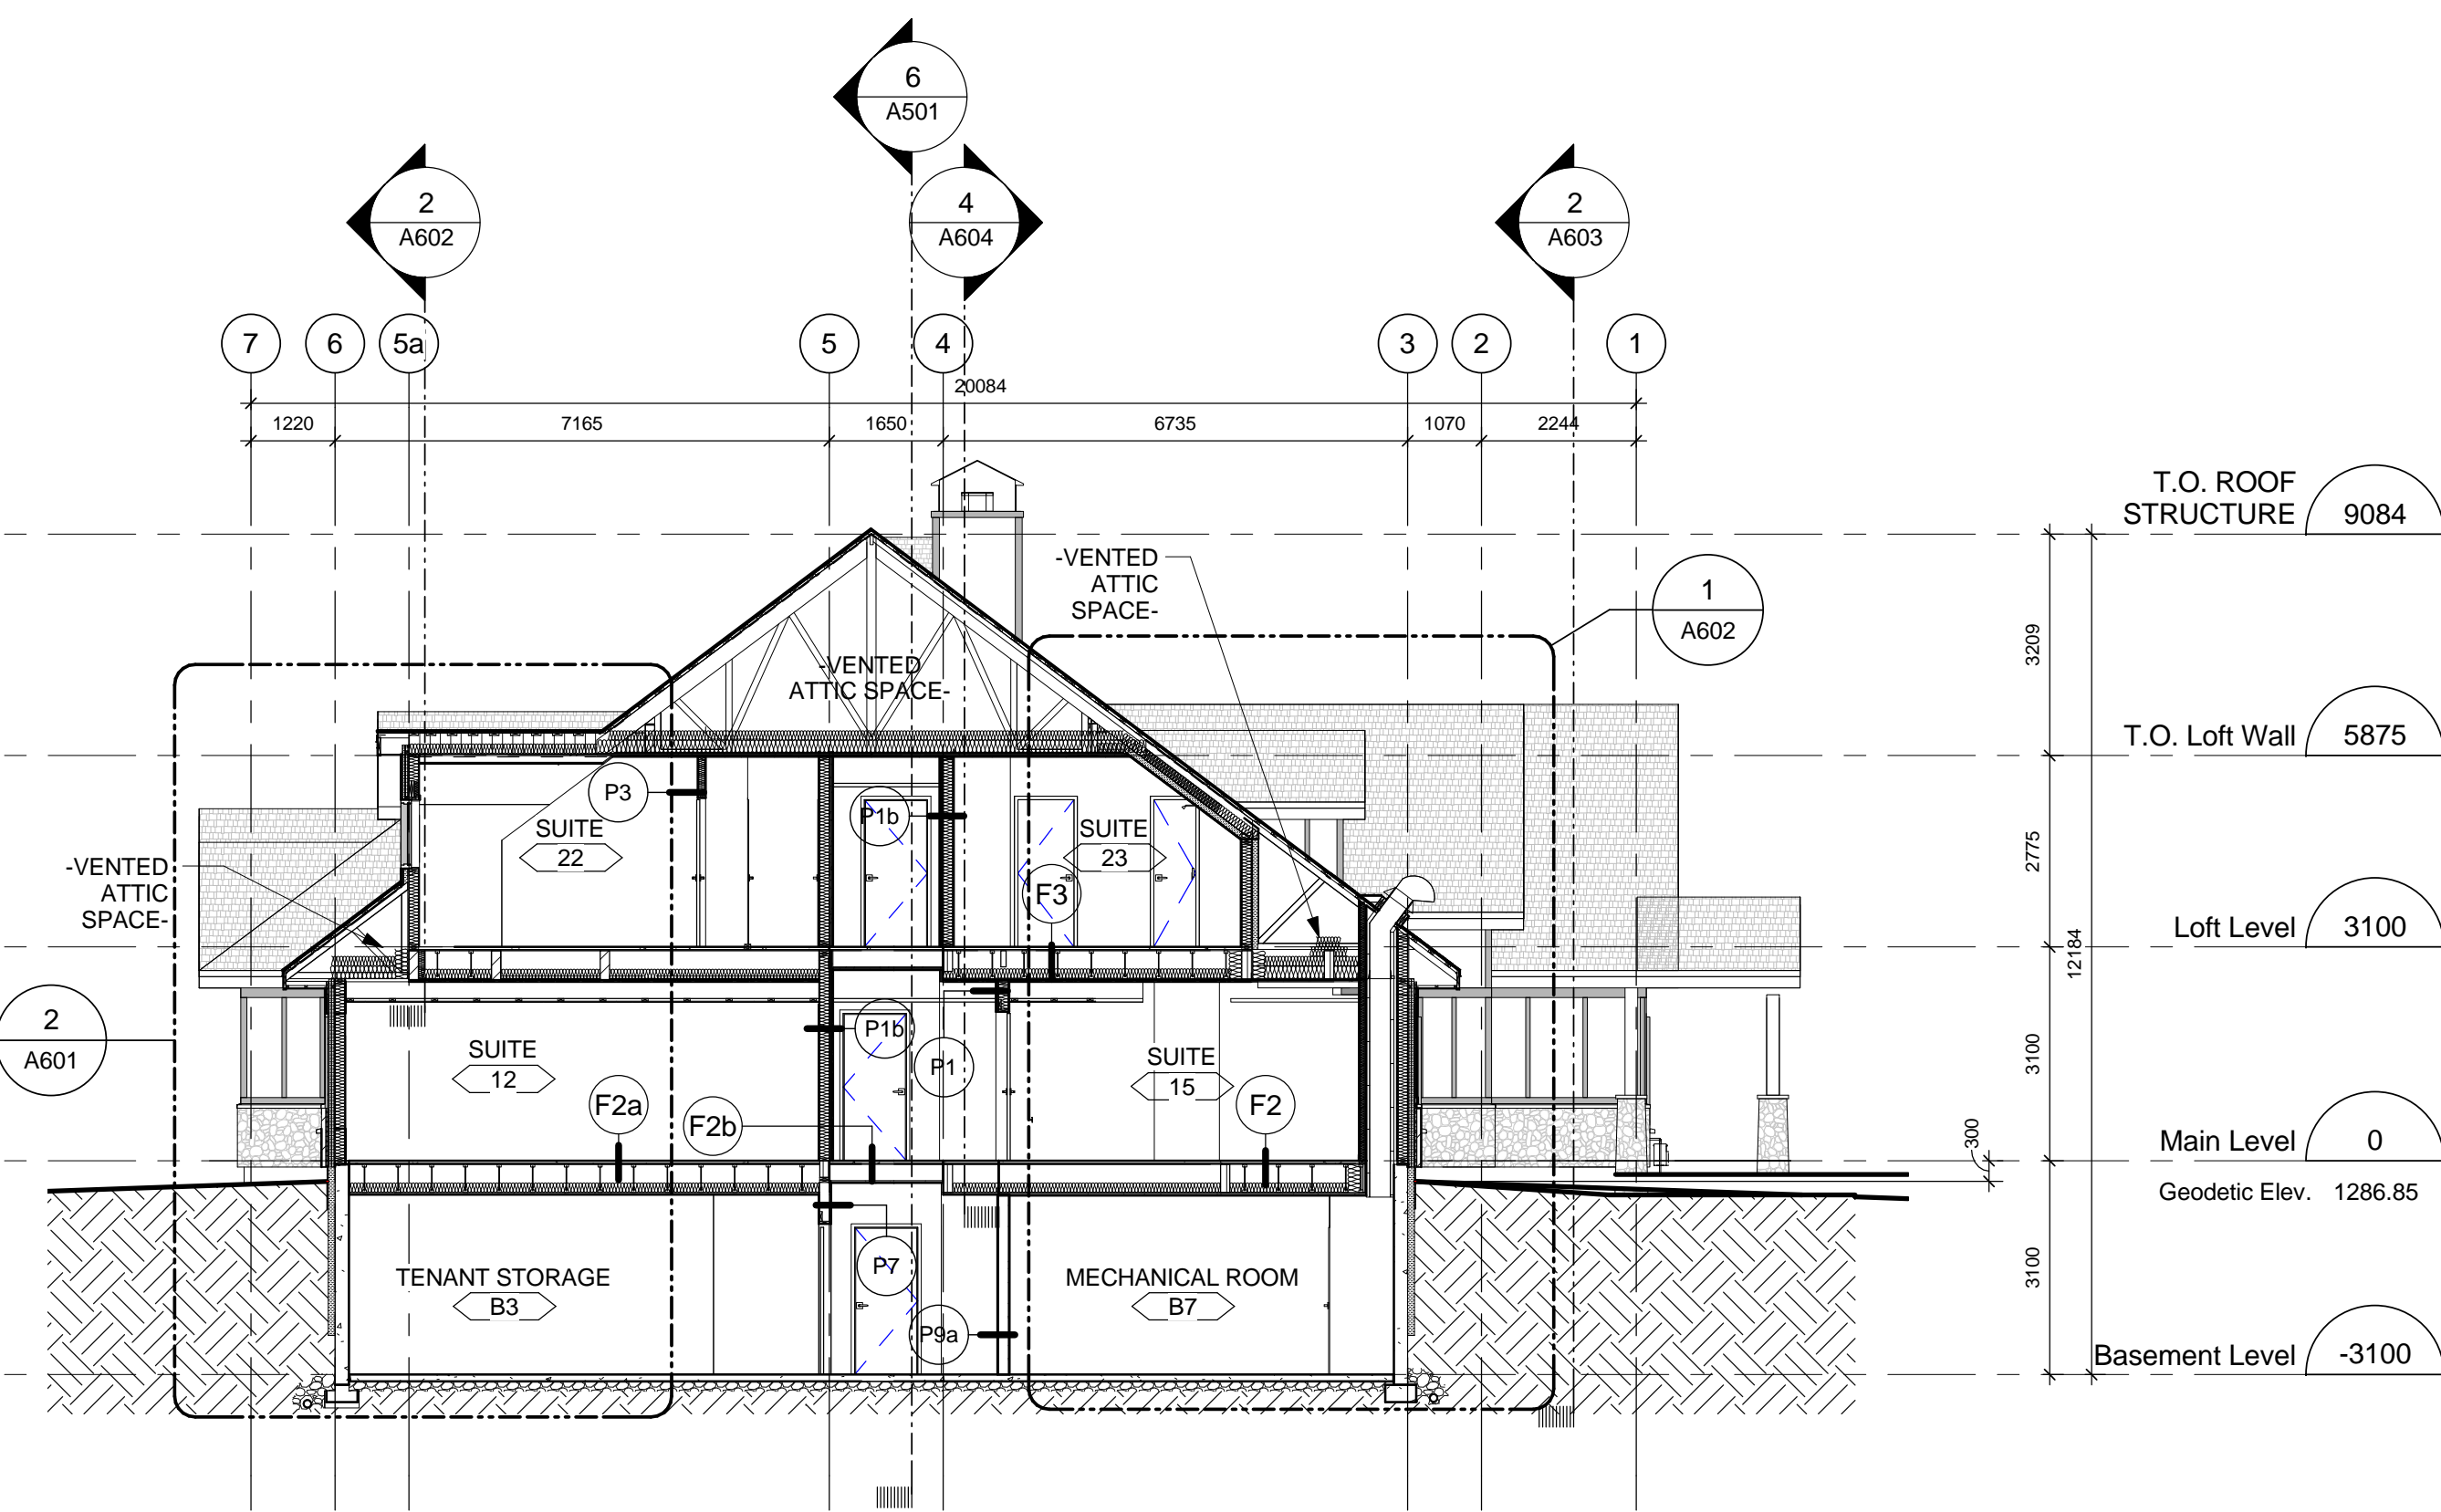
6 BUILDING SECTION 01
A501 Scale: 1 : 100

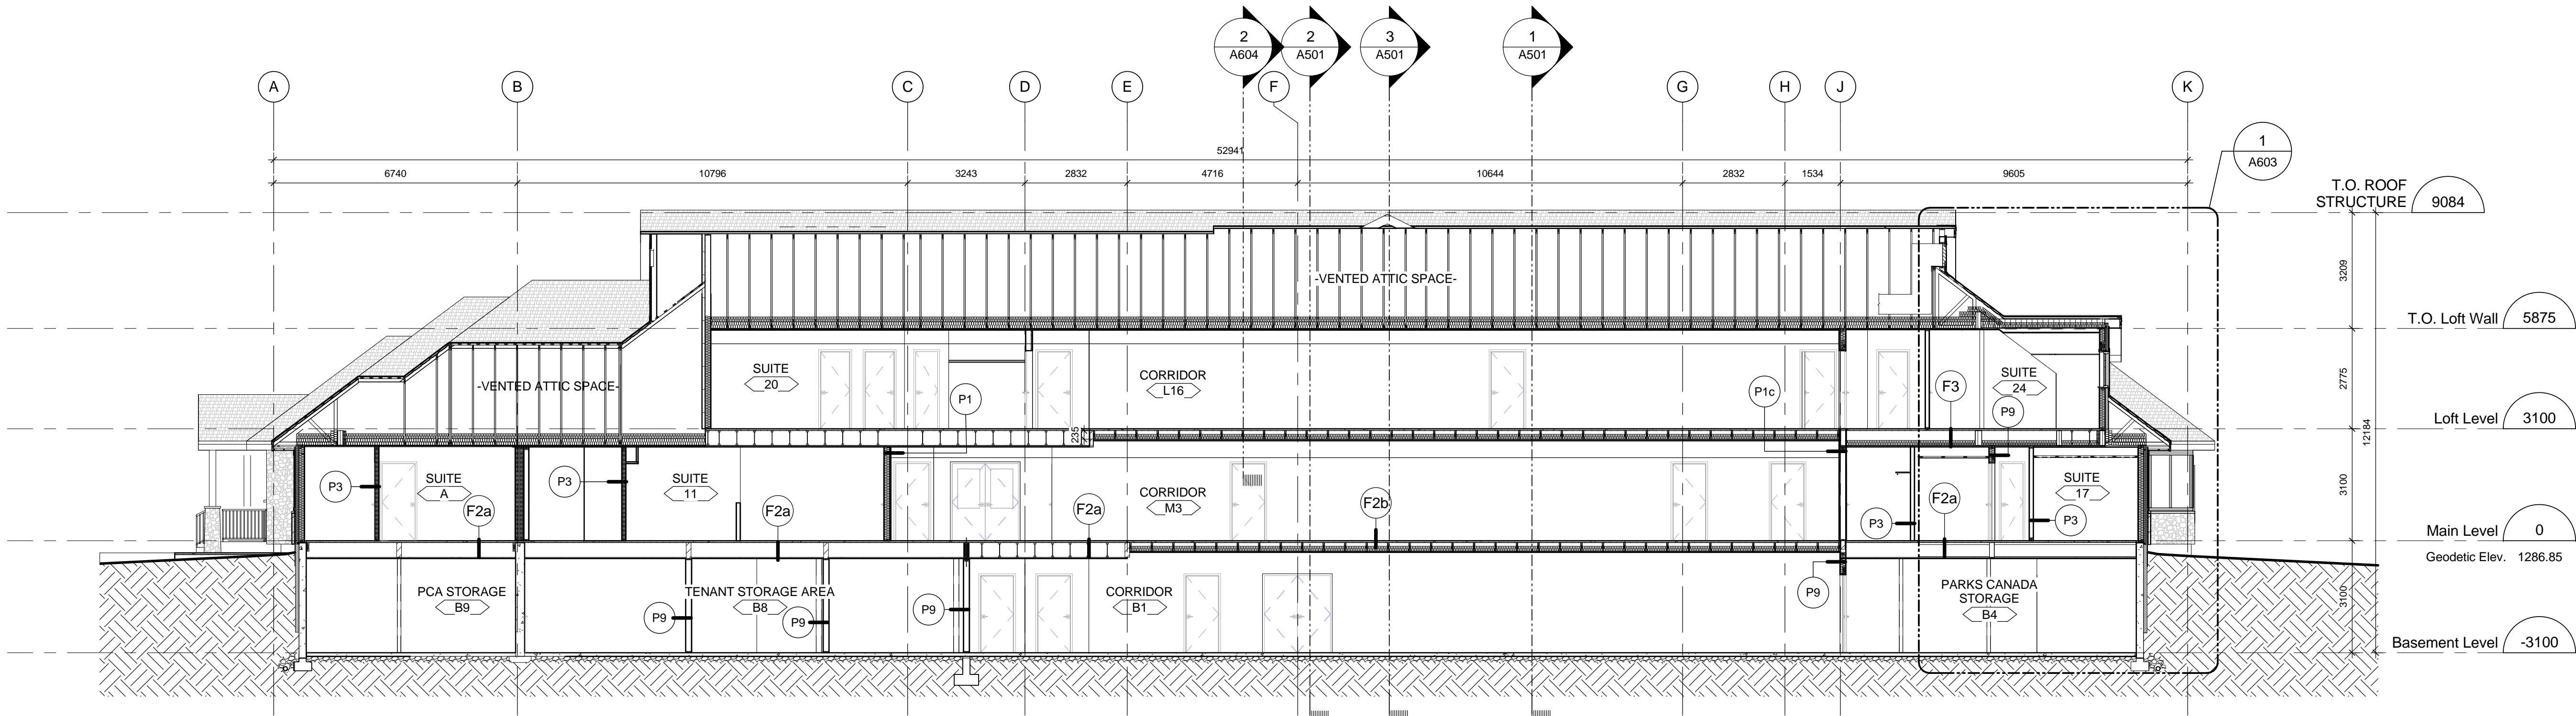

1 BUILDING SECTION 02
A501 Scale: 1 : 100

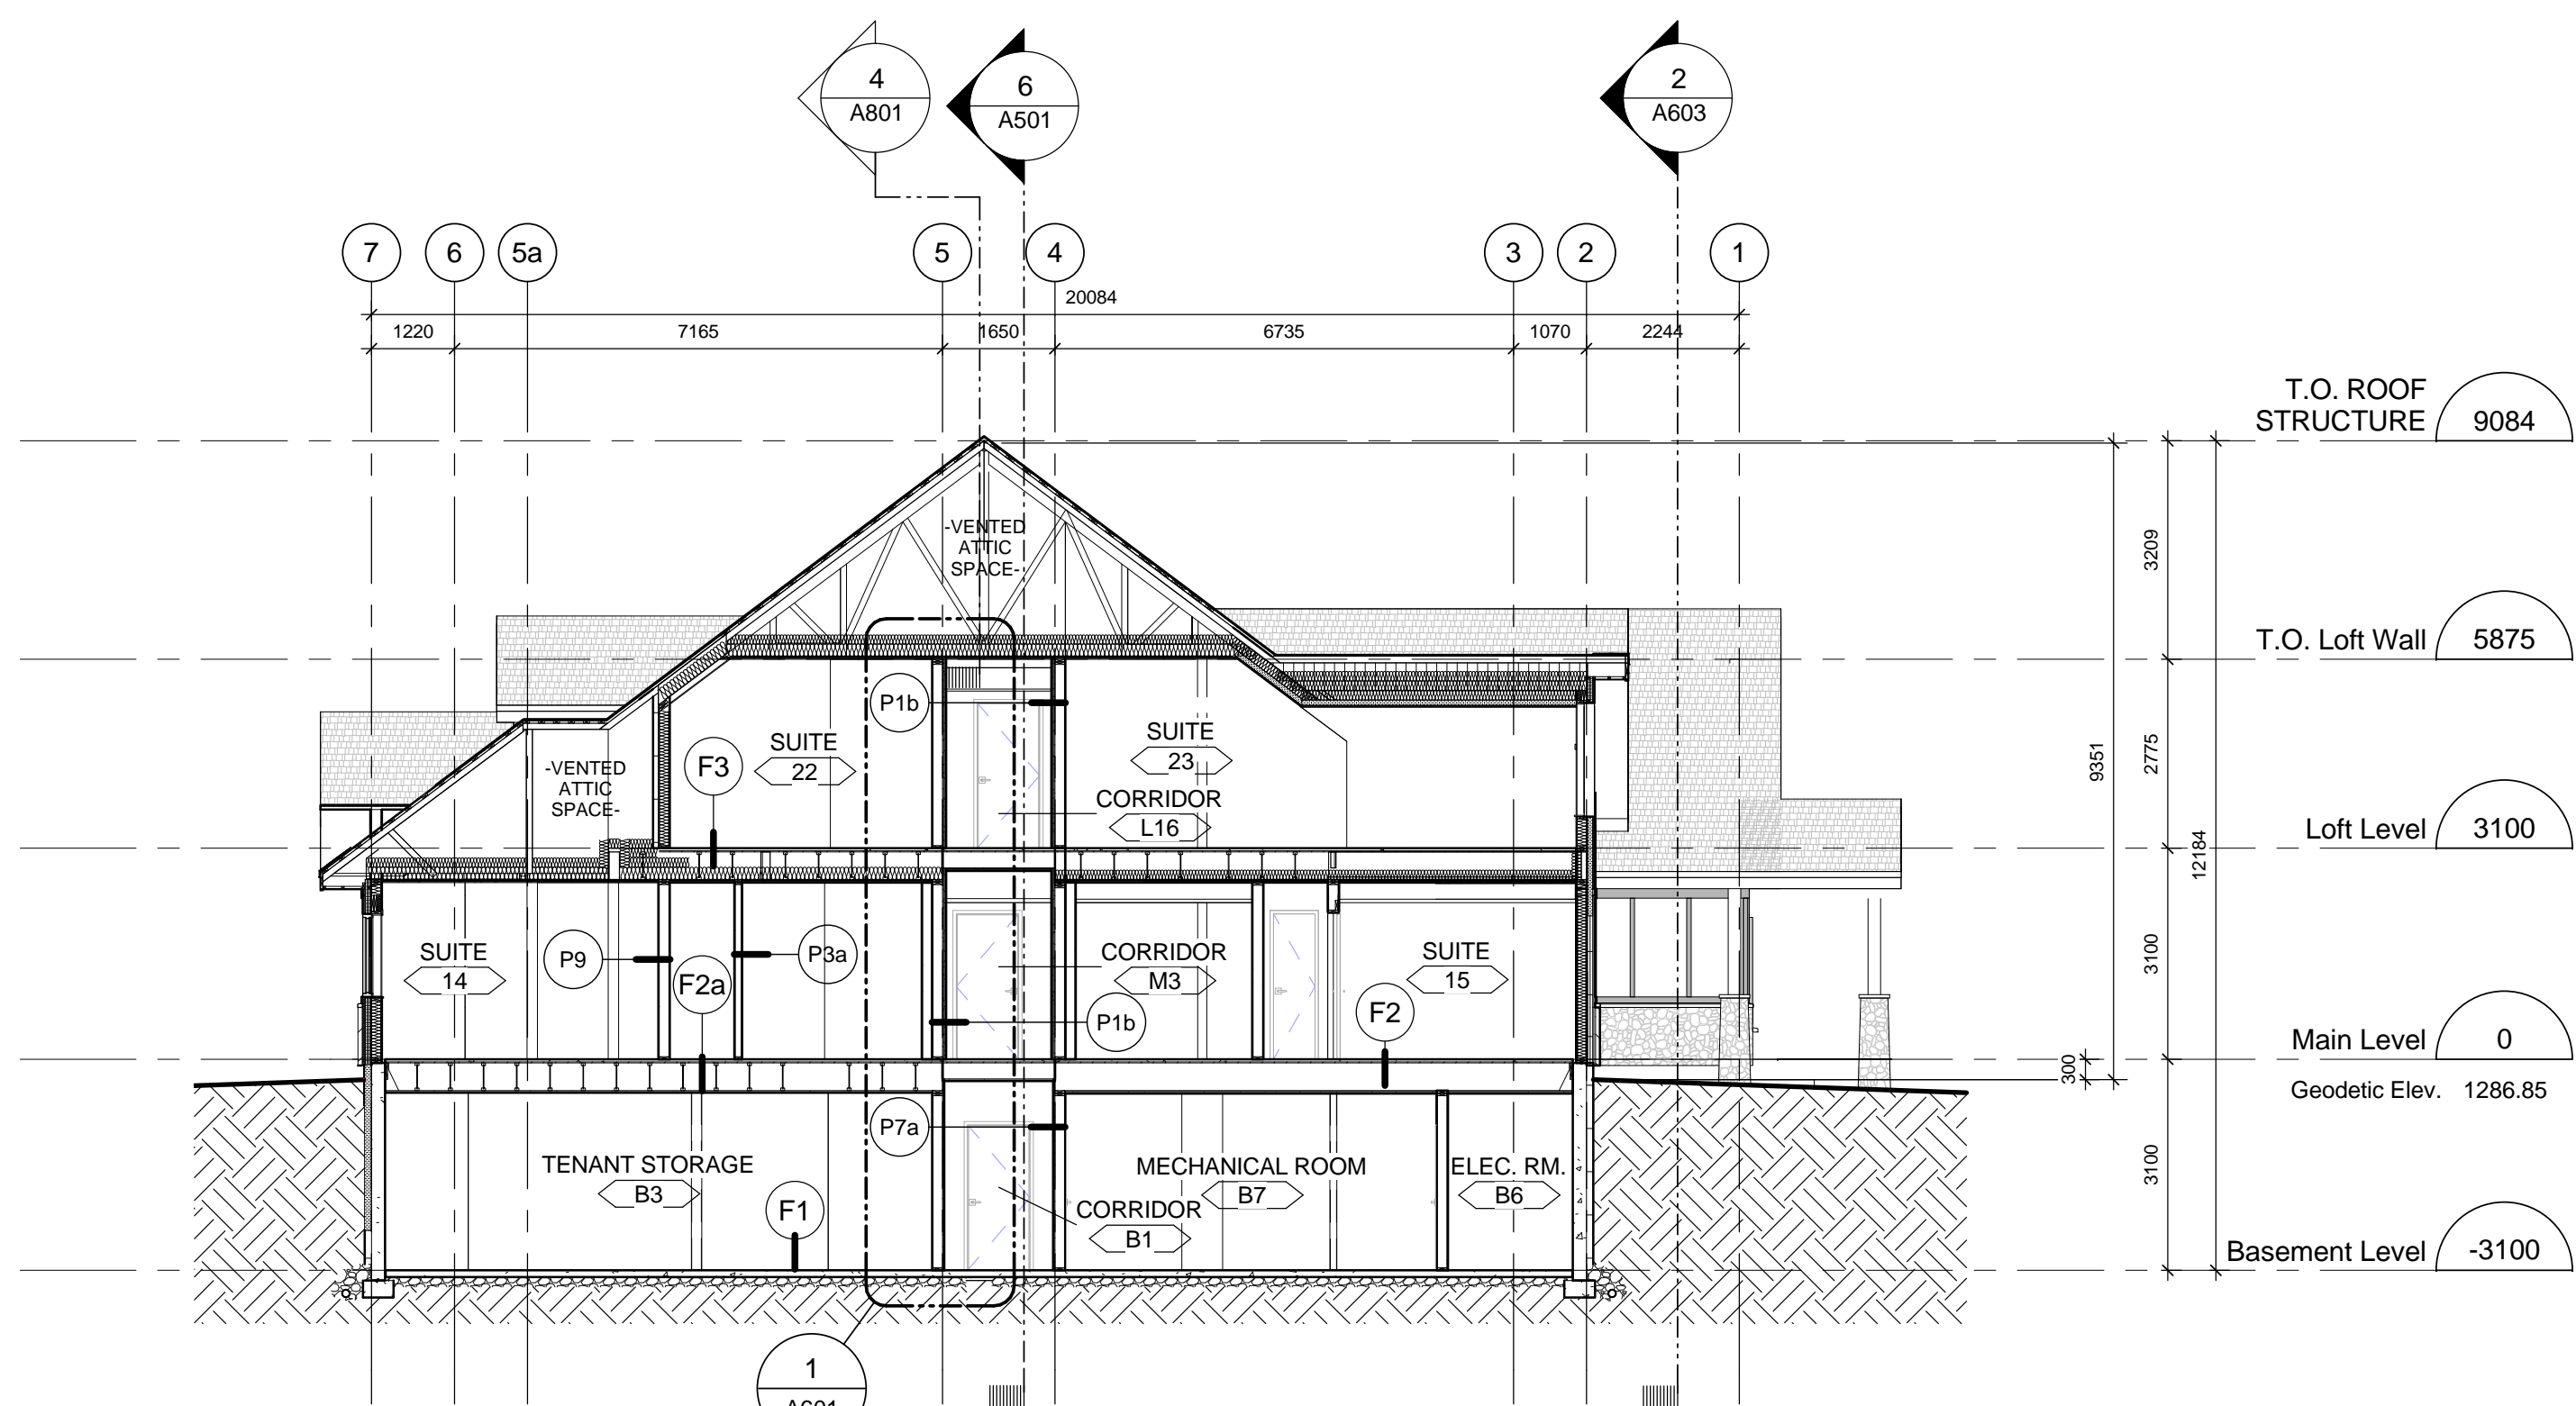

3 BUILDING SECTION 04
A501 Scale: 1 : 100

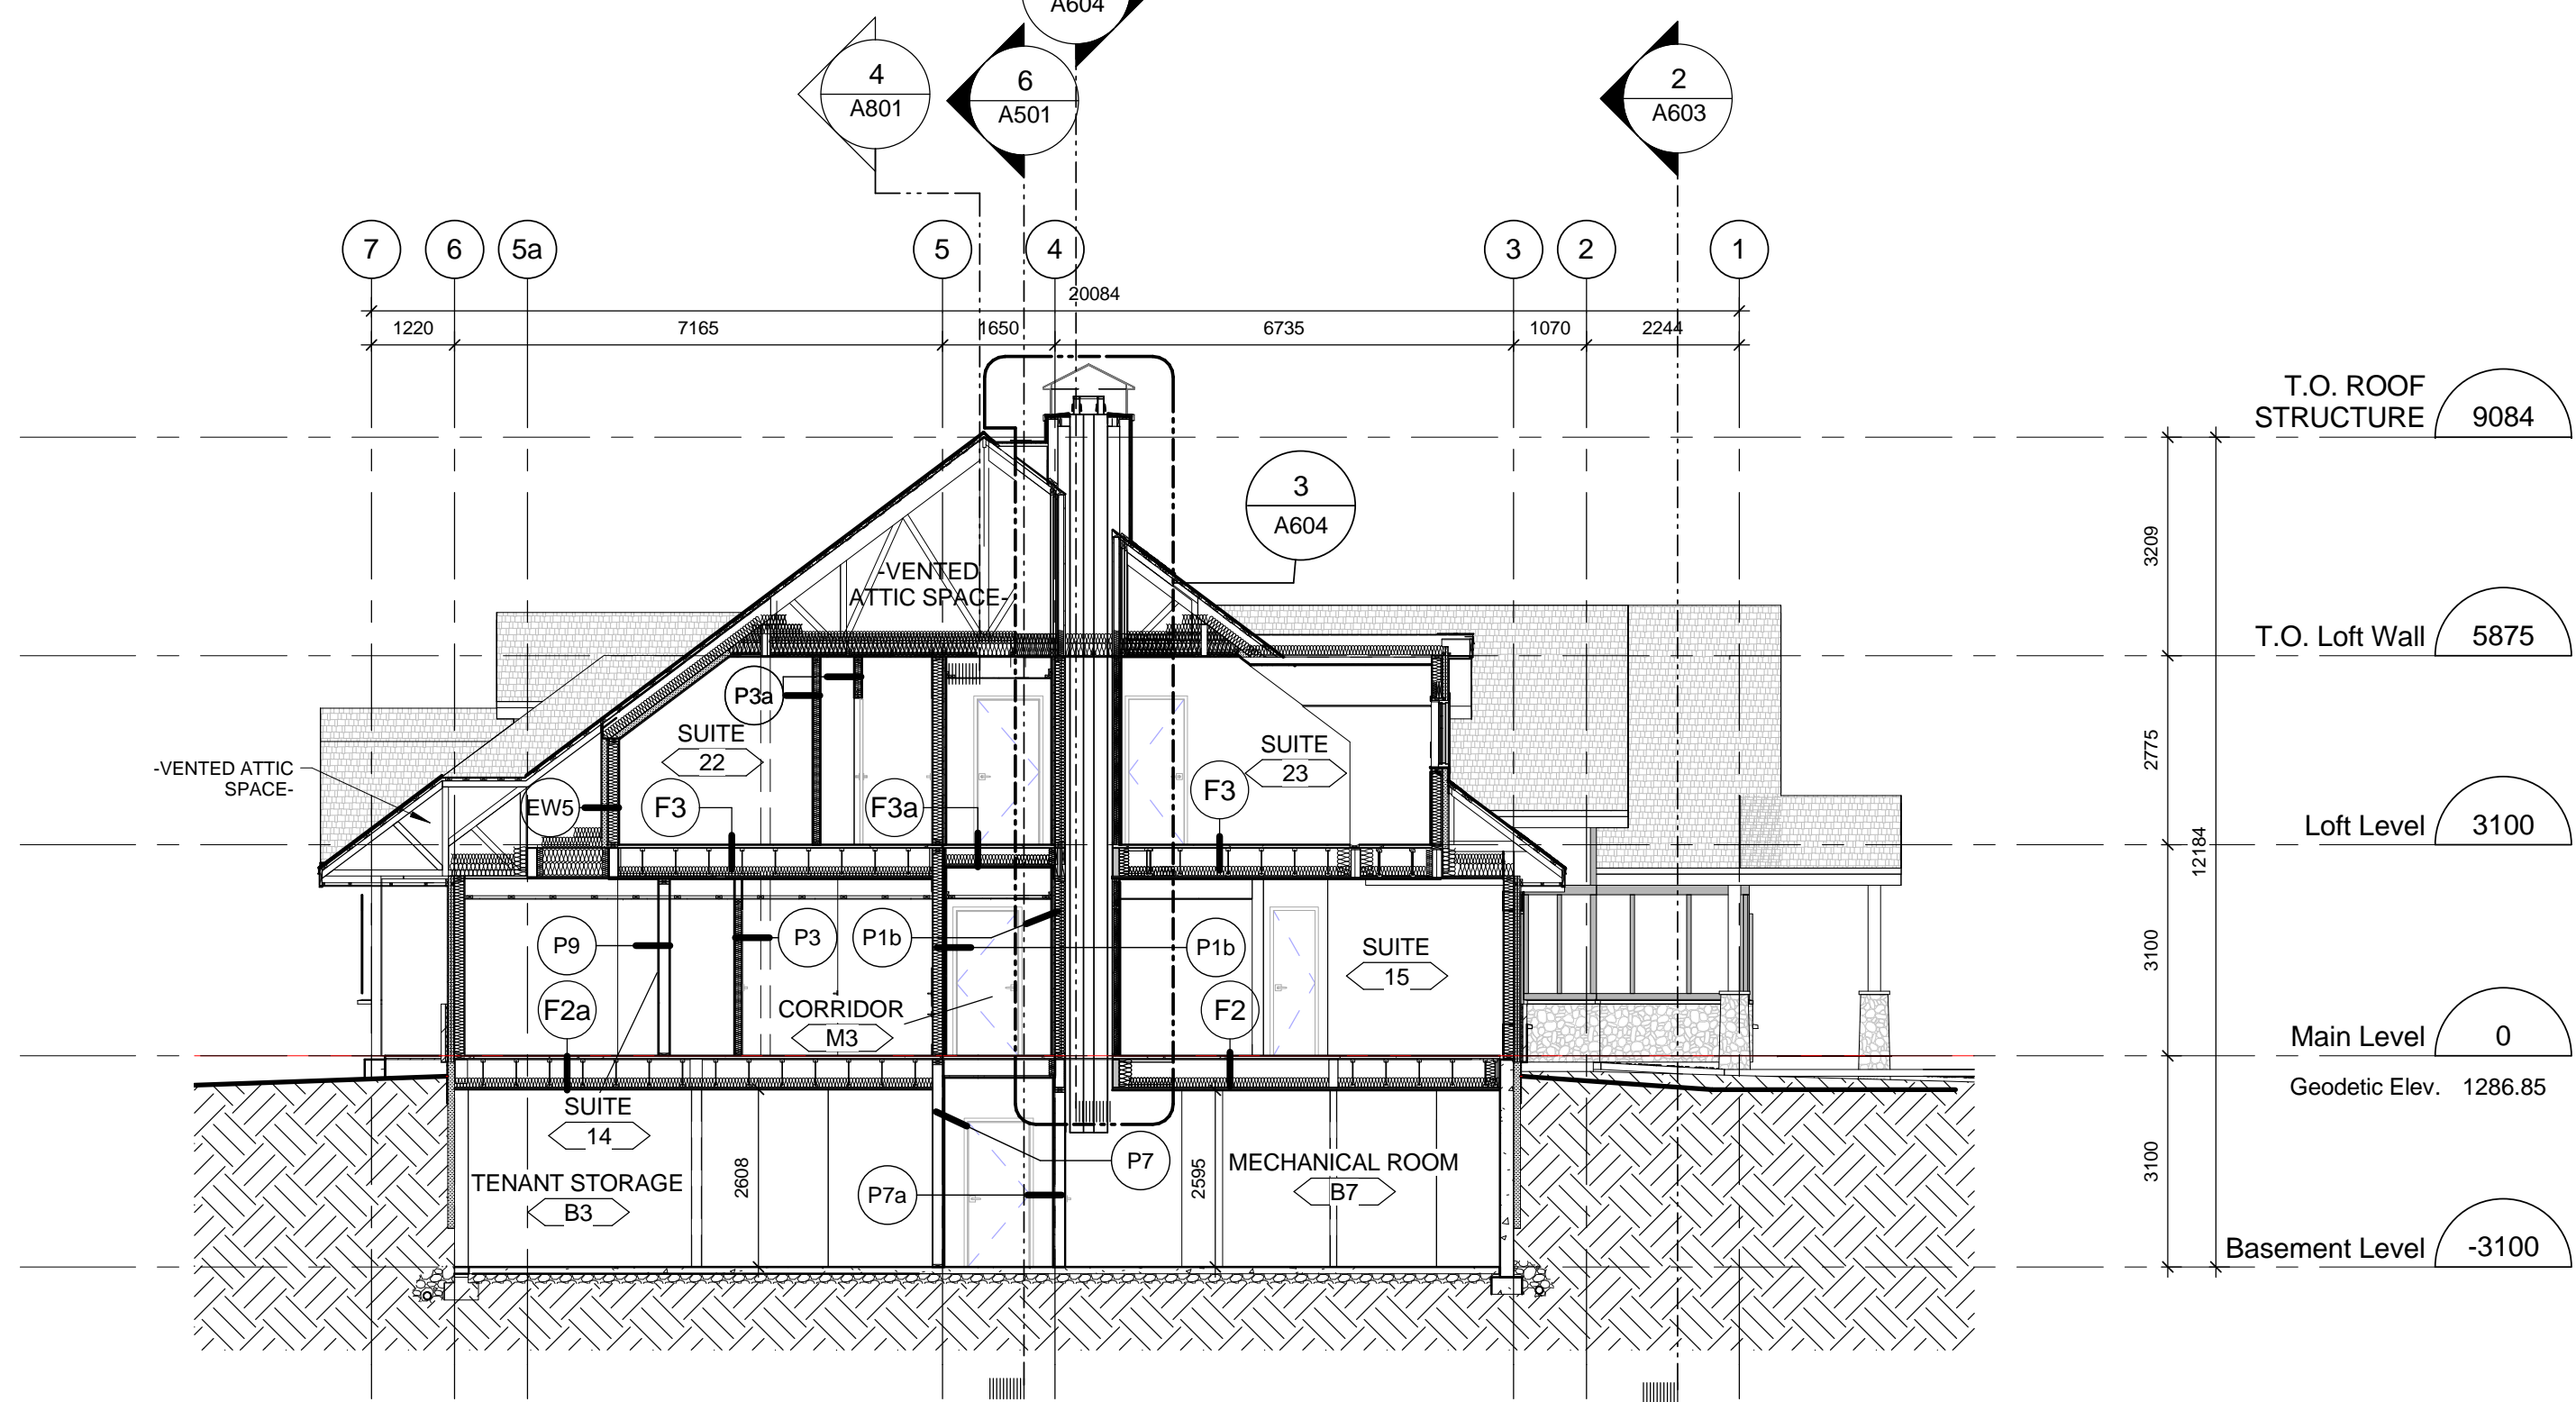

2 BUILDING SECTION 03
A501 Scale: 1 : 100

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6	2016-12-08	ISSUED FOR TENDER		
5	2016-12-08	ISSUED FOR BUILDING PERMIT		
4	2016-08-02	ISSUED FOR 99% REVIEW		
3	2016-06-14	ISSUED FOR 66% REVIEW		
2	2016-05-09	ISSUED FOR 33% REVIEW		
1	2016-05-06	DEVELOPMENT PERMIT REVIEW		

Revision / Revision	
A detail number numéro de détail	A
B source drawing no. de dessin no.	B
C detail on drawing no. détail sur dessin no.	C

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	Western and Northern Region	Ouest et Nord du Canada

Staff Housing Phase 2 Waterton Lakes National Park

BUILDING SECTIONS

Surveyed by/Arpenté par	Drawn by/Dessiné par	Date/Date
LS/FVR	MP/AG	2016-12-08
Designed by/Concept par	Reviewed by/Revisé par	Scale/Echelle
LS/FVR	LS/FVR	1 : 100

PWGSC Project Manager/Administrateur de Projets TPSPCC
Randy Boldt



Client Acceptance/Acceptation du client
Approved by/Approuvé par

Task Responsible/Officer/Agent Responsable

Project No./No. du projet
39000

Asset No./No. du bien
FII # 945

Sheet No./
No. de la feuille
A501

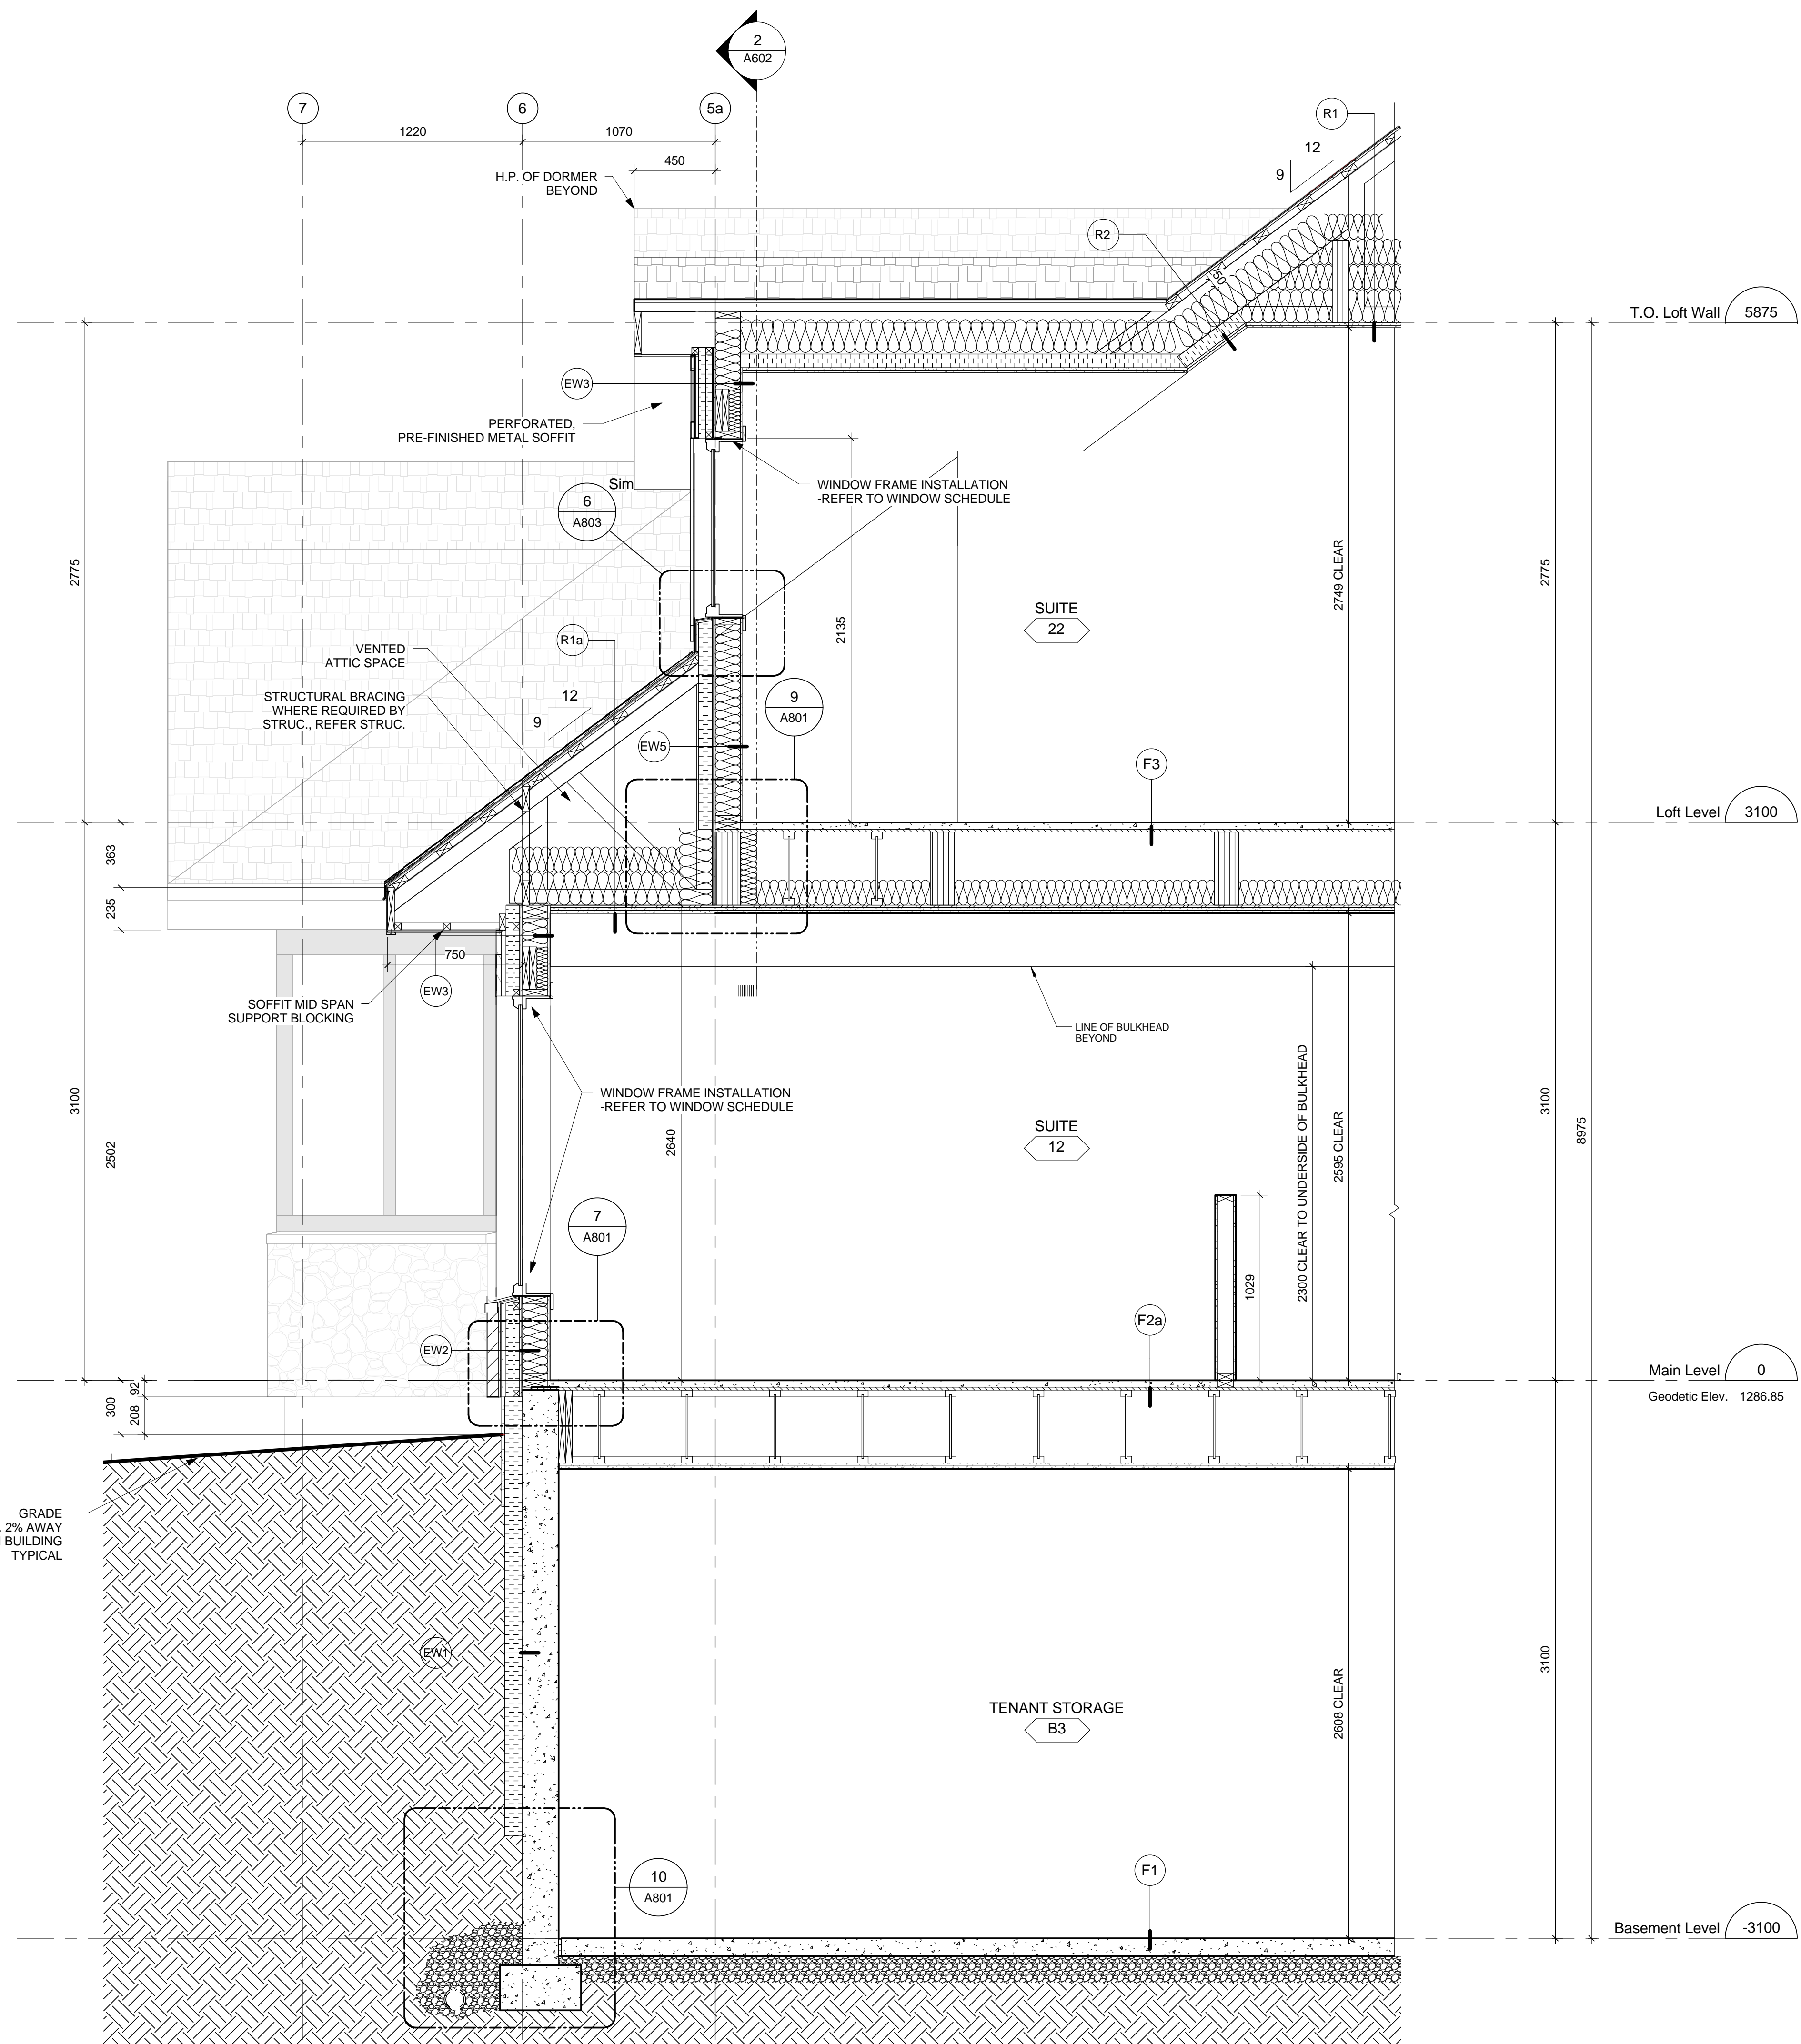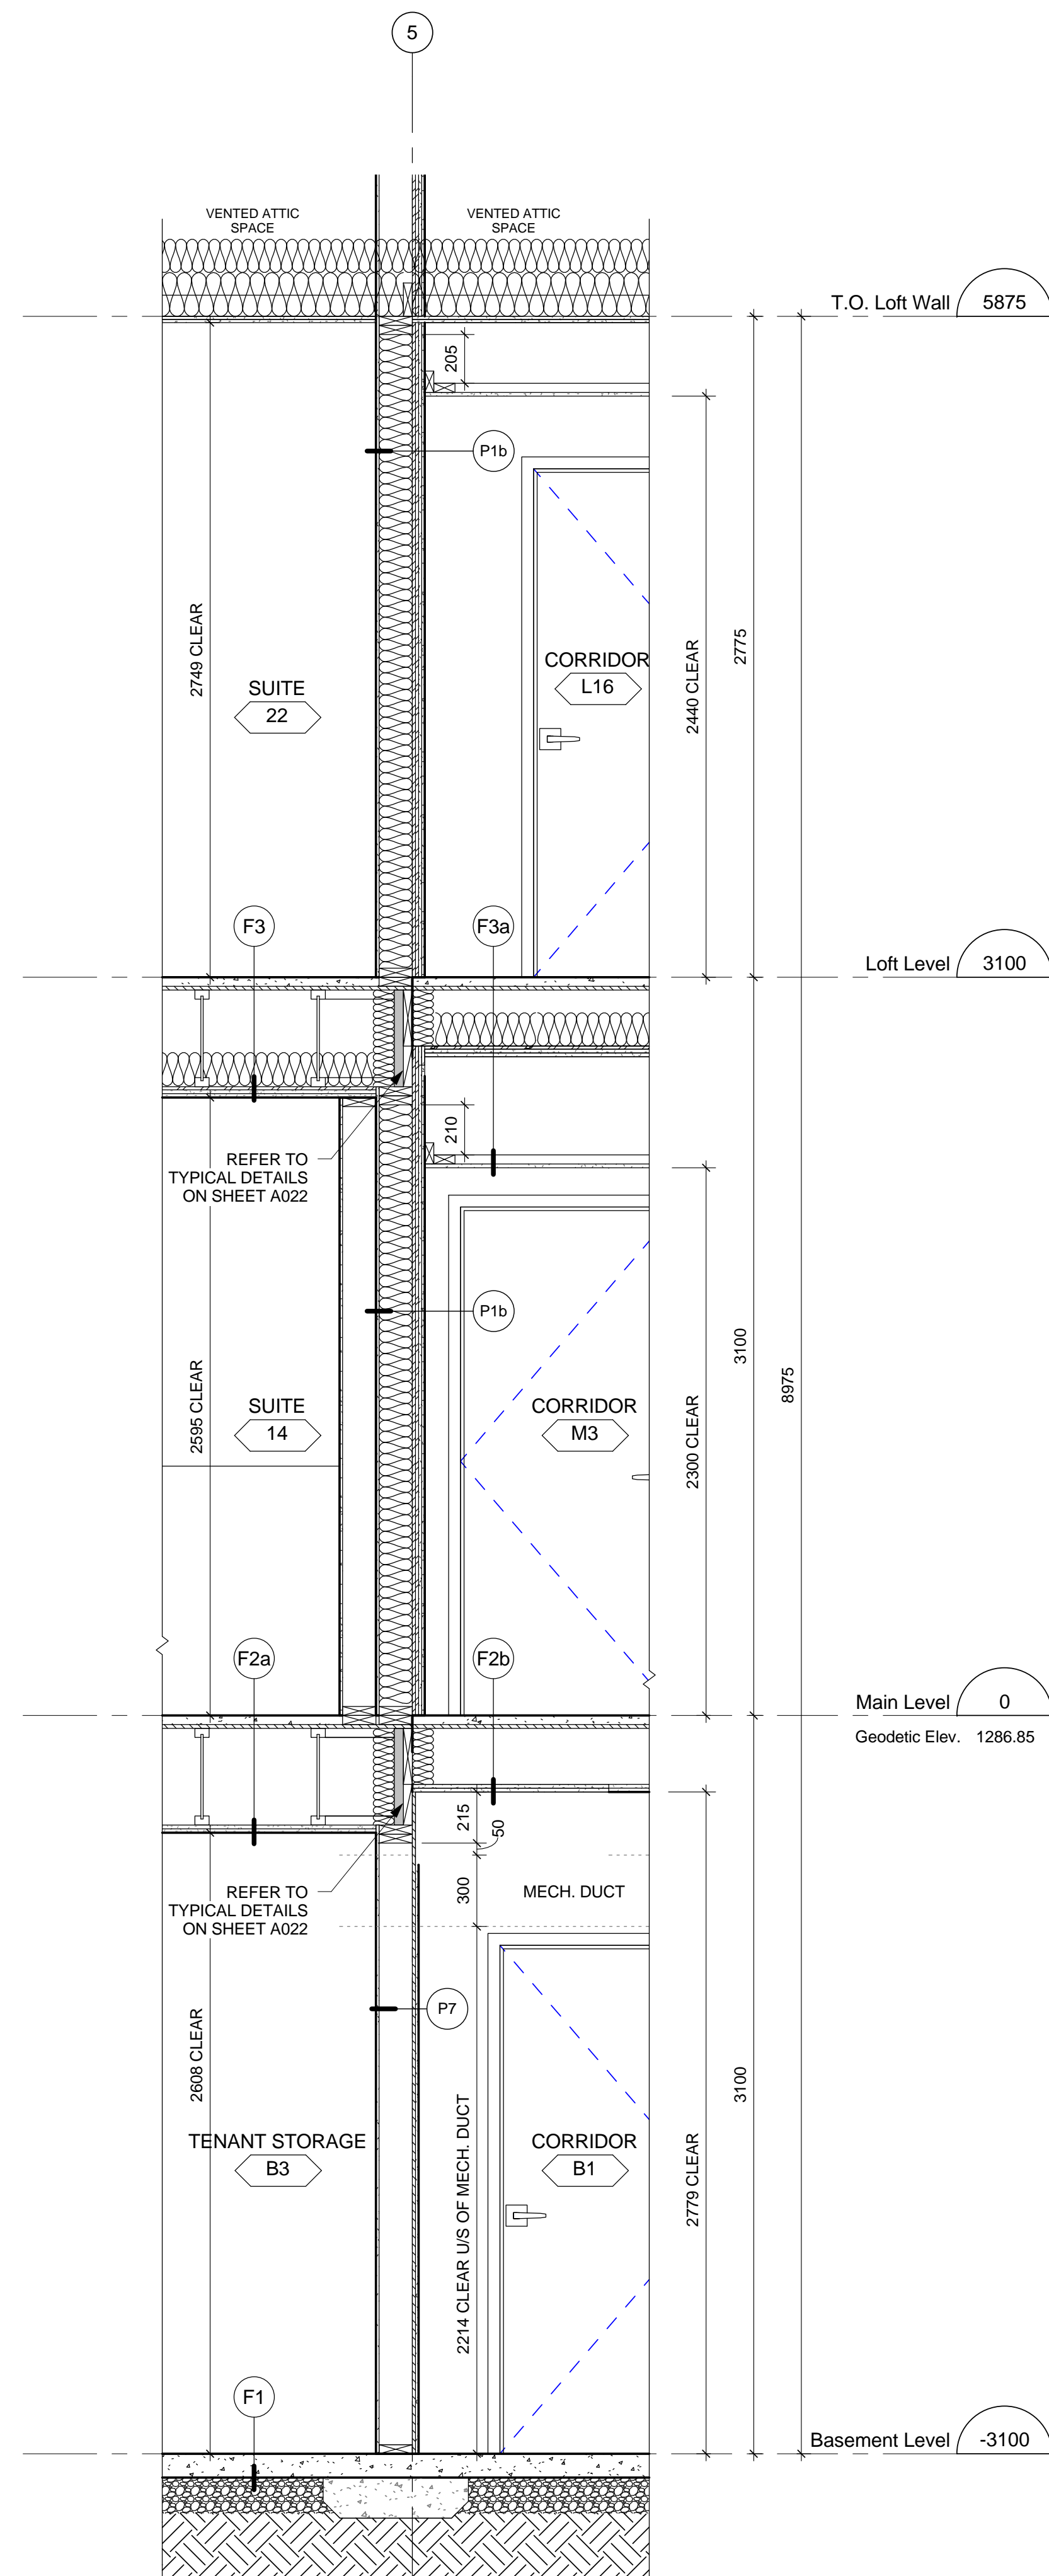



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5	2016-12-08	ISSUED FOR BUILDING PERMIT		
4	2016-09-02	ISSUED FOR 99% REVIEW		
3	2016-06-14	ISSUED FOR 66% REVIEW		
2	2016-05-09	ISSUED FOR 33% REVIEW		
1	2016-05-06	DEVELOPMENT PERMIT REVIEW		

No.	Date/Date	Description/Description	Drawn by Dessine par	Approved Approuve
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Revision / Revision		
	<p>A detail number numero de detail</p> <p>B source drawing no. de dessin no.</p> <p>C detail on drawing no. detail sur dessin no.</p>	

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eau de l'ingénieur

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Agence Parcs
Canada

Western and Northern Region Ouest et Nord du Canada

Project title/Titre du projet

Staff Housing Phase 2 Waterton Lakes National Park

Drawing title/Titre du dessin

WALL SECTIONS

Surveyed by/Arpente par	Drawn by/Dessine par MP	Date/Date 2016-12-08
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Designed by/Concept par LS/FVR	Reviewed by/Revisé par LS/FVR	Scale/Echelle 1 : 20
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TPSGC Project Manager/Administrateur de Projets TPSGC


Randy Boldt

Client Acceptance/Acceptation du client	Approved by/Approuvé par
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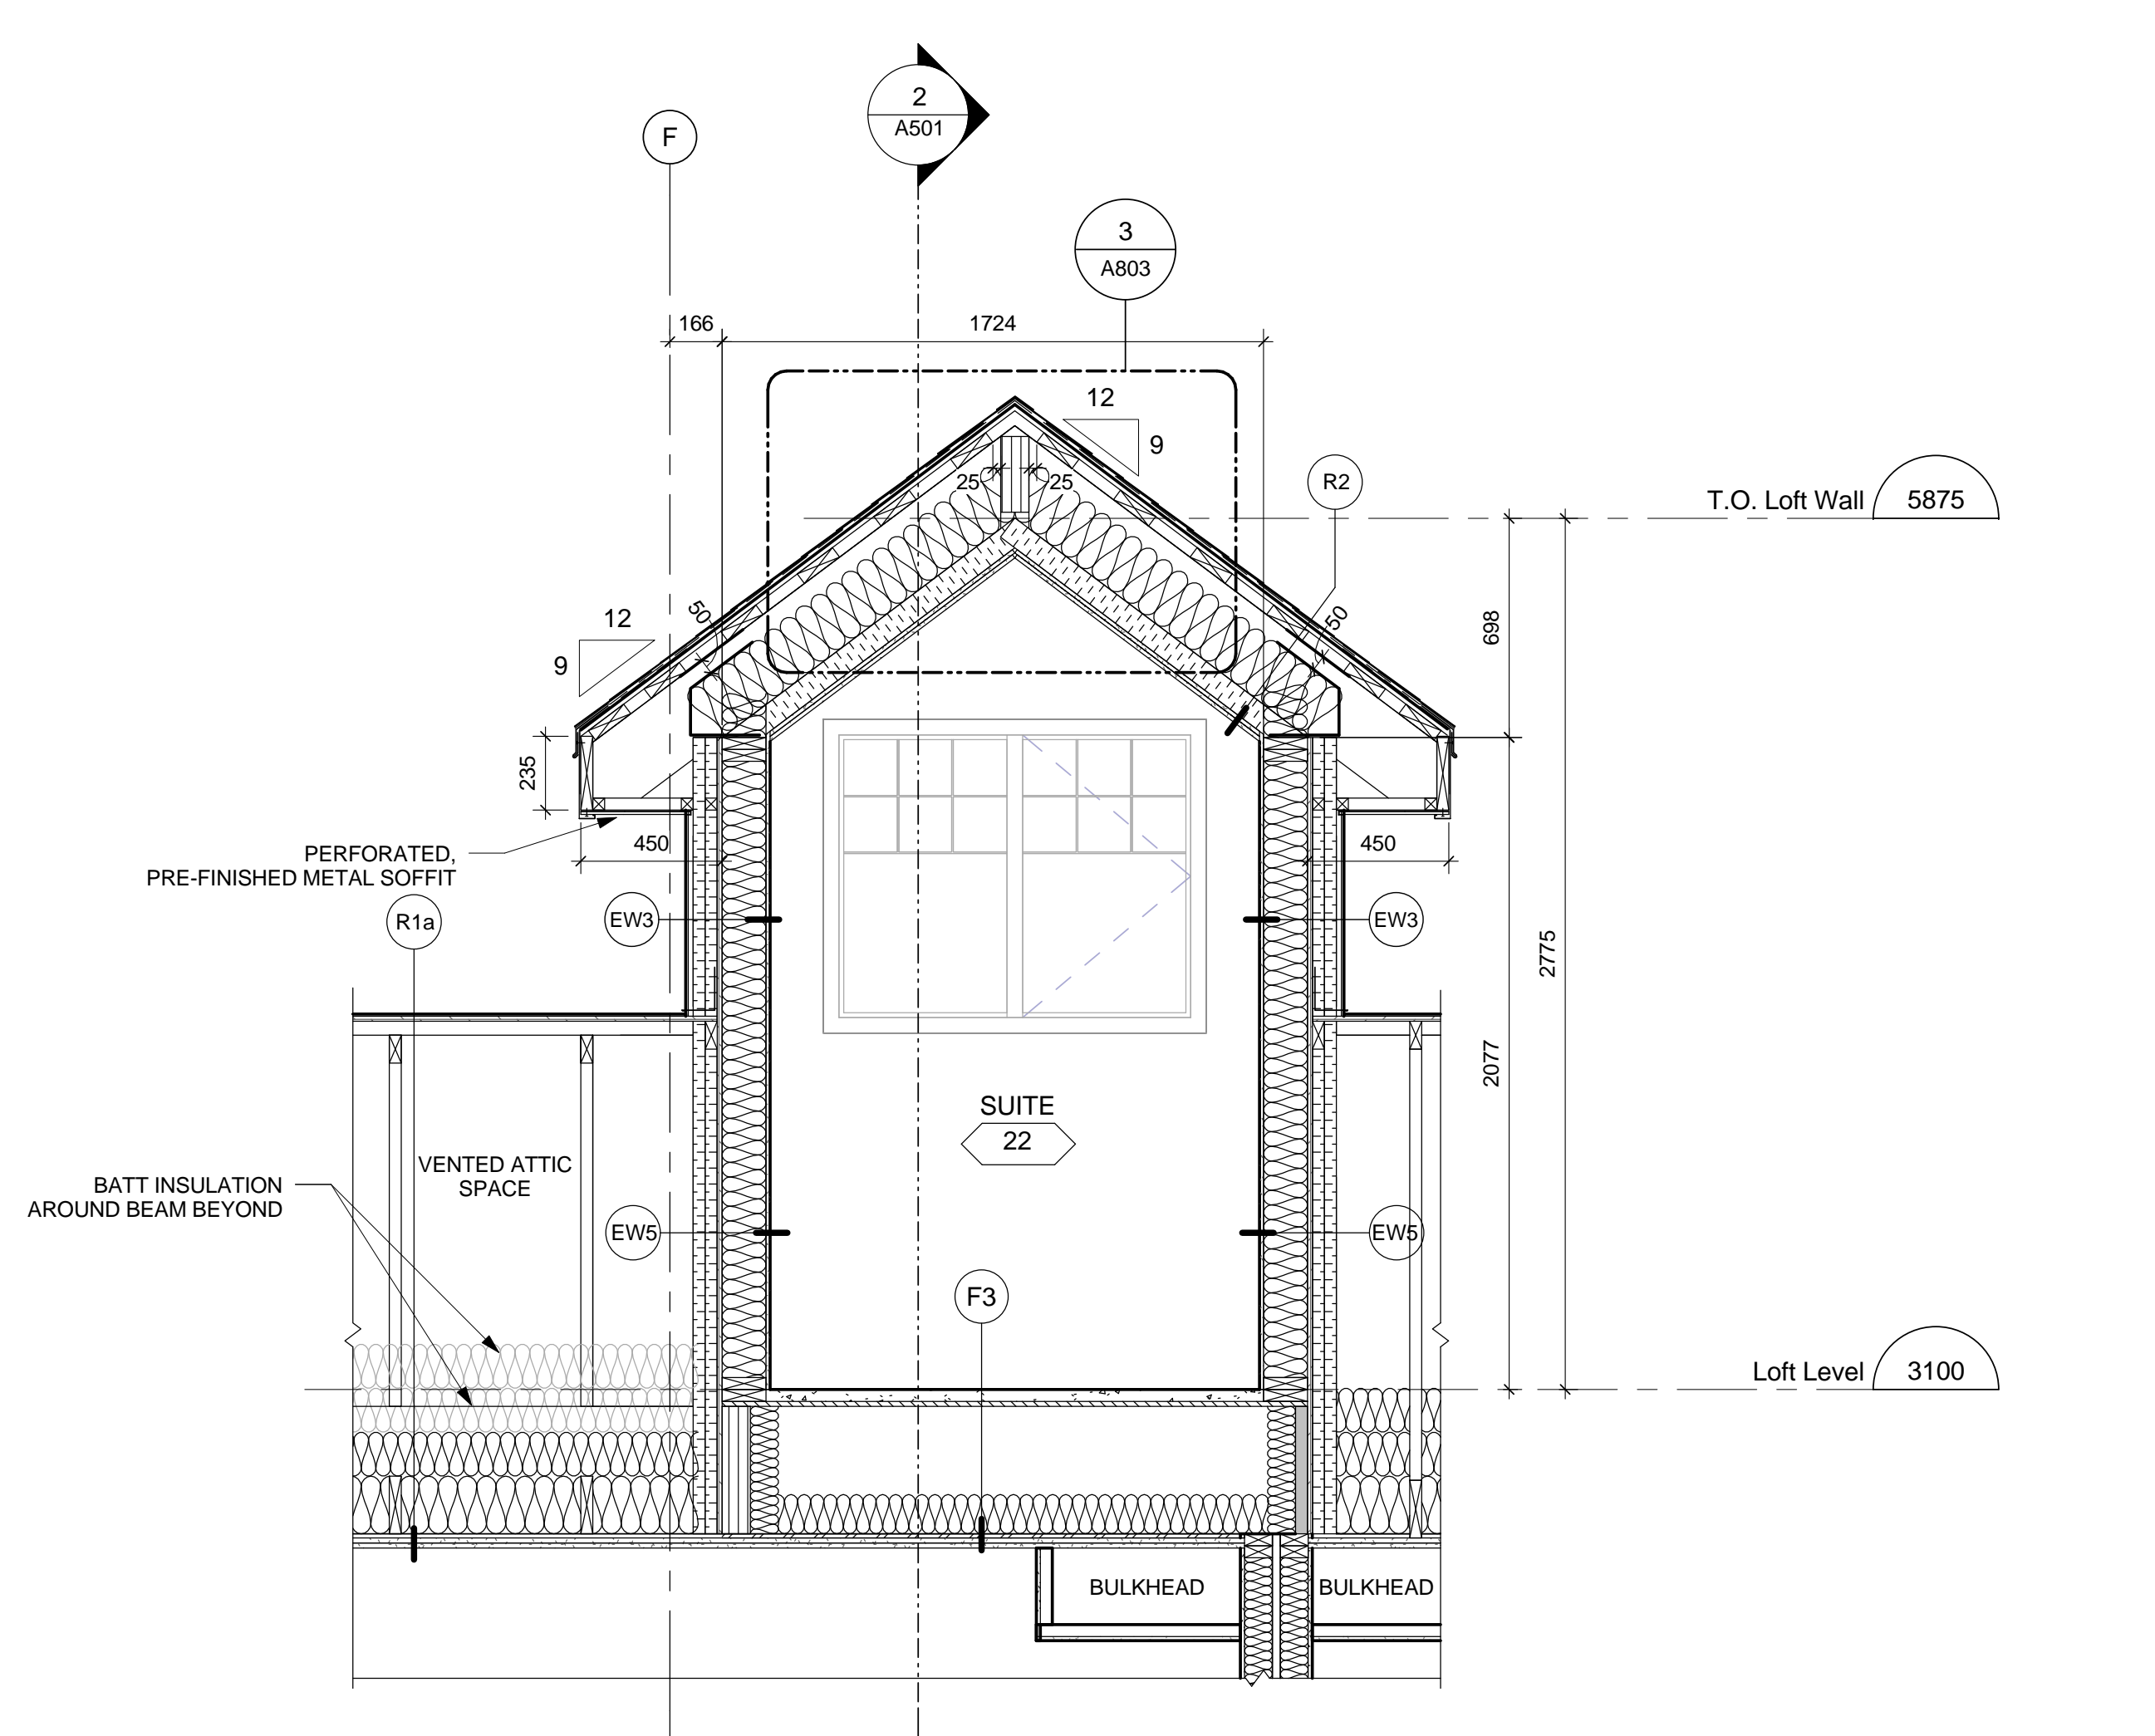
Proj. Desempenho Officer/Assist. Desempenho
 BR/CC - Diretor-Monitore/Adm[inistrador de Qualidade - TDCQ

Project No /No. du projet		Asset No /No. du bien	Sheet No /
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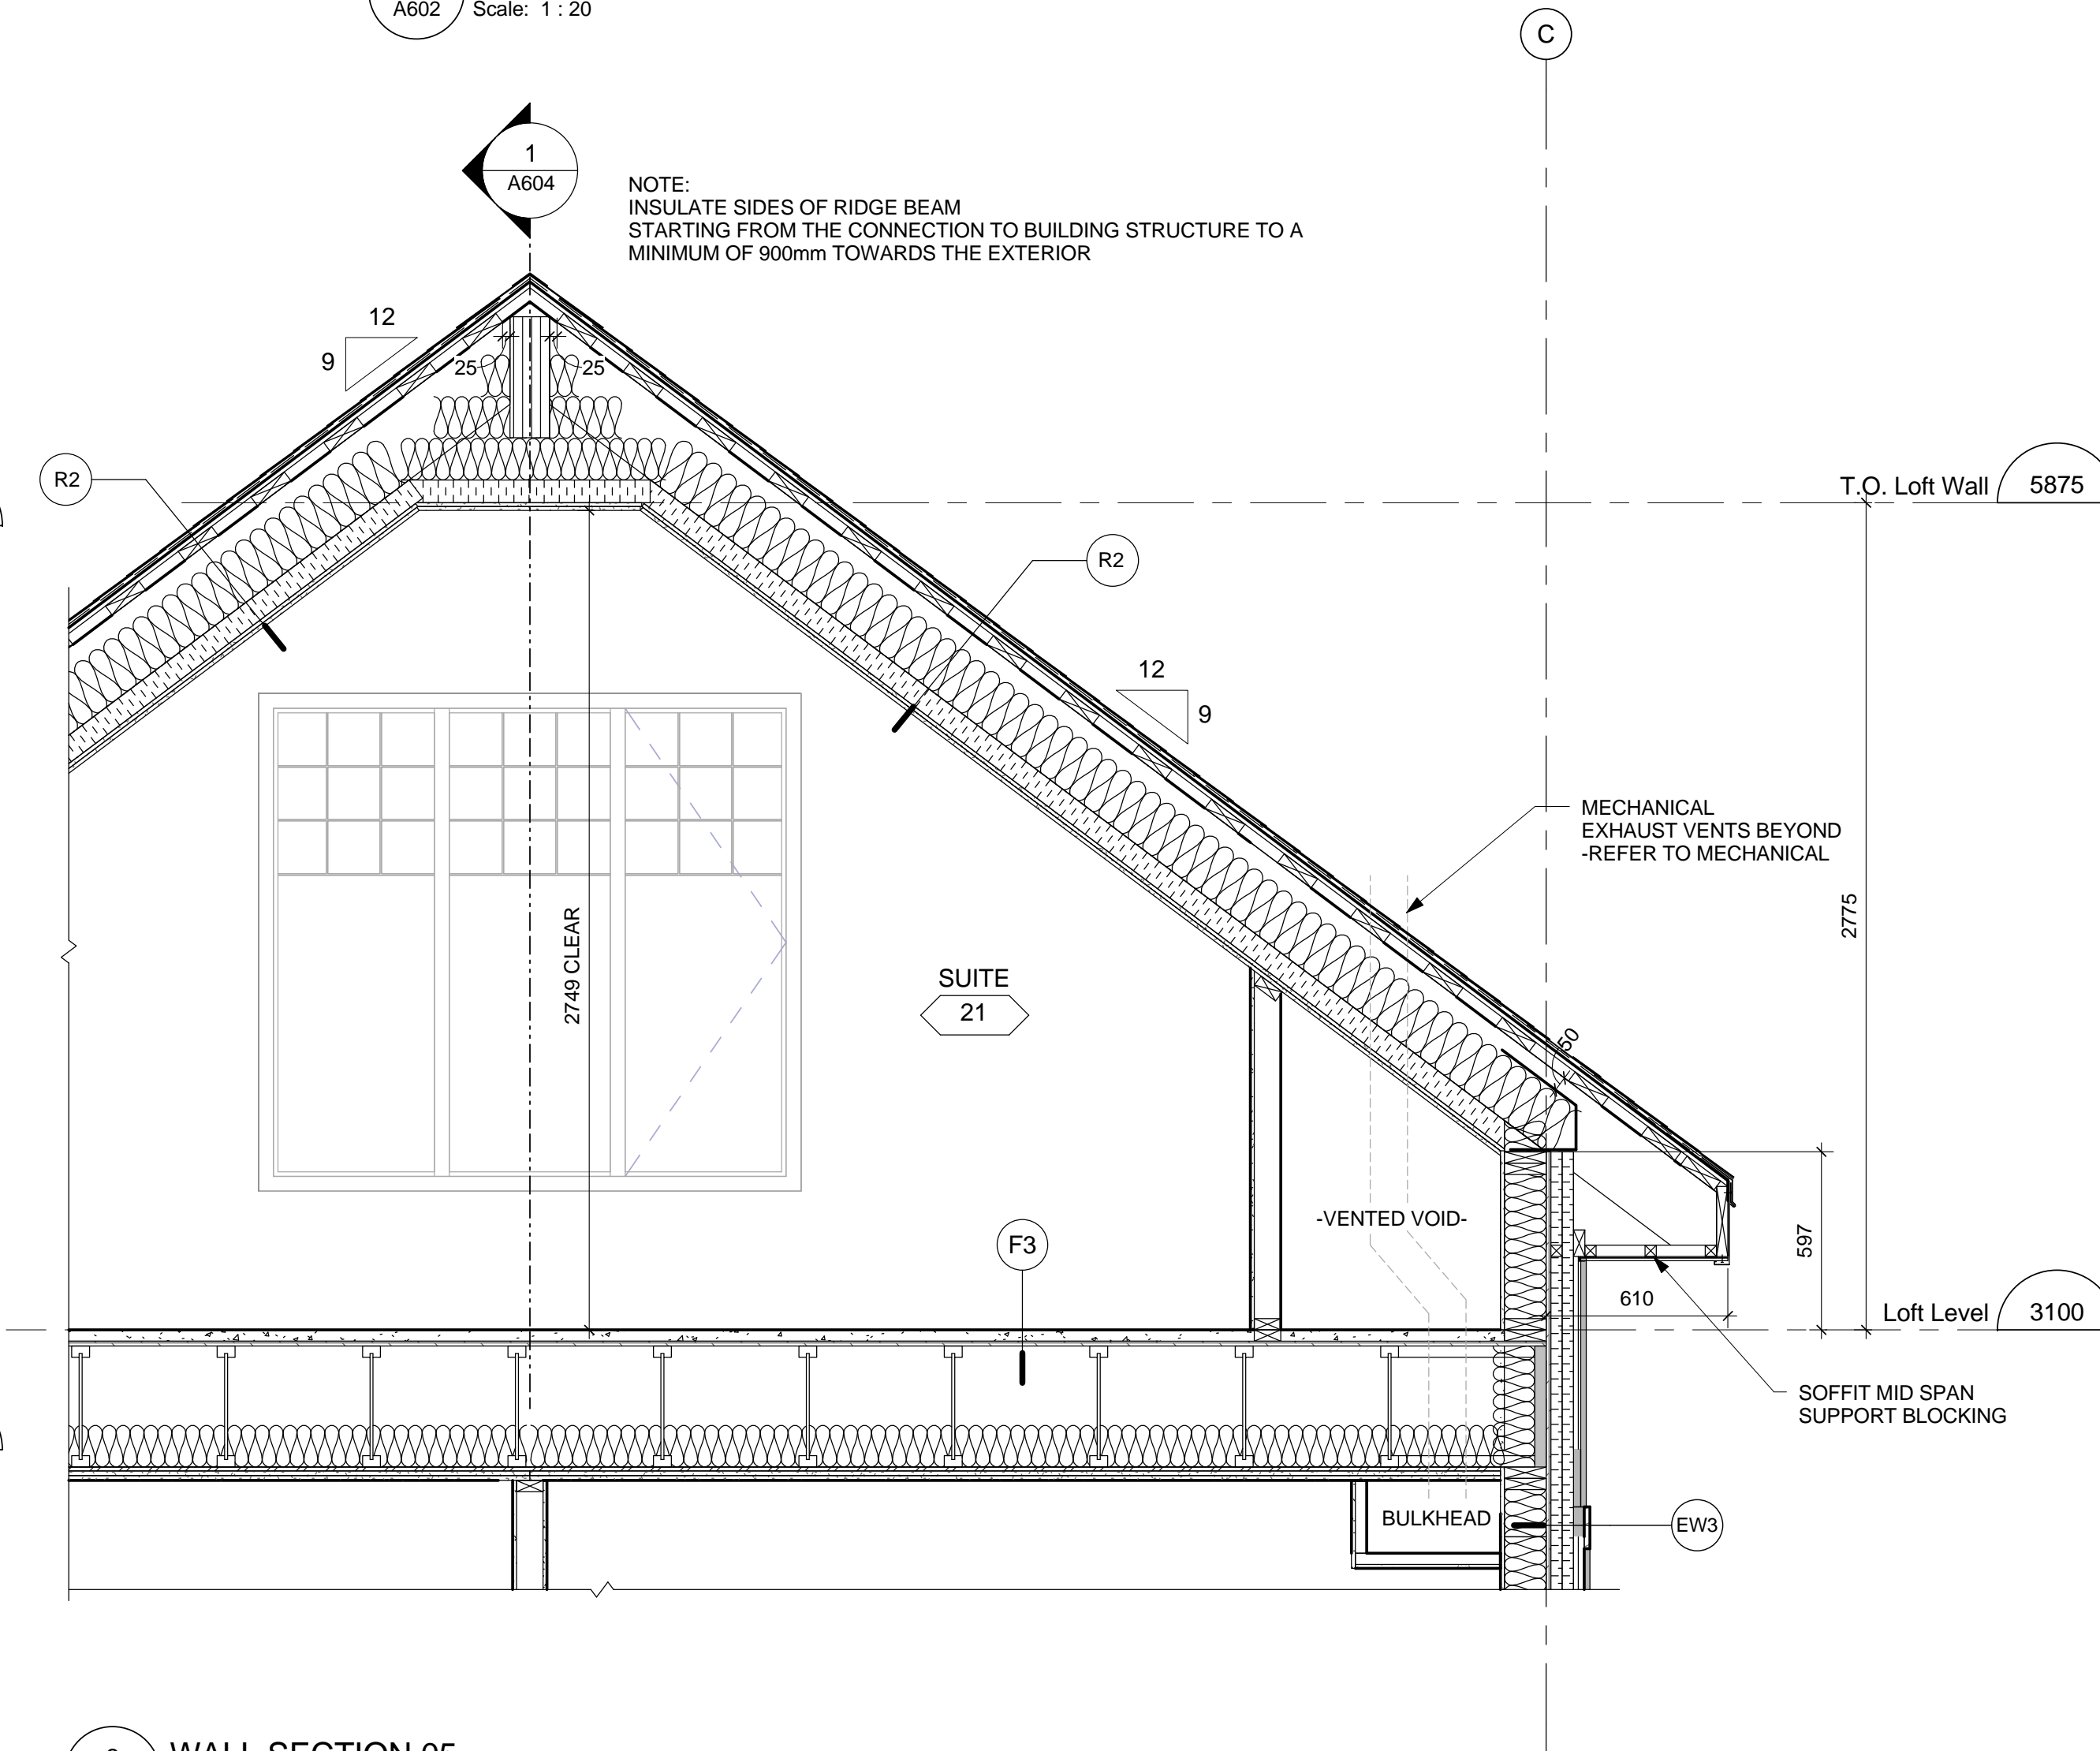
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1 WALL SECTION 03
A602 Scale: 1 : 20



2 WALL SECTION 04
A602 Scale: 1 : 20

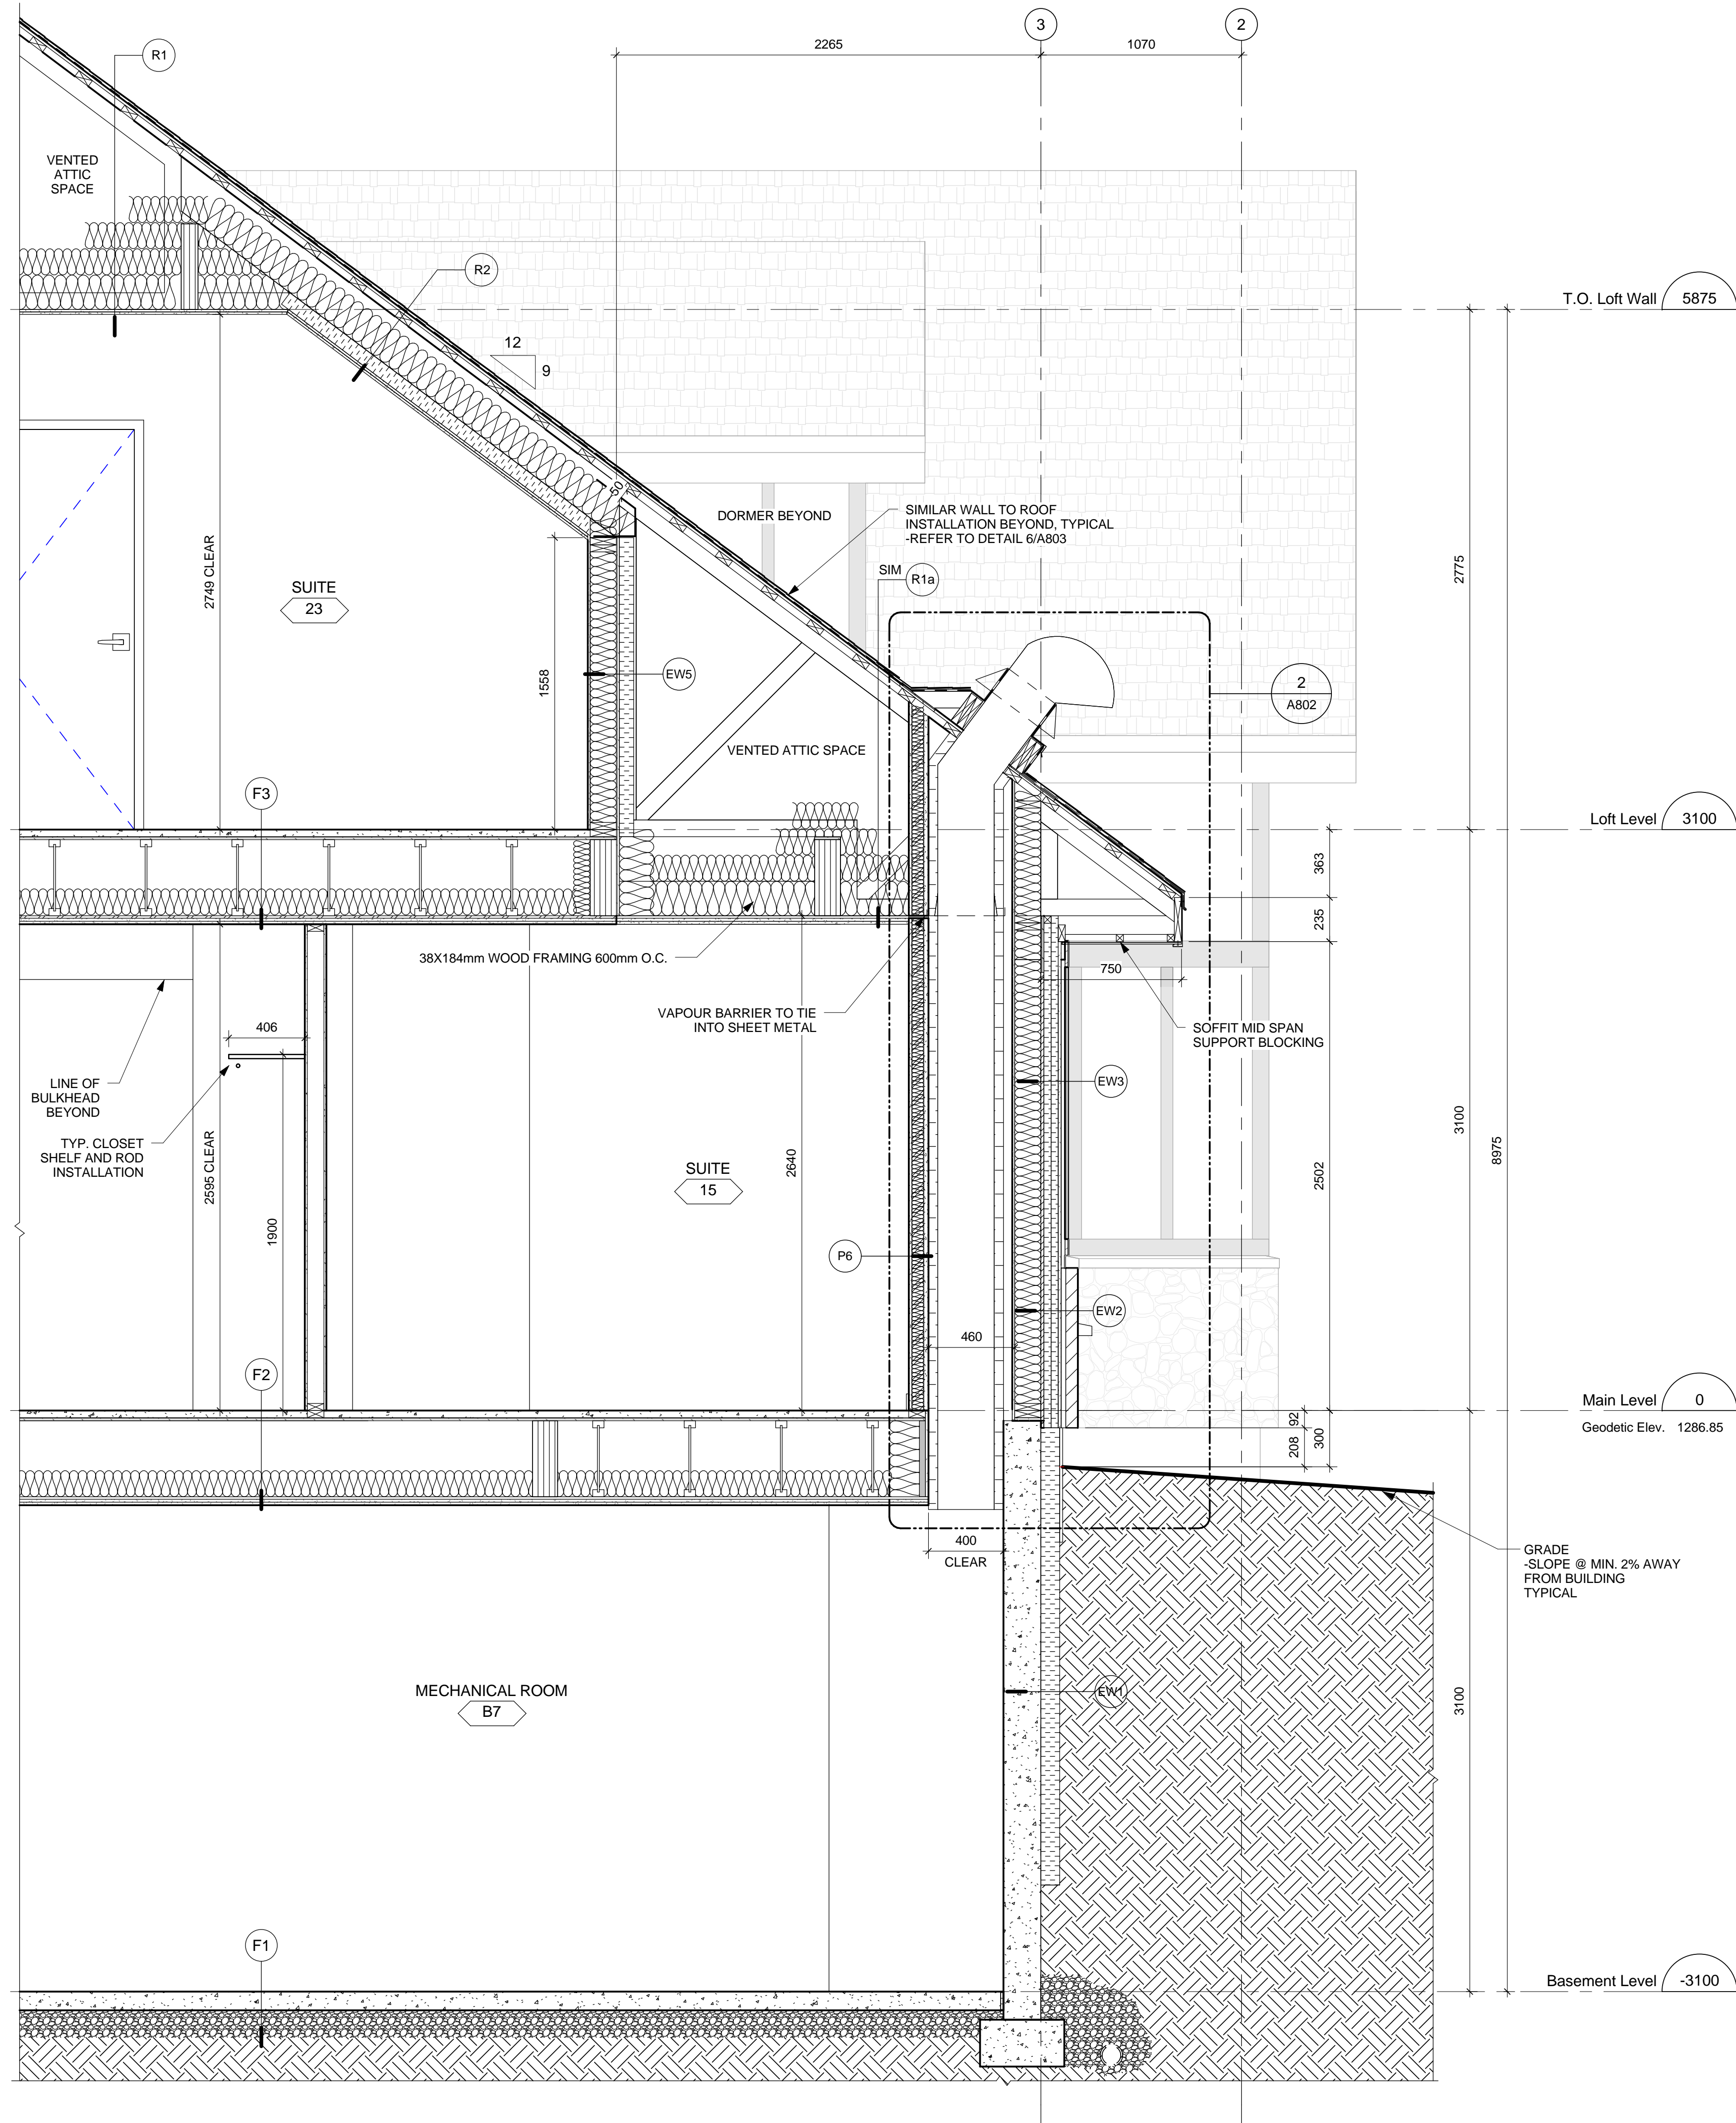

3 WALL SECTION 05
A602 Scale: 1 : 20

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3	2016-12-08	ISSUED FOR BUILDING PERMIT		
2	2016-09-02	ISSUED FOR 99% REVIEW		
1	2016-06-14	ISSUED FOR 66% REVIEW		

Revision /	Revision
A	detail number numéro de détail
B	source drawing no. de dessin no.
C	detail on drawing no. détail sur dessin no.

Consultant's Name
Nom de l'expert-conseil

Eng. Stamp
Sceau de l'ingénieur


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Client Services Team
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L'Agence Parcs
Canada
Western and
Northern Region
Ouest et Nord
du Canada

Project title/Titre du projet
Staff Housing Phase 2
Waterton Lakes National
Park


Drawing title/Titre du dessin
WALL SECTIONS

Surveyed by/Arpenté par LS/FVR	Drawn by/Dessiné par MP	Date/Date 2016-12-08
Designed by/Concept par LS/FVR	Reviewed by/Revisé par LS/FVR	Scale/Echelle 1 : 20
PWGSC Project Manager/Administrateur de Projets TPSCG Randy Boldt		
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Task Responsible/Responsable de la tâche		Task Manager/Administrateur de Projets TPSCG
Project No./No. du projet 39000	Asset No./No. du bien Fil # 945	Sheet No./ No. de la feuille A602
Drawing Reference No./No. de référence du dessin		

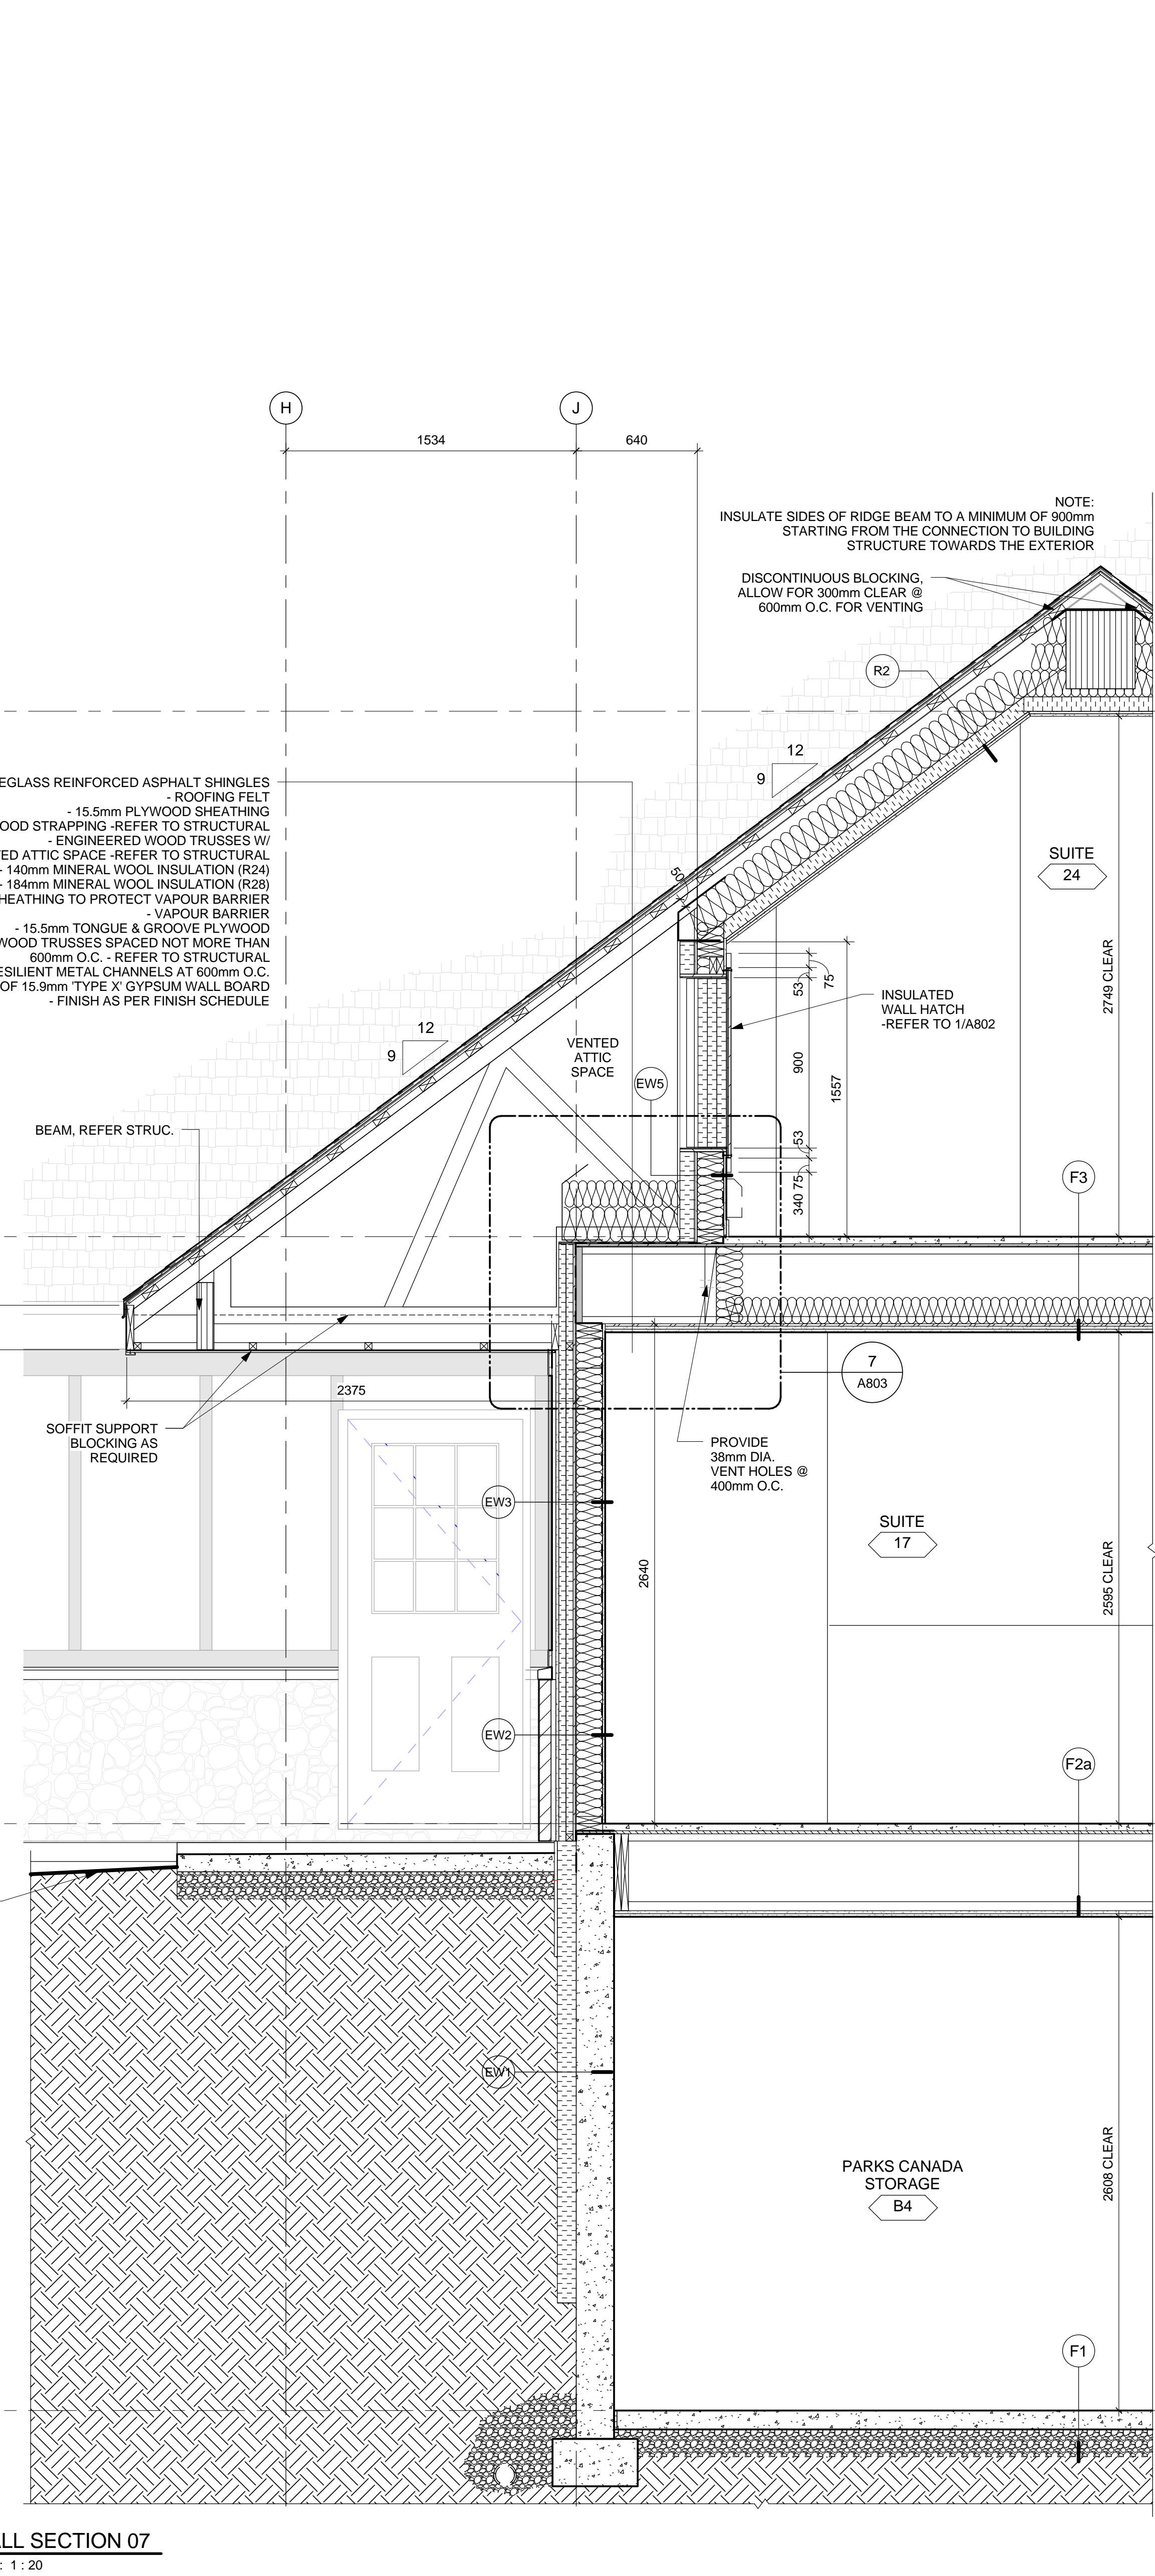


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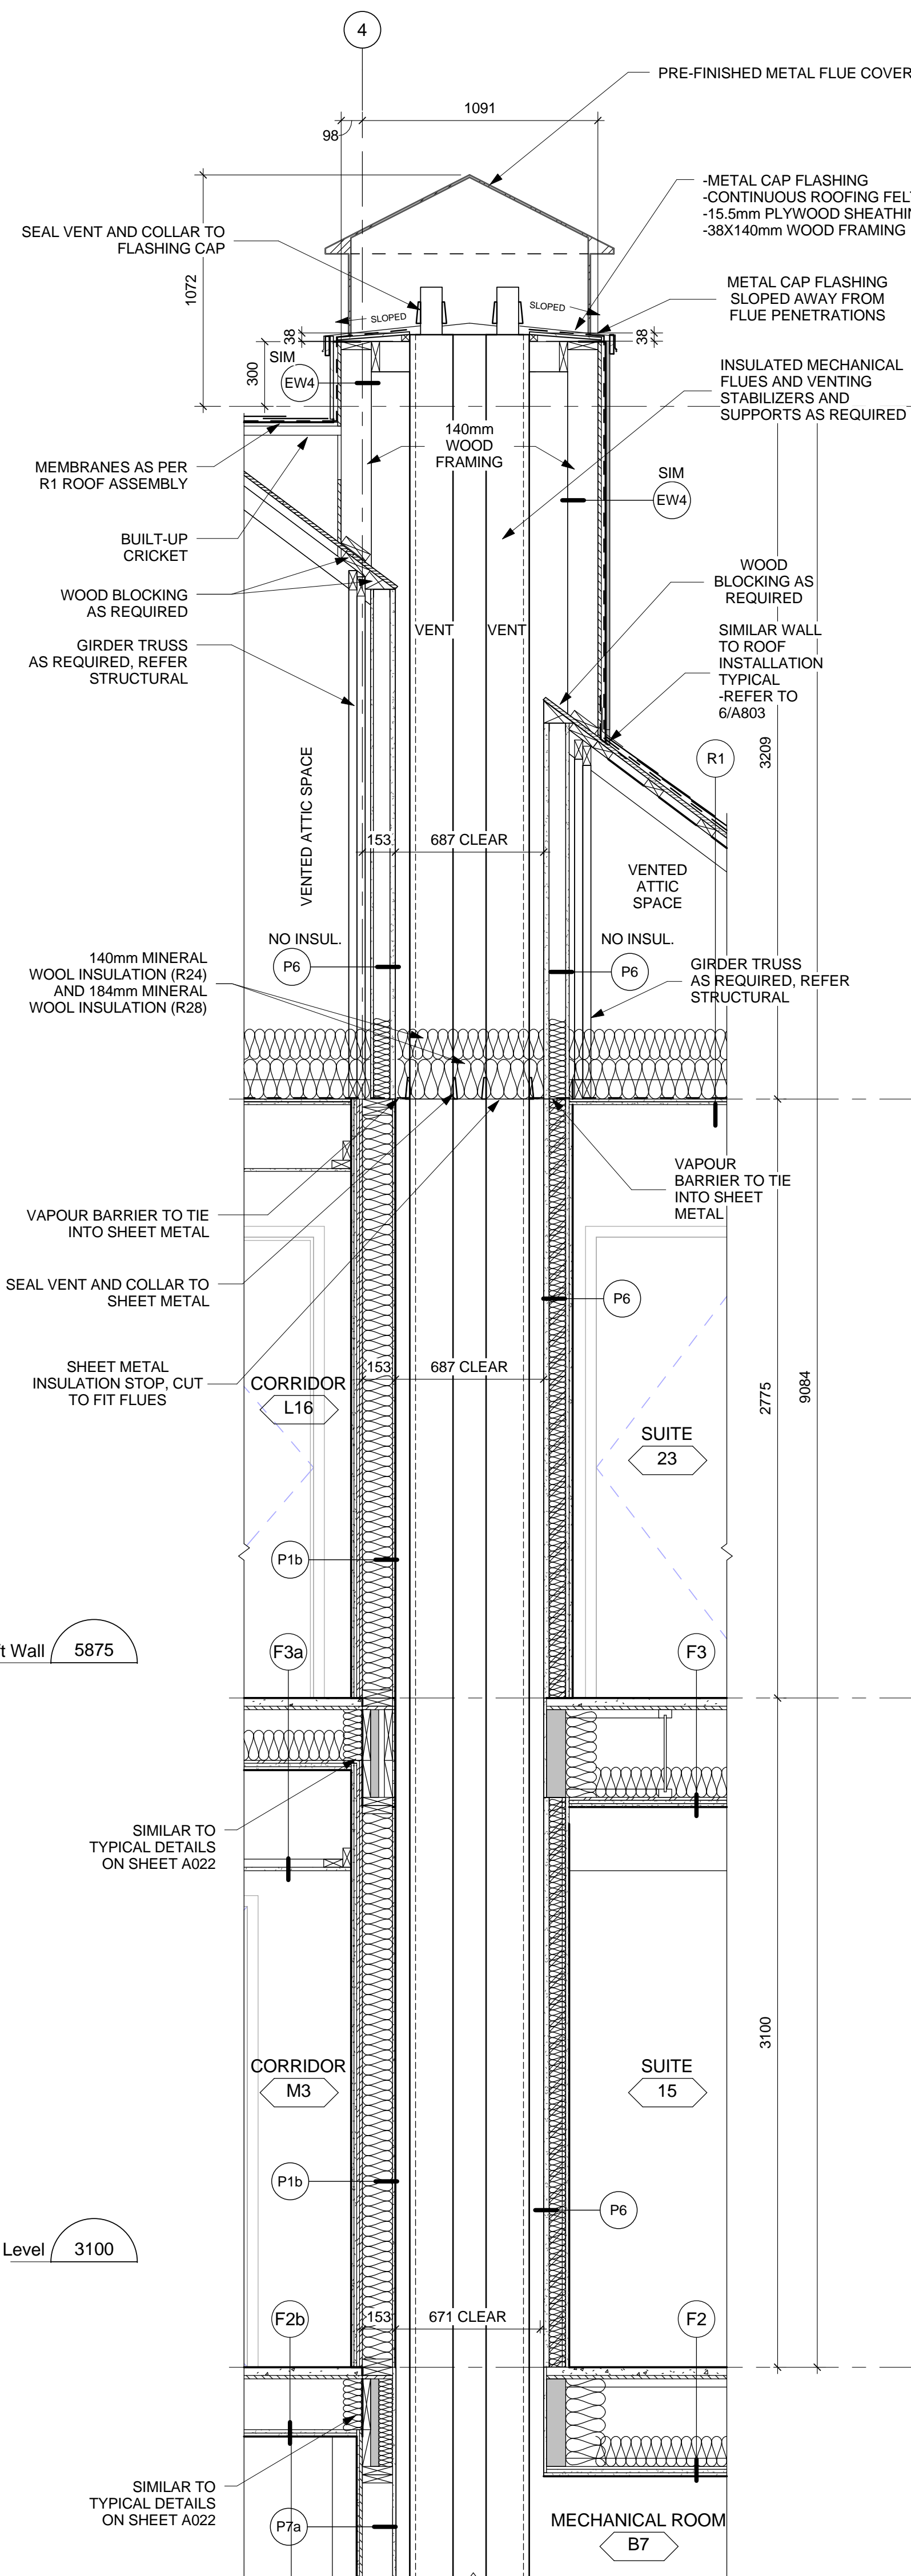
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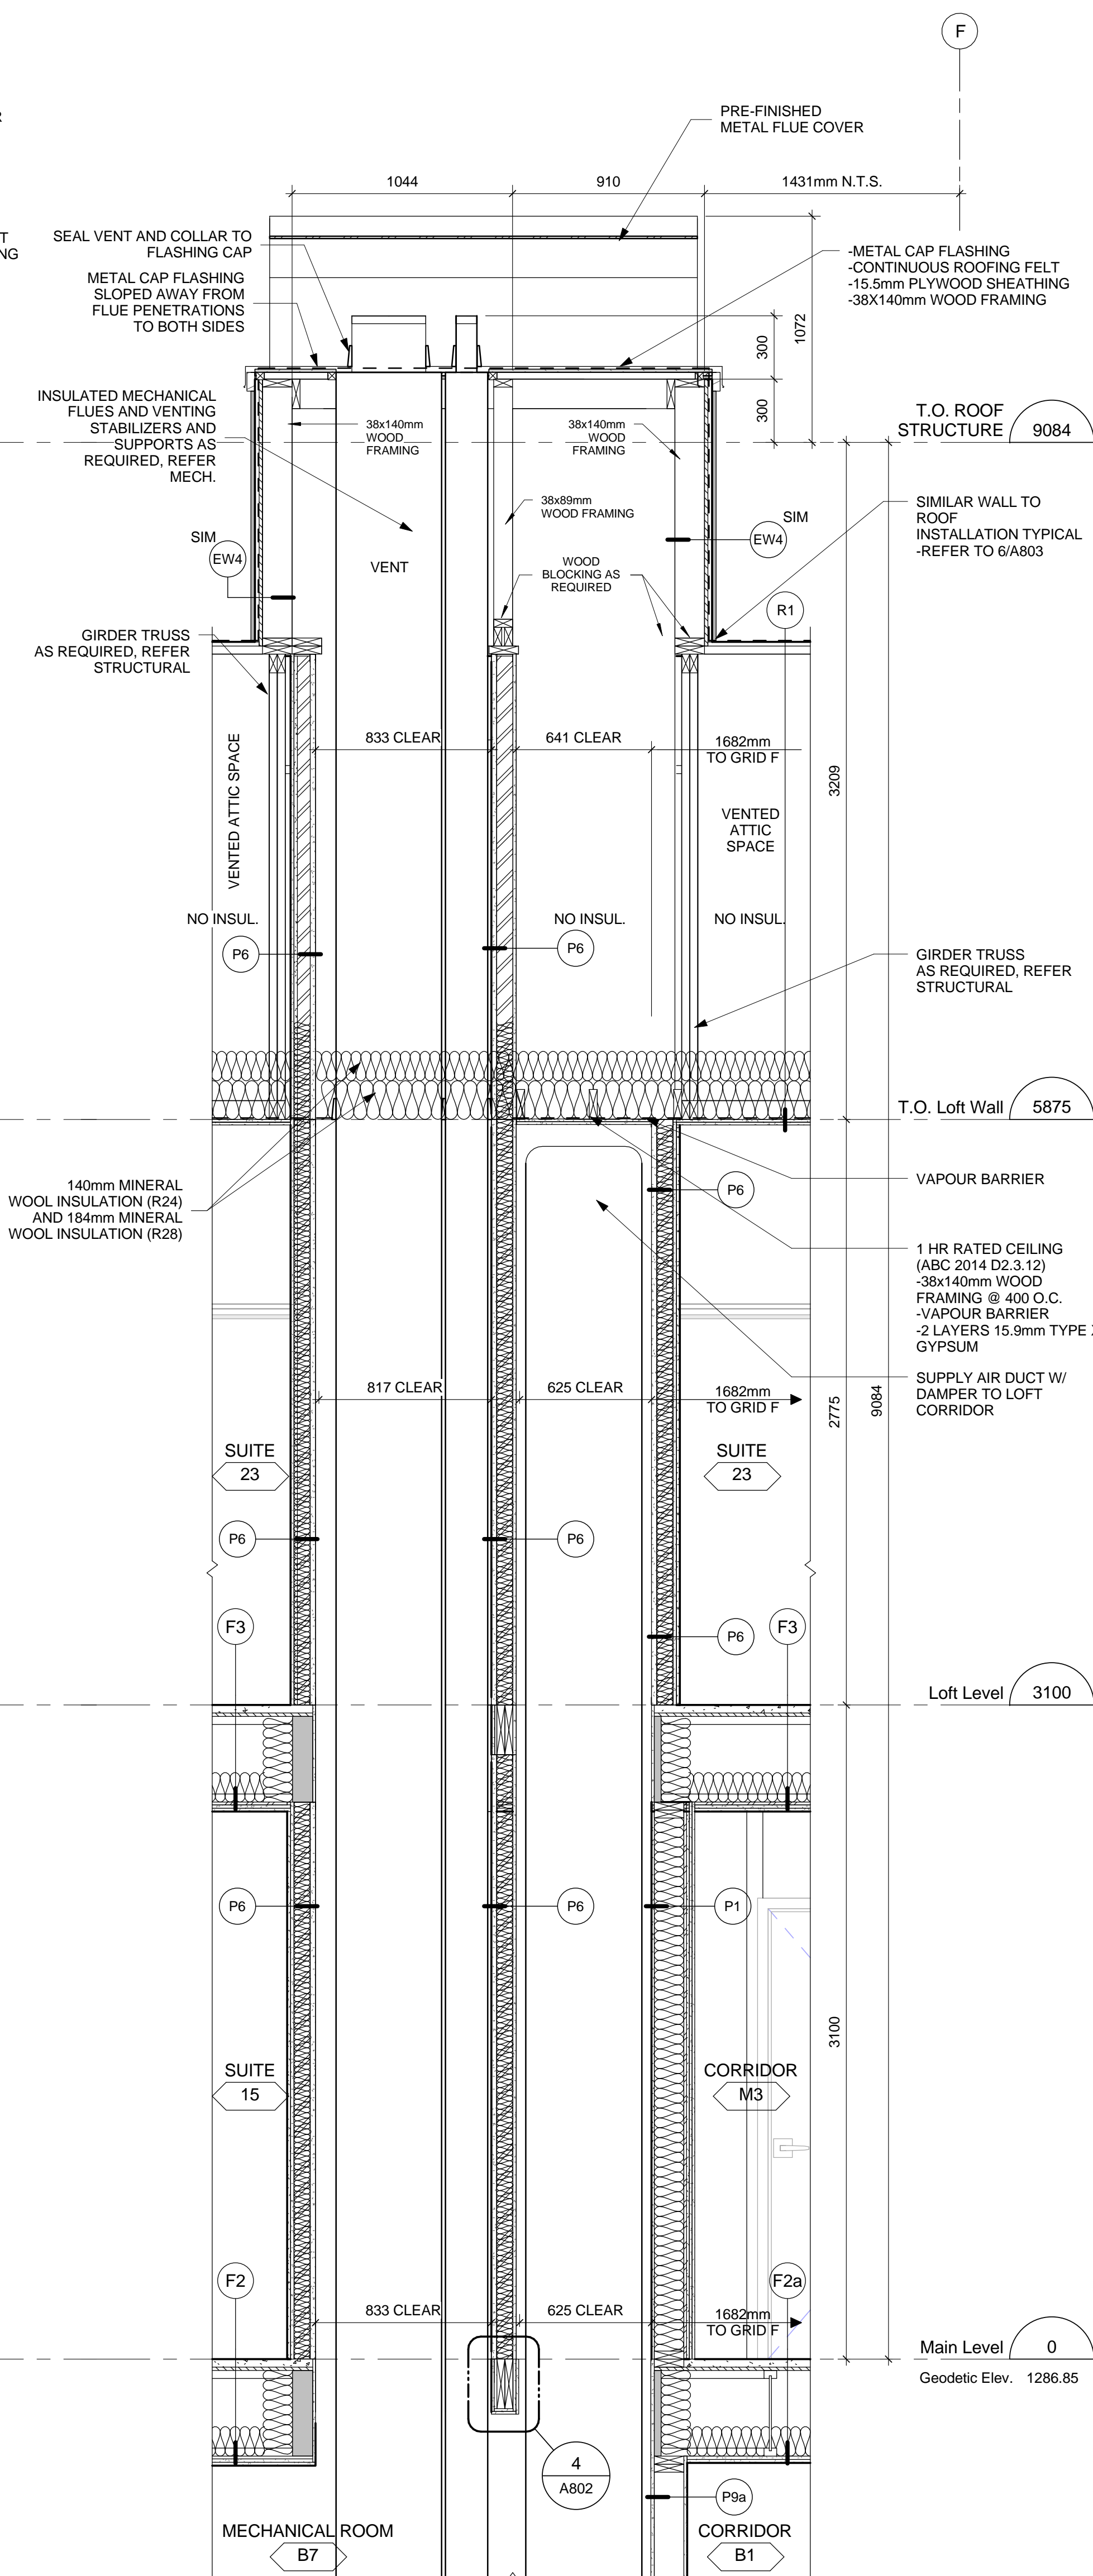
1 WALL SECTION 08
Scale: 1 : 20

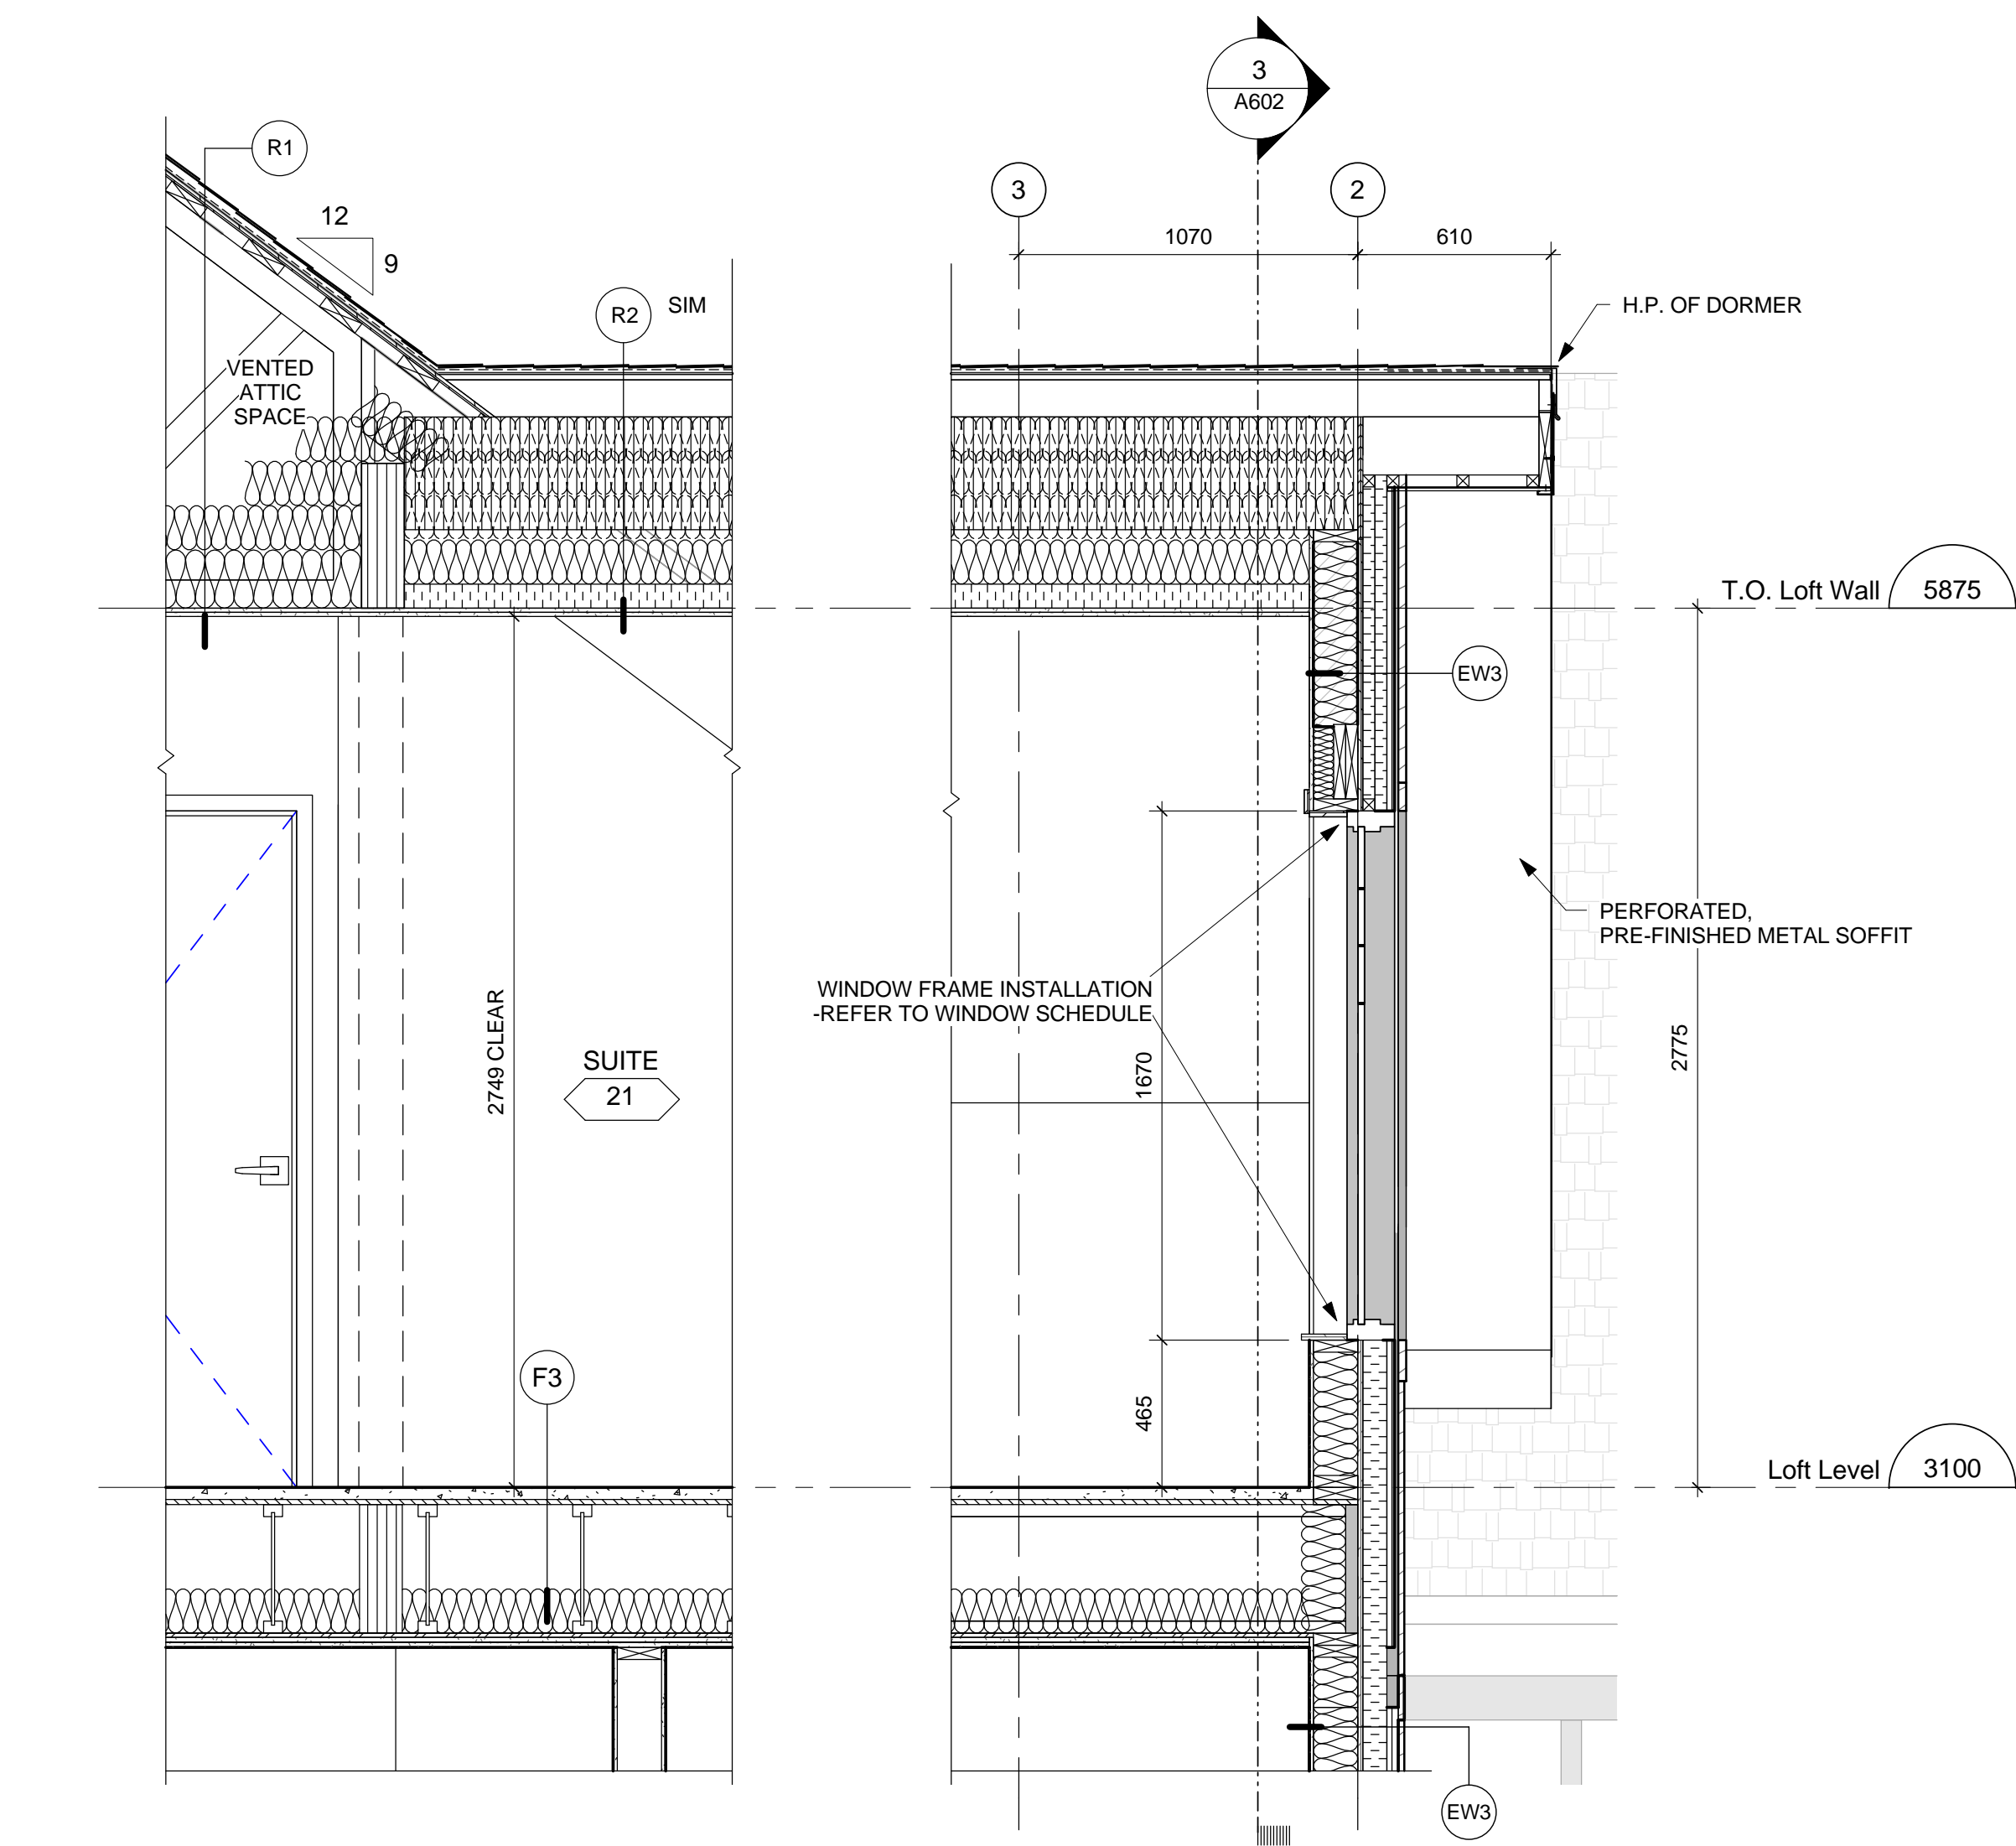

2 WALL SECTION 09
Scale: 1 : 20

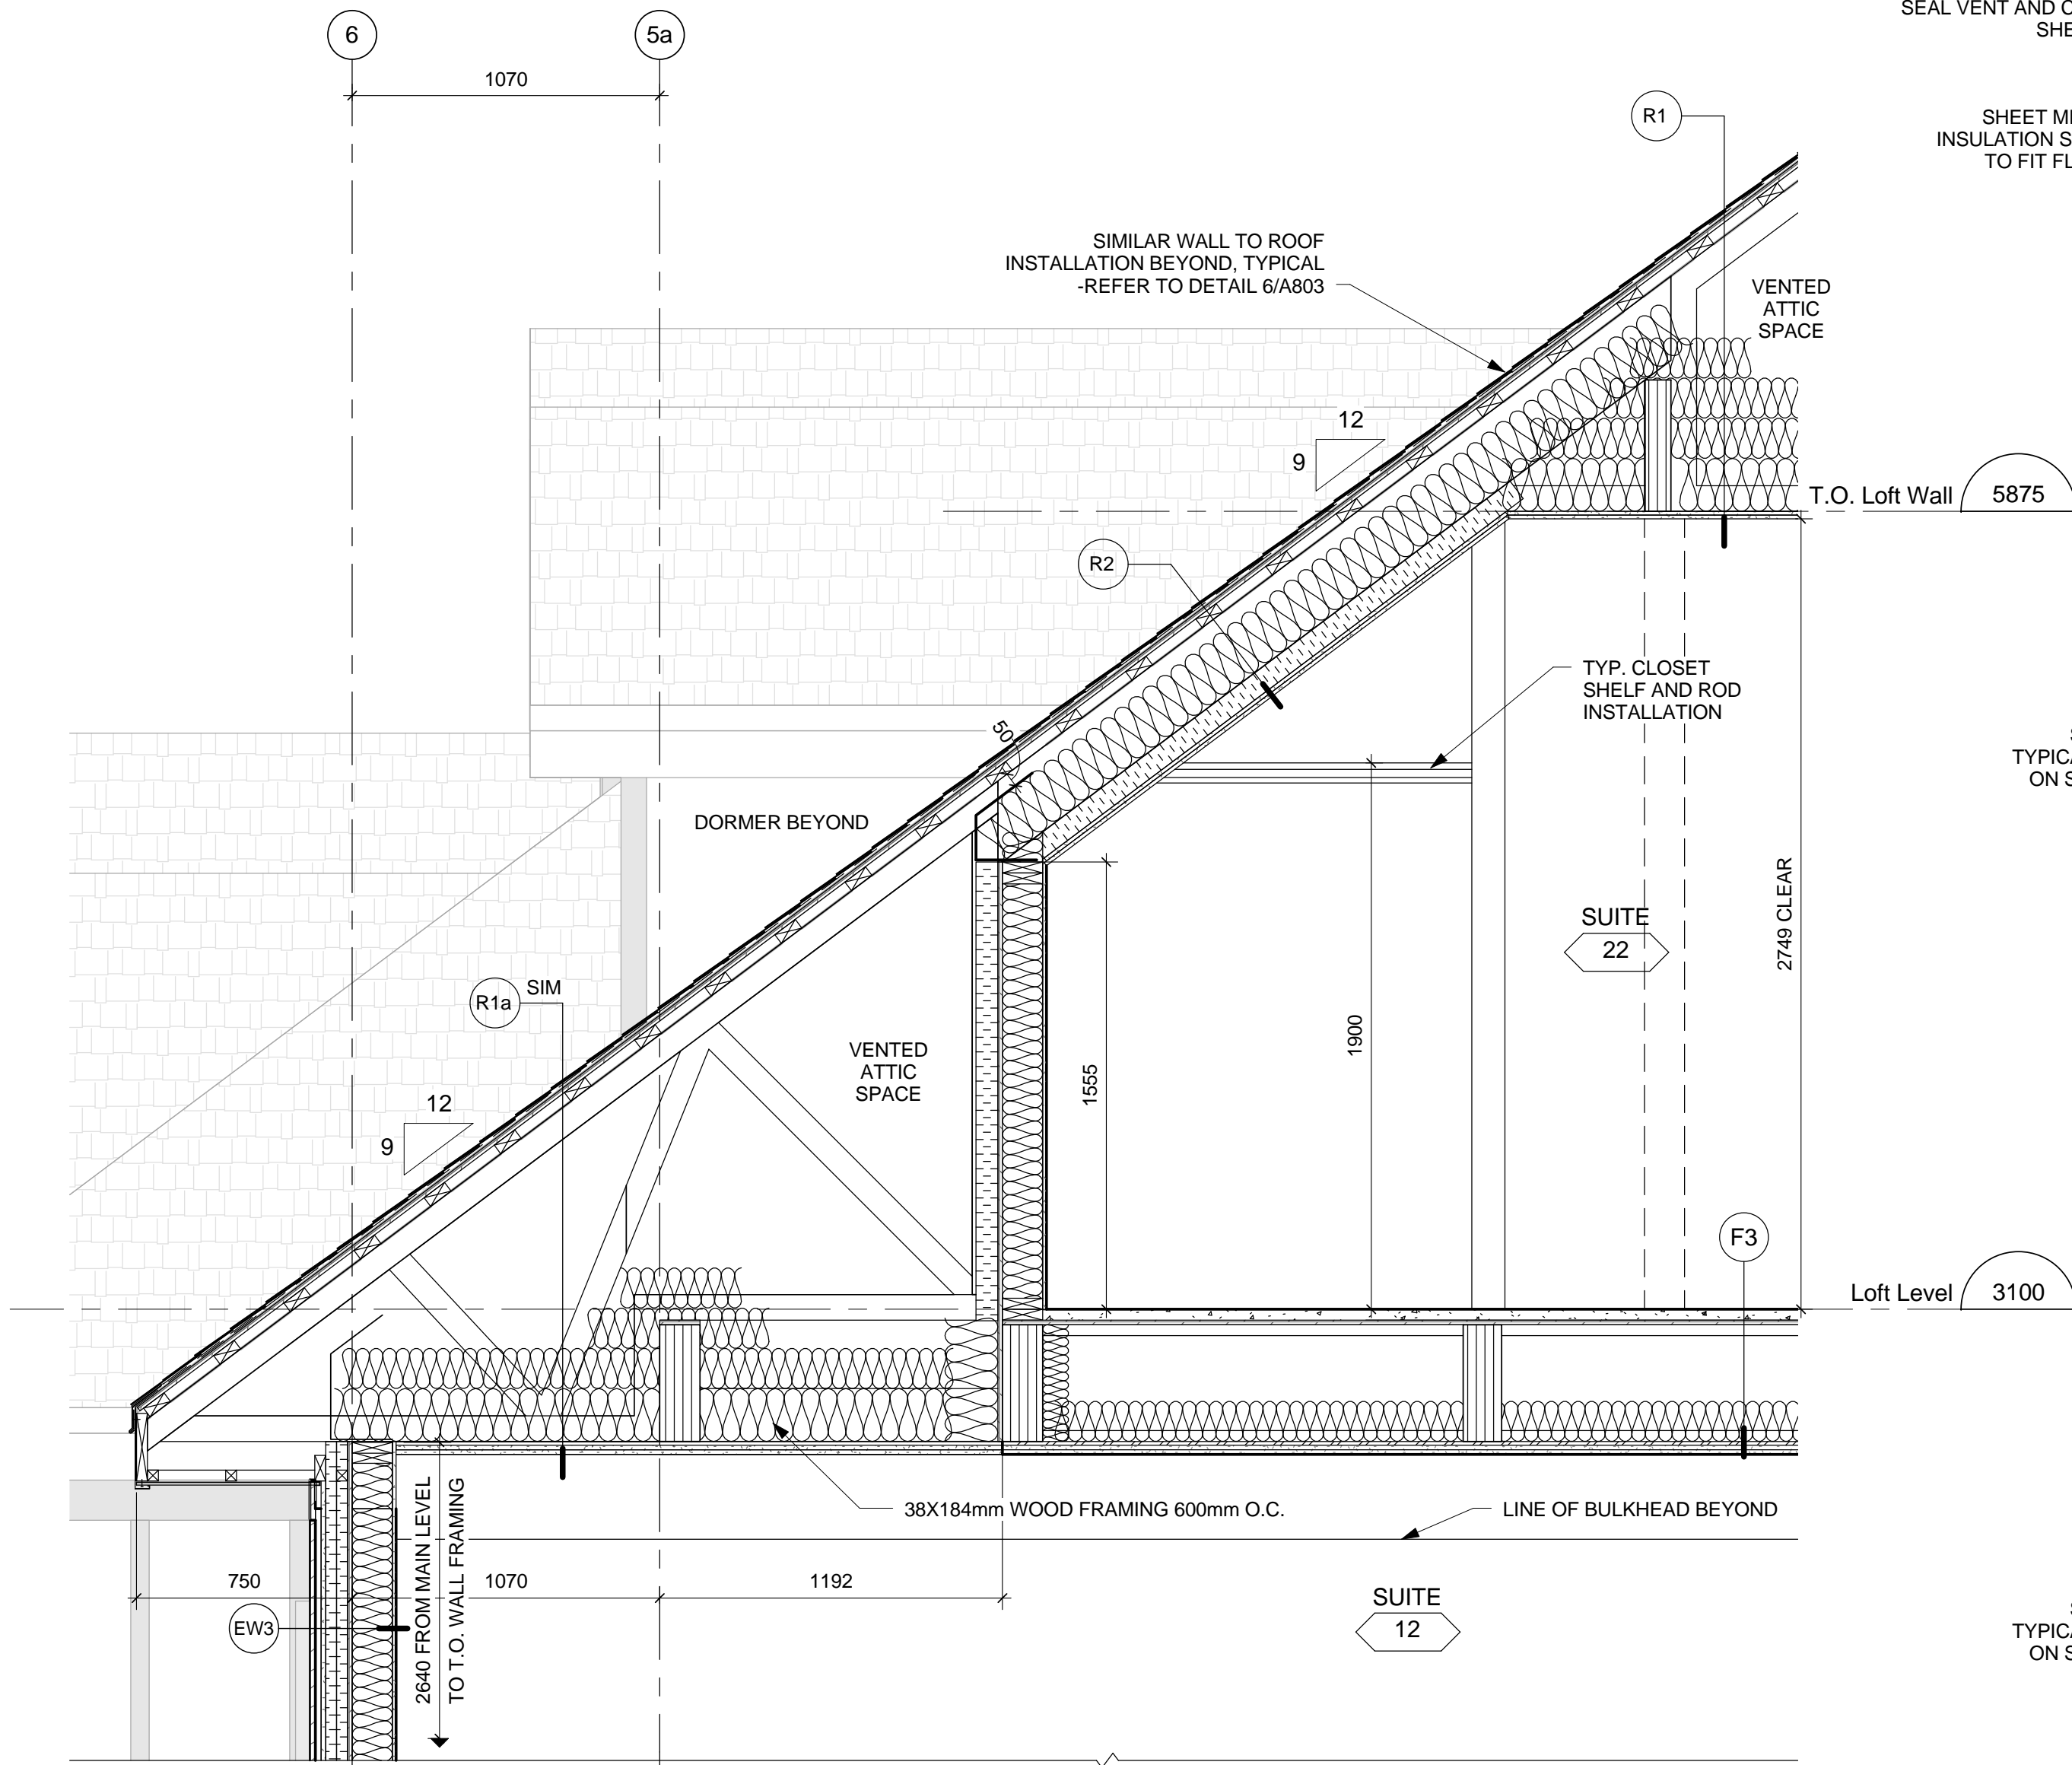

3 PRELIM. CHIMNEY SECTION 01
Scale: 1 : 20



4 PRELIM. CHIMNEY SECTION 02
Scale: 1 : 20

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3

2016-12-08

ISSUED FOR TENDER

2

2016-12-08

ISSUED FOR BUILDING PERMIT

1

2016-09-02

ISSUED FOR 99% REVIEW

No.

Date/Date

Description/Description

Drawn by
Dessiné par

Approved
Approuvé

Revision / Revision

A

detail number
numero de detail

B

source drawing no.
de dessin no.

C

detail on drawing no.
detail sur dessin no.

Consultant's Name
Nom de l'expert-conseil

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L'Agence Parcs
Canada

Ouest et Nord
du Canada

Project title/Titre du projet

Staff Housing Phase 2
Waterton Lakes National
Park

Drawing title/Titre du dessin

WALL SECTIONS

Surveyed by/Arpenté par

Drawn by/Dessiné par

Date/Date

Designed by/Concept par

Reviewed by/Revisé par

Scale/Echelle

LS/FVR

MP

2016-12-08

LS/FVR

LS/FVR

1 : 20

PWGSC Project Manager/Administrateur de Projets TPSCG

Randy Boldt

Client Acceptance/Acceptation du client

Approved by/Approuvé par

Task Responsible/Responsable de la tâche

Task Manager/Administrateur de la tâche

Project No./No. du projet

Asset No./No. du bien


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No. de la feuille

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File # 945



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Drawing Reference No./No. de référence du dessin

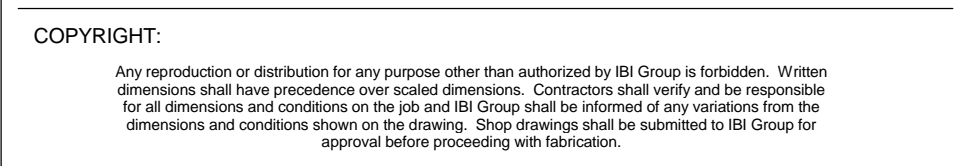

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3	2016-12-08	ISSUED FOR BUILDING
2	2016-09-02	ISSUED FOR 99% REV
1	2016-06-14	ISSUED FOR 66% REV

No.	Date/Date	Description/Description	Drawn by Dessine par	Approved Approuvé
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Revision / Revision	
	<p>A detail number numero de detail</p> <p>B source drawing no. de dessin no.</p> <p>C detail on drawing no. detail sur dessin no.</p>
	

Consultant's Name Nom de l'expert-conseil	Eng. Stamp Sceau de l'ingénieur
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Western and Northern Region	Ouest et Nord du Canada
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Project title/Titre du projet

Staff Housing Phase 2 Waterton Lakes National Park

Drawing title/Titre du dessin

PLAN DETAILS

Surveyed by/Arpenté par	Drawn by/Dessiné par MP/AG	Date/Date 2016-12-08
Designed by/Concept par LS/FVR	Reviewed by/Revisé par LS/FVR	Scale/Echelle 1:5

PWGSC Project Manager/Administrateur de Projets TPSGC		
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Randy Boldt

Client Acceptance/Acceptation du client	Approved by/Approuvé par
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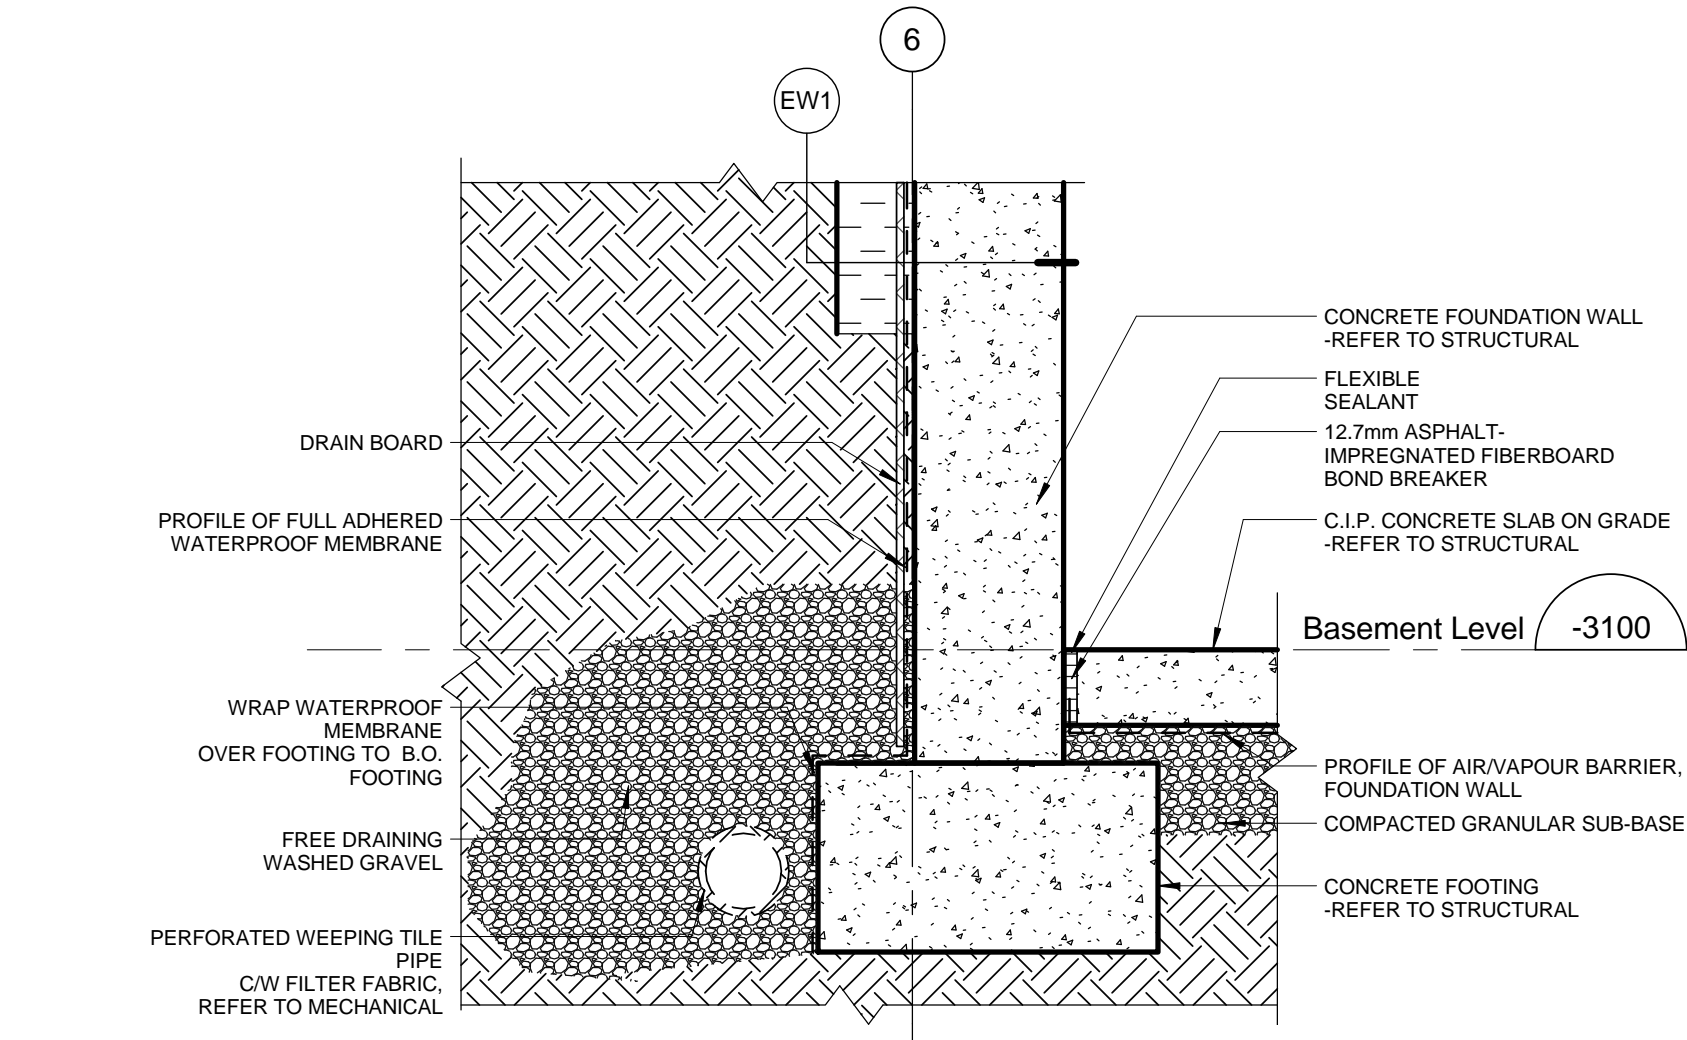
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Perk Responsible Officer/Agent Responsable	PBCSC Project Manager/Administrateur de Projets TPS00
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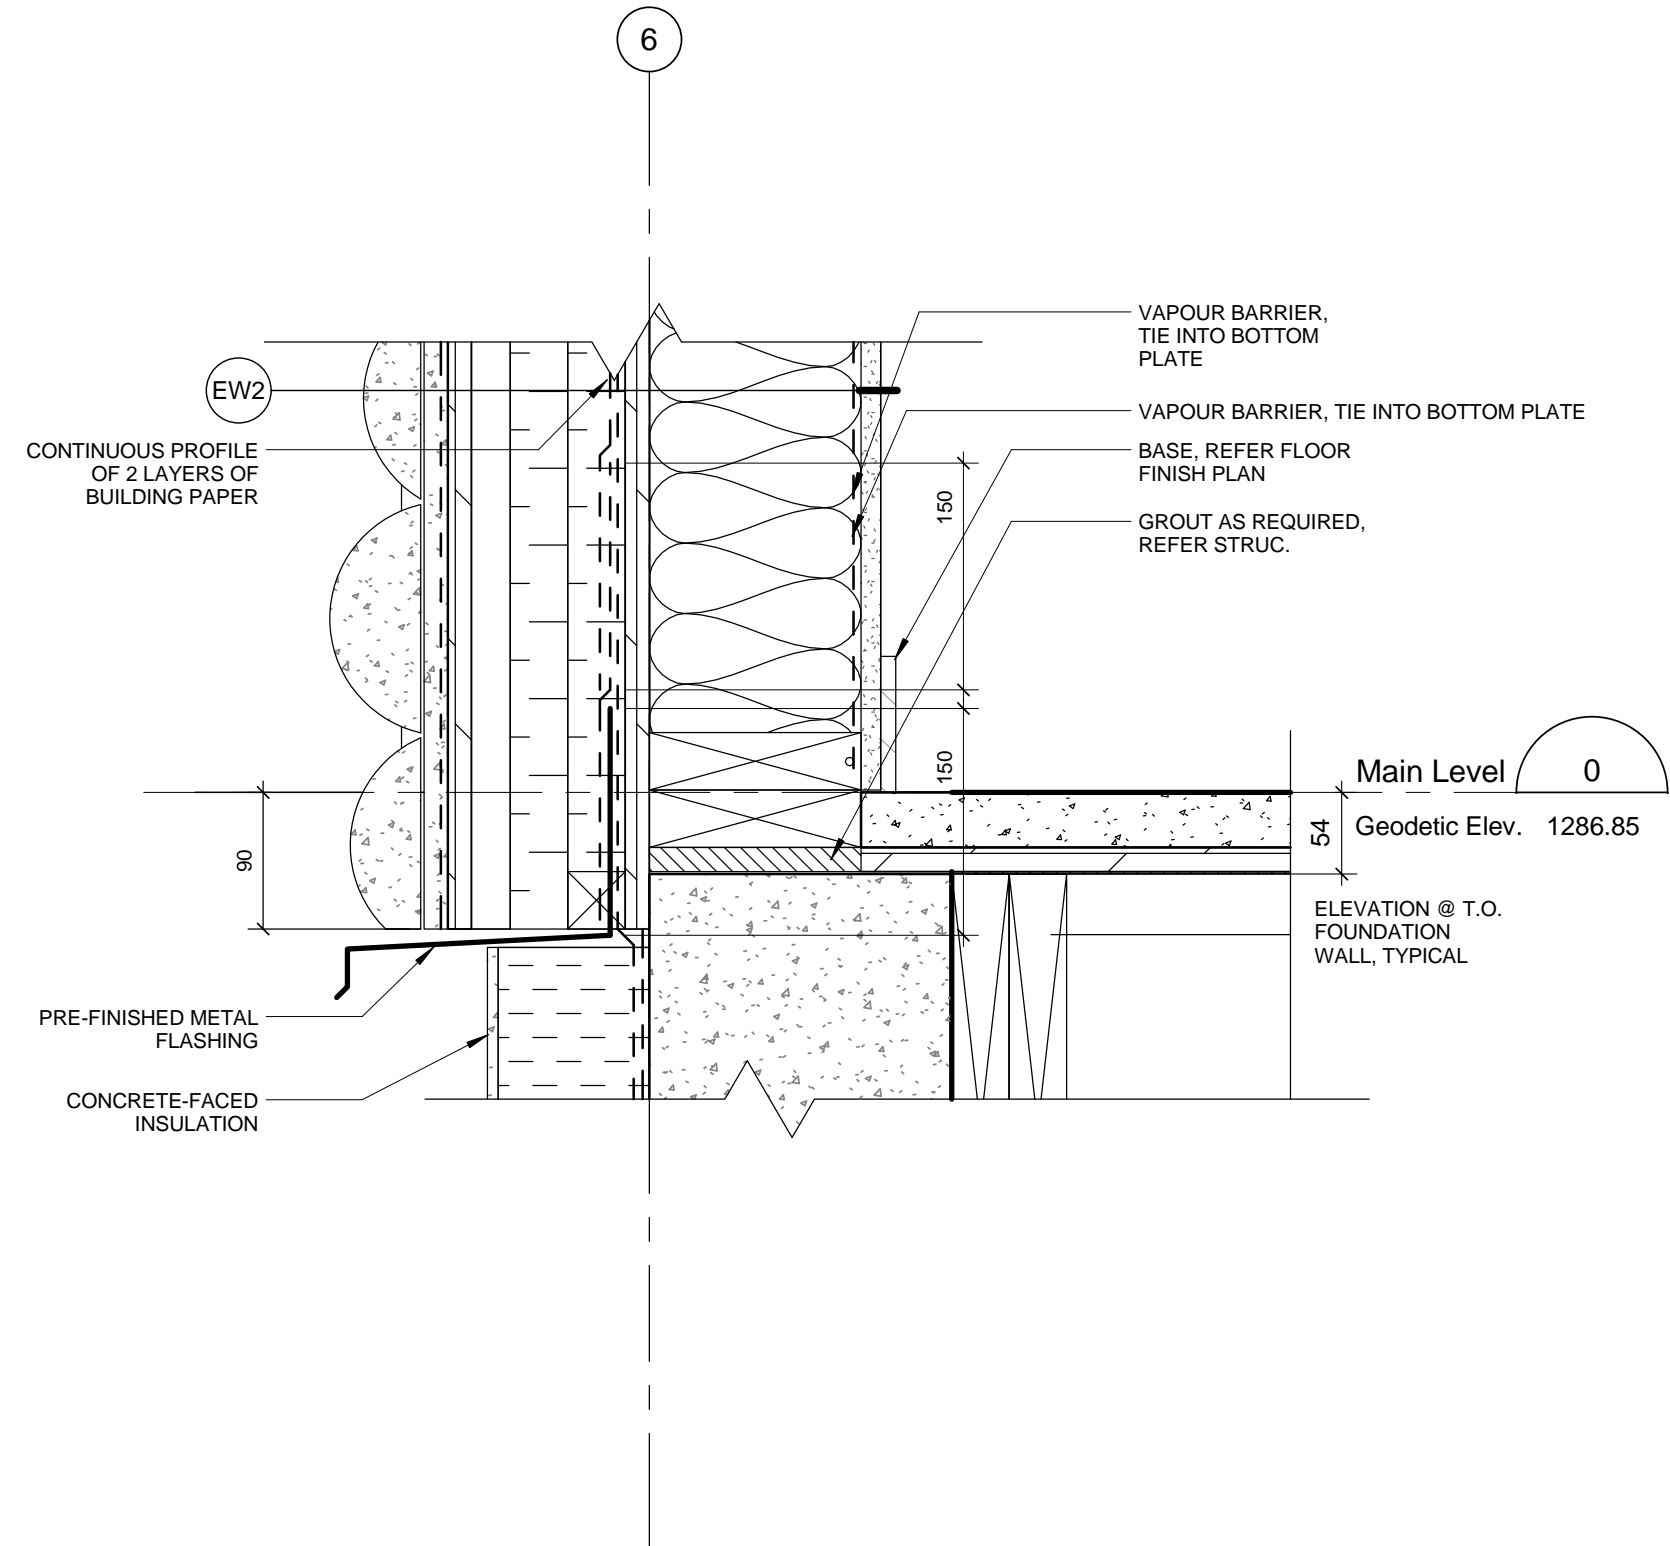
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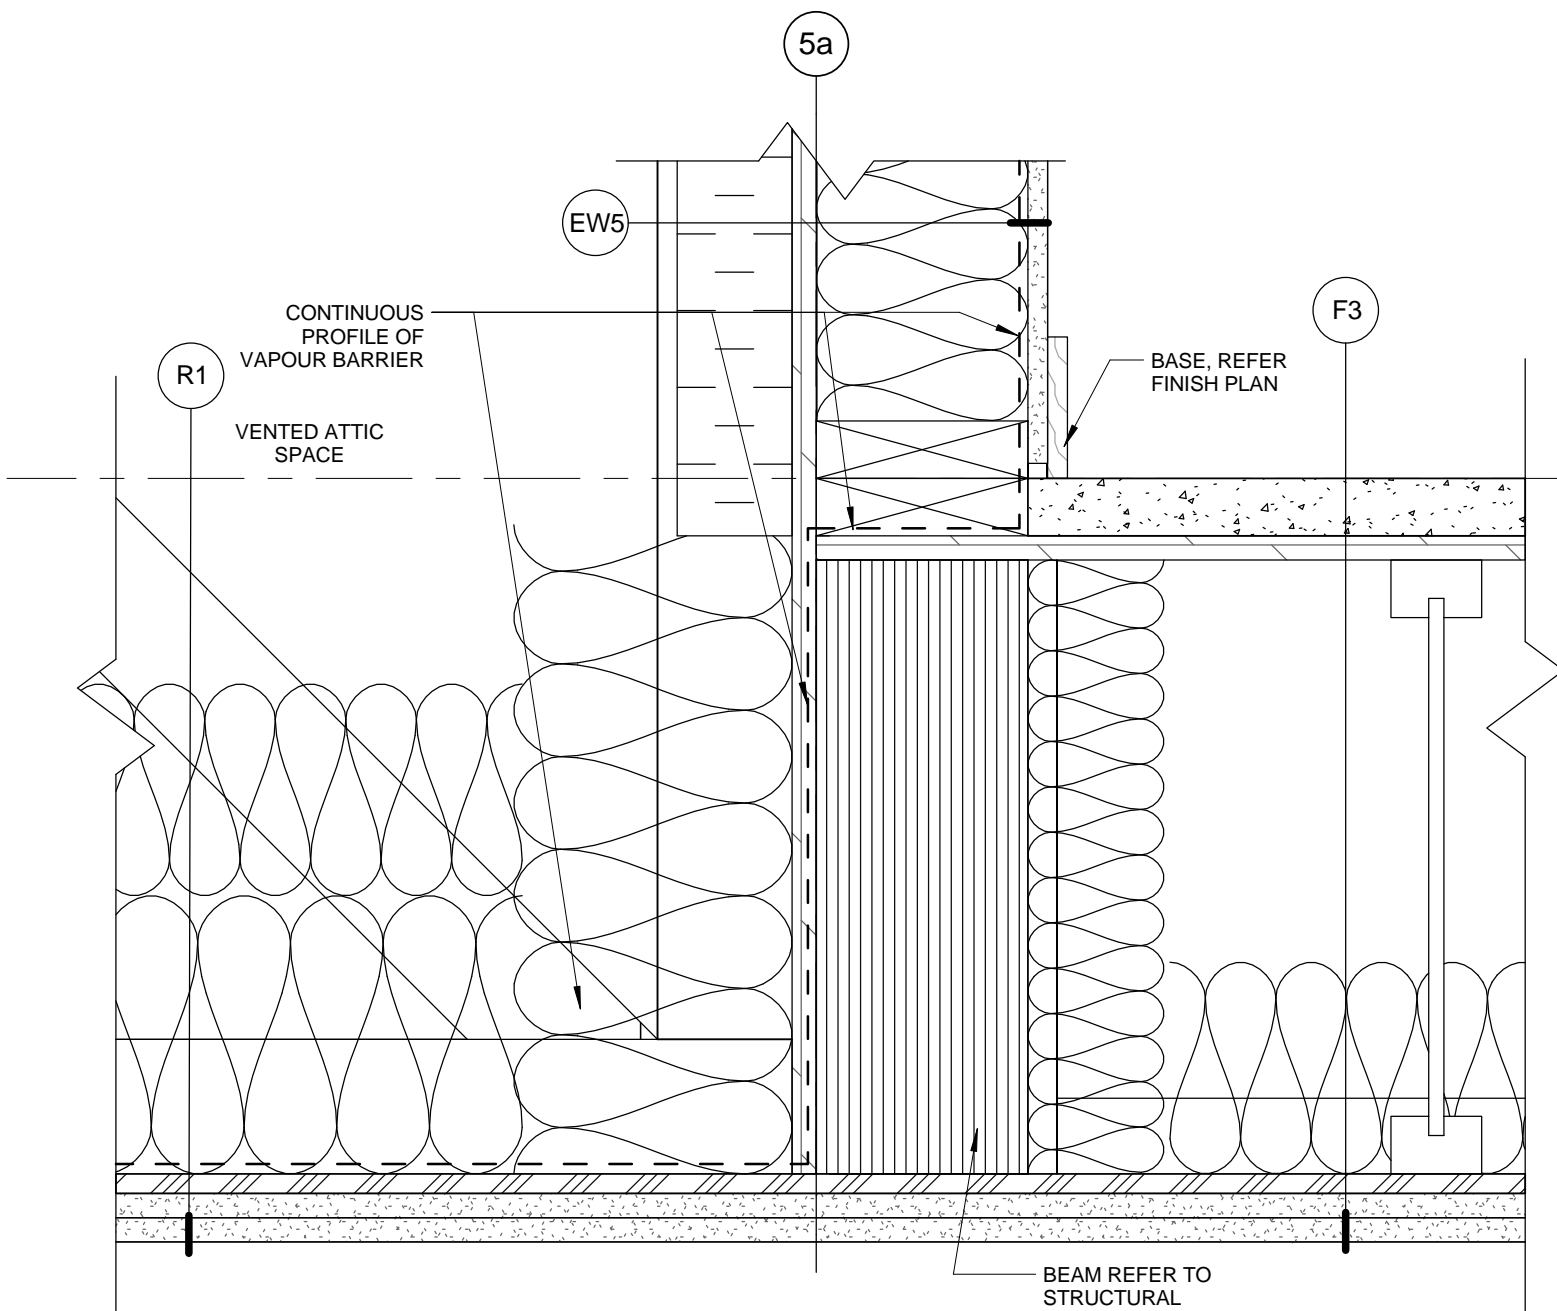
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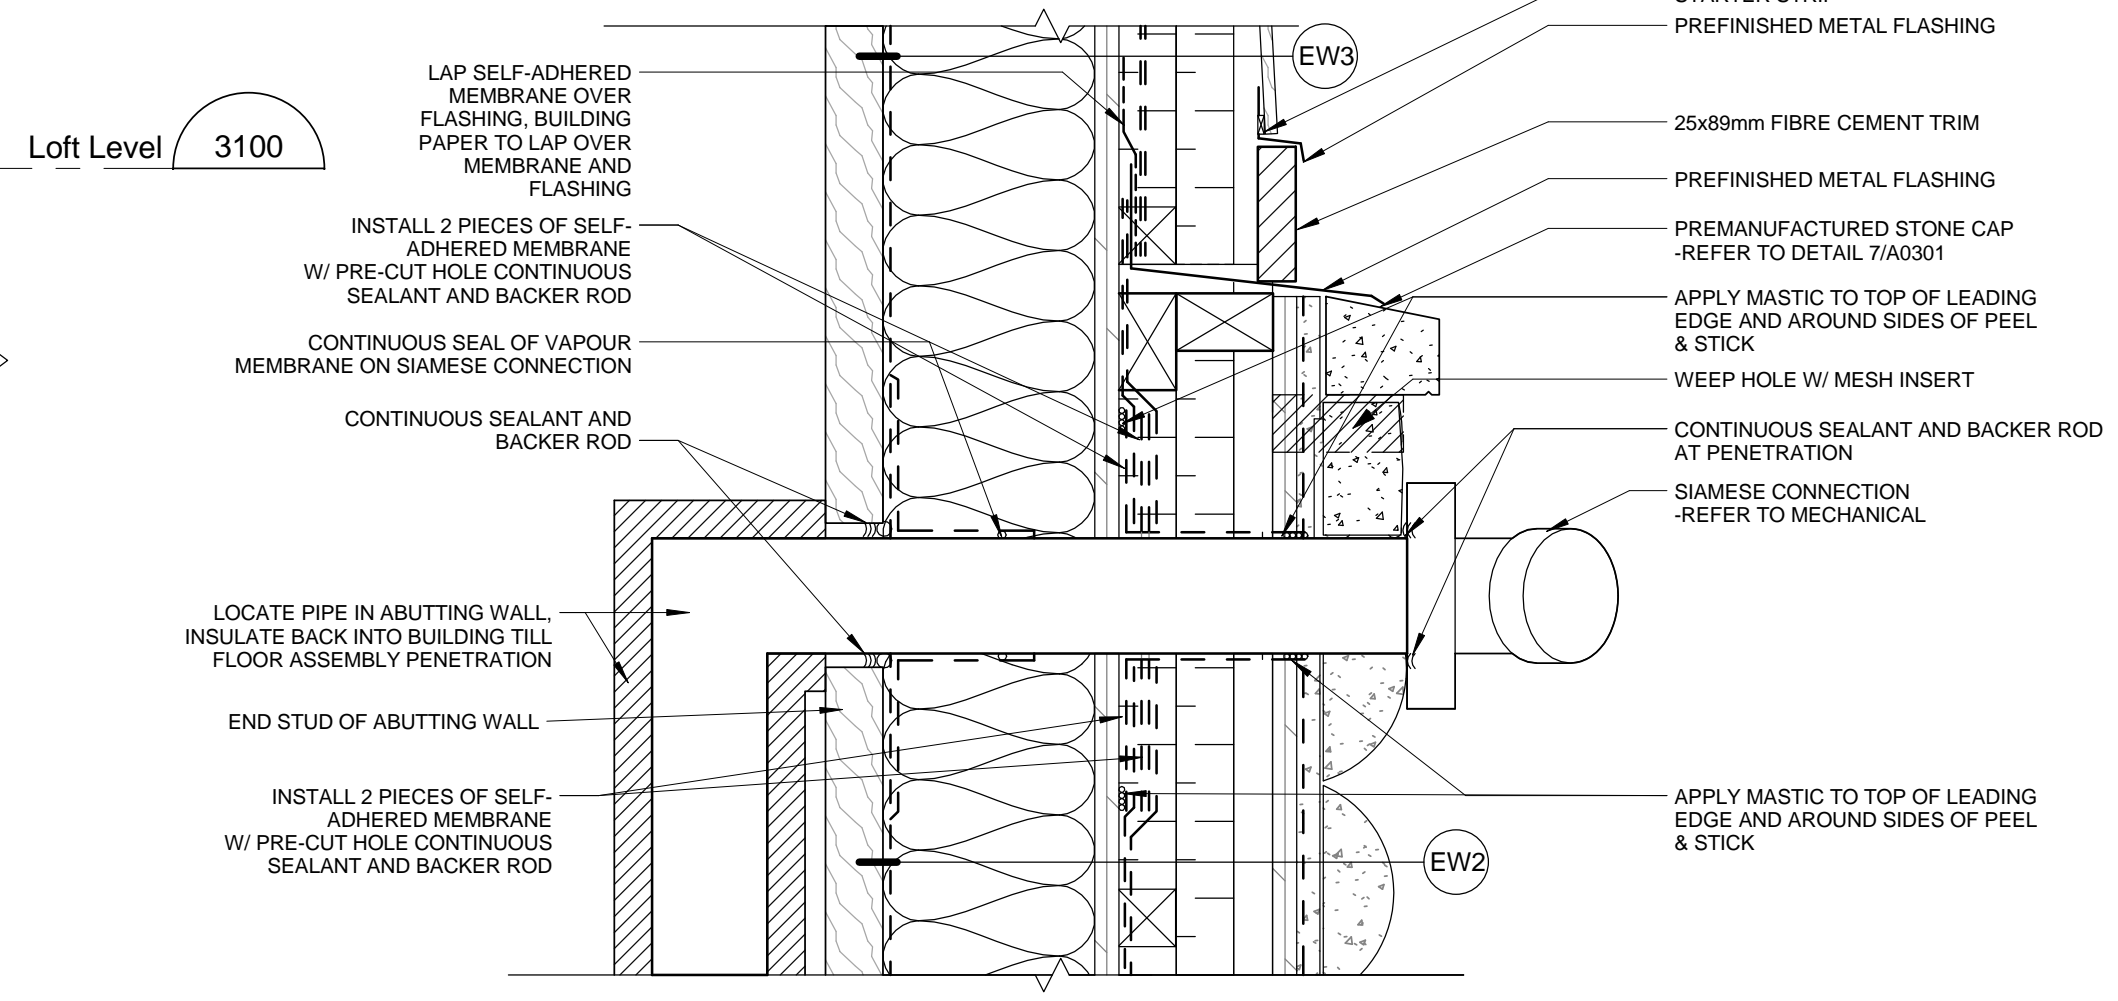
10 SECTION DETAIL - FOUNDATION FOOTING WEEPING TILE - TYPICAL
A801 Scale: 1 : 10




7 SECTION DETAIL - MAIN LEVEL PERIMETER - TYPICAL
A801 Scale: 1 : 5




9 SECTION DETAIL - SUITE WALL/VENTED ATTIC - TYPICAL DETAIL
A801 Scale: 1 : 5




6 SECTION DETAIL - WALL TRANSITION AND SIAMESE CONNECTION
A801 Scale: 1 : 5

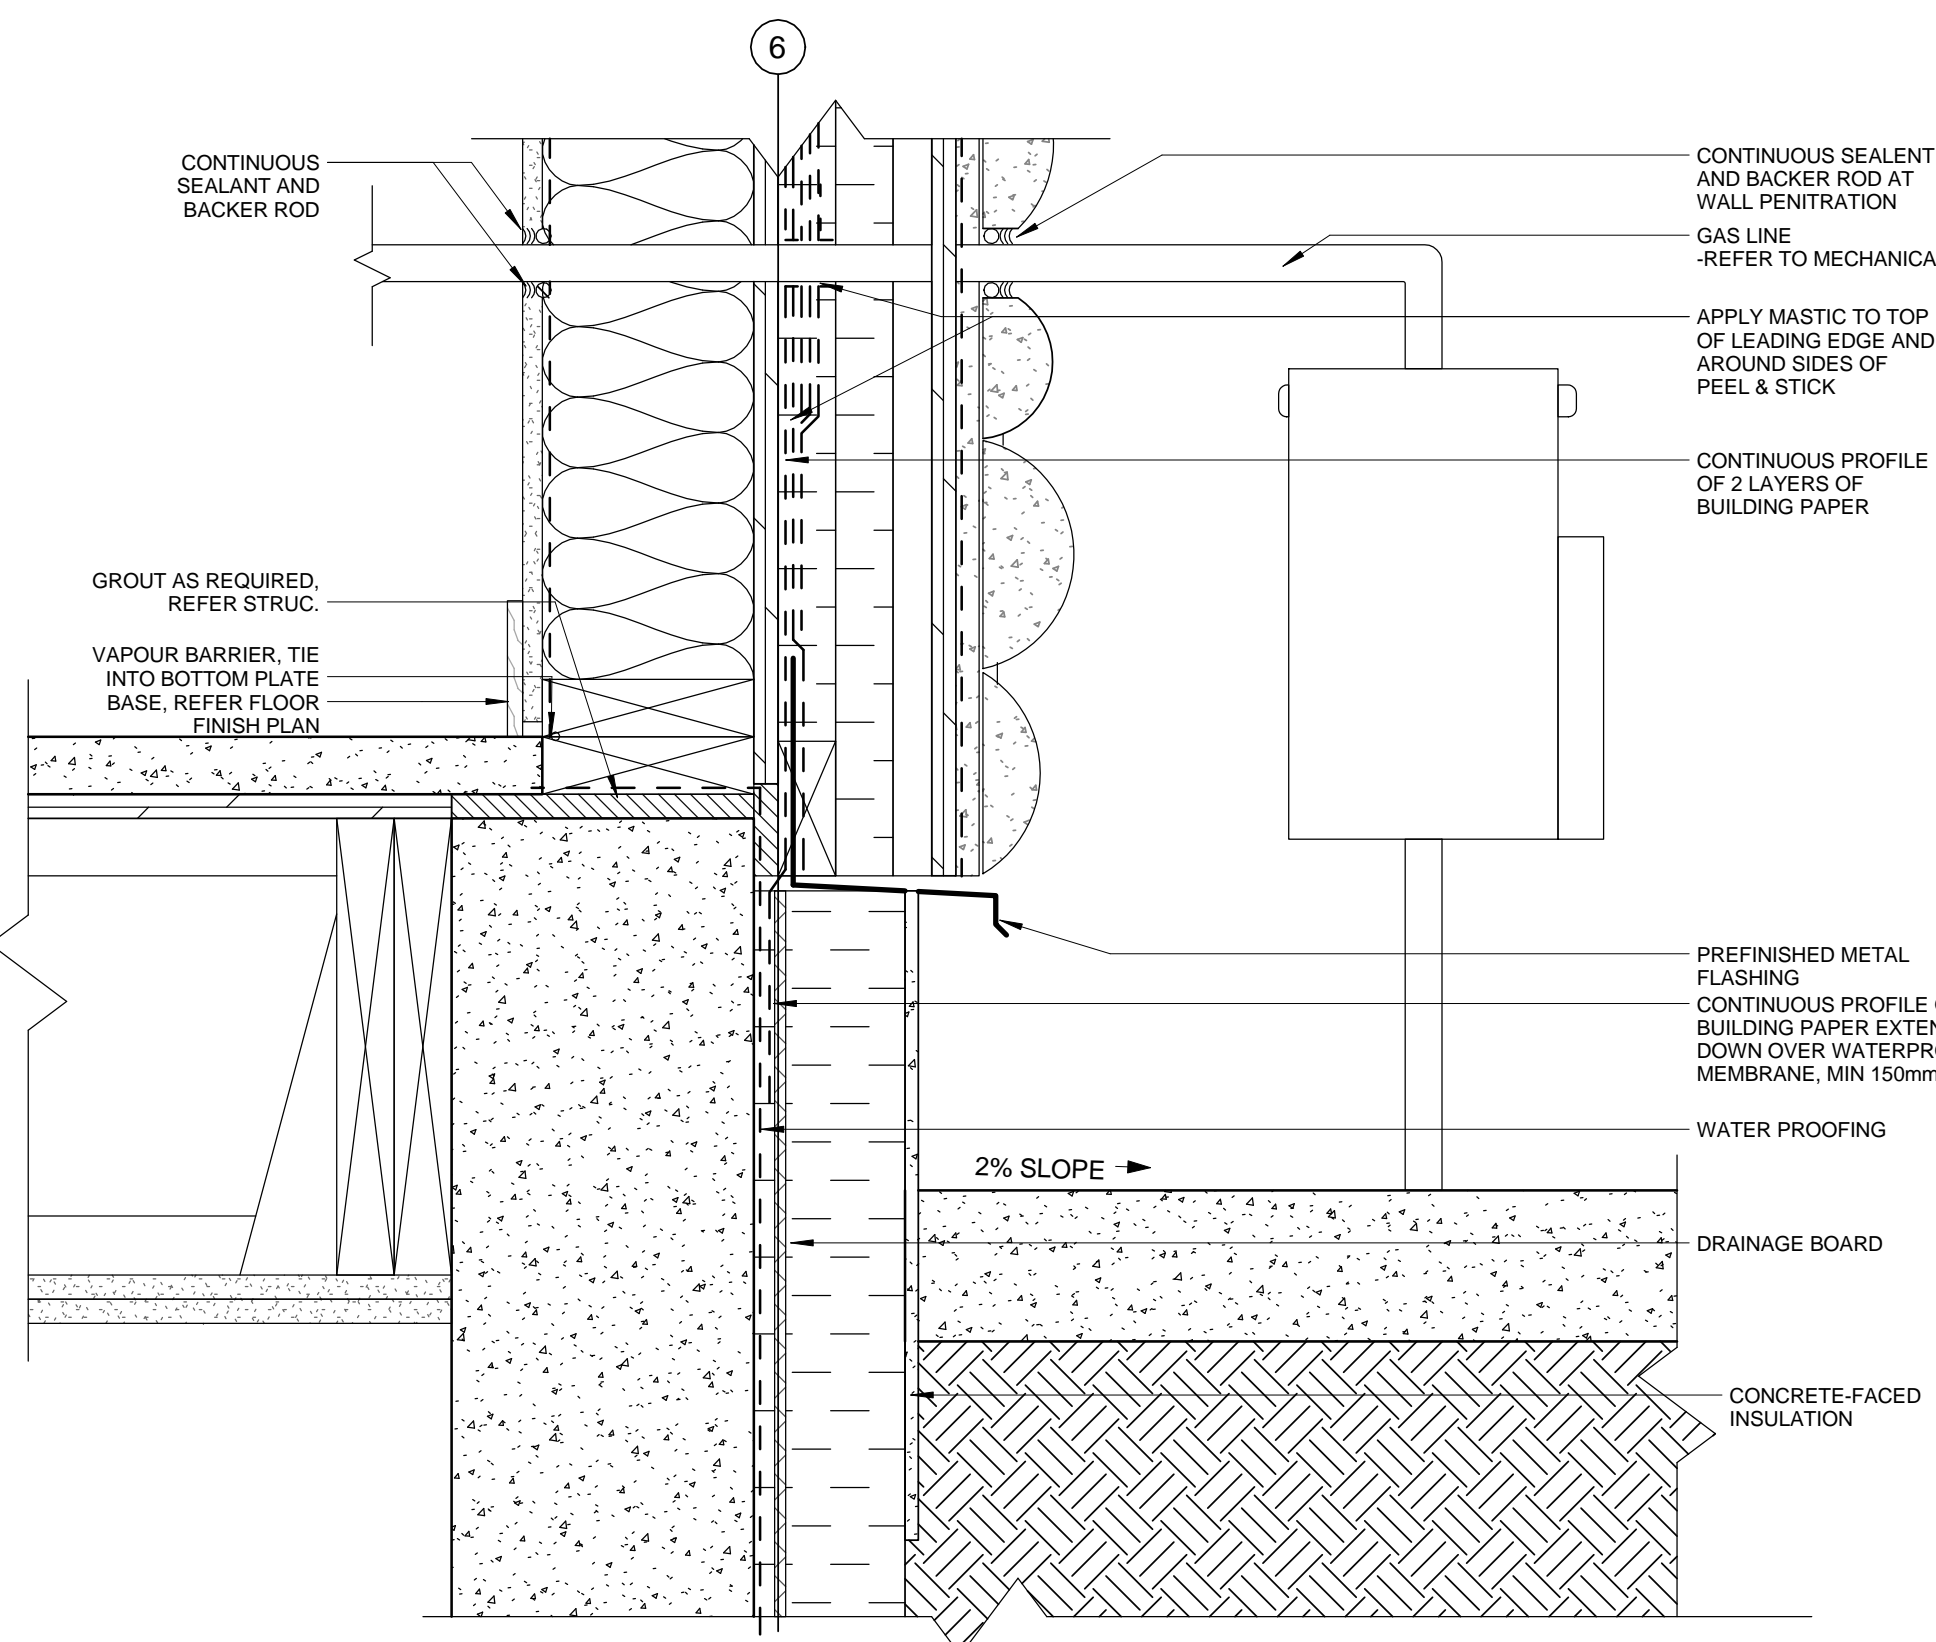


5 SECTION DETAIL - GAS METER PENETRATION
A801 Scale: 1 : 5

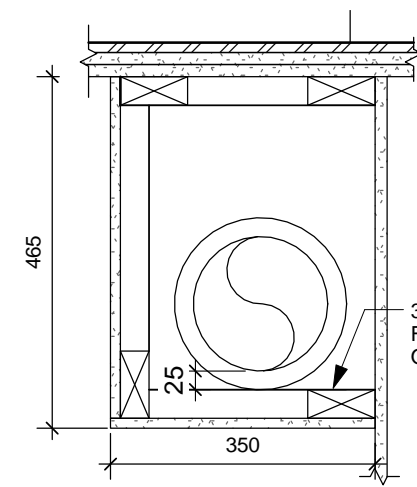

11 SECTION DETAIL - STANDARD BULKHEAD ASSEMBLY - KITCHEN
A801 Scale: 1 : 10

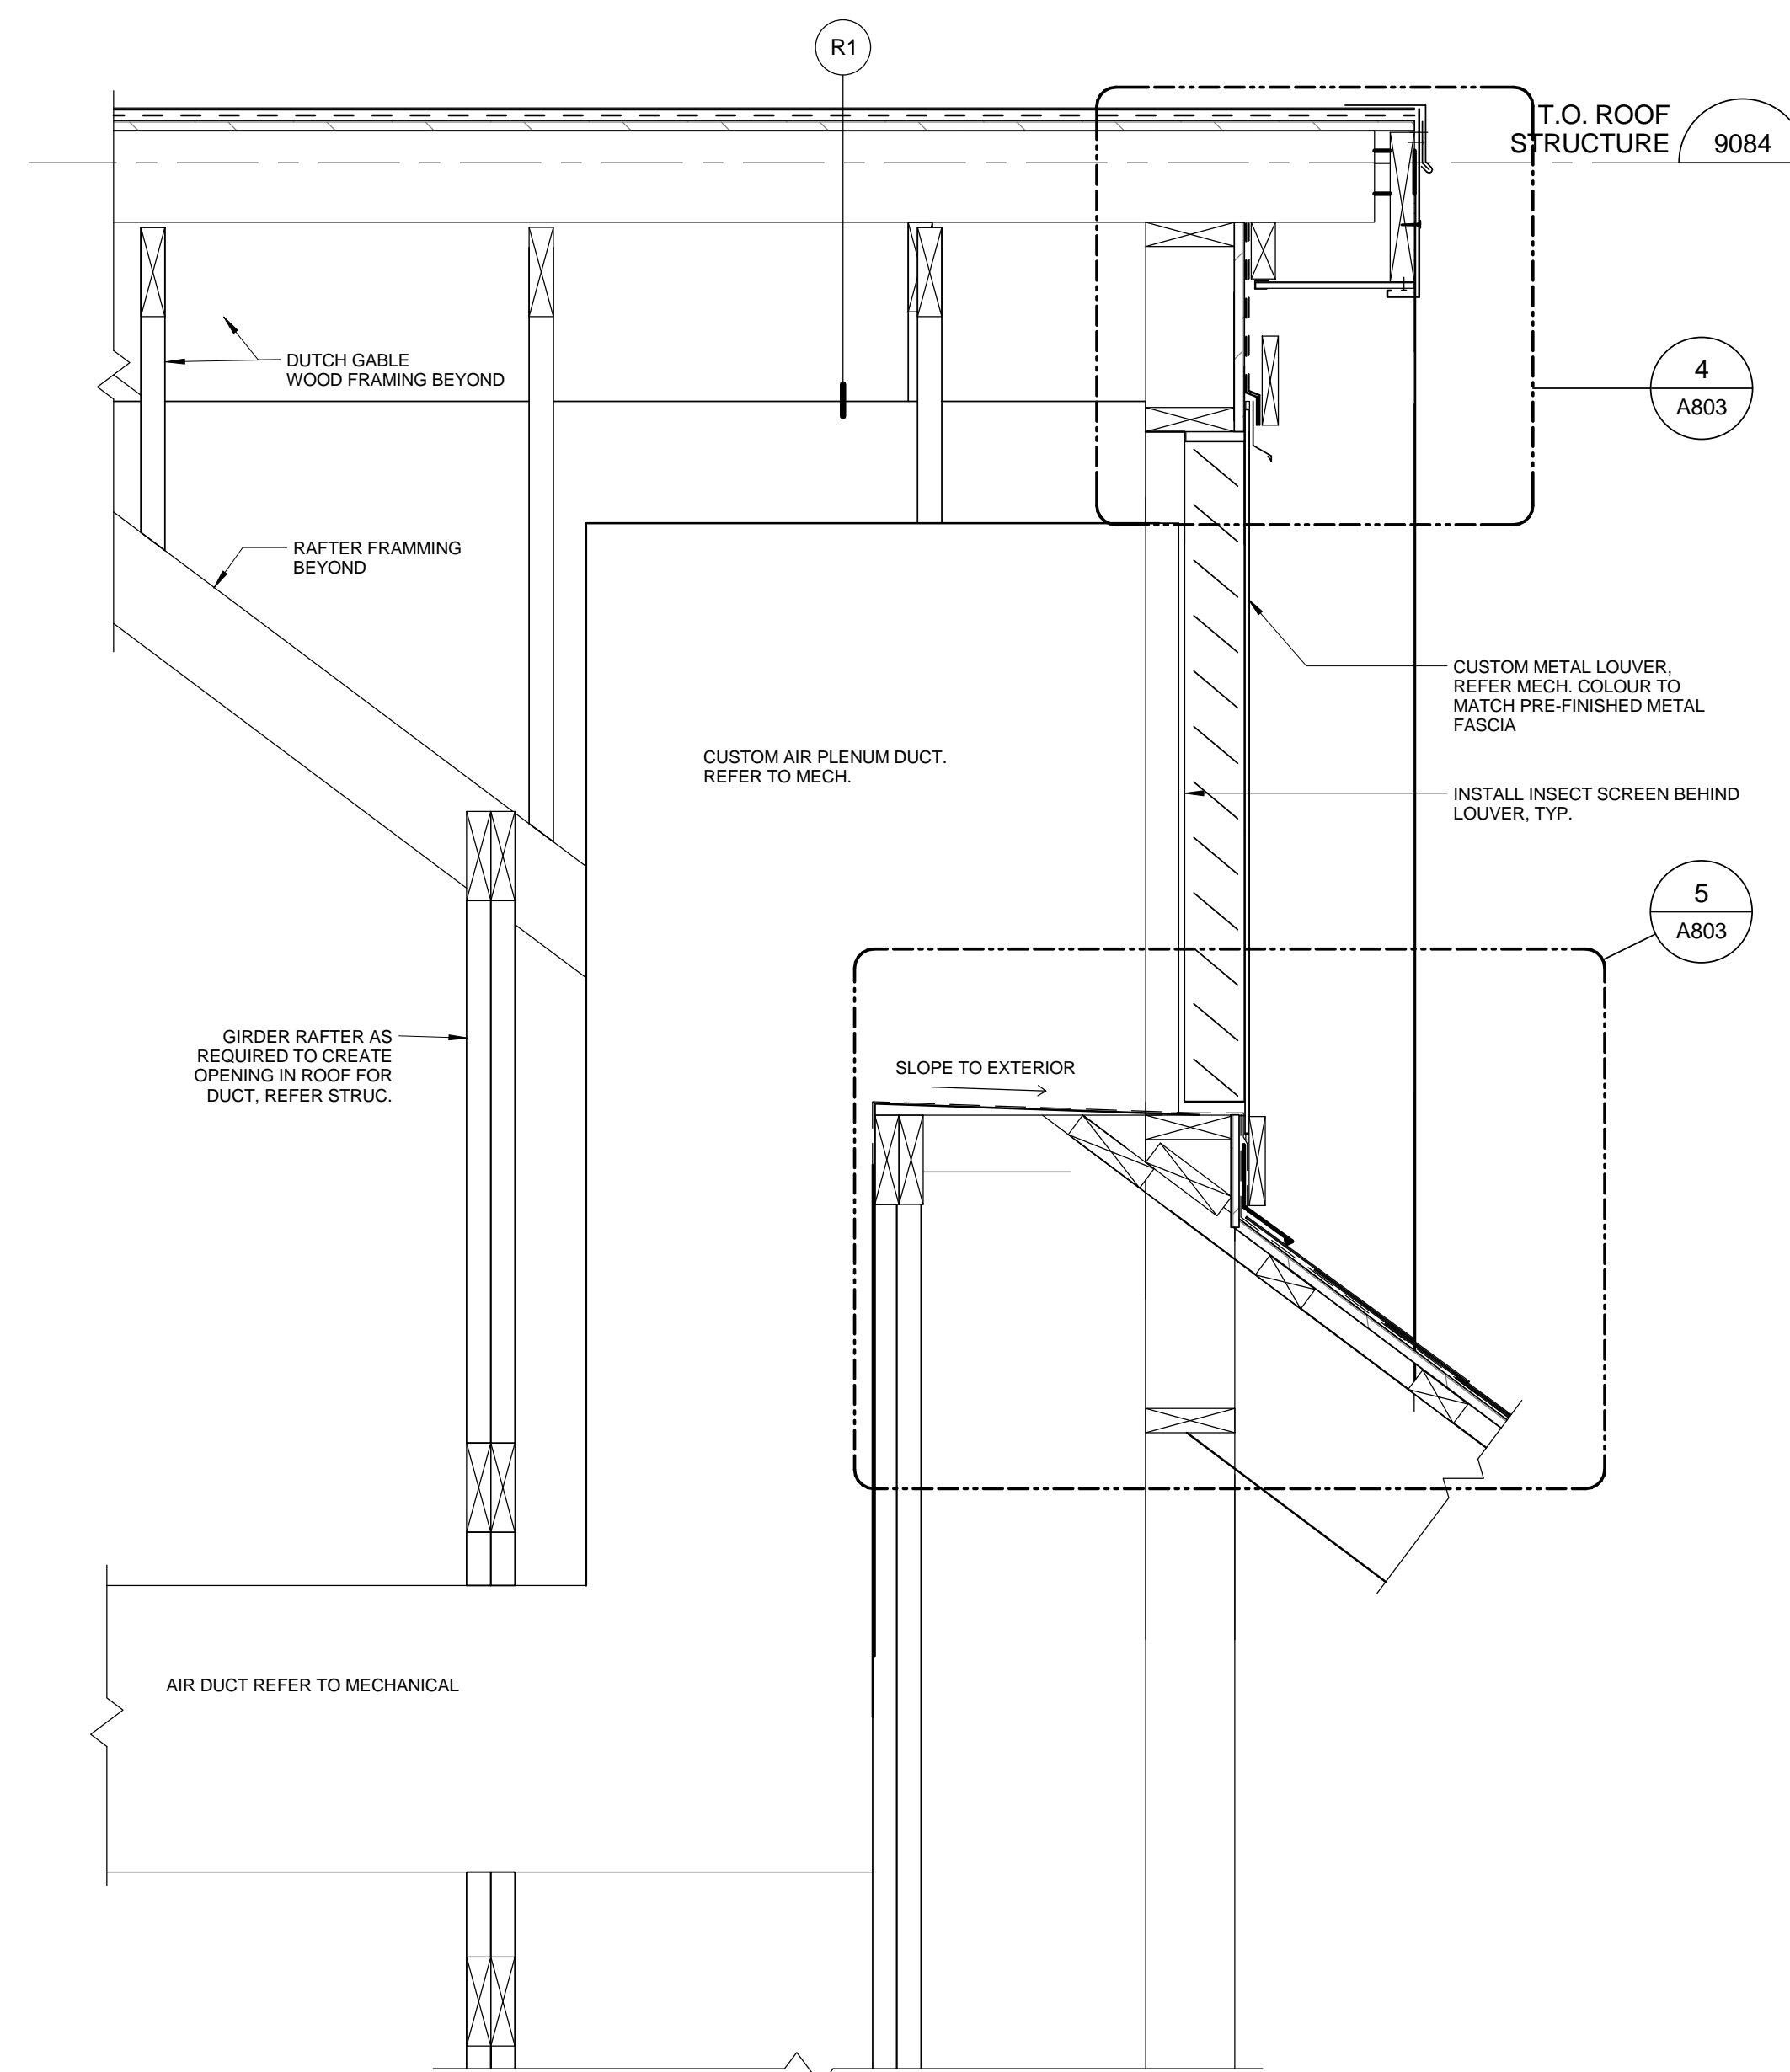


4 ROOF SECTION - TYPICAL GABLE VENT
A801 Scale: 1 : 10

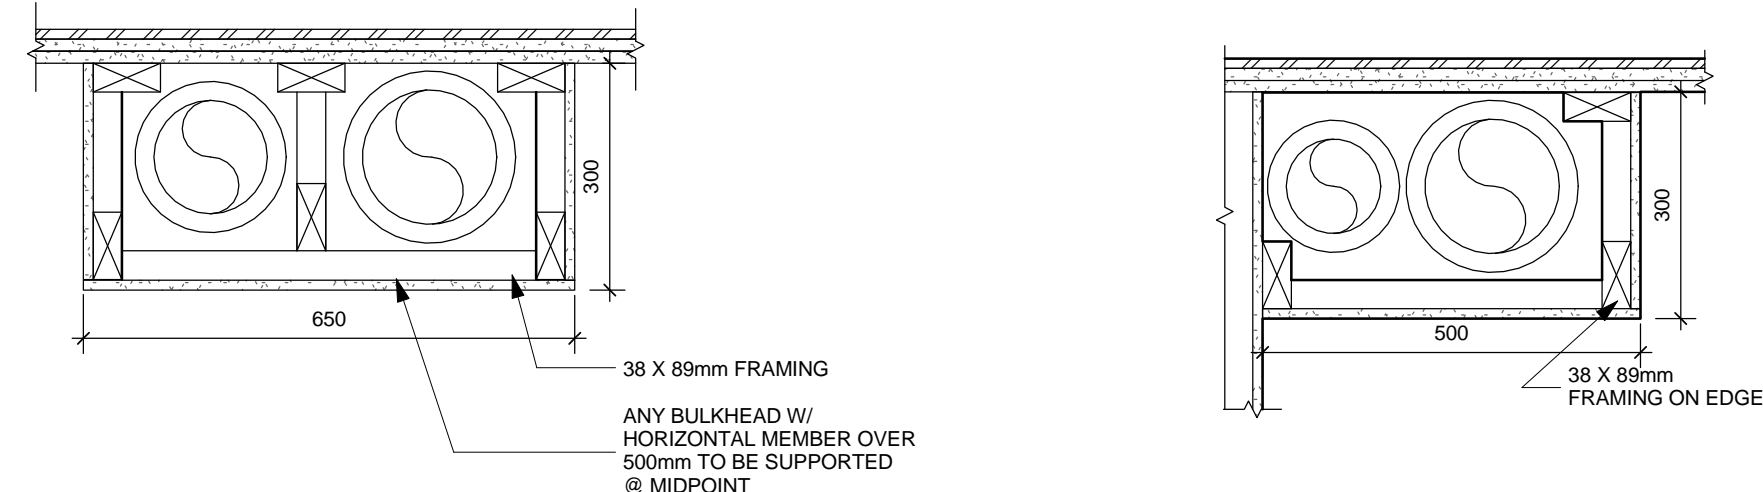

2 OVERSIZE BULKHEAD ASSEMBLY
A801 Scale: 1 : 10

3 STANDARD BULKHEAD ASSEMBLY
A801 Scale: 1 : 10

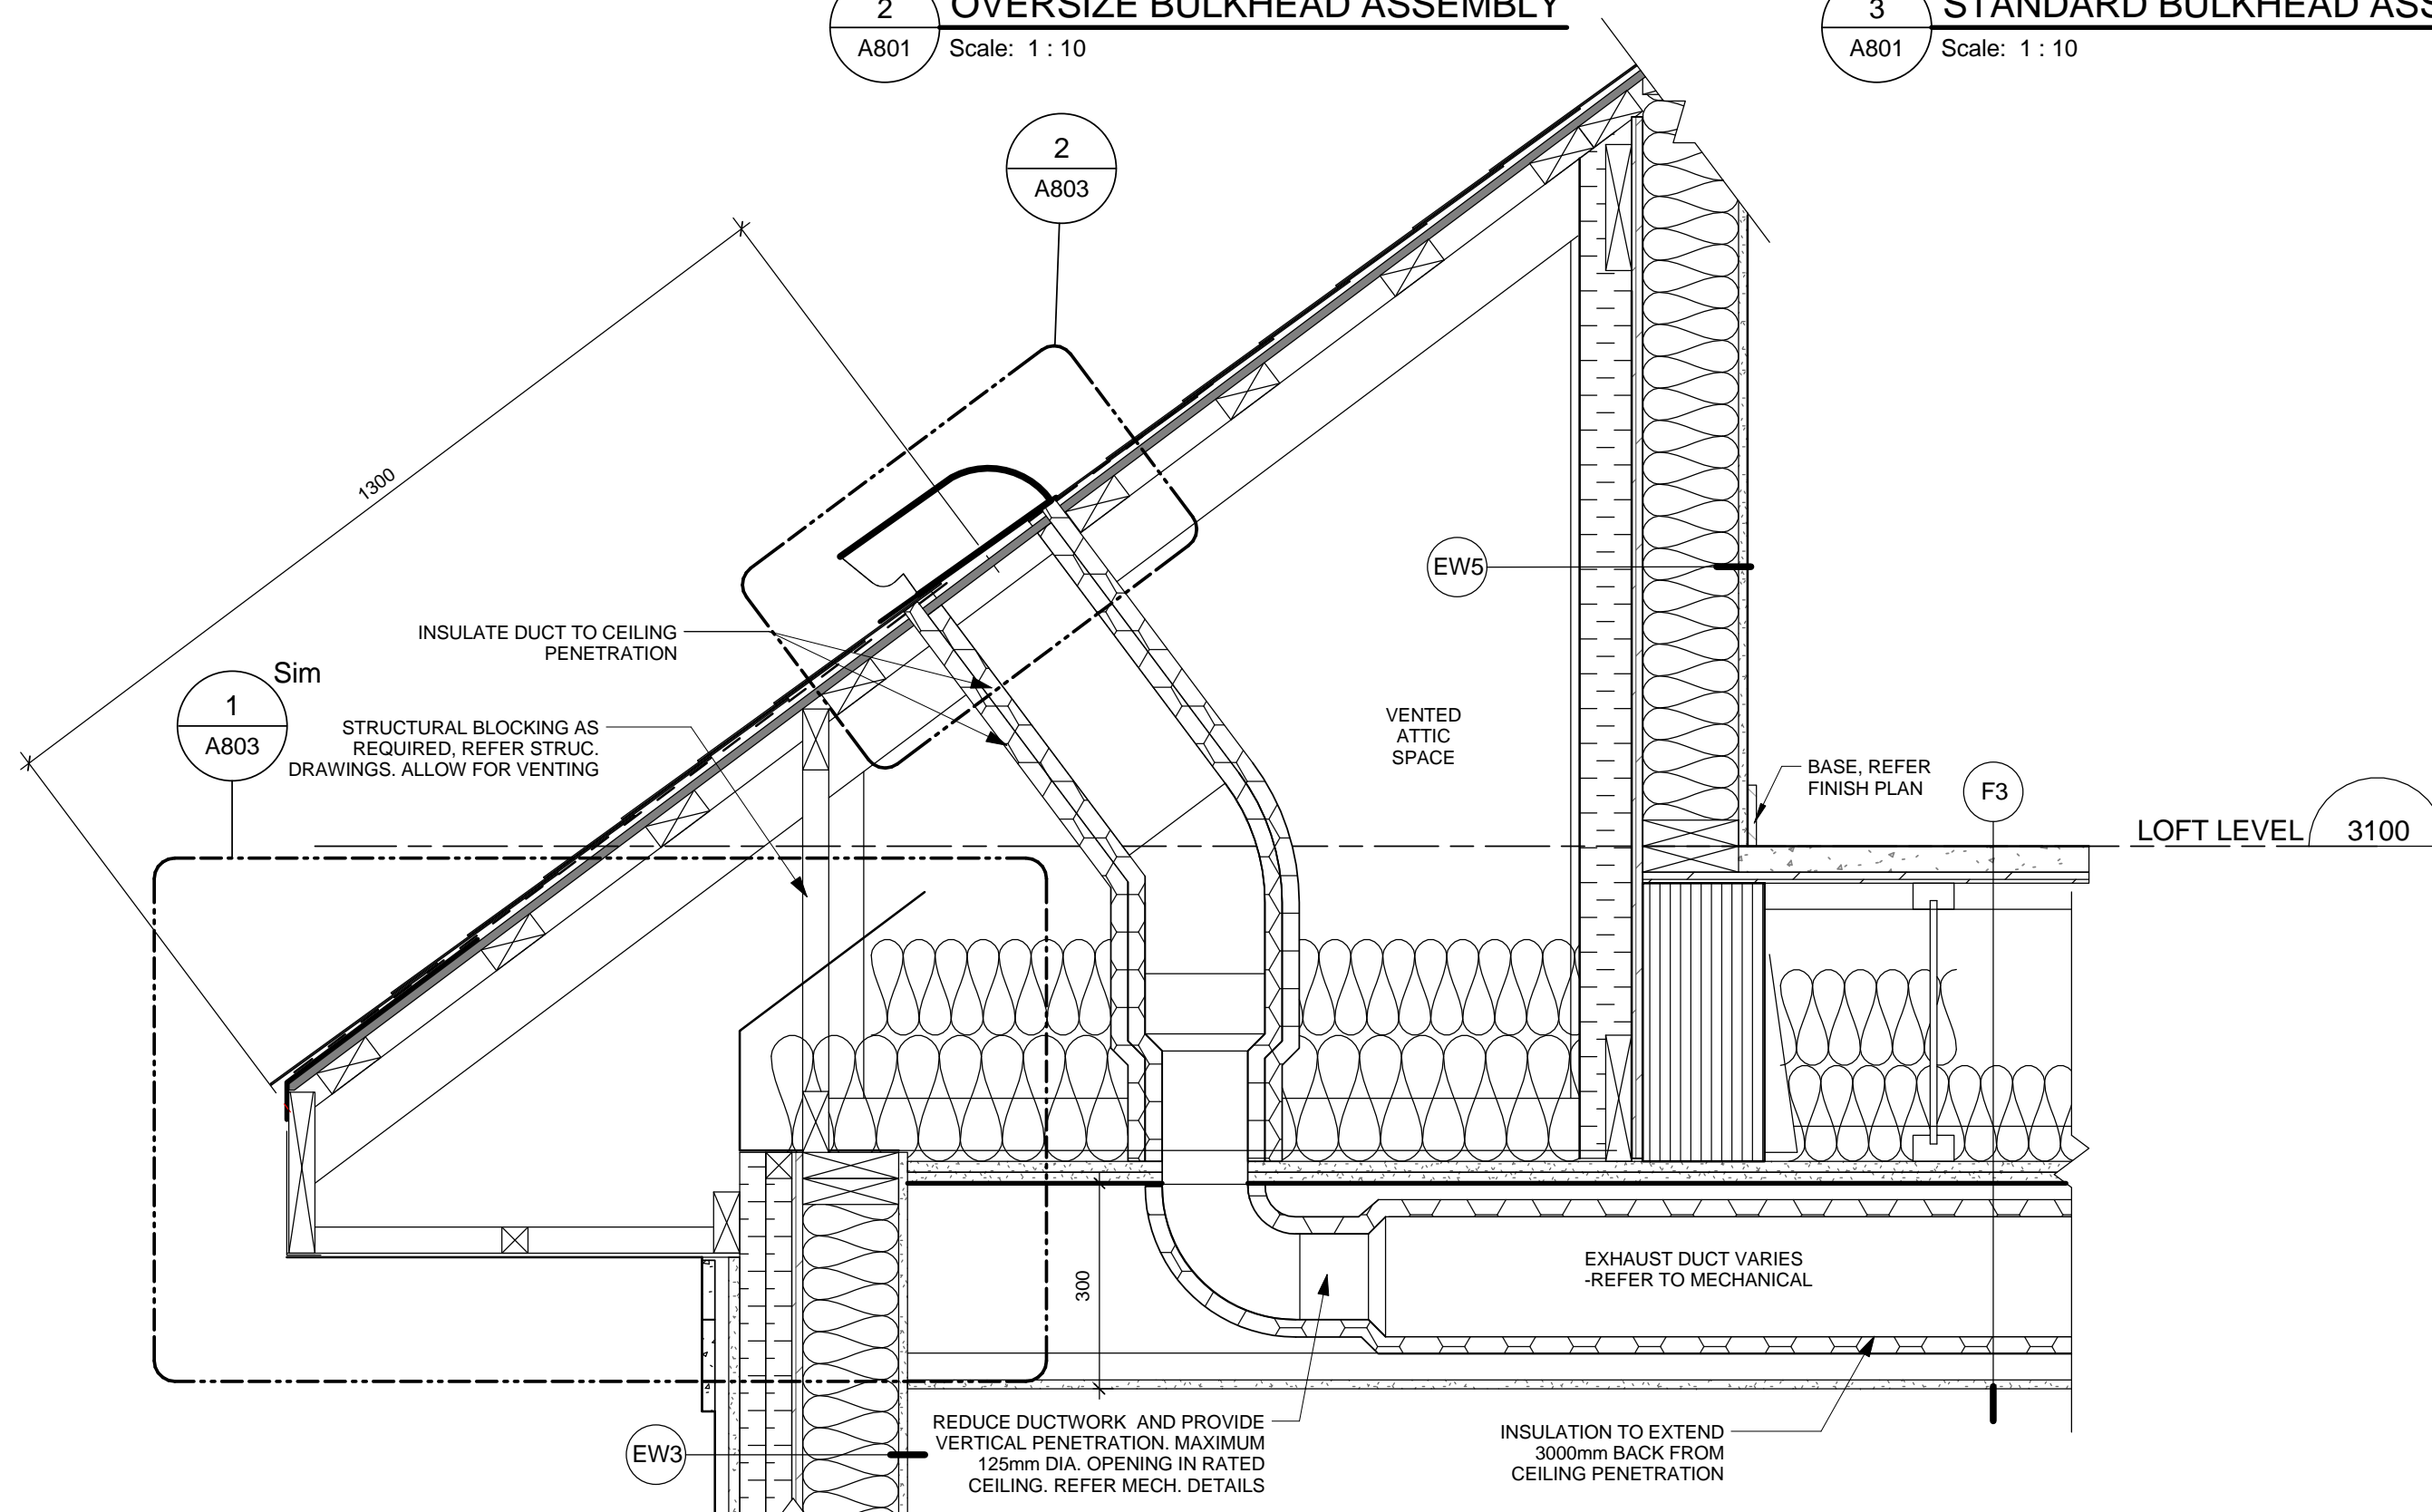

1 SECTION DETAIL - TYPICAL EXHAUST DUCT ROOF PENETRATION @ EAVE
A801 Scale: 1 : 10

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No.	Date/Date	Description/Description	Drawn by Dessiné par	Approved Approuvé
4	2016-12-08	ISSUED FOR TENDER		
3	2016-12-08	ISSUED FOR BUILDING PERMIT		
2	2016-09-02	ISSUED FOR 99% REVIEW		
1	2016-06-14	ISSUED FOR 66% REVIEW		

Revision / Revision	
A detail number numéro de détail	A
B source drawing no. de dessin no.	B
C detail on drawing no. détail sur dessin no.	C

Consultant's Name Nom de l'expert-consult	Eng. Stamp Sceau de l'ingénieur
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Client Services Team Southern Alberta Operations Branch	Le Client Entretien l'Équipe Alberta Méridional Branche d'Opérations

Canada

Client/client	Parks Canada Agence	L'Agence Parcs Canada
	Western and Northern Region	Ouest et Nord du Canada

Staff Housing Phase 2 Waterton Lakes National Park

SECTION DETAILS

Surveyed by/Arpenté par	Drawn by/Dessiné par	Date/Date
LS/FVR	MP/AG	2016-12-08
Designed by/Concept par	Reviewed by/Revisé par	Scale/Echelle
LS/FVR	LS/FVR	As indicated

PWGSC Project Manager/Administrateur de Projets TPSCGC
Randy Boldt

Client Acceptance/Acceptation du client
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Project No./No. du projet	Asset No./No. d'actif	Sheet No./ No. de la feuille
39000	File # 945	A801
Drawing Reference No./No. de référence du dessin		




Drawing title/Titre du dessin


SECTION DETAILS

Drawing Reference No./No. de reference du dessin	A802
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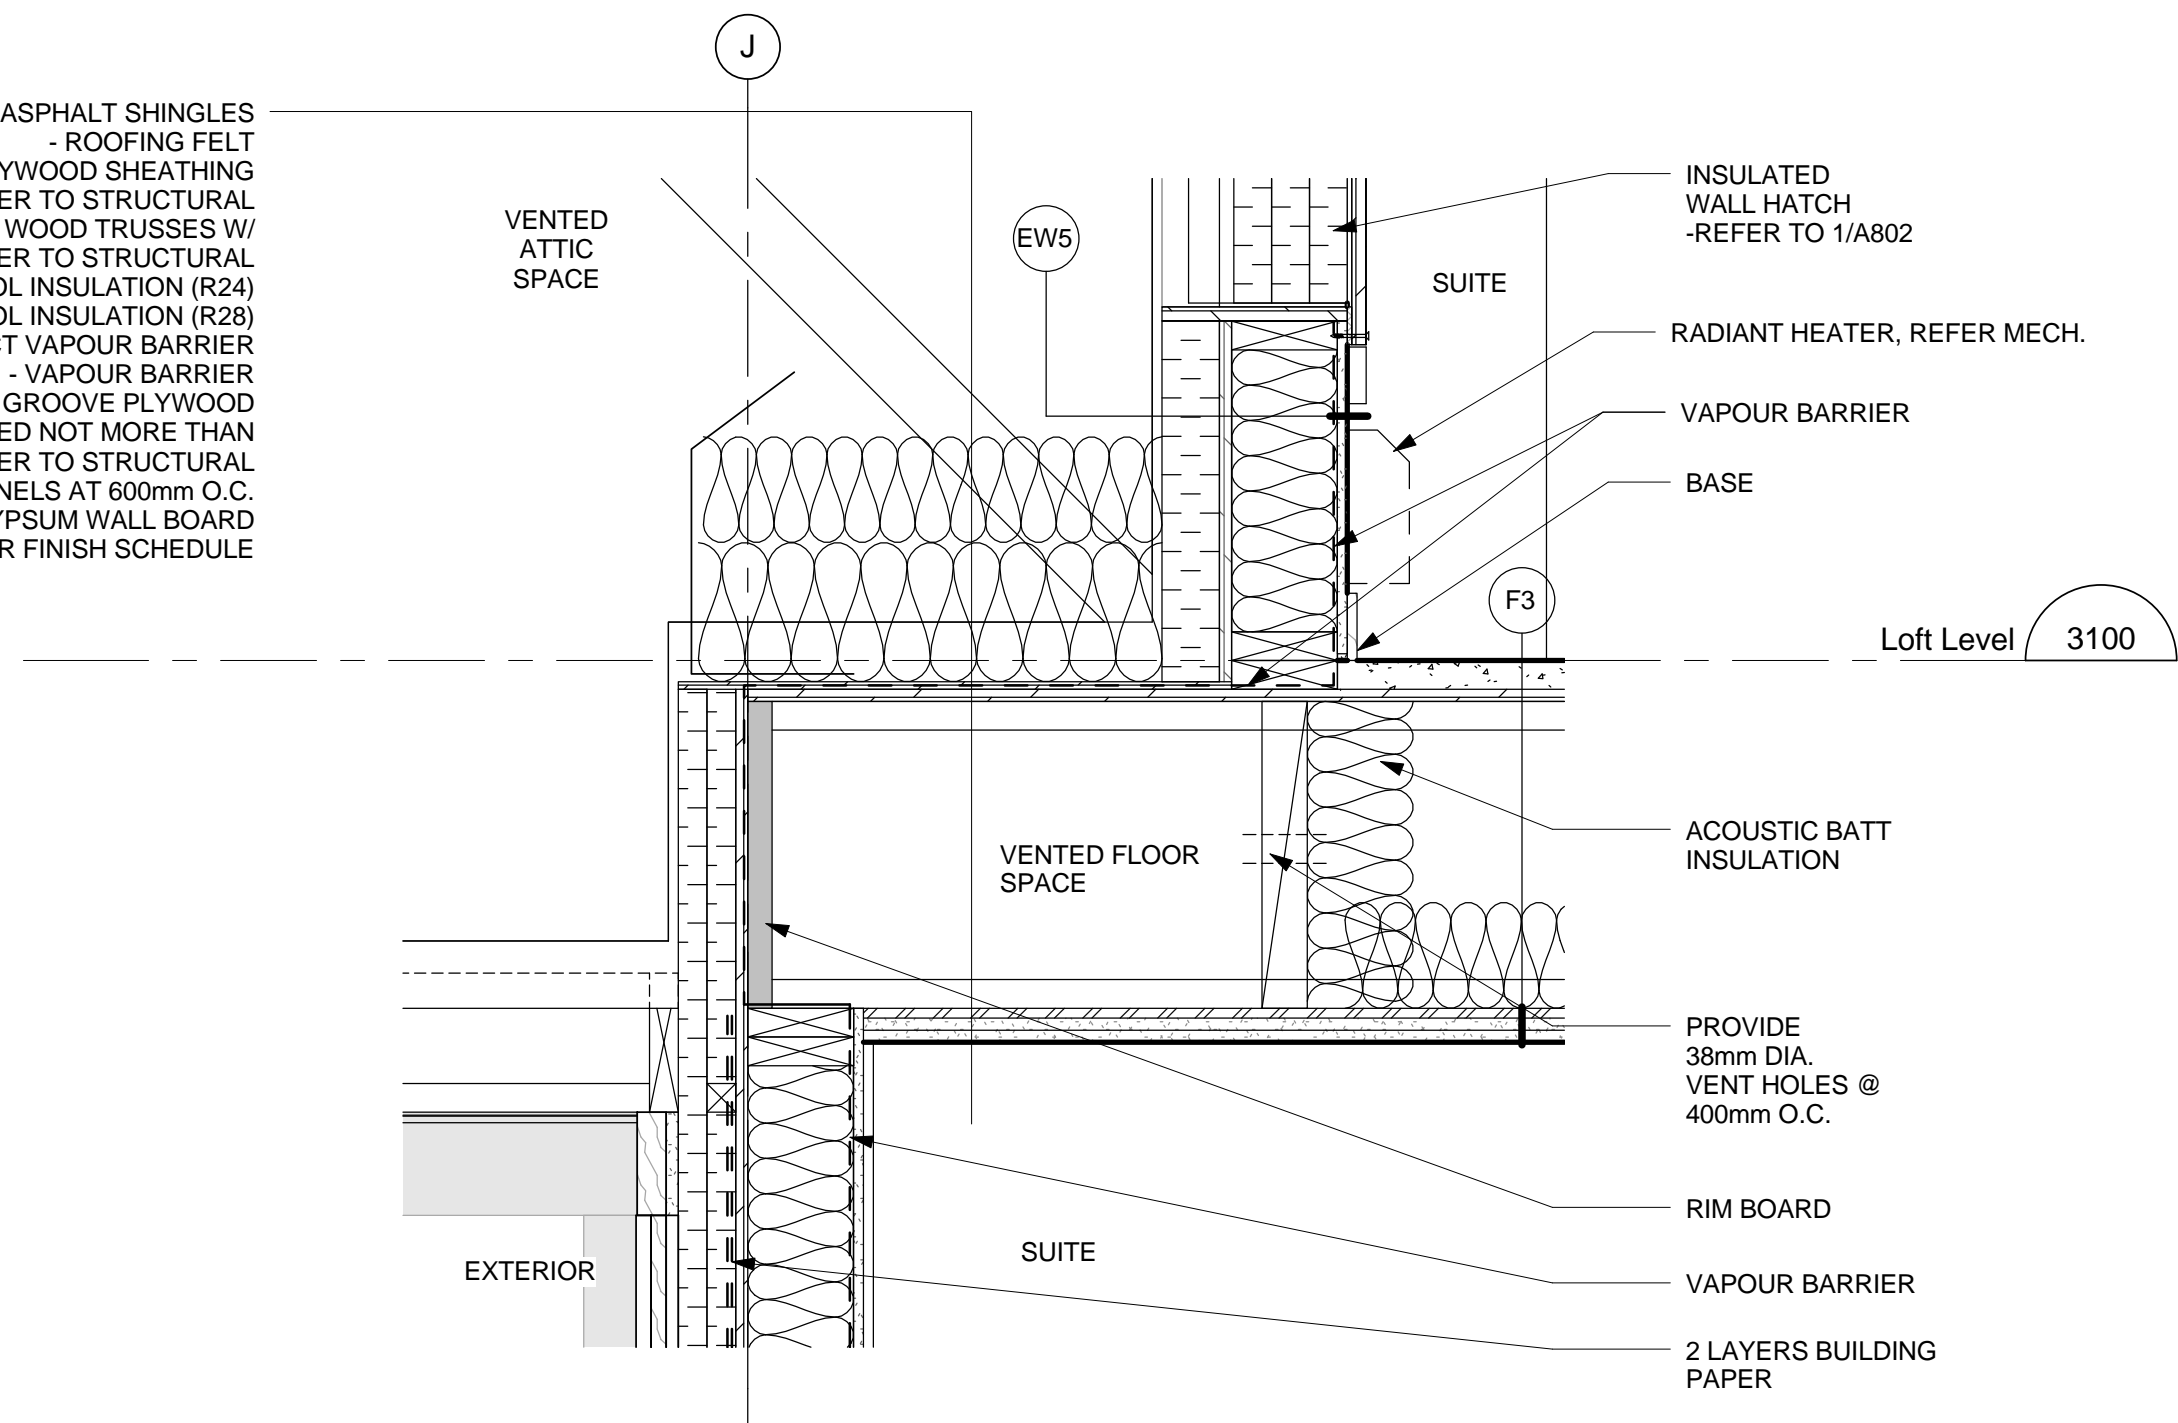


1 SECTION DETAIL - TYPICAL OVERHANG DETAIL
A803 Scale: 1 : 5

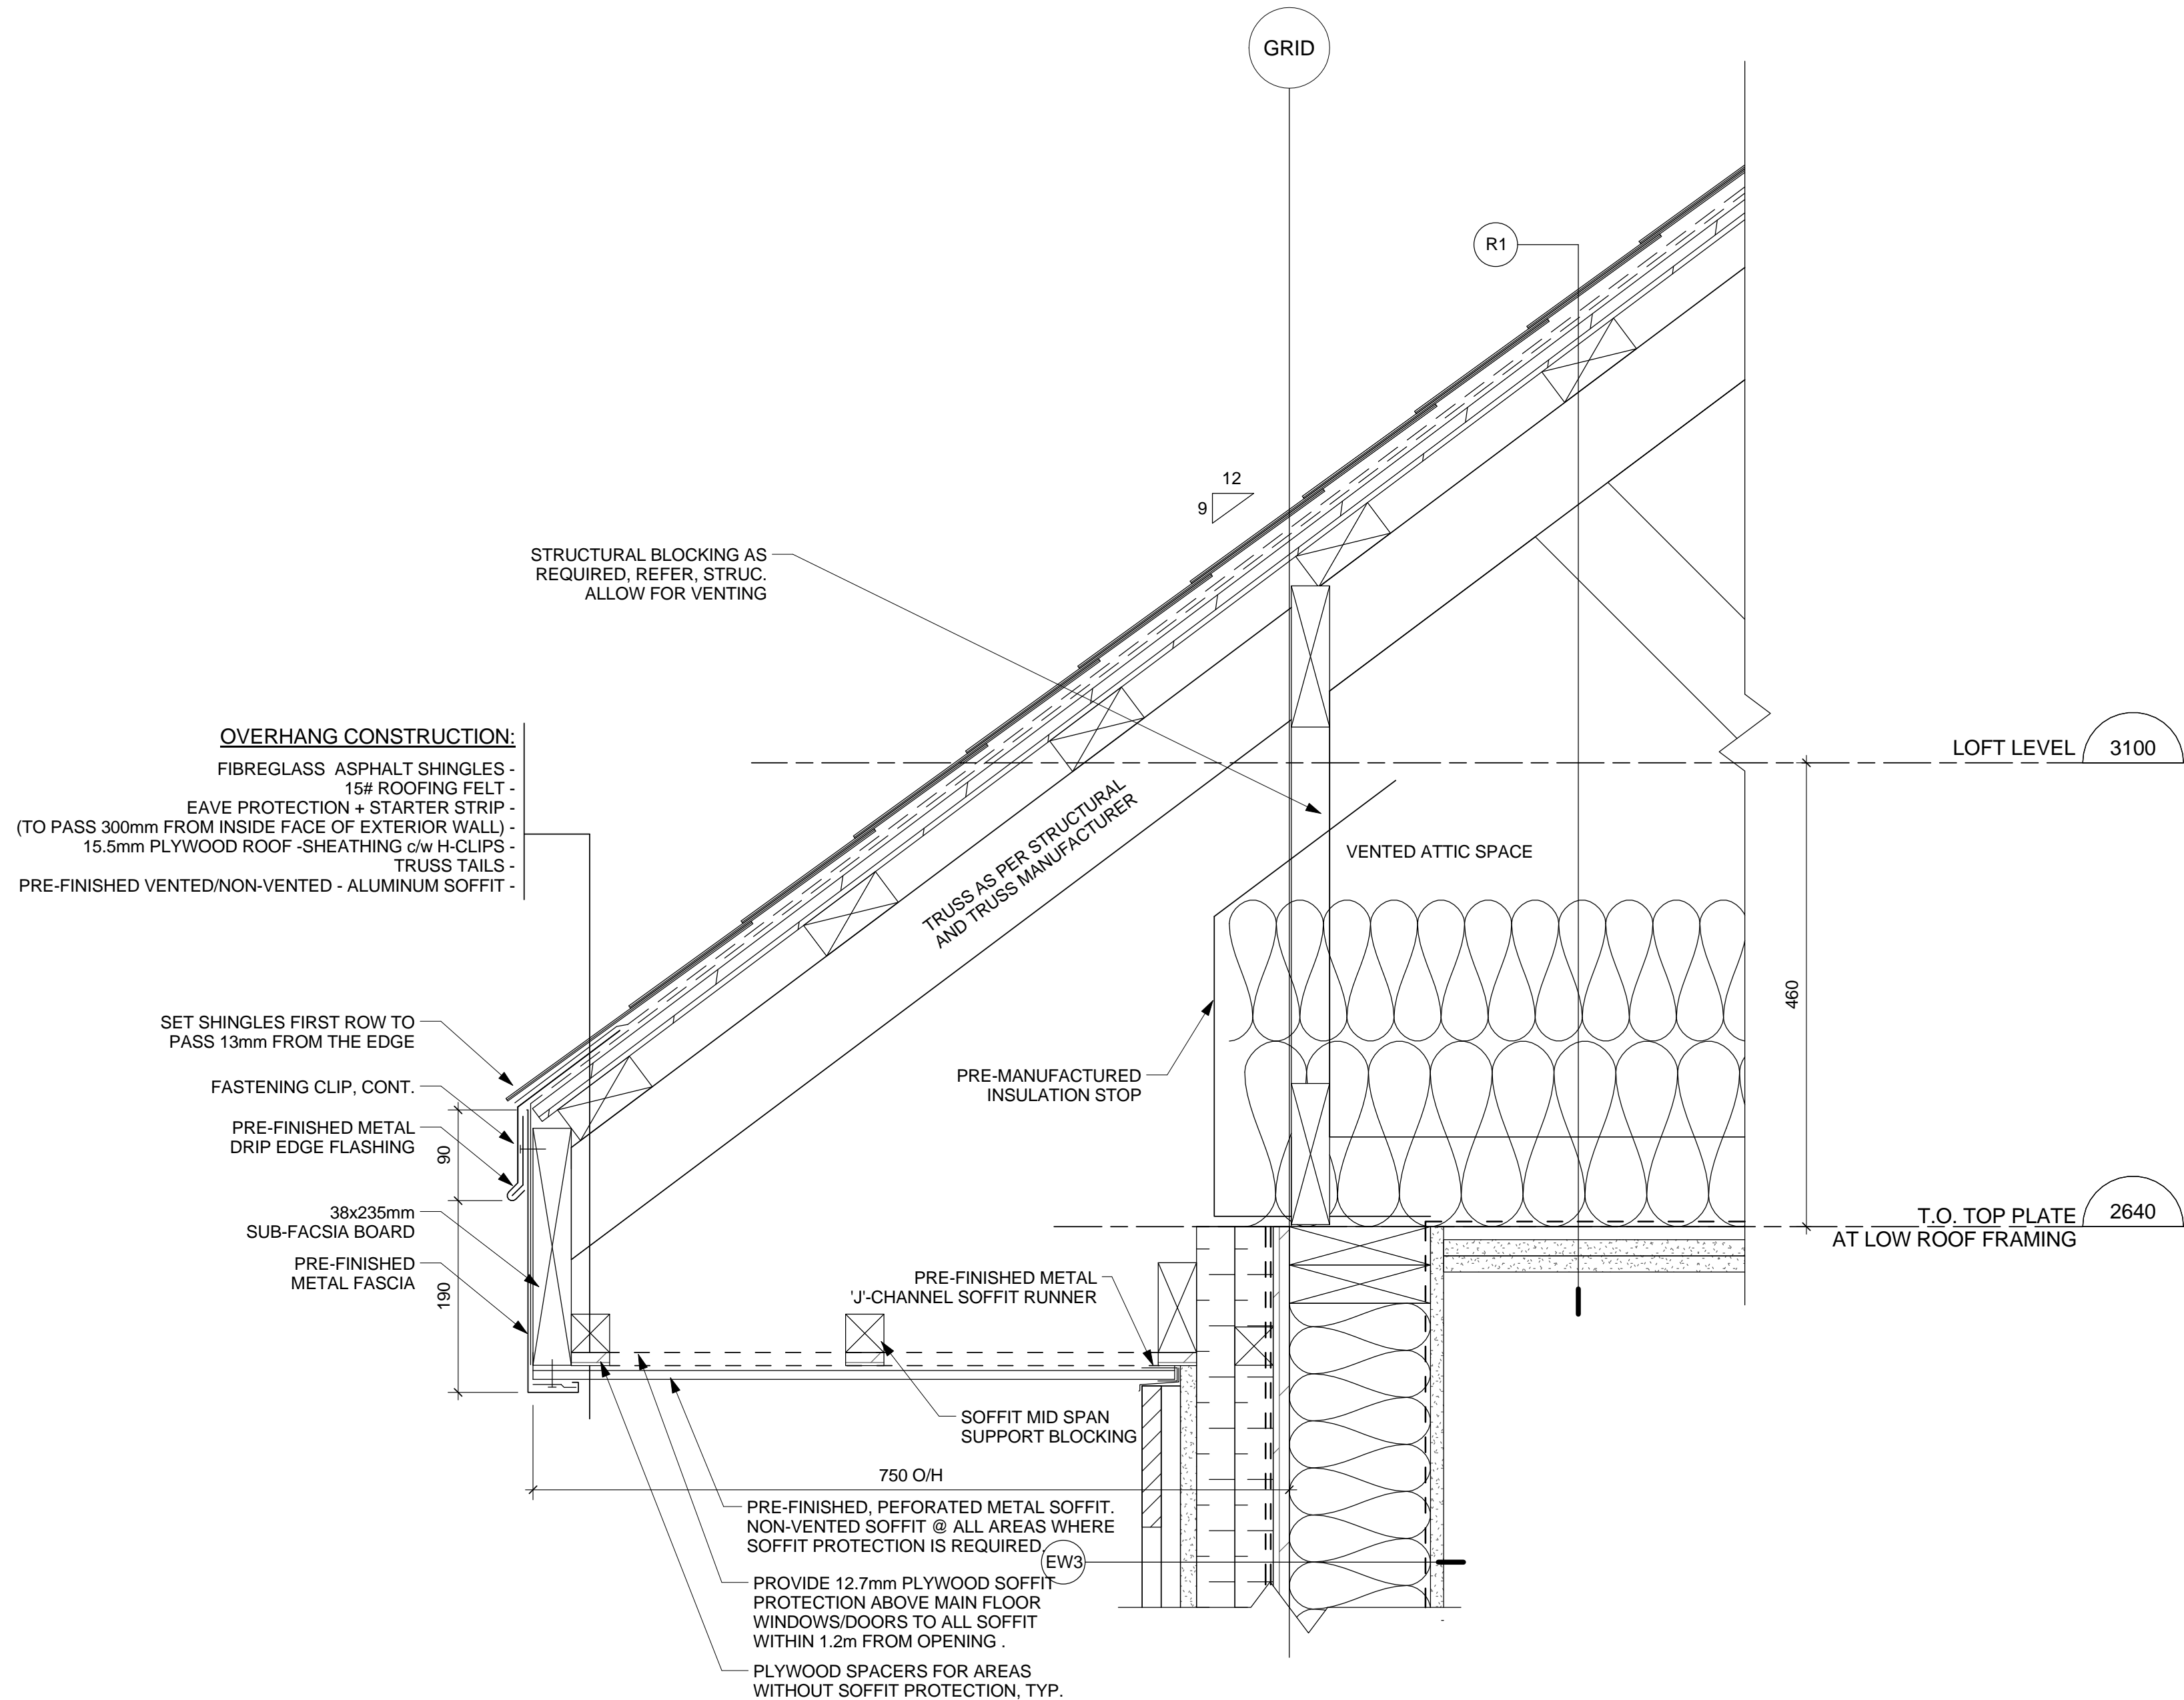


6 TYPICAL DORMER WINDOW SILL
A803 Scale: 1 : 5

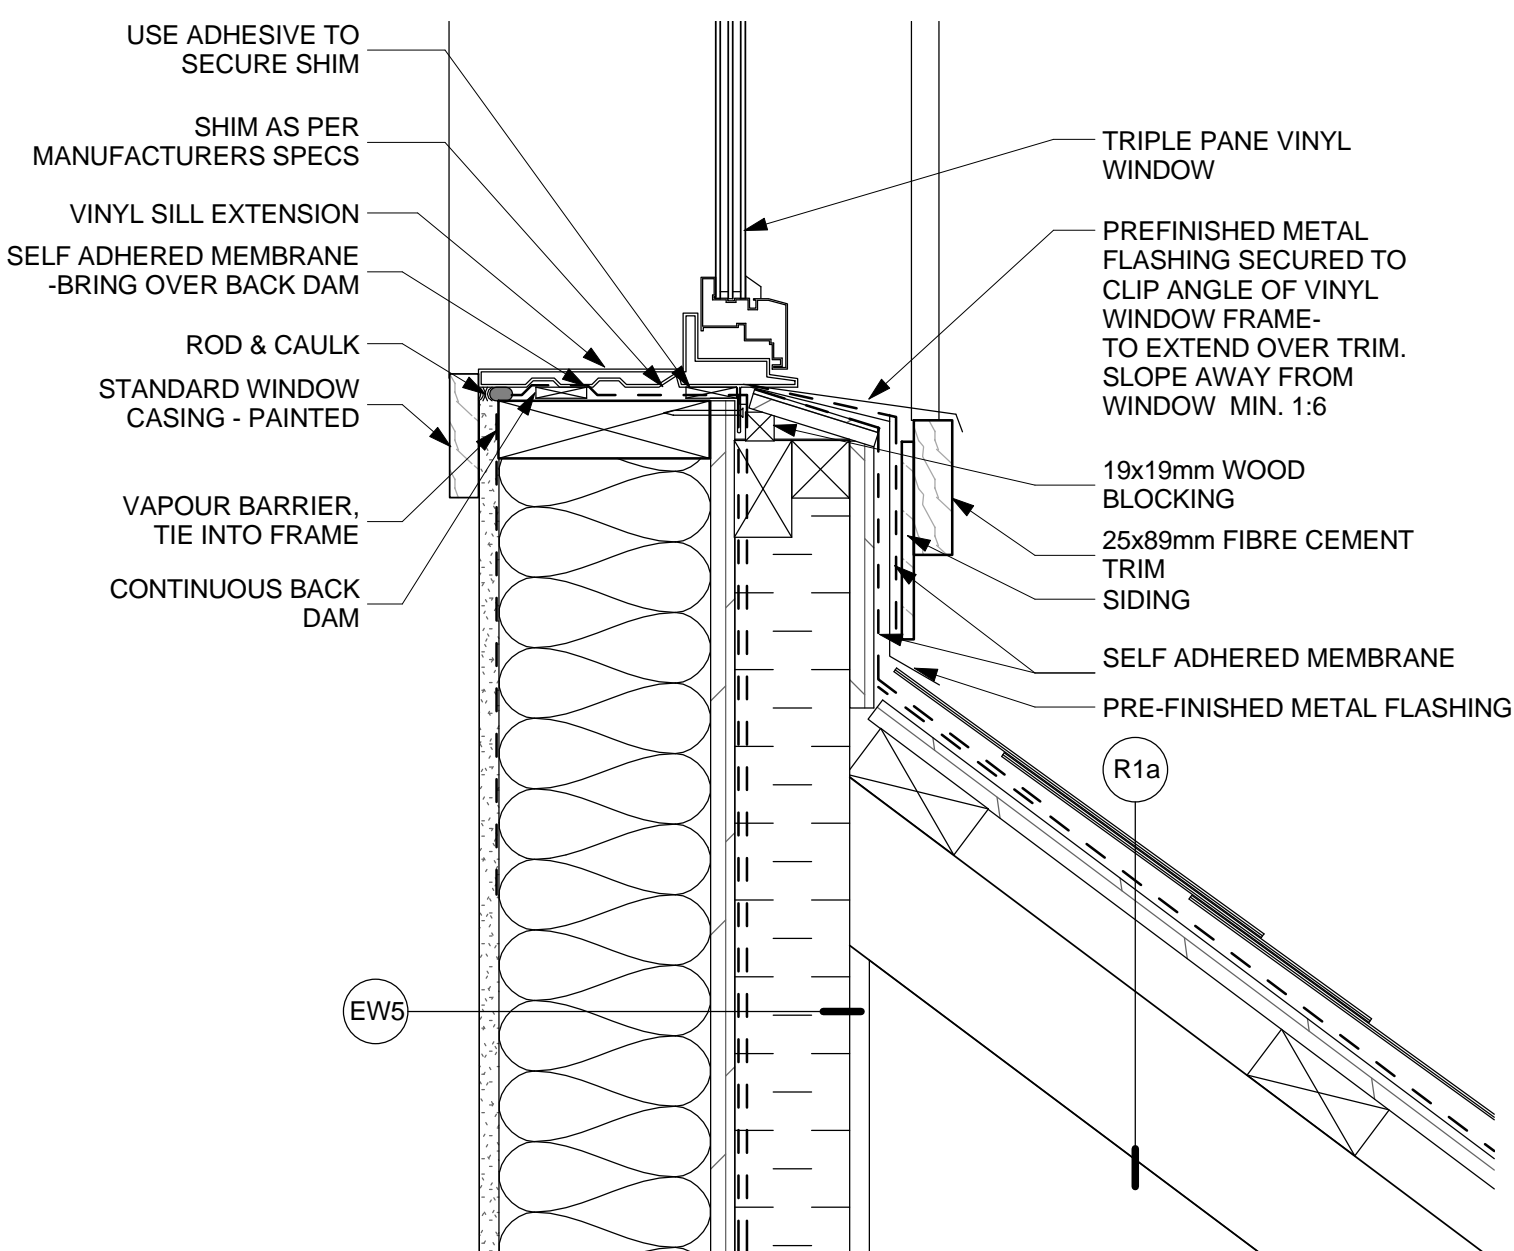
- FIBREGLASS REINFORCED ASPHALT SHINGLES
- ROOFING FELT
- 15.5mm PLYWOOD SHEATHING
- WOOD STRAPPING -REFER TO STRUCTURAL
- ENGINEERED WOOD TRUSSES W/ VENTED ATTIC SPACE -REFER TO STRUCTURAL
- 140mm MINERAL WOOL INSULATION (R24)
- 184mm MINERAL WOOL INSULATION (R28)
- 9.5mm PLYWOOD SHEATHING TO PROTECT VAPOUR BARRIER
- VAPOUR BARRIER
- 15.5mm TONGUE & GROOVE PLYWOOD
- WOOD TRUSSES SPACED NOT MORE THAN 600mm O.C. - REFER TO STRUCTURAL
- 12.7mm RESILIENT METAL CHANNELS AT 600mm O.C.
- 2 LAYERS OF 15.5mm TYPE 'X' GYPSUM WALL BOARD
- FINISH AS PER FINISH SCHEDULE



7 LOFT FLOOR @ REAR CANOPY
A803 Scale: 1 : 10

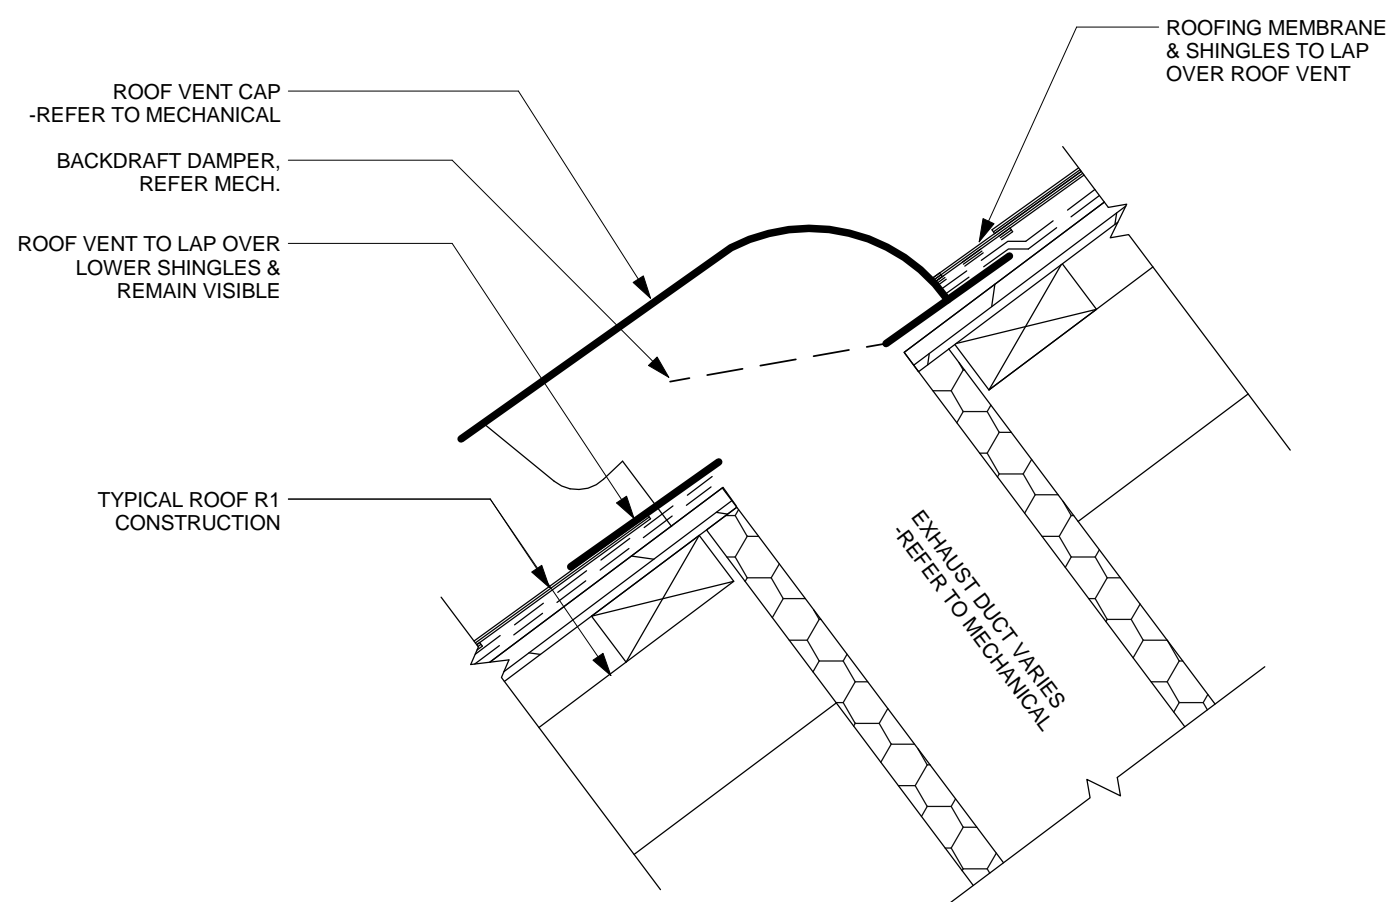

2 SECTION DETAIL - EXHAUST DUCT ROOF PENETRATION
A803 Scale: 1 : 5

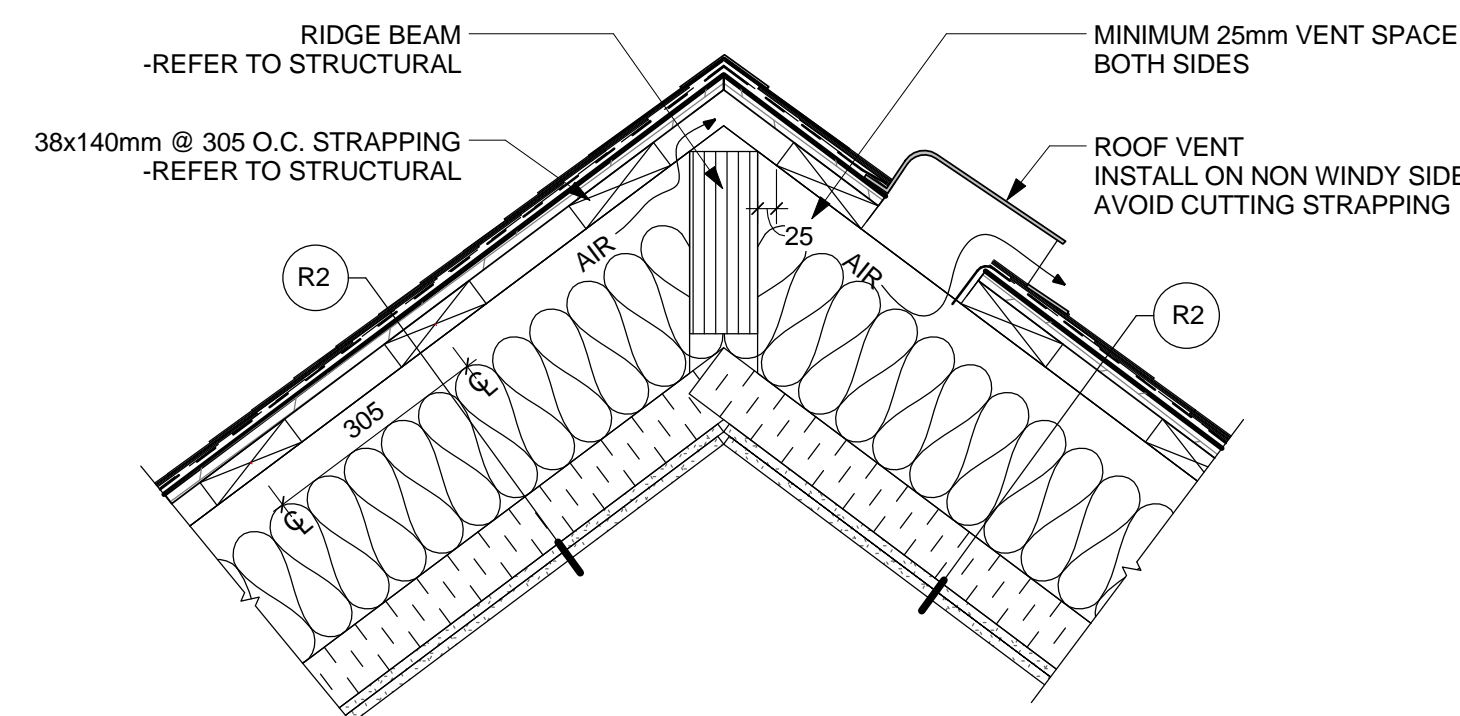

3 R2 DORMER WITH ROOF VENTING
A803 Scale: 1 : 10

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1	2016-06-14	ISSUED FOR 60% REVIEW		

No.	Date/Date	Description/Description	Drawn by Dessiné par	Approved Approuvé
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Revision / Revision	
A	detail number numero de detail
B	source drawing no. de dessin no.
C	detail on drawing no. detail sur dessin no.

Consultant's Name
Nom de l'expert-conseil

Eng. Stamp
Sceau de l'ingénieur

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Suite 500 - 611 Meredith Road NE
Calgary Alberta T2E 2W5
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Ouest et Nord
du Canada

Staff Housing Phase 2 Waterton Lakes National Park

Drawing title/Titre du dessin

SECTION DETAILS

Surveyed by/Arpente par	Drawn by/Dessiné par	Date/Date
LS/FVR	MP/AG	2016-12-08
Designed by/Concept par	Reviewed by/Revisé par	Scale/Echelle
LS/FVR	LS/FVR	As indicated

PWGSC Project Manager/Administrateur de Projets TP50C

Client Acceptance/Acceptation du client

Approved by/Approuvé par

Task Responsible Officer/Agent Responsable

Task Responsible Officer/Administrateur de Projets TP50C

Project No./No. du projet

Asset No./No. du bien

Sheet No./
No. de la feuille

39000


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A803


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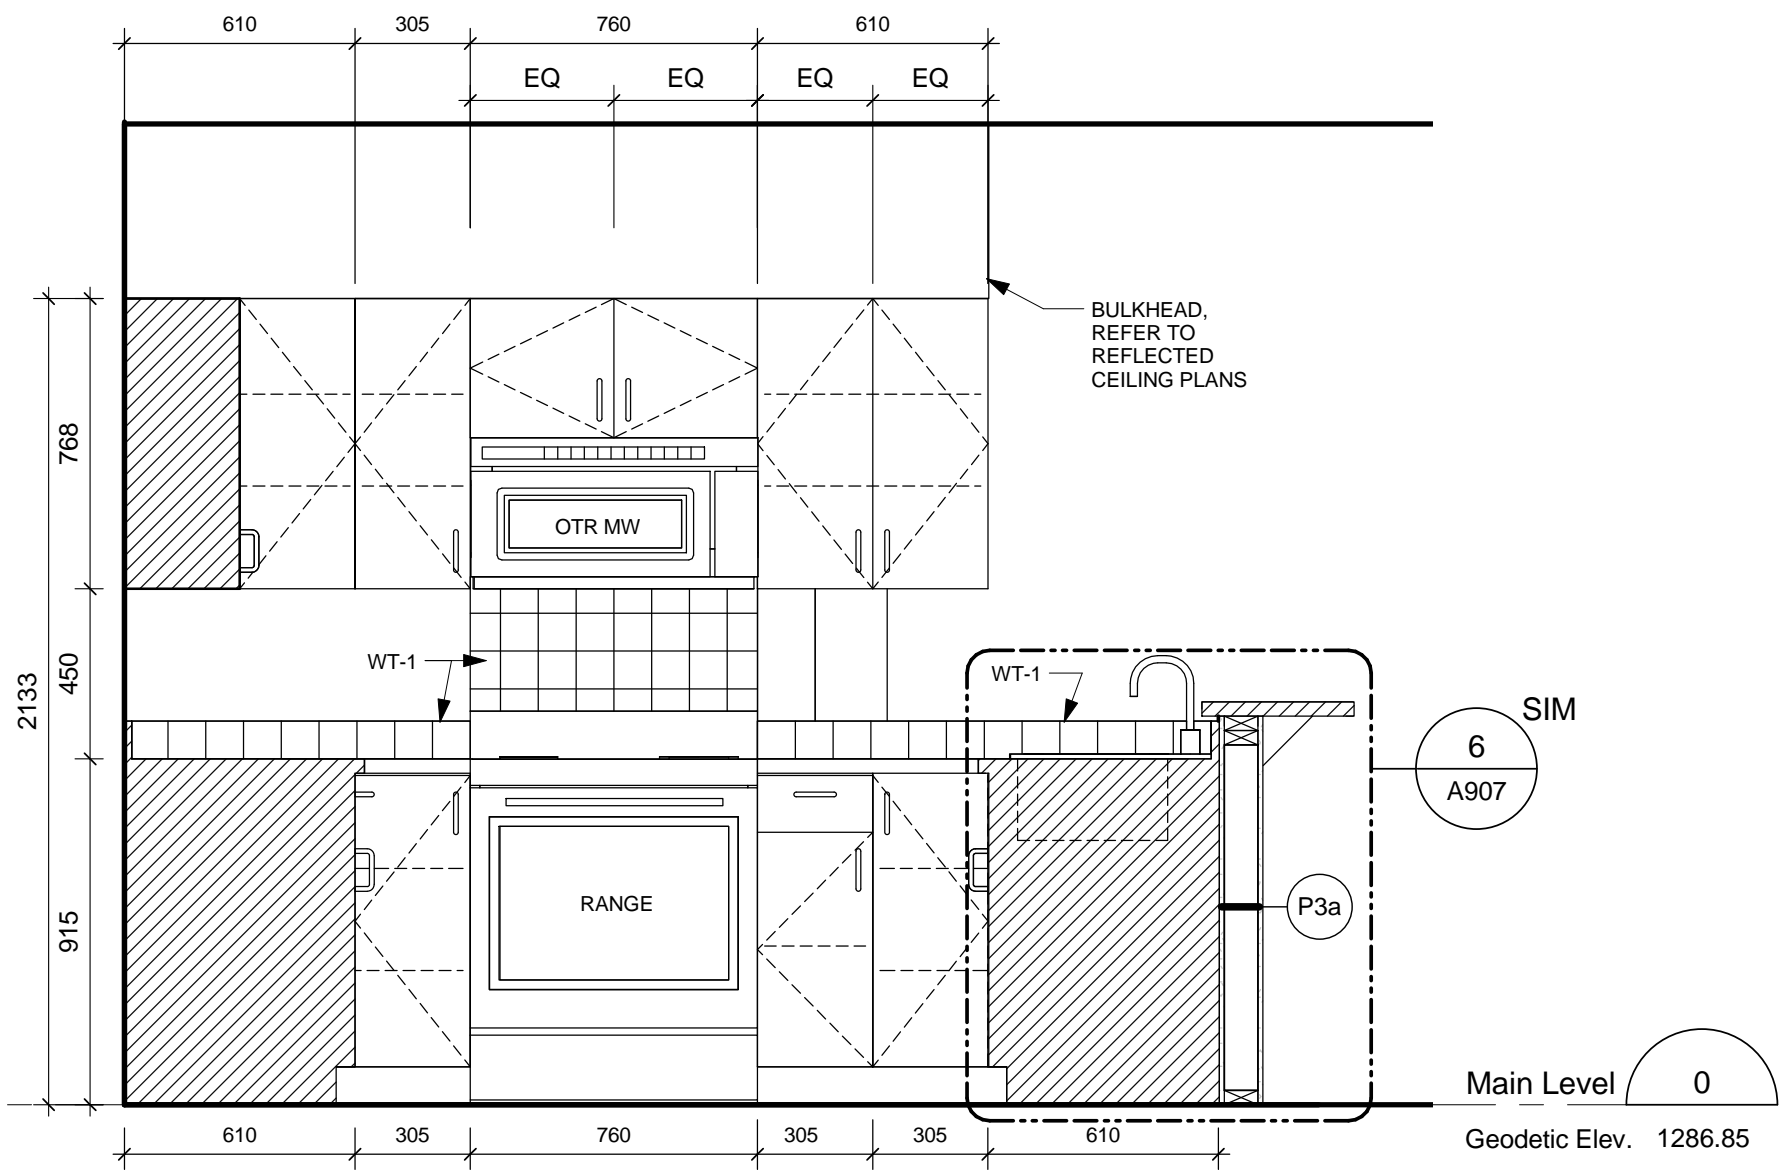
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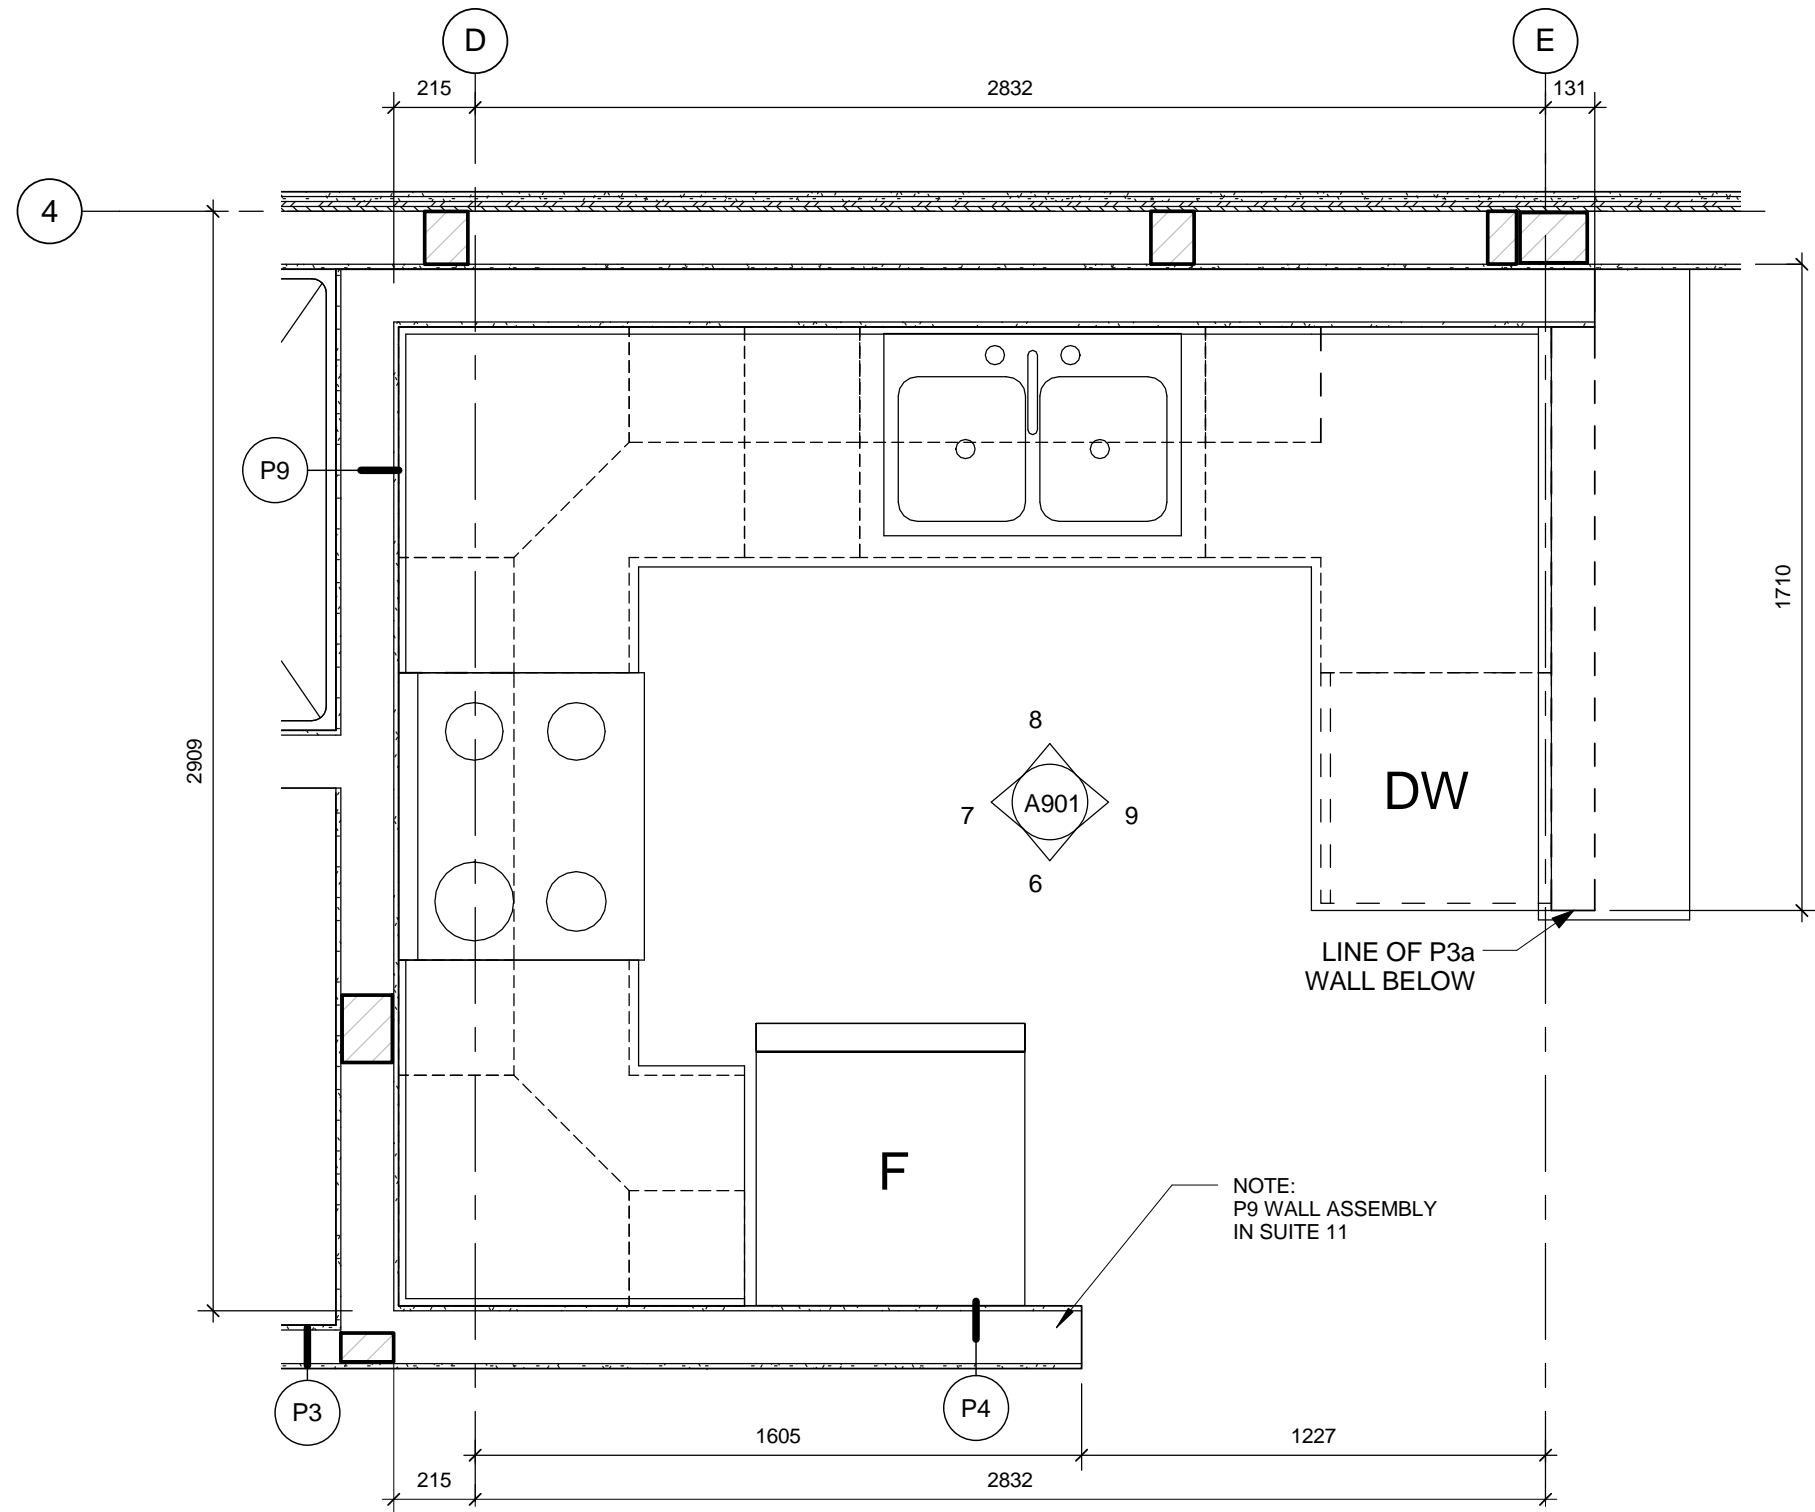
1 Typical Enlarged Plan - Kitchen 1
A901 Scale: 1 : 20




2 Typical Kitchen 1 Elevation 1
A901 Scale: 1 : 20

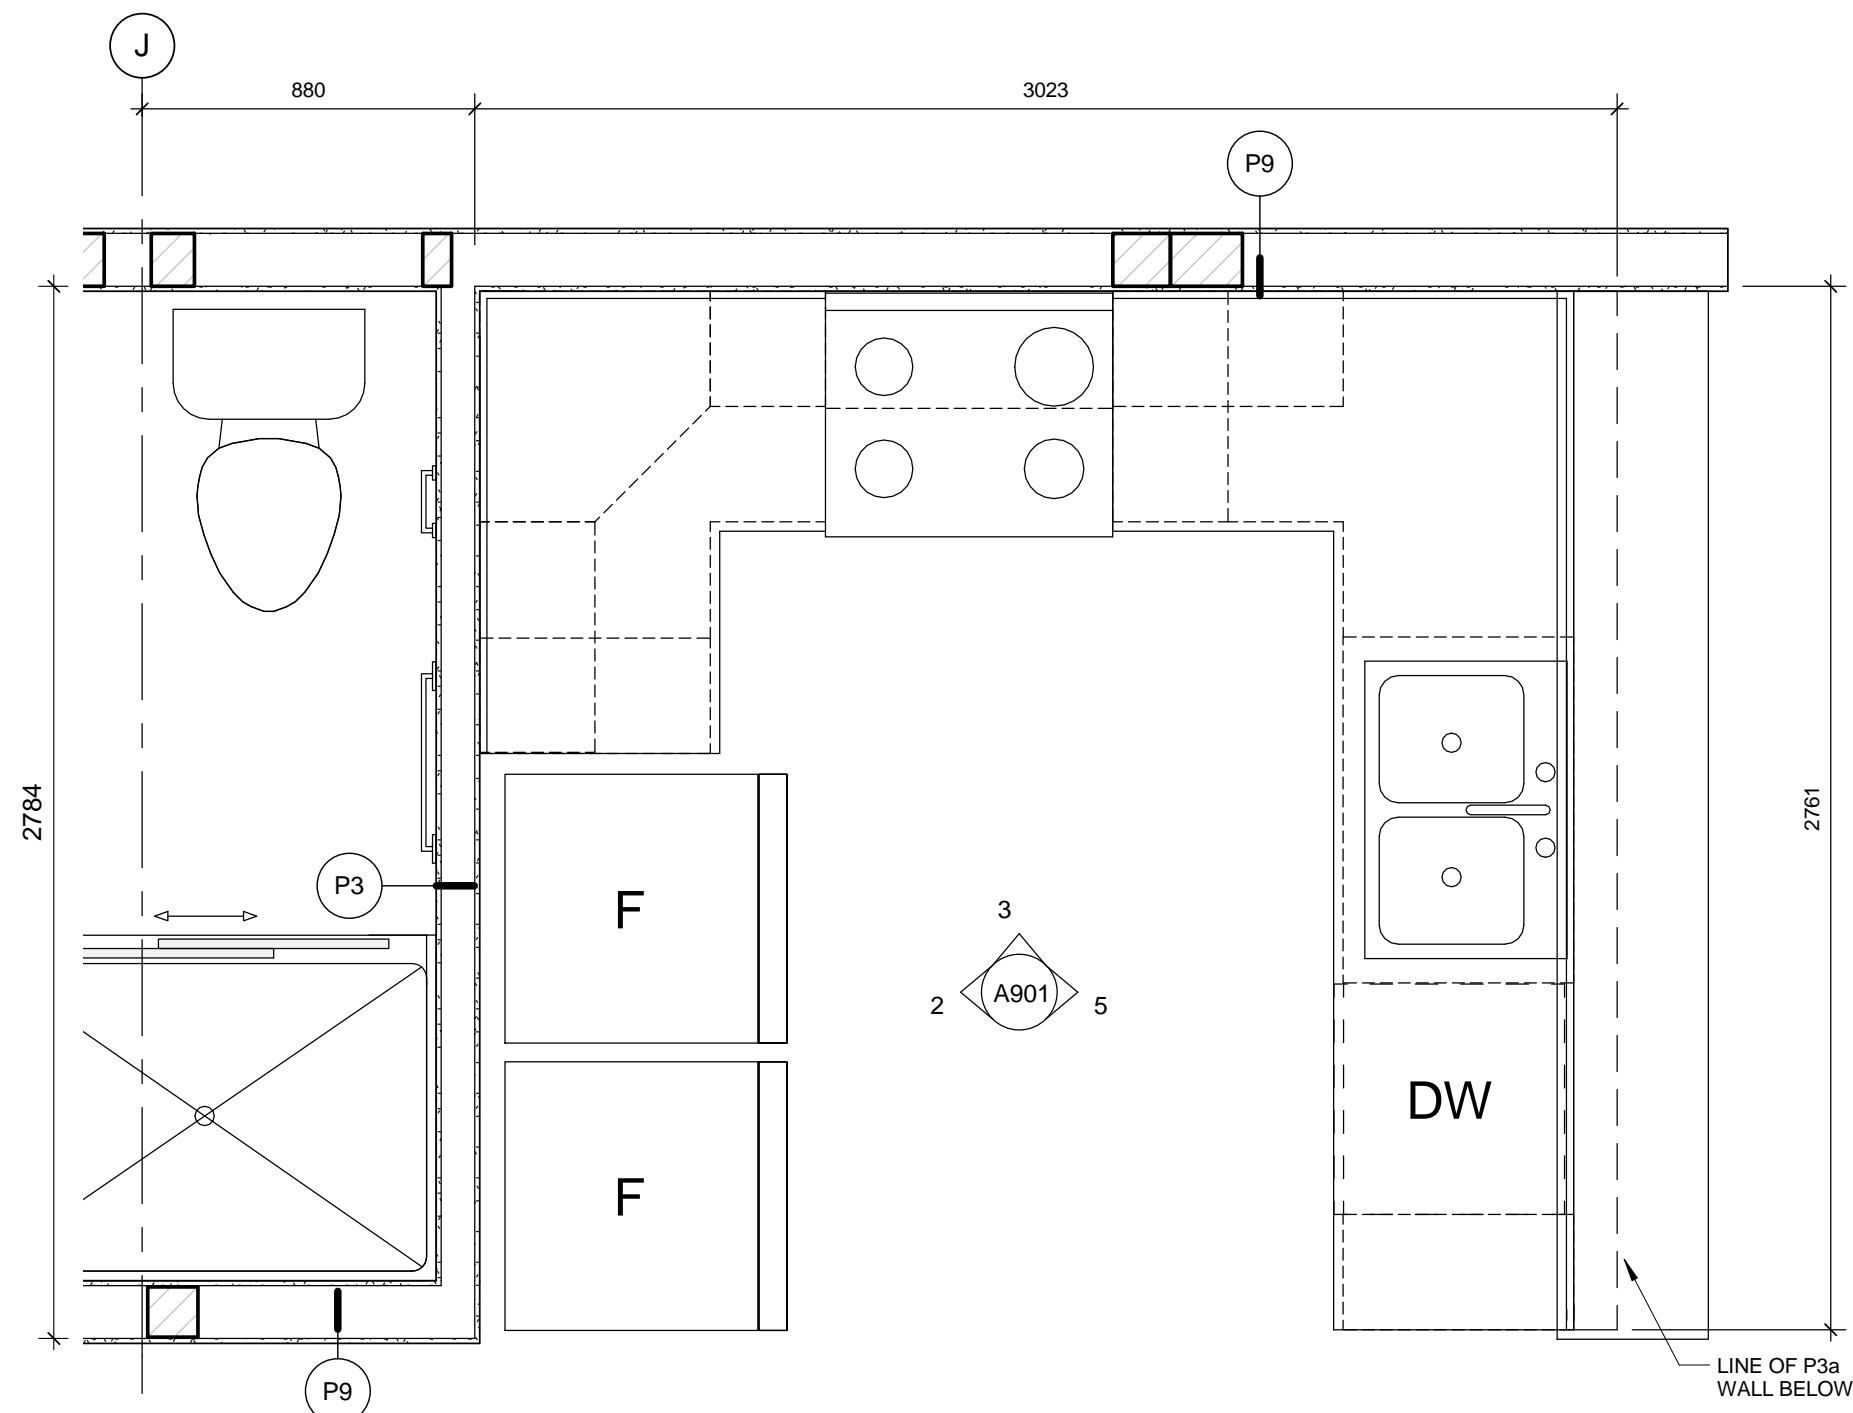


3 Typical Kitchen 1 Elevation 2
A901 Scale: 1 : 20

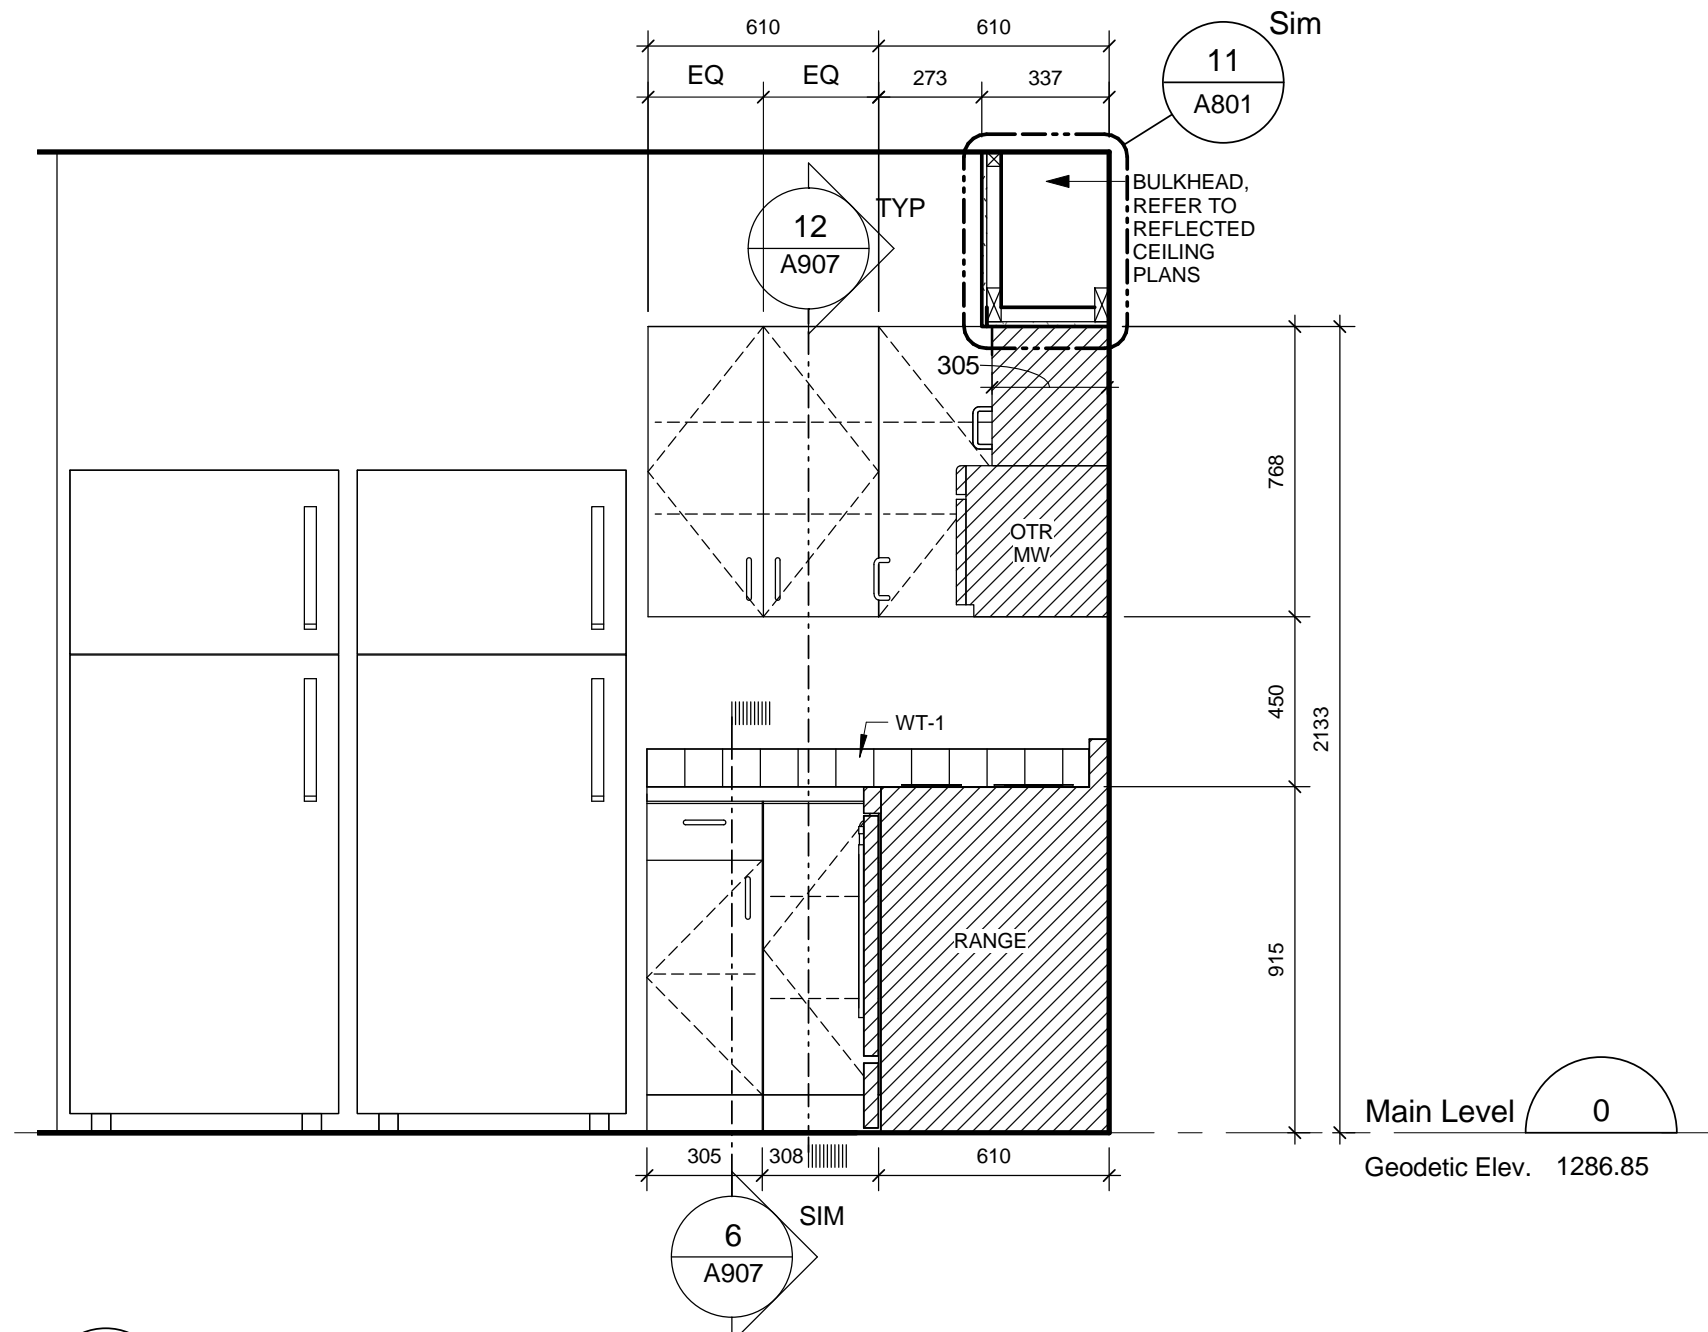


4 Typical enlarged Plan - Kitchen 2
A901 Scale: 1 : 20

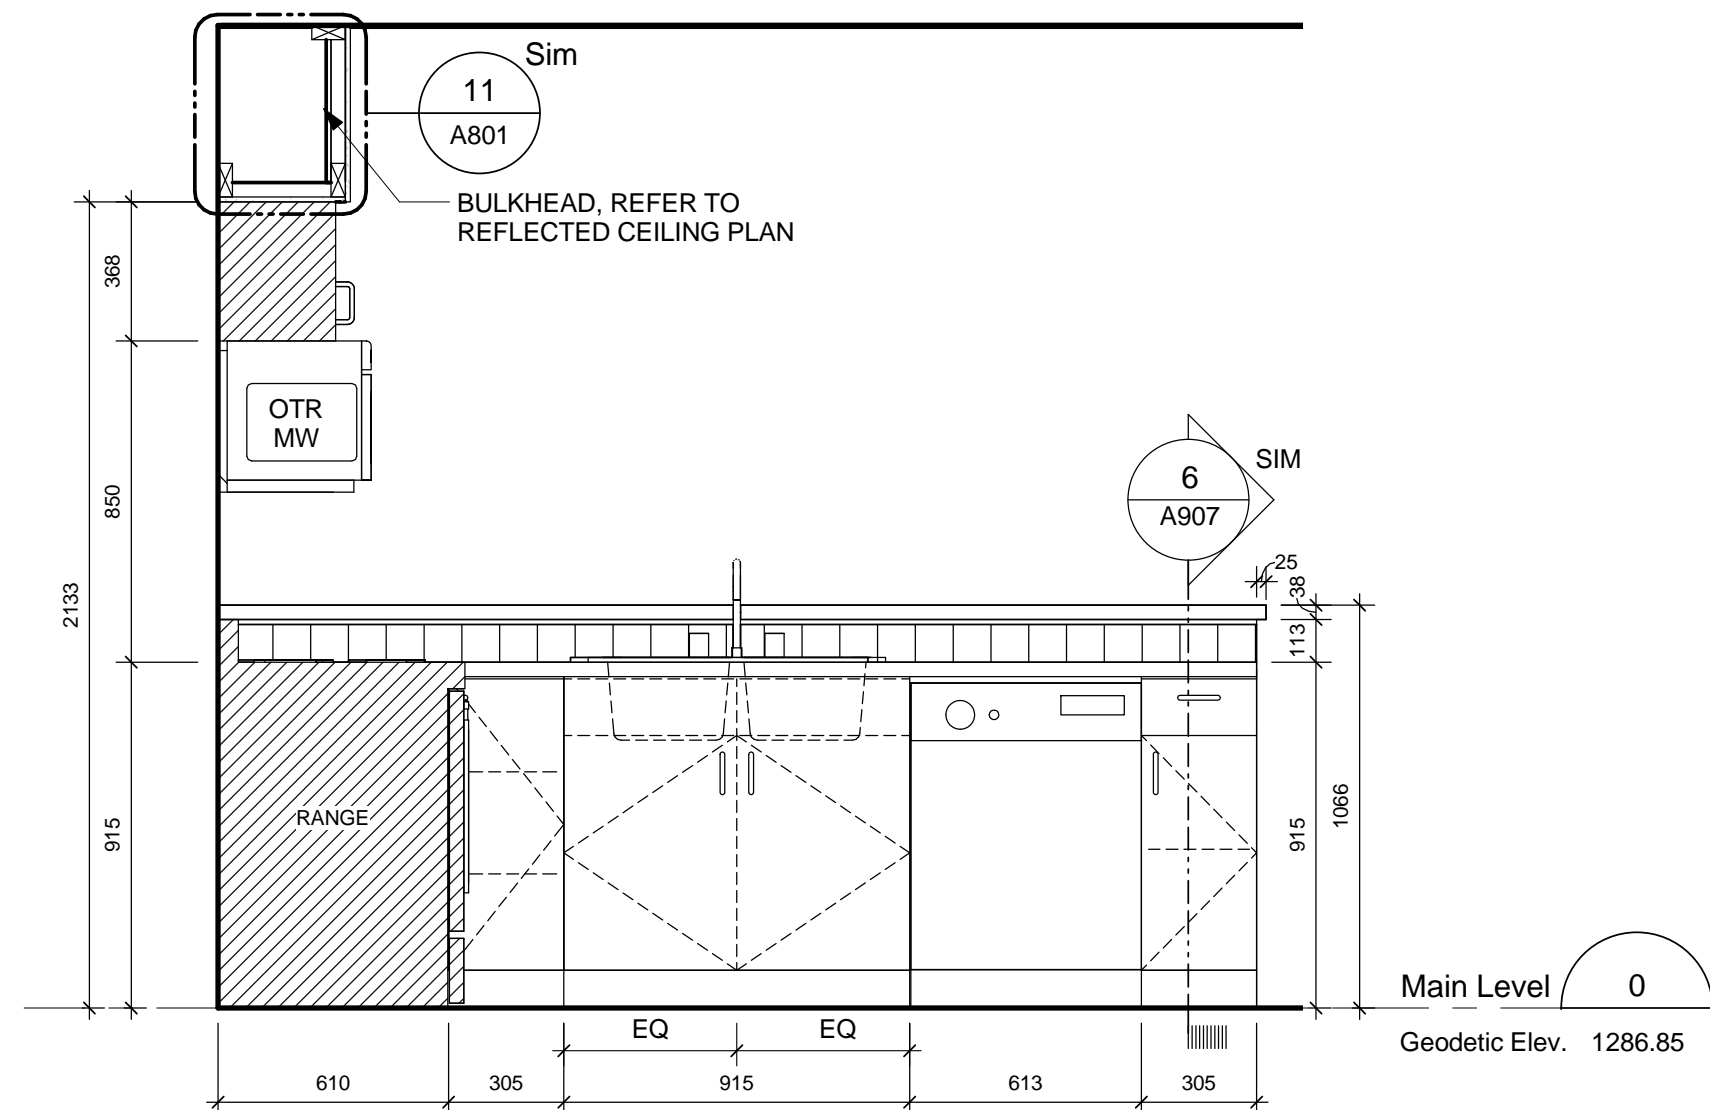


5 Kitchen 1 Elevation 3
A901 Scale: 1 : 20

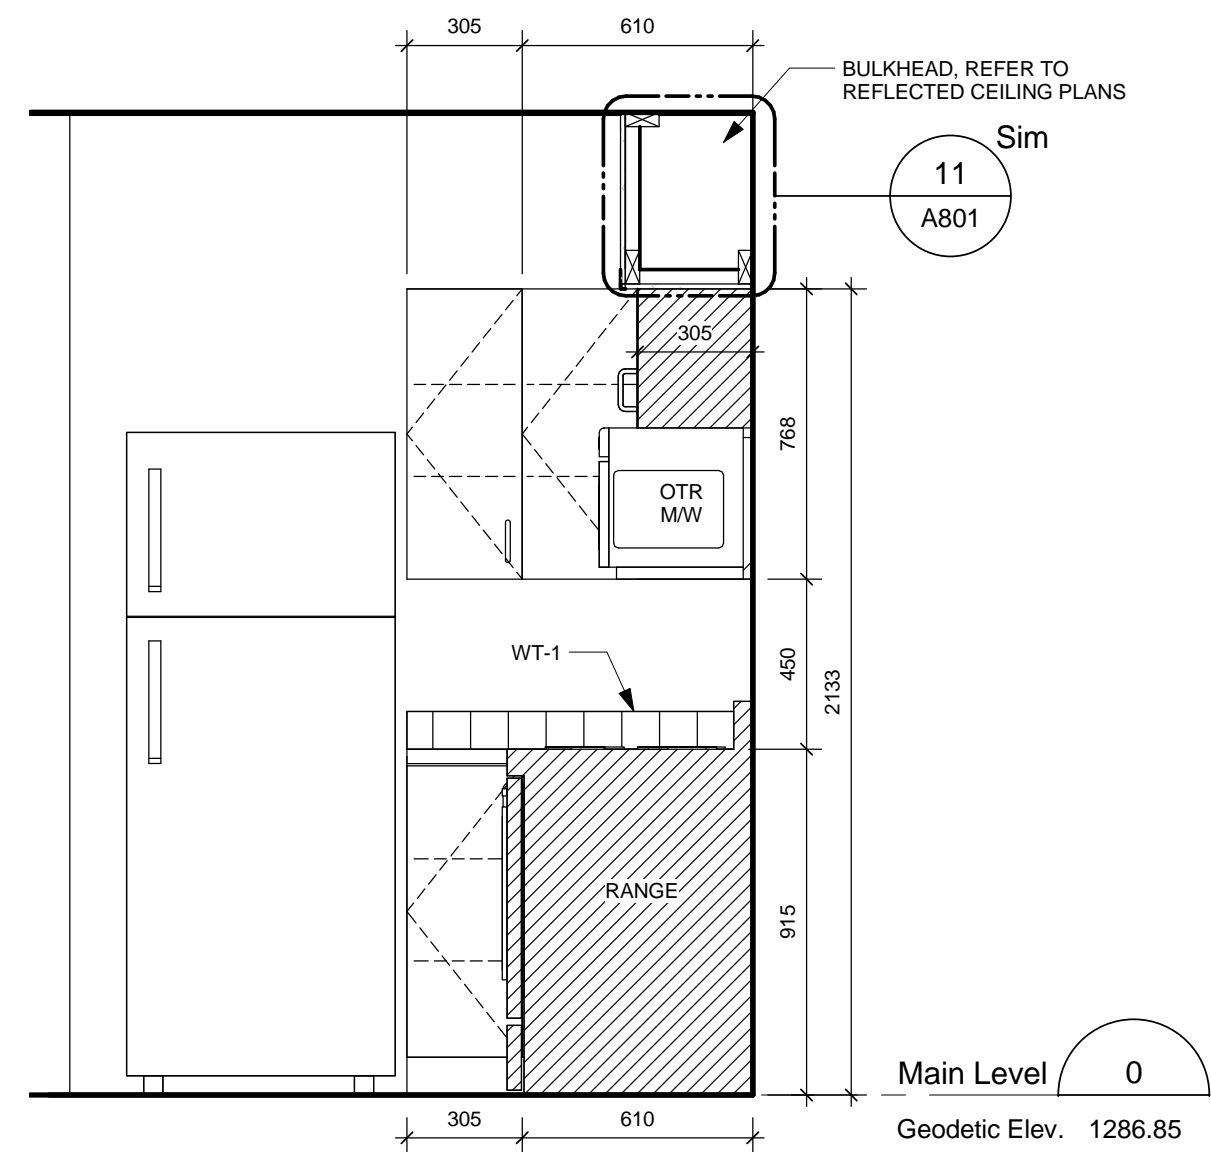


6 Kitchen 2 Elevation 1
A901 Scale: 1 : 20

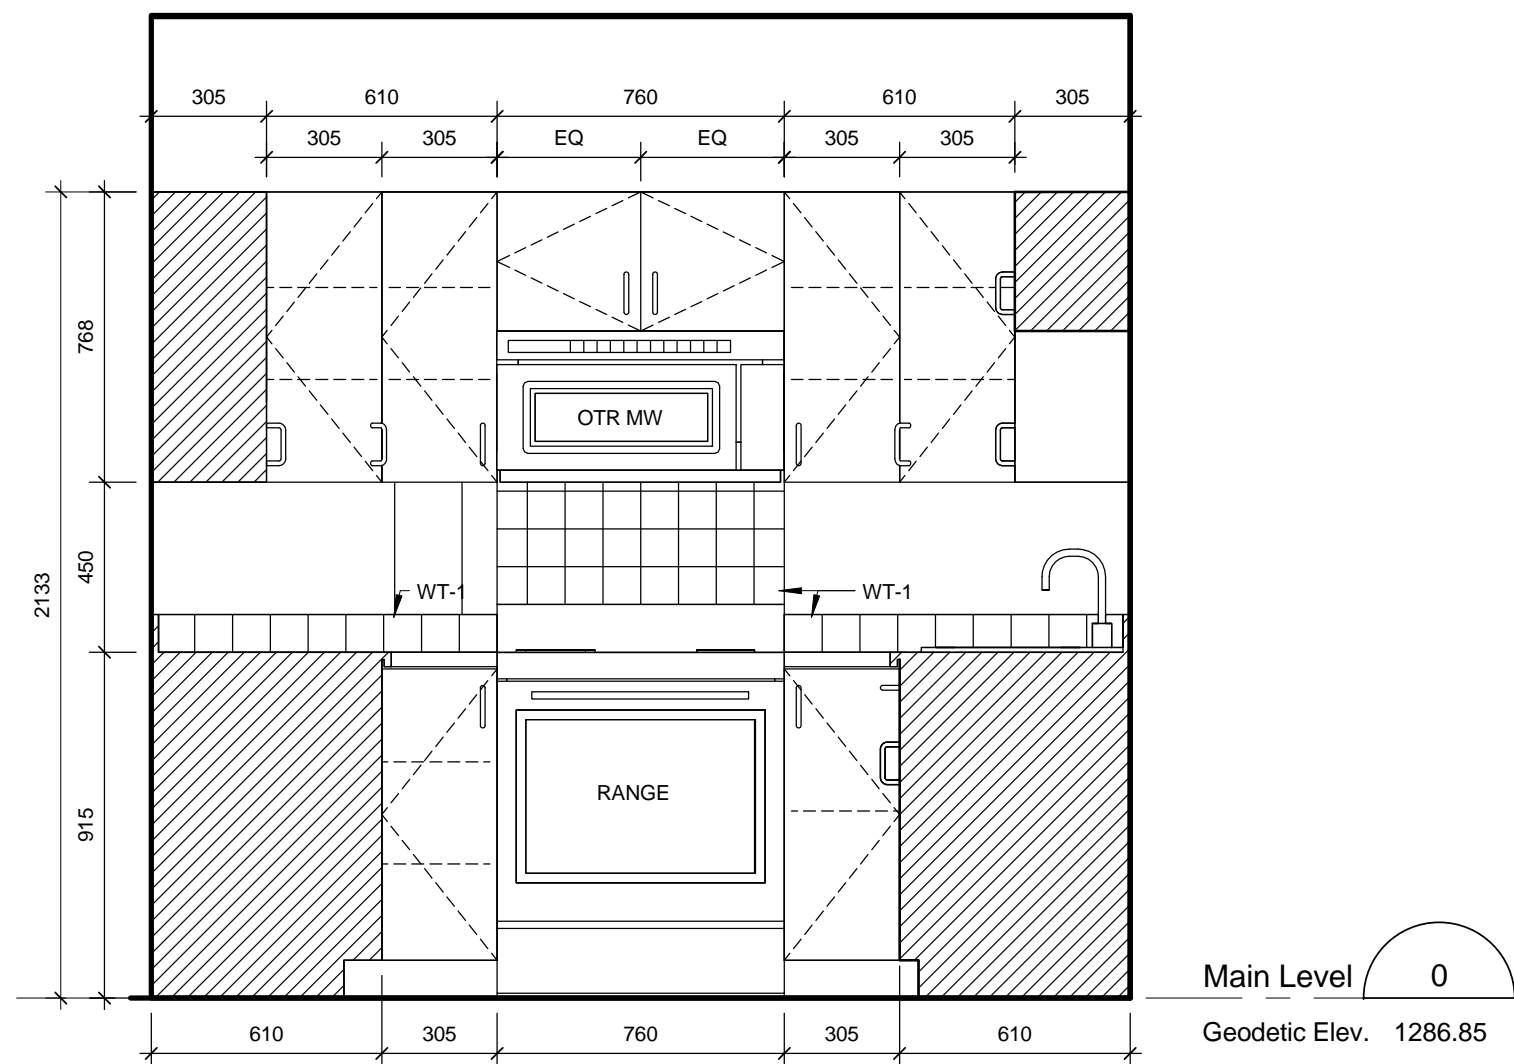

7 Kitchen 2 Elevation 2
A901 Scale: 1 : 20

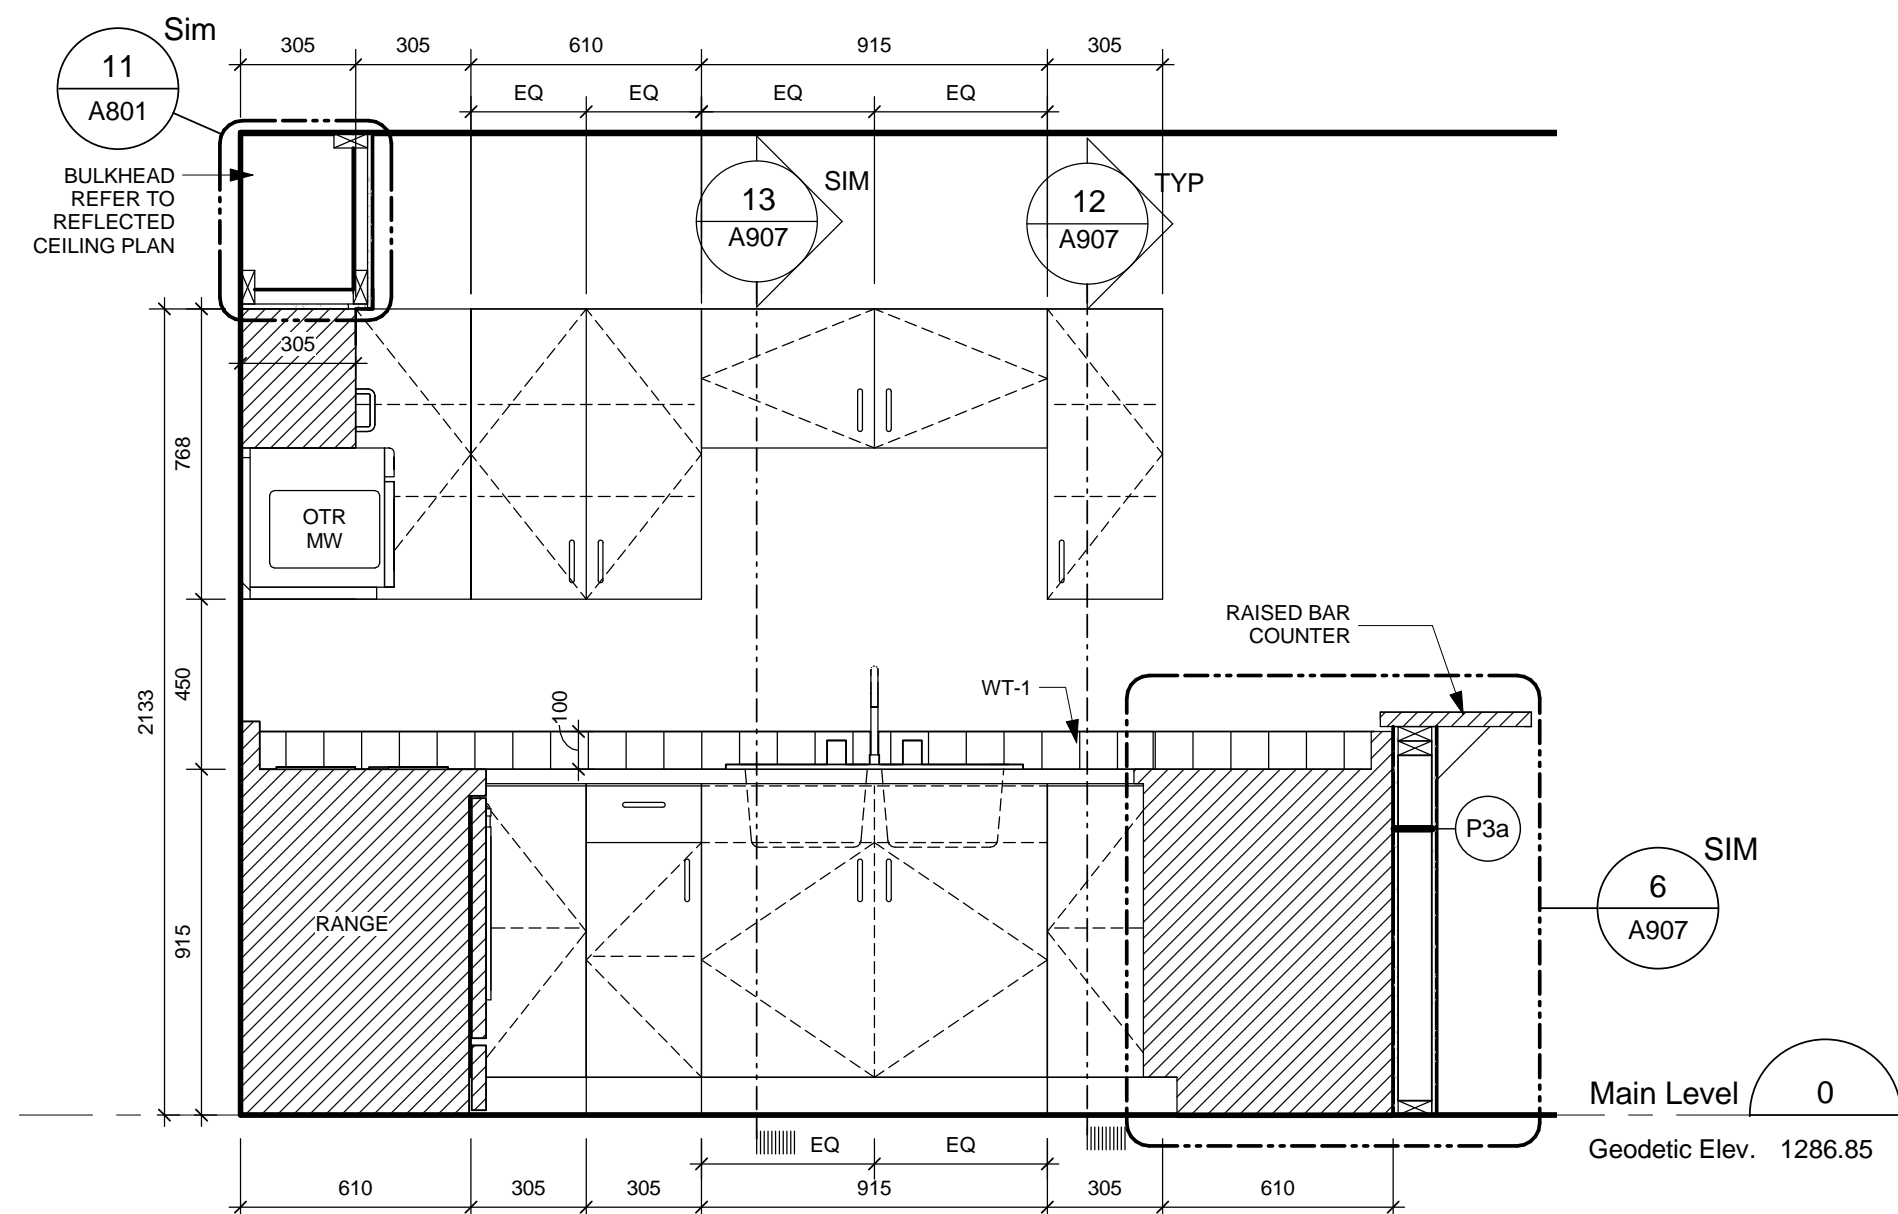

8 Kitchen 2 Elevation 3
A901 Scale: 1 : 20

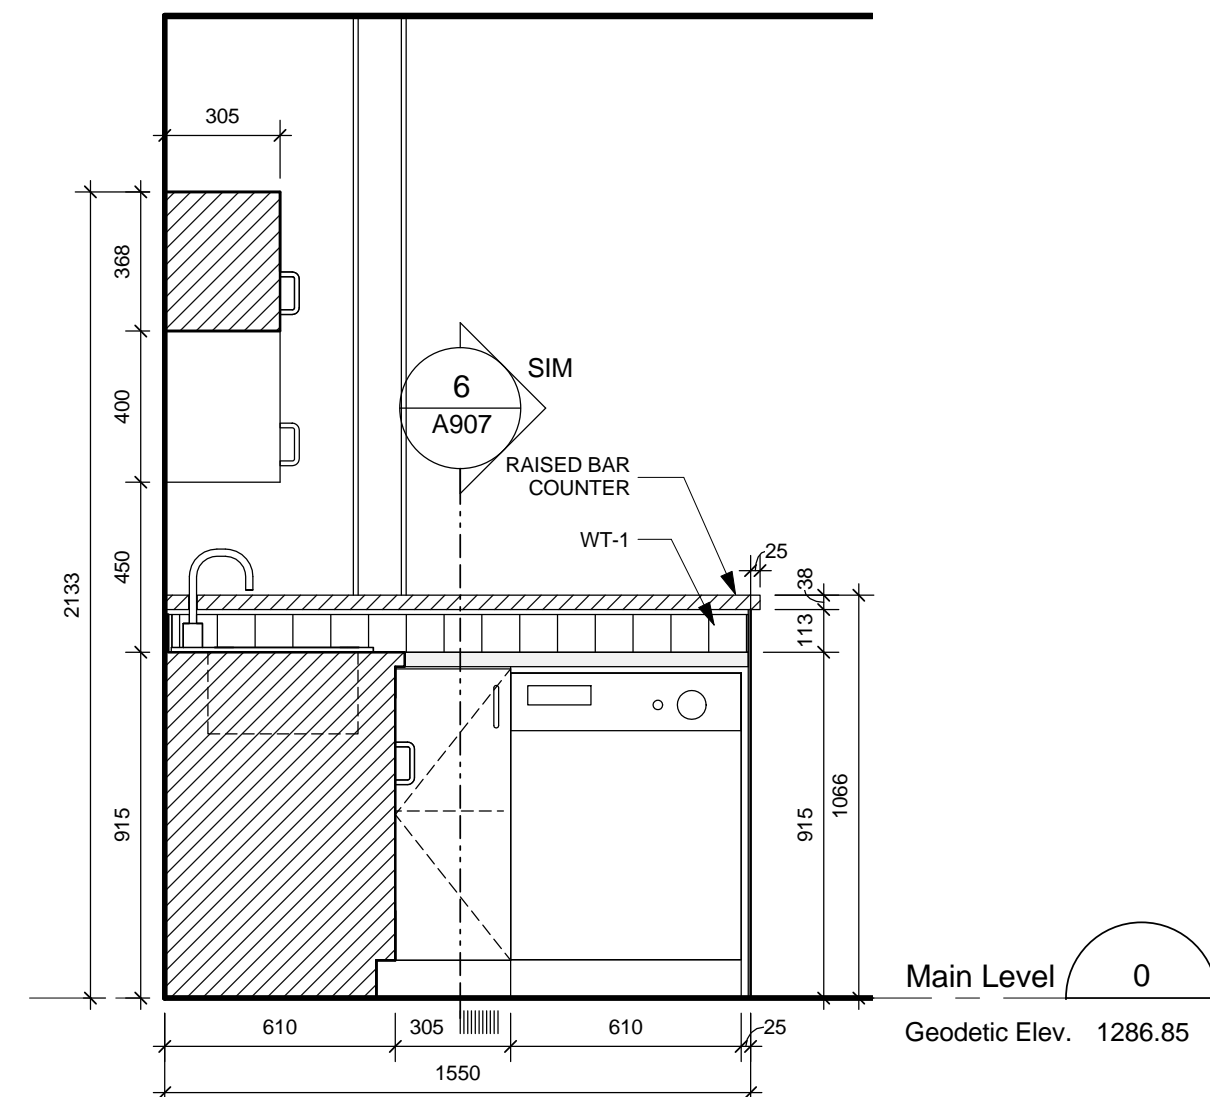

9 Kitchen 2 Elevation 4
A901 Scale: 1 : 20

INTERIOR ELEVATION NOTES:

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No.	Date/Date	Description/Description	Drawn by Dessiné par	Approved Approuvé
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Revision / Revision	
A	detail number numéro de détail
B	source drawing no. de dessin no.
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Consultant's Name Nom de l'expert-conseil	Eng. Stamp Sceau de l'ingénieur
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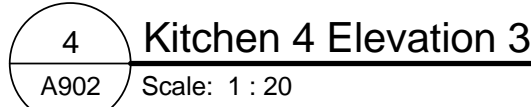
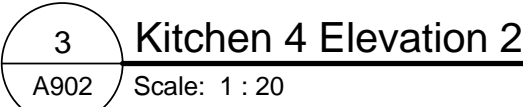
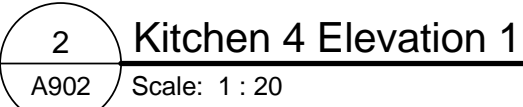
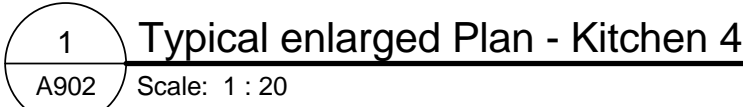
Public Works and Government Services Canada	Travaux publics et Services gouvernementaux Canada
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Canada	
Client/client	Parks Canada Agence
	L'Agence Parcs Canada
	Western and Northern Region
	Ouest et Nord du Canada

Project title/Titre du projet
Staff Housing Phase 2 Waterton Lakes National Park




Drawing title/Titre du dessin
KITCHEN PLANS & ELEVATIONS

Surveyed by/Arpenté par LS/FVR	Drawn by/Dessiné par AG	Date/Date 2016-12-08
Designed by/Concept par LS/FVR	Reviewed by/Revisé par LS/FVR	Scale/Echelle 1:20
FWGSC Project Manager/Administrateur de Projets TPSCG Randy Boldt		
Client Acceptance/Acceptation du client		Approved by/Approuvé par
Project No./No. du projet 39000		Asset No./No. du bien Fil # 945
Drawing Reference No./No. de référence du dessin		Sheet No./ No. de la feuille A901



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<p>Consultant's Name Nom de l'expert-consult</p>		<p>Eng. Stamp Sceau de l'ingenieur</p>
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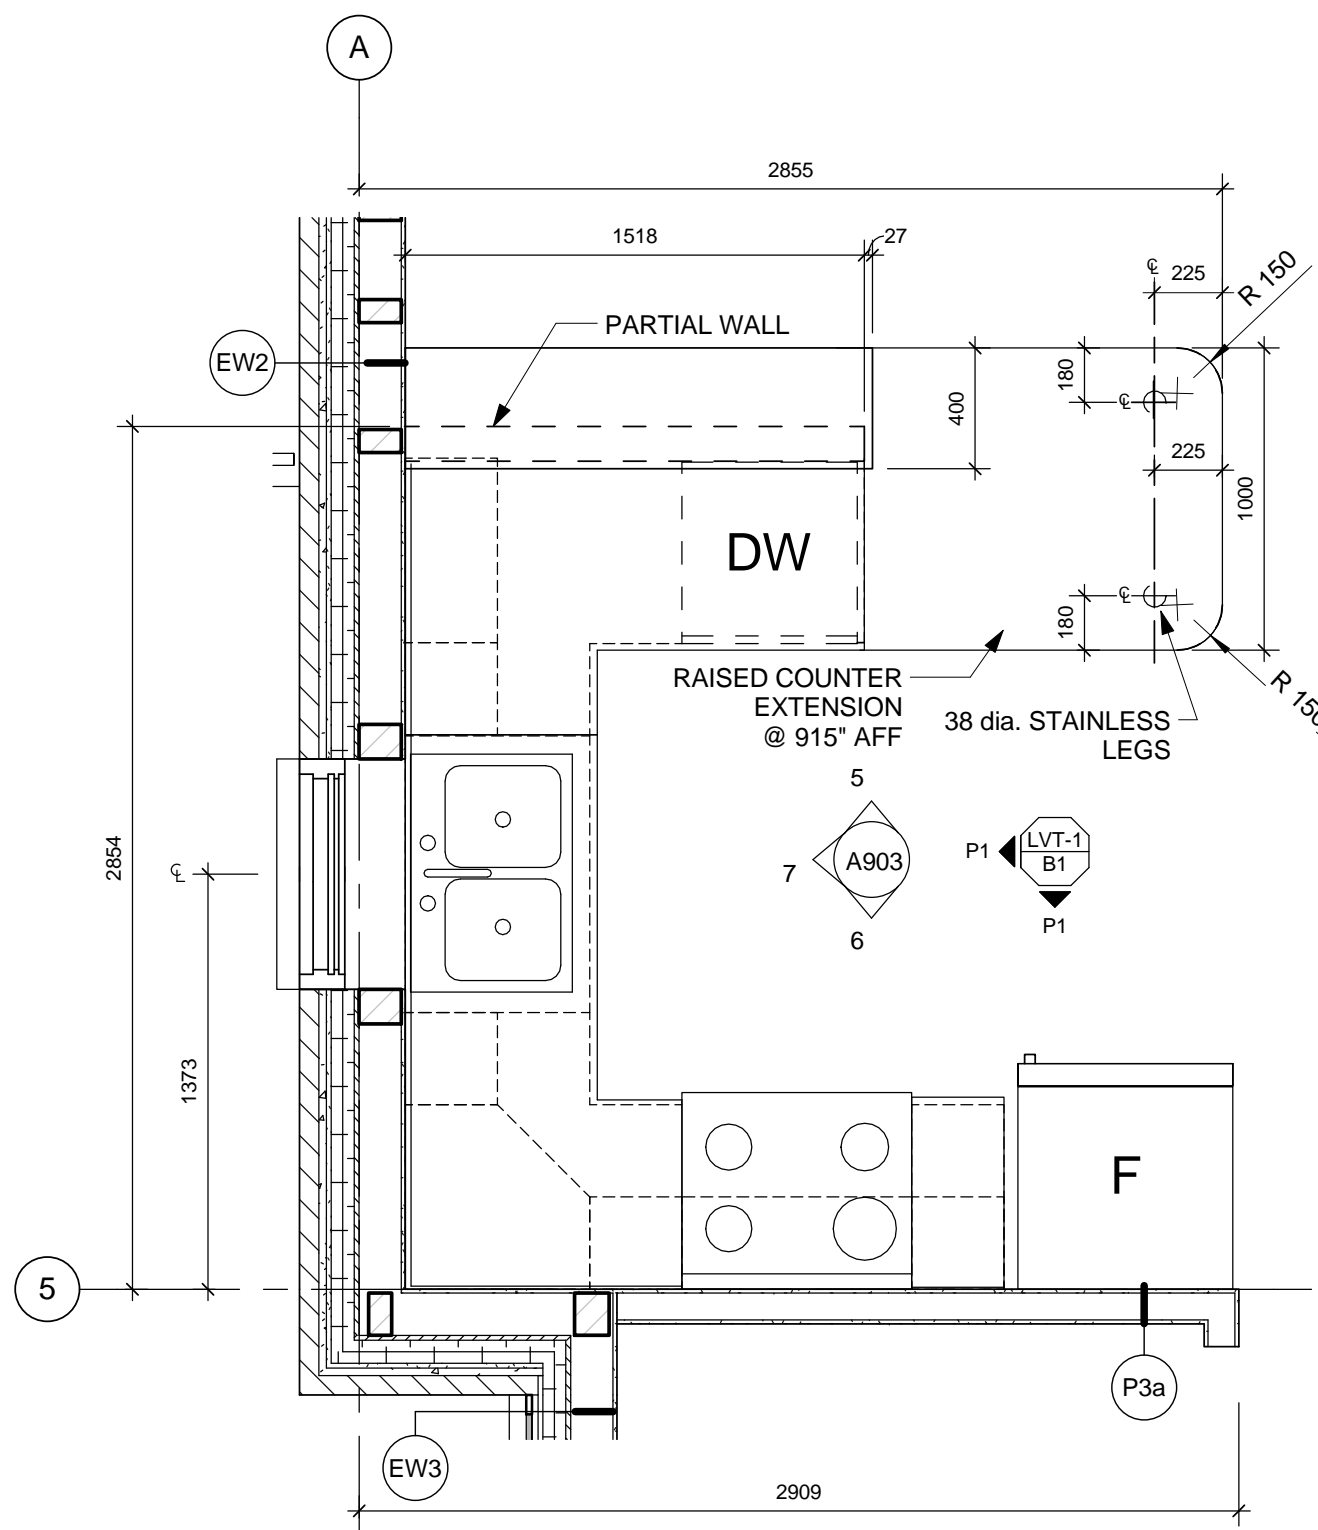
Staff Housing Phase 2 Waterton Lakes National Park

Drawing title/Titre du dessin

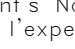
**KITCHEN PLANS &
ELEVATIONS**

Surveyed by/Arpenté par	Drawn by/Dessiné par	Date/Date
AG	AG	2016-12-08
Designed by/Concept par	Reviewed by/Revisé par	Scale/Echelle
LS/FV/R	LS/FV/R	1:20
PWGSC Project Manager/Administrateur de Projets TPSSG		
Randy Boldt		
Client Acceptance/Acceptation du client		Approved by/Approuvé par
Risk Responsible (Project)/Risque Responsable		PWGSC Project Manager/Administrateur de Projets TPSSG
Project No./No. du projet	Asset No./No. du bien	Sheet No./ No. de la feuille
39000	Fill # 945	
Drawing Reference No./No. de référence du dessin		A902


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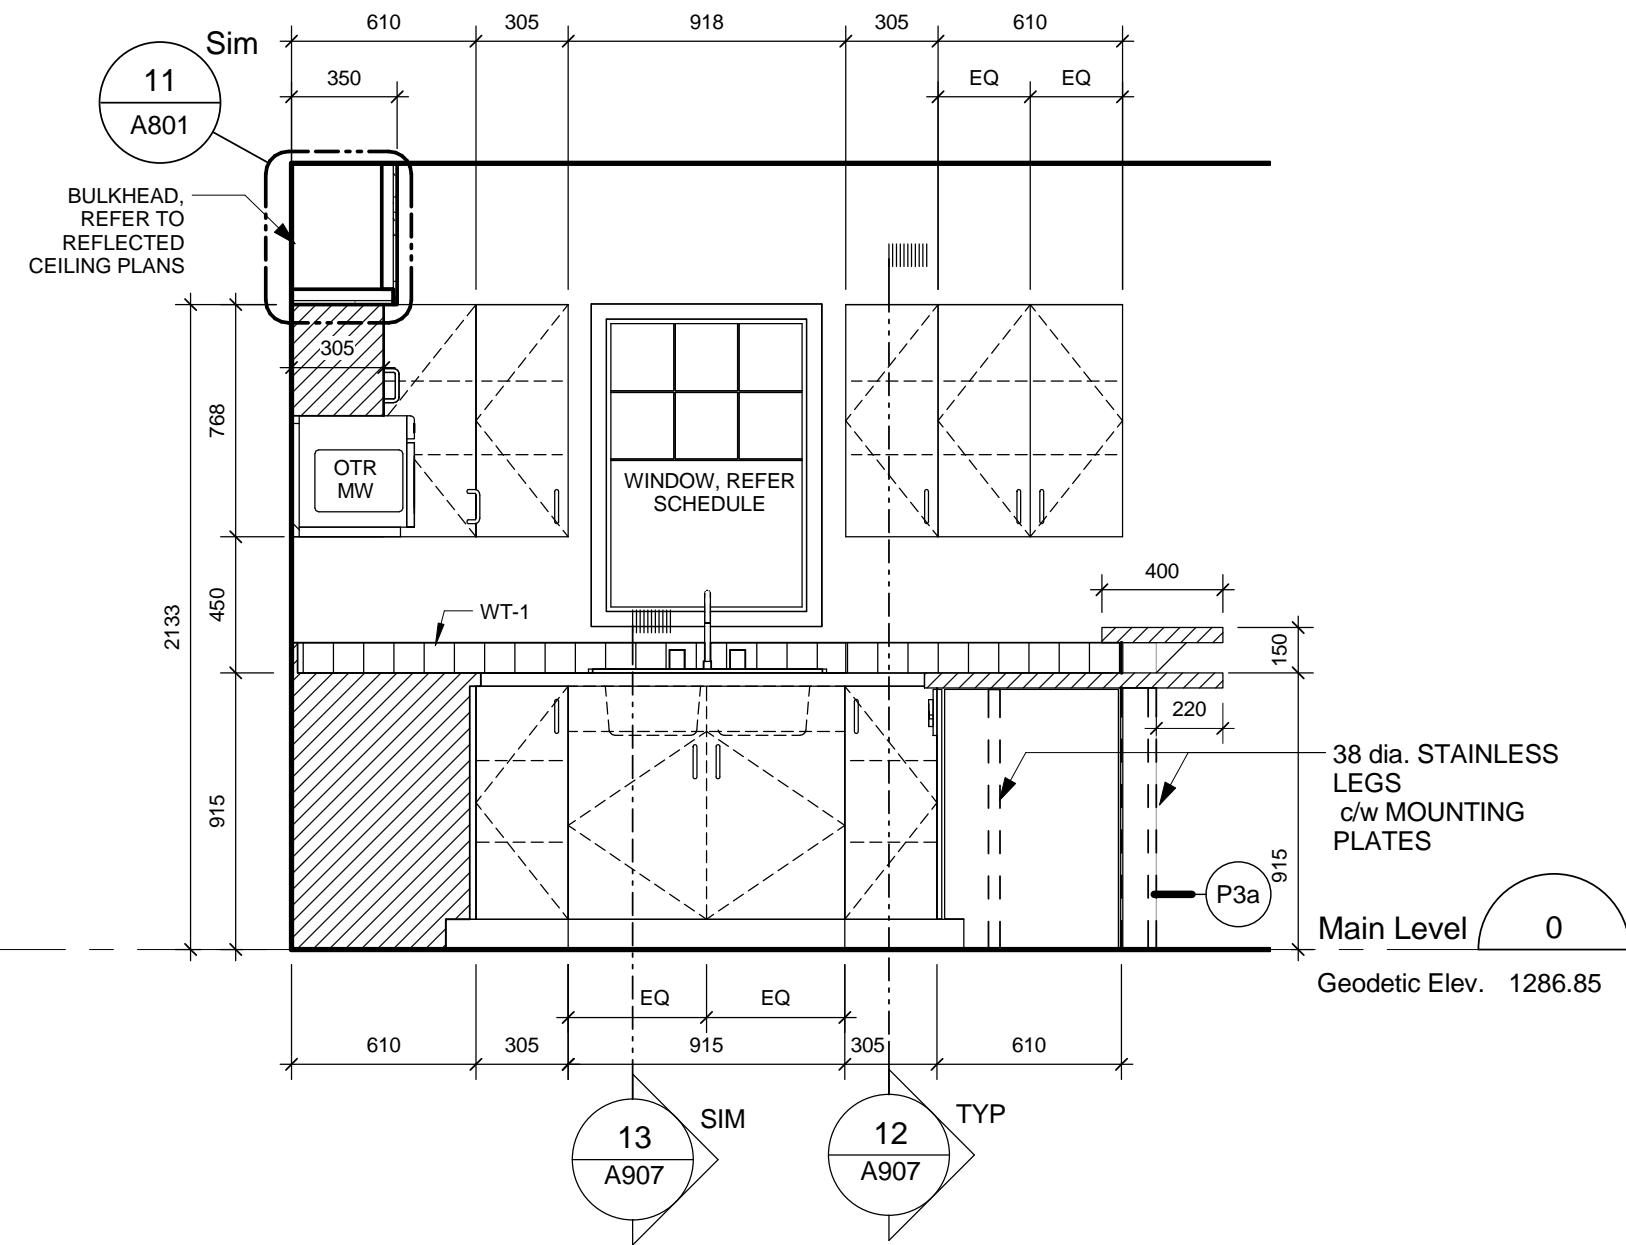
1 Typical enlarged Plan - Kitchen 3 - Unit A
A903 / Scale: 1 : 25




5 Suite A - Kitchen 3 Elevation 1
A903 / Scale: 1 : 25

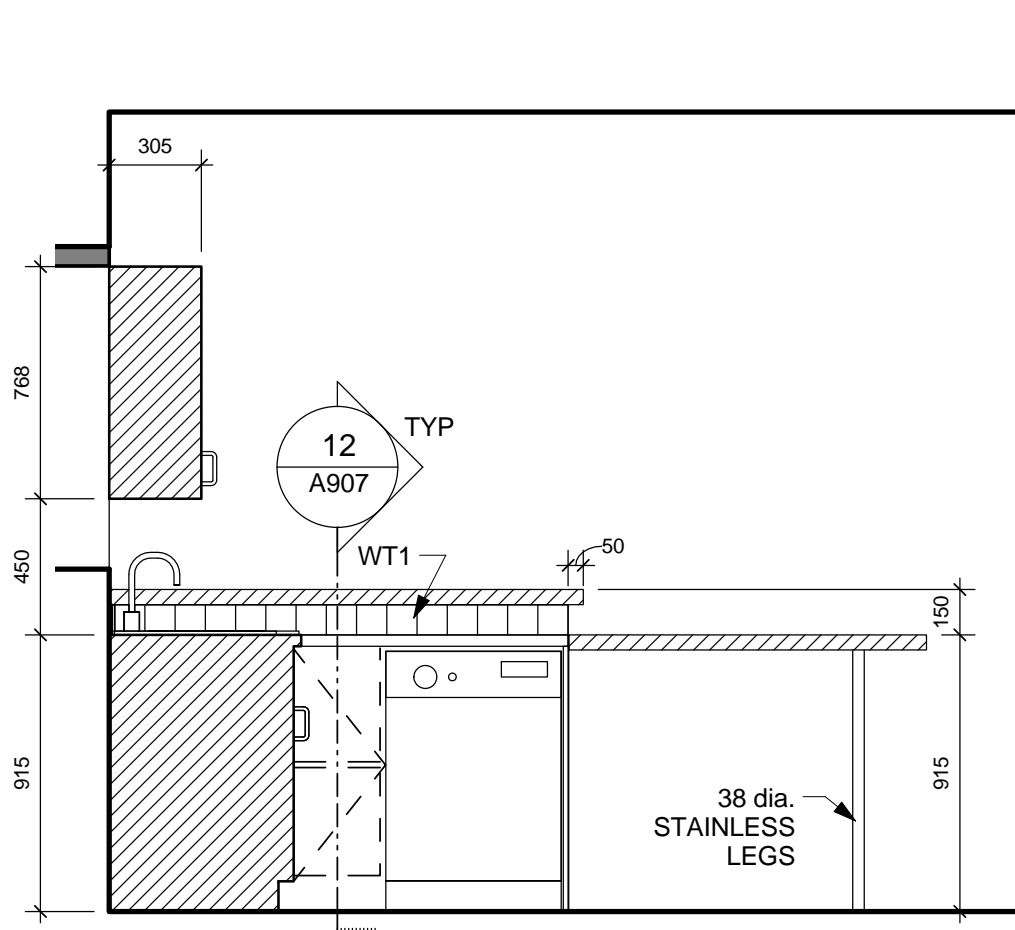


6 Suite A - Kitchen 3 Elevation 2
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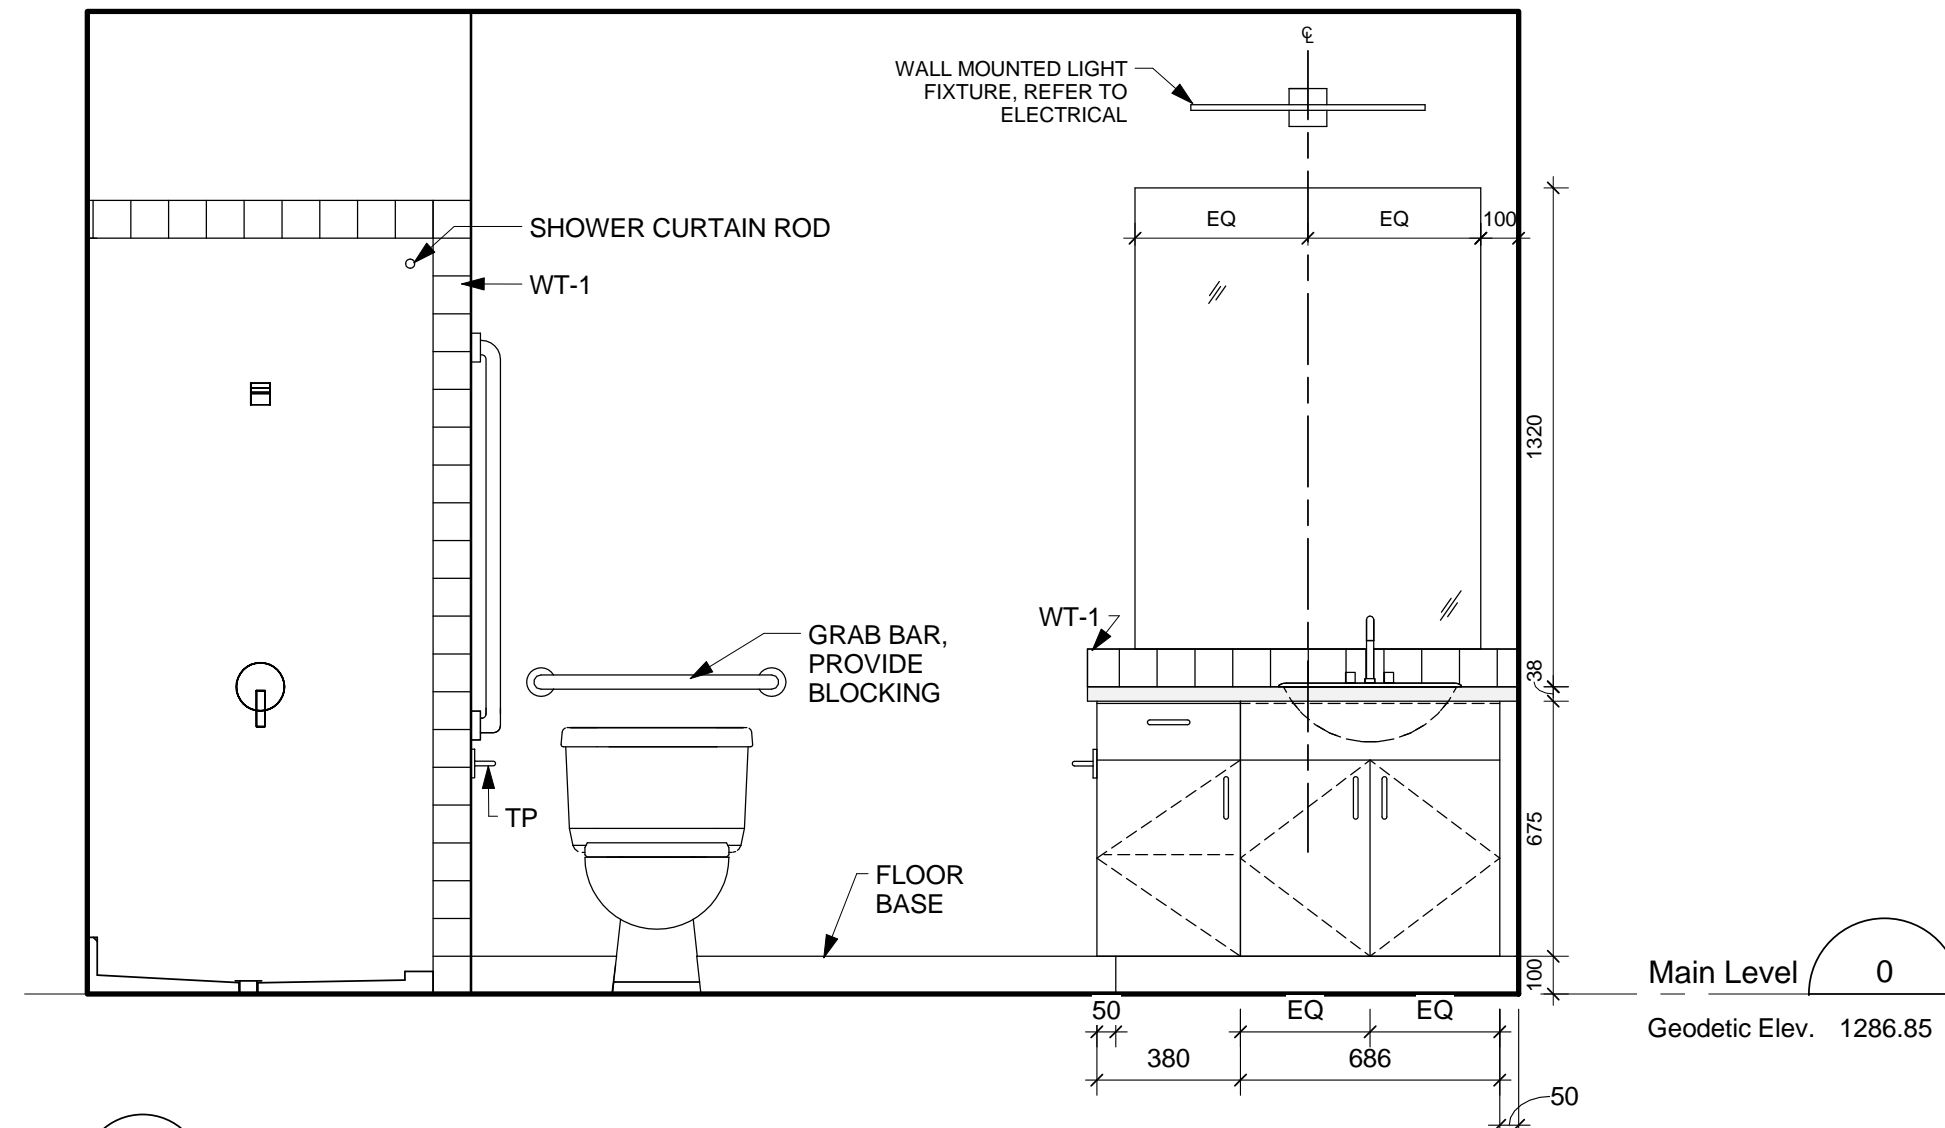
7 Suite A - Kitchen 3 Elevation 3
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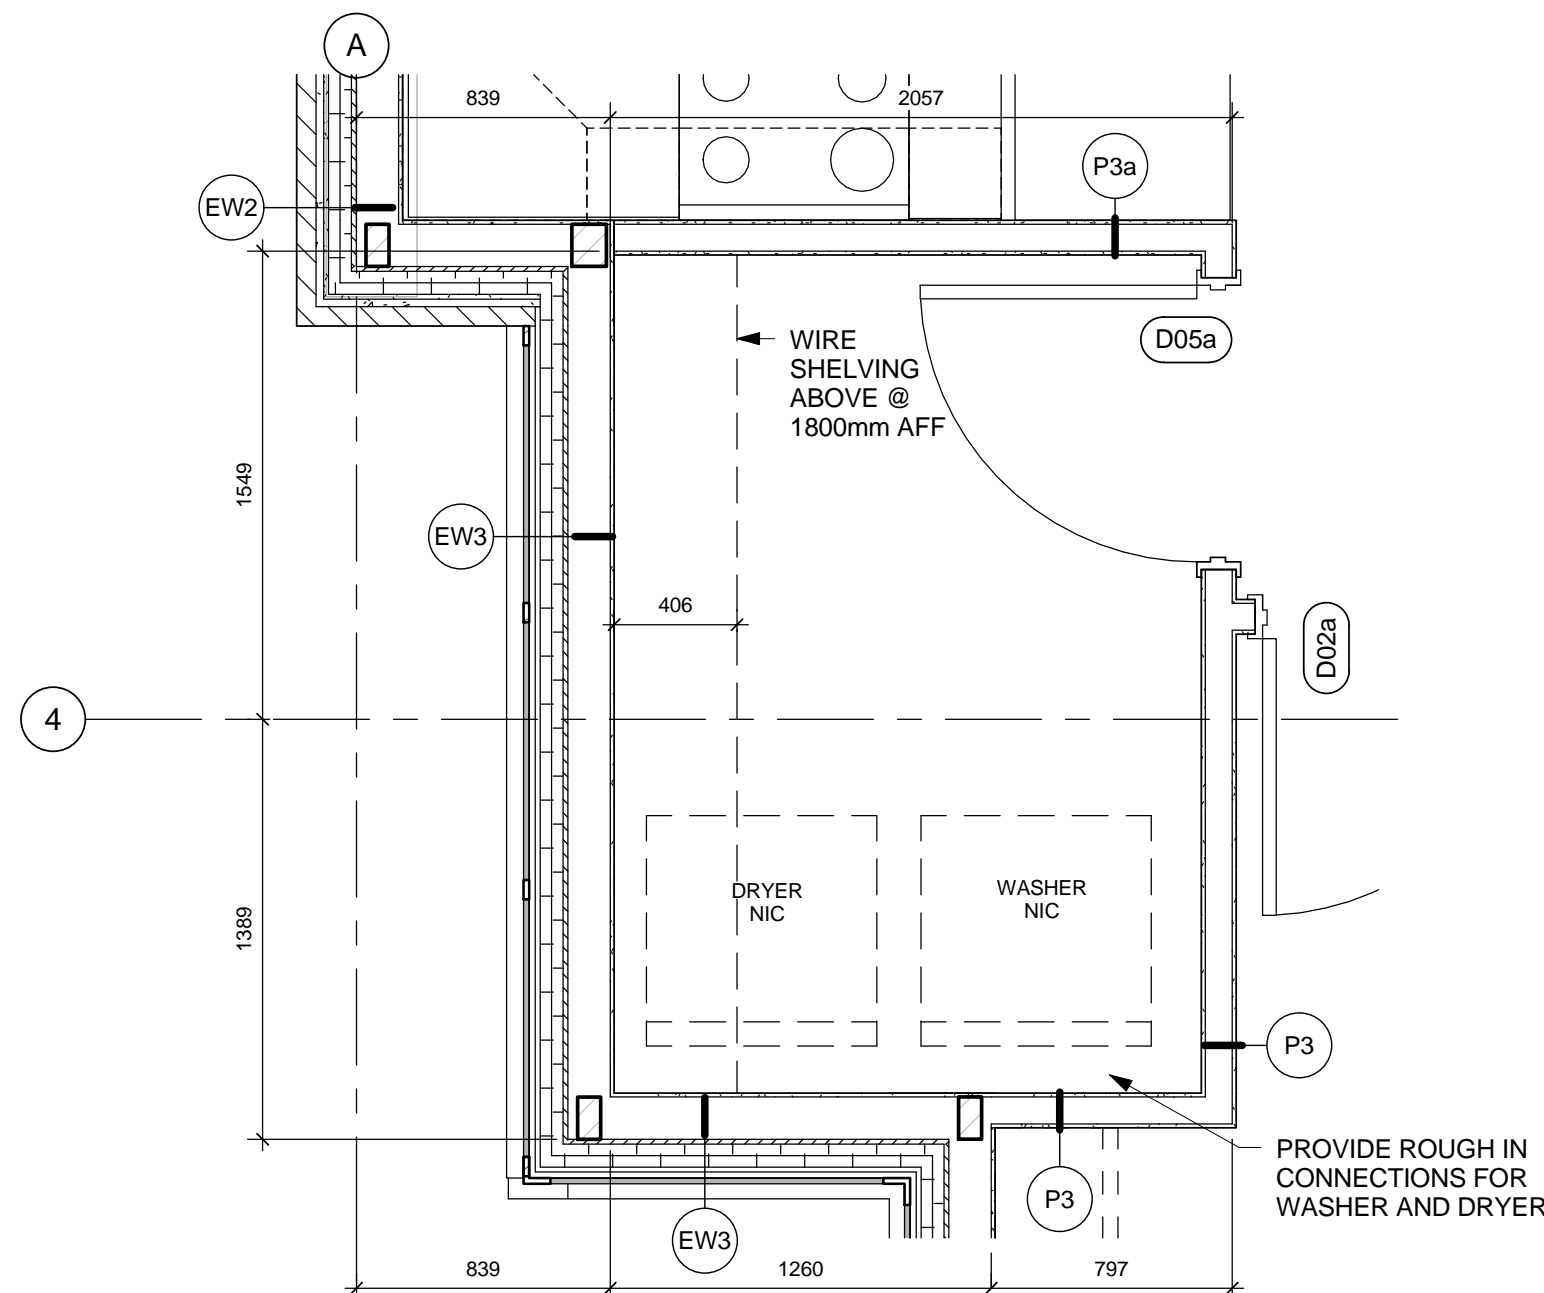
2 Enlarged plan - Bathroom Unit A
A903 / Scale: 1 : 25

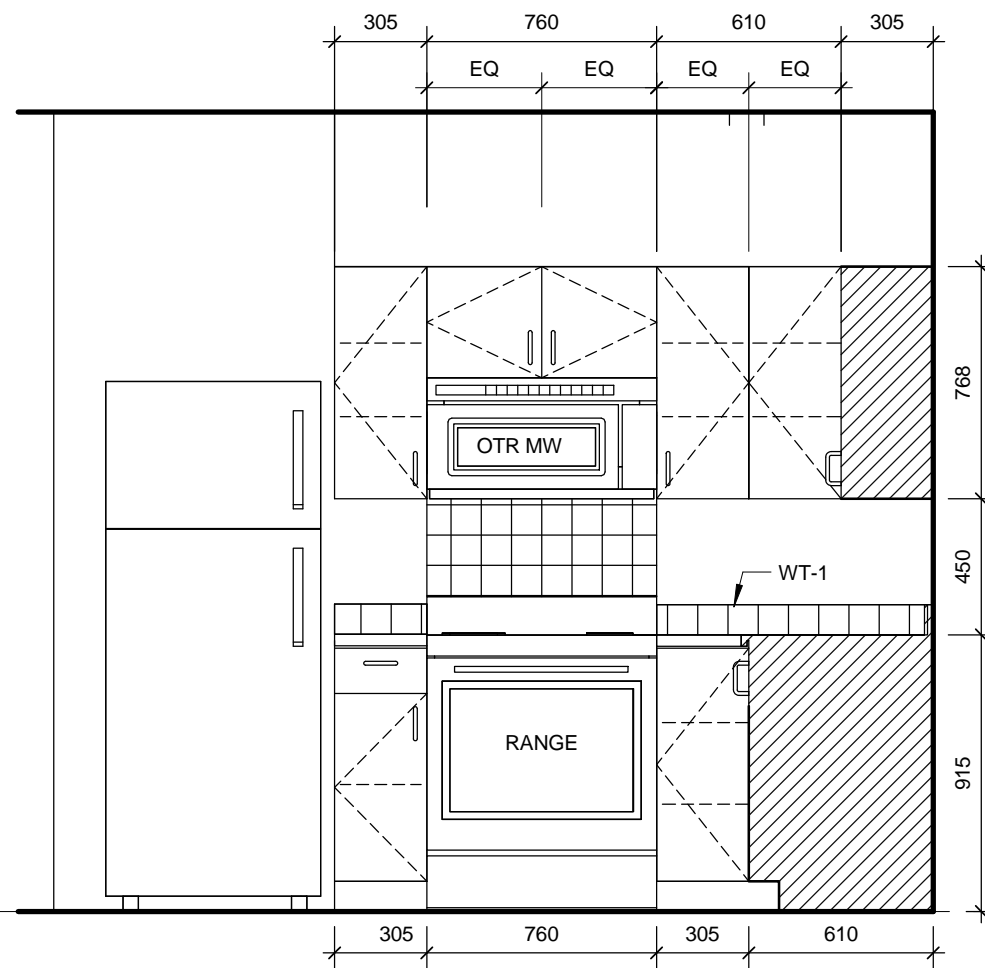

3 Bathroom A Elevation 1
A903 / Scale: 1 : 20

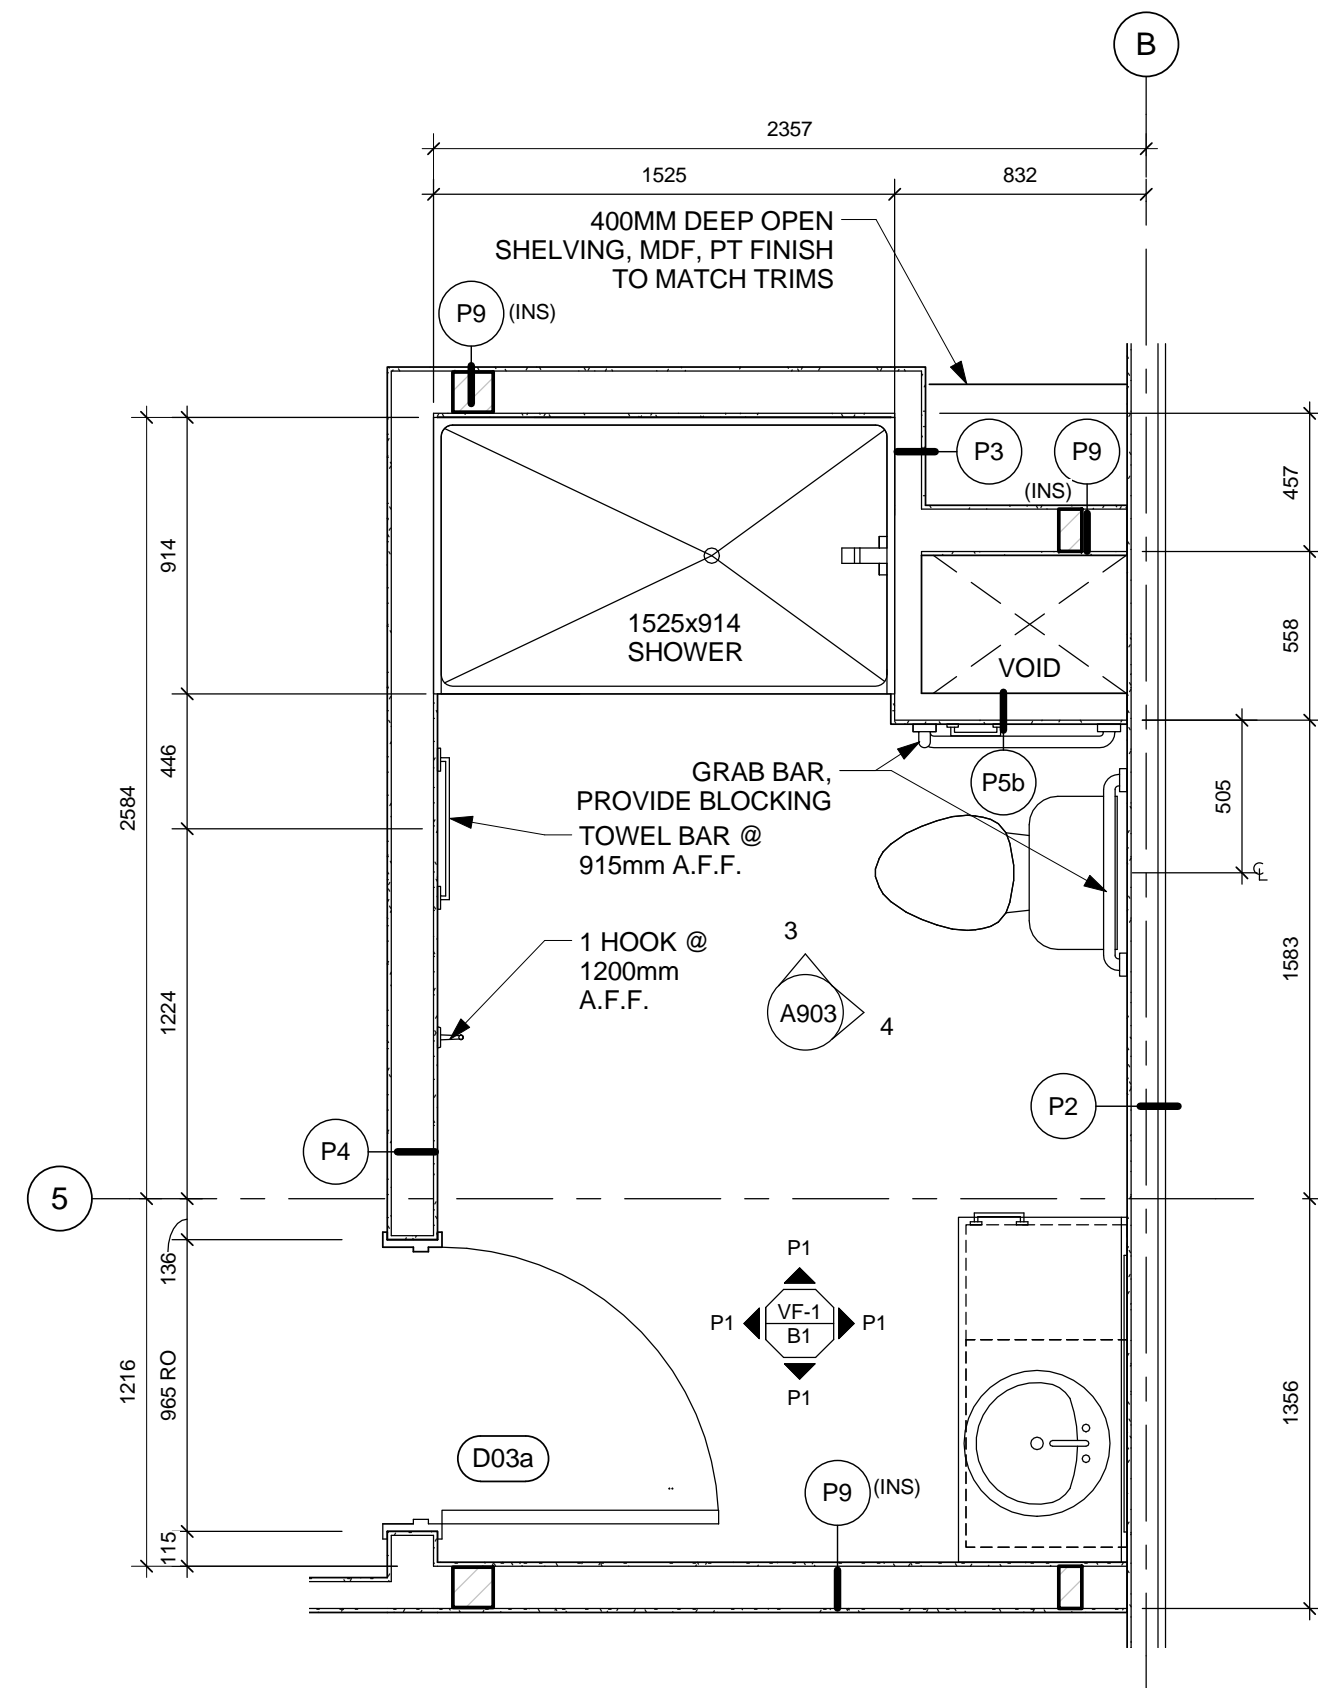

4 Bathroom A Elevation 2
A903 / Scale: 1 : 20

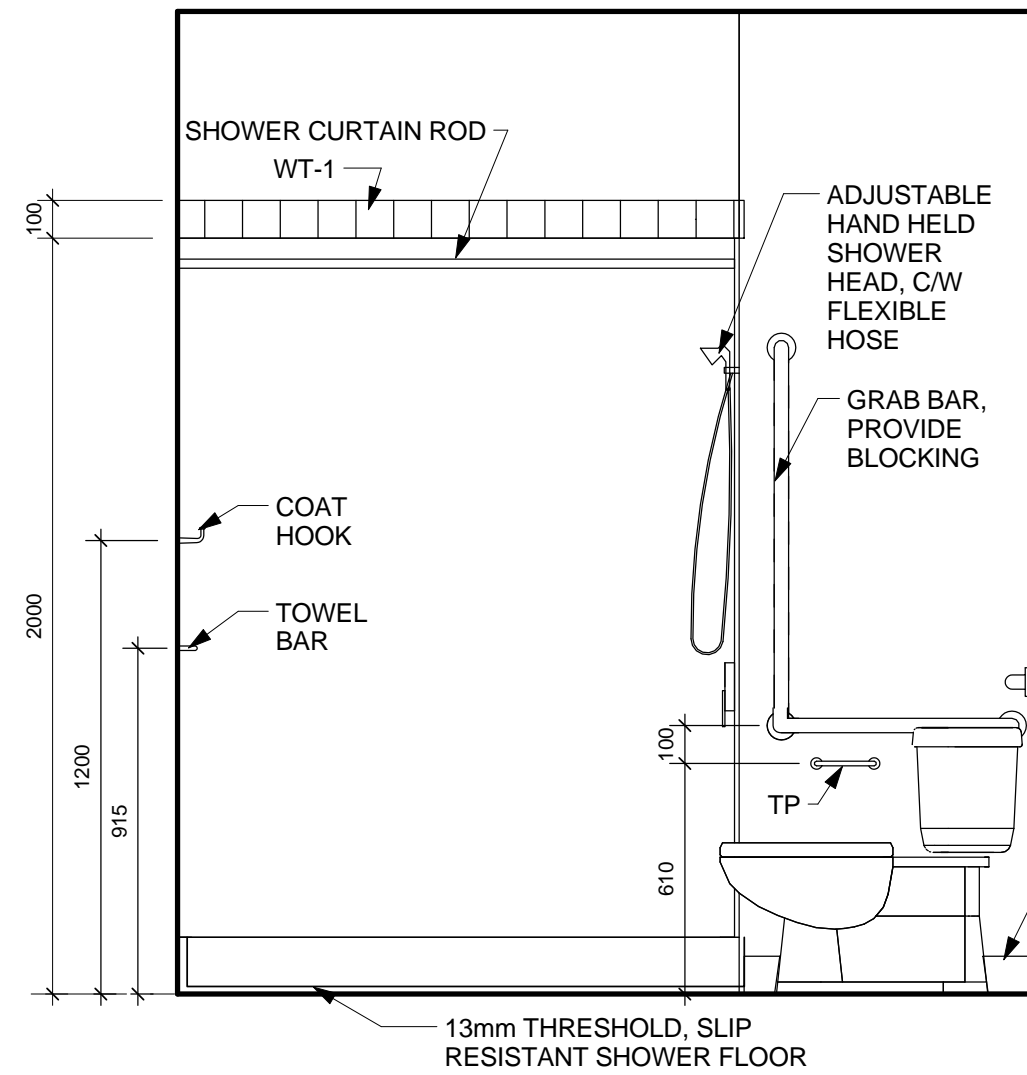

8 Enlarged Plan - Laundry Rm. Unit A
A903 / Scale: 1 : 25

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Revision /	Revision
A	detail number numero de detail
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Staff Housing Phase 2 Waterton Lakes National Park

SUITE A - PLANS & ELEVATIONS


Surveyed by/Arpenté par	Drawn by/Dessiné par	Date/Date
LS/FVR	AG	2016-12-08
Designed by/Concept par	Reviewed by/Revisé par	Scale/Echelle
LS/FVR	LS/FVR	As indicated

FWGSC Project Manager/Administrateur de Projets TPSCG
Randy Boldt


Client Acceptance/Acceptation du client
Approved by/Approuvé par

Project No./No. du projet	Asset No./No. d'actif	Sheet No./ No. de la feuille
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Drawing Reference No./No. de référence du dessin		


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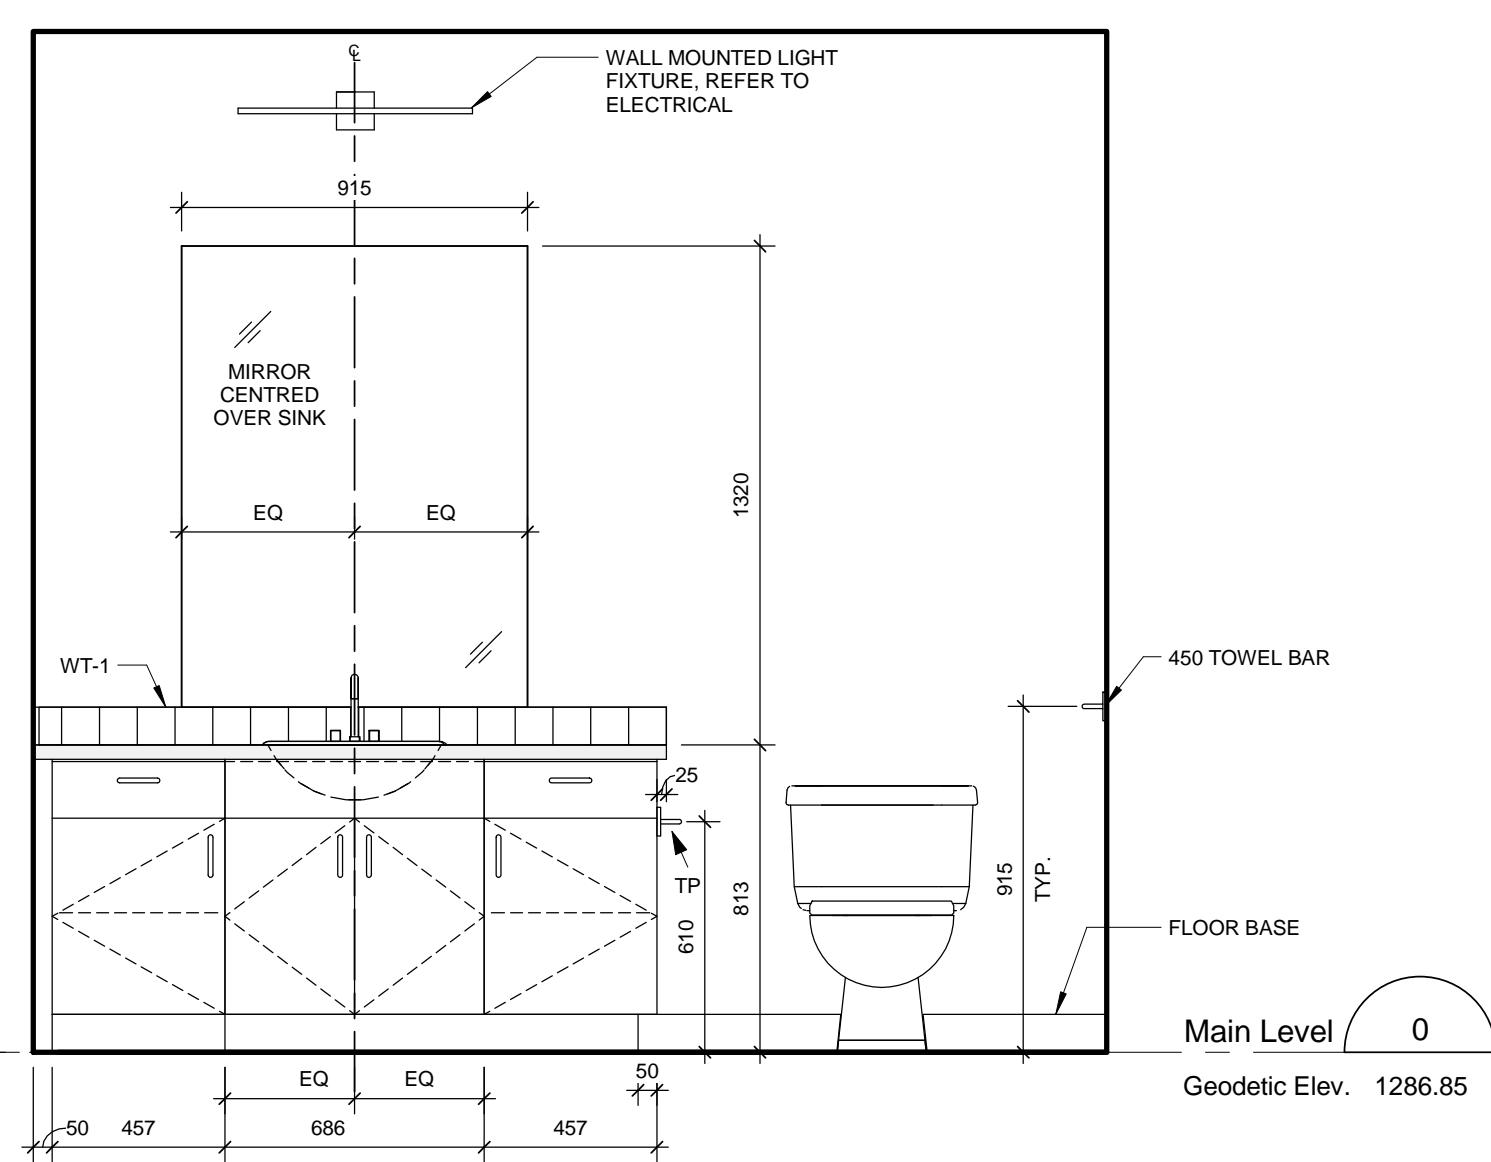
1 Typical enlarged Plan - Bathroom 1
A904 Scale: 1 : 20

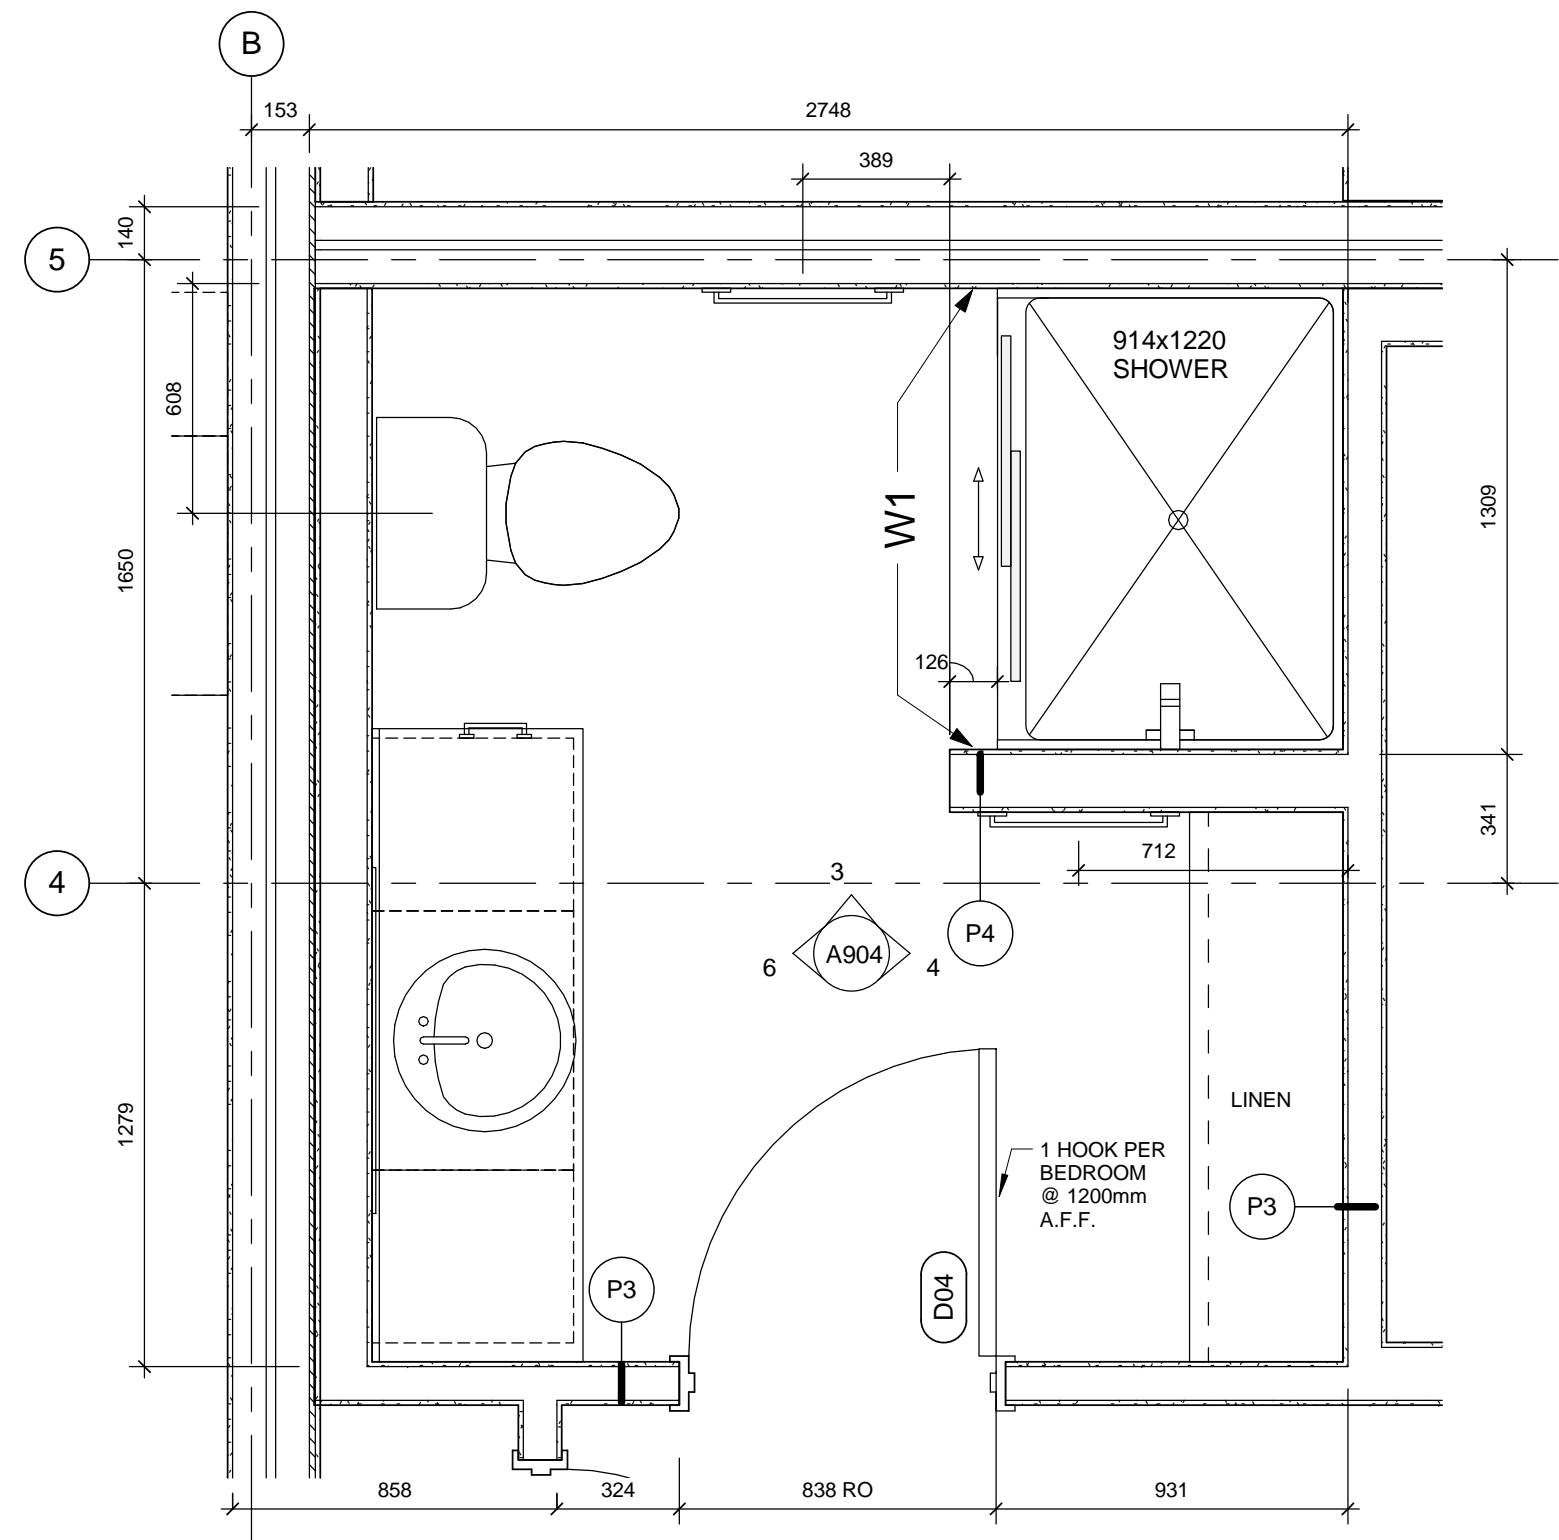


3 Bathroom 1 Elevation 1
A904 Scale: 1 : 20

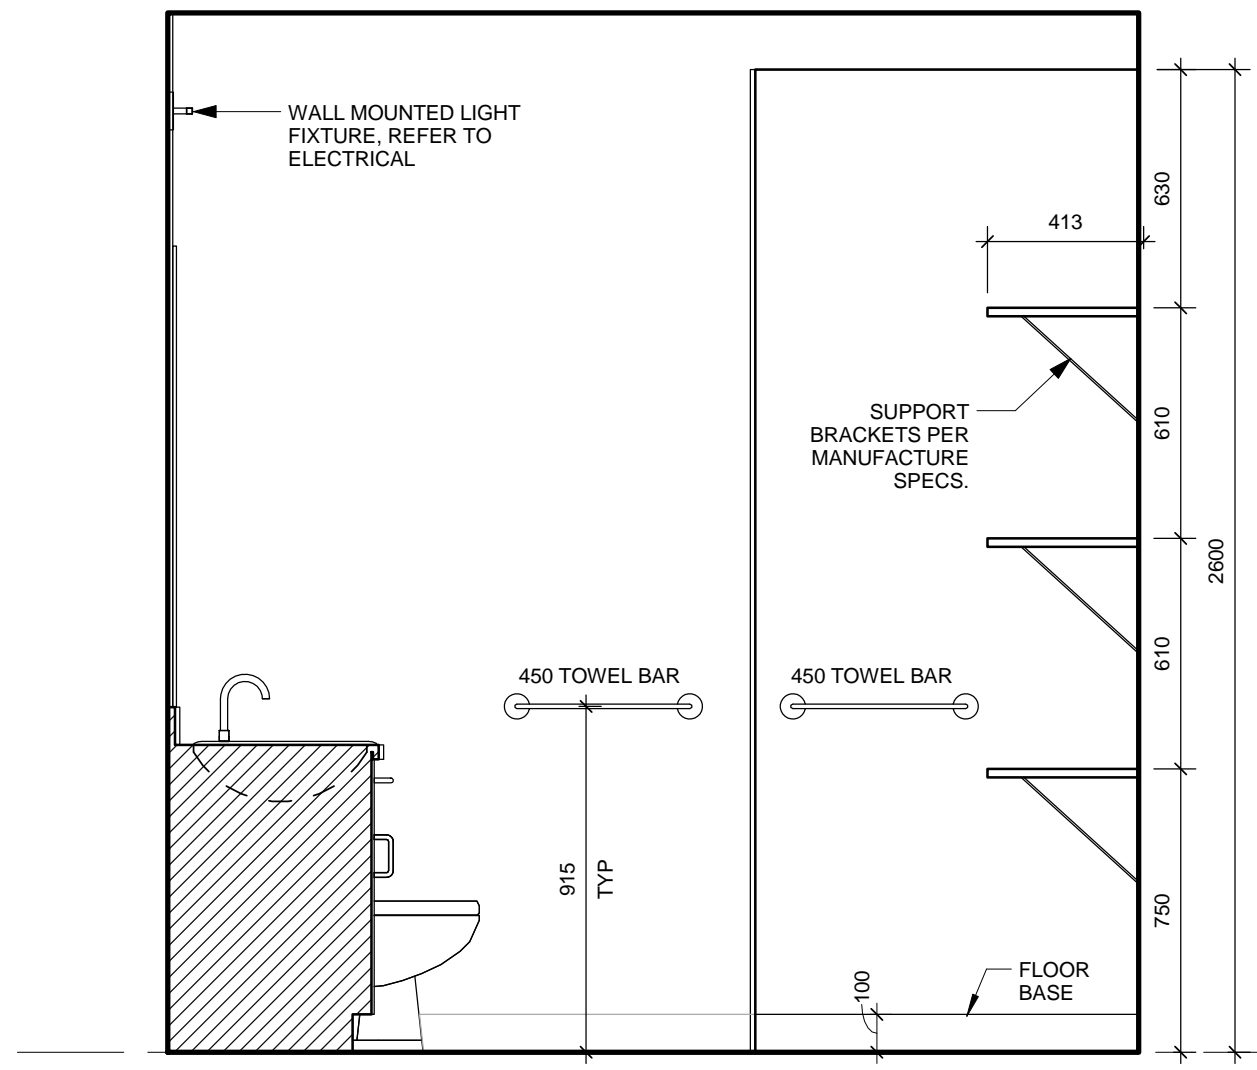


4 Bathroom 1 Elevation 2
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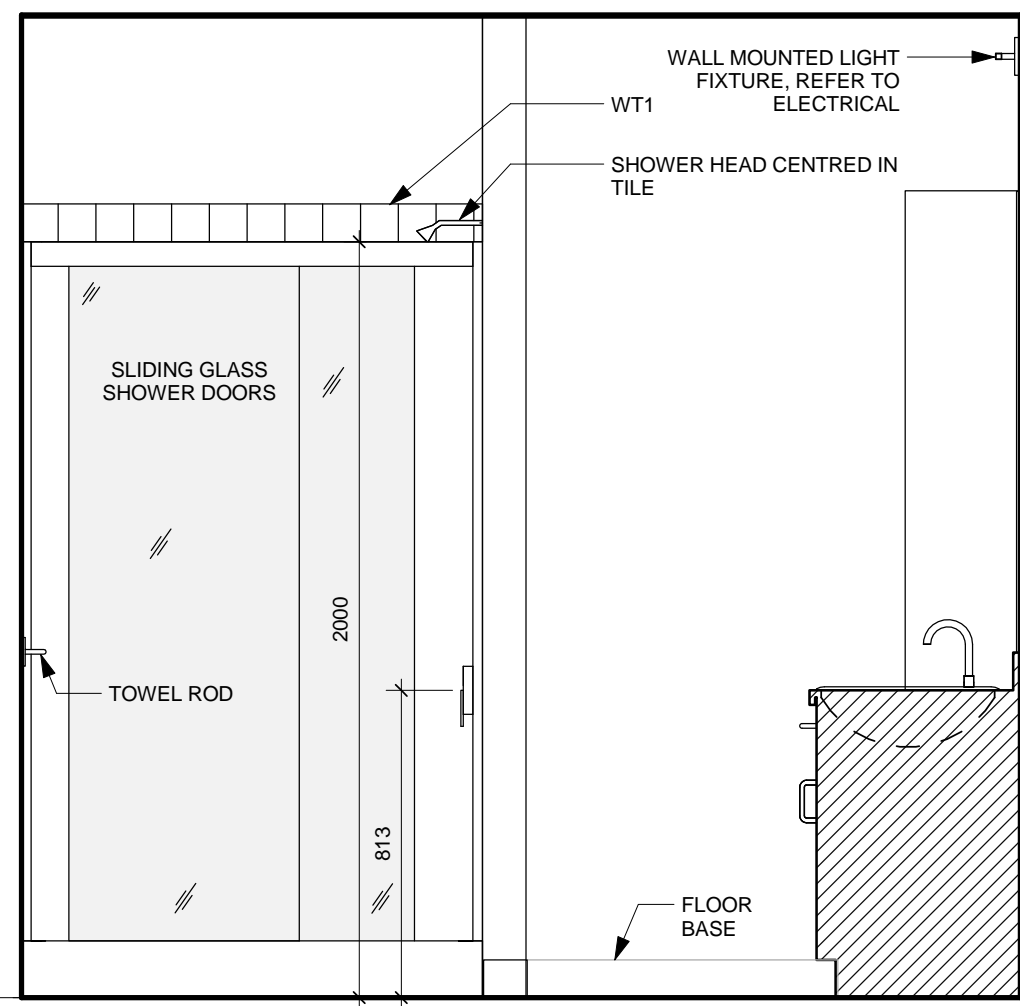
6 Bathroom 1 Elevation 4
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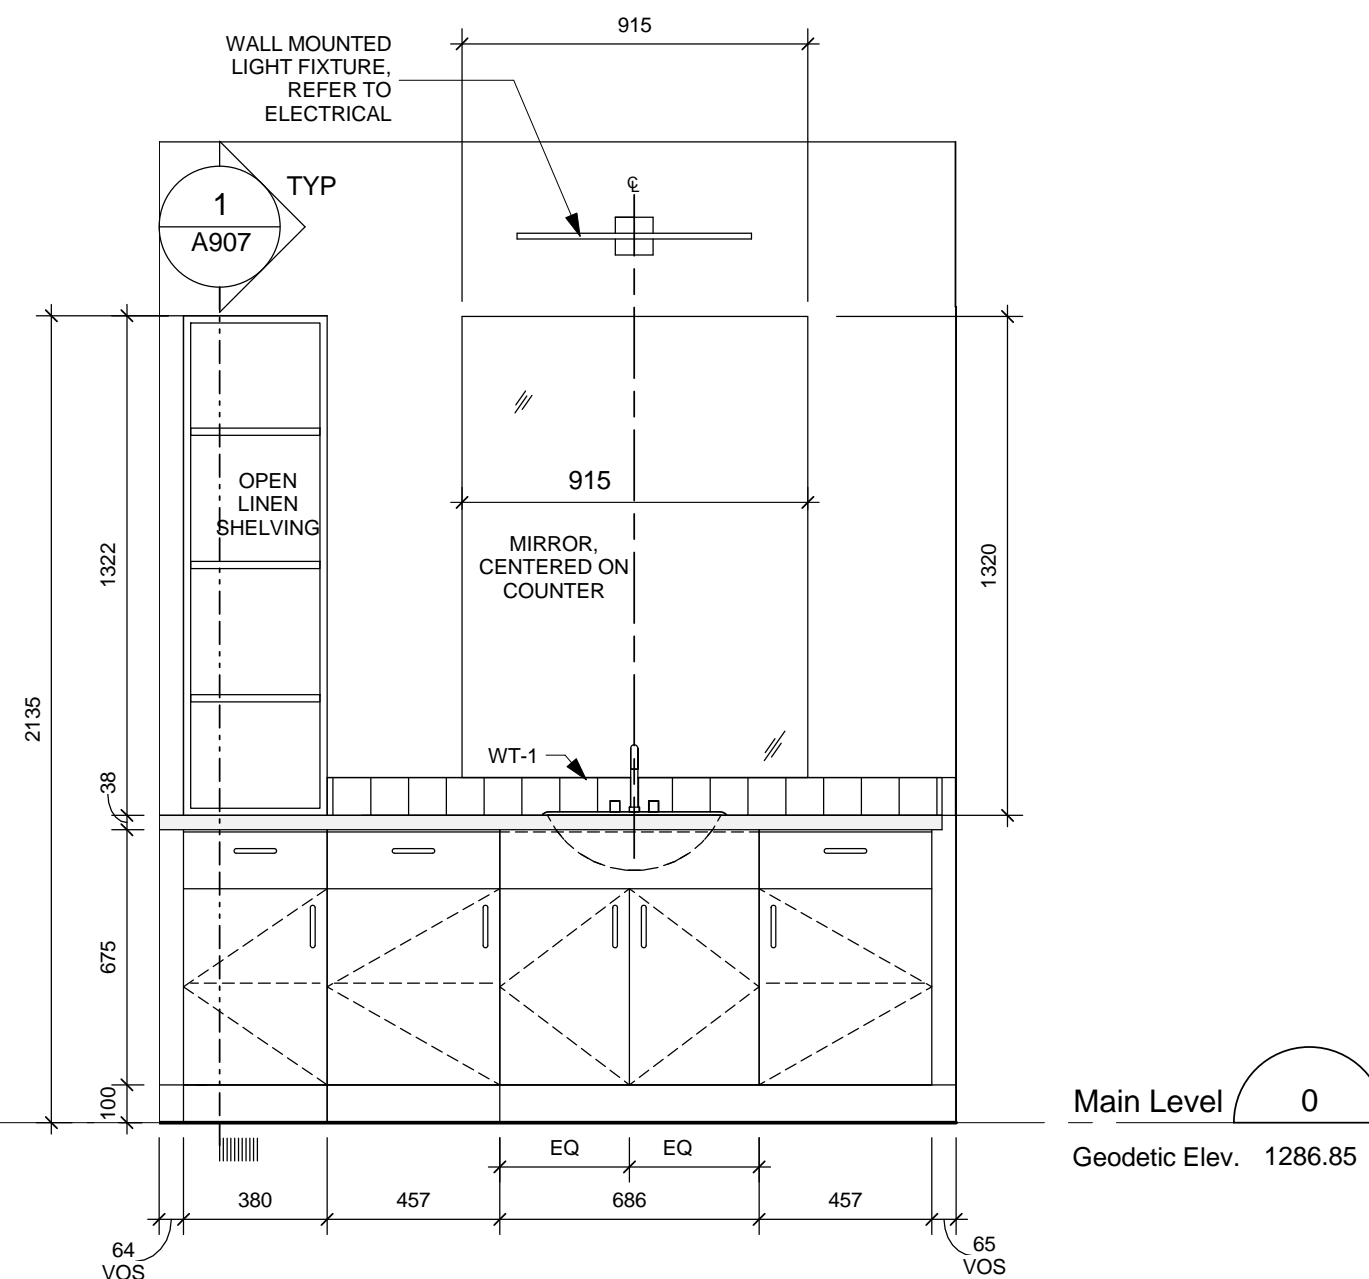
2 Typical enlarged Plan - Bathroom 2
A904 Scale: 1 : 20

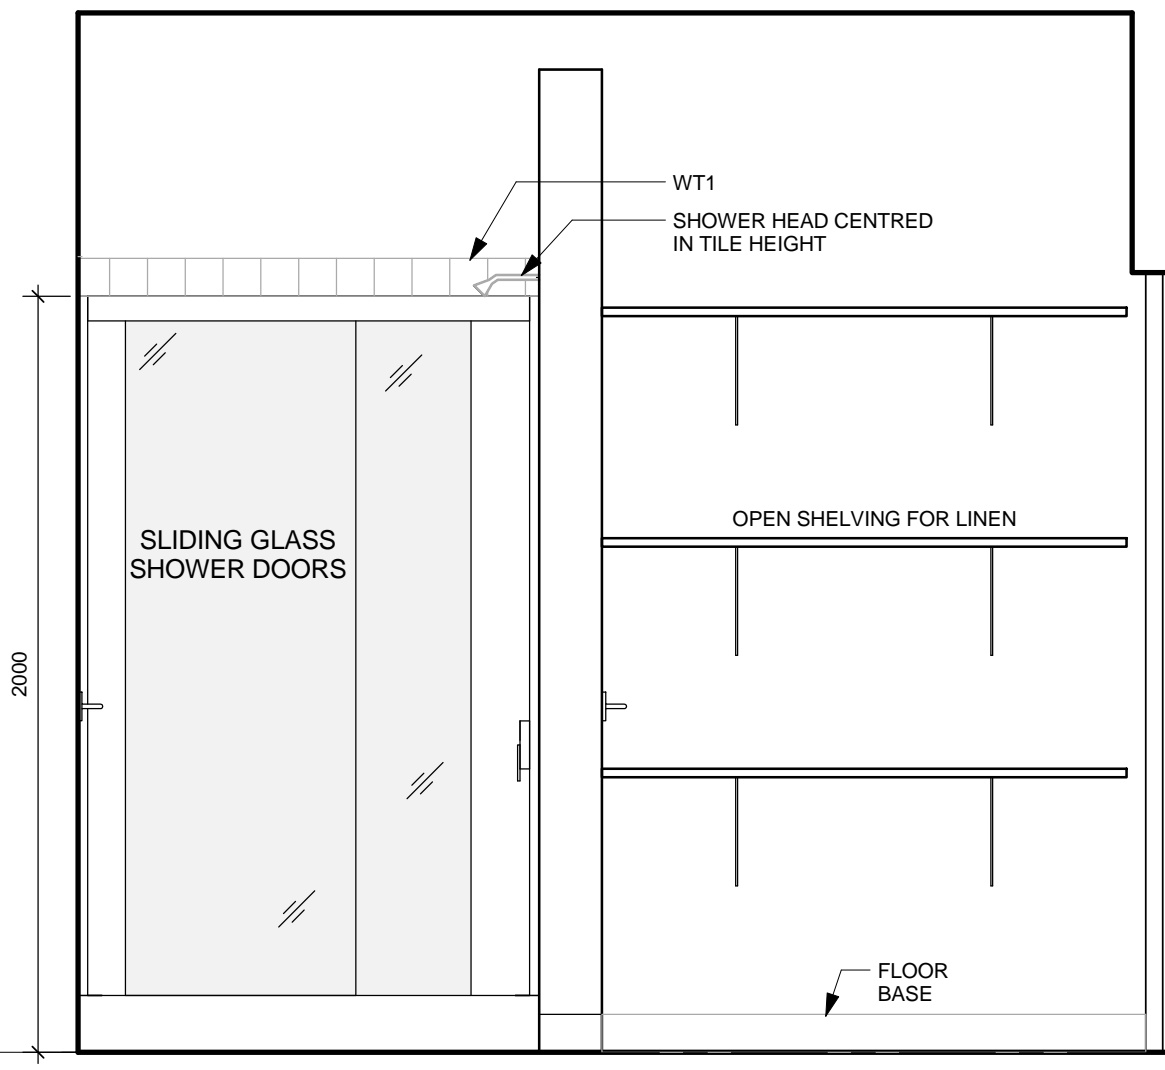

8 Bathroom 2 Elevation 2
A904 Scale: 1 : 20

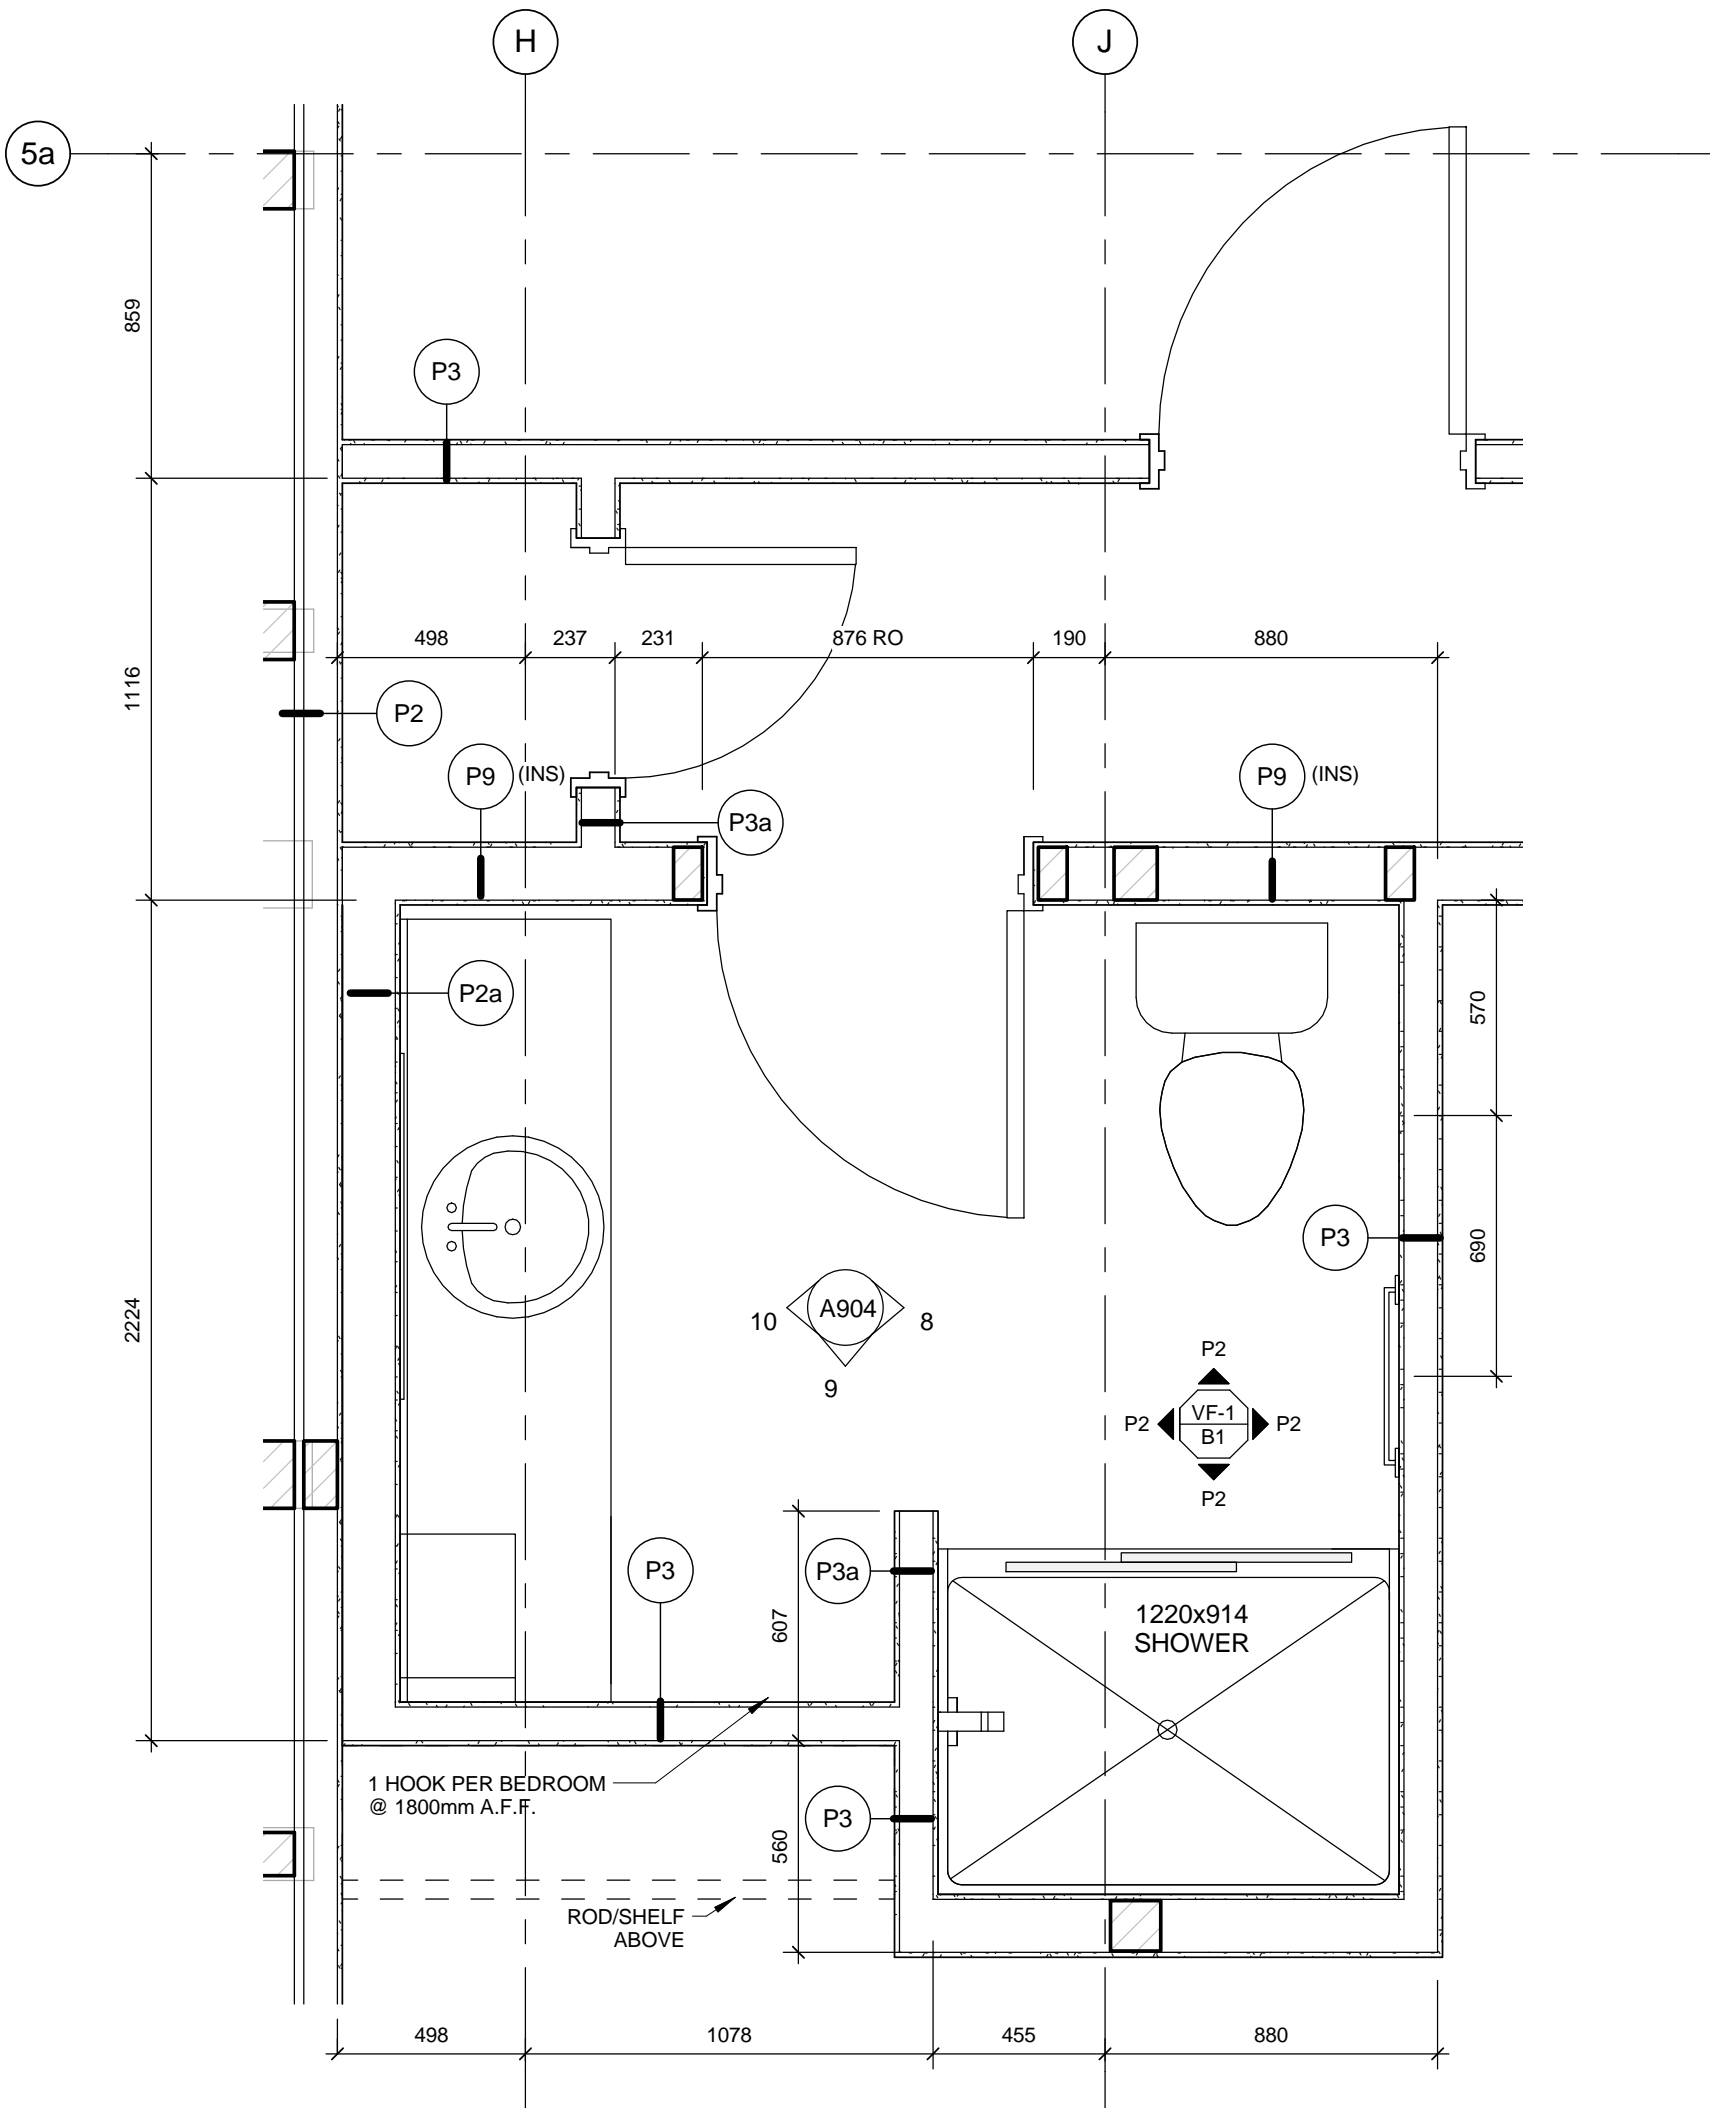

9 Bathroom 2 Elevation 3
A904 Scale: 1 : 20

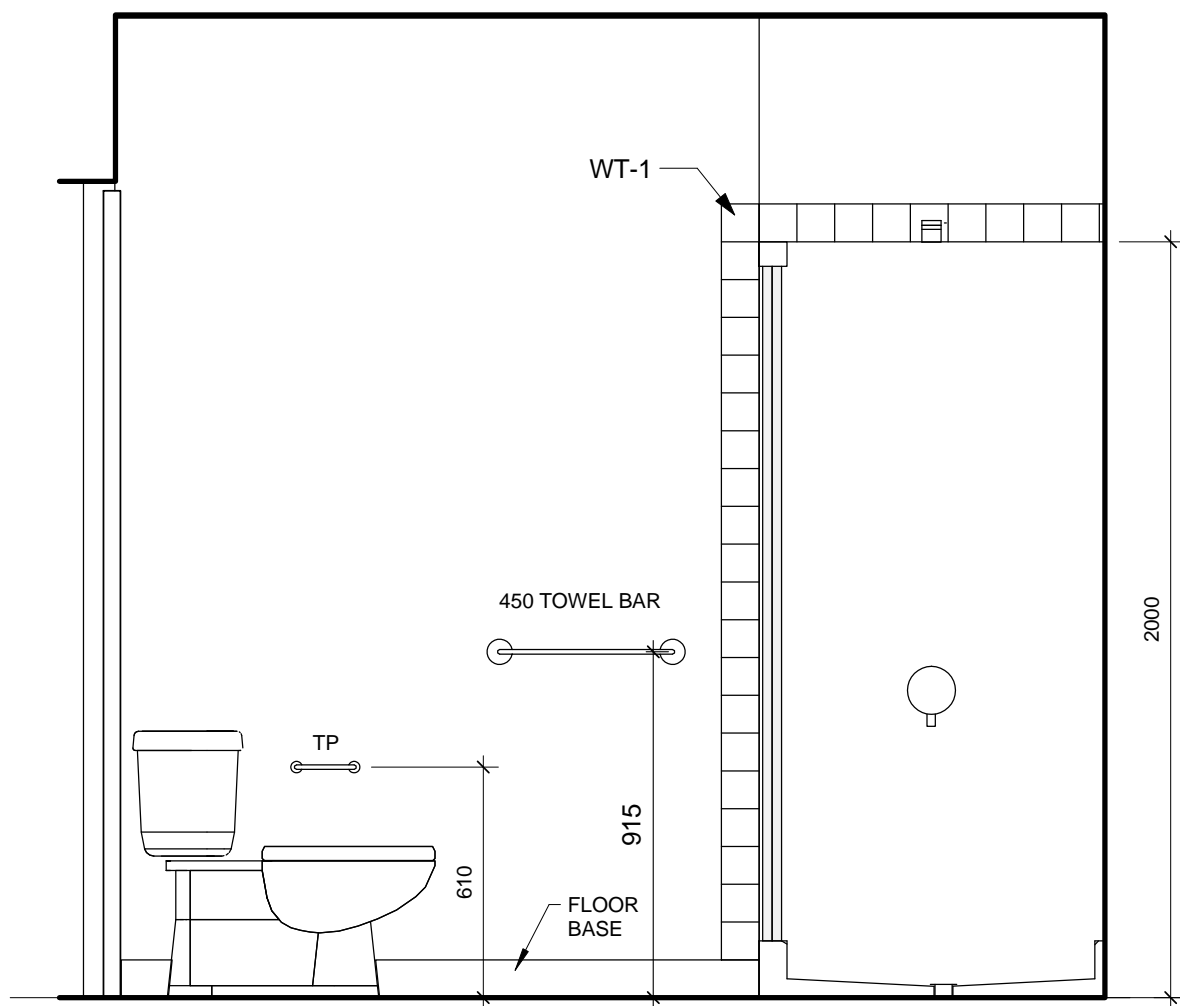

10 Bathroom 2 Elevation 4
A904 Scale: 1 : 20


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No.	Date/Date	Description/Description	Drawn by Dessiné par
		Revision / Revision	Approved Approuvé
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		B source drawing no. de dessin no.	
		C detail on drawing no. détail sur dessin no.	
Consultant's Name Nom de l'expert-conseil		Eng. Stamp Sceau de l'ingénieur	
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		Public Works and Government Services Travaux publics et Services gouvernementaux Canada Client Services Team Southern Alberta Operations Branch Le Client Entretien l'Équipe Alberta Méridionale Branche d'Opérations	
			
Client/client		Parks Canada Agence L'Agence Parcs Canada Western and Northern Region Ouest et Nord du Canada	
			
Project title/Titre du projet Staff Housing Phase 2 Waterton Lakes National Park			
Drawing title/Titre du dessin BATHROOM PLANS & ELEVATIONS			
Surveyed by/Arpenté par		Drawn by/Dessiné par	Date/Date
AG		AG	2016-12-08
Designed by/Concept par		Reviewed by/Revisé par	Scale/Echelle
LS/FVR		LS/FVR	1 : 20
PWGSC Project Manager/Administrateur de Projets TPWGC Randy Boldt			
Client Acceptance/Acceptation du client		Approved by/Approuvé par	
Task Responsible Officer/Agent Responsable		Task Responsible Officer/Agent Responsable	
Project No./No. du projet		Asset No./No. du bien	Sheet No./No. de la feuille
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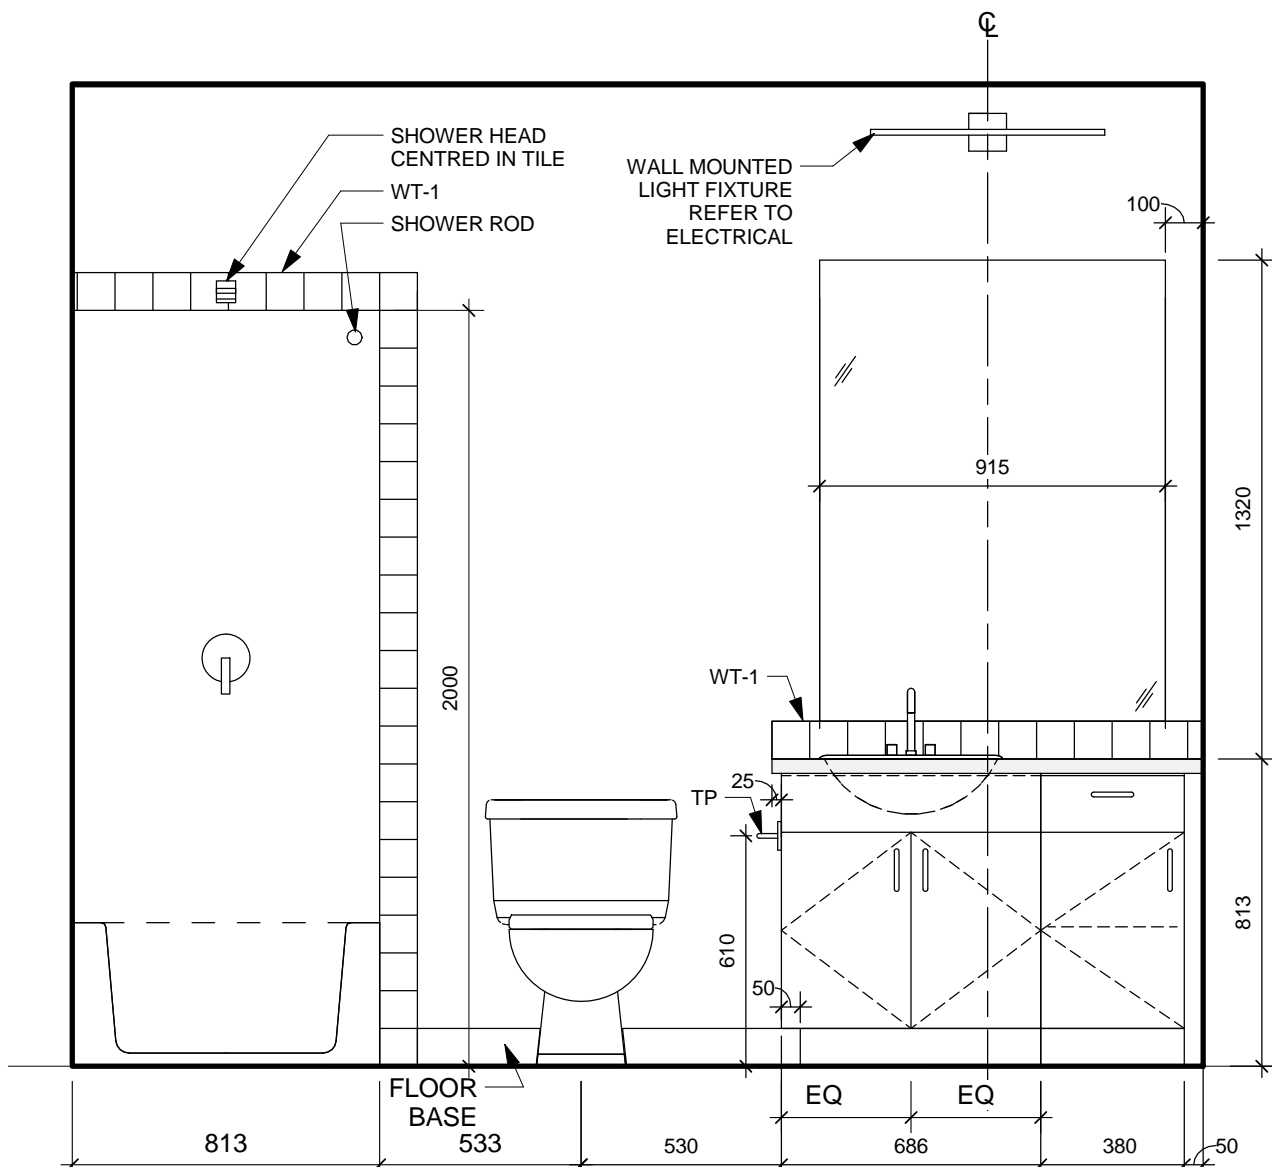
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INTERIOR ELEVATION NOTES:


- REFER TO FINISHES PLANS FOR MATERIALS & FINISHES




1 Typical enlarged Plan - Bathroom 3
A905 Scale: 1 : 20

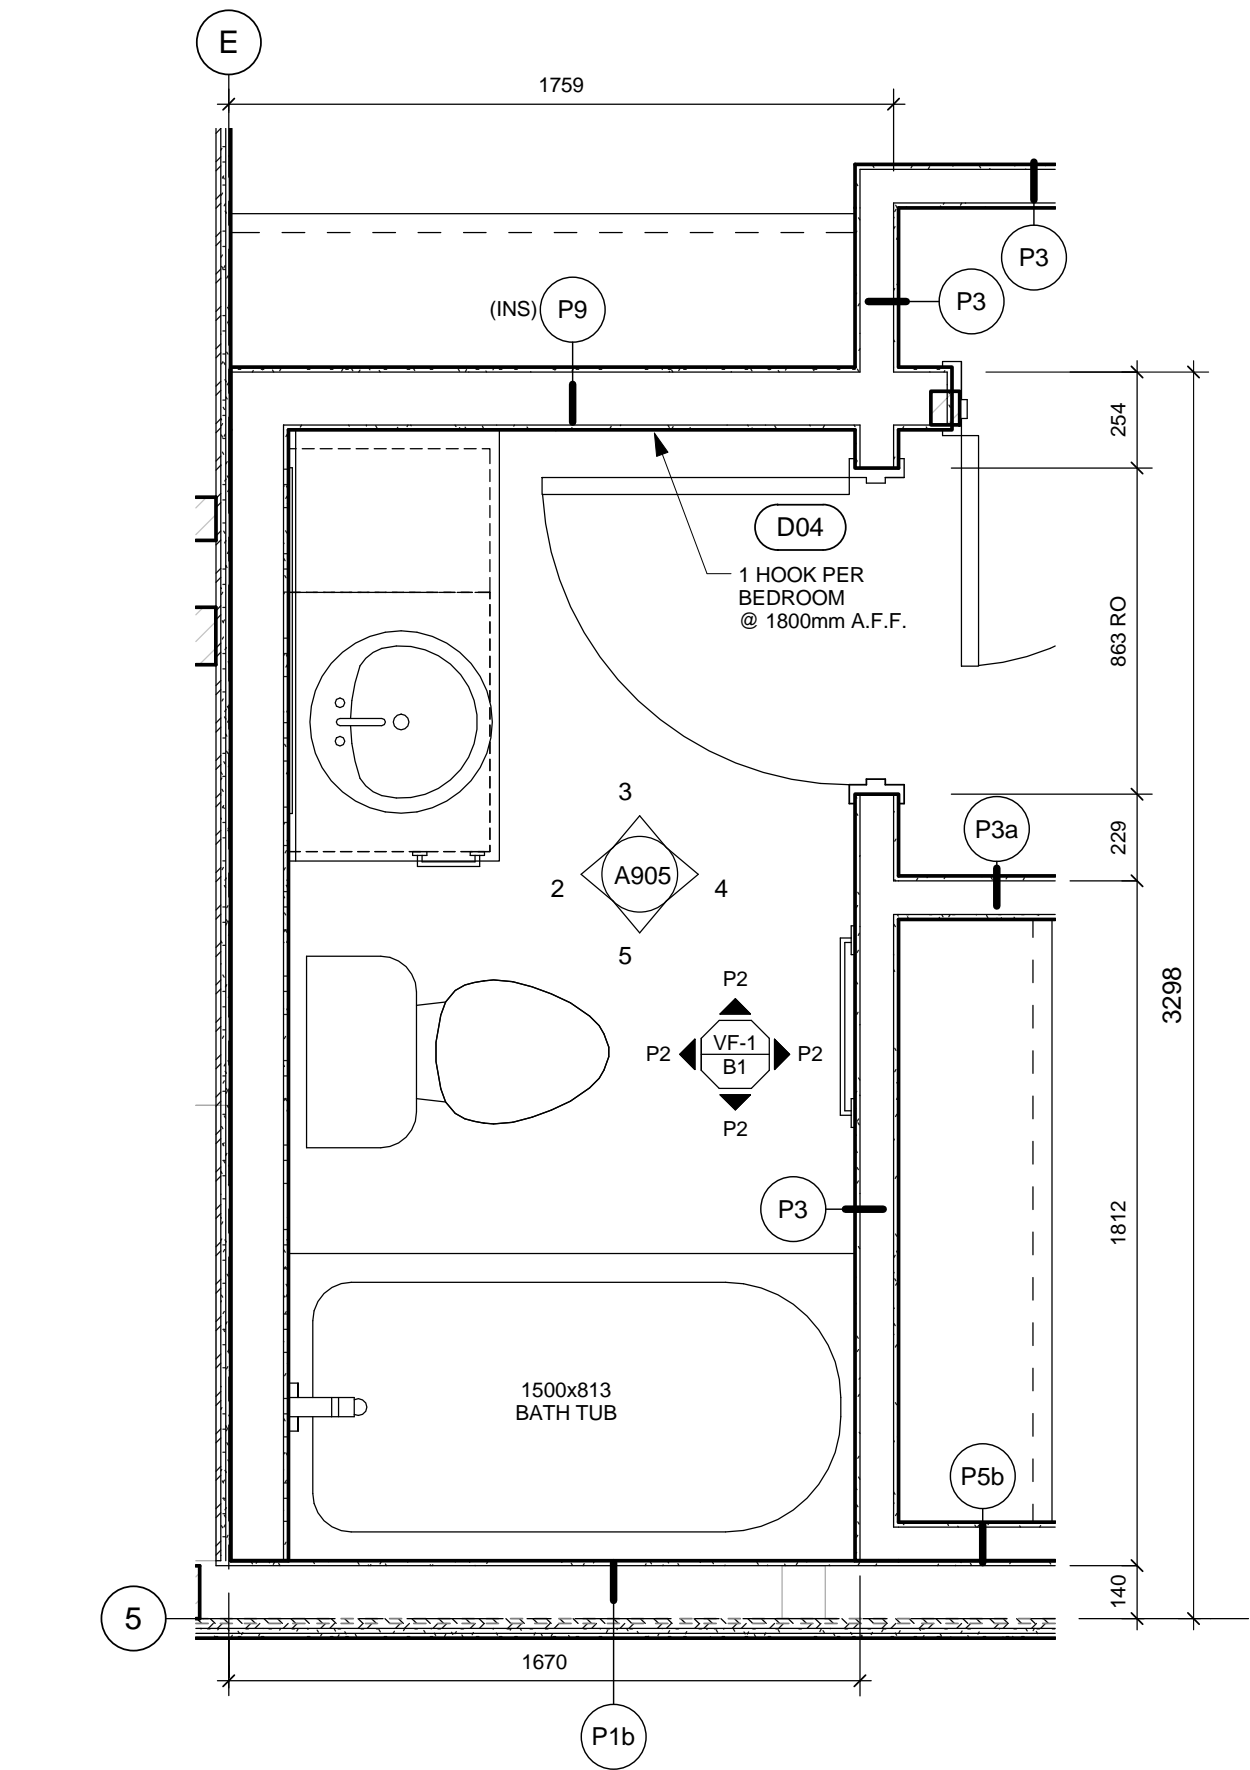


2 Bathroom 3 Elevation 1
A905 Scale: 1 : 20

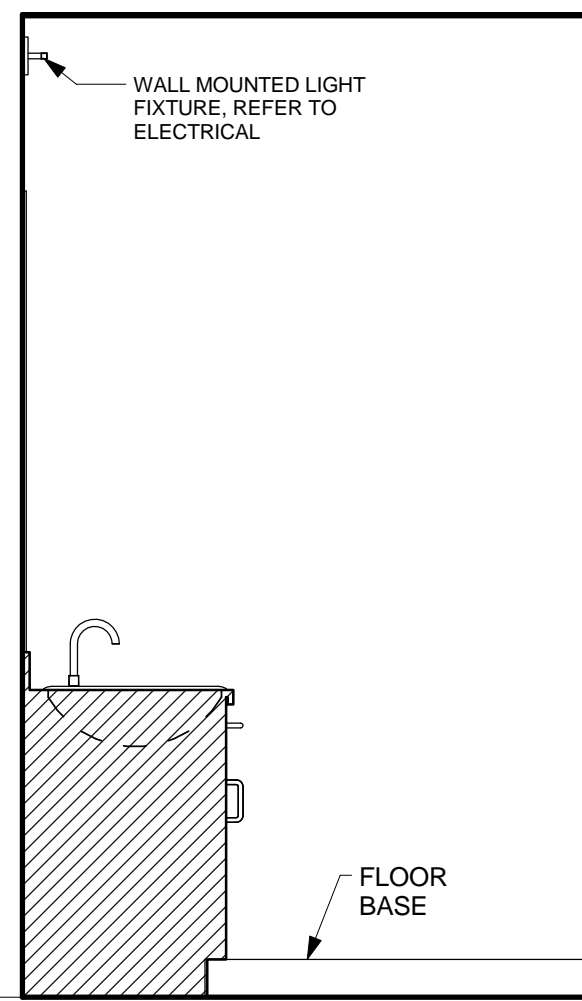

3 Bathroom 3 Elevation 2
A905 Scale: 1 : 20

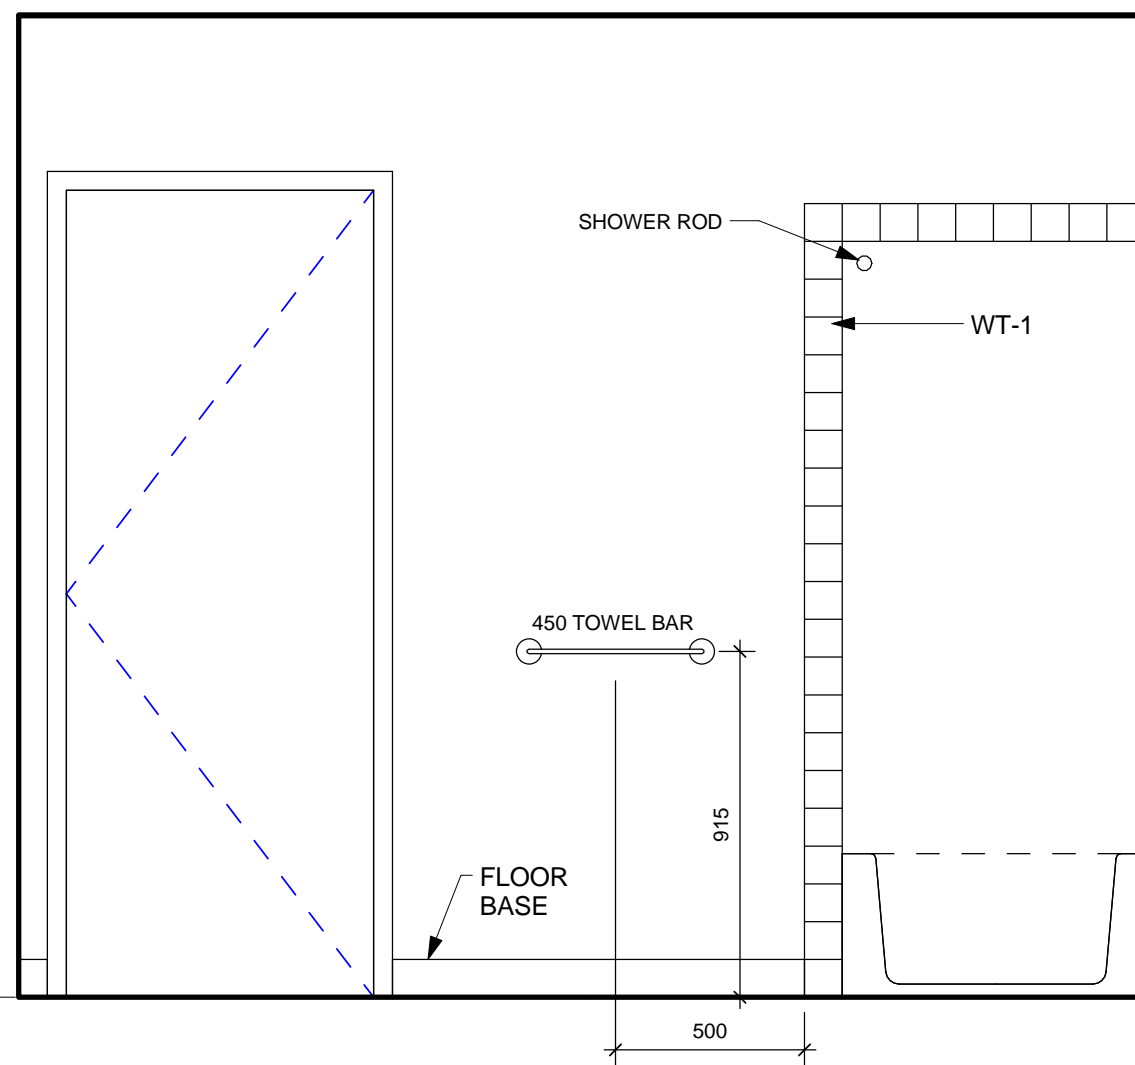


4 Bathroom 3 Elevation 3
A905 Scale: 1 : 20

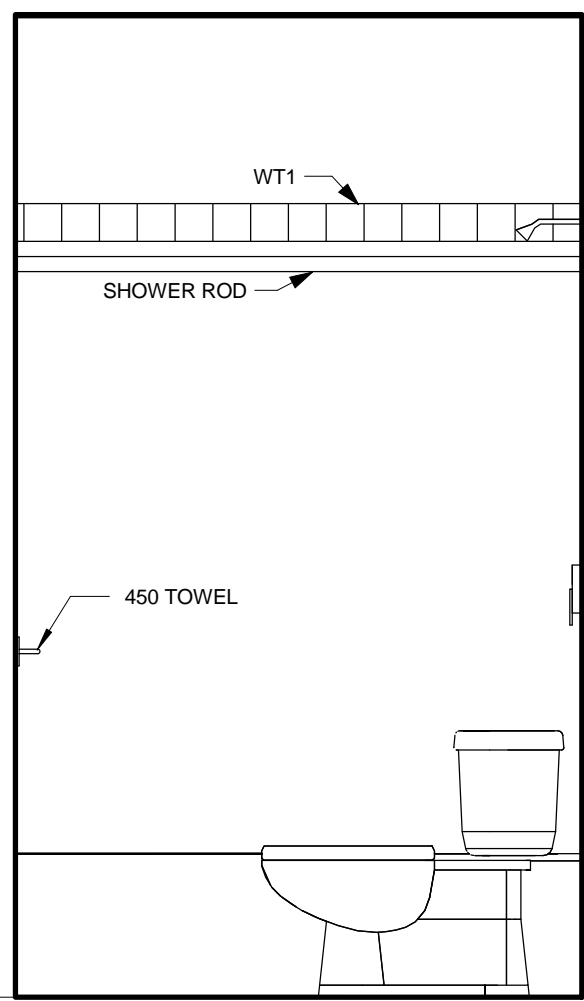


5 Bathroom 3 Elevation 4
A905 Scale: 1 : 20


Main Level 0
Geodetic Elev. 1286.85

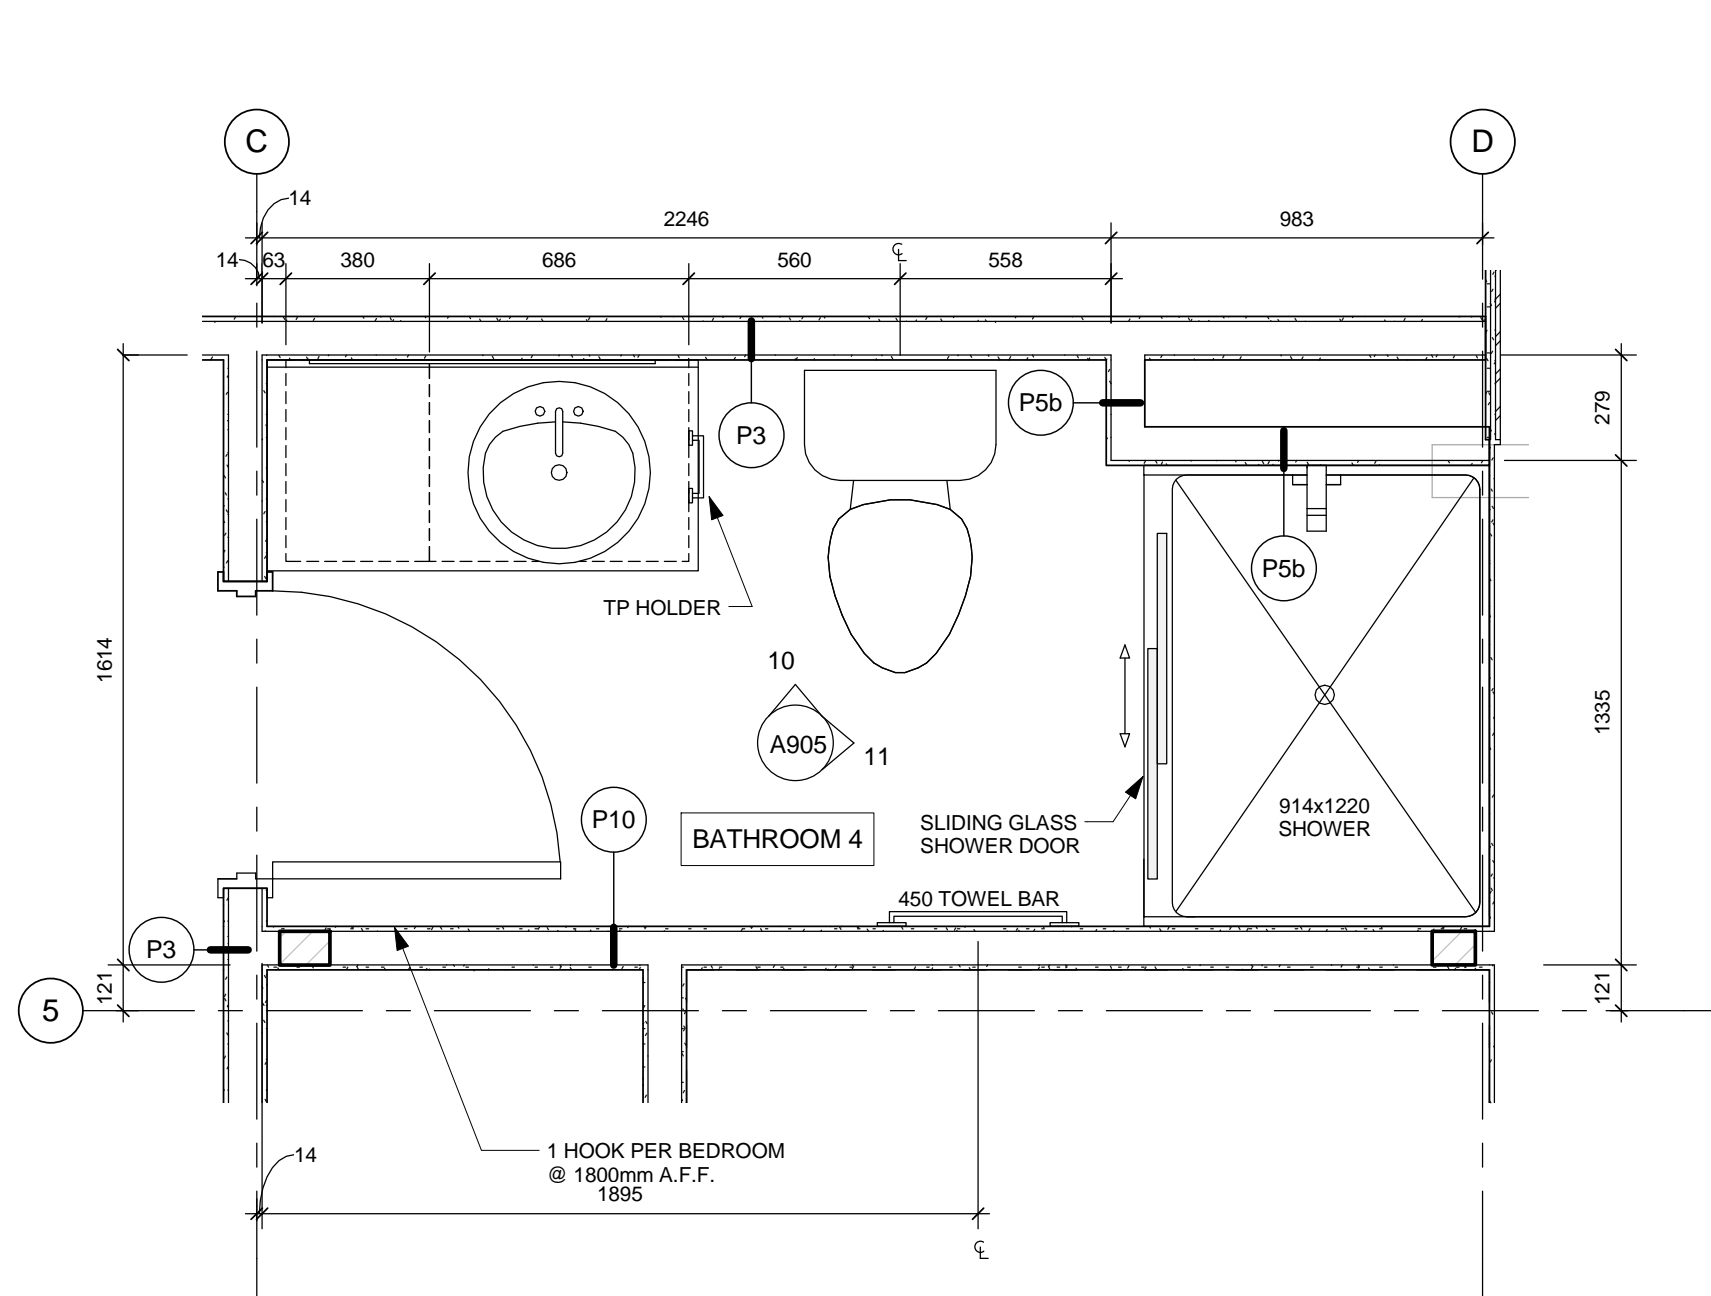

9 Typical enlarged Plan - Bathroom 4
A905 Scale: 1 : 20

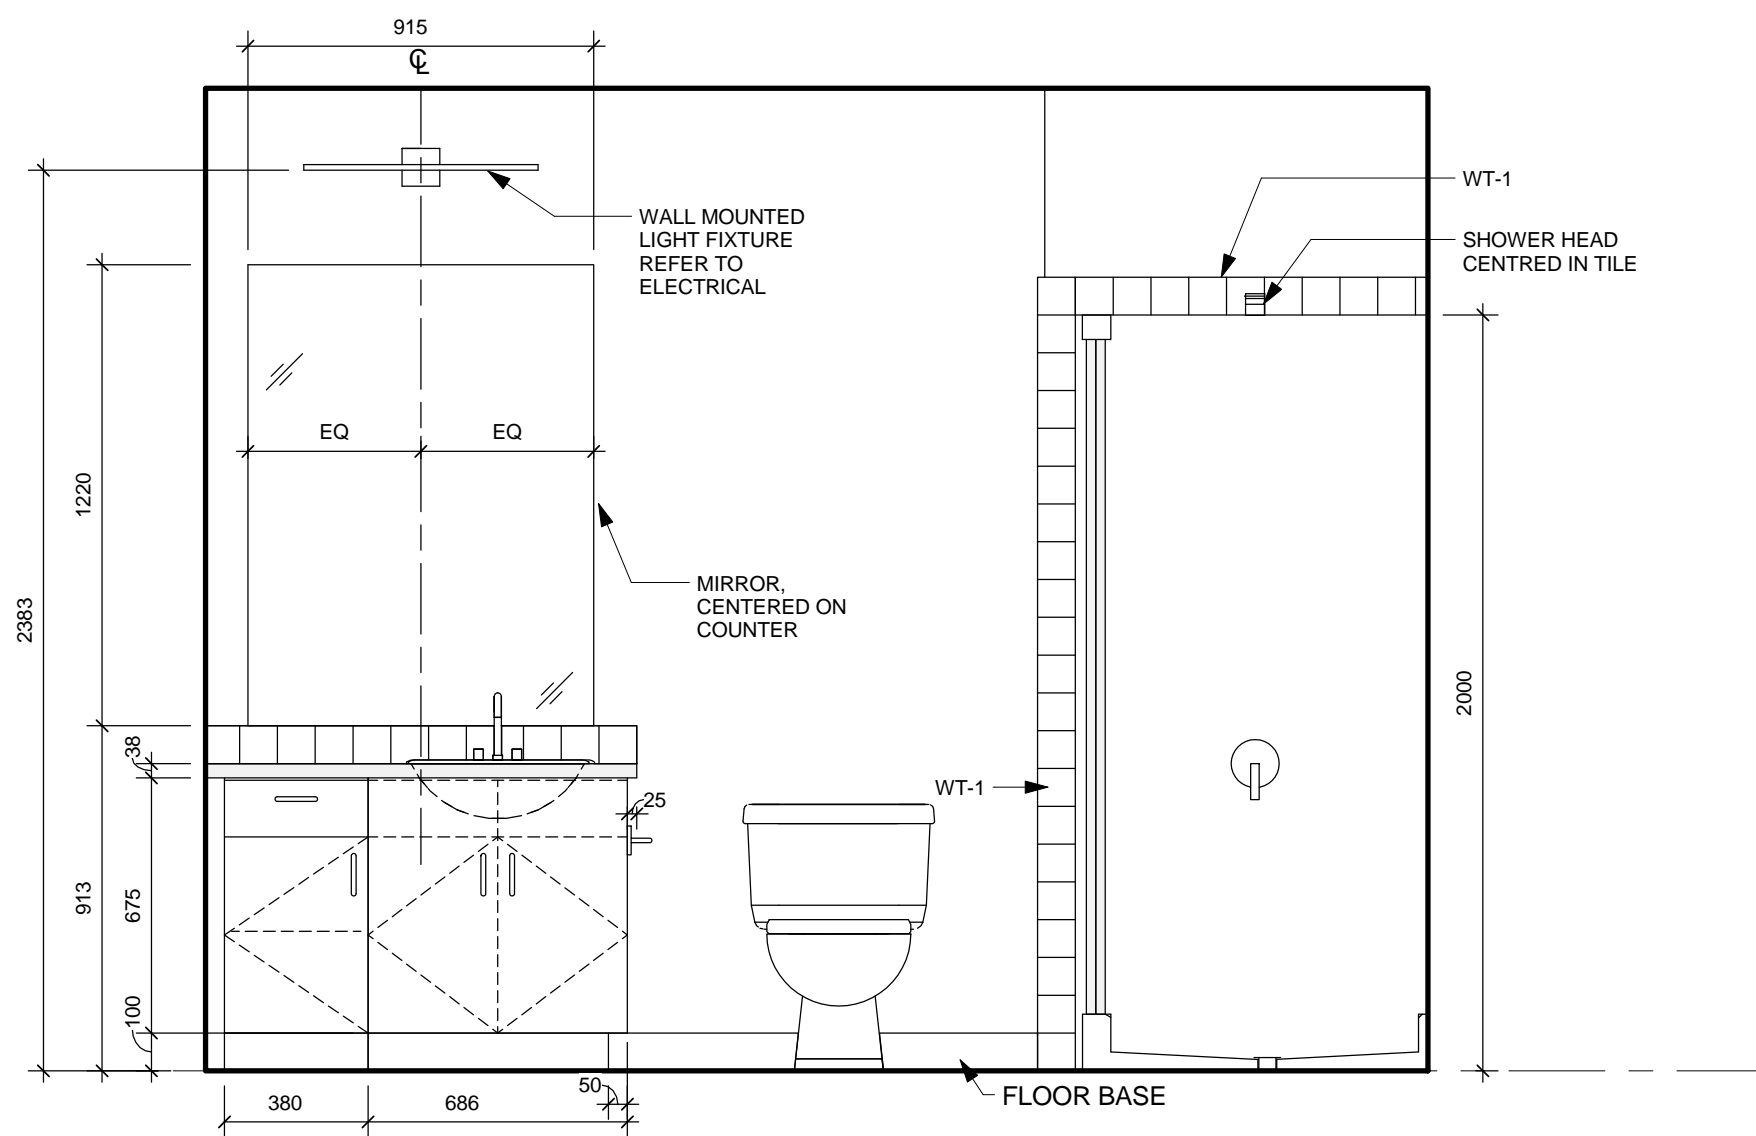

10 Bathroom 5 Elevation 1
A905 Scale: 1 : 20

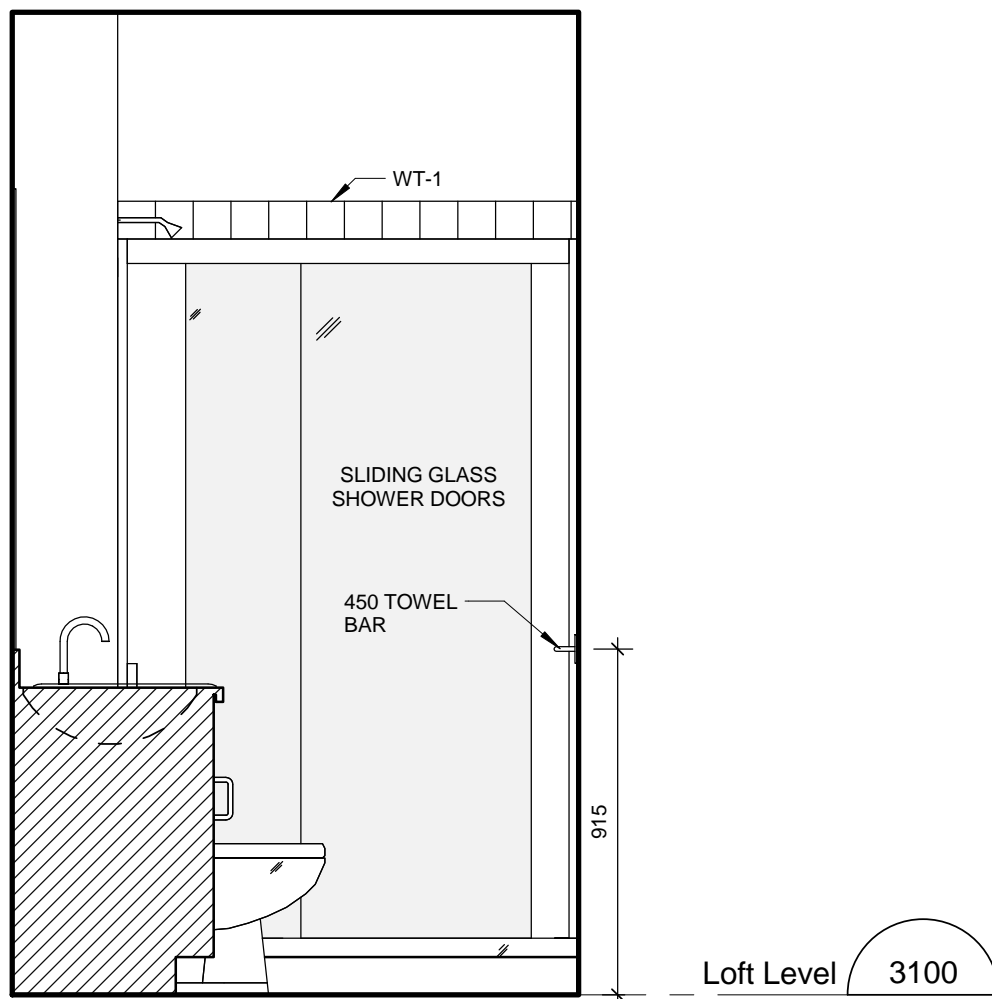

11 Bathroom 5 Elevation 2
A905 Scale: 1 : 20

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1	2016-06-14	ISSUED FOR 60% REVIEW		

No.	Date/Date	Description/Description	Drawn by Dessiné par	Approved Approuvé
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Revision /	Revision
A	detail number numéro de détail
B	source drawing no. de dessin no.
C	detail on drawing no. détail sur dessin no.

Consultant's Name Nom de l'expert-conseil	Eng. Stamp Sceau de l'ingénieur
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Client Services Team Southern Alberta Operations Branch	Le Client Entretien l'Équipe Alberta Méridionale Branche d'Opérations

Canada

Client/client	Parks Canada Agence	L'Agence Parcs Canada
	Western and Northern Region	Ouest et Nord du Canada

Project title/Titre du projet
**Staff Housing Phase 2
Waterton Lakes National
Park**

Drawing title/Titre du dessin
**BATHROOM PLANS &
ELEVATIONS**












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LS/FVR	AG	2016-12-08
Designed by/Concept par	Reviewed by/Revisé par	Scale/Echelle
LS/FVR	LS/FVR	1:20

PWGC Project Manager/Administrateur de Projets TPSCG
Randy Boldt



Client Acceptance/Acceptation du client	Approved by/Approuvé par
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Task Responsible/Officier/Agent Responsable
PWGC Project Manager/Administrateur de Projets TPSCG

Project No./No. du projet	Asset No./No. du bien	Sheet No./ No. de la feuille
39000	File # 945	A905
Drawing Reference No./No. de référence du dessin		

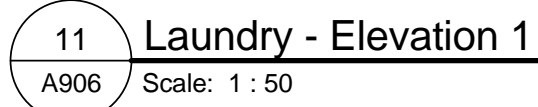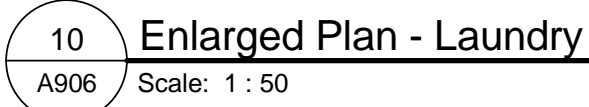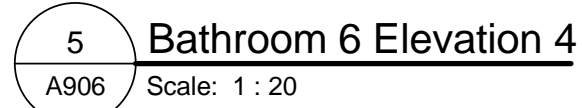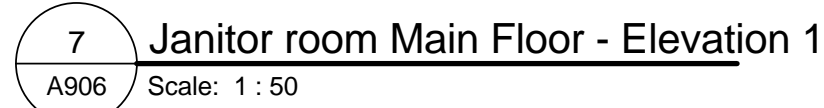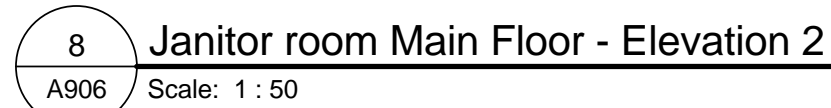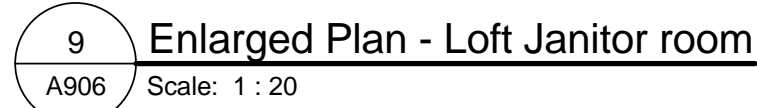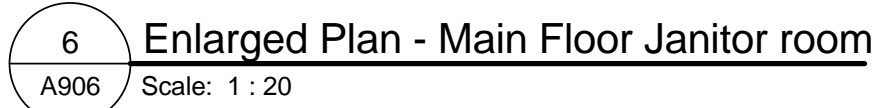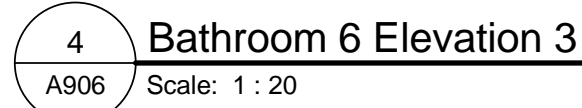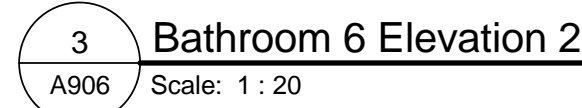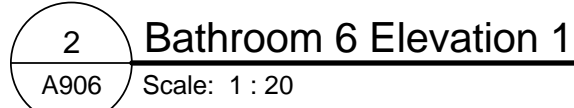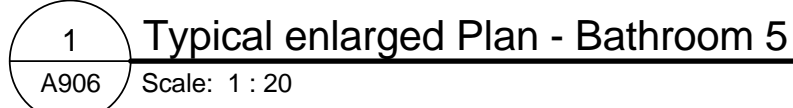

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Revision / Revision		
	A detail number numero de detail	
	B source drawing no. de dessin no.	
	C detail on drawing no. detail sur dessin no.	

IBICanada 

Project title/Titre du projet

Staff Housing Phase 2
Waterton Lakes National
Park

Drawing title/Titre du dessin

**BATHROOM / JANITOR PLANS
& ELEVATIONS**


PWGSC Project Manager/Administrateur de Projets TPSGC

Client Acceptance/Acceptation du client	Approved by/Approuvé par
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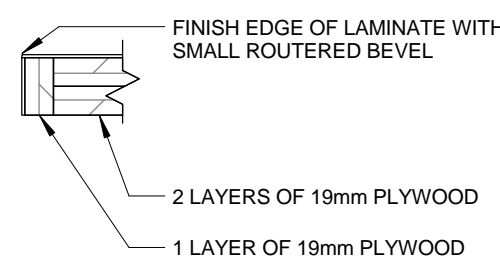
Perk Responsible Officer/Agent Responsable	PMOSC Project Manager/Administrateur de Projets TPSC
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Project No./No. du projet	Asset No./No. du bien	Sheet No./ No. de la feuille
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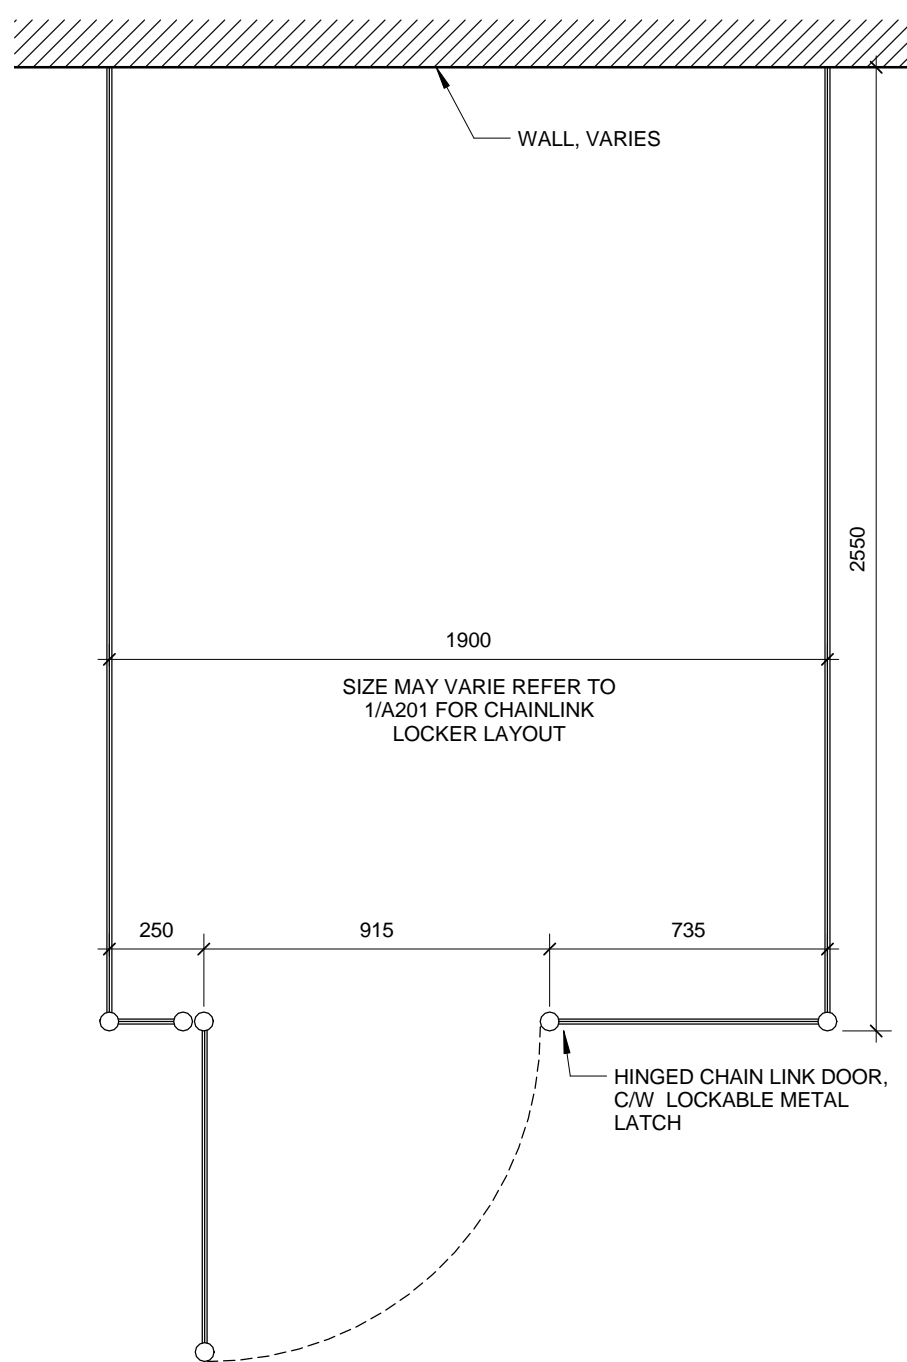
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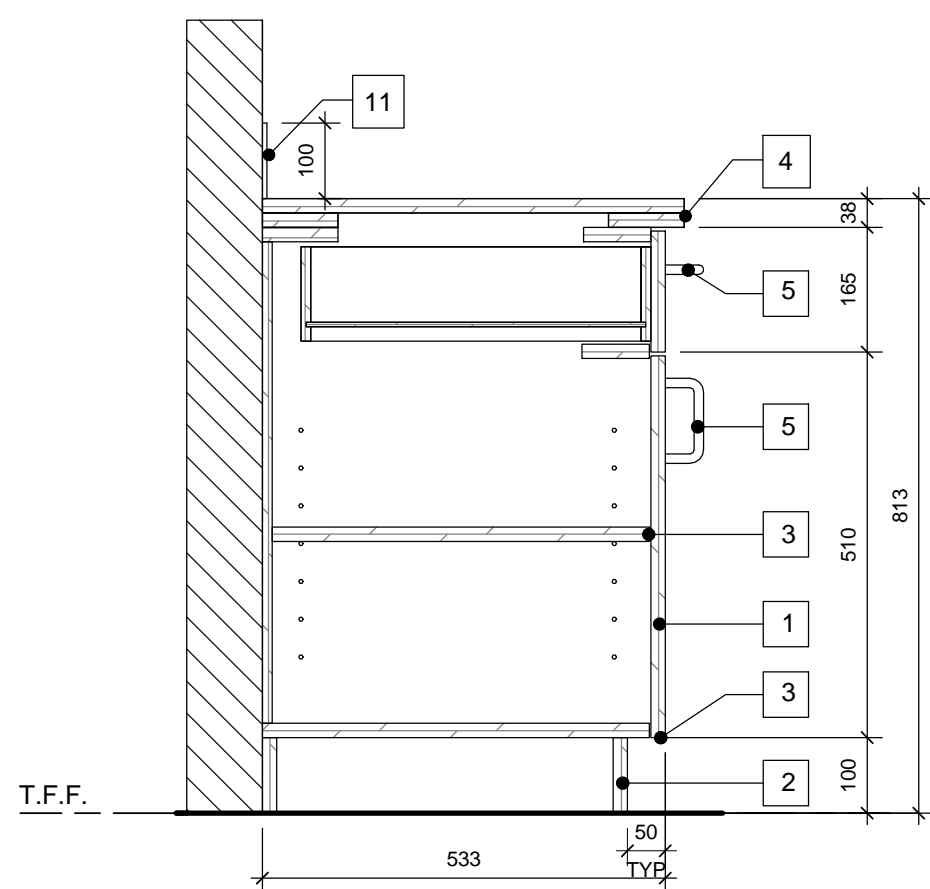
1 Bathroom Linen Open Shelf Section Detail
A907 Scale: 1 : 10




7 Typical Raised Counter Edge Detail
A907 Scale: 1 : 5

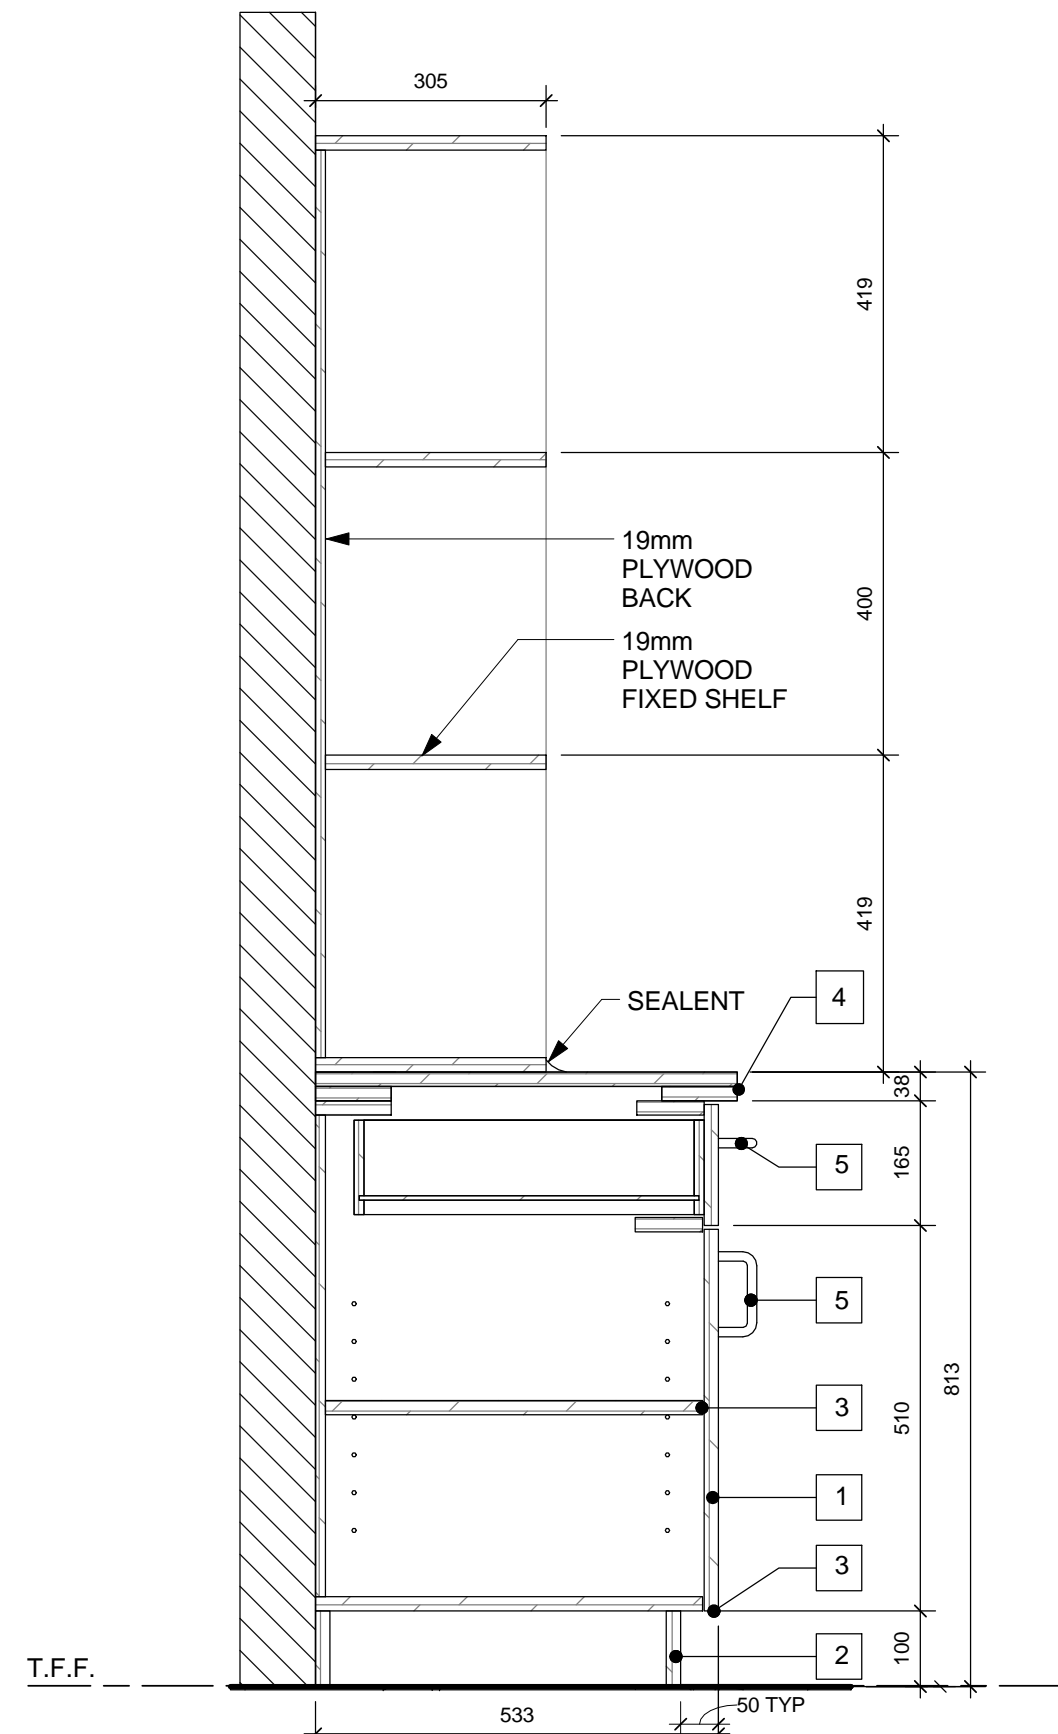


10 Typical Chain Link Locker Plan
A907 Scale: 1 : 20




2 Typical Bathroom Cabinet Section Detail
A907 Scale: 1 : 10

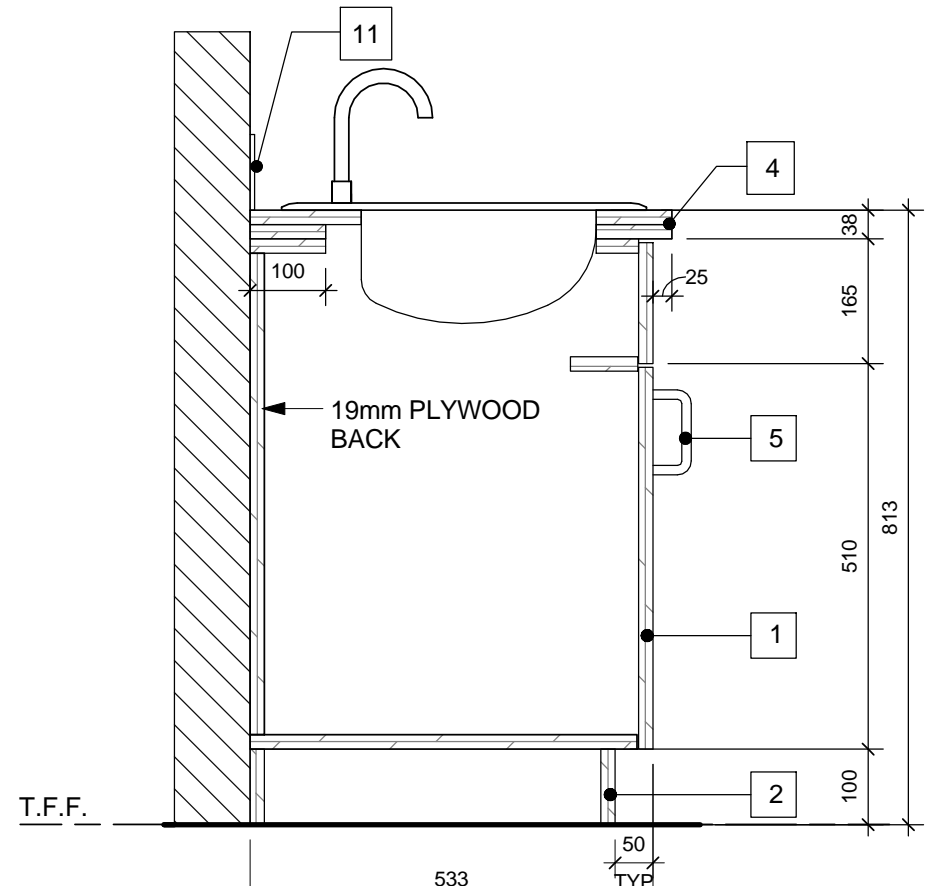


5 Typical Bathroom Cabinet Section Detail With sink
A907 Scale: 1 : 10

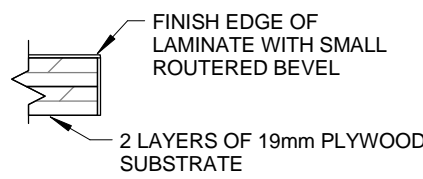


8 Typical Counter Edge Detail
A907 Scale: 1 : 5

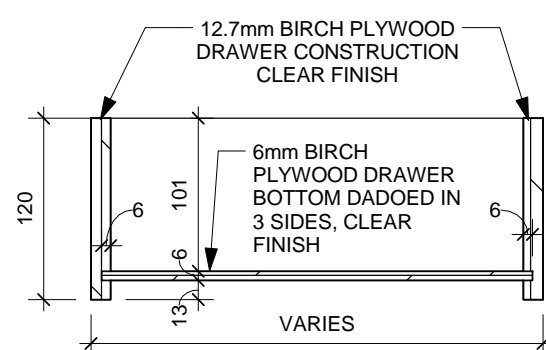


9 Typical Drawer Section Detail
A907 Scale: 1 : 5

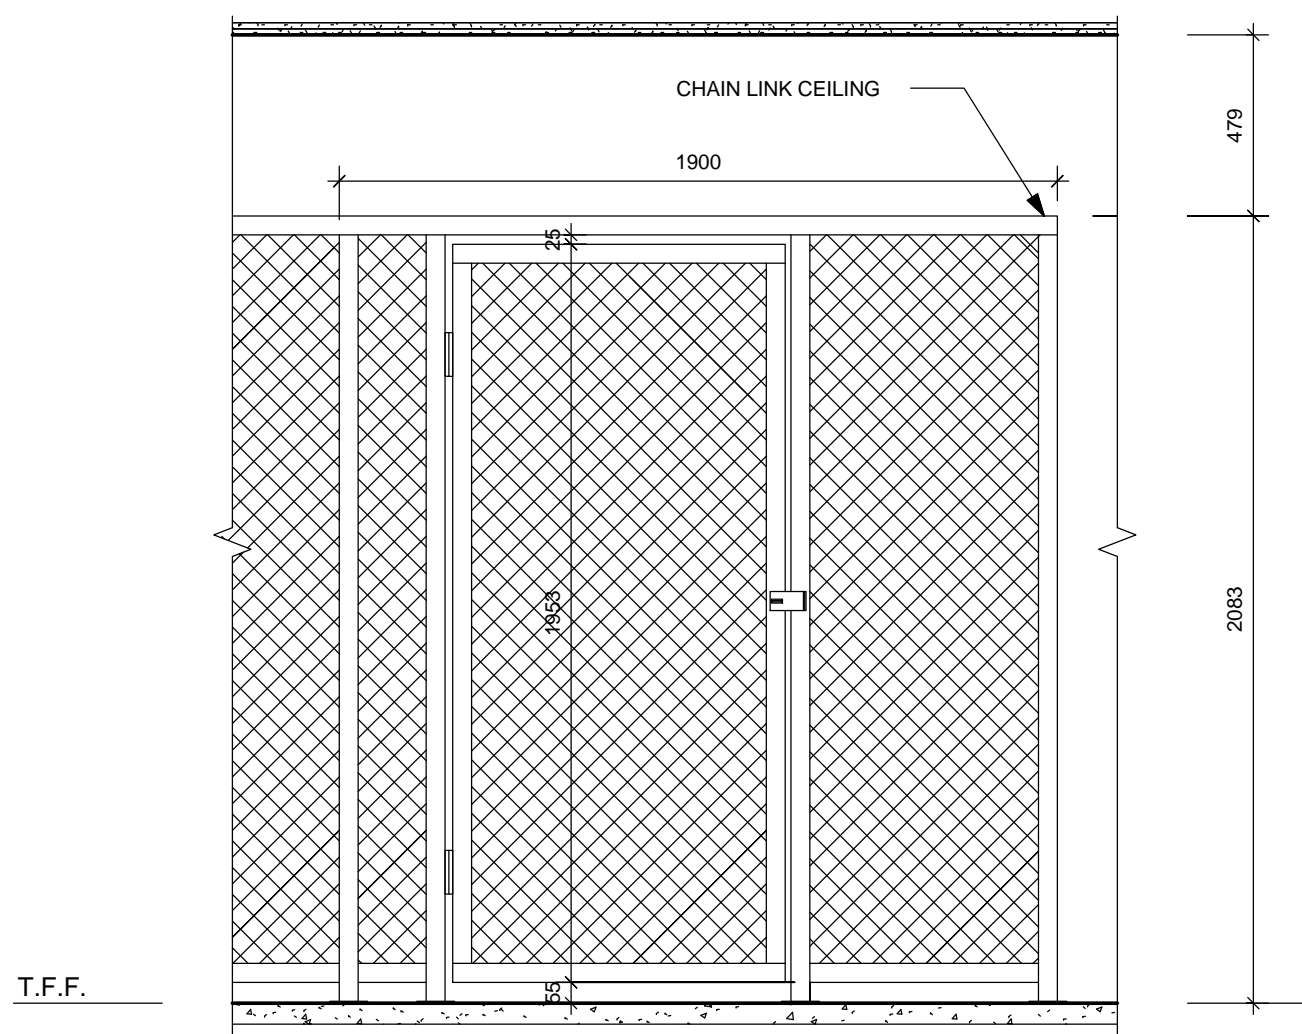


11 Chain Link Locker Fence
A907 Scale: 1 : 20

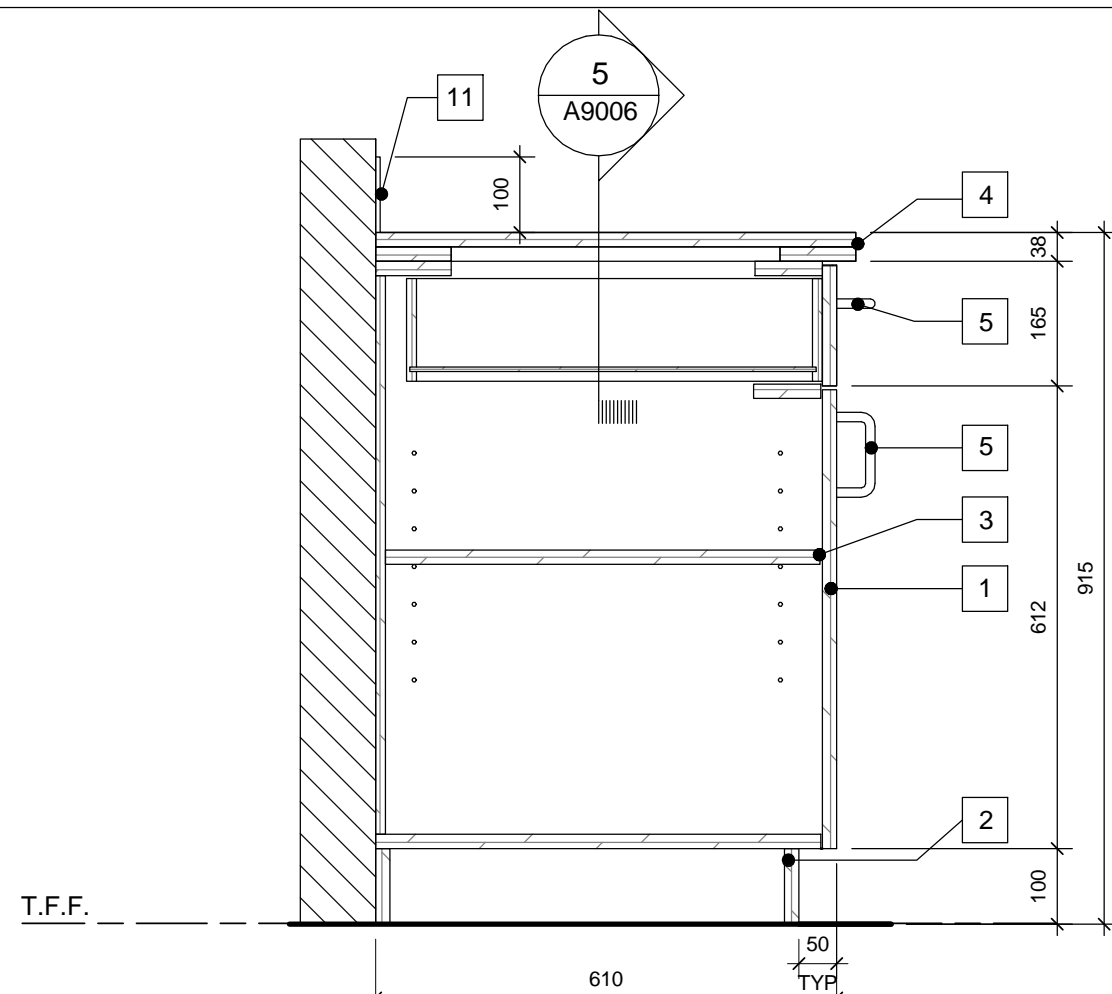


3 Typical Kitchen Base Cabinet Section Detail
A907 Scale: 1 : 10

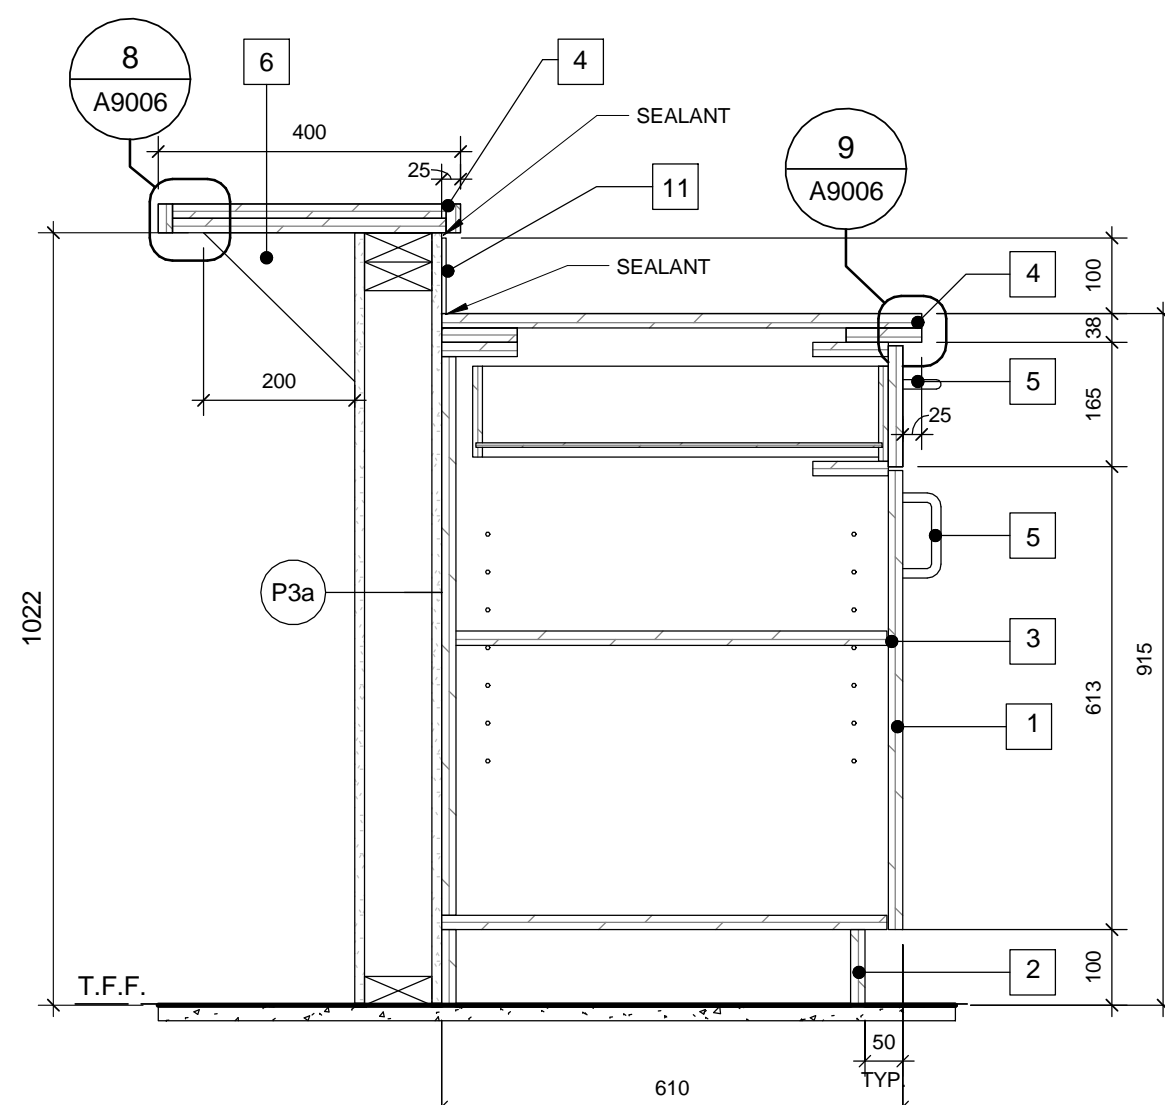


6 Typical Kitchen Raised Bar Cabinet Section Detail
A907 Scale: 1 : 10

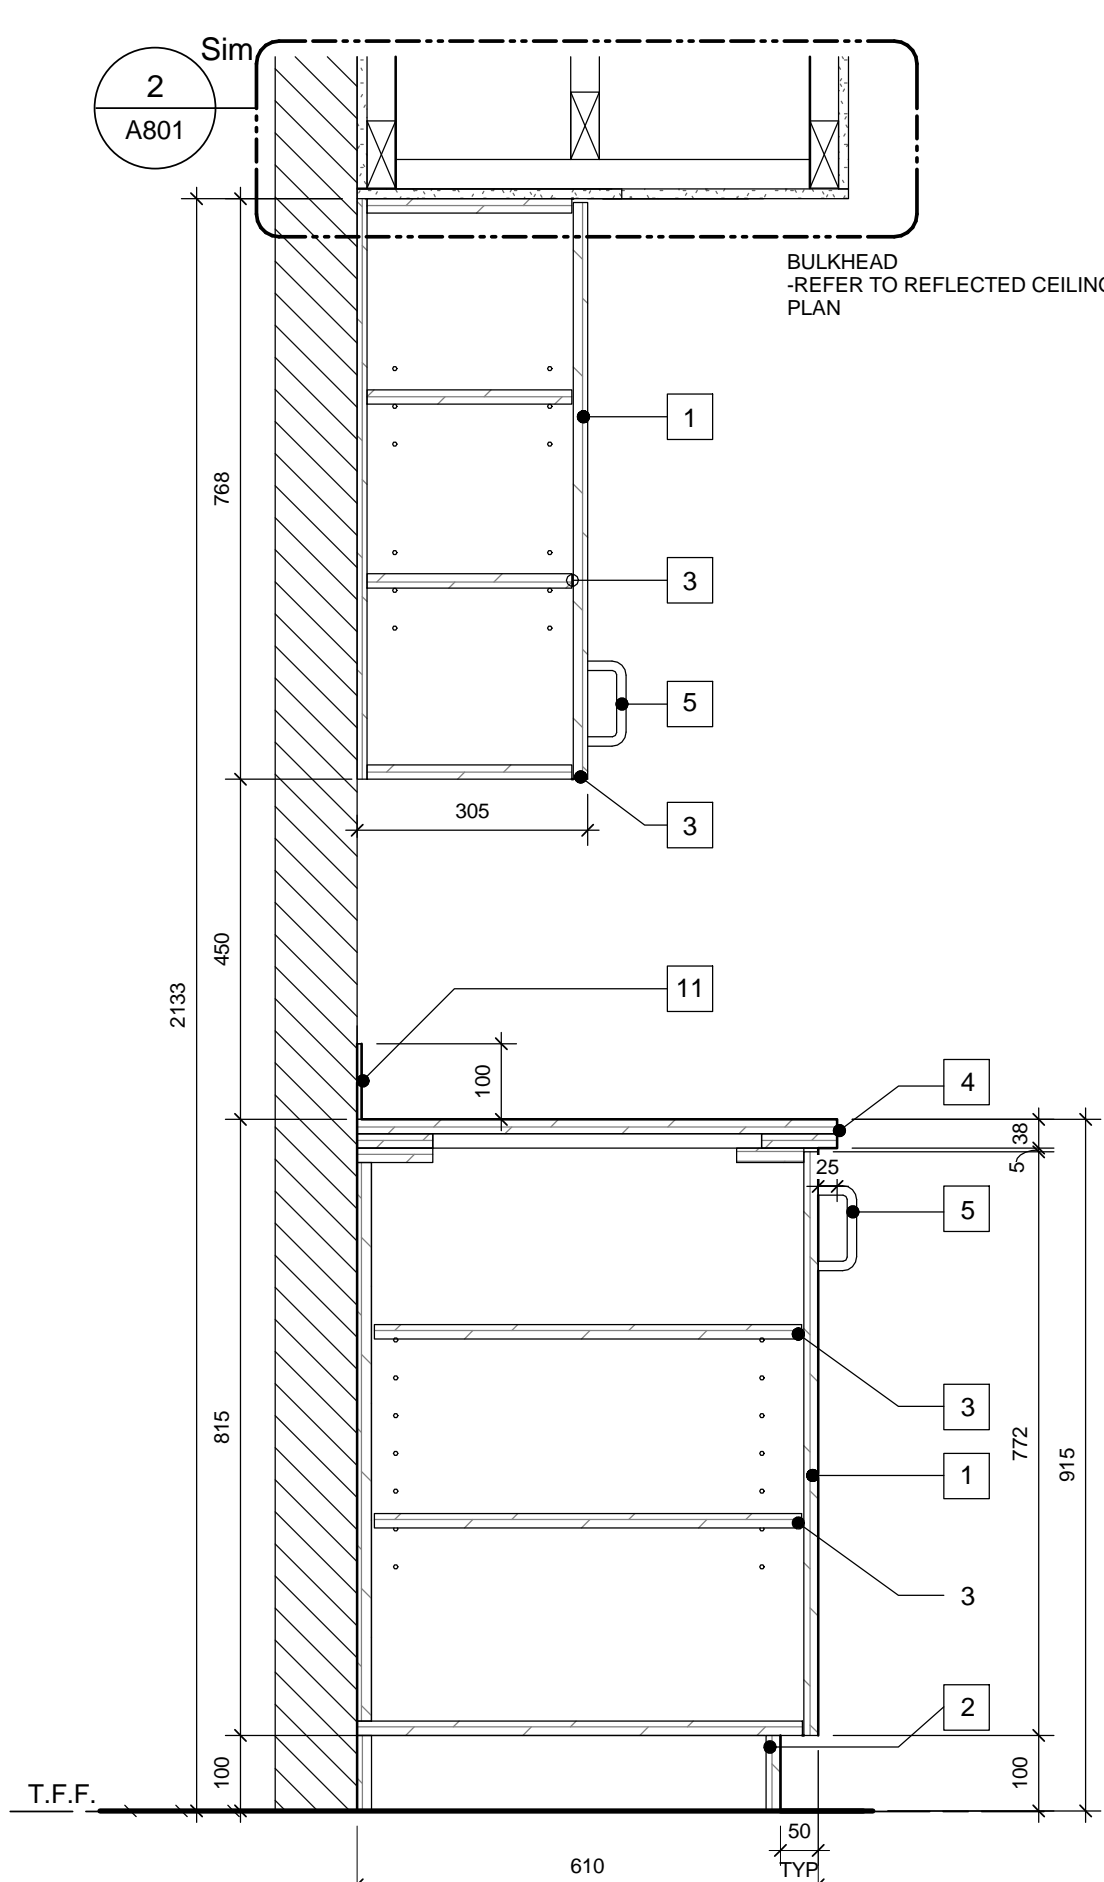

12 Typical Kitchen Upper & Base Cabinets Section Detail
A907 Scale: 1 : 10

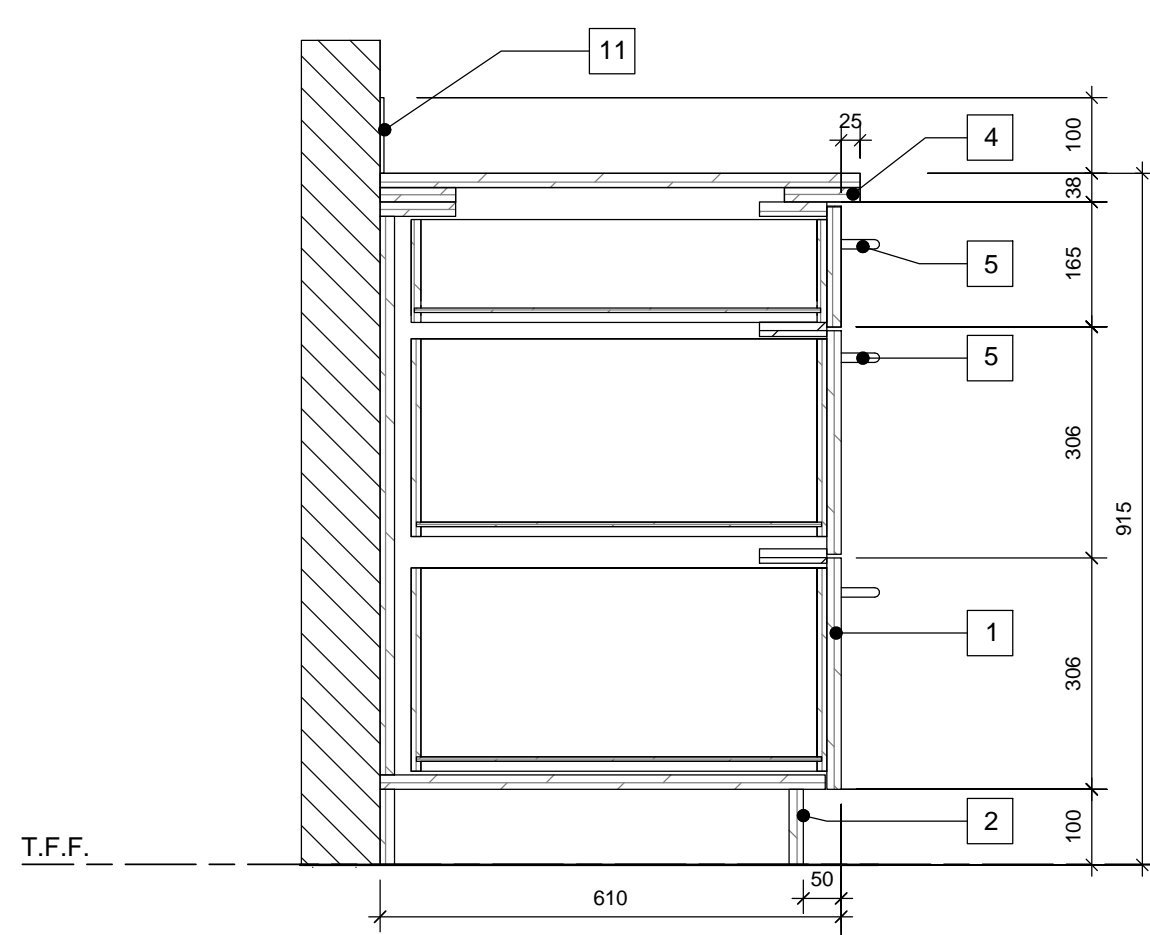

4 Typical Kitchen Base Drawer Cabinet Section
A907 Scale: 1 : 10

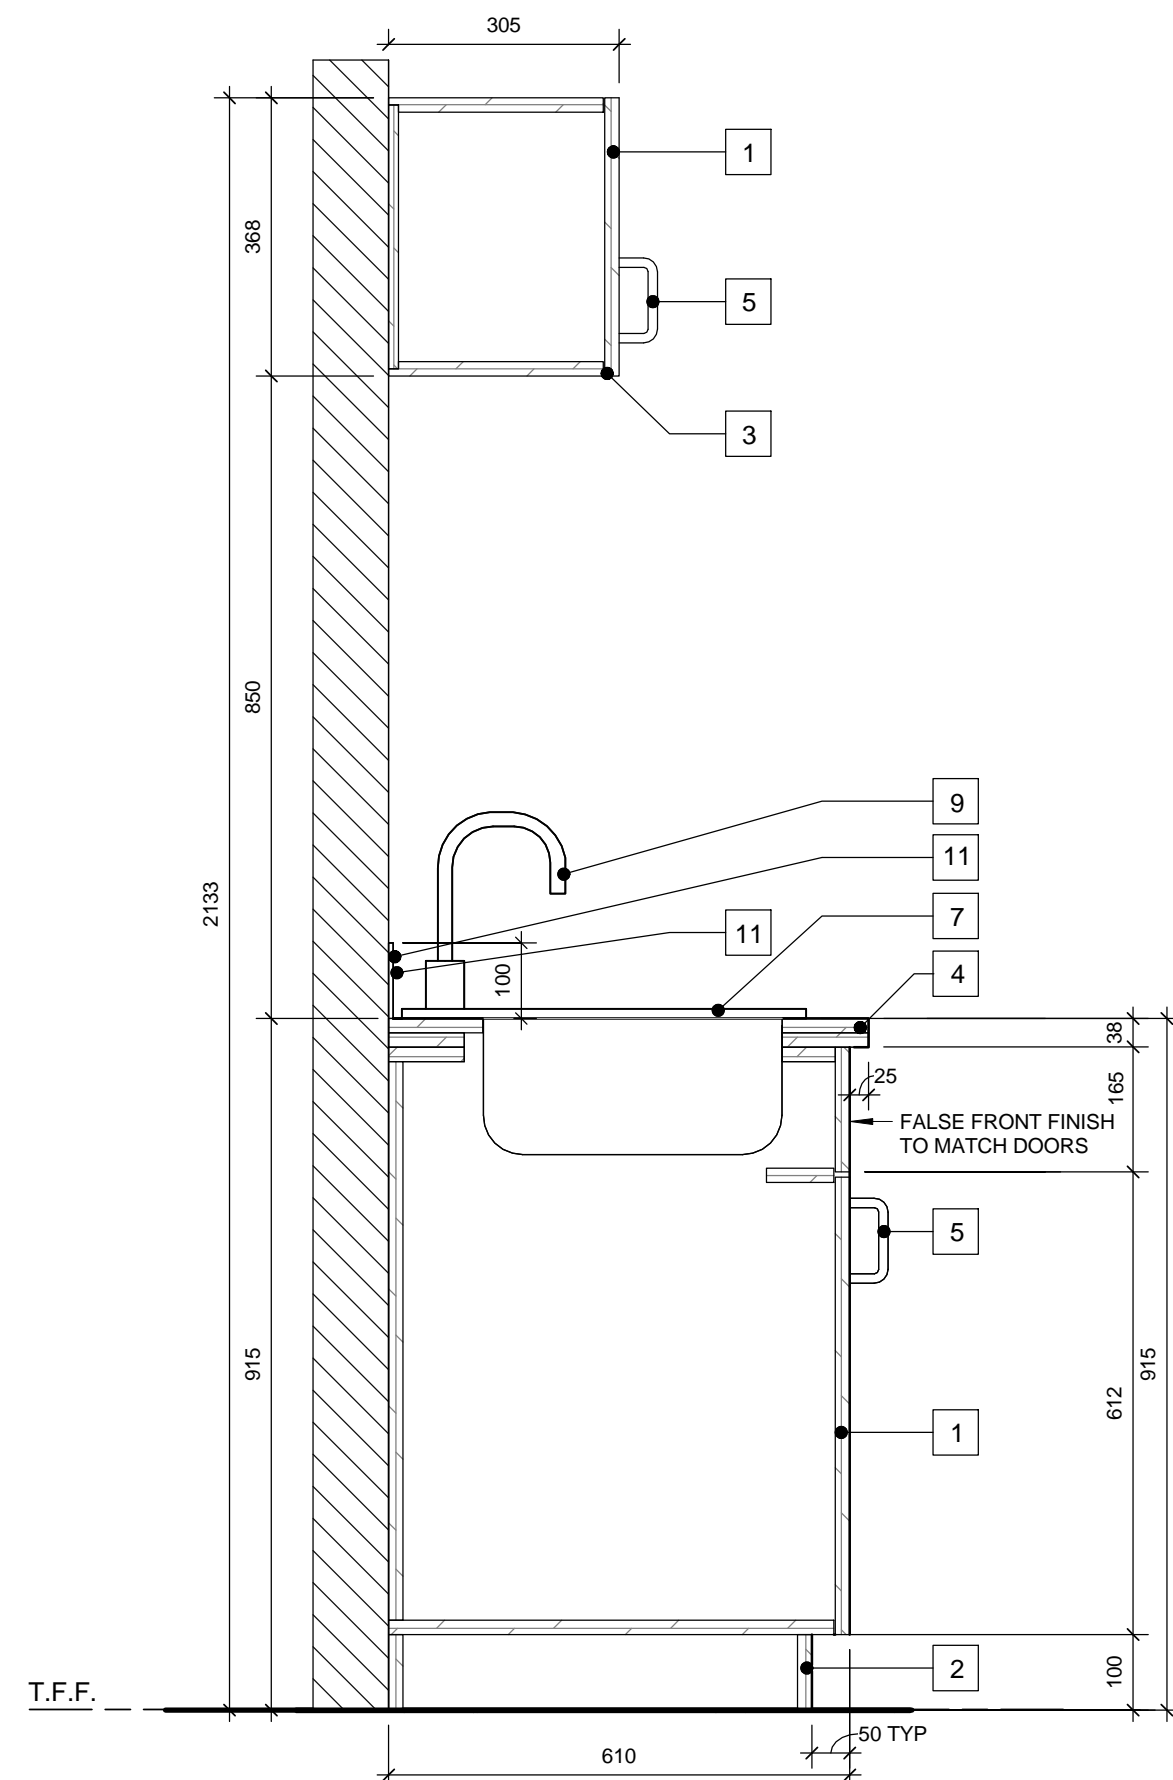

13 Typical Kitchen Upper & Base Sink Cabinets Section Detail
A907 Scale: 1 : 10

MILLWORK LEGEND	
1	-DOOR
2	- 19mm PLYWOOD TOEKICK
3	-ADJUSTABLE SHELVES
4	-PLYWOOD COUNTER, PLASTIC LAMINATE APPLIED TO ALL EXPOSED EDGES
5	-DRAWER/DOOR PULLS
6	- 200mm X 200mm X 38mm THICK ANGLED SHELF SUPPORT, PT. FINISH TO MATCH WALL TRIM
7	- DOUBLE SINK - REFER TO MECHANICAL
8	- SINGLE VANITY SINK - REFER TO MECHANICAL
9	- KITCHEN FAUCET - REFER TO MECHANICAL
10	- BATHROOM FAUCET - REFER TO MECHANICAL
11	- TILE BACKSPLASH, REFER TO INTERIOR FINISH SCHEDULE
12	- STRETCHER, FINISH EXPOSED EDGES TO MATCH CABINET FINISH

MILLWORK NOTES:	
-SITE VERIFY ALL DIMENSIONS PRIOR TO CABINET CONSTRUCTION	
-ALL EXPOSED EDGES TO MATCH CABINET FINISH, EDGE MATERIAL AS PER SPECIFICATION.	

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No.	Date/Date	Description/Description	Drawn by Dessiné par	Approved Approuvé
3	2016-12-08	ISSUED FOR TENDER		
2	2016-12-08	ISSUED FOR BUILDING PERMIT		
1	2016-09-02	ISSUED FOR 99% REVIEW		

Revision / Revision	
A	detail number numero de detail
B	source drawing no. de dessin no.
C	detail on drawing no. detail sur dessin no.
Consultant's Name Nom de l'expert-conseil	
Eng. Stamp Sceau de l'ingénieur	
IBI GROUP Suite 500 - 611 Meredith Road NE Calgary Alberta T2E 2W5 T: (403) 270-5600 F: (403) 270-5610 ibigroup.com	

Public Works and Government Services Canada	Travaux publics et Services gouvernementaux Canada
Client Services Team Southern Alberta Operations Branch	Le Client Entretien l'Équipe Alberta Méridional Branche d'Opérations


Canada

Client/client	Parks Canada Agence	L'Agence Parcs Canada
	Western and Northern Region	Ouest et Nord du Canada

Project title/Titre du projet
**Staff Housing Phase 2
Waterton Lakes National
Park**

Drawing title/Titre du dessin
**CABINET/INTERIOR SECTIONS
& DETAILS**

Surveyed by/Arpenté par	Drawn by/Dessiné par	Date/Date
AG	AG	2016-12-08
Designed by/Concept par	Reviewed by/Revisé par	Scale/Echelle
LS/FVR	LS/FVR	As indicated
PWGSC Project Manager/Administrateur de Projets TPSCG Randy Boldt		
Client Acceptance/Acceptation du client		Approved by/Approuvé par
Task Responsible/Officer/Agent Responsable		Task Manager/Superviseur de Projets TPSCG
Project No./No. du projet	Asset No./No. d'actif	Sheet No./ No. de la feuille
39000	Fil # 945	A907
Drawing Reference No./No. de référence du dessin		

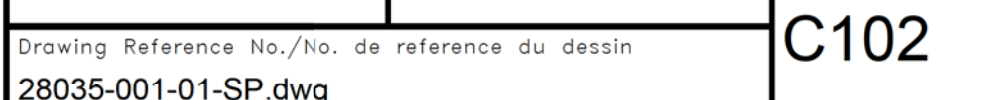

PERMIT TO PRACTICE
MPE ENGINEERING LTD.
PERMIT NUMBER: P 3680
The Association of Professional
Engineers and Geoscientists of Alberta



GENERAL NOTES:

- THESE DETAILS SHALL BE READ IN CONJUNCTION WITH ALL APPLICABLE OWNER STANDARD DETAILS. INFORM THE ENGINEER IMMEDIATELY UPON DISCOVERY OF POTENTIAL CONFLICTS WITH OWNER STANDARDS.
- ALL DIMENSIONS ARE IN MILLIMETERS.
- PIPE DIAMETERS ARE IN MILLIMETERS.
- PROPOSED UNDERGROUND UTILITIES TO BE INSULATED, TO BE CONFIRMED BY CLIENT.
- EXISTING INFORMATION IS BASED ON UTM GRID NAD 83 COORDINATES

SEWER SYSTEM NOTES:

- SEWERS SHALL BE DESIGNED, PROCURED, INSTALLED, INSPECTED, AND TESTED IN ACCORDANCE WITH THE SPECIFICATIONS.
- PIPE, MANHOLES, CATCHBASINS, RIMS, FRAMES, GRATES, AND ALL OTHER APPURTENANCES SHALL BE IN ACCORDANCE WITH LIST OF APPROVED PRODUCTS.
- MANHOLES SHALL BE "TYPE 5A" SRC UNLESS NOTED OTHERWISE.
- MANHOLE BENCHING SHALL BE CONSTRUCTED AS PER THE DETAILS.
- MINIMUM COVER OVER STORM AND SANITARY MAINS AND SERVICES SHALL BE 1.20m AND 2.50m RESPECTIVELY. FOR SEWERS WITH LESS THAN THE MINIMUM SPECIFIED COVER PROVIDE INSULATION.

WATER SYSTEM NOTES:

- POTABLE WATER INFRASTRUCTURE SHALL BE DESIGNED, PROCURED, INSTALLED, INSPECTED, AND TESTED IN ACCORDANCE WITH THE SPECIFICATIONS.
- PIPE, VALVES, HYDRANTS, AND ALL OTHER APPURTENANCES SHALL BE IN ACCORDANCE WITH THE LIST OF APPROVED PRODUCTS.
- WATER PIPES LESS THAN OR EQUAL TO 100mm DIAMETER SHALL BE DR14 PVC UNLESS NOTED OTHERWISE.
- A 2.3 kg ZINC ANODE FOR CATHODIC PROTECTION SHALL BE PROVIDED FOR METALLIC ELEMENTS OF THE WATER SYSTEM.
- MINIMUM COVER OVER WATER MAINS AND SERVICES SHALL BE 2.70m AND 3.00m FOR CLAY AND GRAVEL SOILS RESPECTIVELY. FOR WATER PIPES WITH LESS THAN THE MINIMUM SPECIFIED COVER PROVIDE INSULATION.

6	2016-12-08	ISSUED FOR TENDER	S.D.H.	T.A.C.
5	2016-12-08	ISSUED FOR BUILDING PERMIT	S.D.H.	T.A.C.
4	2016-09-02	ISSUED FOR 99% REVIEW	S.D.H.	T.A.C.
3	2016-08-12	ISSUED FOR COORDINATION	S.D.H.	T.A.C.
2	2016-06-14	ISSUED FOR 66% REVIEW	S.D.H.	T.A.C.

No.	Date/Date	Description/Description	Drawn by Dessiné par	Approved Approuvé
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Revision / Révision	
A	detail number numero de detail
B	source drawing no. de dessin no.
C	detail on drawing no. detail sur dessin no.

Consultant's Name
Nom de l'expert-conseil

**MPE**
Engineering Ltd.



Public Works and
Government Services
Canada


Travaux publics et
Services gouvernementaux
Canada

Client Services Team
Southern Alberta
Operations Branch

Le Client Entretien et l'équipe
Alberta Méridionale
Branche d'Opérations

Canada

Client/client

Parks Canada
Agency

L'Agence Parcs
Canada

Western and
Northern Region

Ouest et Nord
du Canada

Project title/Titre du projet

Staff Housing Phase 2 Waterton Lakes National Park

Drawing title/Titre du dessin

STAFF HOUSING GRADING PLAN DETAIL SHEET


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Designed by/Concept par	Reviewed by/Révisé par	Scale/Echelle
SDH/TAC	TAC	As indicated

PWGSC Project Manager/Administrateur de Projets TP50C

Client Acceptance/Acceptation du client Approved by/Approuvé par

Perk Responsible Officer/Agent Responsable		Perk Project Manager/Administrateur de Projets TP50C
Project No./No. du projet	Asset No./No. du bien	Sheet No./ No. de la feuille
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PERMIT TO PRACTICE
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PERMIT NUMBER: P 3680
The Association of Professional
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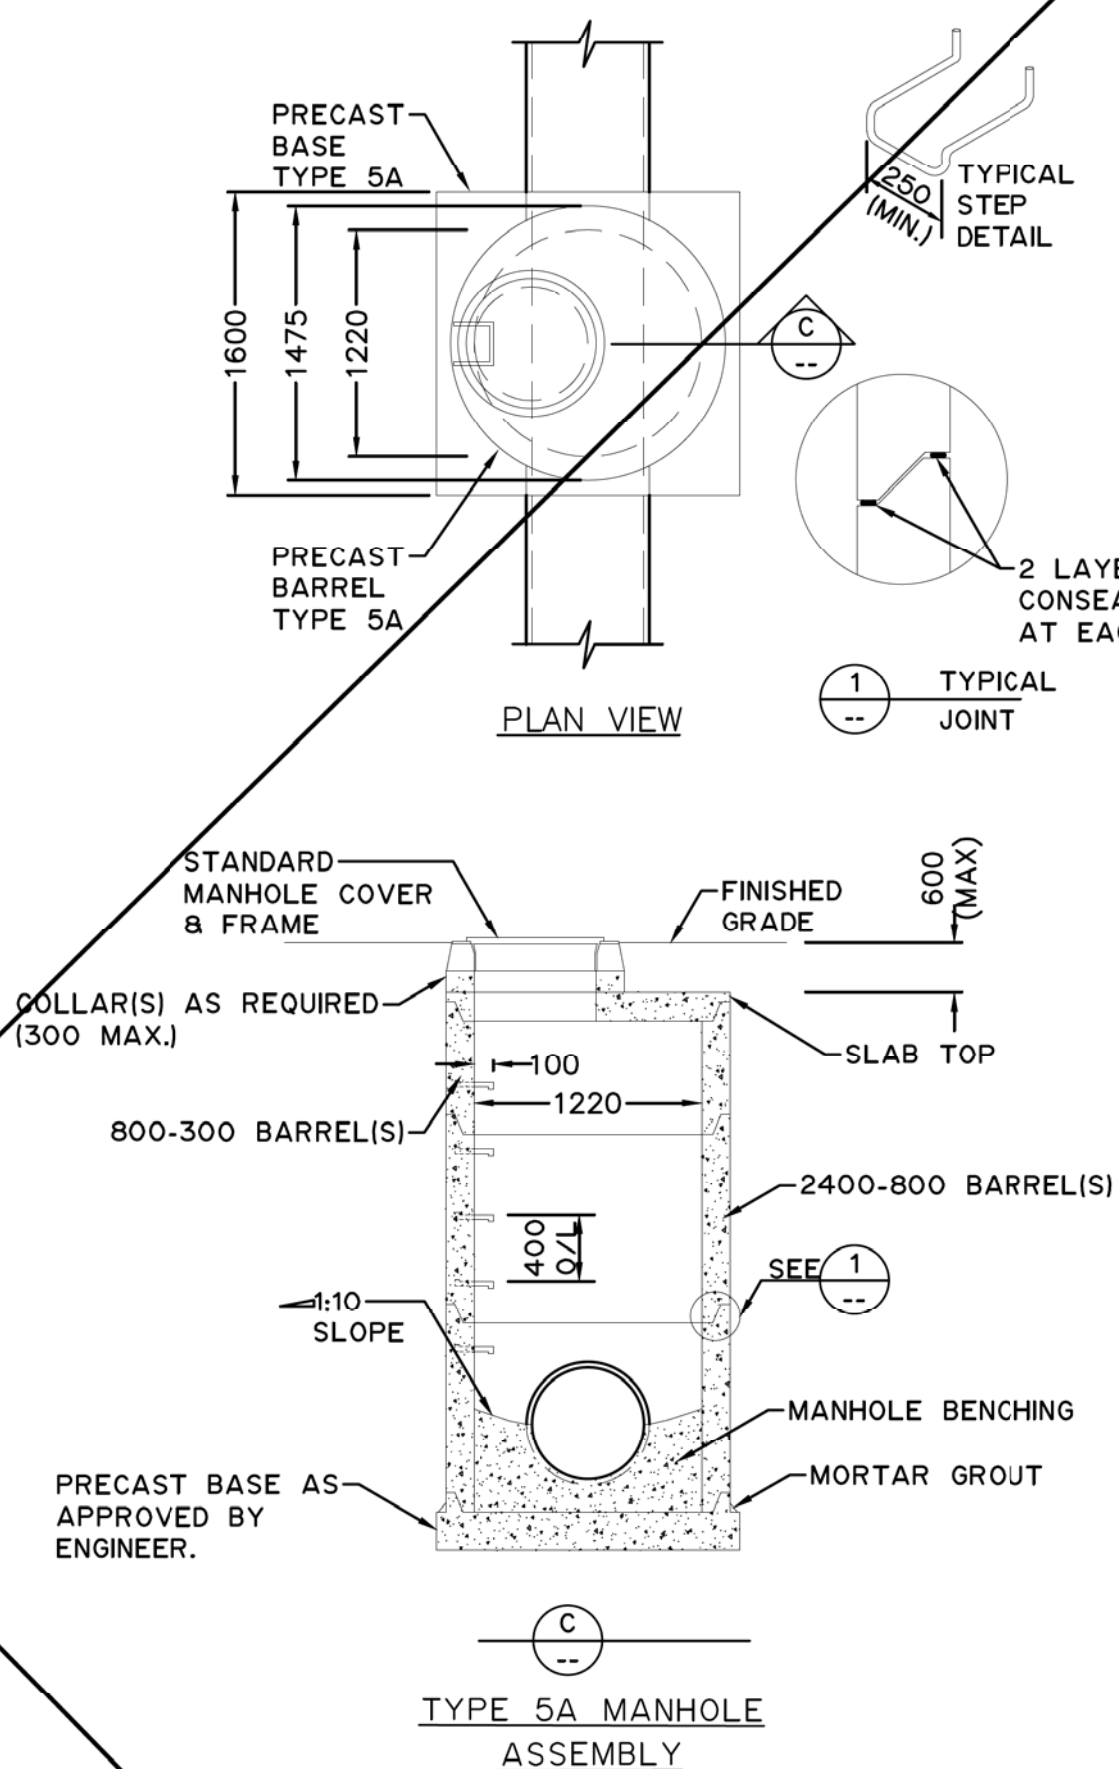


TYPICAL THRUST BLOCK LOCATIONS

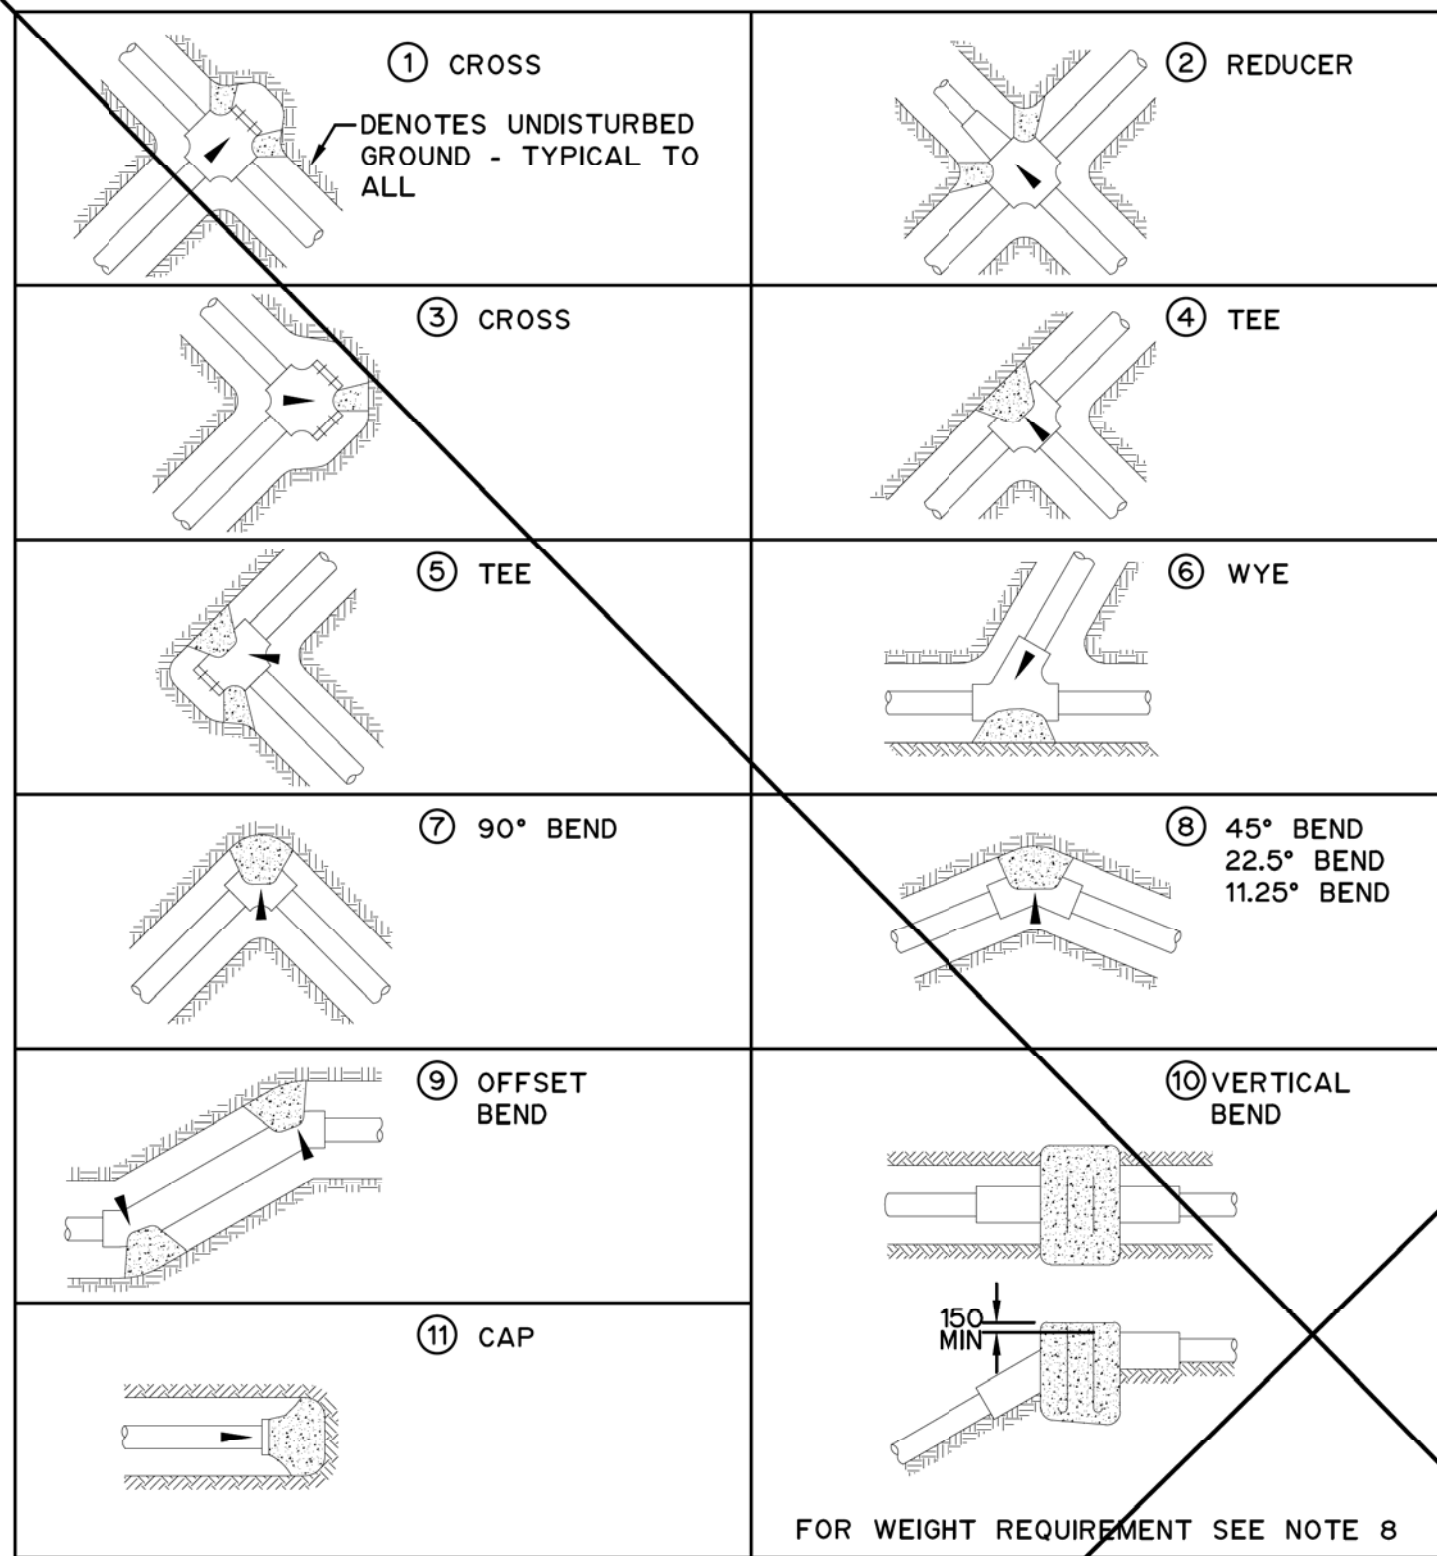BEARING AREA OF BLOCKS						
CONCRETE AREAS IN SQUARE METRES						
TYPE OF FITTING	PIPE SIZE (mm)					
	100	150	200	250	300	400
1,4,11	0.2	0.4	0.7	1.0	1.4	1.9
3,5,7	0.3	0.5	0.9	1.4	2.0	2.7
2	-	-	-	0.5	0.7	1.6
6,8,10	0.2	0.3	0.5	0.6	1.1	1.4
9	0.3	0.6	1.0	1.2	2.2	2.9

DEAD WEIGHT IN CUBIC METRES OF CONCRETE (m³)					
DEGREE OF BEND	SIZE OF BEND (mm)				
	100	150	200	250	400
90°	0.8	1.5	2.7	4.2	10.7
45°	0.4	1.1	1.5	2.3	5.7
22 1/2°	0.4	0.8	0.9	1.1	3.1
11 1/4°	0.4	0.4	0.5	0.8	1.5

THRUST BLOCK DATA




TYPE 5A MANHOLE
ASSEMBLY


NOTE:
- REFER TO NOTES

NOTES:


- DESIGN ASSUMPTION
a) HYDRAULIC PRESSURE 1.38 MPa (200 psi)
b) SOIL BEARING 100 kPa (2000 lbs/ft²)
MEDIUM SOFT CLAY
- CONCRETE SHALL BE SULPHATE RESISTANT.
- TEMPORARY BLOCKING MUST BE APPROVED BY THE ENGINEER
- 2 PLY OF 0.15mm (6 MIL) POLYETHYLENE SHALL BE PLACED BETWEEN PIPE AND CONCRETE
- CONCRETE SHALL BE 20 MPa at 28 DAY STRENGTH, MAXIMUM SLUMP 75mm.
- THRUST BLOCKS AS PER STD. SPEC. SECTION 33 11 16.
- IN DISTURBED GROUND (COMPACTED BACK FILL) INCREASE BEARING AREA BY 50%
- DEAD WEIGHT REACTION BLOCK REQUIREMENTS FOR VERTICAL BENDS (BASED ON 1380 kPa PRESSURE) SHALL BE AS FOLLOWS:

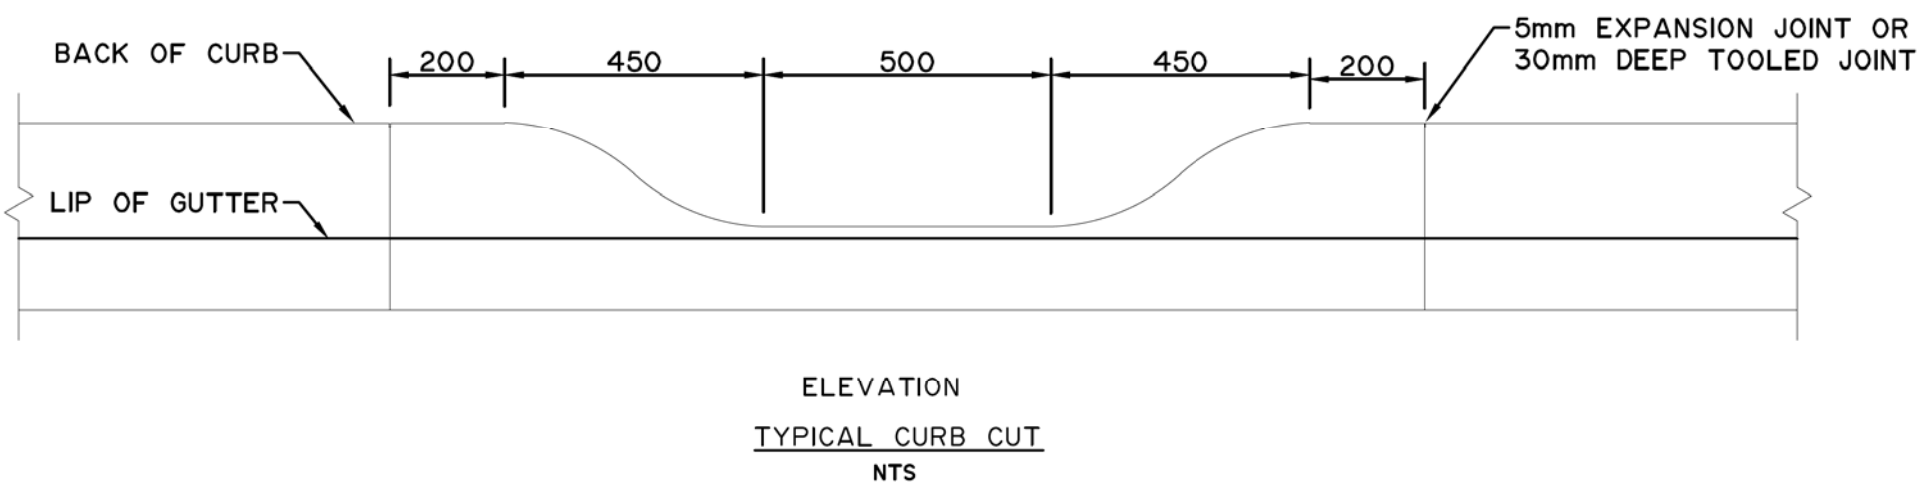


ELEVATION
TYPICAL CURB CUT
NTS

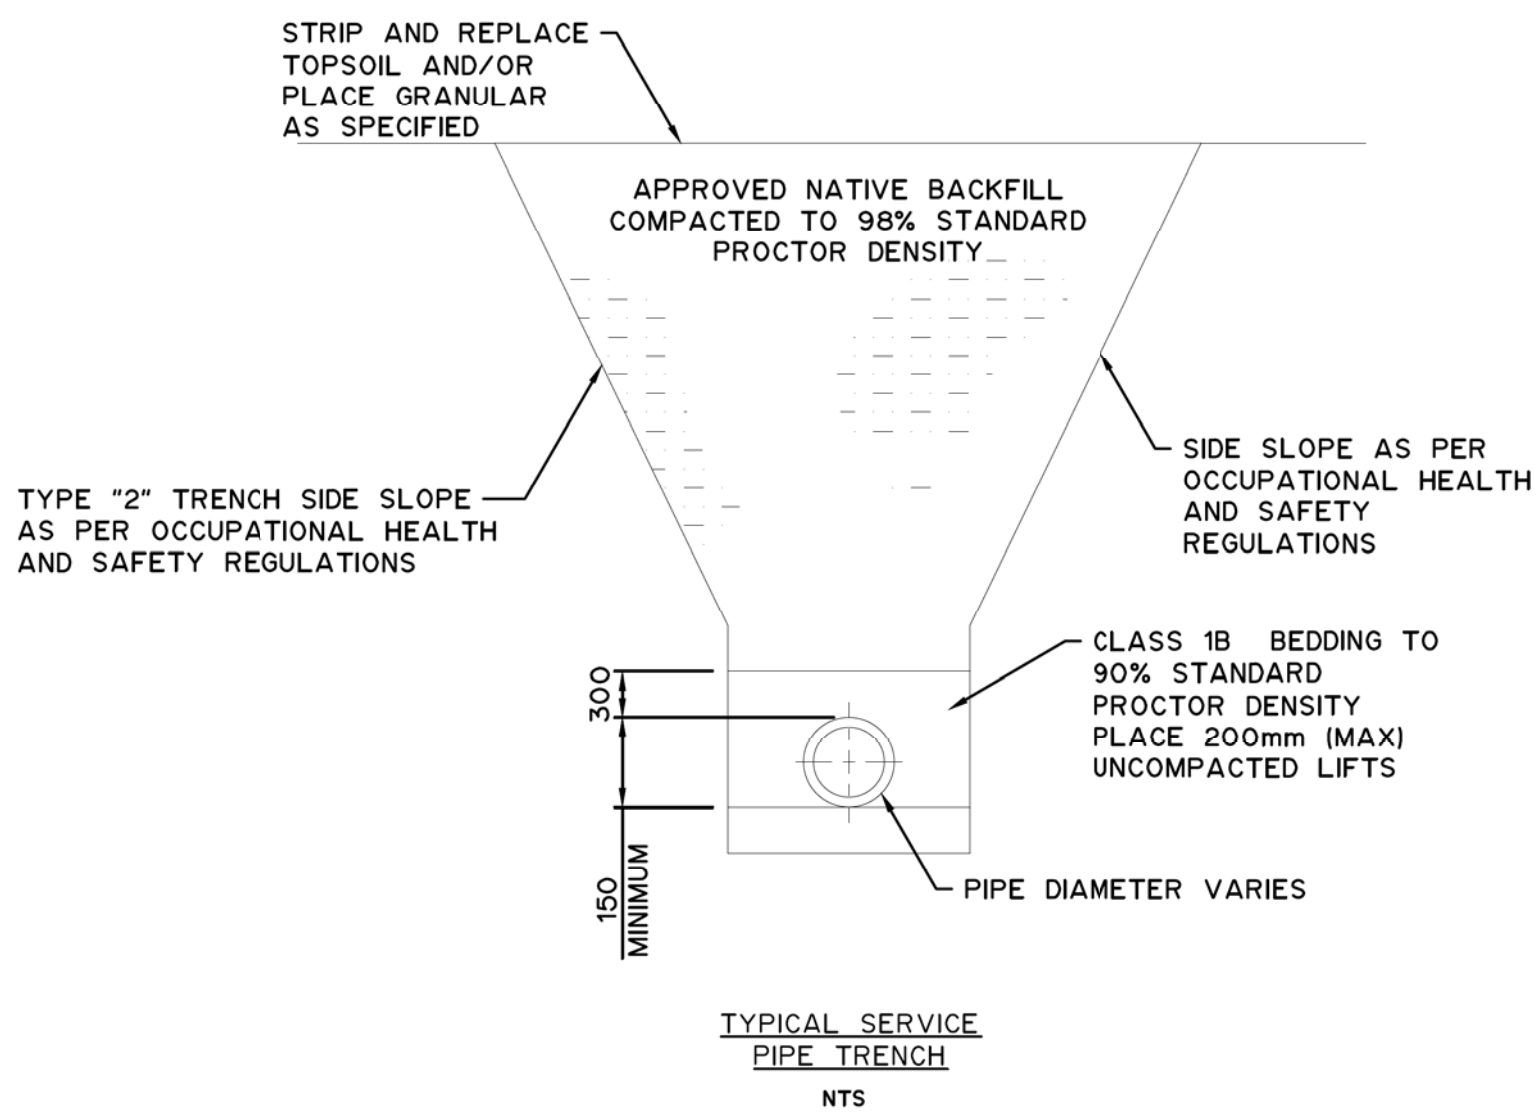

TYPICAL SERVICE
PIPE TRENCH
NTS

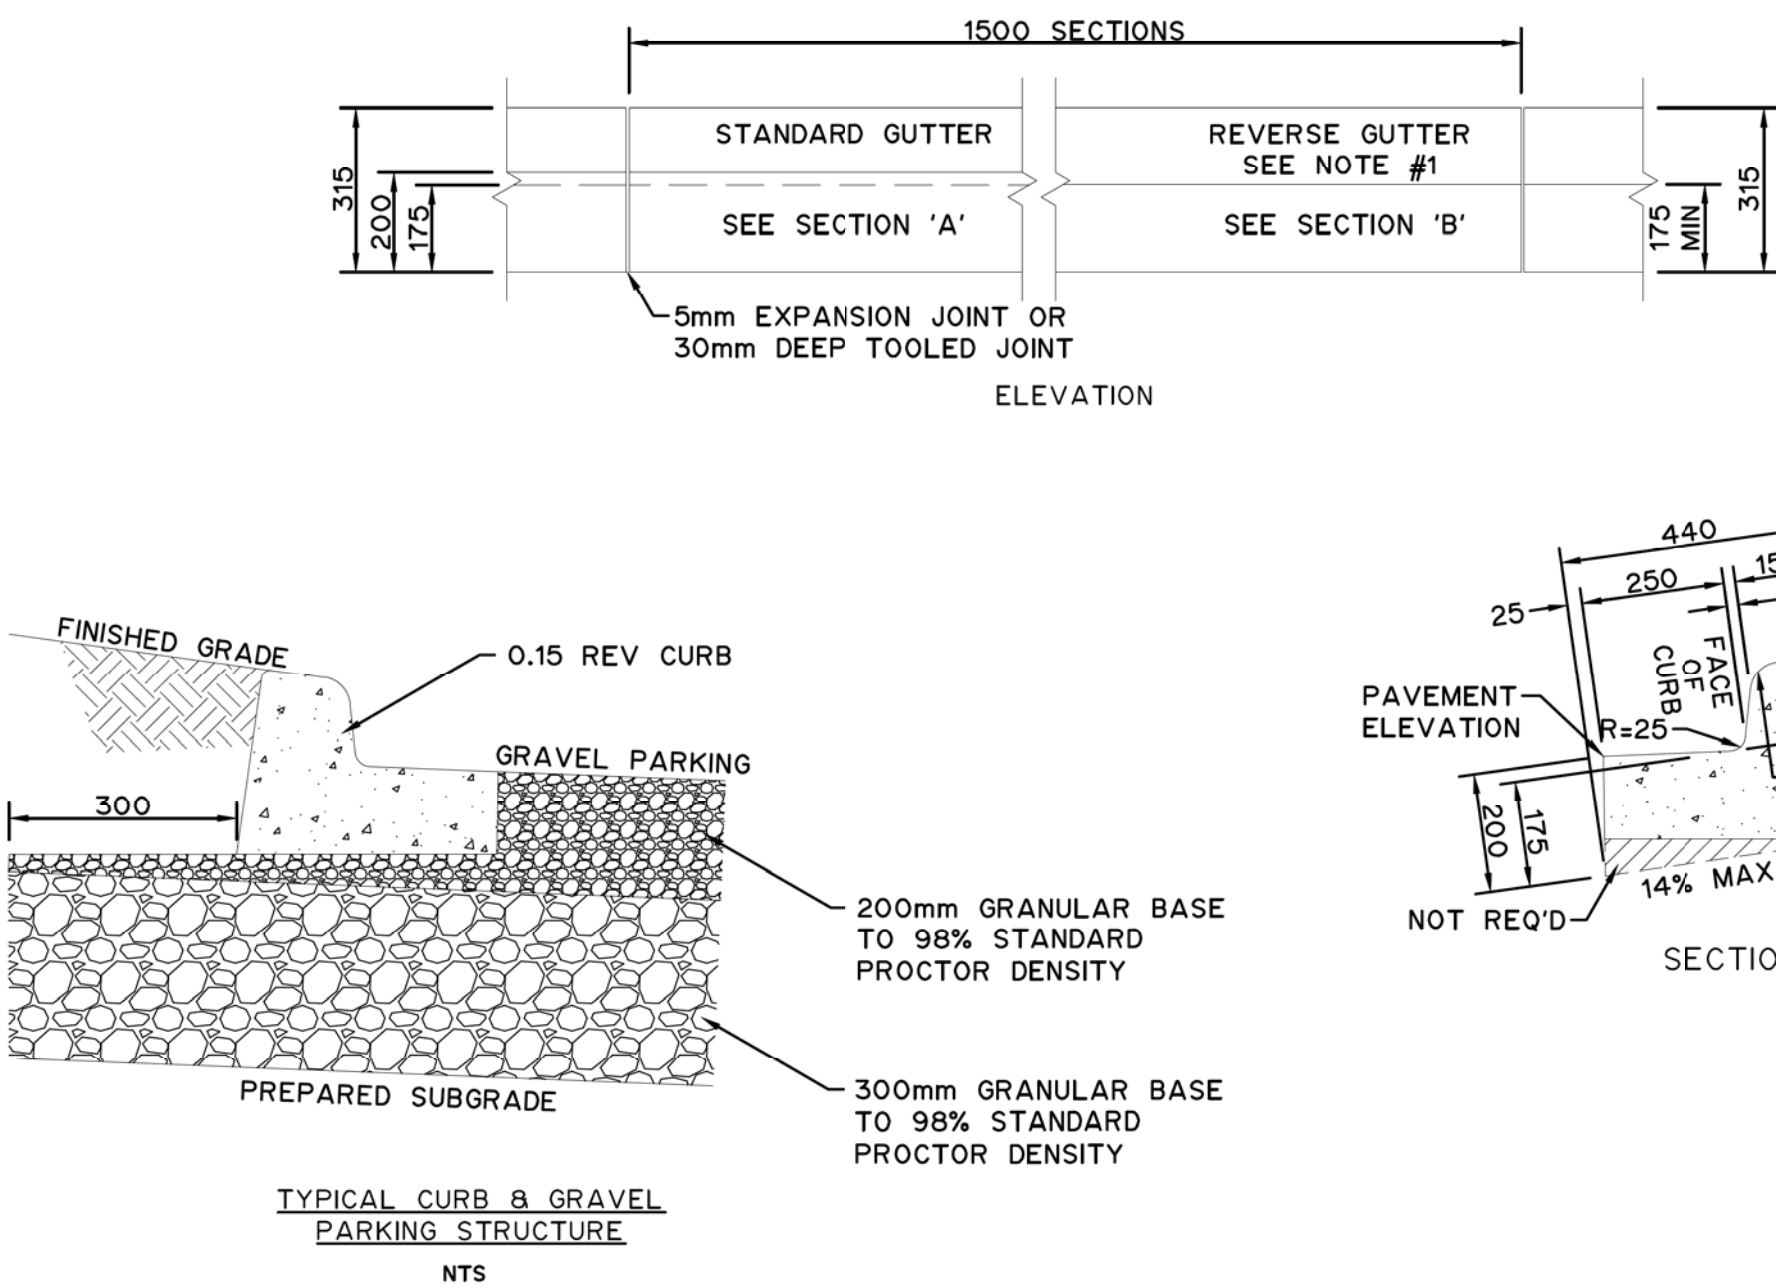

TYPICAL CURB & GRAVEL
PARKING STRUCTURE
NTS

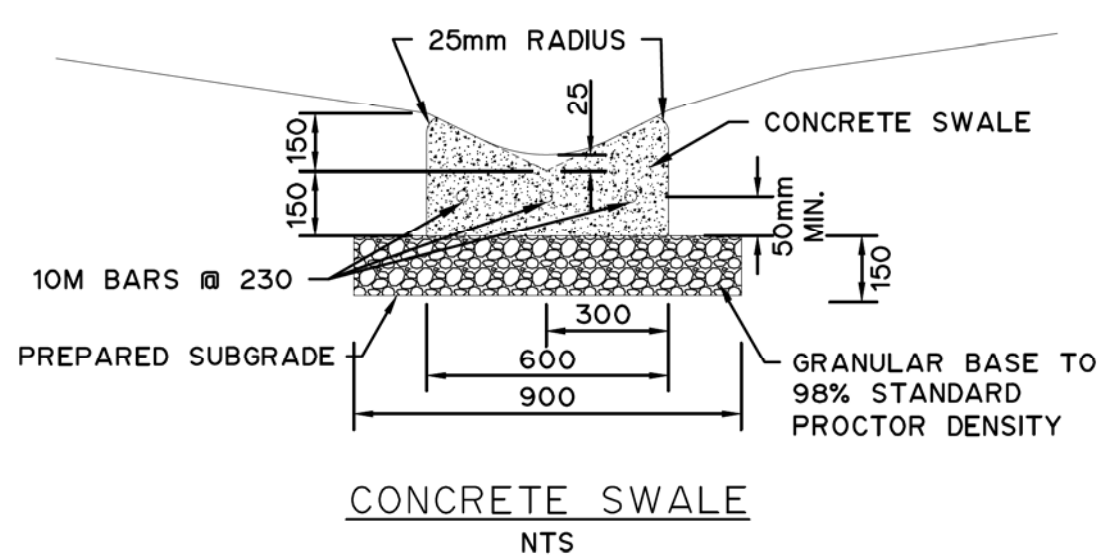

CONCRETE SWALE
NTS

- MATERIAL SPECIFICATIONS:**
- CONCRETE AS SET OUT UNDER SECTION 403.10.08
 - REINFORCING STEEL TO BE DEFORMED BARS $f_y=400MPa$ (CONFORM TO C.S.A. SPEC G30.18 - LATEST EDITION).
 - COVERING FOR REINFORCING STEEL SHALL BE 50mm.
 - ALL LAPS SHALL BE 30 BAR DIAMETERS. ALL LAPS MUST BE TIED SECURELY.
 - REINFORCING BARS TO BE EXTENDED INTO CURB, GUTTER AND SIDEWALK.
 - REINFORCEMENT OR FIBRE CONCRETE (OPTIONAL) - FIBRE CONCRETE SPECIFICATION - SEE ROADS CONSTRUCTION SPEC. (MOST RECENT VERSION) SECTION 310.01.04.
 - CONSTRUCTION JOINTS AS PER ROADS CONSTRUCTION SPEC.- JOINT DETAILS #454.1015.006

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A. GENERAL

1.

THE STRUCTURE IS TO BE BUILT IN ACCORDANCE WITH THE REQUIREMENTS OF THE NATIONAL BUILDING CODE OF CANADA 2015 (NBC), AND ANY APPLICABLE REQUIREMENTS OR BY LAWS OF THE AUTHORITY HAVING JURISDICTION.
2.

WHERE DOCUMENTS ARE REFERENCED IN THE GENERAL AND DESIGN NOTES, THEY SHALL BE THE LATEST EDITIONS OR REVISION, UNLESS NOTED OTHERWISE.
3.

READ STRUCTURAL DRAWINGS AND SPECIFICATIONS IN CONJUNCTION WITH ALL OTHER CONTRACT DOCUMENTS.
4.

BEFORE PROCEEDING WITH WORK, CHECK THE DIMENSIONS SHOWN ON THE STRUCTURAL DRAWINGS AGAINST ALL OTHER DRAWINGS AND REPORT DISCREPANCIES TO THE CONSULTANT. DO NOT SCALE THE DRAWINGS.
5.

REFER TO THE ARCHITECTURAL AND OTHER DRAWINGS FOR LOCATIONS AND SIZES OF PITS, BASES, HOUSEKEEPING PADS, SUMPS, TRENCHES, DEPRESSIONS, GROOVES, CURBS, CHAMFERS, SLOPES, OPENINGS AND SLEEVES NOT SHOWN ON THE STRUCTURAL DRAWINGS. OBTAIN THE CONSULTANT'S PRIOR APPROVAL BEFORE INSTALLING OPENINGS, SLEEVES, ETC. WHICH ARE NOT SHOWN ON STRUCTURAL DRAWINGS.
6.

THE STRUCTURE HAS BEEN DESIGNED FOR THE LOADS SHOWN. ENSURE THEY ARE NOT EXCEEDED DURING CONSTRUCTION.
7.

TYPICAL STRUCTURAL DETAILS SHALL GOVERN THE WORK. IF DETAILS DIFFER ON OTHER DRAWINGS, THE MOST STRINGENT SHALL GOVERN. IN SOME TYPICAL DETAILS, PORTIONS OF THE STRUCTURE HAVE BEEN CUT BACK OR REMOVED FOR CLARITY PURPOSES ONLY. REFER TO PLANS AND SECTIONS FOR ACTUAL CONDITIONS.
8.

THE GENERAL CONTRACTOR IS TO COORDINATE WITH THE STRUCUTRAL STEEL TRADE AND THE WOOD FRAMER TRADE TO MINIMIZE THE POTENTIAL AFFECTS FROM DIFFERENTIAL SHRINKAGE. PROTECT ALL WOOD ELEMENTS DUE TO WETTING DURING STORAGE AND INSTALLATION. DRY WOOD PRIOR TO INSTALLING SHEATHING.
9.

CONTRACT ADMINISTRATION BY ENTUITIVE
- A.

ENTUITIVE HAS BEEN RETAINED TO PROVIDE CONTRACT ADMINISTRATION SERVICES FOR THE PROJECT. THESE SERVICES INCLUDE FIELD REVIEW, REVIEW OF SHOP DRAWINGS, ATTENDANCE AT SITE MEETINGS DURING THE CONSTRUCTION OF THE STRUCTURAL WORK, RESPONSE TO SITE GENERATED QUESTIONS, CLARIFICATIONS, RFI'S, AS WELL AS ADDITIONAL ACTIVITIES ASSOCIATED WITH THE ADMINISTRATION OF THE CONSTRUCTION CONTRACT.
- B.

FIELD REVIEW:
- i

ENTUITIVE WILL CARRY OUT PERIODIC FIELD REVIEWS OF THE WORK SHOWN ON THE STRUCTURAL CONTRACT DOCUMENTS ONLY. THESE REVIEWS WILL BE PERFORMED ON BEHALF OF THE OWNER TO DETERMINE WHETHER THE CONSTRUCTION IS BEING CARRIED OUT IN GENERAL CONFORMITY WITH THE CONTRACT DOCUMENTS. THE CONTRACTOR IS SOLELY RESPONSIBLE FOR ENSURING THAT THE WORK IS COMPLETED IN CONFORMANCE WITH THE CONTRACT DOCUMENTS AND ALL APPLICABLE CODES, STANDARDS AND ACTS.
- ii

THE CONTRACTOR IS NOT TO CONSTRUE THESE REVIEWS AS BEING PART OF OR IN LIEU OF THEIR OWN FIELD REVIEW OF THE WORK BEING CARRIED OUT ON SITE.
- iii

THE EXTENT AND NATURE OF THE WORK REVIEWED ON SITE IS AT THE SOLE DISCRETION OF ENTUITIVE'S SITE REPRESENTATIVE. THE WORK WILL BE REVIEWED ON A SAMPLING BASIS.
- iv

THE GENERAL CONTRACTOR IS TO PROVIDE A MINIMUM OF 48 HOURS ADVANCE NOTICE WHEN A PARTICULAR ASPECT OF THE WORK IS READY FOR REVIEW. THE WORK TO BE REVIEWED SHALL BE GENERALLY COMPLETE, PRIOR TO ENTUITIVE'S SITE REPRESENTATIVE VISITING THE SITE.
- C.

SHOP DRAWING REVIEW:
- i

ENTUITIVE'S REVIEW OF SHOP DRAWINGS IS CARRIED OUT ON A RANDOM SAMPLING BASIS. AS SUCH, NOT ALL SHOP DRAWINGS ARE REVIEWED NOR IS ALL OF THE INFORMATION ON ANY PARTICULAR SHOP DRAWING REVIEWED BY ENTUITIVE.
- ii

REVIEW OF SHOP DRAWINGS IS ONLY FOR GENERAL CONFORMITY WITH THE CONTRACT DOCUMENTS. THE REVIEW OF SHOP DRAWINGS DOES NOT RELIEVE THE CONTRACTOR OF ANY OF THEIR CONTRACTUAL RESPONSIBILITIES, NOR DOES IT RELIEVE THE CONTRACTOR OF THEIR RESPONSIBILITIES TO ENSURE THE SHOP DRAWINGS ARE COMPLETE, COORDINATED WITH THE WORK OF ALL OTHER TRADES AND FREE OF ERRORS. THE CONTRACTOR IS SOLELY RESPONSIBLE FOR ENSURING THAT INFORMATION SHOWN ON THE SHOP DRAWINGS INCLUDING BUT NOT LIMITED TO: MEMBER SIZES, QUANTITIES, DIMENSIONS, EXISTING SITE CONDITIONS, FABRICATION PROCESSES, MEANS AND METHODS OF CONSTRUCTION AND THE LIKE ARE CORRECT, CONSISTENT WITH THE REQUIREMENTS OF THE CONTRACT DOCUMENTS AND ARE COORDINATED WITH THE WORK OF ALL OTHER TRADES.
- iii

ALL SHOP DRAWINGS ARE TO BE REVIEWED BY THE GENERAL CONTRACTOR PRIOR TO BEING SUBMITTED TO ENTUITIVE. THE GENERAL CONTRACTOR'S REVIEWED STAMP SHALL BE AFFIXED TO ALL SHOP DRAWINGS SUBMITTED TO ENTUITIVE FOR REVIEW
- iv

SHOP DRAWINGS ARE TO BE SEALED AND SIGNED BY A PROFESSIONAL ENGINEER AS REQUIRED BY THE CONTRACT DOCUMENTS. ANY SHOP DRAWINGS SUBMITTED WITHOUT THE PROFESSIONAL ENGINEER'S SEAL AND SIGNATURE (WHERE REQUIRED) WILL BE RETURNED "UNREVIEWED" AND MARKED FOR RESUBMISSION.
- v

COMMENTS MADE ON SHOP DRAWINGS ARE NOT TO BE CONSTRUED AS INSTRUCTIONS OR AUTHORIZED CHANGES TO THE CONTRACT DOCUMENTS. IF THE GENERAL CONTRACTOR BELIEVES THAT COMMENTS MADE ON THE SHOP DRAWINGS WILL RESULT IN CHANGES TO THE CONTRACT, THEY ARE TO NOTIFY THE CONSULTANT OF THIS PRIOR TO UNDERTAKING THE WORK
- vi

SHOP DRAWINGS WILL BE PROCESSED WITHIN THE TIME FRAMES NOTED IN THE CONTRACT DOCUMENTS UNLESS OTHER ARRANGEMENTS ARE MADE IN ADVANCE OF THE SUBMISSION OF THE SHOP DRAWINGS.
- D.

RESPONSE TO RFI'S:
- i

RFI'S WILL BE PROCESSED IN A TIMELY MANNER , PROVIDED THE TIME FRAMES IDENTIFIED ARE REASONABLE AND CONSISTENT WITH THE URGENCY OF THE REQUIRED RESPONSE.
- ii

THE EXTENT OF ANY PARTICULAR RFI SHALL BE LIMITED TO A PARTICULAR AREA OF THE WORK OR A CONSISTENT ISSUE AFFECTING DIFFERENT AREAS OF THE WORK. ANY PARTICULAR RFI SHALL NOT INCLUDE TWO OR MORE UNRELATED ITEMS.

B. OPENINGS THROUGH THE STRUCTURE

1.

PLACEMENT AND DETAILING OF REINFORCEMENT AROUND SLEEVES, FORMED OPENINGS AND THE LIKE ARE TO CONFORM TO THE REQUIREMENTS NOTED ON THE STRUCTURAL CONTRACT DOCUMENTS. PROVIDE COORDINATED SLEEVING DRAWINGS IN ACCORDANCE WITH SPECIFICATION REQUIREMENTS.
2.

REFER TO TYPICAL DETAIL FOR MINIMUM SPACING OF SLEEVES. IF THESE SPACING REQUIREMENTS CAN NOT BE MAINTAINED, REINFORCE AROUND SLEEVES AS PER DETAILS FOR FORMED OPENINGS IN TYPICAL DETAIL .

C. SEQUENCE OF CONSTRUCTION

1.

PROVIDE ALL NECESSARY CONNECTIONS AND TEMPORARY SUPPORTS AS REQUIRED TO SAFELY CONSTRUCT THE STRUCTURE.
2.

UNLESS NOTED OTHERWISE, THE FINAL CONSTRUCTION SEQUENCING OR PHASING REQUIREMENTS ARE THE RESPONSIBILITY OF THE GENERAL CONTRACTOR AND SHALL BE DETERMINED AS AN INTEGRAL PART OF THEIR OVERALL CONSTRUCTION MEANS AND METHODS.
3.

THE TIMBER FRAME ALONE IS NOT STABLE UNTIL THE PLYWOOD WALL SHEATHING IS INSTALLED AND THE FLOOR AND ROOF SHEATHING IS INSTALLED

D. FUTURE PROVISIONS

1.

THE STRUCTURE HAS NOT BEEN DESIGNED FOR ANY FUTURE PROVISIONS OR EXTENSIONS

E. MATERIALS

1.

CONCRETE: CONFORM TO THE REQUIREMENTS OF CSA-A23.1 & AND THE FOLLOWING PERFORMANCE BASED CRITERIA:

- FOOTINGS:

EXPOSURE CLASS GU; MIN 28 DAY COMPRESSIVE STRENGTH = 30 MPa;
SLUMP 80±30; MAX W/C RATIO 0.40

- FOUNDATION WALLS:

EXPOSURE CLASS 'F'-2'; MIN 28 DAY COMPRESSIVE STRENGTH = 30 MPa;
SLUMP 80±30; MAX W/C RATIO 0.40; AIR CONTENT 5% TO 8%

- SOIL BEARING SLAB ON GRADE:

EXPOSURE CLASS GU; MIN 28 DAY COMPRESSIVE STRENGTH = 25 MPa;
SLUMP 40±20

- TOPPING SLABS:

EXPOSURE CLASS GU; MIN 28 DAY COMPRESSIVE STRENGTH = 25 MPa;
- RAMP, EXTERIOR STAIRS, REINFORCED CURBS, RETAINING WALLS:

- UNREINFORCED SIDEWALKS:

EXPOSURE CLASS C-1; MIN 28 DAY COMPRESSIVE STRENGTH = 35 MPa;
EXPOSURE CLASS C-2; MIN 28 DAY COMPRESSIVE STRENGTH = 32 MPa;
- UNSHRINKABLE FILL:

- LEAN MIX CONCRETE:

MAX 28 DAY COMPRESSIVE STRENGTH = 0.40 MPa MAX
MIN 28 DAY COMPRESSIVE STRENGTH = 8 MPa
2.

REINFORCEMENT: CONFORM TO CSA G30 SERIES, fy = 400 MPa FOR ALL REINFORCEMENT EXCEPT THAT fy = 450 MPa FOR WELDED WIRE FABRIC EQUAL TO OR GREATER THAN MW7.7 (Ø=3.1mm) AND fy=386 MPa FOR WELDED WIRE FABRIC LESS THAN MW7.7 (Ø3.1mm). PROVIDE WELDED WIRE FABRIC IN FLAT SHEETS ONLY. ALL REINFORCEMENT IS TO BE BLACK EXCEPT WHERE THE SUFFIX C IS USED TO DESIGNATE EPOXY COATED REINFORCEMENT.
3.

STRUCTURAL STEEL:

ANGLES, PLATES AND CHANNELS TO CONFORM TO CAN/CSA-G40.20/G40.21 GRADE 300W.

HOLLOW STRUCTURAL SECTIONS TO CONFORM TO ASTM A500 GRADE C.

4.

ANCHOR RODS: CONFORM TO 300W THREADED ROD CONFORMING TO CSA G40.21-M, UNLESS NOTED OTHERWISE.

5.

STRUCTURAL BOLTS SHALL CONFORM TO ASTM A325M, NUTS SHALL CONFORM TO ASTM A563M, WASHERS SHALL CONFORM TO ASTM F436M.

6.

WELDED STUD SHEAR CONNECTORS: HEADED STUDS SHALL BE MANUFACTURED BY NELSON (OR APPROVED ALTERNATIVE) AND SHALL BE MADE FROM MILD STEEL CONFORMING TO ASTM A108 GRADE 1010 THROUGH 1020. HEADED STUDS SHALL BE WELDED PER MANUFACTURER'S RECOMMENDATIONS. MECHANICAL PROPERTIES OF HEADED STUDS SHALL BE IN ACCORDANCE WITH AWS D1.1.

7.

NON-SHRINK GROUT: 35 MPa MINIMUM COMPRESSIVE STRENGTH AT 28 DAYS.

8.

FOUNDATION INSULATION: EXTRUDED POLYSTYRENE WITH A MINIMUM COMPRESSIVE STRENGTH OF 0.24 MPa UNLESS NOTED OTHERWISE.

9.

SAWN LUMBER: CONFORM TO THE REQUIREMENTS OF CSA O141. SPECIES: SPRUCE-PINE-FIR, GRADE: No.2 OR BETTER.

10.

PLYWOOD SHEATHING: DOUGLAS FIR PLYWOOD CONFORMING TO THE REQUIREMENTS OF CSA O121, CANADIAN SOFTWOOD PLYWOOD CONFORMING TO THE REQUIREMENTS OF CSA O151 AND BEAR THE STAMP INDICATING SUCH.

11.

GLUED-LAMINATED TIMBER: CONFORM TO CSA O122. APPEARANCE GRADE: INDUSTRIAL.

12.

TIMBER I-JOISTS: CONFORM TO CSA 086. MANUFACTURED BY WEYERHAEUSER OR APPROVED EQUIVALENT.

13.

STRENGTH PROPERTIES OF PROPRIETARY MANUFACTURED WOOD ELEMENTS TO MEET OR EXCEED THOSE SPECIFIED IN WEYERHAEUSER'S Trus Joist® Beam, Header, and Column Specifier's Guide (W. Canada) T1-9505 May 2015" SPECIFIER'S GUIDE. MATERIAL TO MEET OR EXCEED THE FOLLOWING VALUES FOR MODULUS OF ELASTICITY (E). COMMON WIDTH AND DEPTH SIZES PROVIDED IN mm. REFER TO SPECIFIER'S GUIDE FOR ALL OTHER MECHANICAL PROPERTIES.

14.

LAMINATED STRAND LUMBER (LSL) - 1.55E TimberStrand(r) LSL: E = 10.7 GPa FOR HEADERS AND BEAMS: WIDTHS = 45, 89; DEPTHS = 241, 302, 356, 406

15.

LAMINATED VENEER LUMBER (LVL) - 2.0E Microllam(r) LVL: E = 13.8 GPa FOR HEADERS AND BEAMS: WIDTH = 45; DEPTHS = 140, 184, 235, 241, 286, 302, 356, 406, 457, 508

16.

PARALLEL STRAND LUMBER (PSL) - 1.8E Parallam(r) PSL: E = 12.4 GPa FOR COLUMN AND POSTS: SIZE = 89x89, 89x133, 89x178, 133x133, 133x178, 178x178

17.

PARALLEL STRAND LUMBER (PSL) - 2.2E Parallam(r) PSL: E = 15.2 GPa FOR HEADERS AND BEAMS: WIDTHS = 89, 133, 178; DEPTHS = 235, 241, 286, 302, 356, 406, 457, 483, 508, 559, 610

18.

WIRE NAILS, SPIKES, AND STAPLES: CONFORM TO CSA-B111. NAILS SHALL BE EITHER HOT-DIPPED GALVANIZED OR STAINLESS STEEL. NO STAPLES ARE TO BE USED TO FASTEN SRUCTURAL ELEMENTS TOGETHER.

19.

WOOD ADHESIVES: CONFORM TO CSA-0112

20.

LAG SCREWS: CONFORM TO ASTM B18.2.1

21.

WOOD SCREWS: CONFORM TO ASTM B18.6.1. SCREW NOMINAL DIAMETERS AND YIELD STRENGTHS TO CONFORM TO CSA 086.

22.

GALVANIZING: CONFORM TO ASTM A653M, STANDARD SPECIFICATION FOR STEEL SHEET, ZINC-COATED (GALVANIZED) OR ZINC-IRON ALLOY-COATED (GALVANNEALD) BY HOT-DIP PROCESS.

23.

INSTALL ALL HARDWARE AS PER MANUFACTURER'S INSTALLATION INSTRUCTIONS.

F. FOUNDATIONS

1.

A COPY OF THE GEOTECHNICAL INVESTIGATION REPORT BY GOLDER ASSOCIATES DATED DECEMBER 4, 2015 TITLED WATERTON LAKES STAFF HOUSING, WATERTON LAKES NATIONAL PARKS, AB (GOLDER PROJECT No. 1534393/PHASE 2000 IS AVAILABLE FROM THE CONSULTANT. THIS INFORMATION IS AVAILABLE SOLELY AS A GUIDE. NO RESPONSIBILITY IS ACCEPTED BY THE OWNER OR THE CONSULTANT FOR ITS CORRECTNESS, NOR SHALL ITS ACCURACY AFFECT THE PROVISION OF THIS CONTRACT.

2.

FOUND ALL FOOTINGS ON NATURALLY CONSOLIDATED UNDISTURBED SAND AND GRAVEL CAPABLE OF SAFELY SUSTAINING A FACTORED ULTIMATE LIMIT STATES (ULS) BEARING PRESSURE AND A SERVICEABILITY LIMIT STATE (SLS) BEARING PRESSURE AS PRESENTED IN TABLES 1 AND 2 BELOW. IF THESE CONDITIONS DO NOT PREVAIL AT THE FOUNDING ELEVATIONS SHOWN, ADVISE THE CONSULTANT BEFORE PROCEEDING WITH THE WORK.

TABLE 1: FACTORED ULS BEARING PRESSURE(kPa) FOR SQUARE AND STRIP FOOTINGS PLACE ON NATIVE UNDISTURBED SAND AND GRAVEL					
FOOTING WIDTH	0.5m	1.0m	1.5m	2.0m	2.5m
SQUARE FOOTING	550	600	675	725	775
STRIP FOOTING	575	650	N/A	N/A	N/A

TABLE 2: FACTORED SSL BEARING PRESSURE(kPa) FOR SQUARE AND STRIP FOOTINGS PLACE ON NATIVE UNDISTURBED SAND AND GRAVEL					
FOOTING WIDTH	0.5m	1.0m	1.5m	2.0m	2.5m
SQUARE FOOTING	1000	600	400	300	300
STRIP FOOTING	600	425	N/A	N/A	N/A

3.

FOUNDING ELEVATION OF FOOTINGS ARE NOTED ON THE FOUNDATION PLAN. THESE ELEVATIONS HAVE BEEN DETERMINED BASED ON RECOMMENDATIONS INCLUDED IN THE GEOTECHNICAL REPORT. FOUNDING ELEVATIONS ARE SUBJECT TO CONFIRMATION BY THE GEOTECHNICAL ENGINEER DURING CONSTRUCTION. FOUND FOOTINGS SUSCEPTIBLE TO FROST DAMAGE A MINIMUM OF 1800 mm AND 1200mm BELOW FINISHED GRADE FOR UNHEATED AND HEATED STRUCTURES RESPECTIVELY UNLESS NOTED OTHERWISE.

4.

PROVIDE TEMPORARY FROST PROTECTION, DURING CONSTRUCTION, FOR ALL FOUNDATIONS WHICH ARE NOT FOUNDED A MINIMUM OF 1800 mm BELOW GRADE

5.

INSULATION IS SHOWN WHERE REQUIRED FOR PROTECTION OF THE FOUNDATIONS FROM DAMAGE DUE TO FROST ACTION ONLY. REFER TO ARCHITECTURAL DRAWINGS FOR FOUNDATION INSULATION NOT SHOWN ON THE STRUCTURAL DRAWINGS.

6.

THE LINE OF SLOPE BETWEEN ADJACENT FOOTINGS OR EXCAVATIONS OR ALONG STEPPED FOOTINGS SHALL NOT EXCEED A RISE OF 7 IN A RUN OF 10 UNLESS NOTED OTHERWISE.

7.

DO NOT PLACE BACKFILL AGAINST WALLS RETAINING EARTH (OTHER THAN CANTILEVER RETAINING WALLS) UNTIL THE WALLS AND THE FLOOR CONSTRUCTION AT TOP AND BOTTOM OF THE WALLS HAVE BEEN CAST AND ATTAINED 100% OF THEIR DESIGN STRENGTH.

8.

CARRY OUT BACKFILLING AGAINST FOUNDATION WALLS WHERE THERE IS GRADE ON BOTH SIDES IN SUCH A MANNER THAT THE LEVEL OF BACKFILLING ON ONE SIDE OF THE WALL IS NEVER MORE THAN 600 mm DIFFERENT FROM THE LEVEL ON THE OTHER SIDE OF THE WALL.

9.

DO NOT COMPACT CLOSER THAN 1800 mm FROM WALLS WITH HEAVY EQUIPMENT. USE LIGHT HAND CONTROLLED EQUIPMENT WITHIN 1800 mm FROM WALLS.

G. SLAB ON GRADE

1.

PLACE SLAB-ON-GRADE ON MATERIAL CAPABLE OF SUSTAINING A MINIMUM SLS BEARING PRESSURE OF 25 kPa WITHOUT SETTLEMENT.

2.

REFER TO THE GEOTECHNICAL REPORT FOR SUB-SOIL RECOMMENDATIONS.

H. CONCRETE AND REINFORCEMENT

1.

ALL DOWELS SHALL HAVE MINIMUM EMBEDMENT EQUIVALENT TO THE STRAIGHT TENSION EMBEDMENT LENGTH OR 600 mm, WHICHEVER IS GREATER, UNLESS NOTED OTHERWISE.

2.

PROVIDE DOWELS TO WALLS, COLUMNS AND PLASTERS SIMILAR IN NUMBER, SIZE, AND SPACING TO THE VERTICAL STEEL IN THE WALL, COLUMN OR PLASTER ABOVE UNLESS NOTED OTHERWISE.

3.

REINFORCEMENT IDENTIFIED AS 'CONTINUOUS' SHALL TERMINATE WITH STANDARD END HOOKS AND SHALL BE LAPPED WITH CLASS 'B' TENSION LAP SPLICES.

5.

REINFORCEMENT LENGTHS NOTED IN TYPICAL DETAILS ARE MINIMUM LENGTHS UNLESS NOTED OTHERWISE.

6.

CONSTRUCTION JOINTS:

A.

HORIZONTAL CONSTRUCTION JOINTS IN WALLS SHALL ONLY BE MADE WHERE SHOWN ON THE DRAWINGS.

B.

SUBMIT PROPOSED LOCATION OF ALL CONSTRUCTION JOINTS FOR REVIEW BY THE CONSULTANT.

7.

LAP SPLICES FOR WELDED WIRE FABRIC (WWF) SHALL BE:

152 X 152 WWF 500 mm

102 X 102 WWF 350 mm

51 X 51 WWF 250 mm

8.

CONCRETE COVER:

A.

COVER SHALL BE MEASURED FROM THE DEEPEST POINT OF TEXTURED CONCRETE SURFACE (OR REGLET/REVEAL) TO THE NEAREST DEFORMATION OF THE REINFORCEMENT. REINFORCEMENT INCLUDES TIES / STIRRUPS AND MAIN REINFORCEMENT.

B.

ALL CONCRETE CAST AGAINST EARTH IS TO HAVE 75 mm COVER, UNO.

C.

ALL CONCRETE EXPOSED TO EARTH IS TO HAVE 50 mm COVER, UNO.

D.

FOUNDATION WALL INSIDE FACE TO HAVE 25mm COVER, UNO.

I. STRUCTURAL STEEL

1.


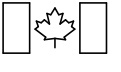
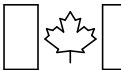
SUBMIT SEALED SHOP DRAWINGS OF ALL STRUCTURAL STEEL FRAMING. PROVIDE SEQUENCE OF ERECTION, TYPE OF EQUIPMENT USED IN ERECTION, AND TEMPORARY BRACINGS.

2.

SPLICES SHALL BE DESIGNED TO DEVELOP THE FULL CROSS SECTIONAL CAPACITY OF THE MEMBER AT THE POINT OF THE SPLICE. MEMBERS SHALL NOT BE SPLICED AT POINTS OF MAXIMUM STRESS. NO SPLICES SHALL BE MADE UNLESS SHOWN ON THE DRAWINGS OR REVIEWED AND APPROVED BY THE CONSULTANT.





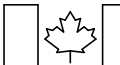
3.

LENGTH FOR ANCHOR RODS, STRAP ANCHORS AND SIMILAR DEVICES IS GIVEN FOR THE STRAIGHT LENGTH WITHOUT HOOK. PROVIDE 50mm HOOK FOR STRAP ANCHORS TYPICAL UNLESS NOTED OTHERWISE.

5	2016-12-08	ISSUED FOR TENDER	AD	IW					
4	2016-12-08	ISSUED FOR BUILDING PERMIT	AD	IW					
3	2016-09-02	ISSUED FOR 99%	AD	IW					
2	2016-06-03	ISSUED FOR 66%	AD	IW					
1	2016-05-05	ISSUED FOR 33%	AD	IW					
No.	Date/Date	Description/Description	Drawn by Dessiné par	Approved Approuvé					
Revision / Revision									
<div><div>A</div><div>C</div></div>		<div>A detail number numero de detail</div> <div>B source drawing no. de dessin no.</div> <div>C detail on drawing no. detail sur dessin no.</div>	<div><div>A</div><div>B</div><div>C</div></div>						
Consultant's Name Nom de l'expert-conseil			Eng. Stamp Sceau de l'ingénieur						
ENTUITIVE 209 - 8th Avenue SW, Suite 300 Calgary, AB T2P 1B5 403-878-1270									
 Public Works and Government Services Canada		Travaux publics et Services gouvernementaux Canada							
Client Services Team Southern Alberta Operations Branch		Le Client Entretien l'Équipe Alberta Méridional Branche d'Opérations							
<div><div>Canada</div><div>Client/client</div><div> Parks Canada Agence</div><div>L'Agence Parcs Canada</div><div>Western and Northern Region</div><div>Ouest et Nord du Canada</div></div>									
Project title/Titre du projet									
<div>Staff Housing Phase 2</div> <div>Waterton Lakes National</div> <div>Park</div>									
Drawing title/Titre du dessin									
<div>GENERAL</div> <div>NOTES</div>									
Surveyed by/Arpenté par		Drawn by/Dessiné par		Date/Date					
KL		AD		12/02/16					
Designed by/Concept par		Reviewed by/Revisé par		Scale/Echelle					
KL		IW		1 : 1					
PWGSC Project Manager/Administrateur de Projets TPSPGC									
Client Acceptance/Acceptation du client			Approved by/Approuve par						
Randy Boldt									
Task Responsible/Responsable de la tâche			PWGSC Project Manager/Administrateur de Projets TPSPGC						
Project No./No. du projet		Asset No./No. du bien		Sheet No./ No. de la feuille					
C015-0870		Fil # 945		S001					
Drawing Reference No./No. de référence du dessin									

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J. TIMBER		K. TIMBER EXECUTION		M. POST-INSTALLED ANCHORS	
1.	PROTECT ALL WOOD ELEMENTS FROM DAMAGE AND STAINING DUE TO WETTING AND MOISTURE DURING STORAGE AND INSTALLATION.	1.	WALL STUD SPACING SHALL NOT EXCEED 406 mm UNO.	1.	EXCEPT WHERE INDICATED ON THE DRAWINGS, POST-INSTALLED ANCHORS SHALL CONSIST OF THE FOLLOWING ANCHOR TYPES AS PROVIDED BY HILTI (CANADA) CORPORATION.
2.	ENSURE SURFACES THAT ARE TO RECEIVE FINISHES MEET MANUFACTURERS REQUIREMENTS FOR MAXIMUM MOISTURE CONTENT FOR THE FINISH SPECIFIED.	2.	FINGER JOINED STUDS ARE NOT PERMITTED.	A.	ANCHORAGE TO CONCRETE
3.	PROVIDE A MOISTURE BARRIER FOR ALL WOOD ELEMENTS IN CONTACT WITH CONCRETE OR MASONRY. THE MOISTURE BARRIER JOINTS ARE TO BE LAPPED AND SEALED.	3.	ALL DIMENSION LUMBER BUILT-UP COLUMNS SUPPORTING DIMENSION LUMBER BUILT-UP BEAMS SHALL HAVE THE NUMBER OF COLUMN PLYS MATCHING THE NUMBER OF BEAM PLYS.	i	ADHESIVE ANCHORS FOR CONCRETE USE:
4.	TIMBER SHALL NOT BE INCISED FOR PRESERVATIVE TREATMENT, UNLESS NOTED OTHERWISE.	4.	ALL DIMENSION LUMBER BUILT-UP COLUMNS SUPPORTING PROPRIETARY MANUFACTURED BUILT-UP BEAMS SHALL HAVE THE NUMBER OF COUNM PLYS EXCED THE NUMBER OF BEAM PLYS BY ONE.	1.	HILTI HIT-HY 200 SAFE SET SYSTEM WITH HILTI HIT-Z ROD FOR FAST CURE APPLICATIONS.
5.	HOLES, CUTS OR NOTCHES IN WOOD ELEMENTS OTHER THAN THOSE SHOWN IN TYPICAL DETAILS ARE NOT PERMITTED WITHOUT PRIOR APPROVAL FROM THE STRUCTURAL ENGINEER.	5.	ALL FREE STANDING DIMENSION LUMBER BUILT-UP COLUMNS SHALL HAVE 3 PLYS MINIMUM.	2.	HILTI HIT-HY 200 SAFE SET SYSTEM WITH HILTI HOLLOW DRILL BIT SYSTEM FOR FAST CURE APPLICATIONS.
6.	HANGERS AND THEIR CONNECTIONS MUST ADEQUATELY SUPPORT THE FULL SHEAR CAPACITY OF THE MEMBER, UNLESS NOTED OTHERWISE.	6.	MULTI-PLY PROPRIETARY MANUFACTURED BEAMS SHALL BE NAILED WITH THREE (3) ROWS OF 89 mm NAILS AT 300 mm O/C EACH SIDE FOR THREE (3) PLYS. FOUR (4) OR MORE PLYS SHALL BE BOLTED WITH 2 ROWS OF 12.7 mm DIAMETER BOLTS AT 300 mm O/C STAGGERED BETWEEN ROWS.	3.	HILTI HIT-RE 500-SD EPOXY ADHESIVE ANCHORING SYSTEM FOR SLOW CURE APPLICATIONS.
7.	NAILS FASTENED INTO SHEAR WALLS OR DIAPHRAGMS SHALL NOT BE OVER-DRIVEN MORE THAN 15% OF THE PANEL THICKNESS.	7.	ALL FRAMING CONNECTORS SHALL BE A MINIMUM OF 0.912 mm (20-GAUGE) HOT-DIPPED GALVANIZED STEEL CONFORMING TO ASTM A653/A653M-15, STANDARD SPECIFICATION FOR STEEL SHEET, ZINC-COATED (GALVANIZED) OR ZINC-IRON ALLOY-COATED (GALVANNEALD) BY HOT-DIP PROCESS. FRAMING STRAPS SHALL BE A MINIMUM OF 38 mm x 400 mm.	4.	HILTI HIT-RE 500 EPOXY ADHESIVE ANCHORING SYSTEM FOR SLOW CURE APPLICATIONS.
8.	ALL LAG SCREWS, THROUGH BOLTS, AND OTHER HARDWARE CONNECTING PRESERVATIVE TREATED MEMBERS ARE TO BE HOT DIPPED GALVANIZED.	8.	REFER TO WALL, COLUMN, LINTEL, AND BEAM SCHEDULES AND DETAILS.	5.	STEEL ANCHOR ELEMENT SHALL BE HILTI HIS-N INTERNALLY THREADED INSERTS, HILTI HAS-E CONTINUOUSLY THREADED ROD, OR CONTINUOUSLY DEFORMED STEEL REBAR.
9.	REPRESENTATIVE TIMBER TO TIMBER CONNECTIONS HAVE BEEN SHOWN ON THE DRAWINGS. THE TIMBER SUPPLIER IS RESPONSIBLE FOR THE FINAL DESIGN OF CONNECTIONS BETWEEN TIMBER ELEMENTS AND CONFORM IN PRINCIPLE WITH THE REPRESENTITIVE CONNECTIONS. THESE INCLUDE AND ARE NOT LIMITED TO CONNECTORS, FASTENERS, HANGERS, TIE-DOWNS, POST AND BEAM HARDWARE.	9.	WHERE SHEATHING PANEL THICKNESSES DIFFERS BETWEEN ARCHITECTURAL AND STRUCTURAL DRAWINGS, USE THE THICKER OF THE PANELS SPECIFIED. NOTIFY THE ARCHITECT AND STRUCTURAL ENGINEER OF ANY DIFFERENCES PRIOR TO CONSTRUCTION.	ii	MEDIUM DUTY MECHANICAL ANCHORS FOR CONCRETE USE:
10.	END GRAIN OF ALL GLULAM MEMBERS ARE TO BE FACTORY COATED WITH END SEALER.	10.	ALL SHEATHING TO BEAR A MARK INDICATING THE PANEL IS SUTABLE FOR THE PROPOSED END USE (i.e. FLOOR, ROOF, OR WALL) AND THE SPACING OF THE SUPPORTS ON WHICH THE PANEL IS FASTENED.	1.	HILTI KWIK HUS EZ AND KWIK HUS EZ-I SCREW ANCHORS.
11.	ALL TEMPORARY BRACING AND GUARDS SHALL BE THE RESPONSIBILITY OF THE GENERAL CONTRACTOR.	11.	ALL SHEATHING TO BE INSTALLED WITH ITS LONG AXIS PERPENDICULAR TO THE SUPPORTING MEMBERS WITH PANEL EDGES STAGGERED.	2.	HILTI KWIK BOLT-TZ EXPANSION ANCHORS.
12.	DIMENSIONAL LUMBER:	12.	WALL SHEATHING TO BE A MINIMUM 12.5 mm THICK. PROVIDE A 2 mm GAP BETWEEN PANEL EDGES. PROVIDE BLOCKING AT ALL HORIZONTAL PANEL EDGES IN SHEAR-WALL SEGMENTS AS NOTED IN THE DRAWINGS.	3.	HILTI KWIK BOLT 3 EXPANSION ANCHORS.
A.	ALL CARPENTRY SHALL CONFORM TO SECTION 9.23 OF THE NATIONAL BUILDING CODE AND CSA 086-14.	13.	FLOOR SHEATHING TO BE 16 mm THICK CANADIAN SOFTWOOD T&G FIR PLYWOOD SUB FLOOR SCREWED SECURELY TO ALL JOISTS AT 150 mm ALONG EDGES AND 300 mm ON INTERMEDIATE MEMBERS. GLUE TO ALL SUPPORTING MEMBERS USING PL400 OR EQUIVALENT.	iii	HEAVY DUTY MECHANICAL ANCHORS FOR CONCRETE USE:
B.	ALL DIMENSION LUMBER TO BE KILN DRIED TO A MOISTURE CONTENT OF LESS THAN 19%, AND SHALL BE SPF #2 GRADE OR BETTER.	14.	ROOF SHEATHING SHALL BE A MINIMUM 15.5mm THICK PLYWOOD OR OSB.	1.	HILTI HDA UNDERCUT ANCHORS.
C.	UNO SILL PLATES ARE TO BE SECURED TO CONCRETE WITH 13 mm DIAMETER ANCHOR RODS 150 mm EMBEDMENT WITH 50 mm 90 DEGREE HOOKS SPACED AT 1200 o/c OR POST INSTALLED 13mm DIAMETER SIMPSON TITEN HD ANCHORS 127mm EMBEDMENT SPACED AT 1200 mm o/c UNO. ANCHOR SPACING SHALL BE 600 o/c FOR SILLS ON FOUNDATION WALL.	15.	PROVIDE 3 mm GAP AT ALL EDGES OF ROOF SHEATHING.	2.	HILTI HSL-3 EXPANSION ANCHORS.
D.	ALL SPANS FOR WOOD JOISTS, RAFTERS, BEAMS, AND LINTELS SHALL COMPLY WITH SPANS SHOWN IN THE CANADIAN WOOD COUNCIL PUBLICATION "THE SPAN BOOK" AND/OR THE NATIONAL BUILDING CODE.	16.	FOR UPLIFT PROVIDE FRAMING ANCHORS TO RESIST A FACTORED 4 kN LOAD AT EACH END OF EACH ROOF RAFTER.		
E.	JOISTS ARE TO BE DOUBLED UNDER ALL PARALLEL PARTITIONS AND UNO.	17.	MEMBERS SHALL BE ALIGNED LEVEL AND PLUMB WITHIN A TOLERANCE OF 1 IN 500.		
F.	JOISTS SHALL BE PLACED TO ACCOMMODATE HEATING AND PLUMBING.	18.	PROVIDE SOLID BLOCKING BETWEEN JOISTS OVER SUPPORT AT ALL CANTILEVERED CONDITIONS.		
G.	ALL STAIR TREADS AND RISERS TO BE SCREWED AND GLUED WITH AN ADHESIVE TO THE STAIR STRINGERS.	19.	MINIMUM BEARING LENGTHS		
H.	ALL POSTS OR COLUMNS TO BE CONTINUOUS FROM BEAM ELEVATION TO FOUNDATIONS OR OTHER SOLID SUPPORT EVEN IF SUPPORTED ON LOAD BEARING STUD WALLS. PROVIDE SQUASH BLOCKING THROUGH FLOOR SYSTEM IN ALL CASES WHERE POSTS OR COLUMNS DO NOT BEAR DIRECTLY ON SOLID SUPPORT.		50 mm FOR ALL JOISTS, LINTELS, AND RAFTERS 100 mm FOR ALL BEAMS		
13.	CONNECTIONS:	20.	PROVIDE 38x38 DIAGONAL CROSS BRIDGING AT MIDSPAN OR AT 2100 mm O/C MAXIMUM FOR ALL DIMENSION LUMBER JOISTS.		
	ALL BOLTS AND ANCHOR BOLTS SHALL CONFORM TO ASTM A307.				
	ALL BOLTS AND NUTS MUST BE FITTED WITH CUT STEEL WASHERS.				
	ALL STEEL PLATE USED IN CONNECTION DETAILS SHALL BE 300W.				
	ALL HOLD-DOWN CONNECTORS SHALL BE 'SIMPSON' AS SPECIFIED ON THE DRAWINGS, OR APPROVED EQUIVALENT.				
	NAILING SHALL BE WITH COMMON WIRE NAILS.				
	BOLT HOLES SHALL BE 1.5mm LARGER THAN THE BOLT DIAMETER.				
	NO CHECKS OR SPLITS ALLOWED AT AREAS TO BE BOLTED OR LAGGED.				
	ALL EXPOSED BOLTS AND WASHERS SHALL BE GALVANIZED, OR AS SPECIFIED BY THE ARCHITECT.				
14.	PROVIDE 2X BLOCKING AT MIDHEIGHT OF STUDS OVER 2400 IN HEIGHT.				
15.	BLOCKING OR EQUIVALENT BRACING SHALL BE PLACED BETWEEN ALL TRUSSES AT BEARING SUPPORTS. TJI BLOCKING OR 32mm LSL RIMBOARD SHALL BE PLACED BETWEEN ALL JOISTS AT BEARING SUPPORTS, UNO.				
16.	ENSURE THAT ALL JAMBS, CRIPPLES AND POSTS ARE SUPPORTED CONTINUOUSLY WITH MINIMUM EQUAL MEMBERS AT LEVELS BELOW INCLUDING WITHIN FLOOR DEPTHS AND HEADER/BEAM LOCATIONS, UNO.				
17.	ALL HEADERS ARE TO BE FASTENED TO THE FIRST JAMB STUD WITH A MINIMUM 3 - 76mm 10D NAILS PER 38mm WIDTH OF HEADER WITH THE SAME NAILING PATTERN USED TO FASTEN EACH ADDITIONAL JAMB STUD, UNO.				
18.	ALL STRUCTURAL CONNECTORS SHALL BE INSTALLED IN ACCORDANCE WITH MANUFACTURER'S RECOMMENDATIONS.				
19.	PRE-ENGINEERED FLOOR AND ROOF SYSTEMS:				
A.	ALL PRE-ENGINEERED FLOOR AND ROOF SYSTEM LAYOUTS TO BE REVIEWED AND CONFIRMED BY MANUFACTURER PRIOR TO START OF CONSTRUCTION.	A.	BOTTOM PLATE TO STUD: 3x76 mm EACH STUD. TOP PLATE TO STUD:		
			38x140 STUD: 3x89 mm EACH STUD 38x184 STUD: 4x89 mm EACH STUD		
B.	ALL PRE-ENGINEERED FLOOR AND ROOF SYSTEMS INCLUDING JOISTS, BEAMS, LINTELS, AND TRUSSES TO BE SIZED, INSTALLED, AND BRACED ACCORDING TO MANUFACTURER'S SPECIFICATIONS.	C.	HORIZONTAL BLOCKING: 2x76 mm EACH END		
		D.	FRAMING AROUND WINDOWS AND OPENINGS - THROUGH NAILING (IN ADDITION TO FRAMING ANCHORS SHOWN/PROVIDED):		
C.	PRE-ENGINEERED MANUFACTURER TO PROVIDE SHOP DRAWINGS OF FLOOR AND ROOF SYSTEM COMPONENTS WHICH SHALL BE VERIFIED BY AND BEAR THE STAMP OF A PROFESSIONAL ENGINEER.		38x140 MEMBERS: 3x89mm EACH MEMBER 38x184 MEMBERS: 3x89 mm EACH MEMBER		
D.	BEAM LAMINATIONS AS PER FLOOR SUPPLIERS RECOMMENDATION.	E.	FLOOR JOISTS AND BLOCKING TO TOP PLATES - TOE NAILING:		
			38x140 MEMBERS: 3x89 mm EACH MEMBER 38x184 MEMBERS: 3x89 mm EACH MEMBER		
		F.	FLOOR SHEATHING: 63 mm @ 150 mm O/C ON ALL SUPPORTS MINIMUM UNO		
		G.	ROOF SHEATHING: SEE DETAILS		
		H.	REFER TO TYPICAL DETAIL T3 FOR BUILT-UP COLUMNS AND TIMBER EXECUTION ABOVE.		
		I.	BUILT-UP DIMENSION LUMBER BEAMS:		
			2 PLY: 76 mm @ 200 mm O/C STAGER ROWS TOP AND BOTTOM. DO NOT SPLICE MEMBERS. 3 PLY: 89 mm @ 200 mm O/C STAGER ROWS TOP AND BOTTOM. DO NOT SPLICE MEMBERS.		
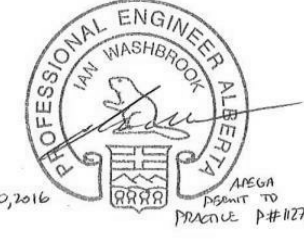
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2	2016-06-03	ISSUED FOR 66%	AD	IW	
1	2016-05-05	ISSUED FOR 33%	AD	IW	
No.	Date/Date	Description/Description	Drawn by Dessiné par	Approved Approuvé	
Revision / Revision					
A detail number numero de detail B source drawing no. de dessin no. C detail on drawing no. detail sur dessin no.					
Consultant's Name Nom de l'expert-conseil ENTUITIVE 209 - 8th Avenue SW, Suite 300 Calgary, AB T2P 1B5 403-878-1270			Eng. Stamp Sceau de l'ingénieur  Andrew Dietrich Ingénieur Mécanique No. 18729		
		Public Works and Government Services Canada	Travaux publics et Services gouvernementaux Canada		
		Client Services Team Southern Alberta Operations Branch	Le Client Entretien l'Équipe Alberta Méridional Branche d'Opérations		
					
Client/client 		Parks Canada Agency	L'Agence Parcs Canada		
		Western and Northern Region	Ouest et Nord du Canada		
Project title/Titre du projet Staff Housing Phase 2 Waterton Lakes National Park					
Drawing title/Titre du dessin GENERAL NOTES					
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Client Acceptance/Acceptation du client			Approved by/Approuvé par		
Task Responsible/Travaux Responsables			PWGSC Project Manager/Administrateur de Projets TPSGC		
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Drawing Reference No./No. de référence du dessin					

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A. GENERAL

1. THE STRUCTURE HAS BEEN DESIGNED IN ACCORDANCE WITH THE REQUIREMENTS OF THE NATIONAL BUILDING CODE OF CANADA 2015 (NBC).
2. ALL REINFORCED CONCRETE ELEMENTS HAVE BEEN DESIGNED IN ACCORDANCE WITH CSA A23.3, DESIGN OF CONCRETE STRUCTURES.
3. ALL STRUCTURAL STEEL ELEMENTS HAVE BEEN DESIGNED IN ACCORDANCE WITH CSA-S16, LIMIT STATES DESIGN OF STEEL STRUCTURES.

A. THE STRUCTURAL STEEL DESIGN IS BASED ON "SIMPLE" CONSTRUCTION.

B. ALL CONNECTIONS ARE ASSUMED TO BE BEARING TYPE CONNECTIONS, UNLESS NOTED OTHERWISE. THE BOLTS SHALL BE BROUGHT TO A SNUG-TIGHT CONDITION AS DEFINED IN CSA-S16.
4. ALL STRUCTURAL GLUED-LAMINATED TIMBER ELEMENTS HAVE BEEN DESIGNED IN ACCORDANCE WITH CSA-086, ENGINEERING DESIGN IN WOOD (LIMIT STATES DESIGN).

B. LATERAL LOAD RESISTING SYSTEM

1. THE LATERAL WIND AND EARTHQUAKE LOADS APPLIED TO THE STRUCTURE ARE RESISTED BY THE FOLLOWING:

A. TIMBER NAILED SHEAR WALLS WITH WOOD-BASED PANELS AND GYPSUM PANELS IN COMBINATION.
2. THE STRUCTURE HAS BEEN DESIGNED TO RESIST LATERAL WIND AND EARTHQUAKE LOADS IN ACCORDANCE WITH THE NATIONAL BUILDING CODE OF CANADA 2015.
3. THE DESIGN PARAMETERS FOR WIND AND EARTHQUAKE ARE AS NOTED BELOW:

A. WIND LOADS

THE WIND LOADS HAVE BEEN CALCULATED IN ACCORDANCE WITH STATIC PROCEDURE AS OUTLINED IN THE USER'S GUIDE - NBC 2015 STRUCTURAL COMMENTARIES.

HOURLY WIND PRESSURES FOR WATERTON VILLAGE, ALBERTA (VALUES PROVIDED BY PARKS CANADA AGENCY):
q50 = 0.97 kPa

WIND IMPORTANCE FACTOR, BASED ON TABLE 4.1.7.1 OF THE 2015 NBC CATEGORY - NORMAL
Iw = 1.0 (ULS)
Iw = 0.75 (SLS)

EXPOSURE FACTOR BASED ON OPEN TERRAIN AS DESCRIBED IN THE USER'S GUIDE - NBC 2015 STRUCTURAL COMMENTARIES
Ce = 0.91

EXTERNAL AND INTERNAL GUST EFFECT FACTORS AND PRESSURE COEFFICIENTS
CpCg FACTORS BASED ON USER'S GUIDE - NBC 2015 STRUCTURAL COMMENTARIES FIGURE I-7 FOR PRIMARY STRUCTURAL ACTIONS, FIGURE I-8 FOR THE DESIGN OF EXTERIOR WALL STRUCTURAL COMPONENTS AND CLADDING, AND FIGURE I-11 FOR HIPPED ROOFS WITH A SLOPE GREATER THAN 7 DEGREES FOR THE DESIGN OF STRUCTURAL COMPONENTS AND CLADDING.
Cgi = 2.0 AS CALCULATED ACCOUNTING FOR THE SIZES OF THE OPENINGS IN THE BUILDING ENVELOPE, THE INTERNAL VOLUME, AND THE FLEXIBILITY OF THE BUILDING ENVELOPE IN ACCORDANCE WITH THE USER'S GUIDE

EXTERNAL AND INTERNAL PRESSURE COEFFICIENTS
Cpi = -0.45 AND +0.30, BASED ON CATEGORY 2 OF THE USER'S GUIDE

B. EARTHQUAKE LOADS

THE EARTHQUAKE LOADS HAVE BEEN CALCULATED IN ACCORDANCE WITH THE EQUIVALENT STATIC FORCE PROCEDURE.

EARTHQUAKE IMPORTANCE FACTOR, BASED ON NATURAL RESOURCES CANADA'S www.earthquakecanada.ca 2015 NATIONAL BUILDING CODE OF CANADA SEISMIC HAZARD CALCULATOR CATEGORY - NORMAL
IE = 1.0 (ULS)

SEISMIC HAZARD PARAMETERS FOR WATERTON VILLAGE, ALBERTA (LATITUDE OF 49.0517 DEGREES AND A LONGITUDE OF -113.9112 DEGREES):
Sa(0.2) = 0.251, Sa(0.5) = 0.151, Sa(1.0) = 0.076, Sa(2.0) = 0.043, PGA = 0.129

SITE CLASSIFICATION FOR SEISMIC SITE RESPONSE:
CLASS = C

ACCELERATION AND VELOCITY BASED SITE COEFFICIENTS:
Fa = 1.0, Fv = 1.0

TYPE OF SEISMIC FORCE RESISTING SYSTEM (SFRS): TIMBER NAILED SHEAR WALLS WITH WOOD-BASED PANELS AND GYPSUM PANELS IN COMBINATION:
Rd = 3.0, Ro = 1.7

FUNDAMENTAL LATERAL PERIOD USED FOR CALCULATIONS
Ta = 0.11 SEC
BASED ON A 2ND FLOOR REFERENCE HEIGHT OF 3m USING THE SHEAR WALL EQUATION FROM 4.1.8.11.3c

4. DESIGN FACTORED BASE SHEAR:

MAXIMUM WIND
NORTH / SOUTH DIRECTION
EAST / WEST DIRECTION

= 700kN
= 200kN

MAXIMUM EARTHQUAKE

= 175kN

5. DESIGN FACTORED BASE OVERTURNING:

MAXIMUM WIND
NORTH / SOUTH DIRECTION
EAST / WEST DIRECTION

= 1215 kNm
= 1535 kNm

MAXIMUM EARTHQUAKE

= 830 kNm

C. LOADS ON FOUNDATION / RETAINING WALLS

1. THE WALLS HAVE BEEN DESIGNED ASSUMING FREE DRAINING BACKFILL WHICH DOES NOT PERMIT THE BUILD-UP OF HYDROSTATIC PRESSURE

2. WALL HAVE BEEN DESIGNED FOR A HORIZONTAL PRESSURE (P IN kPa) AT ANY DEPTH (h in m) GIVEN BY THE EXPRESSION:

P = Ko (gh + q)

WHERE THE
SOIL PRESSURE COEFFICIENT,
UNIT WEIGHT OF SOIL,
SURCHARGE,

Ko = 0.45
g = 21kN/m³
q= 12.0 kPa

D. LIVE LOADS ON FLOORS

1. BASEMENT LEVEL: 4.8kPa
RESIDENTIAL AREAS ON MAIN LEVEL AND LOFT LEVEL: 1.9kPa
COMMON CORRIDORS AT MAIN LEVEL AND LOFT LEVEL, STAIRS, AND LOBBY: 4.8kPa
ROOF TRUSS BOTTOM CHORD: 1.5 kN POINT LOAD APPLIED ANYWHERE

E. LIVE LOADS ON ROOFS AND WALLS

1. THE ROOF AREAS HAVE BEEN DESIGNED TO RESIST SNOW, RAIN AND WIND LOADS IN ACCORDANCE WITH THE NATIONAL BUILDING CODE OF CANADA 2015. THE DESIGN PARAMETERS FOR THESE LOADS ARE AS NOTED BELOW.

2. SNOW LOAD:

THE SNOW LOADS HAVE BEEN CALCULATED IN ACCORDANCE WITH THE NATIONAL BUILDING CODE OF CANADA, 2015.

SNOW IMPORTANCE FACTOR, BASED ON TABLE 4.1.6.2 OF THE NBC 2015 CATEGORY - NORMAL
Is = 1.0 (ULS)
Is = 0.9 (SLS)

GROUND SNOW LOAD (1 IN 50 YEAR)
Ss = 3.2kPa (PSF)

BASIC ROOF SNOW LOAD FACTOR
Cb = 0.8

WIND EXPOSURE FACTOR
Cw = 1.0 (ASSUME FUTURE DEVELOPMENT REDUCES OPEN EXPOSURE)
ROOF SLOPE, α=9:12 (36.9°)

SLOPE FACTOR
Cs = 0.83 (NON-SLIPPERY SLOPE)

SHAPE FACTOR
Ca = 1.0 CASE I; 1.25 CASE II

ASSOCIATED RAIN LOAD (1 IN 50 YEAR)
Sr = 0.3kPa (PSF)
S = Is[Is](CbCwCsCa) + Sr] = 2.42 kPa (CASE I); 2.96 kPa (CASE II). EXCEEDS MINIMUM LIVE LOAD OF 1.0 kPa

ALLOW FOR SNOW CORNICES BEYOND THE EDGE OF THE ROOF A DISTANCE EQUAL TO THE DEPTH OF SNOW OF 1.0m BASED ON AN AVERAGE SNOW DENSITY OF 3.0 kN/m³.

SNOW ACCUMULATION IN VALLEYS AND BETWEEN DORMERS - S = 5.1 kPa.

3. WIND LOAD

THE WIND LOADS HAVE BEEN CALCULATED IN ACCORDANCE WITH STATIC PROCEDURE AS OUTLINED IN THE USER'S GUIDE - NBC 2015 STRUCTURAL COMMENTARIES.

HOURLY WIND PRESSURES FOR WATERTON VILLAGE, ALBERTA (VALUES PROVIDED BY PARKS CANADA AGENCY):
q50 = 0.97 kPa

WIND IMPORTANCE FACTOR, BASED ON TABLE 4.1.7.1 OF THE 2015 NBC CATEGORY - NORMAL
Iw = 1.0 (ULS)
Iw = 0.75 (SLS)

EXPOSURE FACTOR BASED ON OPEN TERRAIN AS DESCRIBED IN THE USER'S GUIDE - NBC 2015 STRUCTURAL COMMENTARIES.
Ce = 0.91

A. ROOFS (+ DOWNWARD; - UPWARD) NET UNFACTORED WIND PRESSURE (ULS):

ROOF OVERHANGS (INCLUDING ENTRANCE CANOPY) = -3.4 kPa

ALL ROOF AREAS = -2.5 kPa FOR EFFECTIVE WIND AREAS ≥ 2.5 m²

ALL ROOF AREAS = -2.6 kPa FOR EFFECTIVE WIND AREAS <2.5 m²

ALL ROOF AREAS = 1.8 kPa

B. EXTERIOR STUD WALLS

NET UNFACTORED WIND PRESSURE (ULS): ± 2.6kPa

F. SUPERIMPOSED DEAD LOADS AND OTHER LOADS

1. THE STRUCTURE HAS BEEN DESIGNED TO RESIST THE FOLLOWING SUPERIMPOSED DEAD LOADS.

- BASEMENT LEVEL:

FLOOR FINISHES
NON-LOAD BEARING PARTITIONS

= 0.5 kPa
= 1.0 kPa

- MAIN LEVEL AND LOFT LEVEL FRAMING:

CARPET & UNDERLAY
38mm NORMAL DENSITY CONCRETE TOPPING
16mm PLYWOOD SHEATHING
300mm ACOUSTICAL BATT INSULATION
2 LAYERS OF 15.9mm TYPE X GYPSUM WALL BOARD
SPRINKLER SYSTEM
SUSPENDED MECHANICAL AND ELECTRICAL ALLOWANCE
NON-LOAD BEARING PARTITIONS
TOTAL

= 0.15 kPa (0.0 kPa FOR UPLIFT LOAD CASE*)
= 0.91 kPa
= 0.09 kPa
= 0.10 kPa (0.0 kPa FOR UPLIFT LOAD CASE*)
= 0.27 kPa
= 0.05 kPa (0.0 kPa FOR UPLIFT LOAD CASE*)
= 0.25 kPa (0.1 kPa FOR UPLIFT LOAD CASE)
= 1.0 kPa (0.5 kPa FOR UPLIFT LOAD CASE*)
= 2.84 kPa (1.89 kPa FOR UPLIFT LOAD CASE*)

- BOTTOM CHORD OF ROOF TRUSSES; UNDERSIDE OF ROOF RAFTERS:

SUSPENDED MECHANICAL AND ELECTRICAL ALLOWANCE
300 BATT INSULATION
1 LAYER OF 15.9mm TYPE X GYPSUM WALL BOARD
TOTAL

= 0.25 kPa (0.1 kPa FOR UPLIFT LOAD CASE*)
= 0.10 kPa
= 0.14 kPa
= 0.5 kPa (0.3 kPa FOR UPLIFT LOAD CASE*)

- TOP CHORD OF ROOF TRUSSES; TOP OF ROOF RAFTERS:

12.5mm PLYWOOD SHEATHING
ASPHALT SHINGLES + FUTURE REROOFING
MISCELLANEOUS
TOTAL

= 0.07 kPa FLAT (0.09 kPa PROJECTED)
= 0.24 kPa FLAT (0.30 kPa PROJECTED); (0.12 kPa FLAT, 0.15 kPa PROJECTED FOR UPLIFT LOAD CASE*)
= 0.1 kPa PROJECTED (0.0 kPa FOR UPLIFT LOAD CASE*)
= 0.5 kPa PROJECTED (0.24 kPa PROJECTED FOR UPLIFT LOAD CASE*)

(*) UPLIFT LOAD CASE IS FOR OVERALL UPLIFT ON THE ROOF TRUSSES AND ROOF RAFTERS FOR ROOF TRUSS DESIGN, RESPECTIVE TIE DOWN DESIGN AND LOAD BEARING WALL DETAILS.

2. THESE SUPERIMPOSED DEAD LOADS HAVE BEEN DETERMINED BASED ON THE MATERIALS SHOWN ON THE ARCHITECTURAL DRAWINGS AND INFORMATION PROVIDED BY THE OTHER DESIGN DISCIPLINES. IF THE CONTRACTOR PROPOSES TO SUBSTITUTE ANY SPECIFIED MATERIALS WITH MATERIALS OF HEAVIER CONSTRUCTION, THEY SHALL INFORM THE CONSULTANT WHO WILL ASSESS THE IMPACT OF THE PROPOSED SUBSTITUTION PRIOR TO PROPOSED SUBSTITUTION BEING ACCEPTED.

3. ASSUMED SELF WEIGHT:

MAIN LEVEL AND LOFT LEVEL WOOD JOIST/FLOOR TRUSS FLOOR FRAMING
ROOF TRUSS SELF WEIGHT

= 0.11 kPa
= 0.2 kPa FLAT (0.25 kPa PROJECTED)

G. STRUCTURAL MOVEMENTS

1. TYPICAL HORIZONTAL ELEMENTS HAVE BEEN DESIGNED SO THAT THE THEORETICAL VERTICAL DEFLECTIONS WILL NOT EXCEED THE VALUES NOTED IN TABLE 1 BELOW.



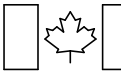
2. INTERIOR NON LOAD BEARING WALLS AND PARTITIONS, ARE TO BE DETAILED TO ACCOMMODATE A MINIMUM OF 25mm (1") VERTICAL MOVEMENT AT THE TOP OF THE PARTITION, UNLESS NOTED OTHERWISE.

3. THE STRUCTURE HAS BEEN DESIGNED TO LIMIT THE MAXIMUM INTERSTOREY DRIFT AT THE SERVICEABILITY LIMIT STATE (SLS) TO h/500, FOR WIND LOADS WHERE 'h' IS THE FLOOR TO FLOOR HEIGHT BETWEEN TWO ADJACENT FLOORS, AND TO 0.025 hs FOR EARTHQUAKE LOADS, WHERE 'hs' IS THE HEIGHT OF THE STOREY.


4. NON STRUCTURAL ELEMENTS SUCH AS MOVEMENT JOINTS, THE BUILDING ENCLOSURE, MECHANICAL AND ELECTRICAL SERVICES AND SUPPORTS, AND THE LIKE, MUST BE DESIGNED AND DETAILED TO ACCOMMODATE, AS A MINIMUM, THE ANTICIPATED MOVEMENTS NOTED ABOVE.

TABLE 1 - VERTICAL DEFLECTION LIMITATIONS		
TYPE OF MEMBER	DEFLECTION TO BE CONSIDERED	DEFLECTION LIMITATION
DIMENSION LUMBER/GLUE-LAMINATED MEMBERS/PROPRIETARY MANUFACTURED WOOD ELEMENTS		
SIMPLE SPAN MEMBERS OF ALL FLOORS AND ROOFS	TOTAL LOAD	L/240 OR 25mm MAX
SIMPLE SPAN MEMBERS OF ROOFS AND PRE-ENGINEERD ROOF TRUSSES SUPPORTING CONSTRUCTION AND FINISHES SUSCEPTIBLE TO CRACKING	LIVE LOAD	L/240
GIRDERS/BEAMS SUPPORTING FLOOR FRAMING	LIVE LOAD	L/360
FLOOR FRAMING	LIVE LOAD	L/480


NOTE: ALL JOISTS ARE TO MEET THE VIBRATION REQUIREMENTS AS SET OUT IN THE NATIONAL BUILDING CODE.

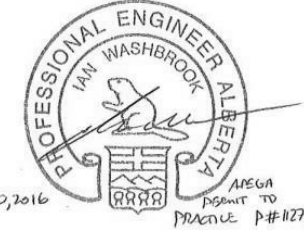5	2016-12-08	ISSUED FOR TENDER	AD	IW					
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Consultant's Name Nom de l'expert-conseil			Eng. Stamp Sceau de l'ingénieur						
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 Public Works and Government Services Canada		Travaux publics et Services gouvernementaux Canada							
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DESIGN NOTES									
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	AD	12/02/16							
Designed by/Concept par	Reviewed by/Revisé par	Scale/Echelle							
KL	IW	1 : 1							
PWGSC Project Manager/Administrateur de Projets TPSGC									
Randy Boldt									
Client Acceptance/Acceptation du client		Approved by/Approuvé par							
Task Responsible/Officer/Agent Responsable		PWGSC Project Manager/Administrateur de Projets TPSGC							
Project No./No. du projet	Asset No./No. du bien	Sheet No./ No. de la feuille							
C015-0870	File # 945								
Drawing Reference No./No. de référence du dessin		S003							

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3D ISO LOOKING NORTH

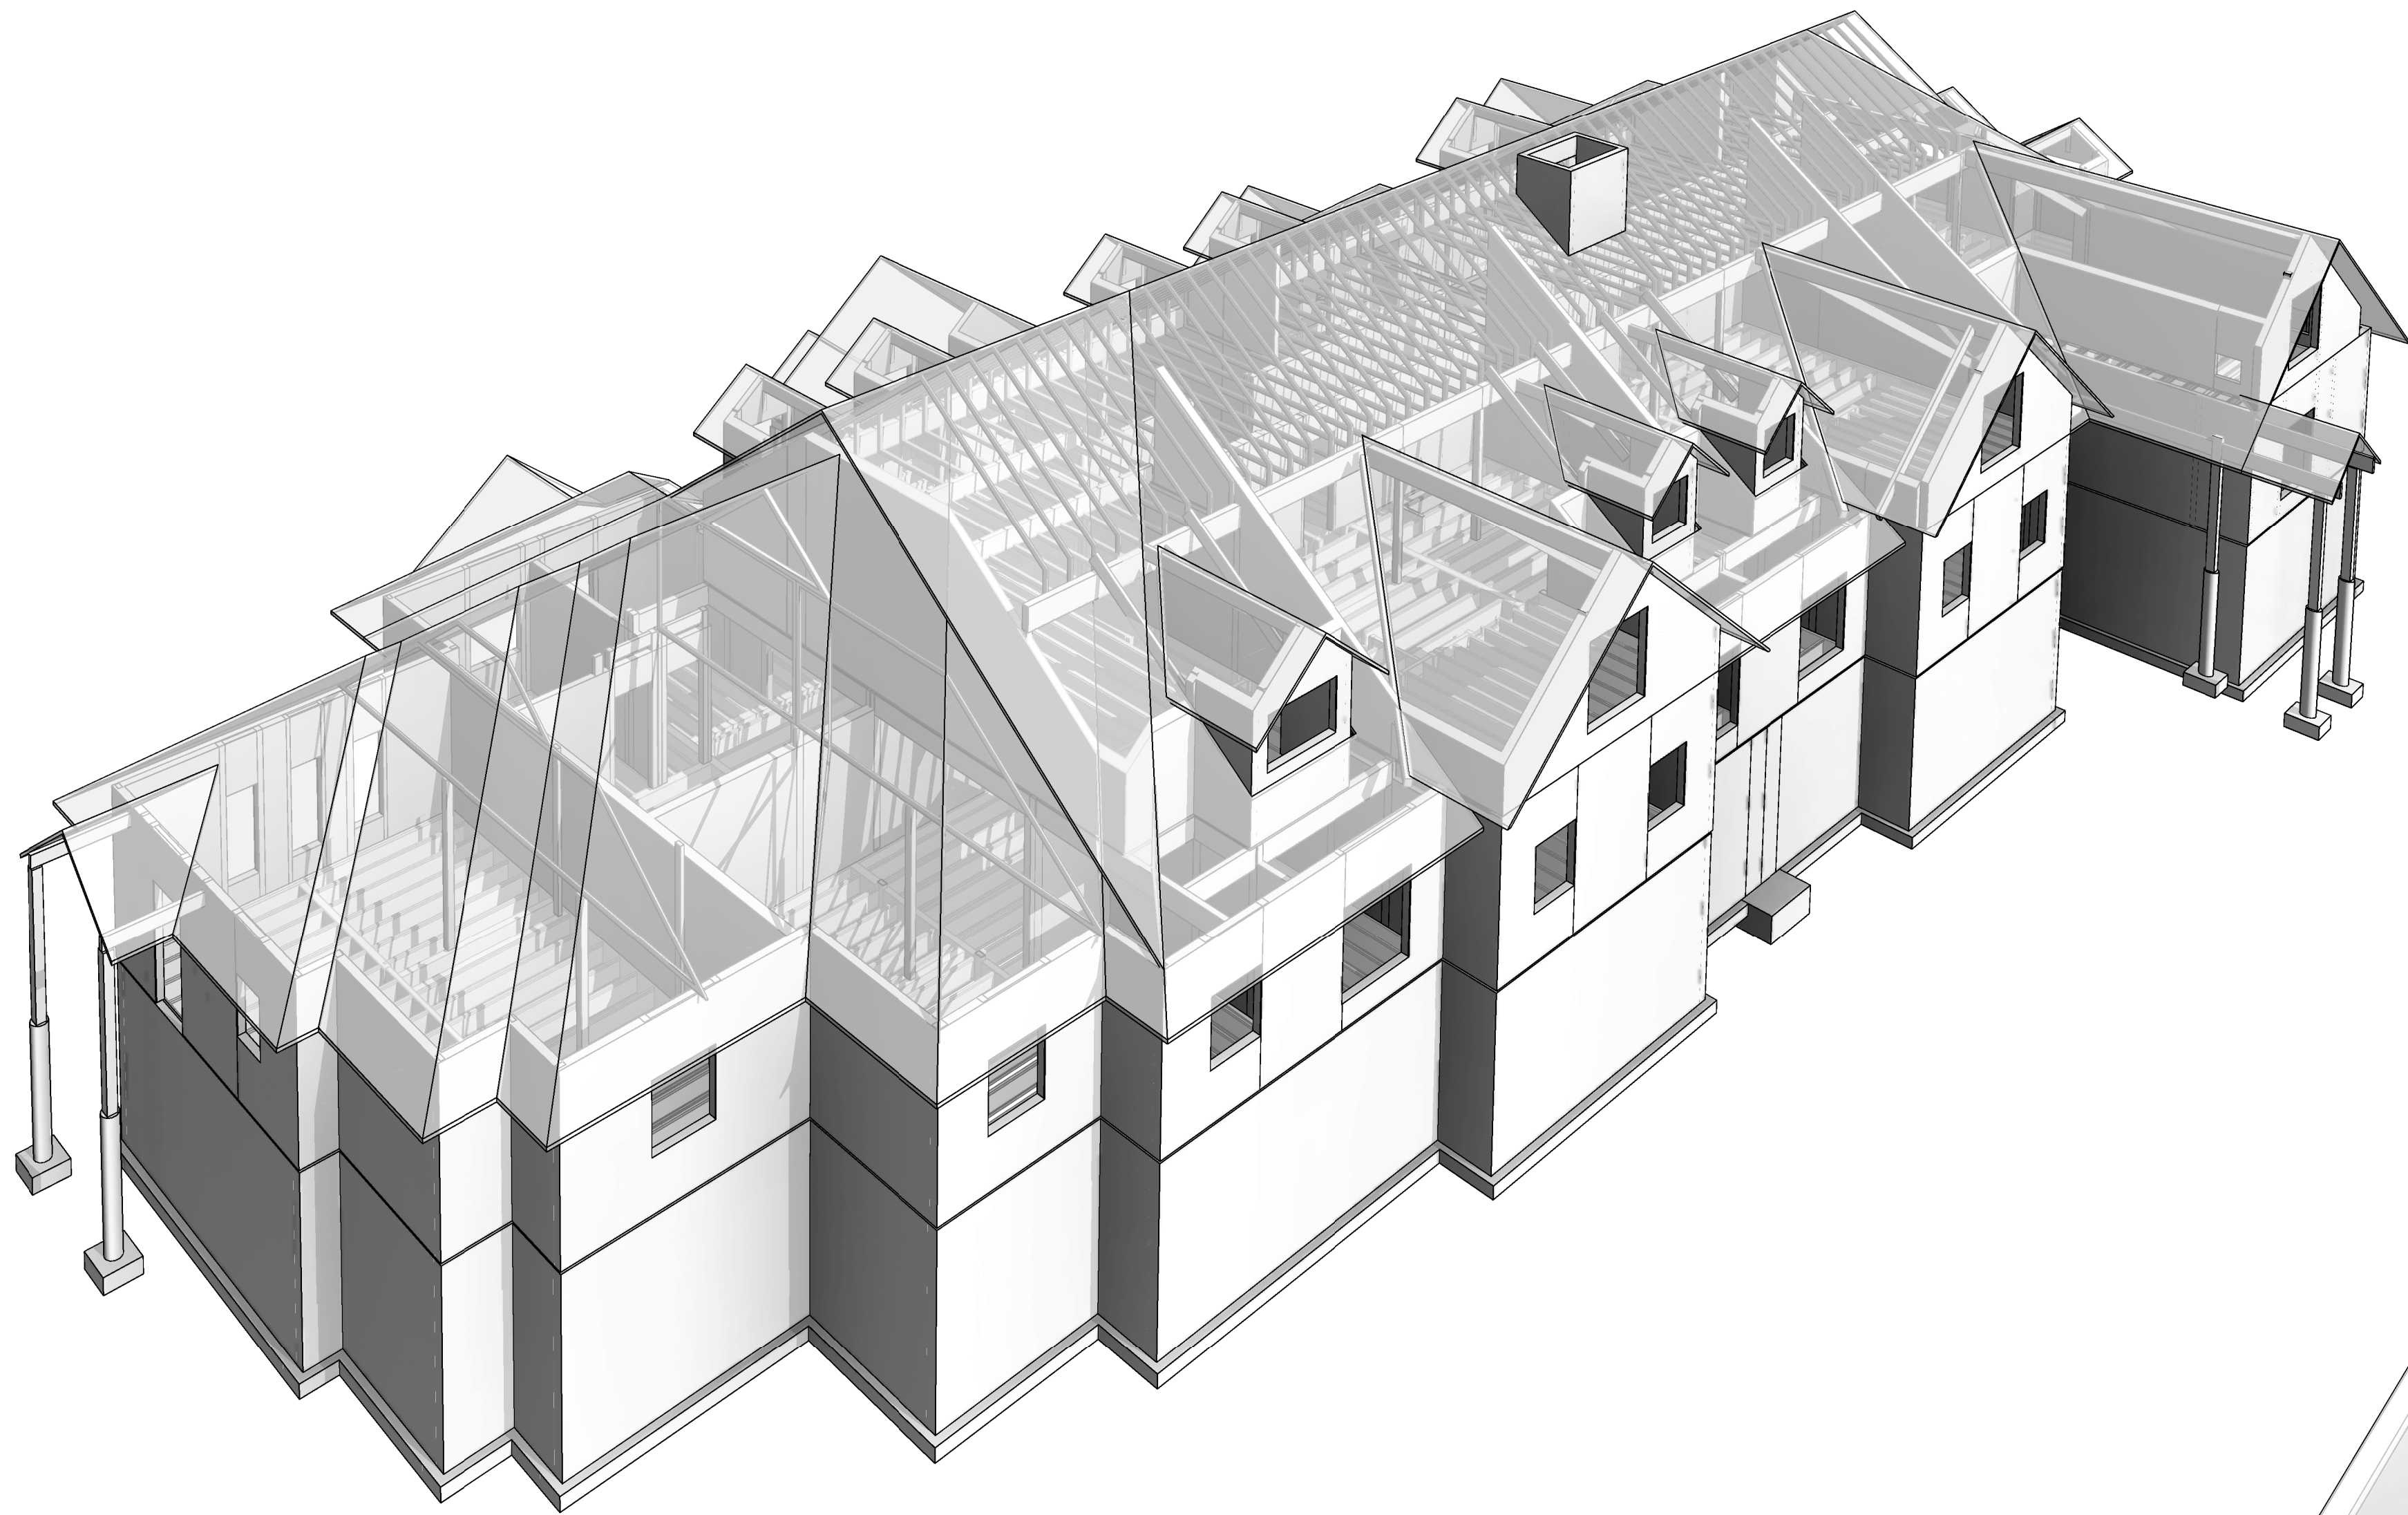


3D ISO LOOKING SOUTH

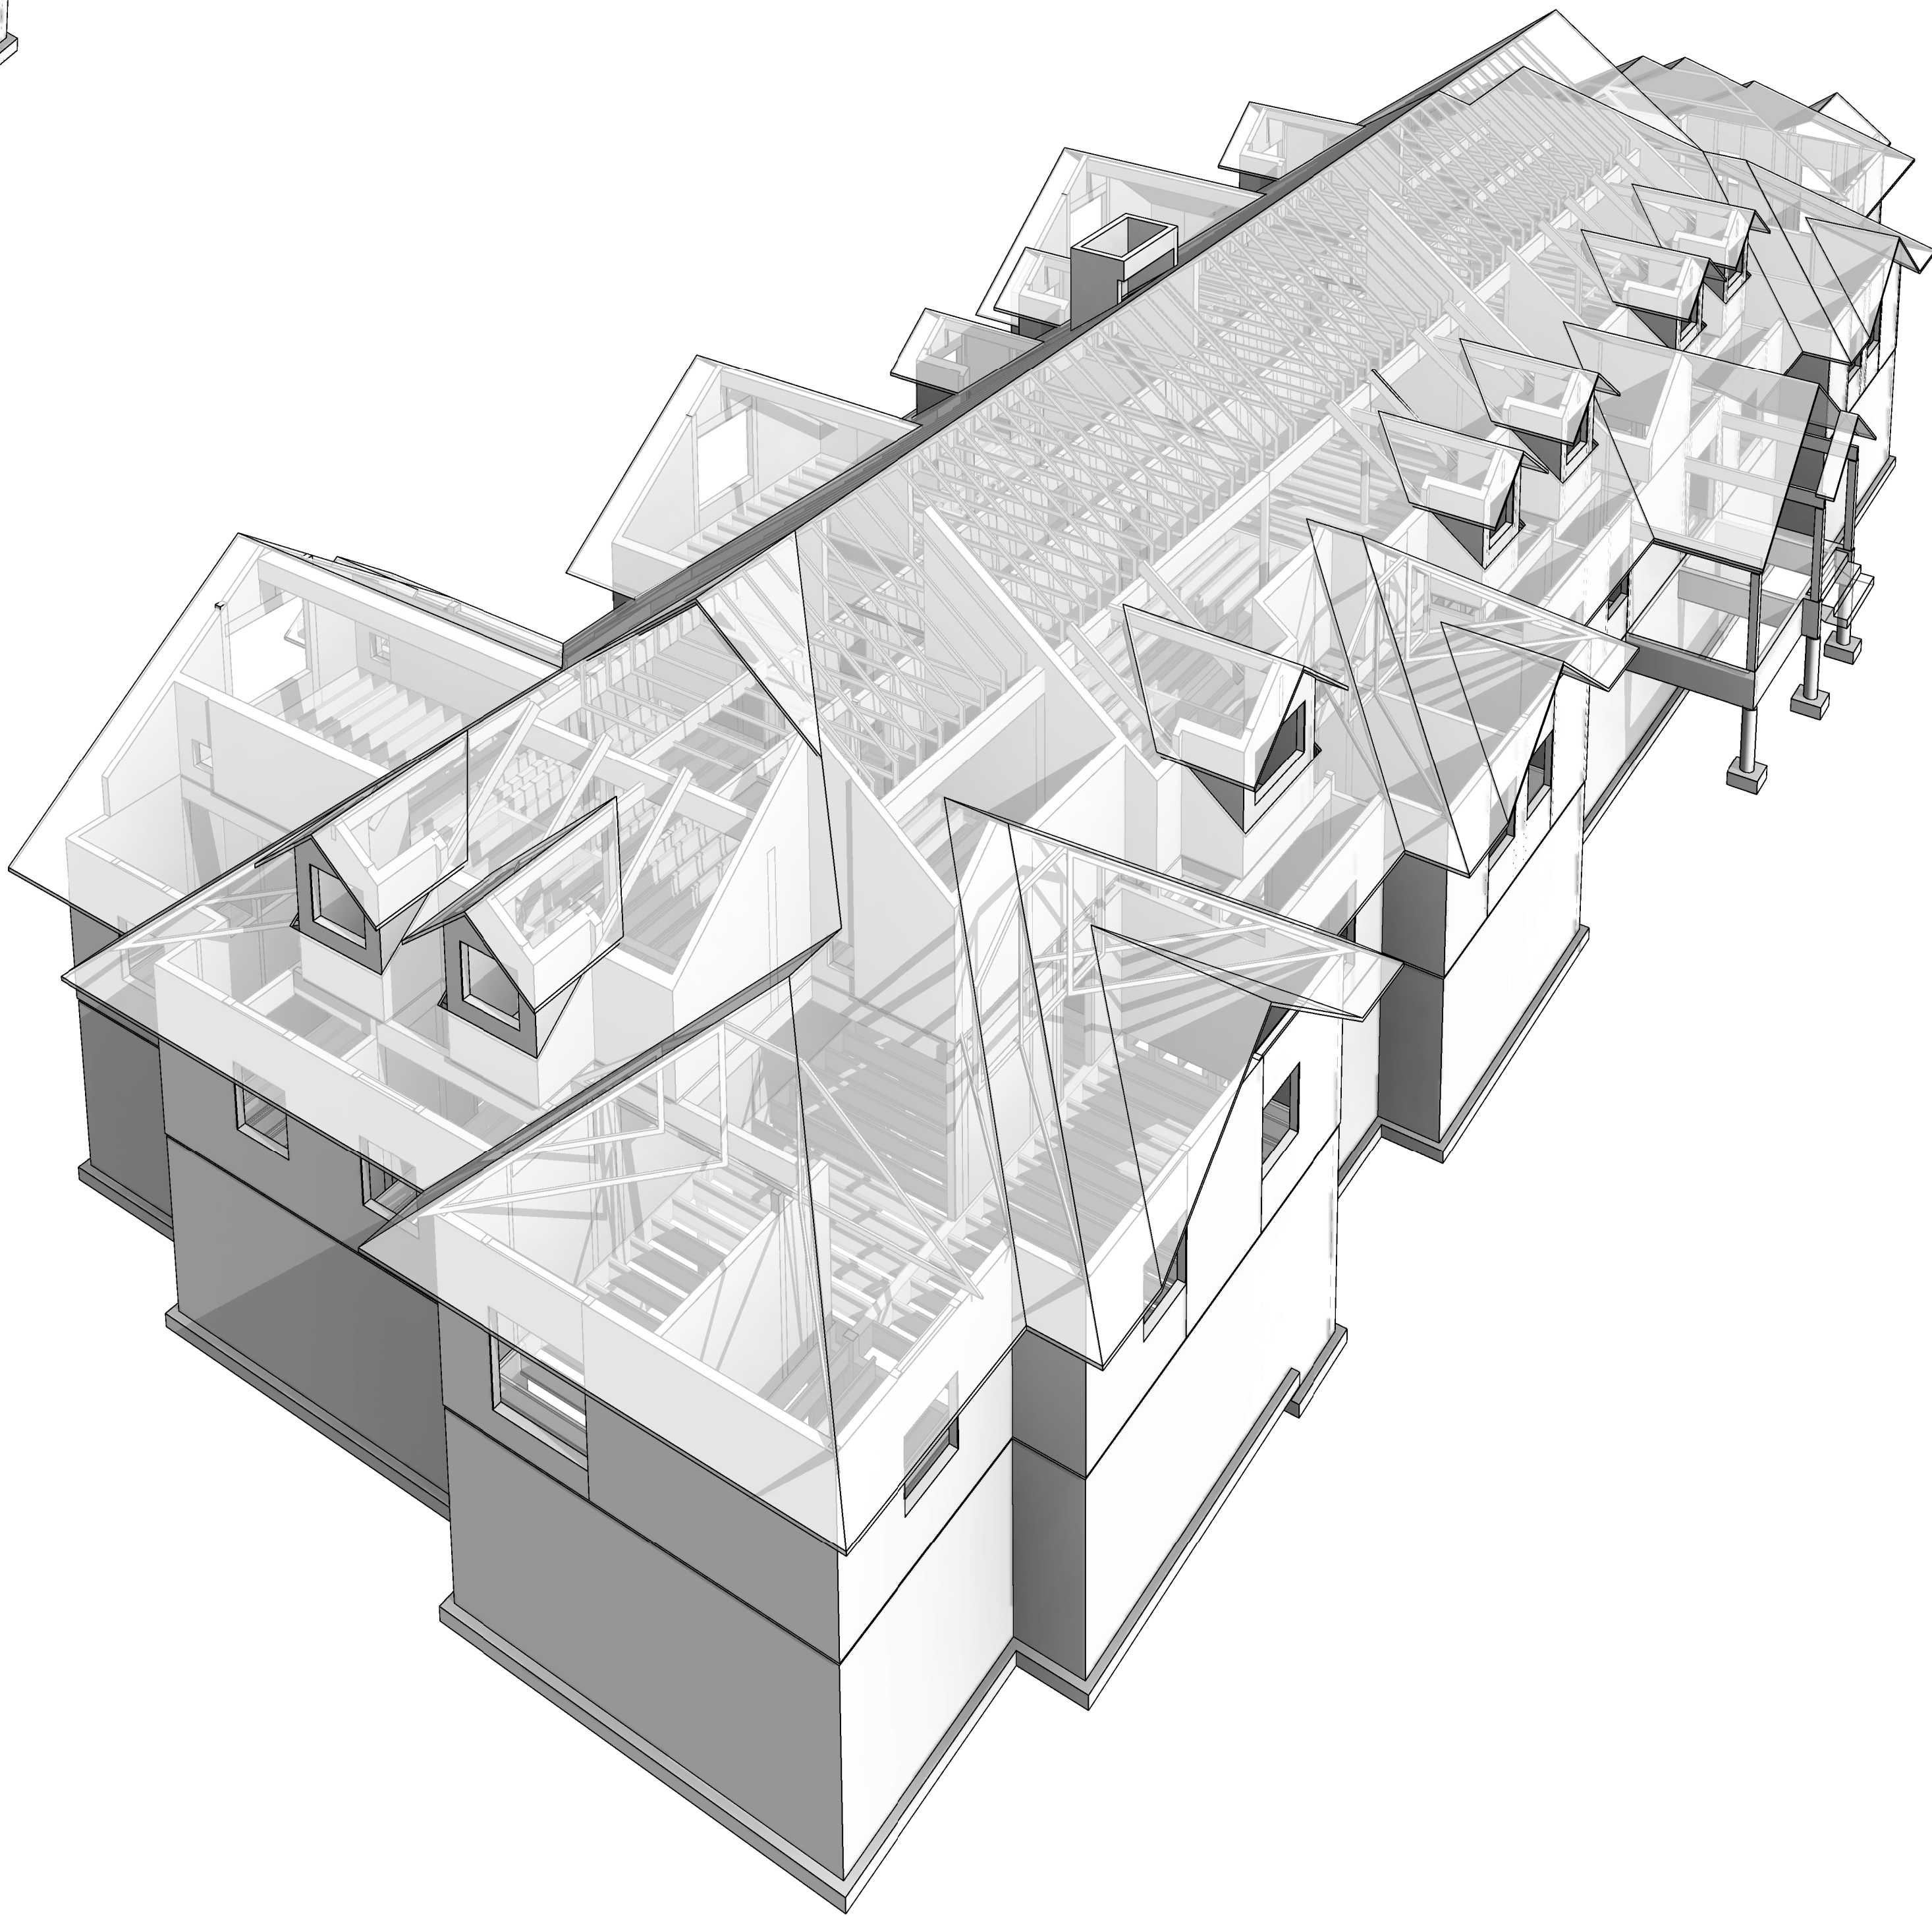DIAGRAM IS INDICATIVE ONLY. REFER TO
PLANS, SECTIONS AND SPECIFICATIONS

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No.	Date/Date	Description/Description	Drawn by Dessine par	Approved Approuvé
Revision / Revision				
		A detail number numéro de détail		
		B source drawing no. de dessin no.		
		C detail on drawing no. détail sur dessin no.		
Consultant's Name Nom de l'expert-conseil			Eng. Stamp Sceau de l'ingénieur	
ENTUITIVE 209 - 8th Avenue SW, Suite 300 Calgary, AB T2P 1B5 403-878-1270				
 Public Works and Government Services Canada			Travaux publics et Services gouvernementaux Canada	
Client Services Team Southern Alberta Operations Branch			Le Client Entretien l'Équipe Alberta Méridional Branche d'Opérations	
Canada				
Client/client  Parks Canada Agency			L'Agence Parcs Canada	
Western and Northern Region			Ouest et Nord du Canada	
Project title/Titre du projet				
Staff Housing Phase 2 Waterton Lakes National Park				
Drawing title/Titre du dessin				
3D REFERENCE VIEWS				
Surveyed by/Arpenté par		Drawn by/Dessiné par		Date/Date
		AD		12/02/16
Designed by/Concept par		Reviewed by/Revisé par		Scale/Echelle
KL		IW		
PWGSC Project Manager/Administrateur de Projets TPSGC				
Randy Boldt				
Client Acceptance/Acceptation du client			Approved by/Approuvé par	
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Project No./No. du projet		Asset No./No. du bien		Sheet No./ No. de la feuille
C015-0870		Fil # 945		S004
Drawing Reference No./No. de référence du dessin				

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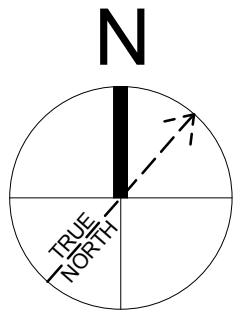


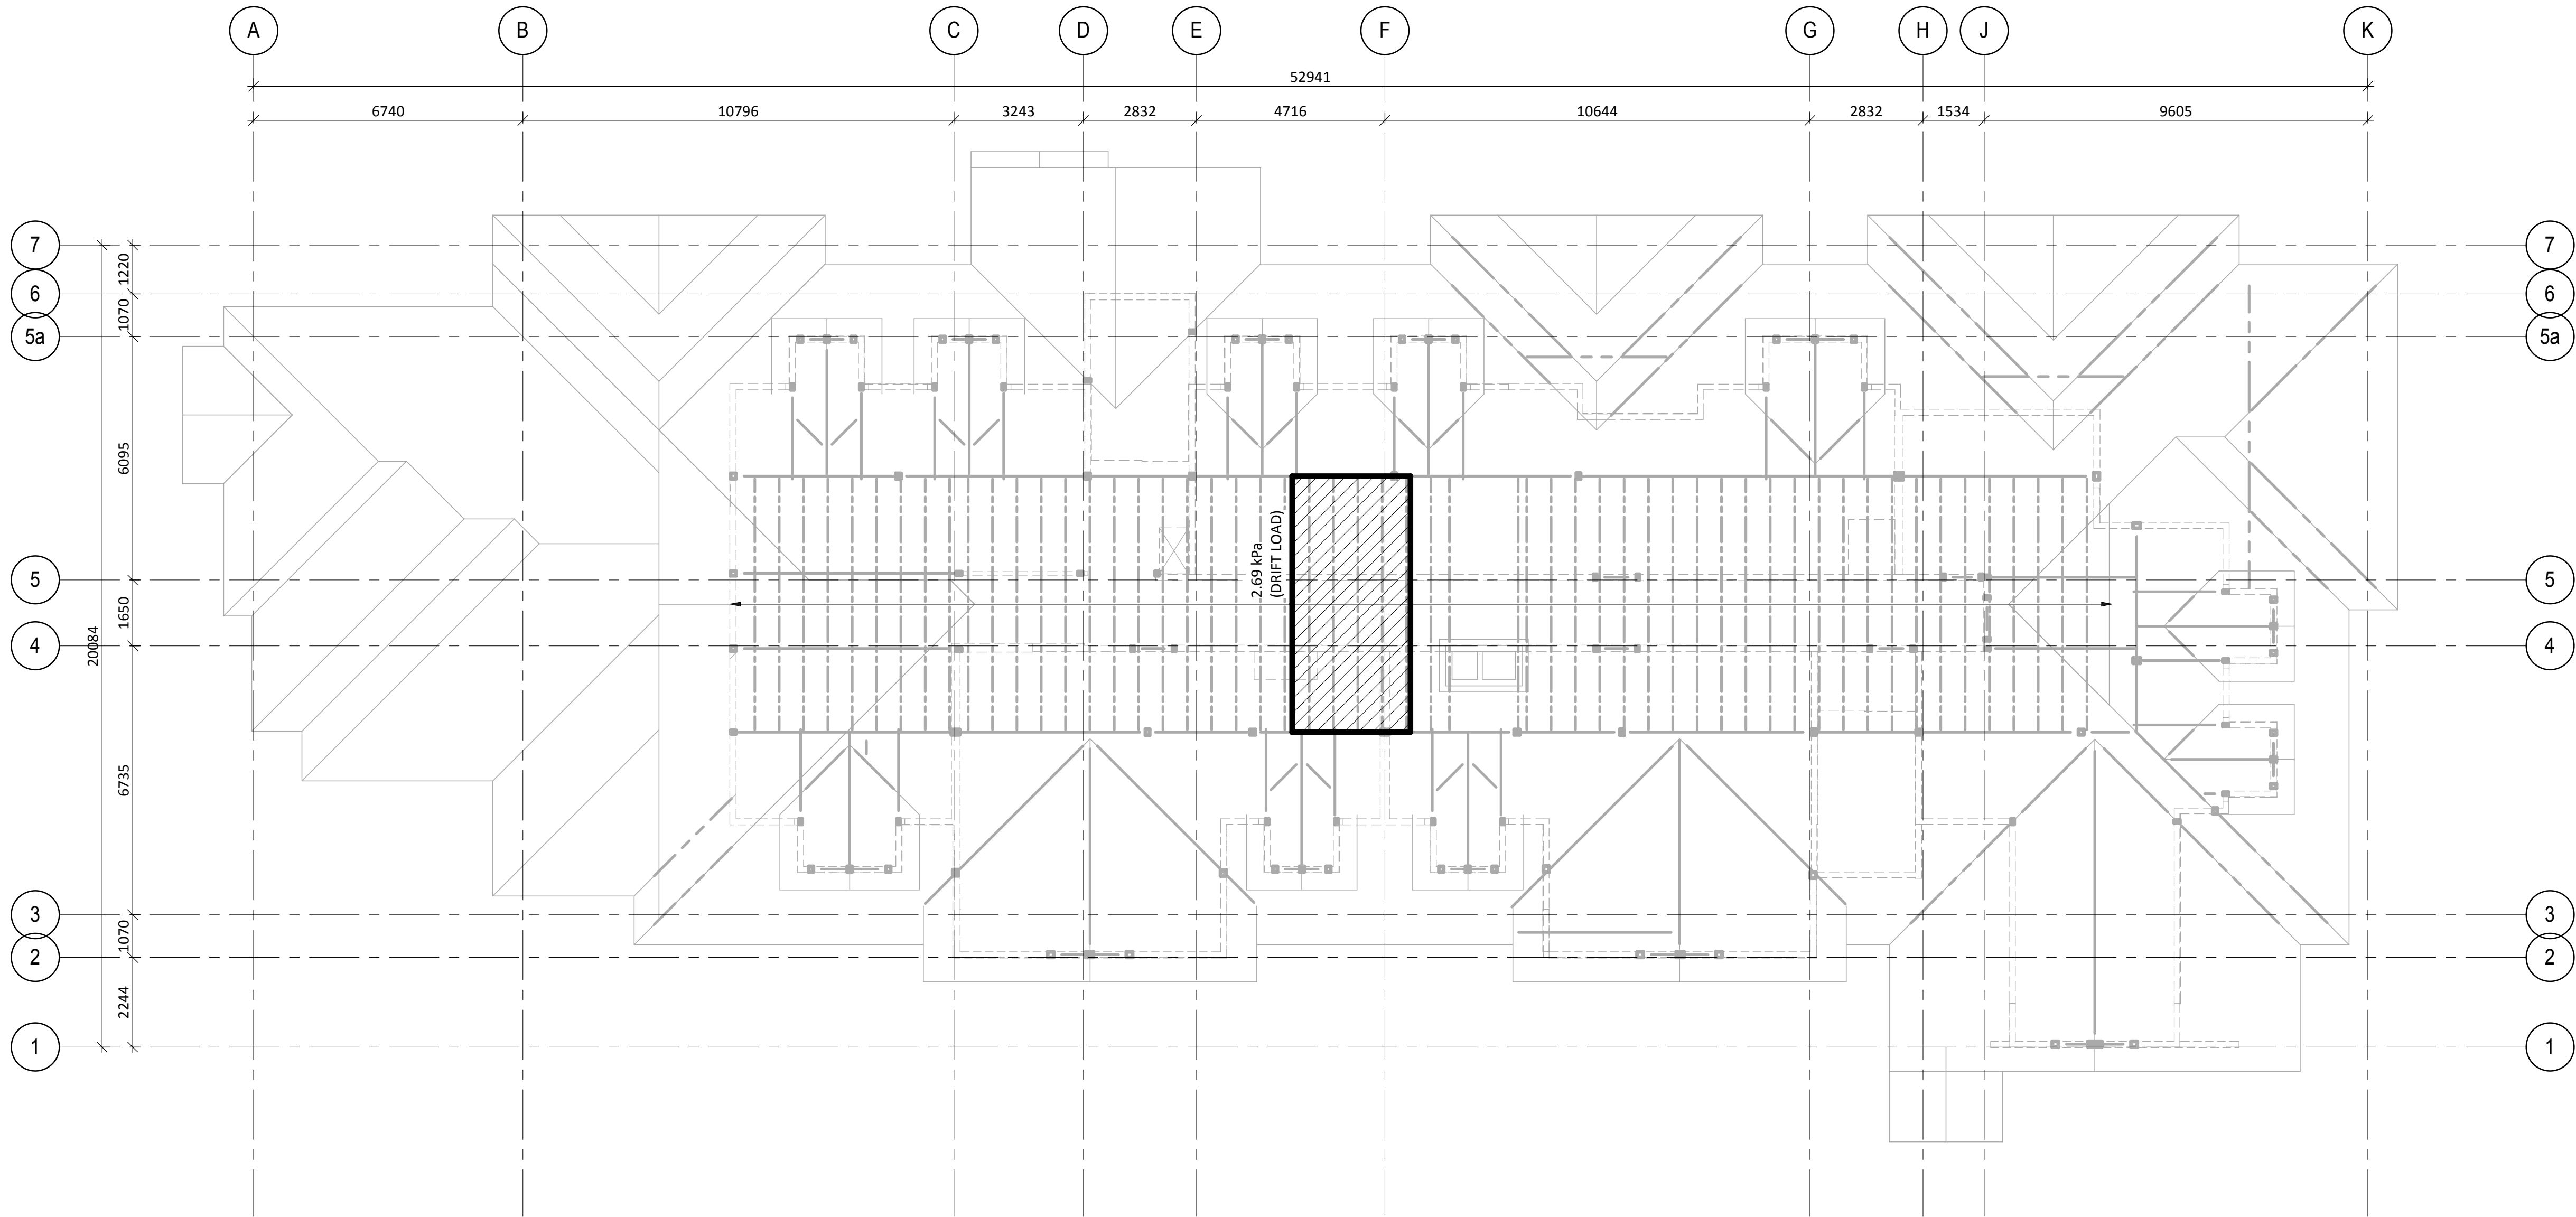ROOF LOADING PLAN

1:100

1. ROOF DRIFT LOAD TYPICAL UNO.

- GIRDERS/BEAMS = 4.0 kPa
- INDIVIDUAL MEMBERS = 5.1 kPa



5	2016-12-08	ISSUED FOR TENDER	AD	IW
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Consultant's Name
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Travaux publics et
Services gouvernementaux
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Southern Alberta
Operations Branch

Le Client Entretient l'Équipe
Alberta Méridional
Branche d'Opérations

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Parks Canada
Agence
Canada

L'Agence Parcs
Canada

Western and
Northern Region

Ouest et Nord
du Canada

Project title/Titre du projet

Staff Housing Phase 2
Waterton Lakes National
Park

Drawing title/Titre du dessin

ROOF LOADING
PLAN

Surveyed by/Arpenté par	Drawn by/Dessiné par	Date/Date
AD	AD	12/02/16
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KL	IW	1 : 100

PWGSC Project Manager/Administrateur de Projets TPSGC	
Randy Boldt	
Client Acceptance/Acceptation du client	Approved by/Approuvé par
Task Responsible/Officer/Agent Responsable	Project Manager/Administrateur de Projets TPSGC

Project No./No. du projet	Asset No./No. du bien	Sheet No./ No. de la feuille
C015-0870	FII # 945	S005
Drawing Reference No./No. de reference du dessin		

@ = AT

CL = CENTRE LINE

► = MOMENT CONNECTION

C = STEEL SADDLE CONNECTION

□ = OPENING

===== SAWCUT IN SLAB ON GRADE

L = SINGLE ANGLE

JL = BACK TO BACK ANGLES

□ = OPENING THROUGH CONCRETE BEAM

▼ = VERTICAL CONTROL JOINT IN MASONRY/CONCRETE WALL

MARK (SEE PLAN AND SCHEDULE) →

INDICATES OPENING IS REINFORCED

MARK (SEE PLAN AND SCHEDULE) →

CIRCULAR BEAM PENETRATION





RECTANGULAR BEAM PENETRATION



OPENINGS THROUGH STEEL BEAMS

STRUCTURE LEGEND	
MARK	DESCRIPTION
NEW STRUCTURE	INDICATES CONCRETE STRUCTURE ABOVE
	INDICATES CONCRETE UPTURNED BEAMS AND CURBS
	INDICATES CONCRETE/MASONRY STRUCTURE BELOW
	INDICATES CONCRETE IN SECTION
	INDICATES MASONRY WALL ABOVE AND IN SECTION
	INDICATES WOOD WALL ABOVE AND IN SECTION
	INDICATES WOOD SHEARWALL ABOVE AND IN SECTION
EXISTING STRUCTURE	INDICATES EXISTING CONCRETE STRUCTURE ABOVE
	INDICATES EXISTING CONCRETE UPTURNED BEAMS AND CURBS
	INDICATES EXISTING CONCRETE/MASONRY STRUCTURE BELOW
	INDICATES EXISTING CONCRETE IN SECTION
	INDICATES EXISTING MASONRY WALL ABOVE AND IN SECTION

G2
R

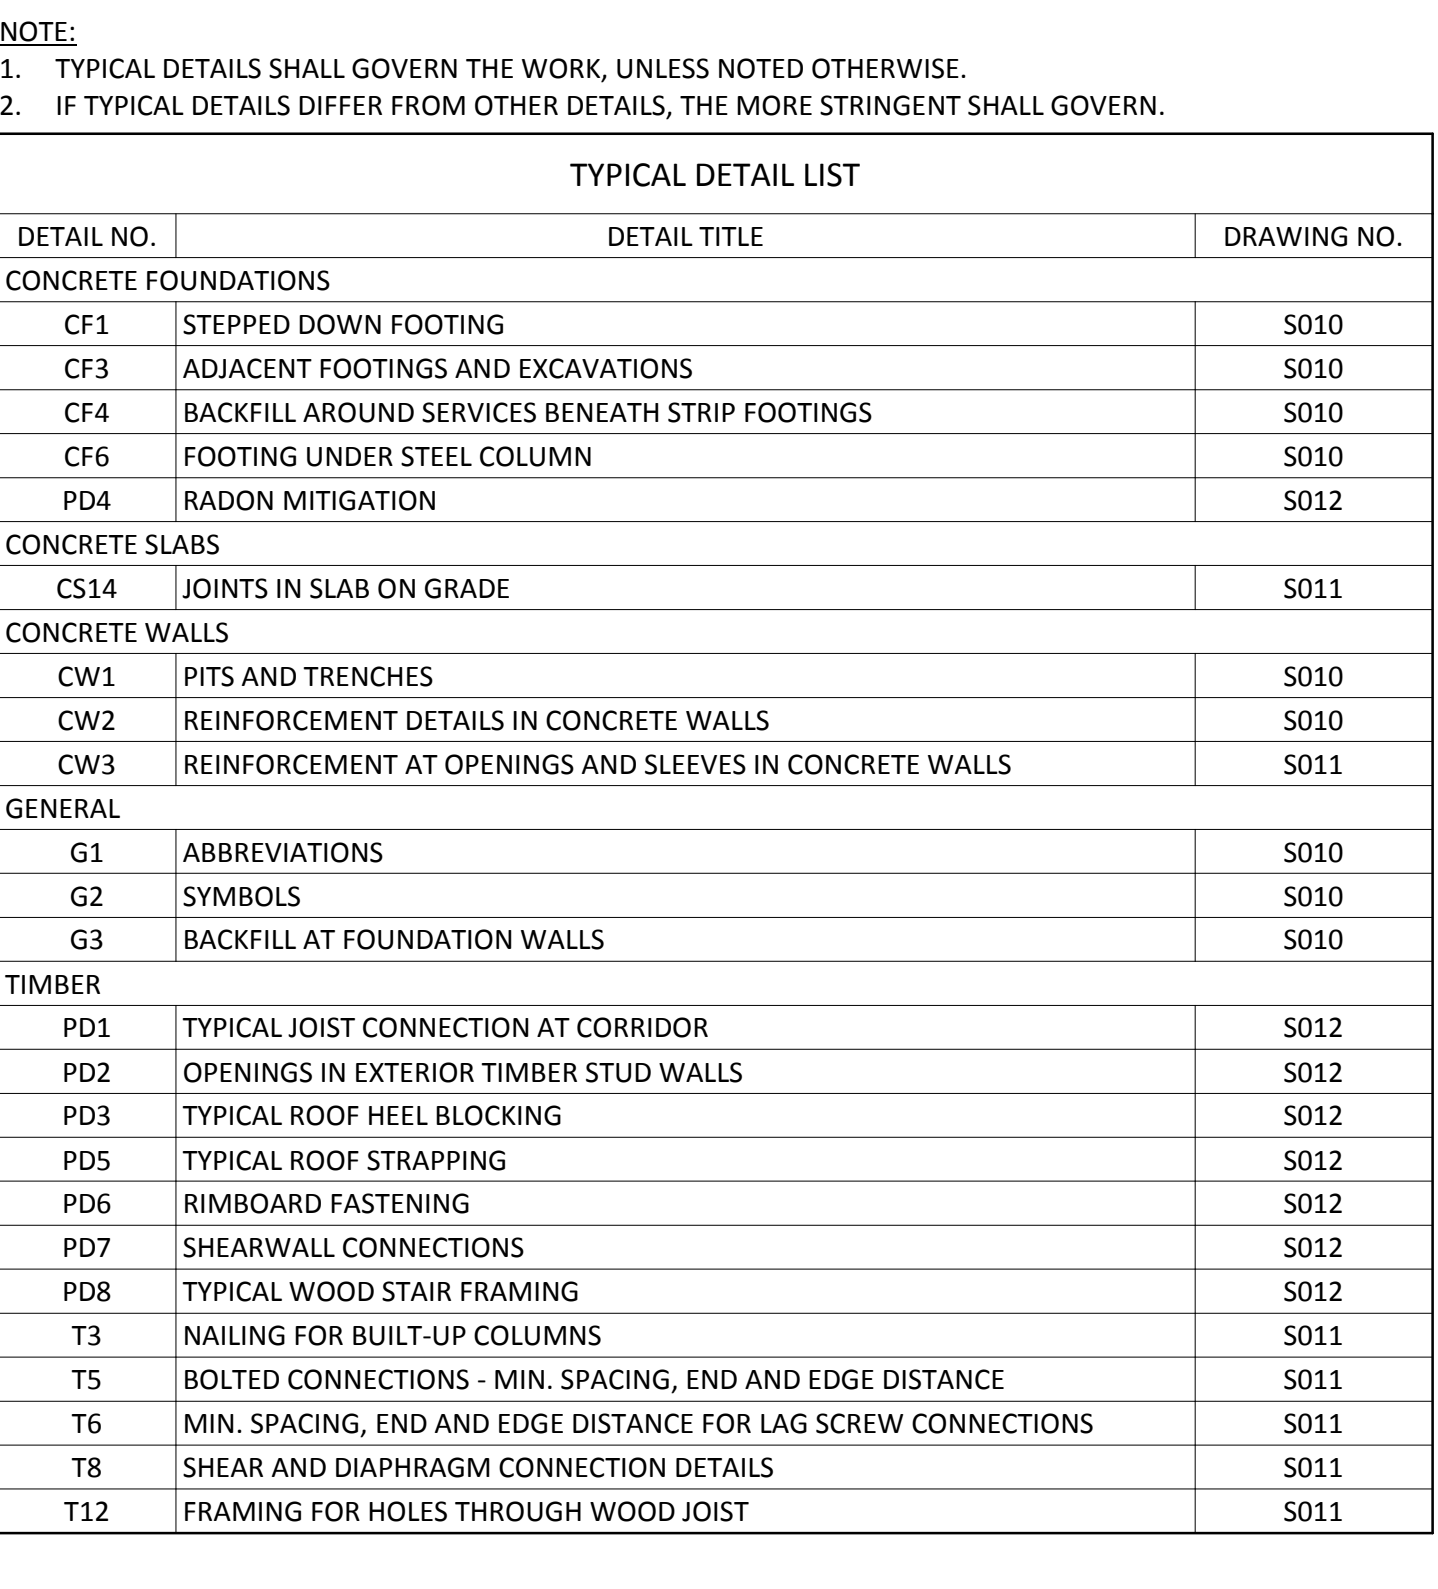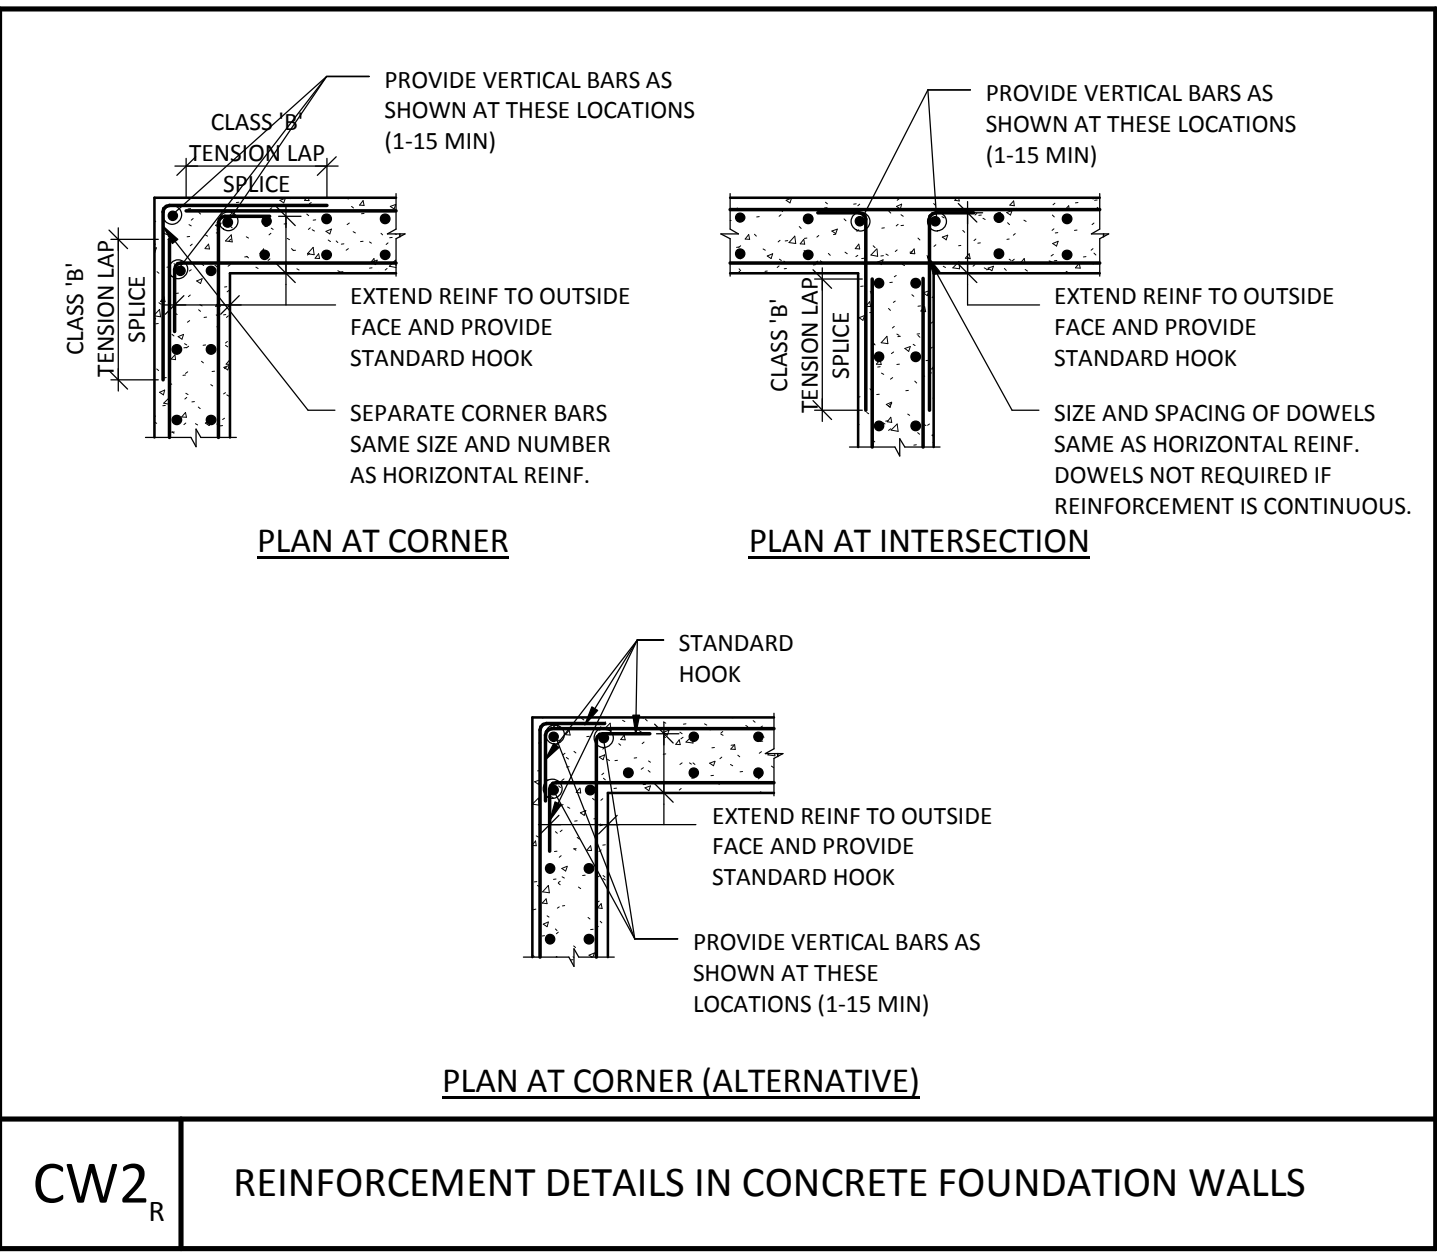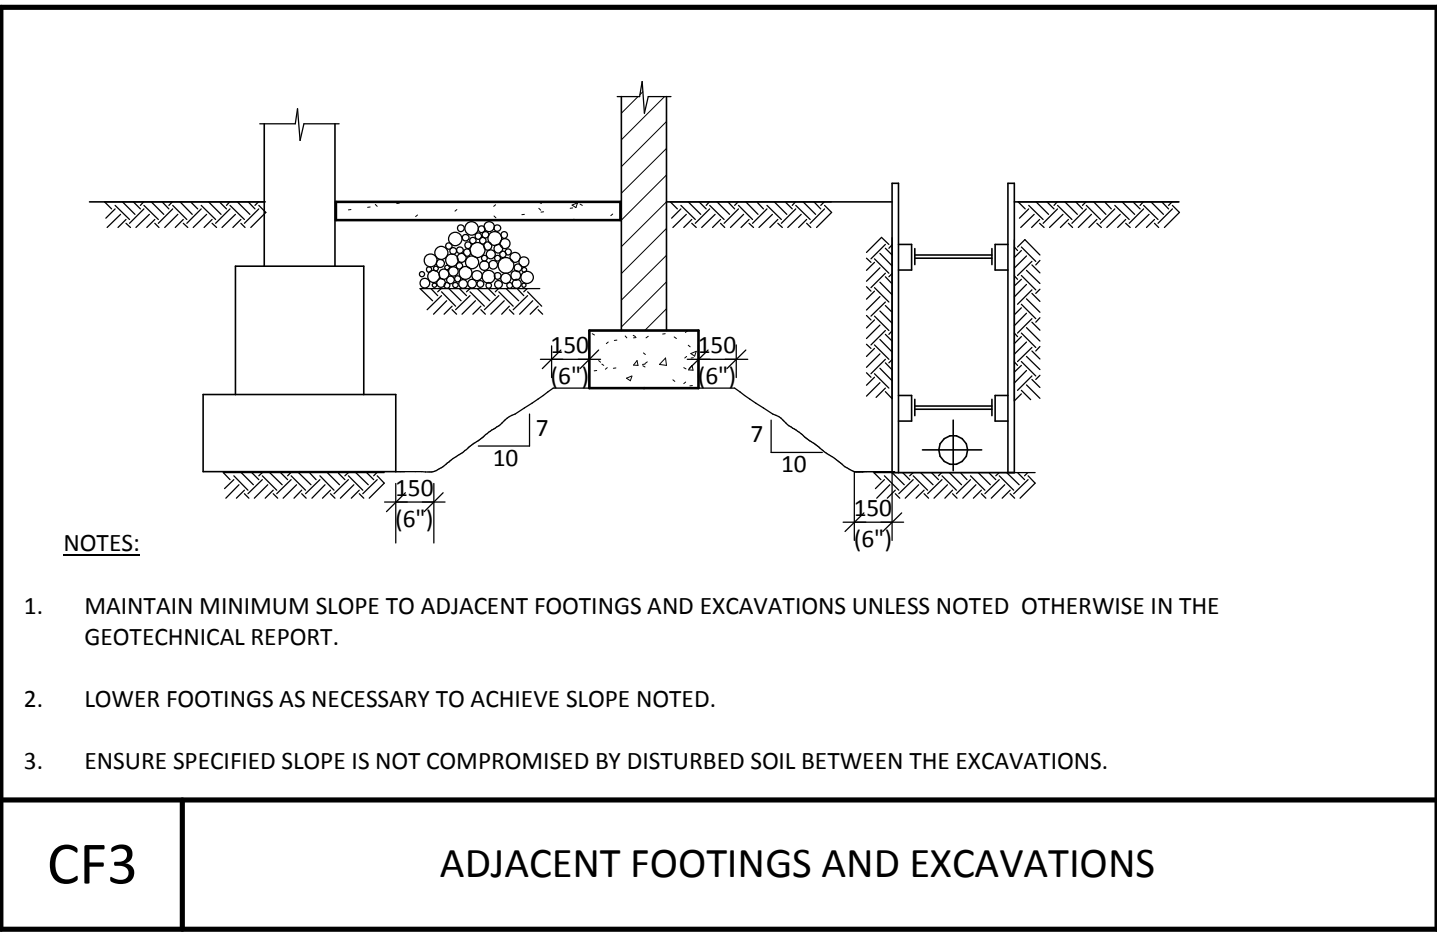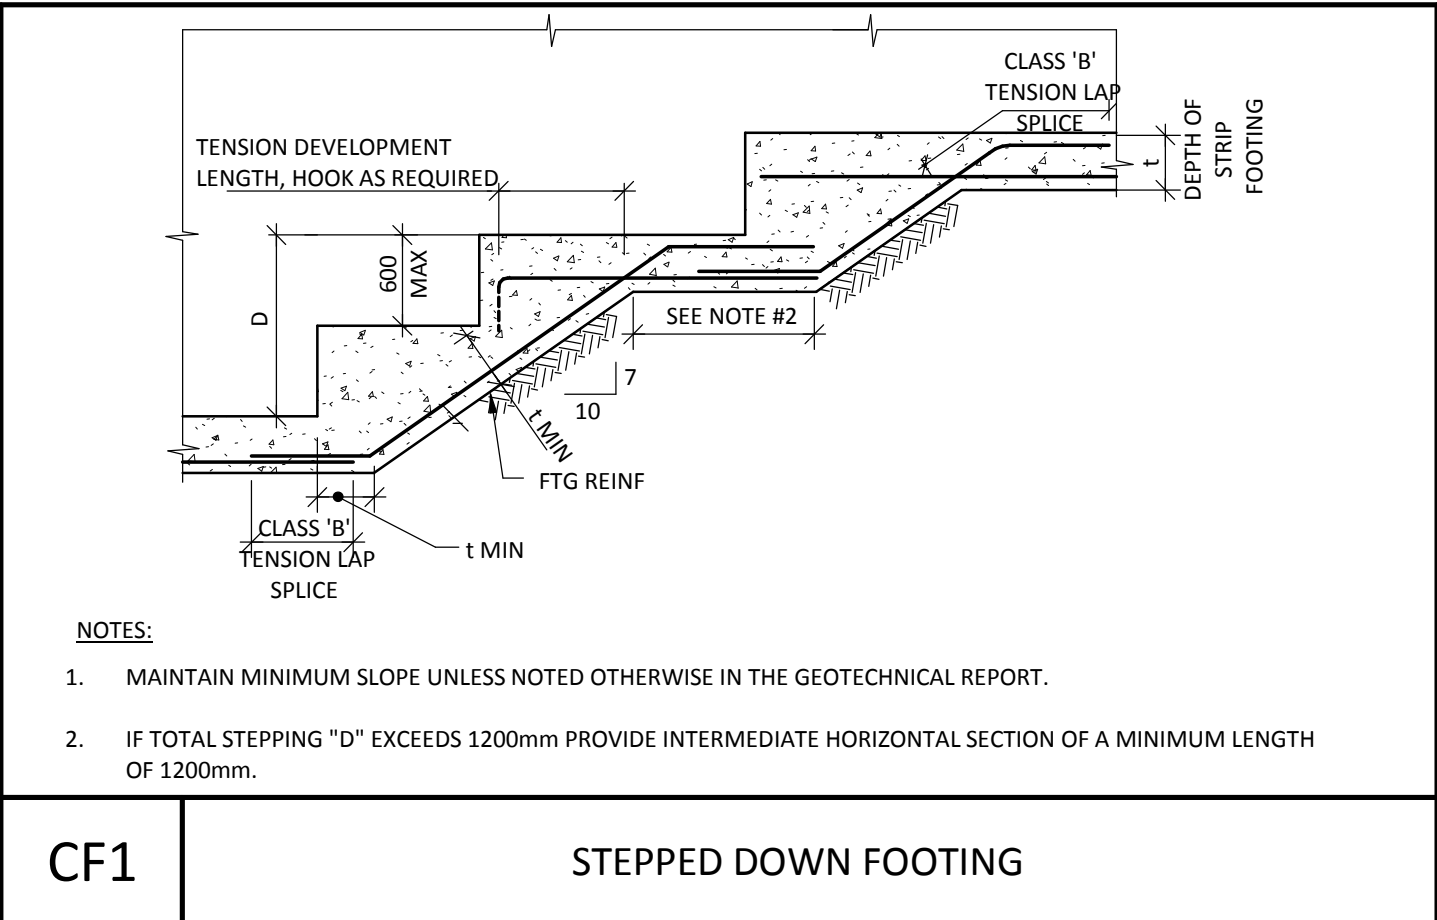SYMBOLS



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	<p>A detail number numero de detail</p> <p>B source drawing no. de dessin no.</p> <p>C detail on drawing no. detail sur dessin no.</p>
	

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IAN WASHBURN
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2004-11-17

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	Client Services Team Southern Alberta Operations Branch	Le Client Entretien l'Équipe Alberta Méridional Branche d'Opérations

Canada 🇨🇦

Client/client
 Parks Canada
 Agency L'Agence Parcs
 Canada

Western and Northern Region	Ouest et Nord du Canada
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Project title/Titre du projet

Staff Housing Phase 2 Waterton Lakes National Park

Drawing title/Titre du dessin

TYPICAL DETAILS

Surveyed by/Arpenté par	Drawn by/Dessiné par	Date/Date
	ADW	12/02/16
Designed by/Concept par	Reviewed by/Revisé par	Scale/Echelle
KL	IW	1 : 1
PWGSC Project Manager/Administrateur de Projets TPSCC		
Randy Bolt		
Client Acceptance/Acceptation du client	Approved by/Approuvé par	
Drawn/Designé (TPSC/Arpenté/Responsable)	PWGSC Project Manager/Administrateur de Projets (TPSC)	
Project No./No. du projet	Asset No./No. du bien	Sheet No./No. de la feuille
C015-0870	File # 945	
Drawing Reference No./No. de référence du dessin	S010	

HOOK BARS AS REQUIRED

1-15x1200 LG IN MIDDLE FOR 200mm WALLS AND 1-15x1500 LG EACH FACE FOR 250mm WALLS AND OVER.

HOOK REINF AT OPENING

DISPLACE WALL REINFORCEMENT EITHER SIDE OF OPENING

ADD TEMPERATURE REINF (As=0.001Ag) EA FACE WITHIN OPENING

OPENINGS IN CONCRETE FOUNDATION WALLS

500 MIN

100mm MIN BUT NOT LESS THAN DIAMETER OF LARGEST ADJACENT SLEEVE

SLEEVES

1-15 BOTTOM EACH SIDE

1-15x1800 LG EACH FACE BETWEEN SLEEVES. OMIT WHERE VERTICAL BARS GO BETWEEN SLEEVES.

SLEEVES IN CONCRETE FOUNDATION WALLS

NOTES:

- DO NOT MAKE OPENINGS LARGER THAN THE MAXIMUM DIMENSIONS NOTED ABOVE WITHOUT PRIOR APPROVAL FROM THE CONSULTANT UNLESS NOTED OTHERWISE.
- UNLESS NOTED OTHERWISE, REINFORCE AROUND OPENINGS IN CONCRETE WALLS AS NOTED ABOVE.

CW3

REINFORCEMENT AT OPENINGS AND SLEEVES IN CONCRETE FOUNDATION WALLS

SLAB REINFORCEMENT WHERE NOTED ON PLAN

1/4 OR MINIMUM 35 (1 1/2")

5mm (3/16")

ENSURE THAT REINFORCEMENT IS NOT SAWCUT

SAWCUT CONTROL JOINT

NOTES:

- SAW CUT SLAB ON GRADE WITHIN 6 TO 18 HOURS AFTER PLACING CONCRETE.
- COORDINATE EXACT LOCATIONS OF SAWCUTS IN SLAB ON GRADE WITH ARCHITECTURAL REQUIREMENTS.
- MAXIMUM SPACING OF SAWCUTS IN SLAB ON GRADE SHALL NOT EXCEED THE FOLLOWING, UNO.

SLAB THICKNESS 100 (4")	3000 (10'-0") MAXIMUM
SLAB THICKNESS 125 (5") OR GREATER	4500 (15'-0") MAXIMUM
- LIMIT LENGTH TO WIDTH RATIO OF ANY SAWCUT PANEL TO 1.5 MAXIMUM.
- SAWCUT SLAB ON GRADE AT LOCATIONS SHOWN ON PLAN OR AS NOTED BELOW. ALTERNATE LOCATIONS SHALL BE SUBMITTED TO CONSULTANT FOR REVIEW, WELL IN ADVANCE OF POURING SLAB ON GRADE.
- AFTER THE SLAB IS A MINIMUM 60 DAYS OLD, REMOVE ALL DEBRIS FROM THE SAW CUTS AND FILL WITH MORTAR CONTAINING CEMENT, SAND AND LATEX BONDING AGENT, OR AS NOTED IN SPECIFICATIONS.
- PRIOR TO SUBSTANTIAL COMPLETION OF THE PROJECT ROUT ALL CRACKS IN THE SLAB ON GRADE AND FILL WITH MORTAR CONTAINING CEMENT, SAND AND LATEX BONDING AGENT OR AS NOTED IN SPECIFICATIONS.

SAWCUT OR TOOL CONSTRUCTION JOINT AND FILL AS PER SAWCUT CONTROL JOINTS REQUIREMENTS.

CLASS 'B' TENSION LAP SPlice

1/2 OR 50mm (2") MIN

SLAB REINFORCEMENT WHERE NOTED ON PLAN

38 DEEP KEY

ADD 10@400 (16") IN MIDDLE LAYER x1200 (4'-0") LONG WHEN NO REINFORCEMENT IS NOTED ON PLAN.

CONSTRUCTION JOINT

REINFORCEMENT WHERE NOTED ON PLAN

13 (1/2")

75 (3")

75 (3")

1/2

PROVIDE 25mm (1") Ø x600mm (24") LONG SMOOTH DOWELS AT A SPACING OF NO GREATER THAN 2 TIMES THE SLAB THICKNESS, WHERE NOTED ON PLAN. LUBRICATE ONE HALF OF DOWEL & PLACE IN 26mm ID SLEEVE TO ALLOW FOR MOVEMENT ACROSS THE JOINT

BITUMINOUS FILLER

MOVEMENT JOINT

GRID

GRID

GRID

GRID

GRID

GRID

SEE DETAILS BELOW FOR SAWCUT PATTERN AT COLUMN

TYPICAL SAWCUT PATTERN IN SLAB ON GRADE

CONCRETE COLUMN (OR HOLLOW STEEL COLUMN)

STEEL COLUMN

PROVIDE "DIAMOND CUT" OR CREATE DIAMOND WITH FORMWORK.

CS14

JOINTS IN SLAB ON GRADE

LOAD PARALLEL GRAIN

LOAD PERPENDICULAR TO GRAIN

BOLT Ø	a	b	c	f	g	h	j	t	s
13mmØ	65	50	40	50	20	40	50	40	40
								65	56
								≥75	65
								40	45
16mmØ	80	65	50	65	25	50	65	65	60
								90	75
								≥95	80
								40	50
19mmØ	95	75	60	75	30	60	75	65	65
								90	80
								≥114	95
								40 TO 45	56
22mmØ	110	90	65	90	30	65	90	65	68
								90	83
								≥130	111
								40 TO 50	65
25mmØ	130	100	75	100	40	75	100	65	72
								90	87
								140	120
								≥150	125

NOTES:

- e = THE GREATER OF 1.5 TIMES BOLT DIAMETER OR HALF OF ACTUAL SPACING BETWEEN ROWS.

T5

BOLTED CONNECTIONS - MINIMUM SPACING, END AND EDGE DISTANCE

LOAD PARALLEL GRAIN

LOAD PERPENDICULAR TO GRAIN

LAG SCREW Ø	a	b	c	d	f	g	h	j	t	s
6mmØ	50	25	13	50	50	10	20	25	13	16
									≥40	32
									20	25
									≥57	50
9.5mmØ	67	40	20	50	50	13	30	40	≥40	36
									40	40
									≥75	65
									40	45
13mmØ	90	50	25	50	50	20	40	50	65	58
									≥75	65
									40	45
									65	60
16mmØ	111	65	32	65	65	25	50	65	90	75
									≥95	79
									65	65
									90	79
20mmØ	133	75	40	75	75	30	57	75	≥114	95

NOTES:

- e = THE GREATER OF 1.5 TIMES BOLT DIAMETER OR HALF OF ACTUAL SPACING BETWEEN ROWS.
- LOADED END DISTANCES ARE MINIMUM PERMITTED FOR TENSION MEMBERS.

T6

LAG SCREW CONNECTIONS - MINIMUM SPACING, END AND EDGE DISTANCE

JOIST SUPPORT

L

L/3

L/3

L/3

d/4

d/4

d/4

2x8 MINIMUM SIZE

38 Ø MAX HOLE SIZE

MIN. 8x Ø OF LARGER HOLE

STUD WALL SUPPORT

HOLES FOR PASSAGE OF WIRES AND CONDUIT PERMITTED IN THIS ZONE

SMALL HORIZONTAL HOLES IN JOIST

NOTES:

- THIS TYPICAL DETAIL IS APPLICABLE ONLY FOR SIMPLY SUPPORTED AND UNIFORMLY LOADED JOISTS
- HOLES INDICATED ARE FOR THE PASSAGES OF WIRES, CONDUIT AND PIPES; NOT FOR THE ATTACHMENT OF HANGING BRACKETS OR HARDWARE.
- HOLES NOT CONFORMING TO THIS TYPICAL DETAIL MUST BE APPROVED BY THE STRUCTURAL ENGINEER.
- REFER TO GUIDELINES SETOUT BY PROPRIETARY MANUFACTURED WOOD SUPPLIERS.

T12_R

FRAMING FOR HOLES THROUGH WOOD JOIST

CHORD SPLICE DETAILS

REFER TO SPACING, END, AND EDGE DISTANCE REQUIREMENTS FOR NAILS

REFER TO SPACING, END, AND EDGE DISTANCE REQUIREMENTS FOR BOLTS

A NAILED LAP SPLICE IN A CONTINUOUS TOP PLATE

B BOLTED CHORD SPLICE

38x89 (2"x4")

38x140 (2"x6")

2-PLY - 76mm (3") NAILS

38x184 (2"x8")

38x89 (2"x4")

38x140 (2"x6")

3-PLY - 114mm (4-1/2") NAILS

38x184 (2"x8")

38x89 (2"x4")

38x140 (2"x6")

4-PLY - 150mm (6") NAILS

38x184 (2"x8")

NOTE:

- * END DISTANCE VALUES ARE SHOWN FOR D, FIR-L, HEM-FIR, AND WESTERN CEDAR. FOR S-P-F AND NORTHERN, DISTANCES MAY BE DECREASED TO 80% OF THOSE SHOWN.

T8

SHEAR AND DIAPHRAGM CONNECTION DETAILS

5	2016-12-08	ISSUED FOR TENDER	AD	IW
4	2016-12-08	ISSUED FOR BUILDING PERMIT	AD	IW
3	2016-09-02	ISSUED FOR 99%	AD	IW
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No.	Date/Date	Description/Description	Drawn by/Dessiné par	Approved/Approuvé

Revision / Revision

A

C

A

B

C

Consultant's Name
Nom de l'expert-conseil

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Ouest et Nord du Canada

Project title/Titre du projet

**Staff Housing Phase 2
Waterton Lakes National Park**

Drawing title/Titre du dessin

**TYPICAL
DETAILS**

Surveyed by/Arpenté par
AD

Designed by/Concept par
KL

Drawing Reference No./No. de référence du dessin

Drawn by/Dessiné par
AD

Reviewed by/Revisé par
IW

Asset No./No. du bien
FII # 945

Date/Date
12/02/16

Scale/Echelle
1 : 1

PWGSC Project Manager/Administrateur de Projets TPSGC
Randy Boldt

Client Acceptance/Acceptation du client

Approved by/Approuvé par









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Project No./No. du projet
C015-0870

Sheet No./No. de la feuille
S011

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Project title/Titre du projet


**Staff Housing Phase 2
Waterton Lakes National Park**

Drawing title/Titre du dessin

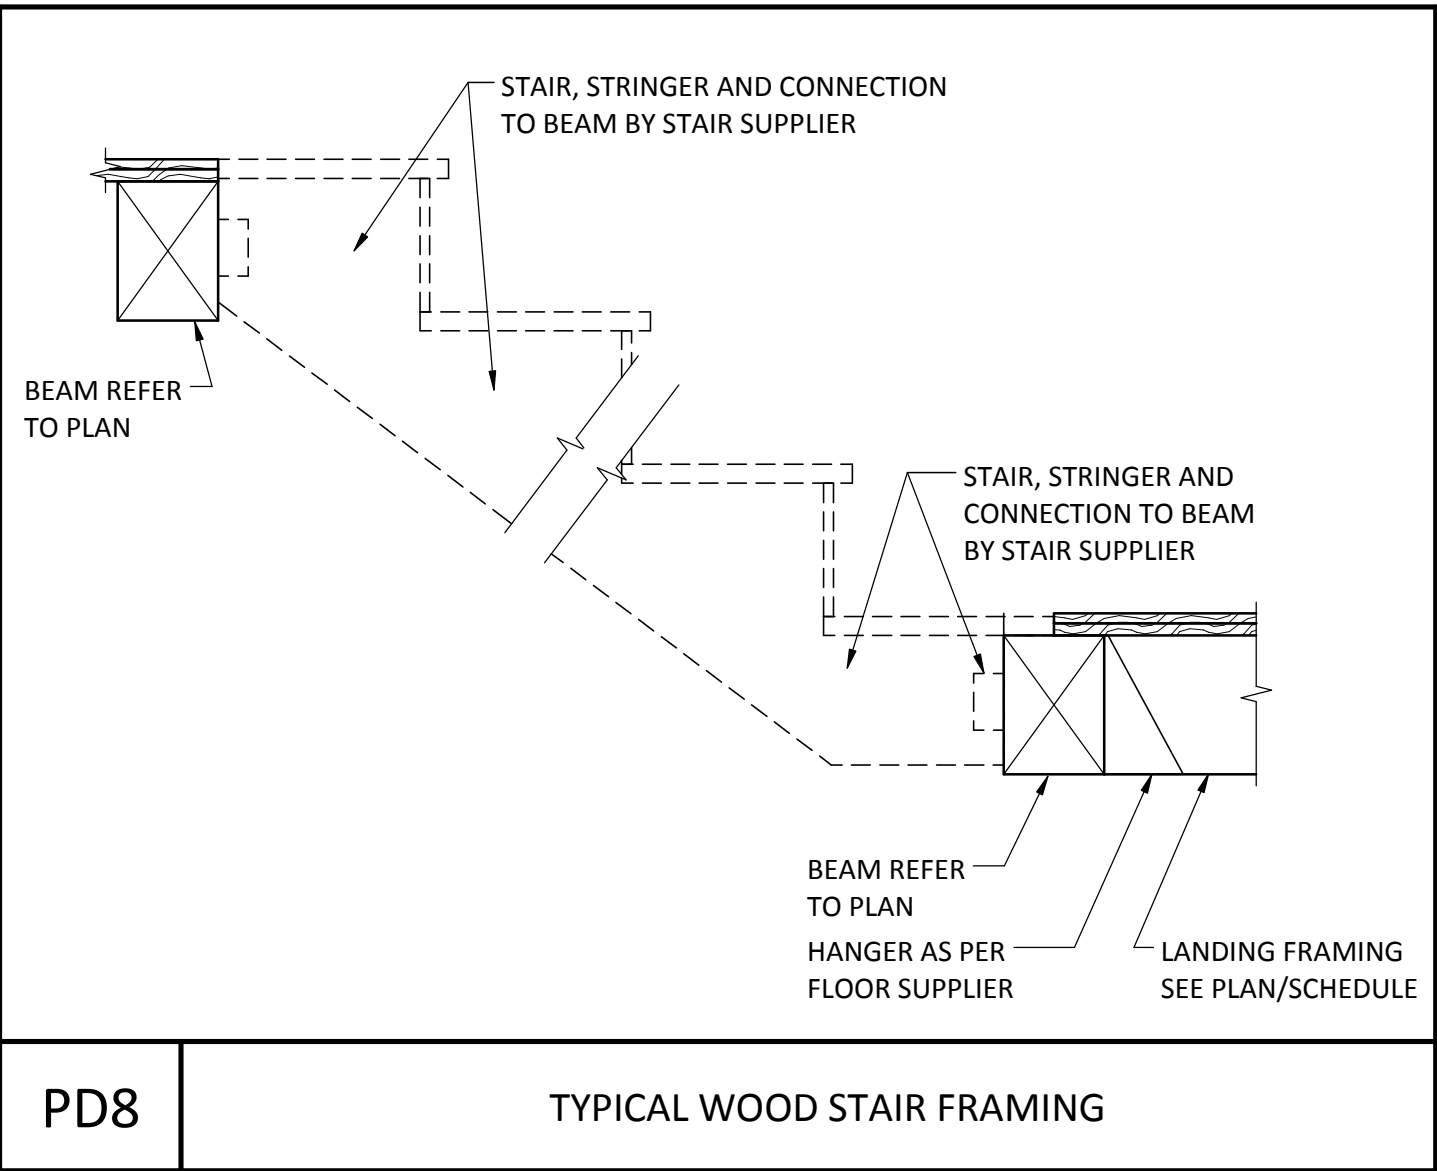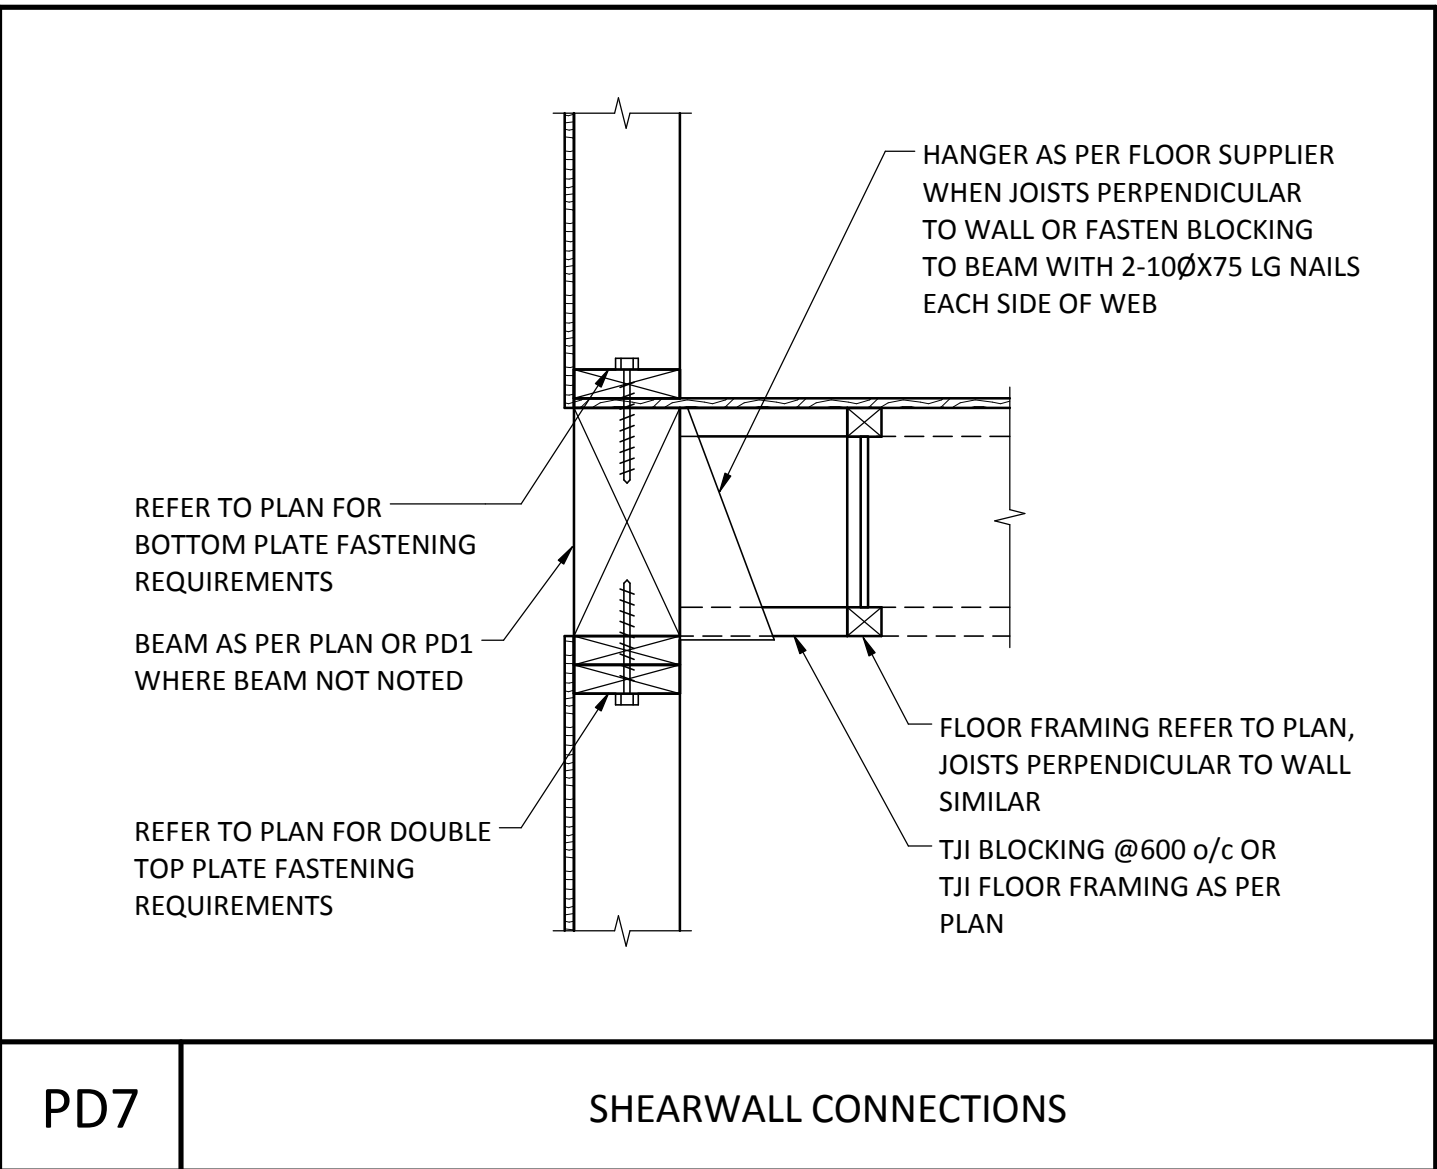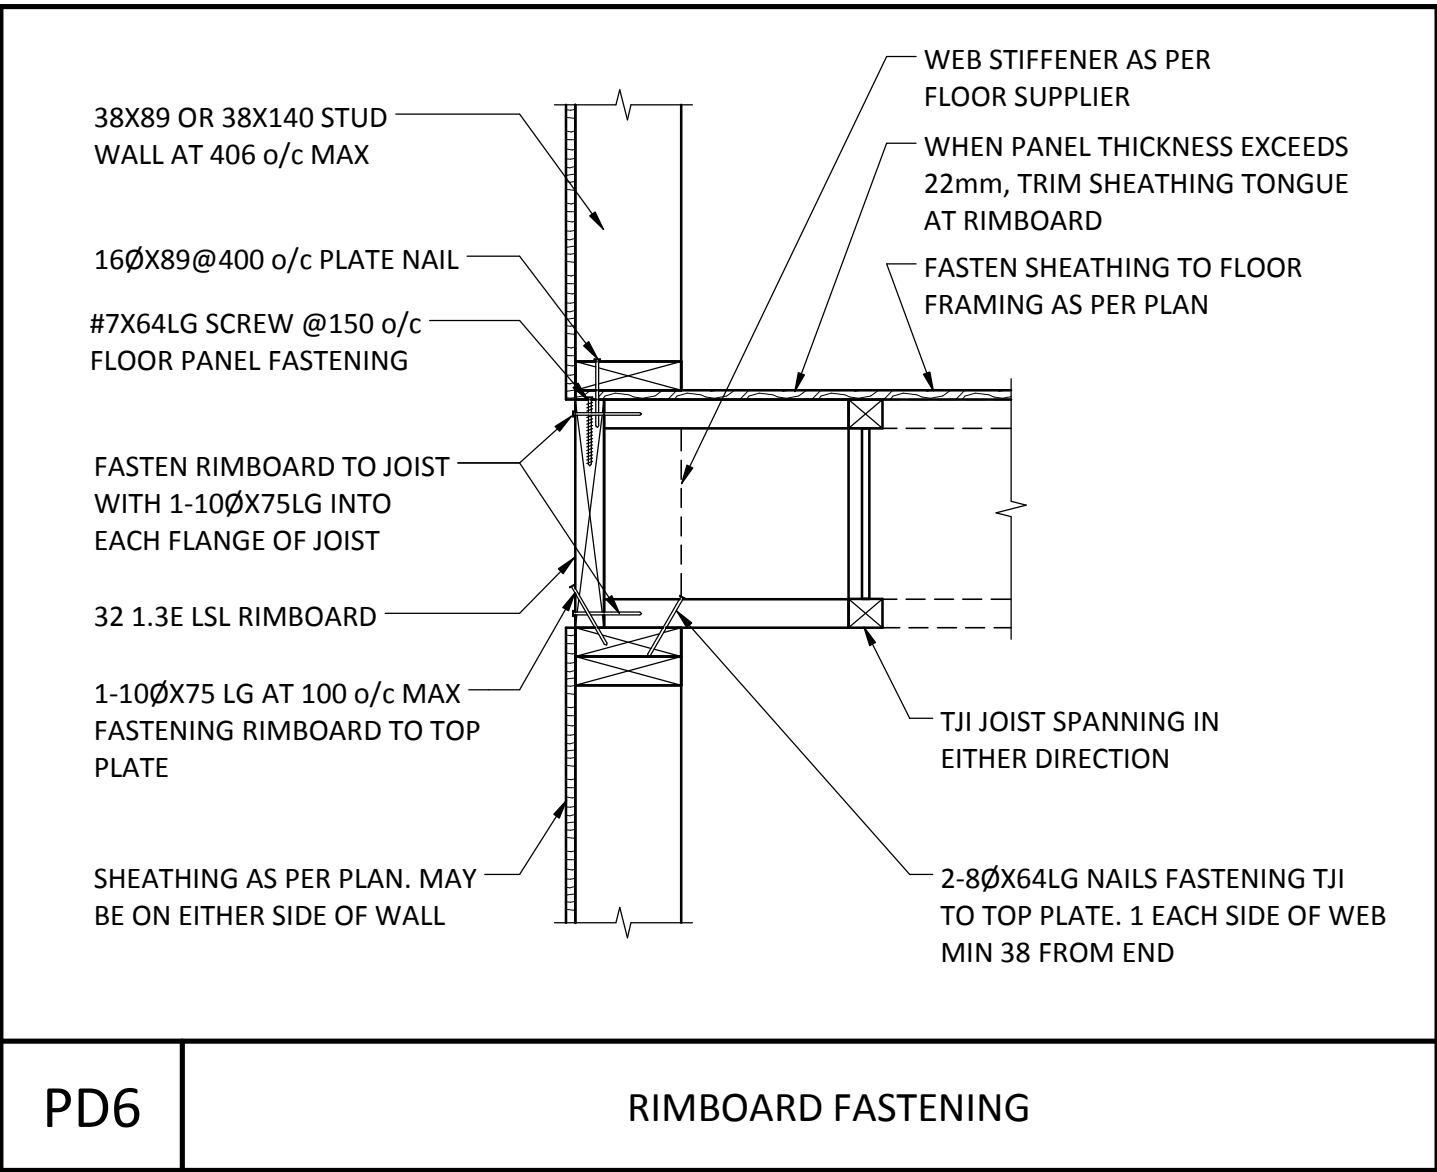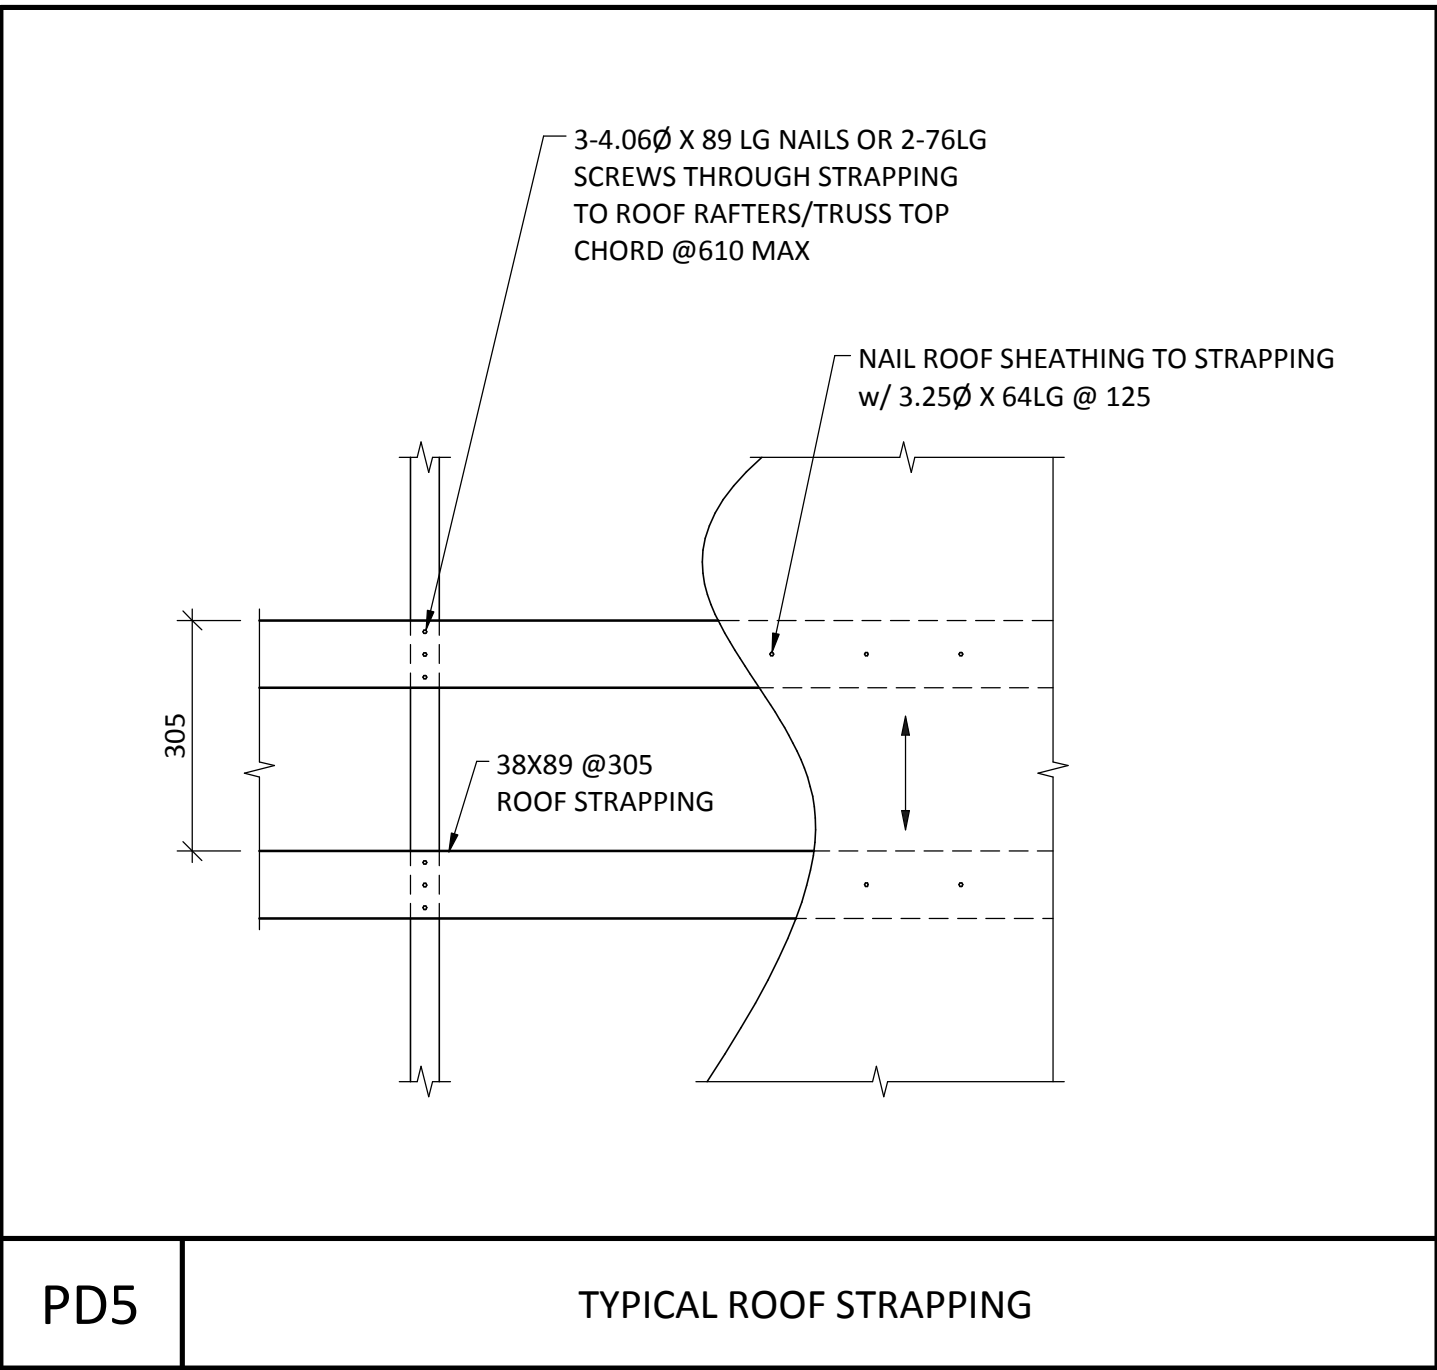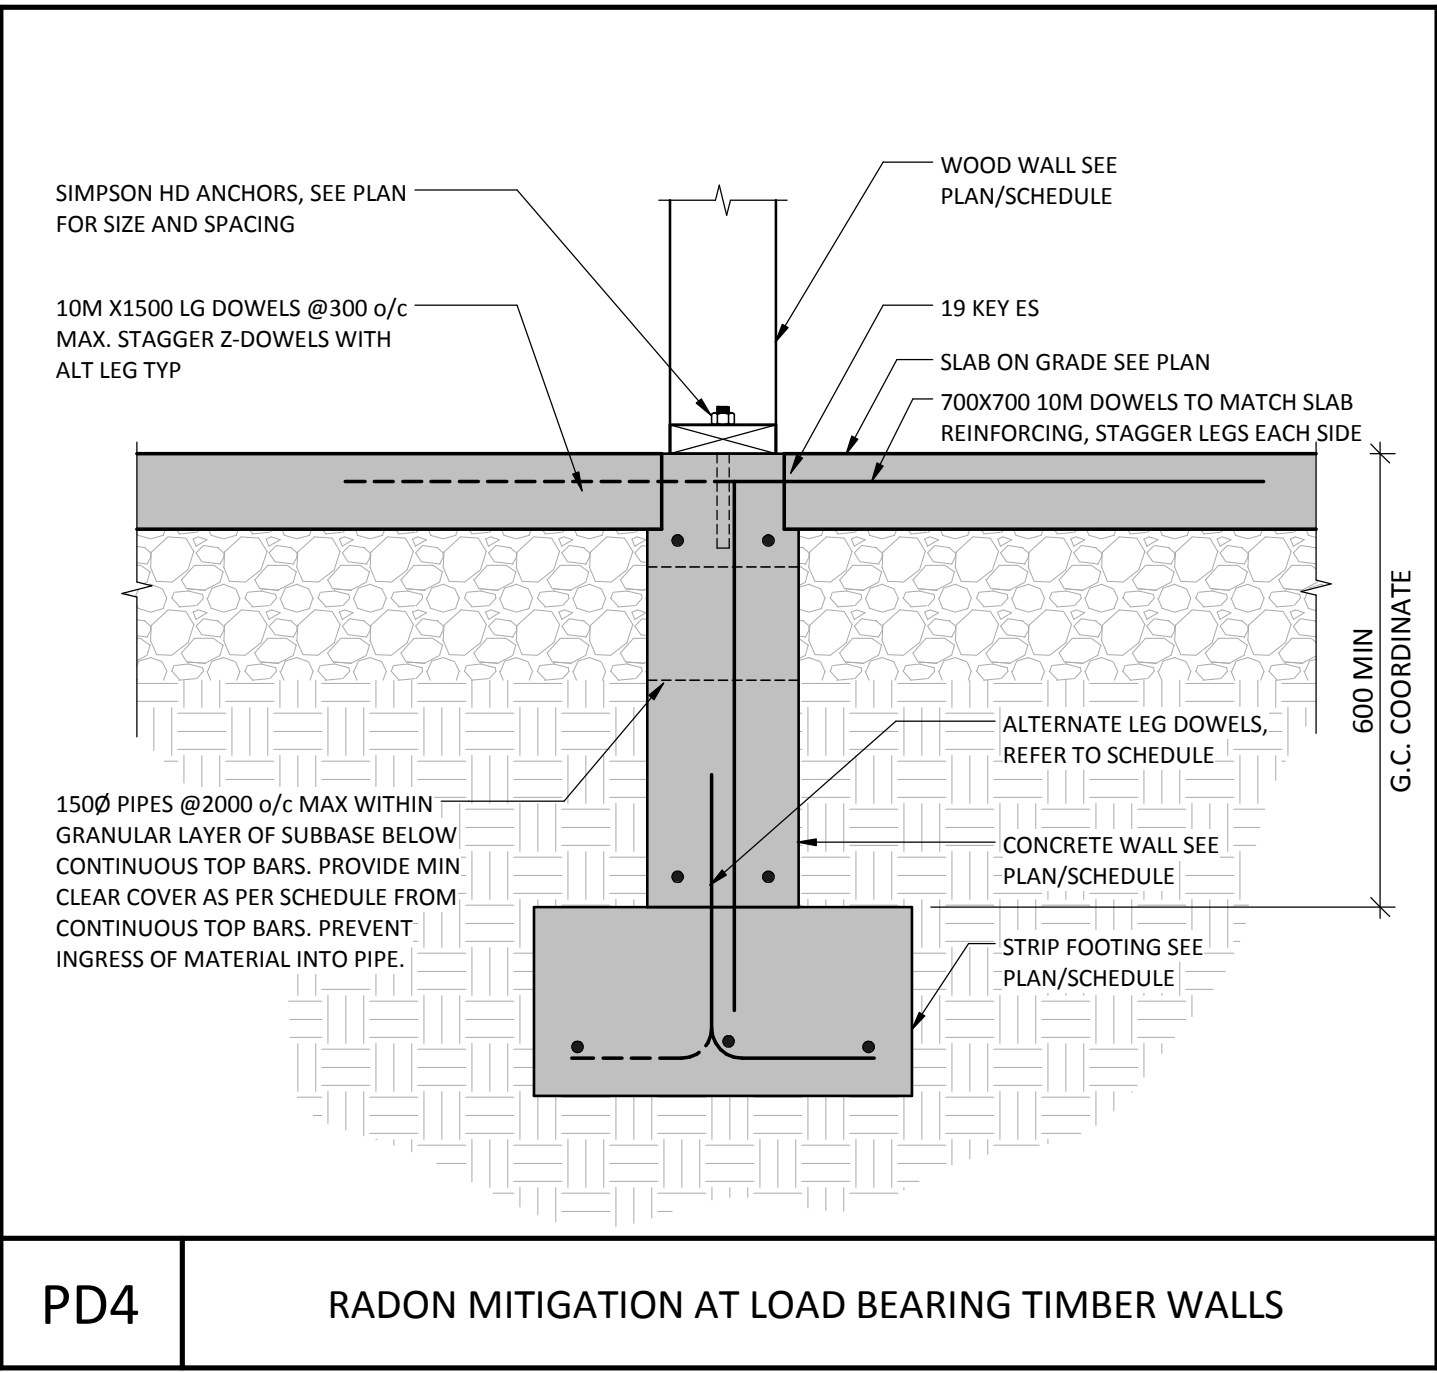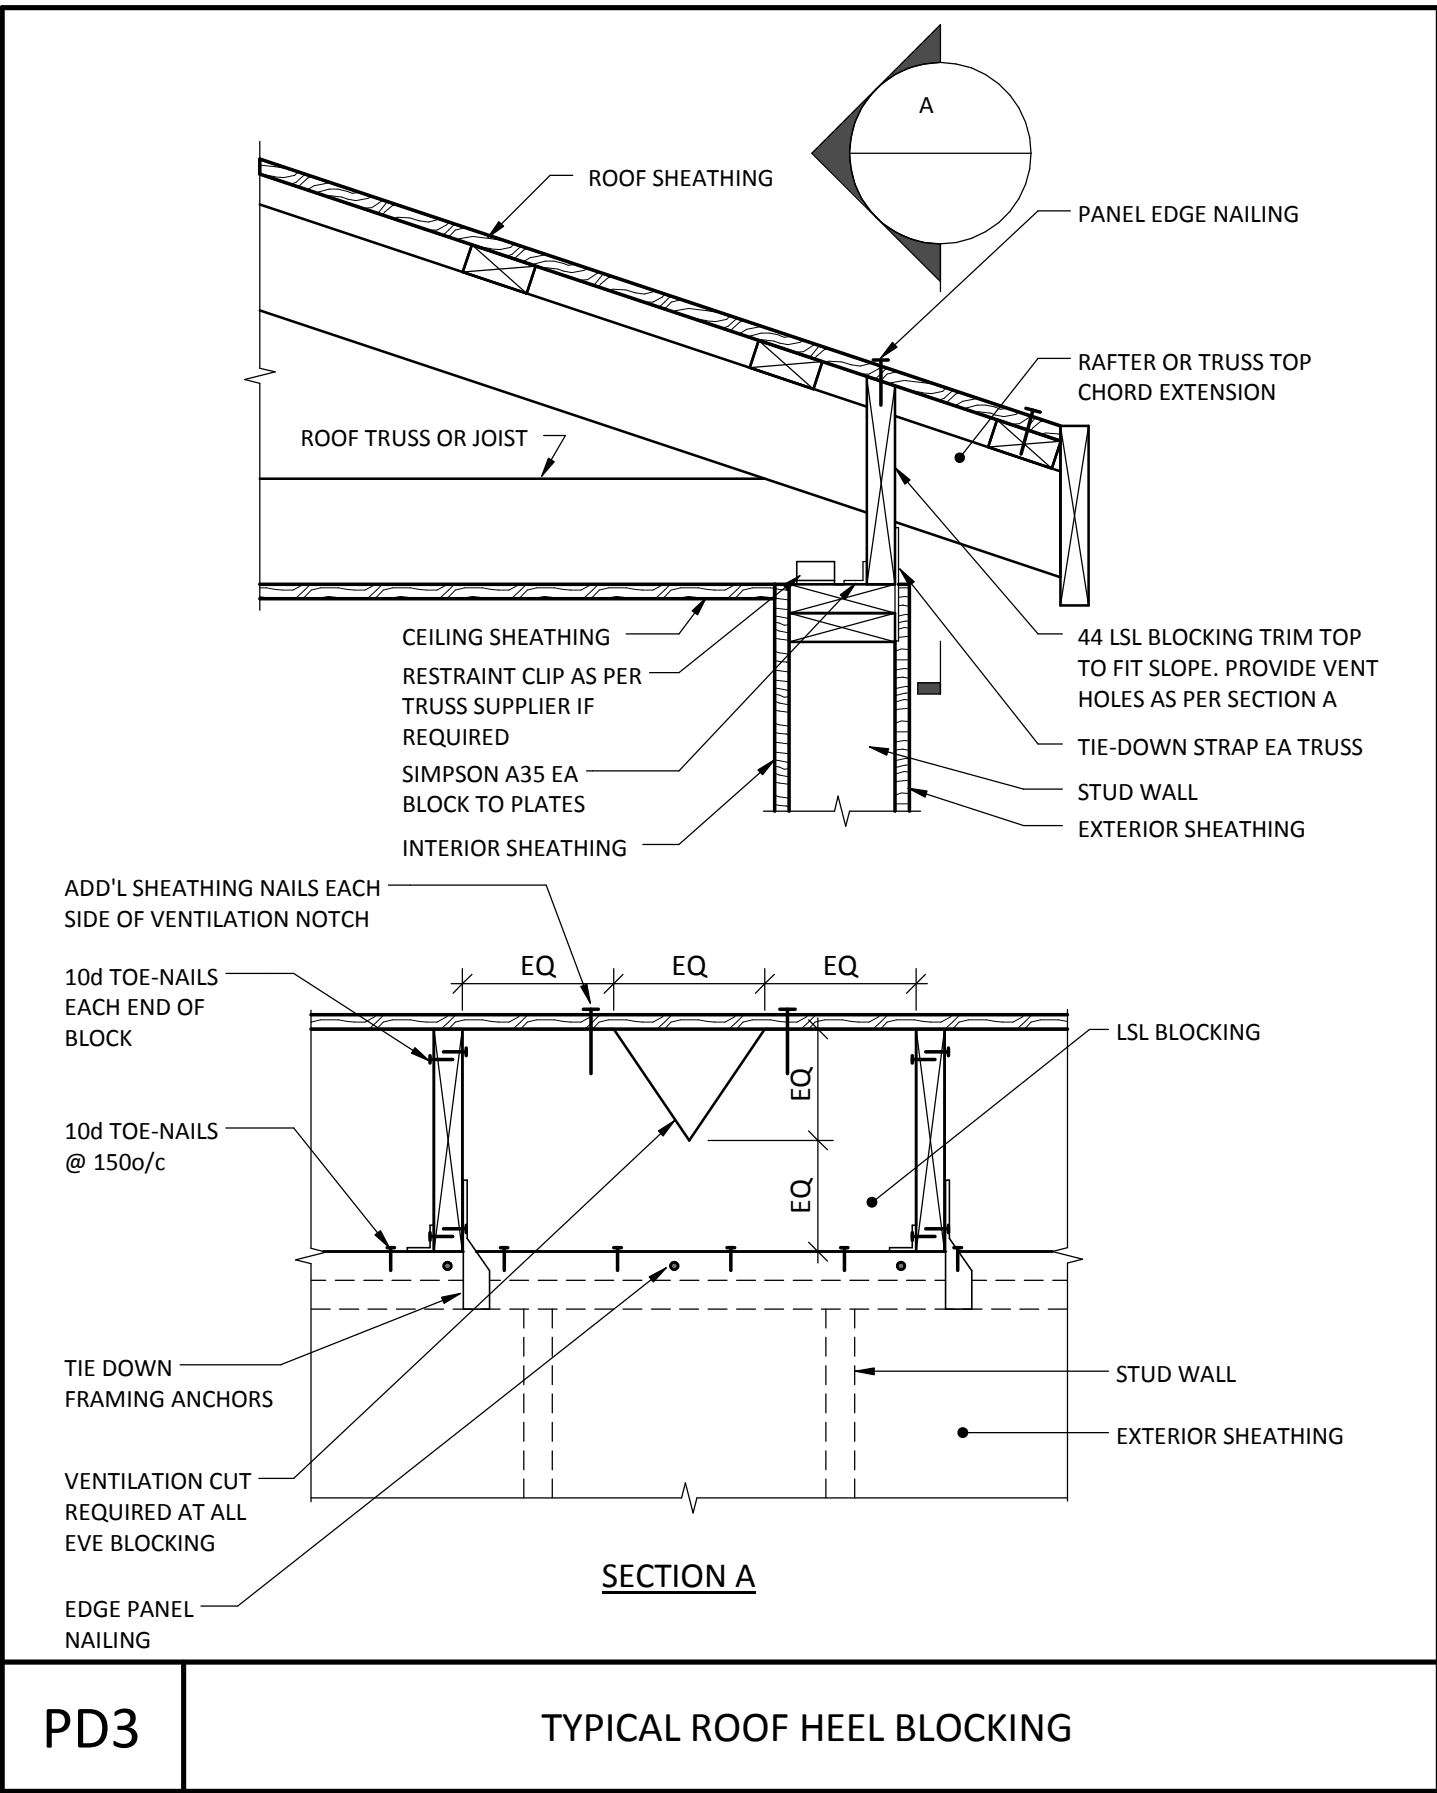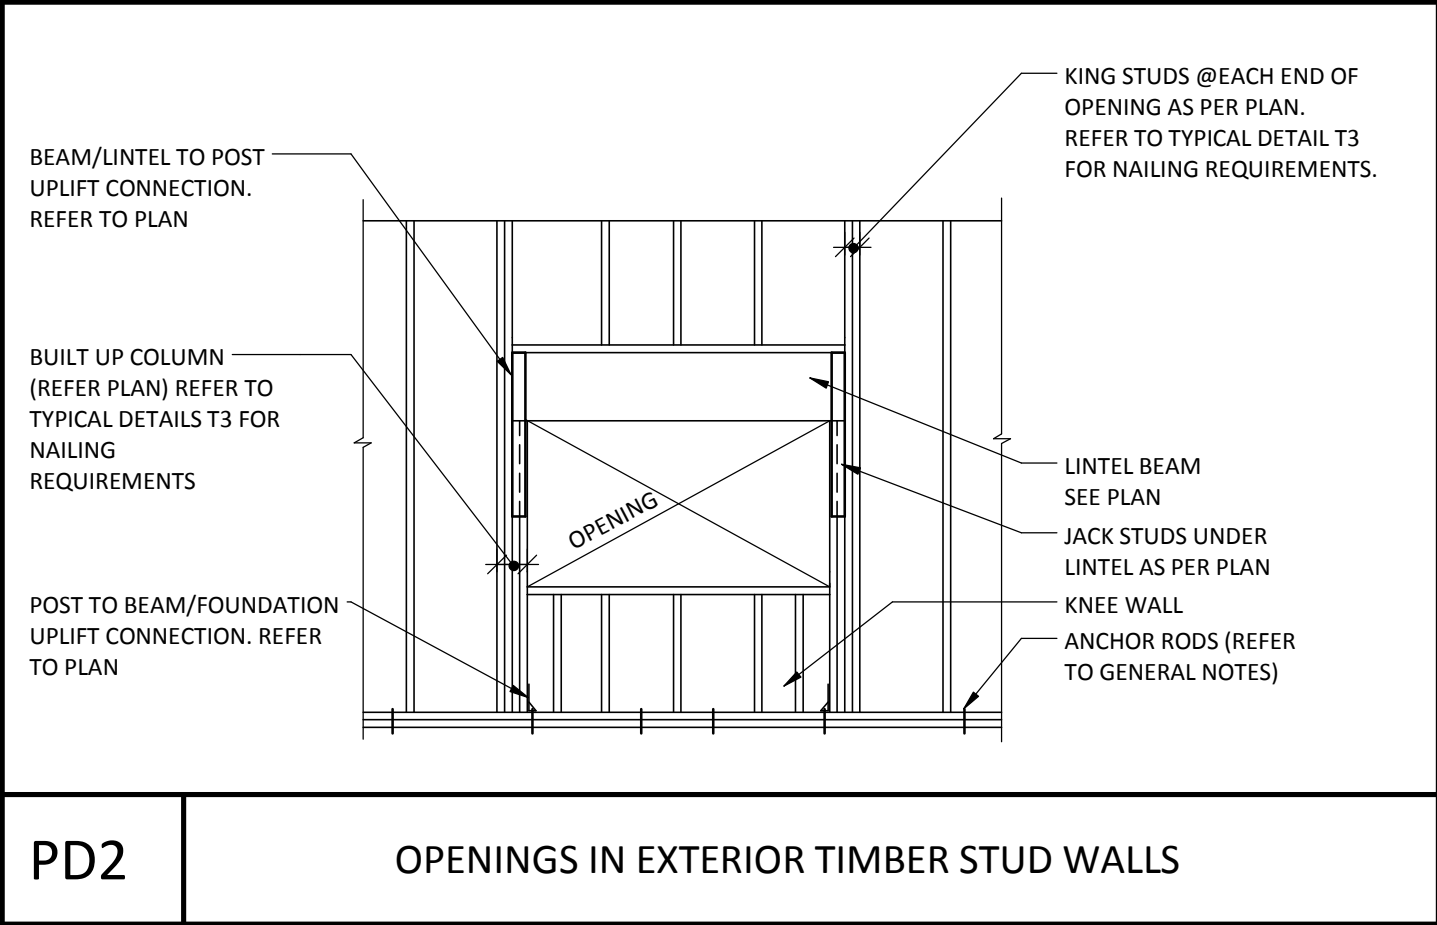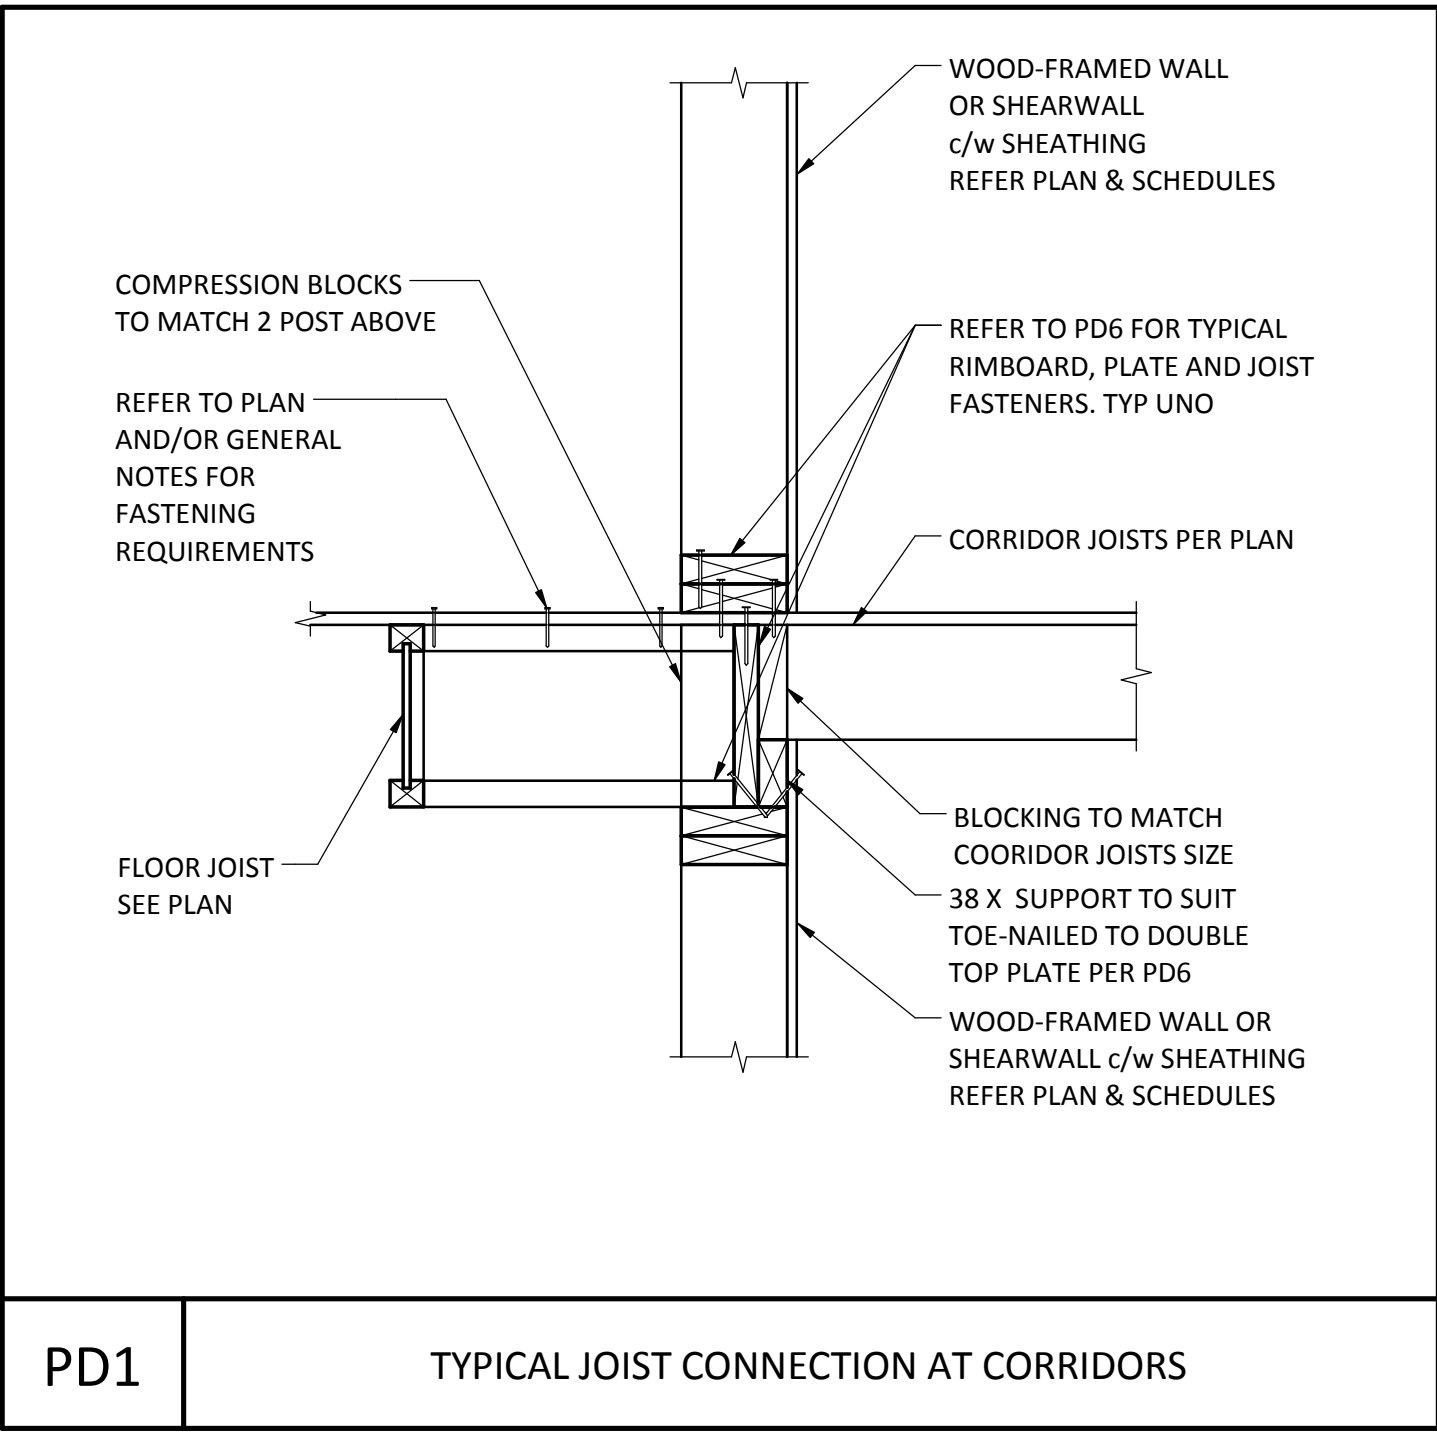**TYPICAL
DETAILS**

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KL	AD	12/02/16
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	IW	As indicated
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Randy Boldt		
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C015-0870	File # 945	
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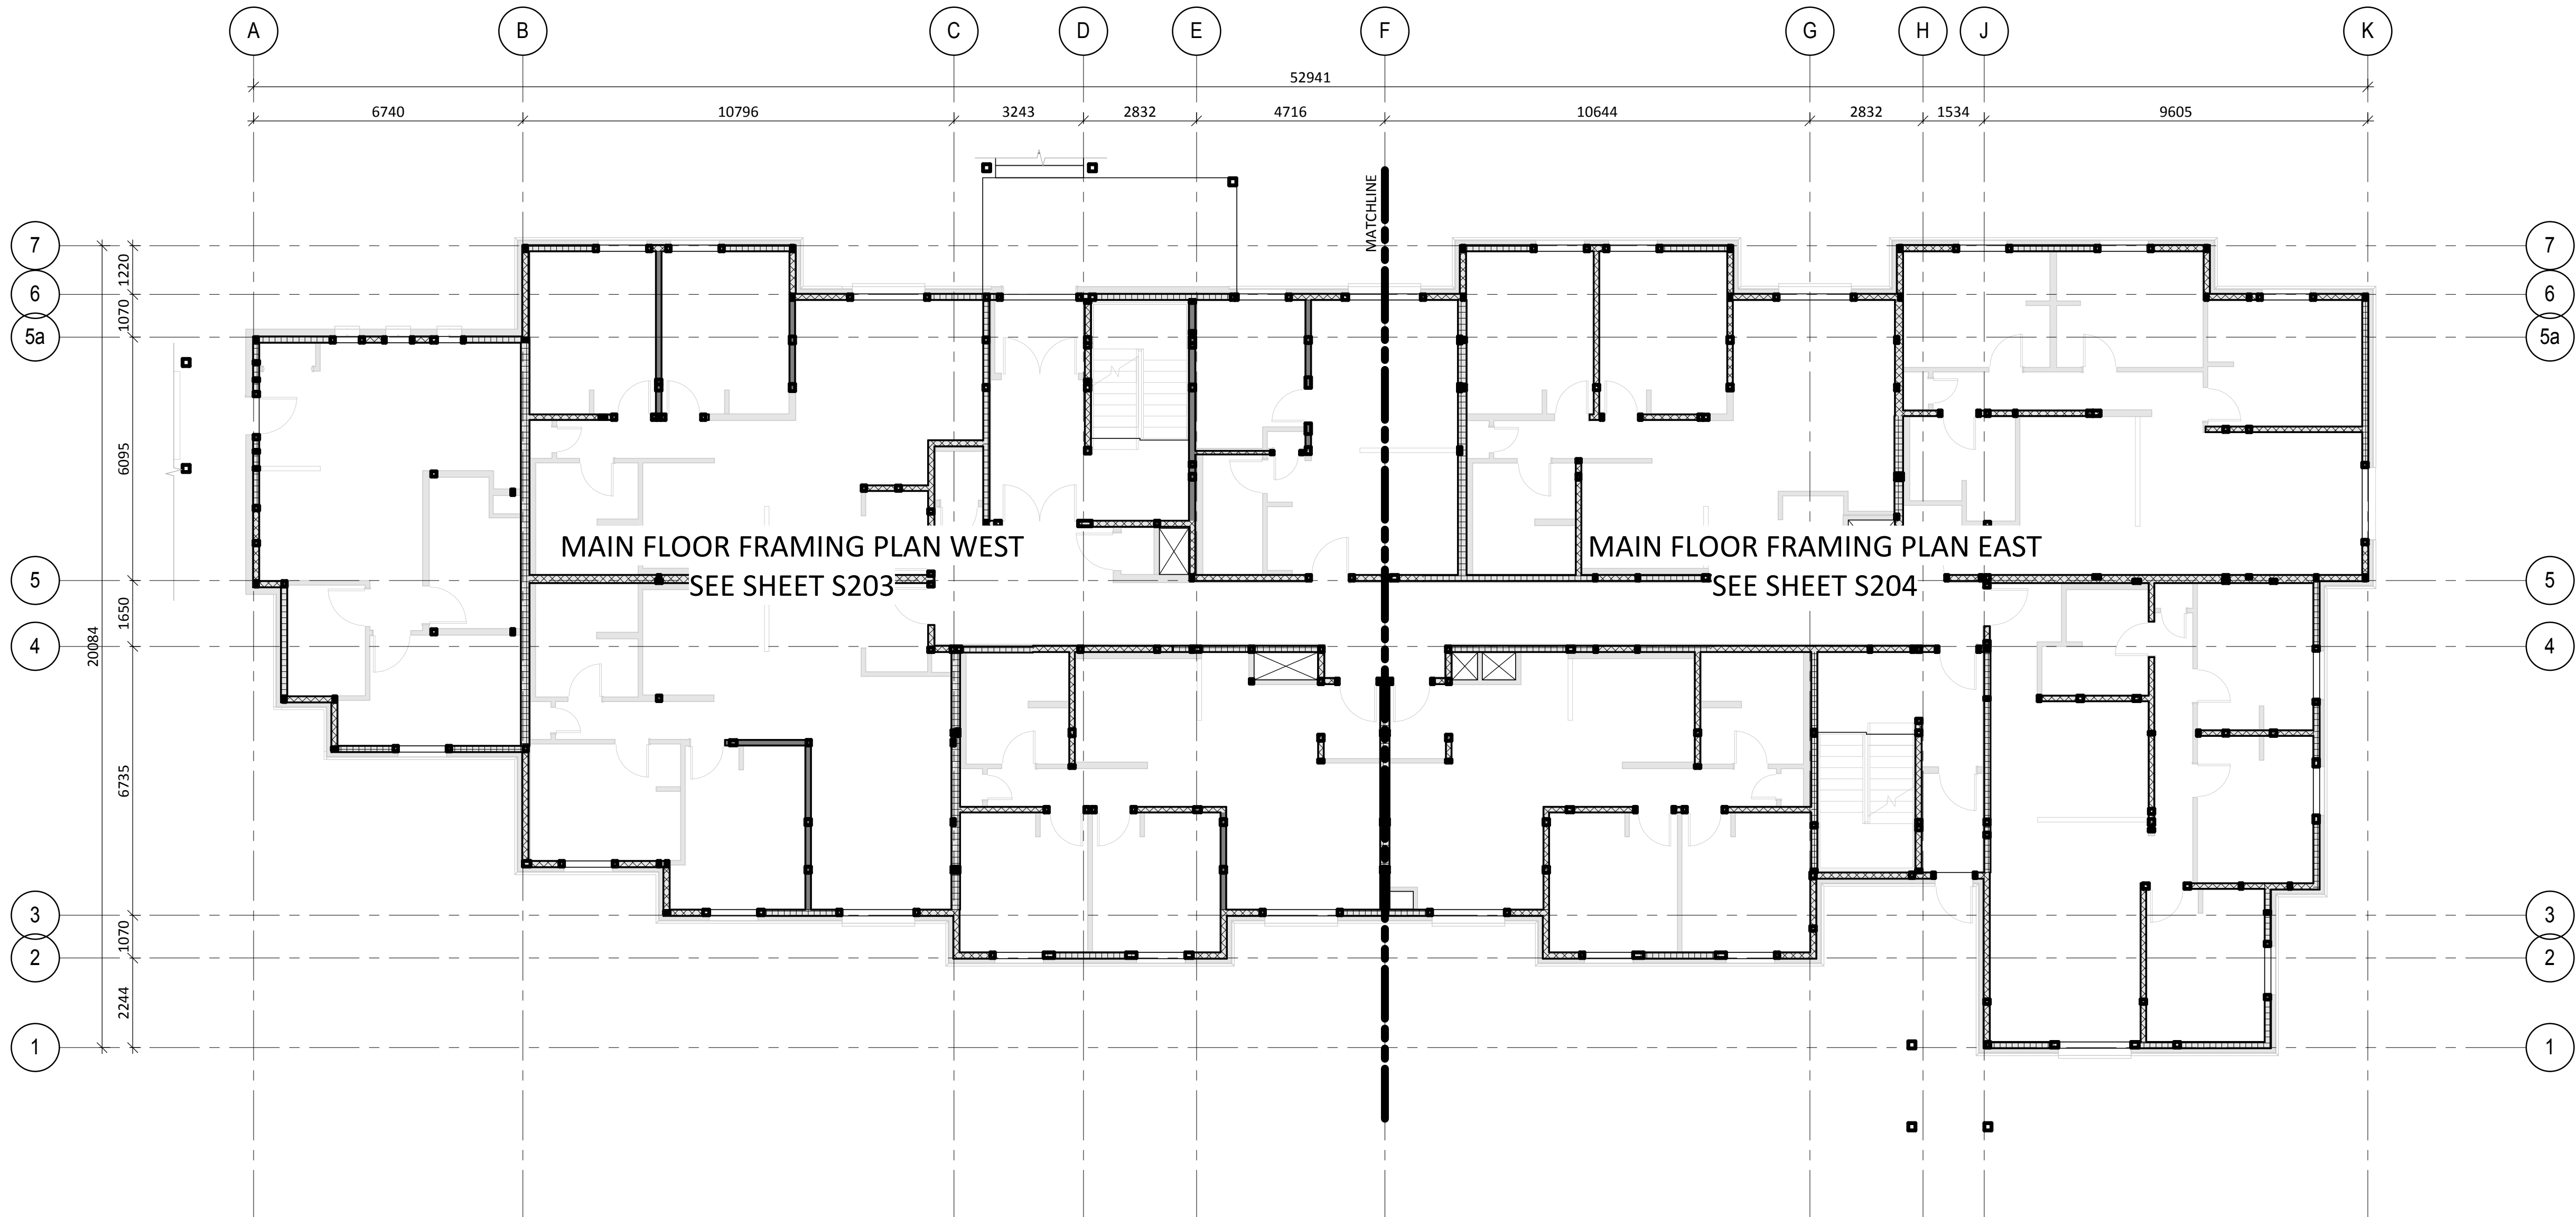
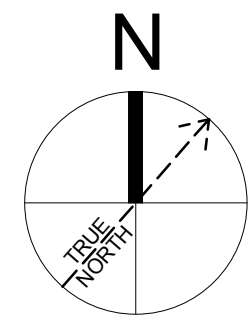
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BASEMENT PLAN OVERALL PLAN

1:100

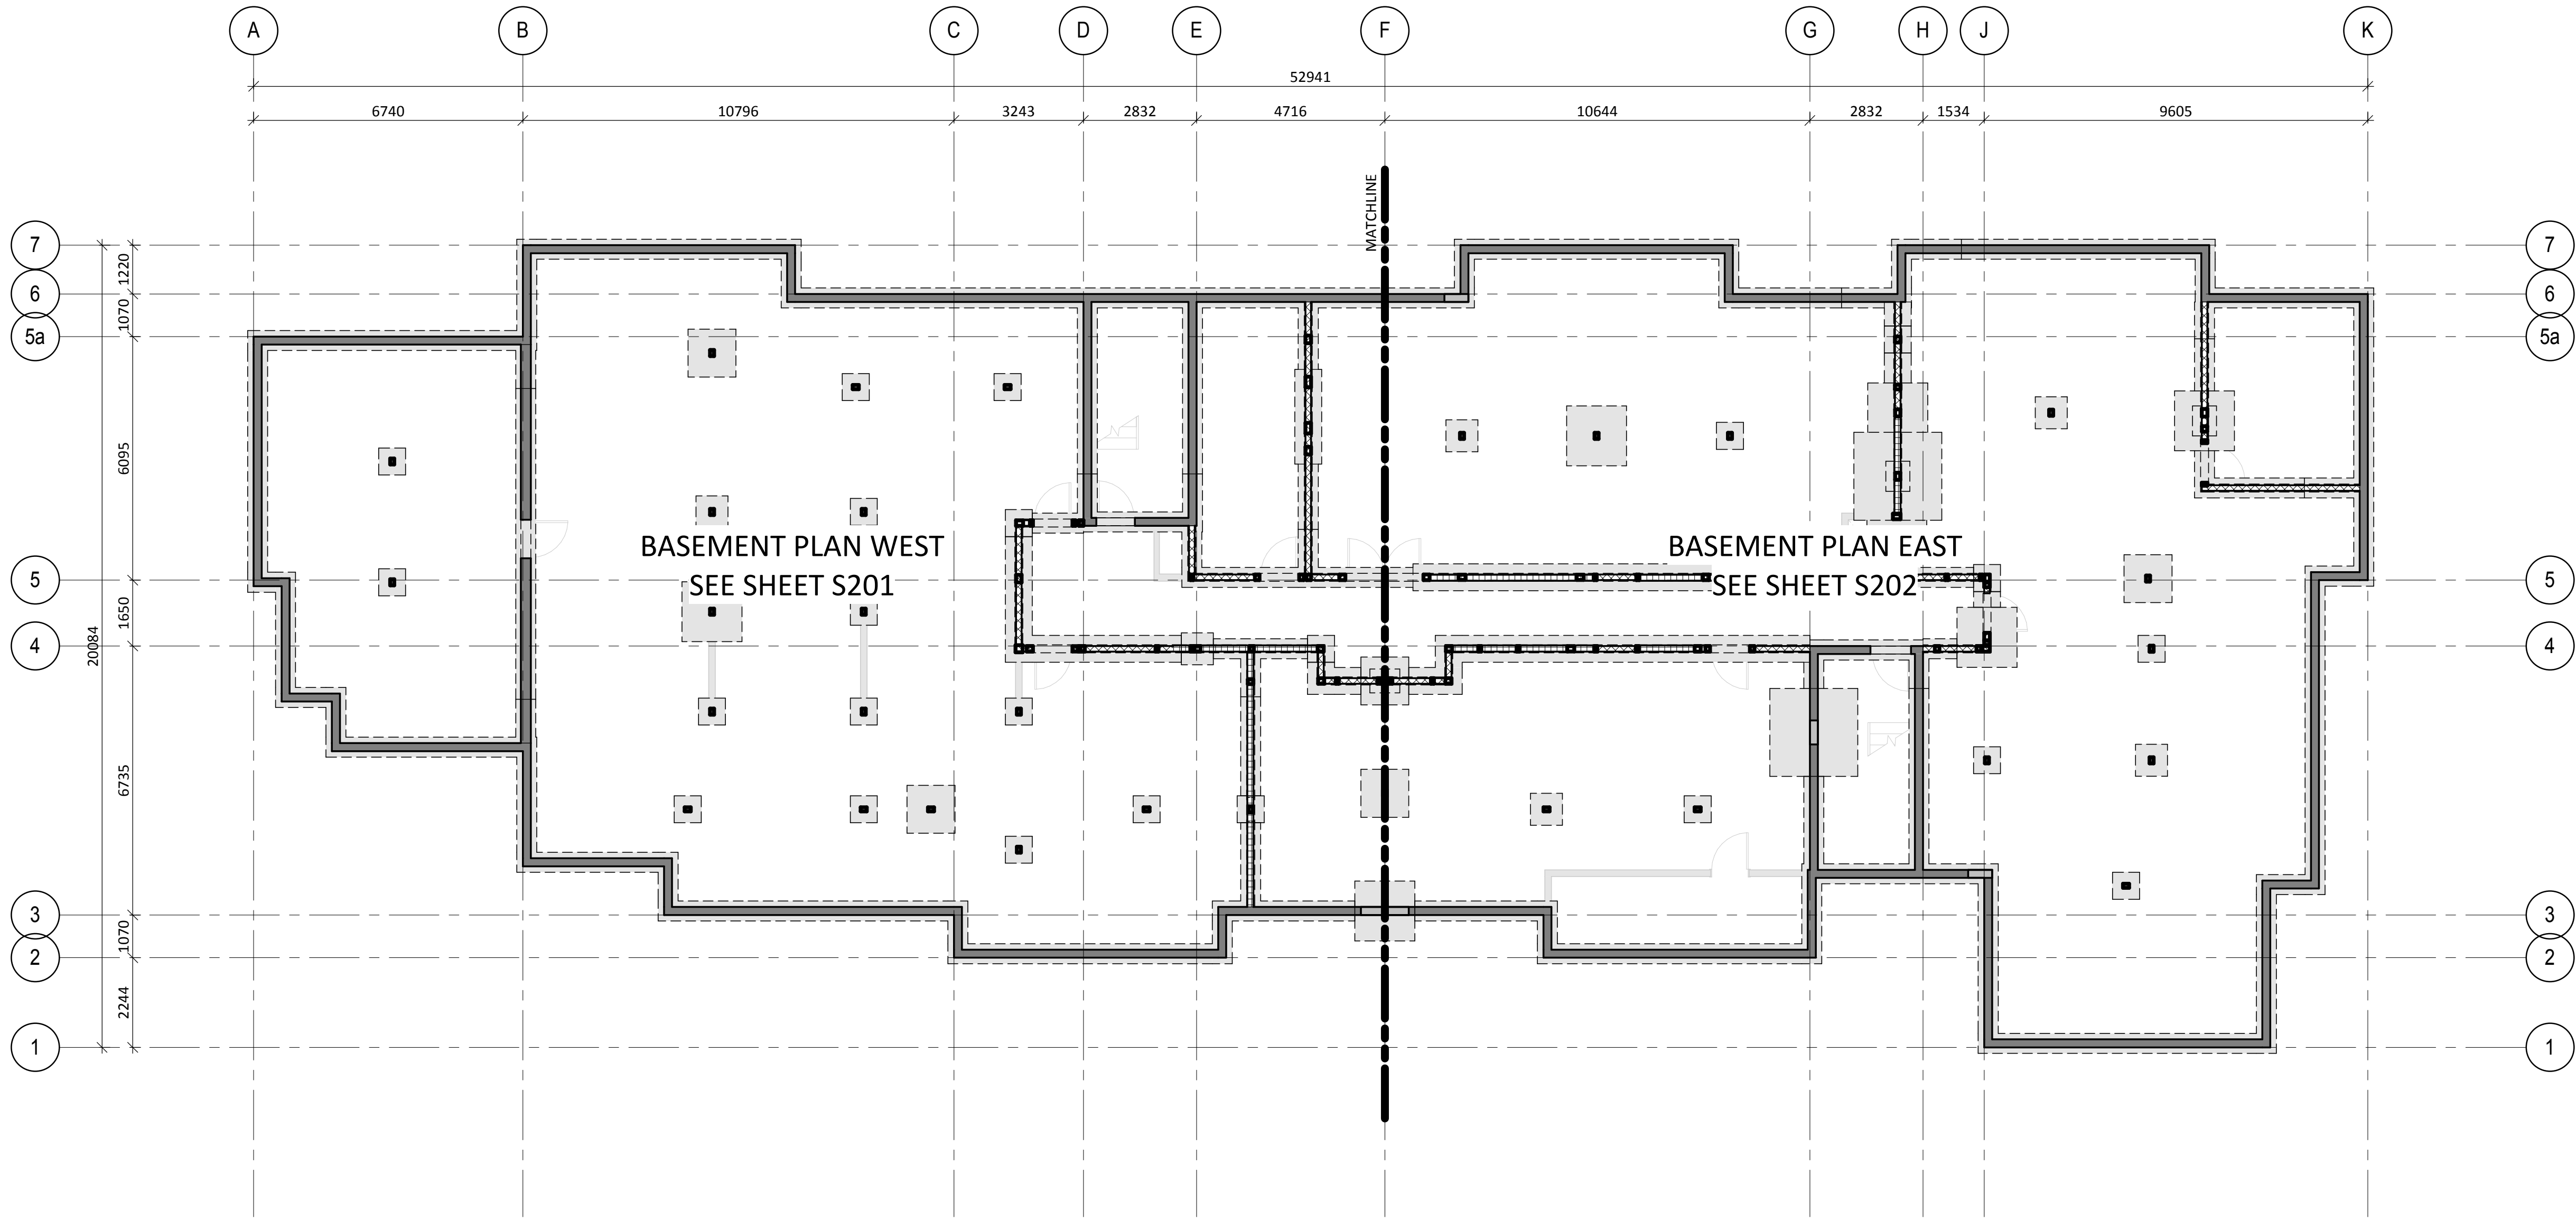
- TOP OF SLAB IS AT REFERENCE ELEVATION -3100 (GEODETTIC 1283.75) EXCEPT AS CROSSED AND NOTED. ELEVATIONS FOR AREAS CROSSED AND NOTED ARE TO BE READ FROM TOP OF SLAB ELEVATION.
- U/S OF COLUMN FOOTINGS ARE AT REFERENCE ELEVATION -3650 (GEODETTIC 1283.2) AND U/S OF WALL FOOTINGS ARE AT REFERENCE ELEVATION -3600 (GEODETTIC 1283.25) UNLESS NOTED OTHERWISE. ELEVATIONS NOTED ARE REFERENCED FROM REFERENCE ELEVATION 0.00 (GEODETTIC 1286.85) TO U/S OF FOOTING.
- CENTRE ALL CAPS AND FOOTINGS UNDER COLUMNS UNLESS NOTED OTHERWISE.
- SEE ARCHITECTURAL DRAWINGS FOR SLOPES TO DRAINS. MAINTAIN SLAB THICKNESS SHOWN.
- REFER TO S300 SCHEDULES FOR COLUMN, BASEPLATES AND SHEARWALL TYPES.



MAIN FLOOR OVERALL PLAN

1:100

- TOP OF FINISHED FLOOR IS AT REFERENCE ELEVATION 0.00 (GEODETTIC 1286.85) EXCEPT AS CROSSED AND NOTED. AREAS CROSSED AND NOTED ARE TO BE READ FROM FINISHED FLOOR ELEVATION.
- TOPS OF JOISTS AND BEAMS ARE 54mm BELOW FINISHED FLOOR ELEVATION EXCEPT AS NOTED OTHERWISE.
- REFER TO S300 SCHEDULES FOR COLUMN, BEAMS, JOISTS AND SHEARWALL TYPES.

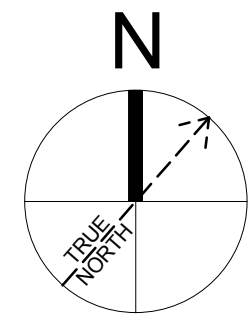

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ENTUITIVE 209 - 8th Avenue SW, Suite 300 Calgary, AB T2P 1B5 403-878-1270	

Public Works and Government Services Canada	Travaux publics et Services gouvernementaux Canada
Client Services Team Southern Alberta Operations Branch	Le Client Entretient l'Équipe Alberta Méridionale Branche d'Opérations

Canada

Client/client	Parks Canada Agence	L'Agence Parcs Canada
	Western and Northern Region	Ouest et Nord du Canada

Project title/Titre du projet


**Staff Housing Phase 2
Waterton Lakes National
Park**

Drawing title/Titre du dessin

**BASEMENT &
MAIN FLOOR
FRAMING PLAN**

Surveyed by/Arpenté par	Drawn by/Dessiné par	Date/Date
AD	AD	12/02/16
Designed by/Concept par	Reviewed by/Revisé par	Scale/Echelle
KL	IW	1 : 100
PWGSC Project Manager/Administrateur de Projets TPSGC		
Randy Boldt		
Client Acceptance/Acceptation du client		Approved by/Approuve par
<div></div>		
Task Responsible/Officer/Agent Responsable		PWGSC Project Manager/Administrateur de Projets TPSGC
Project No./No. du projet	Asset No./No. du bien	Sheet No./No. de la feuille
C015-0870	File # 945	S200
Drawing Reference No./No. de référence du dessin		

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BASEMENT PLAN - WEST

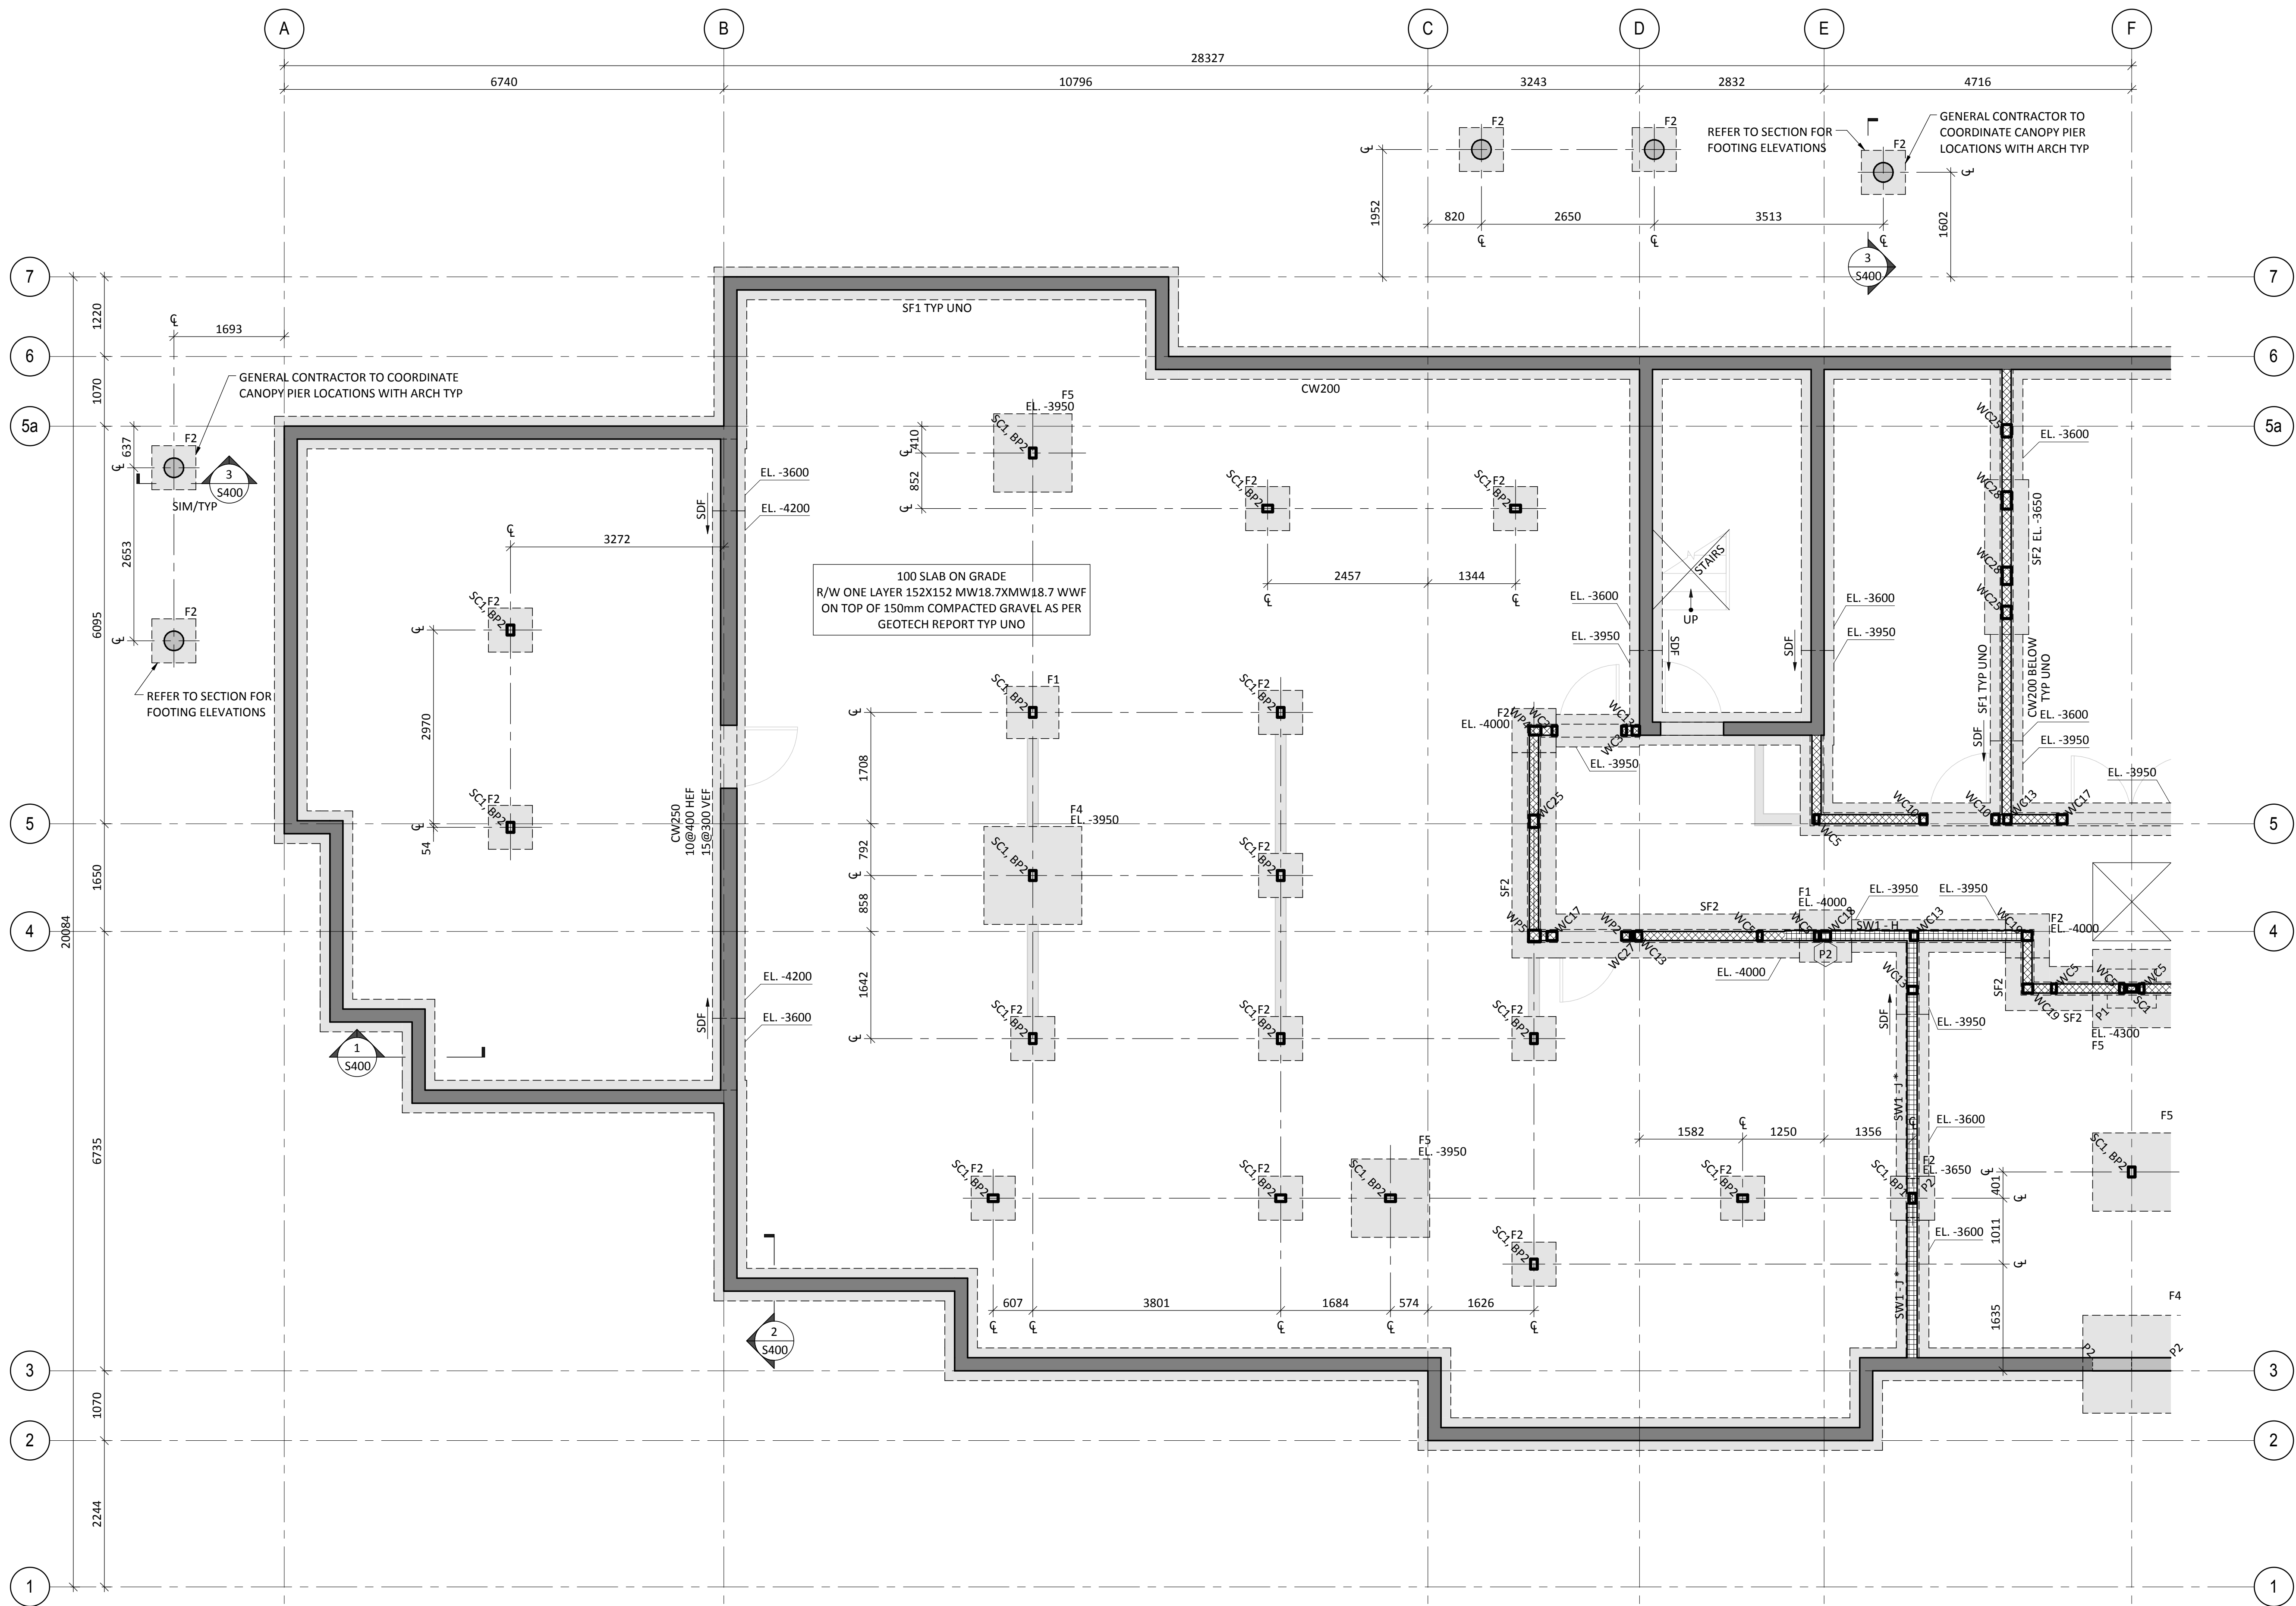1:50

NOTES:



- FOOTING STEP LOCATIONS INDICATED ON PLAN ARE SCHEMATIC ONLY. GENERAL CONTRACTOR TO COORDINATE ALL FOOTING STEP LOCATIONS TYP.
- * - PROVIDE 133X406 1.55E LSL ABOVE WALL FASTEN DOUBLE TOP PLATE TO BEAM ABOVE/BELOW w/ 8ØX150LG RSS SCREWS @150o/c.
- ** - PROVIDE 133X406 1.55E LSL ABOVE WALL FASTEN DOUBLE TOP PLATE TO BEAM ABOVE/BELOW w/ 8ØX150LG RSS SCREWS @100o/c. FASTEN BOTTOM PLATE TO WALL BELOW WITH 16Ø HILTI HUS SCREWS @600 o/c.

UPLIFT NOTES: NOTED ON PLAN AS FOLLOWS:

- 2-HDU8-SDS2.5 CONNECTING POST TO PILASTER BELOW w/ 22Ø HAS ROD. EMBED 250 WITH HILTI HY-200 SAFESIT FASTEN POST TO CONCRETE WALL BELOW w/ HDU5-SDS2.5 w/ AB2. ANCHOR MUST BE CAST IN PLACE, POST INSTALLED ANCHOR NOT ACCEPTABLE.
- (B) - BEAM/LINTEL/TRUSS TO POST BELOW CONNECTION (P) - POST TO BEAM/LINTEL BELOW CONNECTION

STRIP FOOTING SCHEDULE				
MARK	WIDTH (mm)	DEPTH (mm)	LONGITUDINAL	TRANSVERSE
SF1	500	250	3-15 CONT	N/A
SF2	675	300	3-15 CONT	N/A

FOOTING SCHEDULE				
MARK	WIDTH (mm)	LENGTH (mm)	DEPTH (mm)	REINFORCING
F1	800	800	300	3-15 T&B EW (HH)
F2	675	675	300	3-15 BEW (HH)
F3	2200	2200	900	8-25M T&B EW (HH)
F4	1500	1500	600	6-20M T&B EW (HH)
F5	1200	1200	600	5-20M T&B EW (HH)

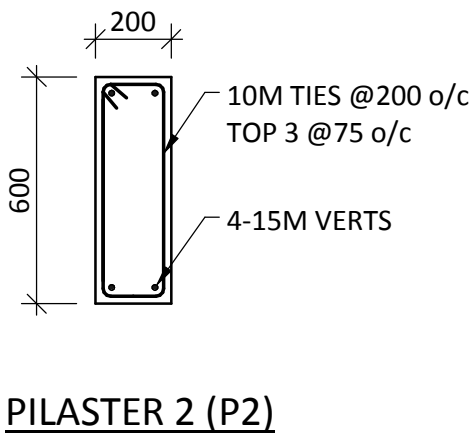
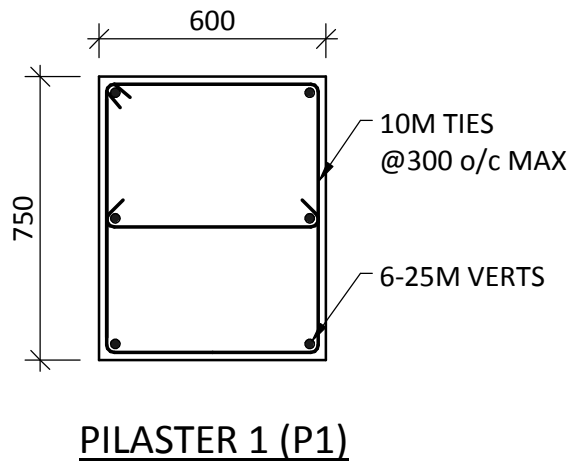


Staff Housing Phase 2 Waterton Lakes National Park

BASEMENT PLAN - WEST

Surveyed by/Arpente par KL	Drawn by/Dessine par AD	Date/Date 12/02/16
Designed by/Concept par KL	Reviewed by/Revisé par IW	Scale/Echelle As indicated
PWGSC Project Manager/Administrateur de Projets TPWGC Randy Boldt		
Client Acceptance/Acceptation du client Approved by/Approuve par		
Project No./No. du projet C015-0870		
Asset No./No. du bien Fil # 945		Sheet No./ No. de la feuille S201
Drawing Reference No./No. de reference du dessin		

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BASEMENT PLAN - EAST

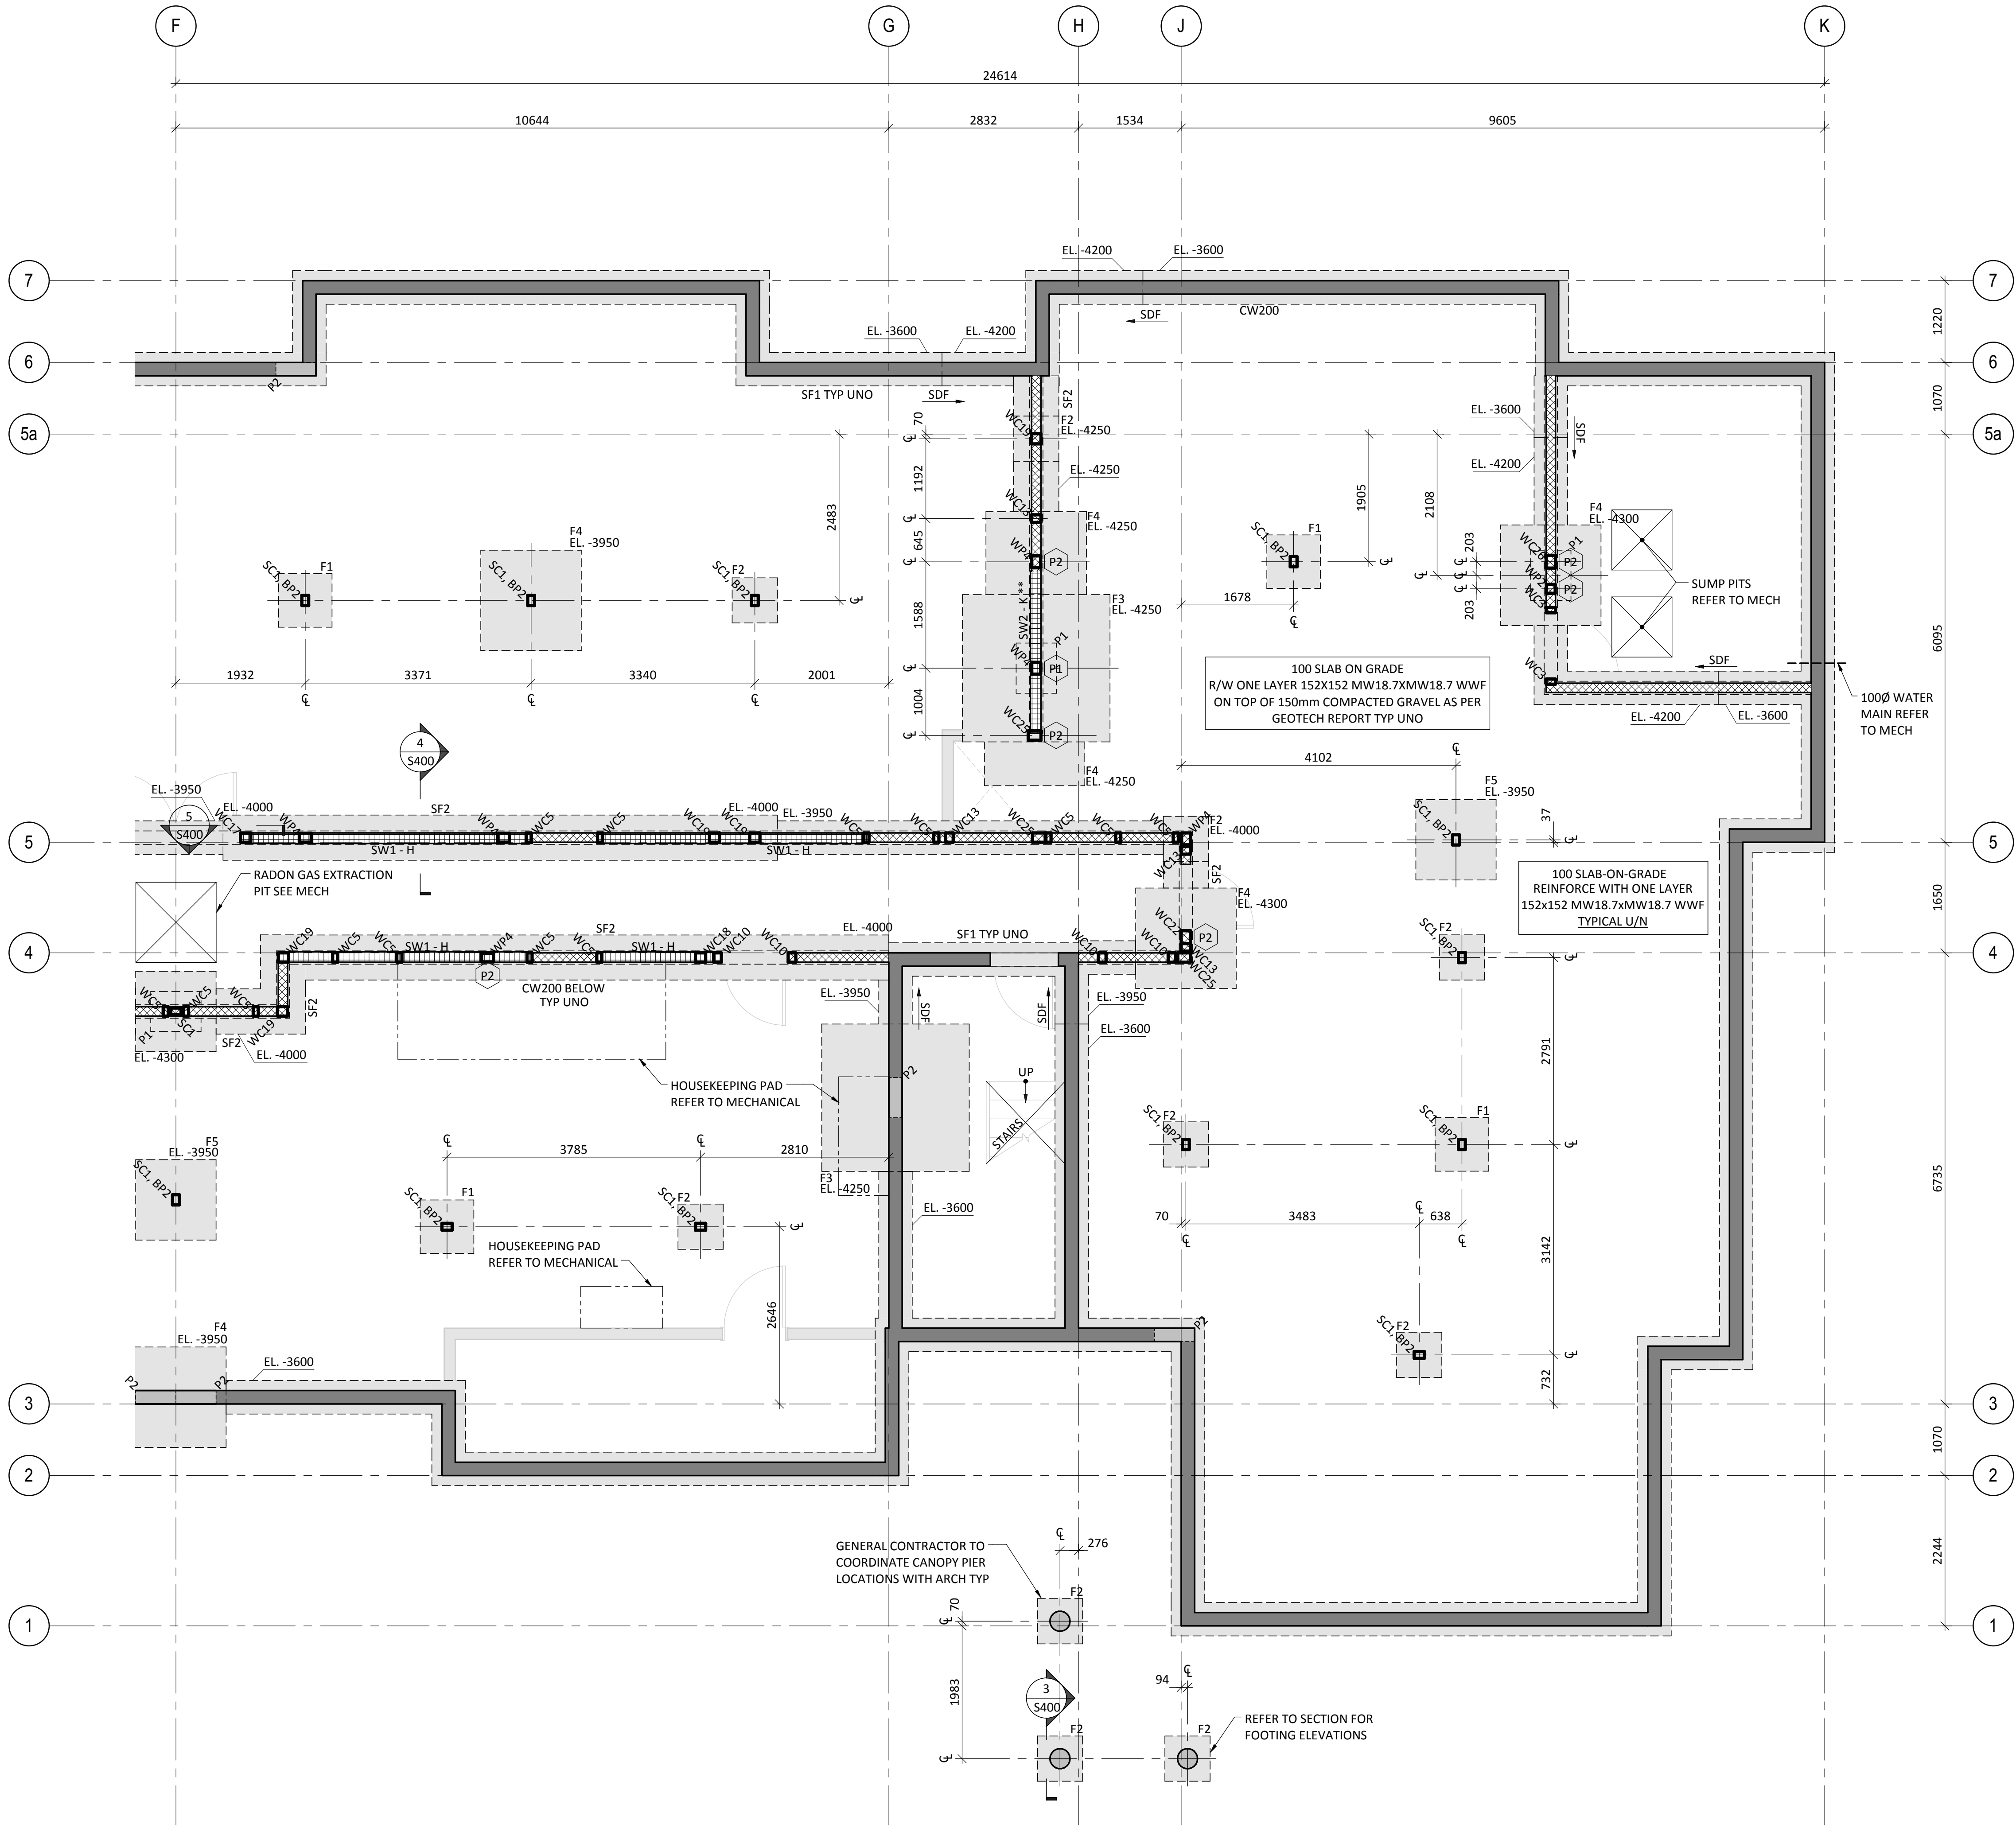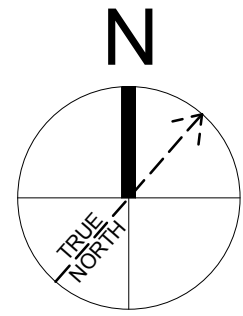1:50

NOTES:

- FOOTING STEP LOCATIONS INDICATED ON PLAN ARE SCHEMATIC ONLY. GENERAL CONTRACTOR TO COORDINATE ALL FOOTING STEP LOCATIONS TYP.
- * - PROVIDE 133X406 1.55E LSL ABOVE WALL FASTEN DOUBLE TOP PLATE TO BEAM ABOVE/BELOW w/ 8ØX150LG RSS SCREWS @150o/c.
- ** - PROVIDE 133X406 1.55E LSL ABOVE WALL FASTEN DOUBLE TOP PLATE TO BEAM ABOVE/BELOW w/ 8ØX150LG RSS SCREWS @100o/c.



UPLIFT NOTES: NOTED ON PLAN AS FOLLOWS:

- 2-HDU8-SDS2.5 CONNECTING POST TO PILASTER BELOW w/ 22Ø HAS ROD. EMBED 250 WITH HILTI HY-200 SAFESET FASTEN POST TO CONCRETE WALL BELOW w/ HDU5-SDS2.5 w/ AB2. ANCHOR MUST BE CAST IN PLACE, POST INSTALLED ANCHOR NOT ACCEPTABLE.
- (B) - BEAM/LINTEL/TRUSS TO POST BELOW CONNECTION (P) - POST TO BEAM/LINTEL BELOW CONNECTION

UPLIFT NOTE NUMBER AS PER BELOW

STRIP FOOTING SCHEDULE				
MARK	WIDTH (mm)	DEPTH (mm)	LONGITUDINAL	TRANSVERSE
SF1	500	250	3-15 CONT	N/A
SF2	675	300	3-15 CONT	N/A

FOOTING SCHEDULE				
MARK	WIDTH (mm)	LENGTH (mm)	DEPTH (mm)	REINFORCING
F1	800	800	300	3-15 T&B EW (HH)
F2	675	675	300	3-15 BEW (HH)
F3	2200	2200	900	8-25M T&B EW (HH)
F4	1500	1500	600	6-20M T&B EW (HH)
F5	1200	1200	600	5-20M T&B EW (HH)

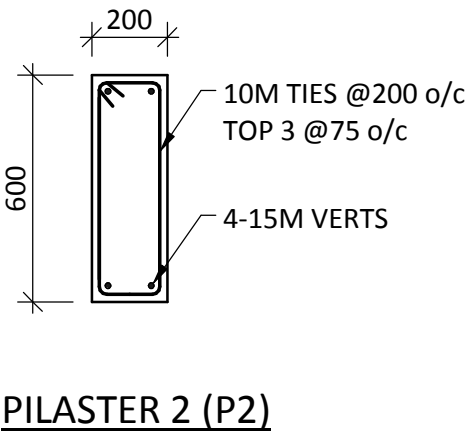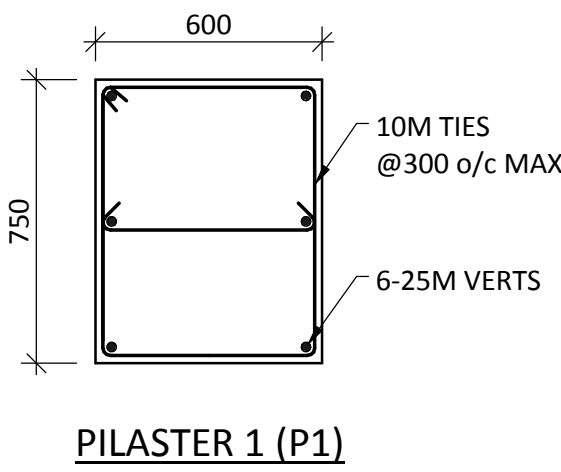


Staff Housing Phase 2
Waterton Lakes National
Park

BASEMENT PLAN
- EAST

Surveyed by/Arpenté par KL	Drawn by/Dessiné par AD	Date/Date 12/02/16
Designed by/Concept par KL	Reviewed by/Revisé par IW	Scale/Echelle As indicated
PWGSC Project Manager/Administrateur de Projets TPWGC Randy Boldt		
Client Acceptance/Acceptation du client		Approved by/Approuvé par
Project No./No. du projet C015-0870		
Asset No./No. du bien Fil # 945		Sheet No./ No. de la feuille S202
Drawing Reference No./No. de référence du dessin		

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MAIN FLOOR FRAMING PLAN - EAST

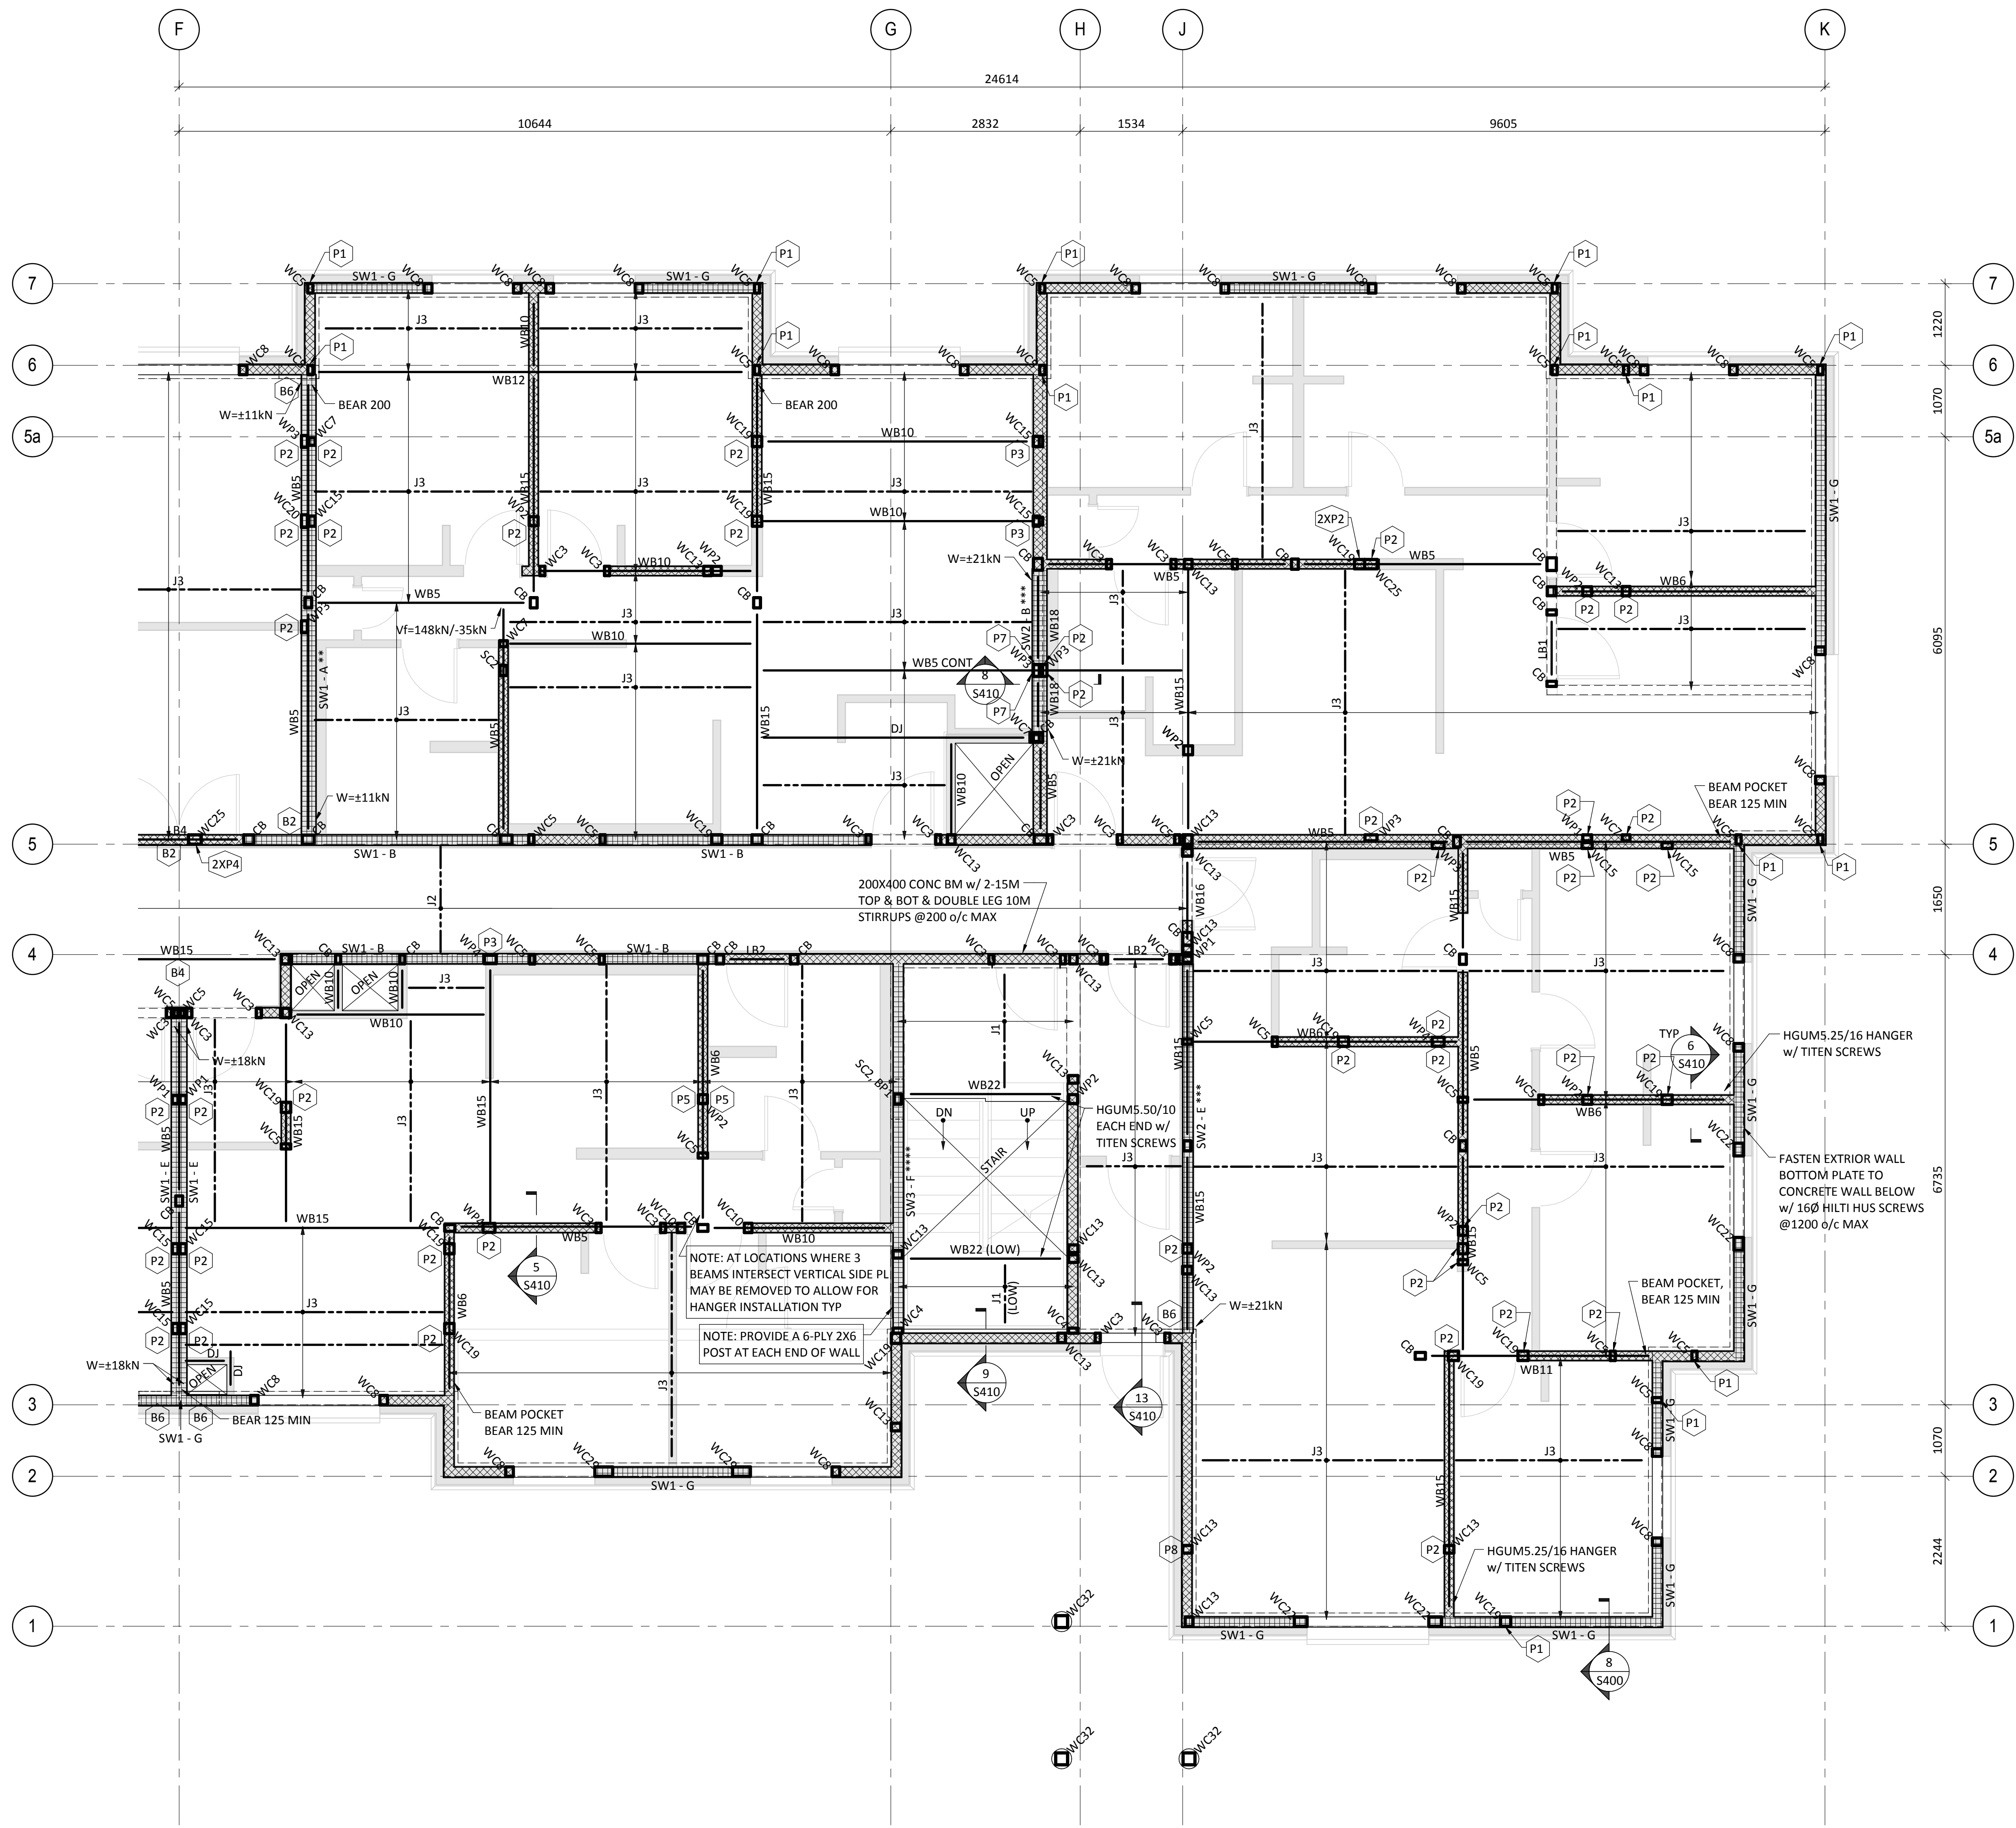1:50

NOTES:

- "DI" INDICATES MEMBER TO BE DESIGNED BY FLOOR SUPPLIER.
- RIMBOARD TO BE 32mm 1.3E LSL TYP UNO.
- FLOOR SHEATHING TO BE 16mm PLYWOOD GLUED & SCREWED TO FLOOR WITH #7 SCREWS @150 o/c AT PANEL EDGES AND 300 o/c AT INTERMEDIATE MEMBERS TYP UNO.
- * - FASTEN BOTTOM PLATE TO BEAM BELOW w/ 8ØX150LG SCREWS @150 o/c MAX.
- ** - PROVIDE 89X406 1.5SE LSL ABOVE WALL. FASTEN DOUBLE TOP PLATE TO BEAM ABOVE/BELOW w/ 8ØX150LG RSS SCREWS @150o/c.
- *** - PROVIDE 89X406 1.5SE LSL ABOVE WALL. FASTEN DOUBLE TOP PLATE TO BEAM ABOVE w/ 8ØX150 LG RSS SCREWS @100 o/c.
- **** - PROVIDE LSL BEAM SEE PLAN/SCHEDULE ABOVE WALL. FASTEN DOUBLE TOP PLATE TO BEAM ABOVE w/ 8ØX150 LG RSS SCREWS @75 o/c. FASTEN DOUBLE BOTTOM PLATE TO CONCRETE WALL BELOW w/ 16Ø HILTI HUS SCREWS @400 o/c MAX.
- PROVIDE 2-HSS76X76X4.8 AT U/S OF BEAM AS SHIM PLATES. WELD SOLIDLY ALONG ONE FACE TYP EACH TUBE.

UPLIFT NOTES: NOTED ON PLAN AS FOLLOWS:

- HDU2-SDS2.5 W/ 16mm HAS ROD CONNECTING POST TO WALL BELOW; EMBED 150 WITH HILTI HY-200 SAFESET.
- MSTC4883 STRAP CONNECTING POST TO BEAM. USE 10ØX64LG NAILS.
- MSTC66 CONNECTING POST TO POST
- HTS16 CONNECTING BEAM TO POST
- HDU5-SDS2.5 AND 16mm THREADED ROD CONNECTING POST TO VGT ON BEAM.
- VGTR/L W/ 16MM HAS ROD CONNECTING BEAM TO CONCRETE WALL BELOW. EMBED 150 WITH HILTI HY-200 SAFESET
- HDU8-SDS2.5 w/ 22Ø THREADED ROD CONNECTING POST TO HDU8-SDS2.5 ON POST BELOW.
- 1-MSTCM60 STRAP CONNECTING POST TO WALL BELOW WITH TITEN SCREWS.

UPLIFT NOTE NUMBER AS PER BELOW

- (B) - BEAM/LINTEL/TRUSS TO POST BELOW CONNECTION
(P) - POST TO BEAM/LINTEL BELOW CONNECTION

No.	Date/Date	Description/Description	Drawn by Dessine par	Approved Approuvé
5	2016-12-08	ISSUED FOR TENDER	AD	IW
4	2016-12-08	ISSUED FOR BUILDING PERMIT	AD	IW
3	2016-09-02	ISSUED FOR 99%	AD	IW
2	2016-06-14	ISSUED FOR 66%	AD	IW

Revision / Revision
A detail number numero de detail
B source drawing no. de dessin no.
C detail on drawing no. detail sur dessin no.

Consultant's Name Nom de l'expert-conseil	Eng. Stamp Sceau de l'ingénieur
ENTUITIVE	
209 - 8th Avenue SW, Suite 300 Calgary, AB T2P 1B5 403-878-1270	

 Public Works and Government Services Canada	Travaux publics et Services gouvernementaux Canada
Client Services Team Southern Alberta Operations Branch	Le Client Entretien l'Équipe Alberta Méridional Branche d'Opérations

 Parks Canada Agency	L'Agence Parcs Canada
Western and Northern Region	Ouest et Nord du Canada

Project title/Titre du projet
Staff Housing Phase 2 Waterton Lakes National Park

Drawing title/Titre du dessin
MAIN FLOOR FRAMING PLAN - EAST

Surveyed by/Arpente par	Drawn by/Dessine par	Date/Date
KL	AD	12/02/16
Designed by/Concept par	Reviewed by/Revisé par	Scale/Echelle
	IW	As indicated

PWGSC Project Manager/Administrateur de Projets TPSPGC

Randy Boldt

Client Acceptance/Acceptation du client

Approved by/Approuvé par

Task Responsible/Officier/Agent Responsable

PWGSC Project Manager/Administrateur de Projets TPSPGC

Project No./No. du projet


Asset No./No. du bien

Sheet No./
No. de la feuille

Drawing Reference No./No. de référence du dessin

S204


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LOFT FLOOR OVERALL PLAN

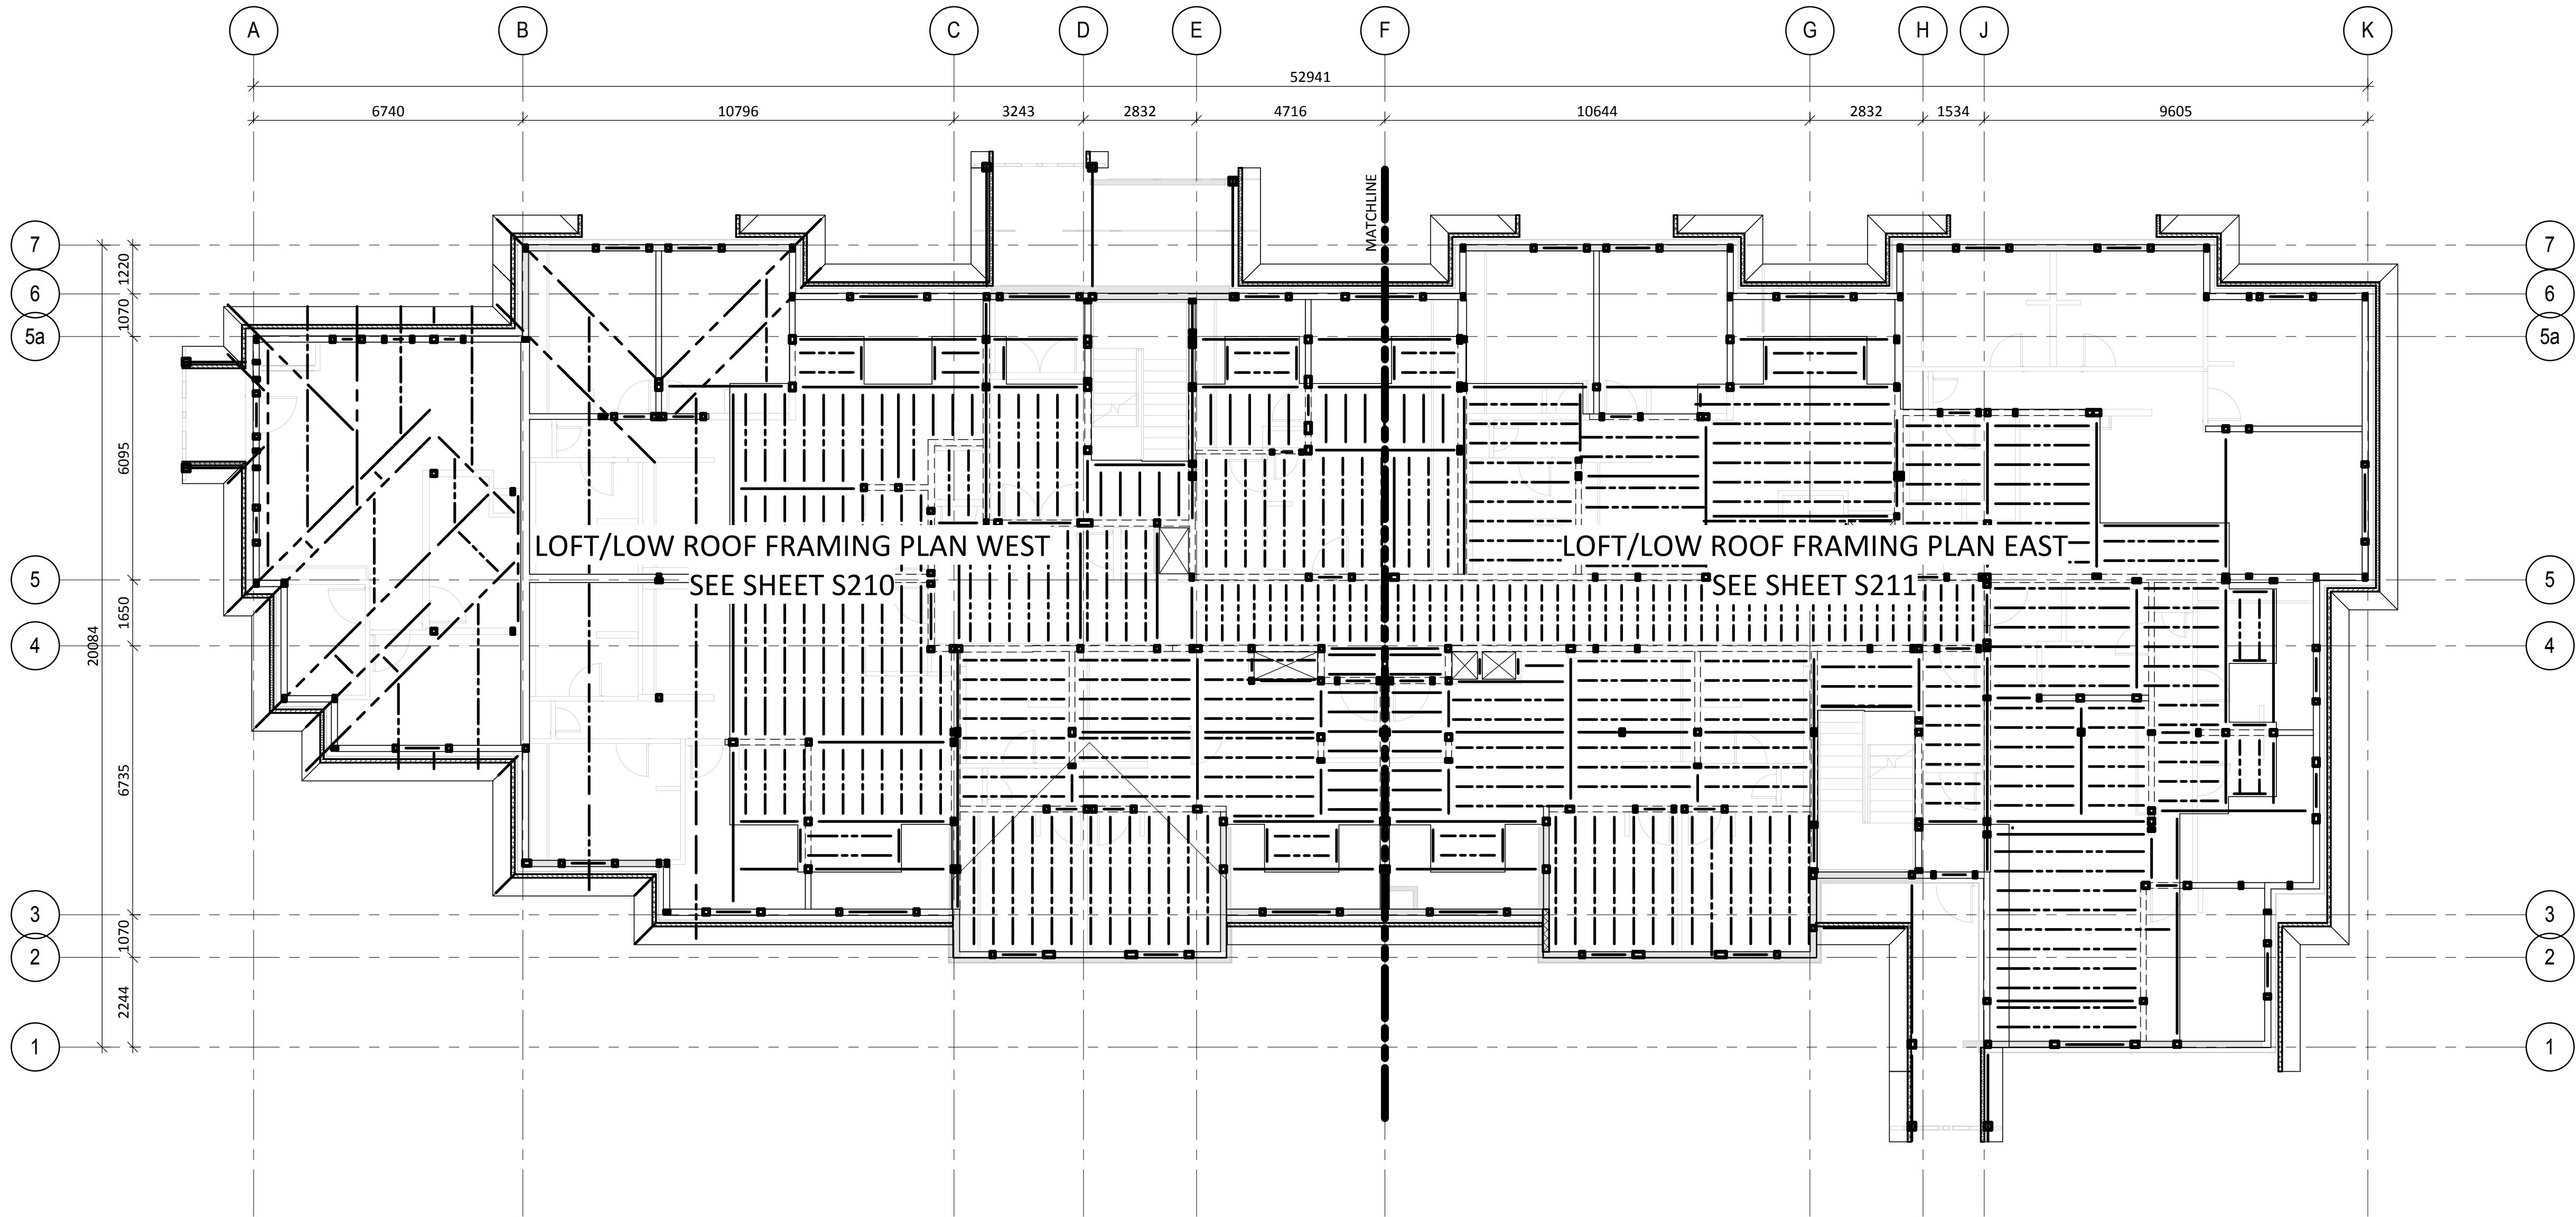1:100



1. TOP OF FINISHED FLOOR IS AT REFERENCE ELEVATION 3100 (GEODETIC 1289.95) EXCEPT AS CROSSED AND NOTED. AREAS CROSSED AND NOTED ARE TO BE READ FROM FINISHED FLOOR ELEVATION.
2. TOPS OF JOISTS AND BEAMS ARE 54mm BELOW FINISHED FLOOR ELEVATION (WHERE FLOOR IS SUPPORTED).
3. REFER TO S300 SCHEDULES FOR COLUMN, BEAMS, JOISTS AND SHEARWALL TYPES.



ROOF OVERALL PLAN

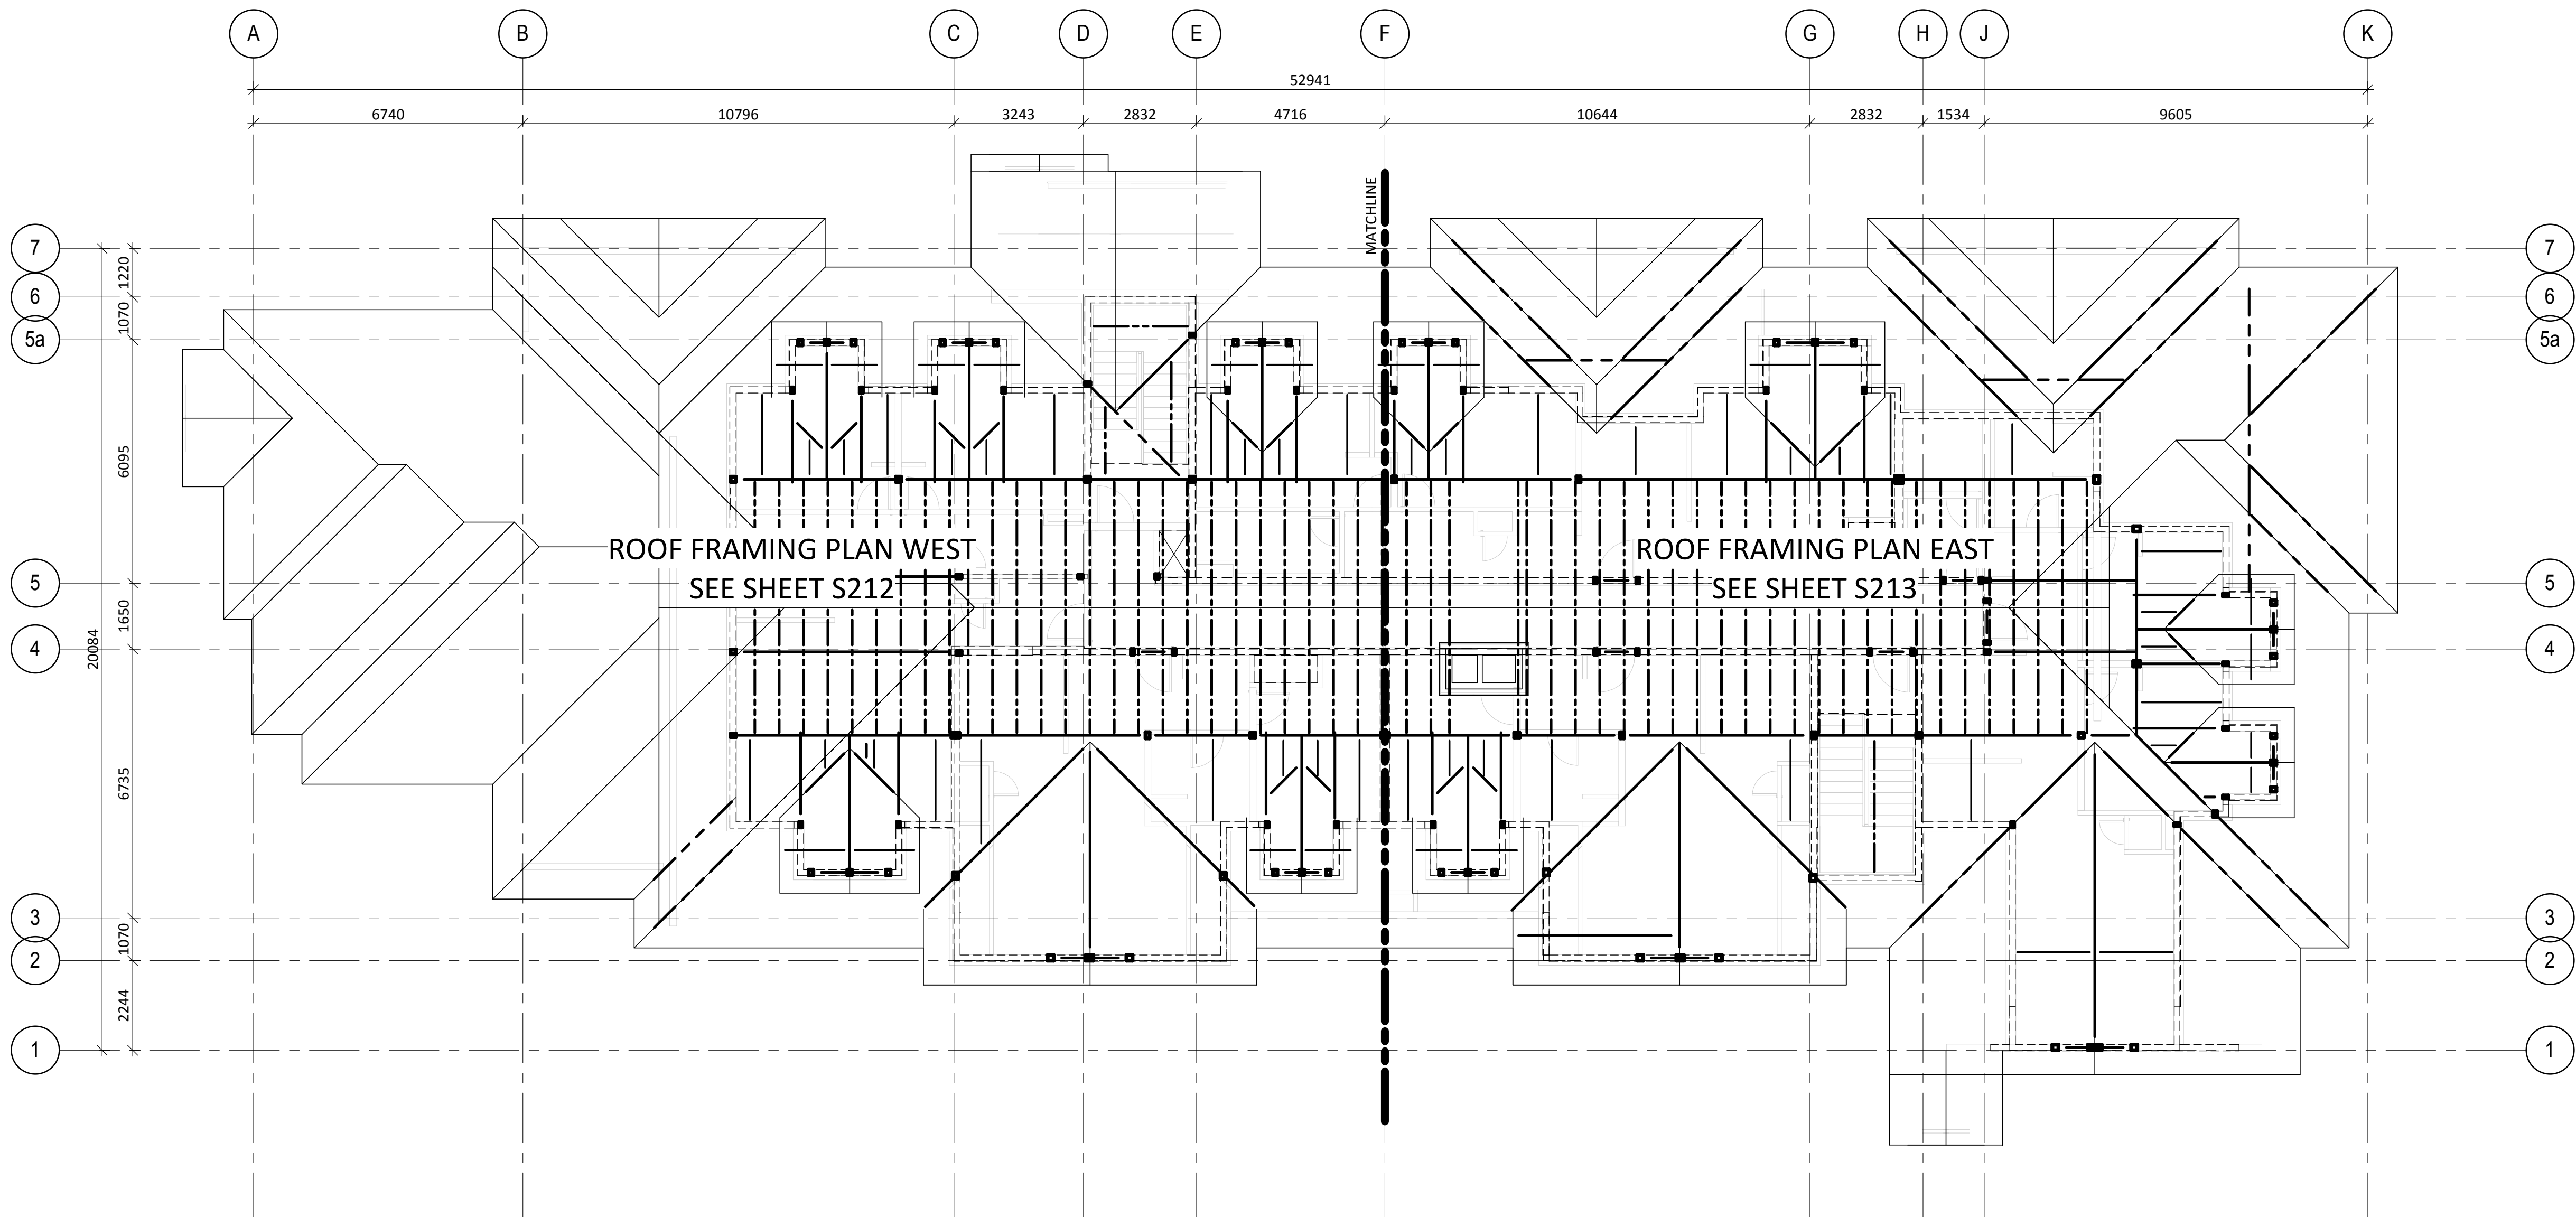1:100

1. REFER TO ARCHITECTURAL FOR ROOF SLOPES.
2. REFER TO S300 SCHEDULES FOR COLUMN, BEAMS, JOISTS AND SHEARWALL TYPES.

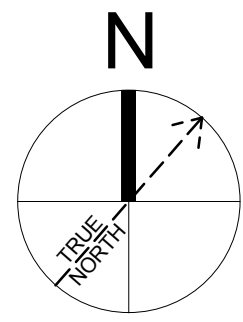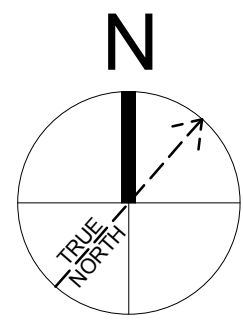

No.	Date/Date	Description/Description	Drawn by Dessiné par	Approved Approuvé
5	2016-12-08	ISSUED FOR TENDER	AD	IW
4	2016-12-08	ISSUED FOR BUILDING PERMIT	AD	IW
3	2016-09-02	ISSUED FOR 99%	AD	IW
2	2016-06-03	ISSUED FOR 66%	AD	IW

Revision / Revision	
A	detail number numéro de détail
B	source drawing no. de dessin no.
C	detail on drawing no. détail sur dessin no.

Consultant's Name Nom de l'expert-conseil	Eng. Stamp Sceau de l'ingénieur
ENTUITIVE 209 - 8th Avenue SW, Suite 300 Calgary, AB T2P 1B5 403-878-1270	

Public Works and Government Services Canada	Travaux publics et Services gouvernementaux Canada
Client Services Team Southern Alberta Operations Branch	Le Client Entretient l'Équipe Alberta Méridional Branche d'Opérations

Canada

Client/client	Parks Canada Agence Canada	L'Agence Parcs Canada
	Western and Northern Region	Ouest et Nord du Canada

Project title/Titre du projet

Staff Housing Phase 2 Waterton Lakes National Park

Drawing title/Titre du dessin

LOFT & ROOF FRAMING PLAN

Surveyed by/Arpenté par	Drawn by/Dessiné par	Date/Date
KL	AD	12/02/16
Designed by/Concept par	Reviewed by/Revisé par	Scale/Echelle
	IW	1:100

PWGSC Project Manager/Administrateur de Projets TPSGC

Randy Boldt

Client Acceptance/Acceptation du client

Approved by/Approuvé par

Task Responsible/Officer/Agent Responsable

Project No./No. du projet

Asset No./No. du bien

Sheet No./
No. de la feuille


Drawing Reference No./No. de référence du dessin

C015-0870

Fil # 945

S210

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LOFT FLOOR FRAMING PLAN - WEST

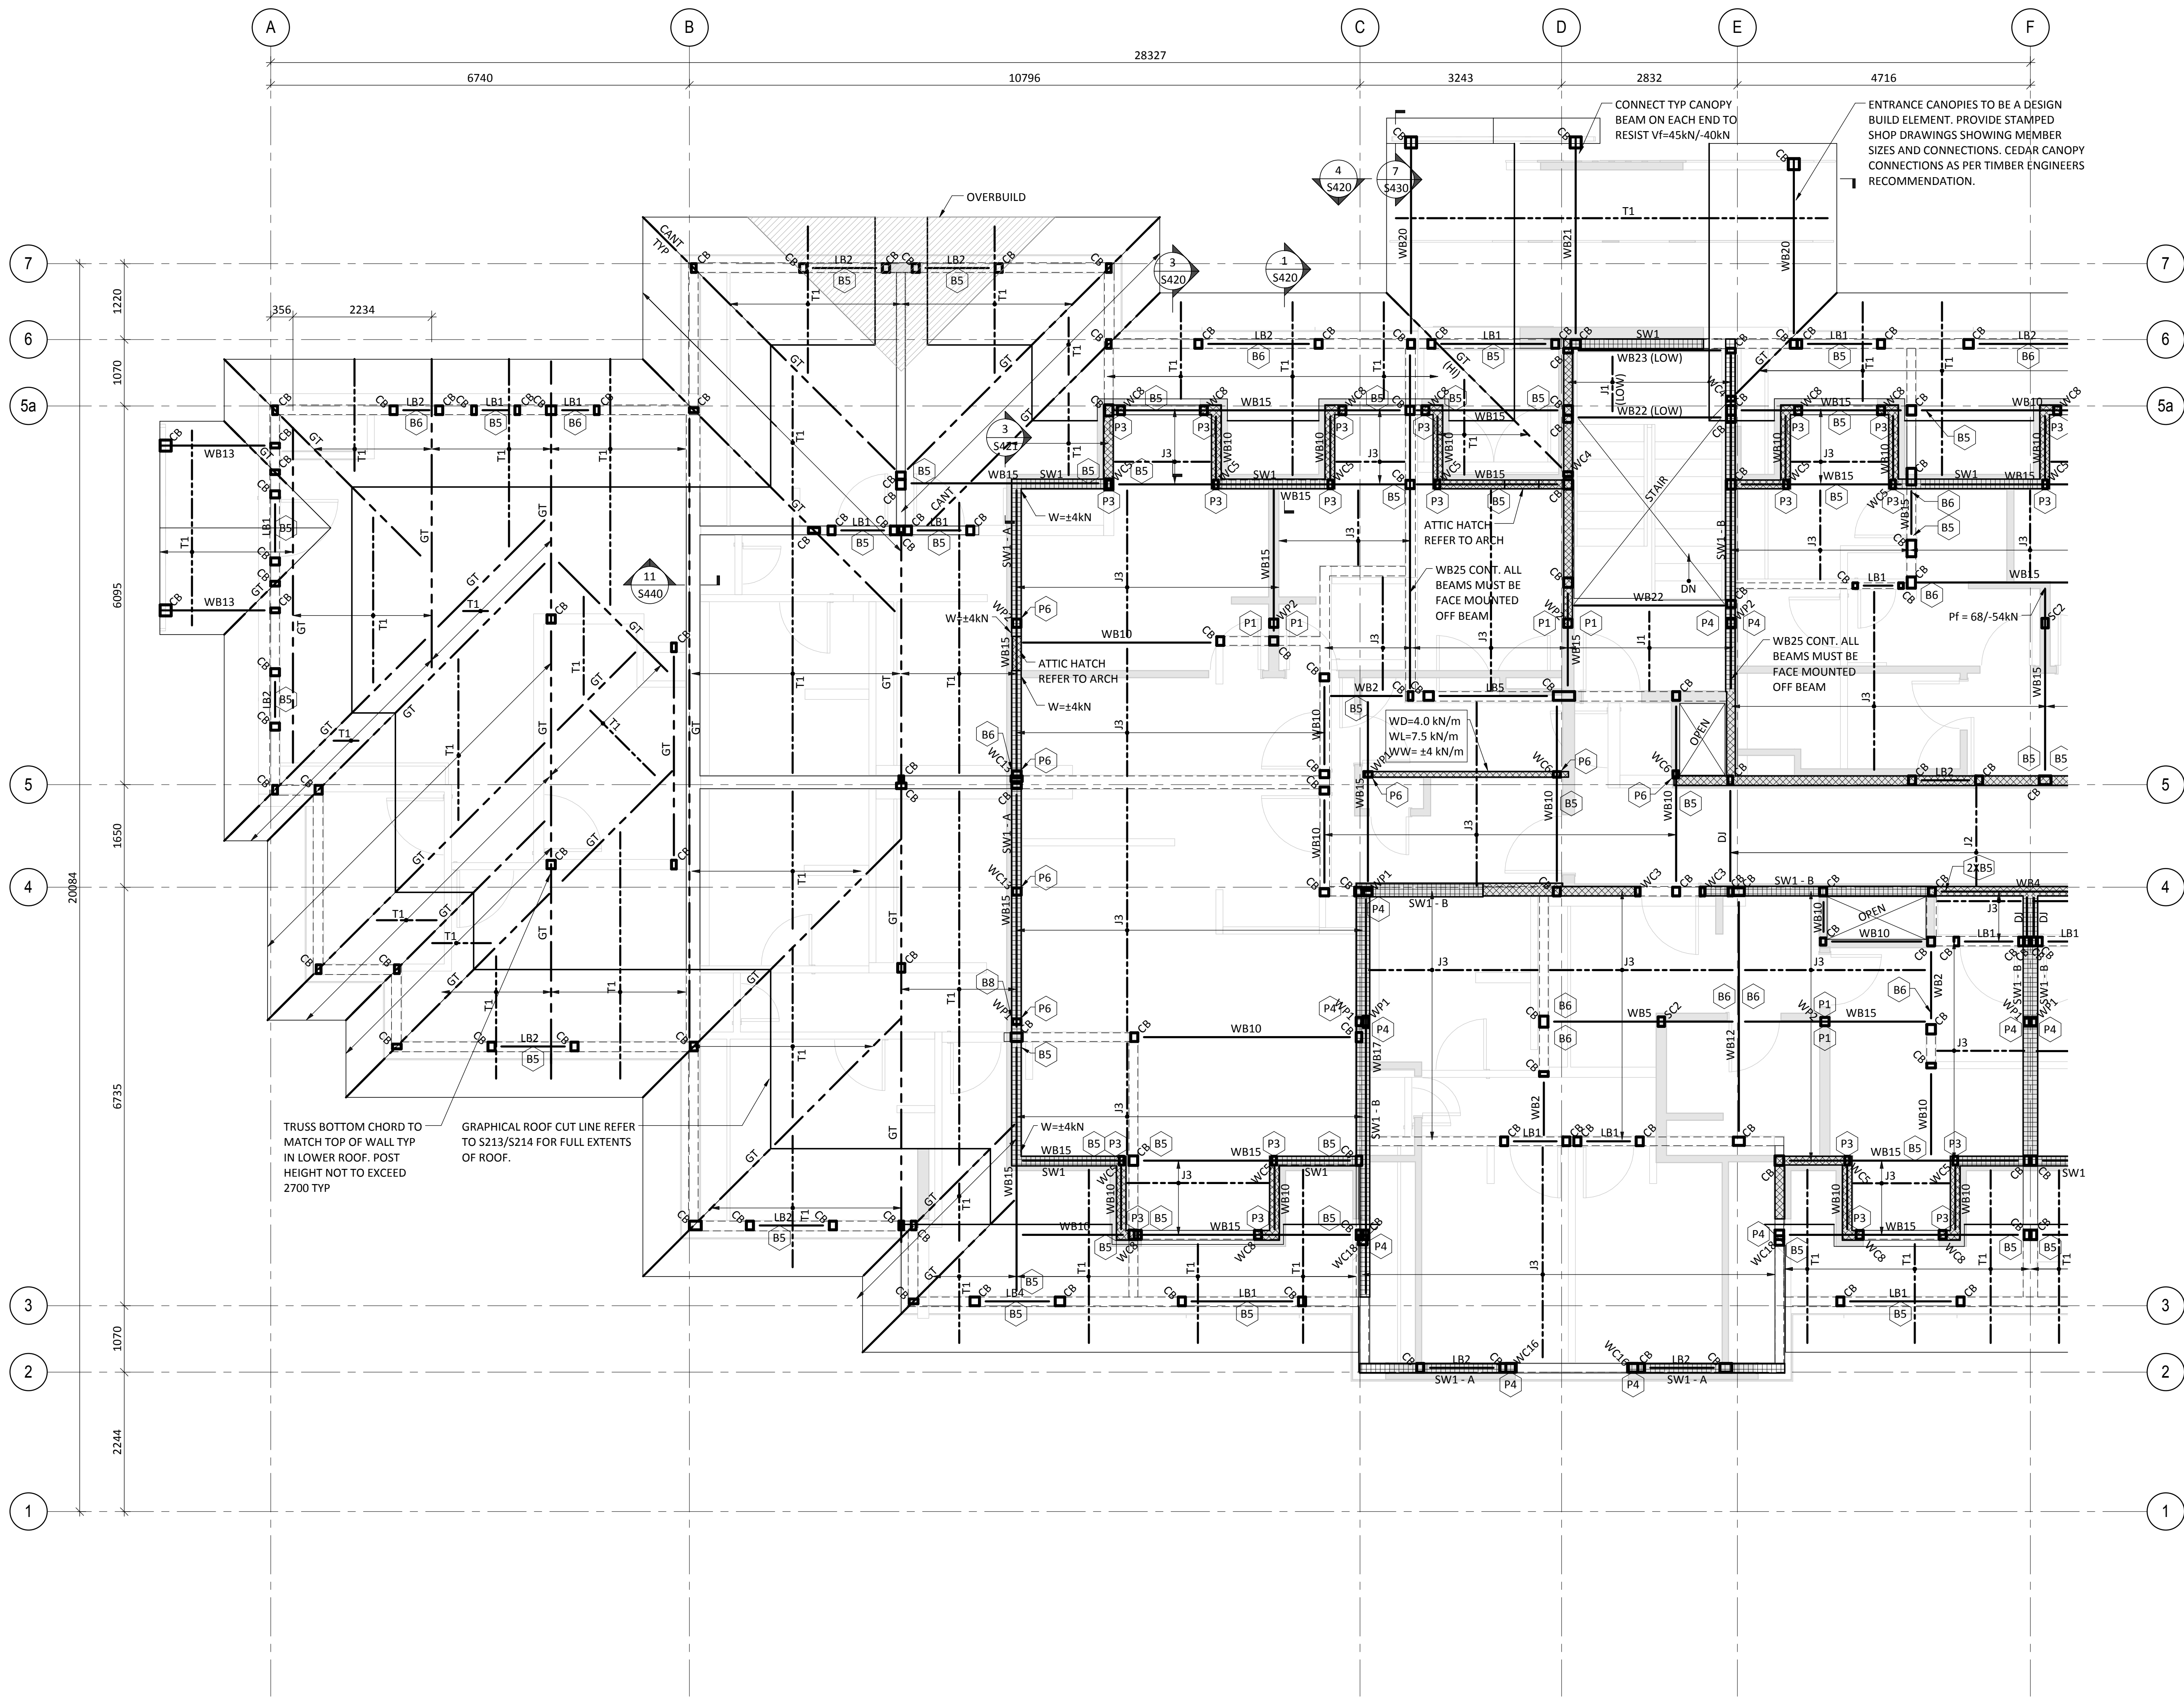1:50


NOTES:

- RIMBOARD TO BE 32mm 1.3E LSL TYP UNO.
- FLOOR SHEATHING TO BE 16mm PLYWOOD GLUED & SCREWED TO FLOOR WITH #7 SCREWS @150 o/c AT PANEL EDGES AND 300 o/c AT INTERMEDIATE MEMBERS TYP UNO.
- ROOF SHEATHING TO BE 16mm PLYWOOD FASTENED AS PER PDS.
- LINTELS AT U/S OF BEAMS/TRUSSES TYP BREAK DOUBLE TOP PLATES AS REQUIRED.
- ANCHORAGE OF GIRDER TRUSSES TO BEAMS, LINTELS & POSTS AS PER TRUSS SUPPLIERS RECOMMENDATION.
- PROVIDE 89X89 1.8E PSL BEAM AND WC3 EACH SIDE AT EACH ATTIC HATCH TYP.
- FRAMING NOTED ON PLAN AS "GT" REPRESENTS A PRE-ENGINEERED GIRDER TRUSS.
- FRAMING NOTED ON PLAN AS "T1" REPRESENTS A PRE-ENGINEERED TRUSS @ 610 o/c. (TRUSS SPACING TO BE COORDINATED BY ROOF SUPPLIER).
- FRAMING NOTED "DJ" REPRESENTS MEMBERS TO BE DESIGNED BY FLOOR SUPPLIER.

UPLIFT NOTES: NOTED ON PLAN AS FOLLOWS:

- MSTC48B3 STRAP CONNECTING POST TO BEAM. USE 10ØX64 LG NAILS.
- VGT W/ 16MM THREADED ROD CONNECTING BEAM TO HDU5-SDS2.5 ON POST
- 1 - LSTA24 CONNECTING POST TO BEAM
- MSTC66 STRAP CONNECTING POST TO POST
- 1 - HTS16 E/E CONNECTING BEAM TO POST
- MSTC48B3 STRAP E/E CONNECTING BEAM TO POST.
- HDU5-SDS2.5 ON POST W/ 16MM THREADED ROD CONNECTED TO VGTR/L ON BEAM.
- HTS16 CONNECTING BEAM TO LINTEL BELOW.

UPLIFT NOTE NUMBER AS PER BELOW
(B) - BEAM/LINTEL/TRUSS TO POST BELOW CONNECTION
(P) - POST TO BEAM/LINTEL BELOW CONNECTION

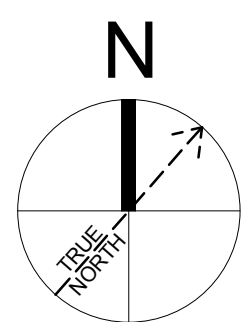

5	2016-12-08	ISSUED FOR TENDER	AD	IW
4	2016-12-08	ISSUED FOR BUILDING PERMIT	AD	IW
3	2016-09-02	ISSUED FOR 99%	AD	IW
2	2016-06-14	ISSUED FOR 66%	AD	IW
No.	Date/Date	Description/Description	Drawn by/Dessiné par	Approved/Approuvé

Revision / Revision	
A	detail number numero de detail
B	source drawing no. de dessin no.
C	detail on drawing no. detail sur dessin no.

Consultant's Name
Nom de l'expert-conseil

ENTUITIVE
209 - 8th Avenue SW, Suite 300
Calgary, AB T2P 1B5
403-878-1270

Eng. Stamp
Sceau de l'ingénieur

Public Works and Government Services Canada
Travaux publics et Services gouvernementaux Canada

Client Services Team
Southern Alberta Operations Branch
Le Client Entretien l'Équipe
Alberta Méridional Branche d'Opérations

Canada

Client/client
Parks Canada Agency
L'Agence Parcs Canada

Western and Northern Region
Ouest et Nord du Canada

Staff Housing Phase 2 Waterton Lakes National Park

LOFT/LOW ROOF FRAMING PLAN - WEST

Surveyed by/Arpenté par	Drawn by/Dessiné par	Date/Date
KL	AD	12/02/16
Designed by/Concept par	Reviewed by/Revisé par	Scale/Echelle
	IW	As indicated

PWGSC Project Manager/Administrateur de Projets TPSCG

Client Acceptance/Acceptation du client

Approved by/Approuvé par

Task Responsible/Responsable de la tâche


PWGSC Project Manager/Administrateur de Projets TPSCG

Project No./No. du projet	Asset No./No. du bien	Sheet No./No. de la feuille
C015-0870	File # 945	

Drawing Reference No./No. de référence du dessin

S211

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LOFT FLOOR FRAMING PLAN - EAST

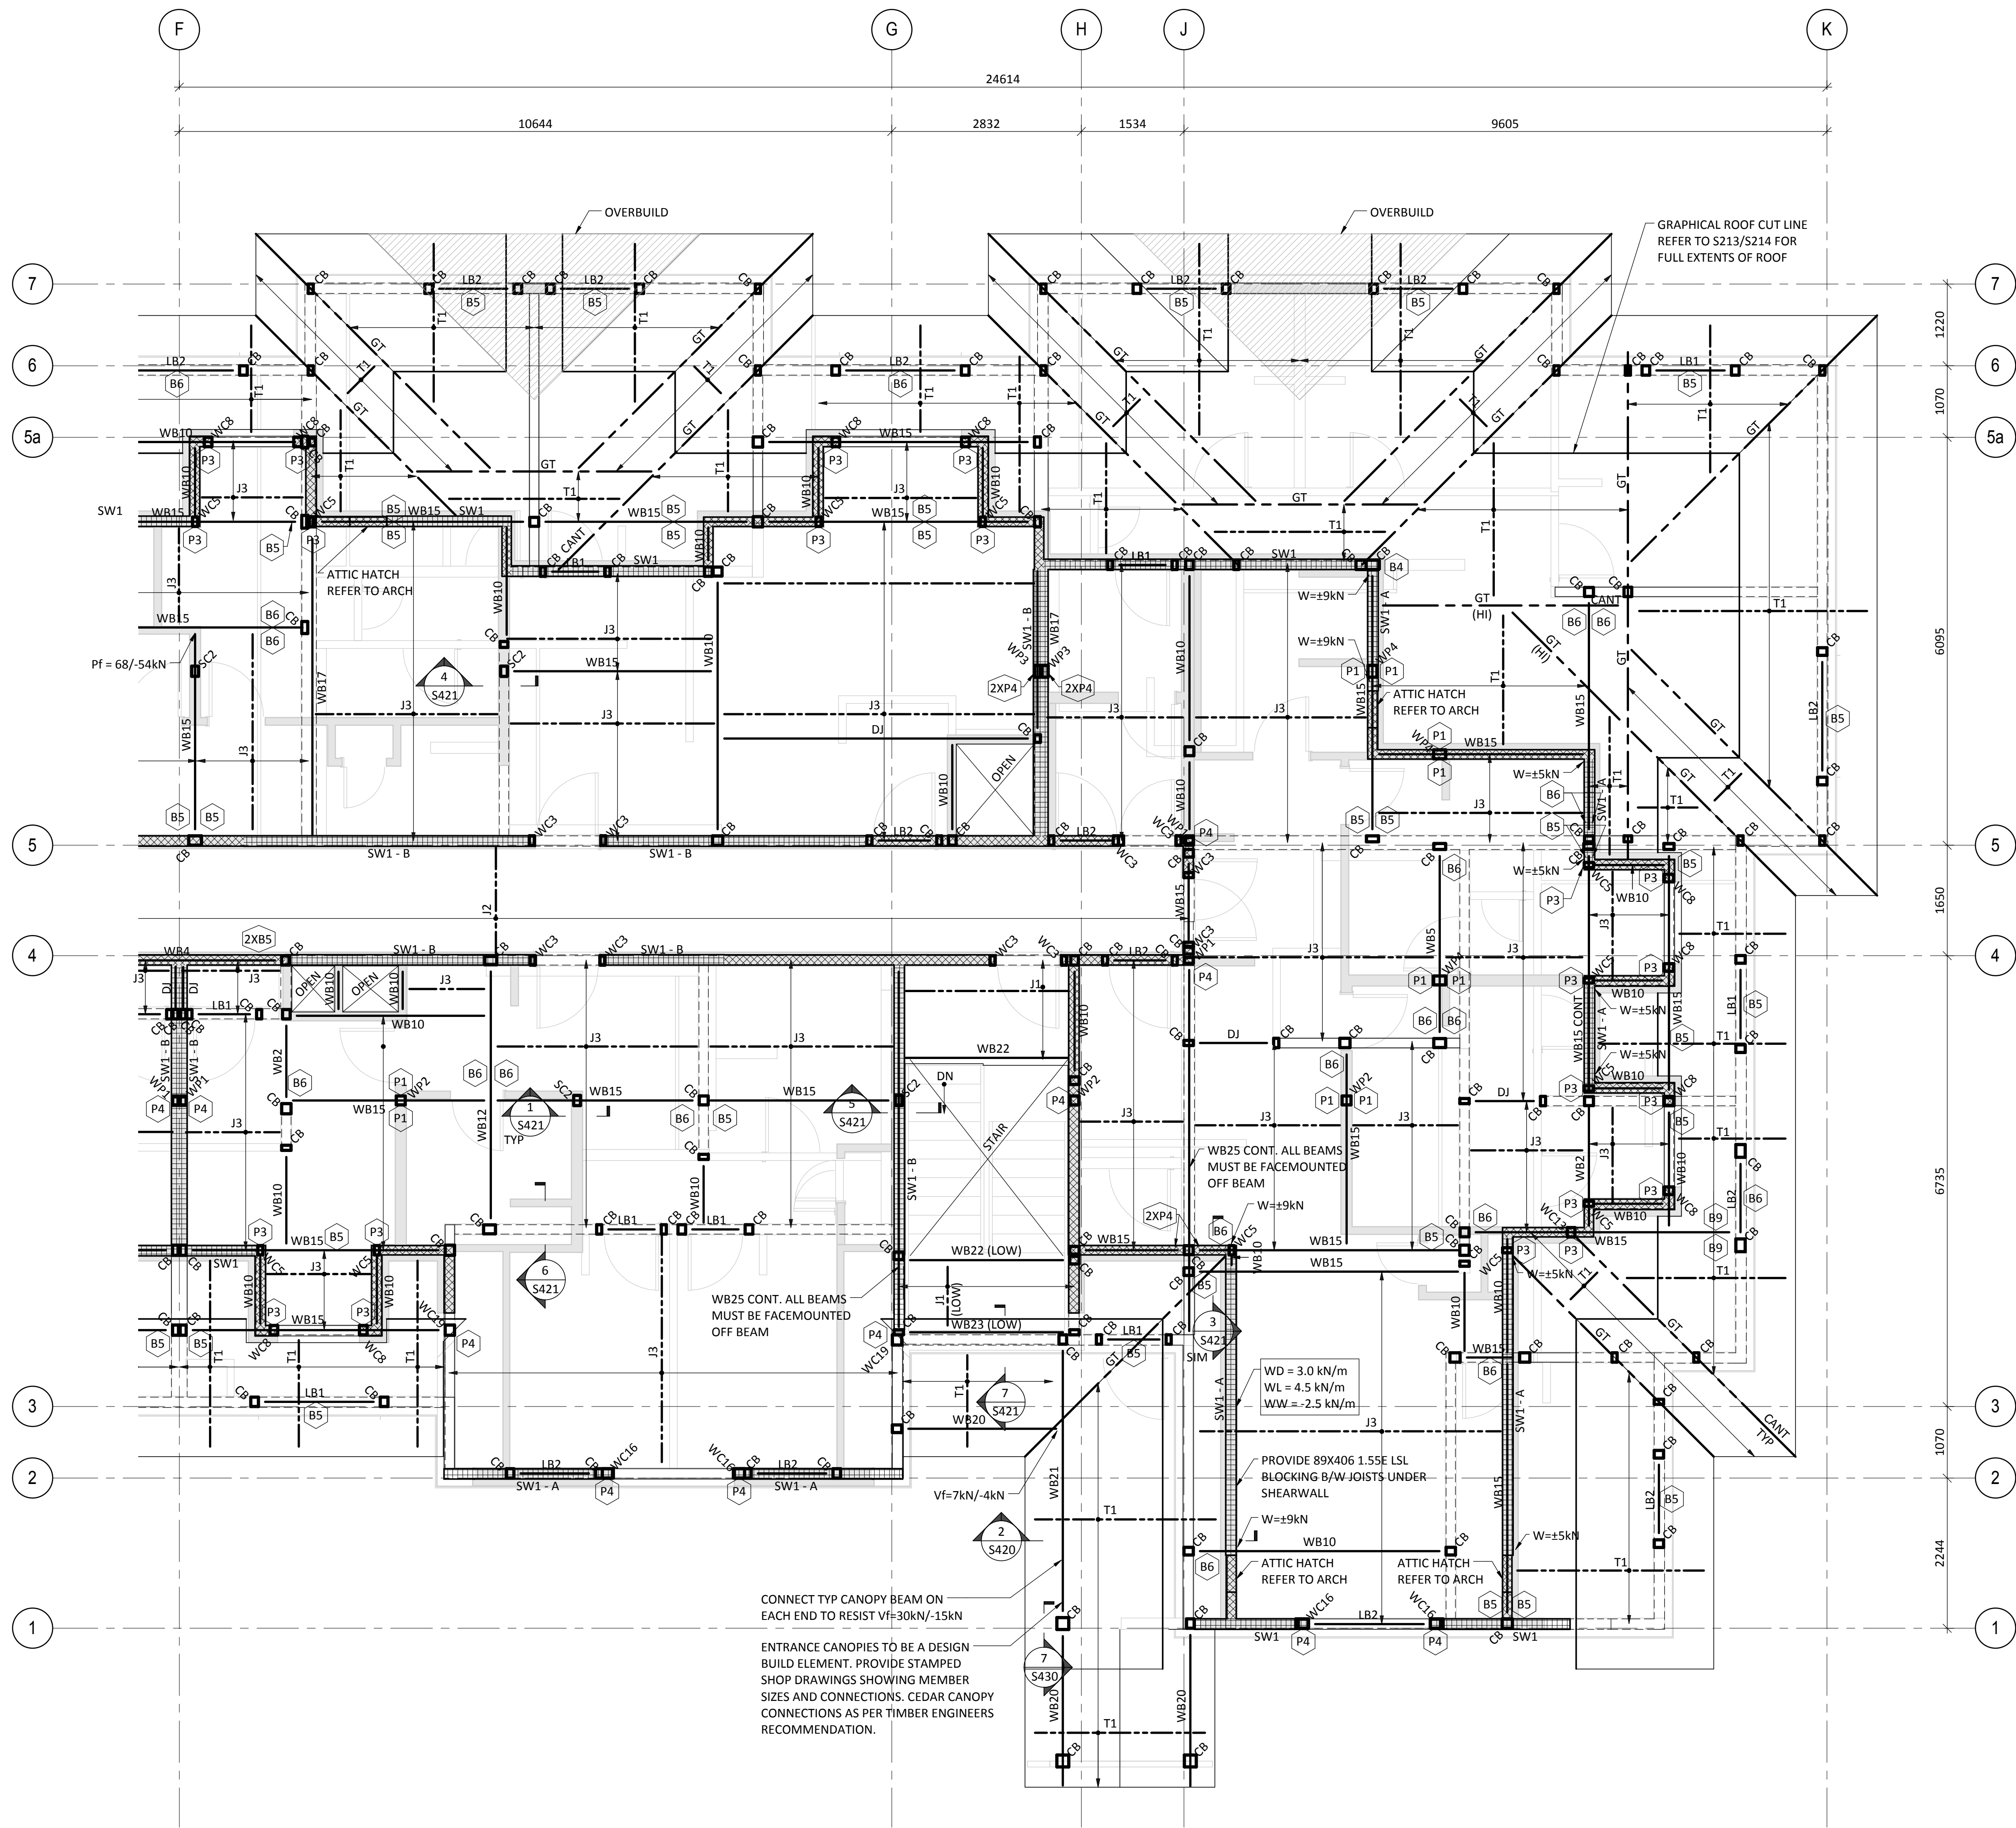1:50


NOTES:

- RIMBOARD TO BE 32mm 1.3E LSL TYP UNO.
- FLOOR SHEATHING TO BE 16mm PLYWOOD GLUED & SCREWED TO FLOOR WITH #7 SCREWS @150 o/c AT PANEL EDGES AND 300 o/c AT INTERMEDIATE MEMBERS TYP UNO.
- ROOF SHEATHING TO BE 16mm PLYWOOD FASTENED AS PER PDS.
- LINTELS AT U/S OF BEAMS/TRUSSES TYP BREAK DOUBLE TOP PLATES AS REQUIRED.
- ANCHORAGE OF GIRDER TRUSSES TO BEAMS, LINTELS & POSTS AS PER TRUSS SUPPLIERS RECOMMENDATION.
- PROVIDE 89X89 1.8E PSL BEAM AND WC3 EACH SIDE AT EACH ATTIC HATCH TYP.
- FRAMING NOTED ON PLAN AS "GT" REPRESENTS A PRE-ENGINEERED GIRDER TRUSS.
- FRAMING NOTED ON PLAN AS "T1" REPRESENTS A PRE-ENGINEERED TRUSS @ 610 o/c. (TRUSS SPACING TO BE COORDINATED BY ROOF SUPPLIER).
- FRAMING NOTED "DJ" REPRESENTS MEMBERS TO BE DESIGNED BY FLOOR SUPPLIER.

UPLIFT NOTES: NOTED ON PLAN AS FOLLOWS:

- MSTC4883 STRAP CONNECTING POST TO BEAM. USE 100X64 LG NAILS.
- VTG W/ 16MM THREADED ROD CONNECTING BEAM TO HDU5-SDS2.5 ON POST
- 1 - LSTA24 CONNECTING POST TO BEAM
- MSTC66 STRAP CONNECTING POST TO POST
- 1 - HTS16 E/E CONNECTING BEAM TO POST
- MSTC4883 STRAP E/E CONNECTING BEAM TO POST.
- HDU5-SDS2.5 ON POST W/ 16MM THREADED ROD CONNECTED TO VTGR/L ON BEAM.
- HTS16 CONNECTING BEAM TO LINTEL BELOW.

(B) - BEAM/LINTEL/TRUSS TO POST BELOW CONNECTION
(P) - POST TO BEAM/LINTEL BELOW CONNECTION

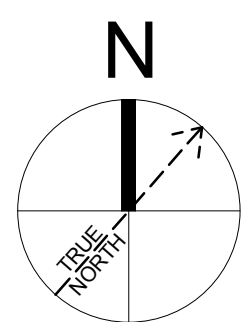

No.	Date/Date	Description/Description	Drawn by/Dessiné par	Approved/Approuvé
5	2016-12-08	ISSUED FOR TENDER	AD	IW
4	2016-12-08	ISSUED FOR BUILDING PERMIT	AD	IW
3	2016-09-02	ISSUED FOR 99%	AD	IW
2	2016-06-14	ISSUED FOR 66%	AD	IW

Revision / Revision
A detail number numero de detail
B source drawing no. de dessin no.
C detail on drawing no. detail sur dessin no.

Consultant's Name
Nom de l'expert-conseil

ENTUITIVE
209 - 8th Avenue SW, Suite 300
Calgary, AB T2P 1B5
403-878-1270

Eng. Stamp
Sceau de l'ingénieur


 Public Works and
Government Services
Canada

Travaux publics et
Services gouvernementaux
Canada

Client Services Team
Southern Alberta
Operations Branch

Le Client Entretien l'Équipe
Alberta Méridional
Branche d'Opérations

 Client/client

Parks Canada
Agence

L'Agence Parcs
Canada

Western and
Northern Region

Ouest et Nord
du Canada

Staff Housing Phase 2 Waterton Lakes National Park

LOFT/LOW ROOF FRAMING PLAN - EAST

Surveyed by/Arpenté par	Drawn by/Dessiné par	Date/Date
KL	AD	12/02/16
Designed by/Concept par	Reviewed by/Revisé par	Scale/Echelle
	IW	As indicated

PWGSC Project Manager/Administrateur de Projets TPSCG

Client Acceptance/Acceptation du client

Approved by/Approuvé par

Task Responsible/Responsable de la tâche

PWGSC Project Manager/Administrateur de Projets TPSCG

Project No./No. du projet

Asset No./No. du bien


Sheet No./
No. de la feuille

Drawing Reference No./No. de référence du dessin

C015-0870

Fil # 945

S212

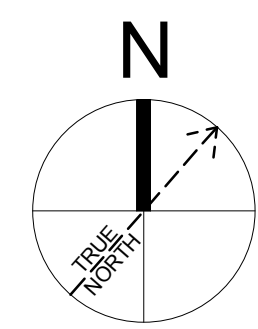


1. 4 - HTS16 CONNECTING BEAM TO POST (B) - BEAM/INTEL/TRUSS TO POST BELOW CONNECTION
2. 1 - MSTC4883 E/E CONNECTING LINTEL TO POST (P) - POST TO BEAM/LINTEL BELOW CONNECTION
3. 1 - HTS 16 CONNECTING BEAM TO POST.
4. 1 - LSTA24 E/E CONNECTING LINTEL TO POST.
5. 1 - HTS16 CONNECTING BEAM TO POST
6. 1 - H2.5T TIE E/E
7. 2 - H2.5T THE CONNECTING BEAM TO POST
8. VGT W/ 16MM THREADED ROD CONNECTING BEAM TO HDU5-SDS2.5 ON POST
9. VGT/R/L W/ 16MM THREADED ROD CONNECTING BEAM TO HDU5-SDS2.5 ON POST
10. MSTC4883 CONNECTING BEAM TO POST.
11. LGT2 CONNECTING GIRDER TRUSS TO POST. TBC BY TRUSS SUPPLIER
12. MSTC66 STRAP CONNECTING POST TO POST
13. HDU5-SDS2.5 W/ 16MM THREADED ROD CONNECTING BEAM TO HDU5-SDS2.5 ON POST
14. HDQ8-SDS3 W/ 22MM THREADED ROD CONNECTING BEAM TO HDQ8-SDS3 ON POST
15. 2 - MST340 STRAPS CONNECTING BEAM TO POST
16. 1 - HTS 16 CONNECTING POST TO LINTEL
17. 4 - HTS 16 CONNECTING POST TO LINTEL
18. FASTEN BOTTOM PLATE TO BEAM BELOW WITH 8MMX150LG RSS SCREWS @ 200 O.C. MAX.

Staff Housing Phase 2 Waterton Lakes National Park

ROOF FRAMING PLAN - WEST

Surveyed by/Arpenté par	AD	Drawn by/Dessiné par	Date/Date
Designed by/Concept par	KL	Reviewed by/Revisé par	12/02/16
		IW	Scale/Echelle As indicated
PWGSC Project Manager/Administrateur de Projets TPSCC			
<div style="text-align: center;">Randy Boldt</div>			
Client Acceptance/Acceptation du client		Approved by/Approuve par	
<div style="border: 1px solid black; height: 40px; width: 100%;"></div>		<div style="border: 1px solid black; height: 40px; width: 100%;"></div>	
<i>Pink: Responsible Officer/Agent Responsable</i>		<i>PWGSC Project Manager/Administrateur de Projets TPSCC</i>	
Project No./No. du projet	Asset No./No. du bien	Sheet No./No. de la feuille	
C015-0870	File # 945		
Drawing Reference No./No. de référence du dessin		<div style="font-size: 2em; font-weight: bold; text-align: center;">S213</div>	

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ROOF FRAMING PLAN - EAST

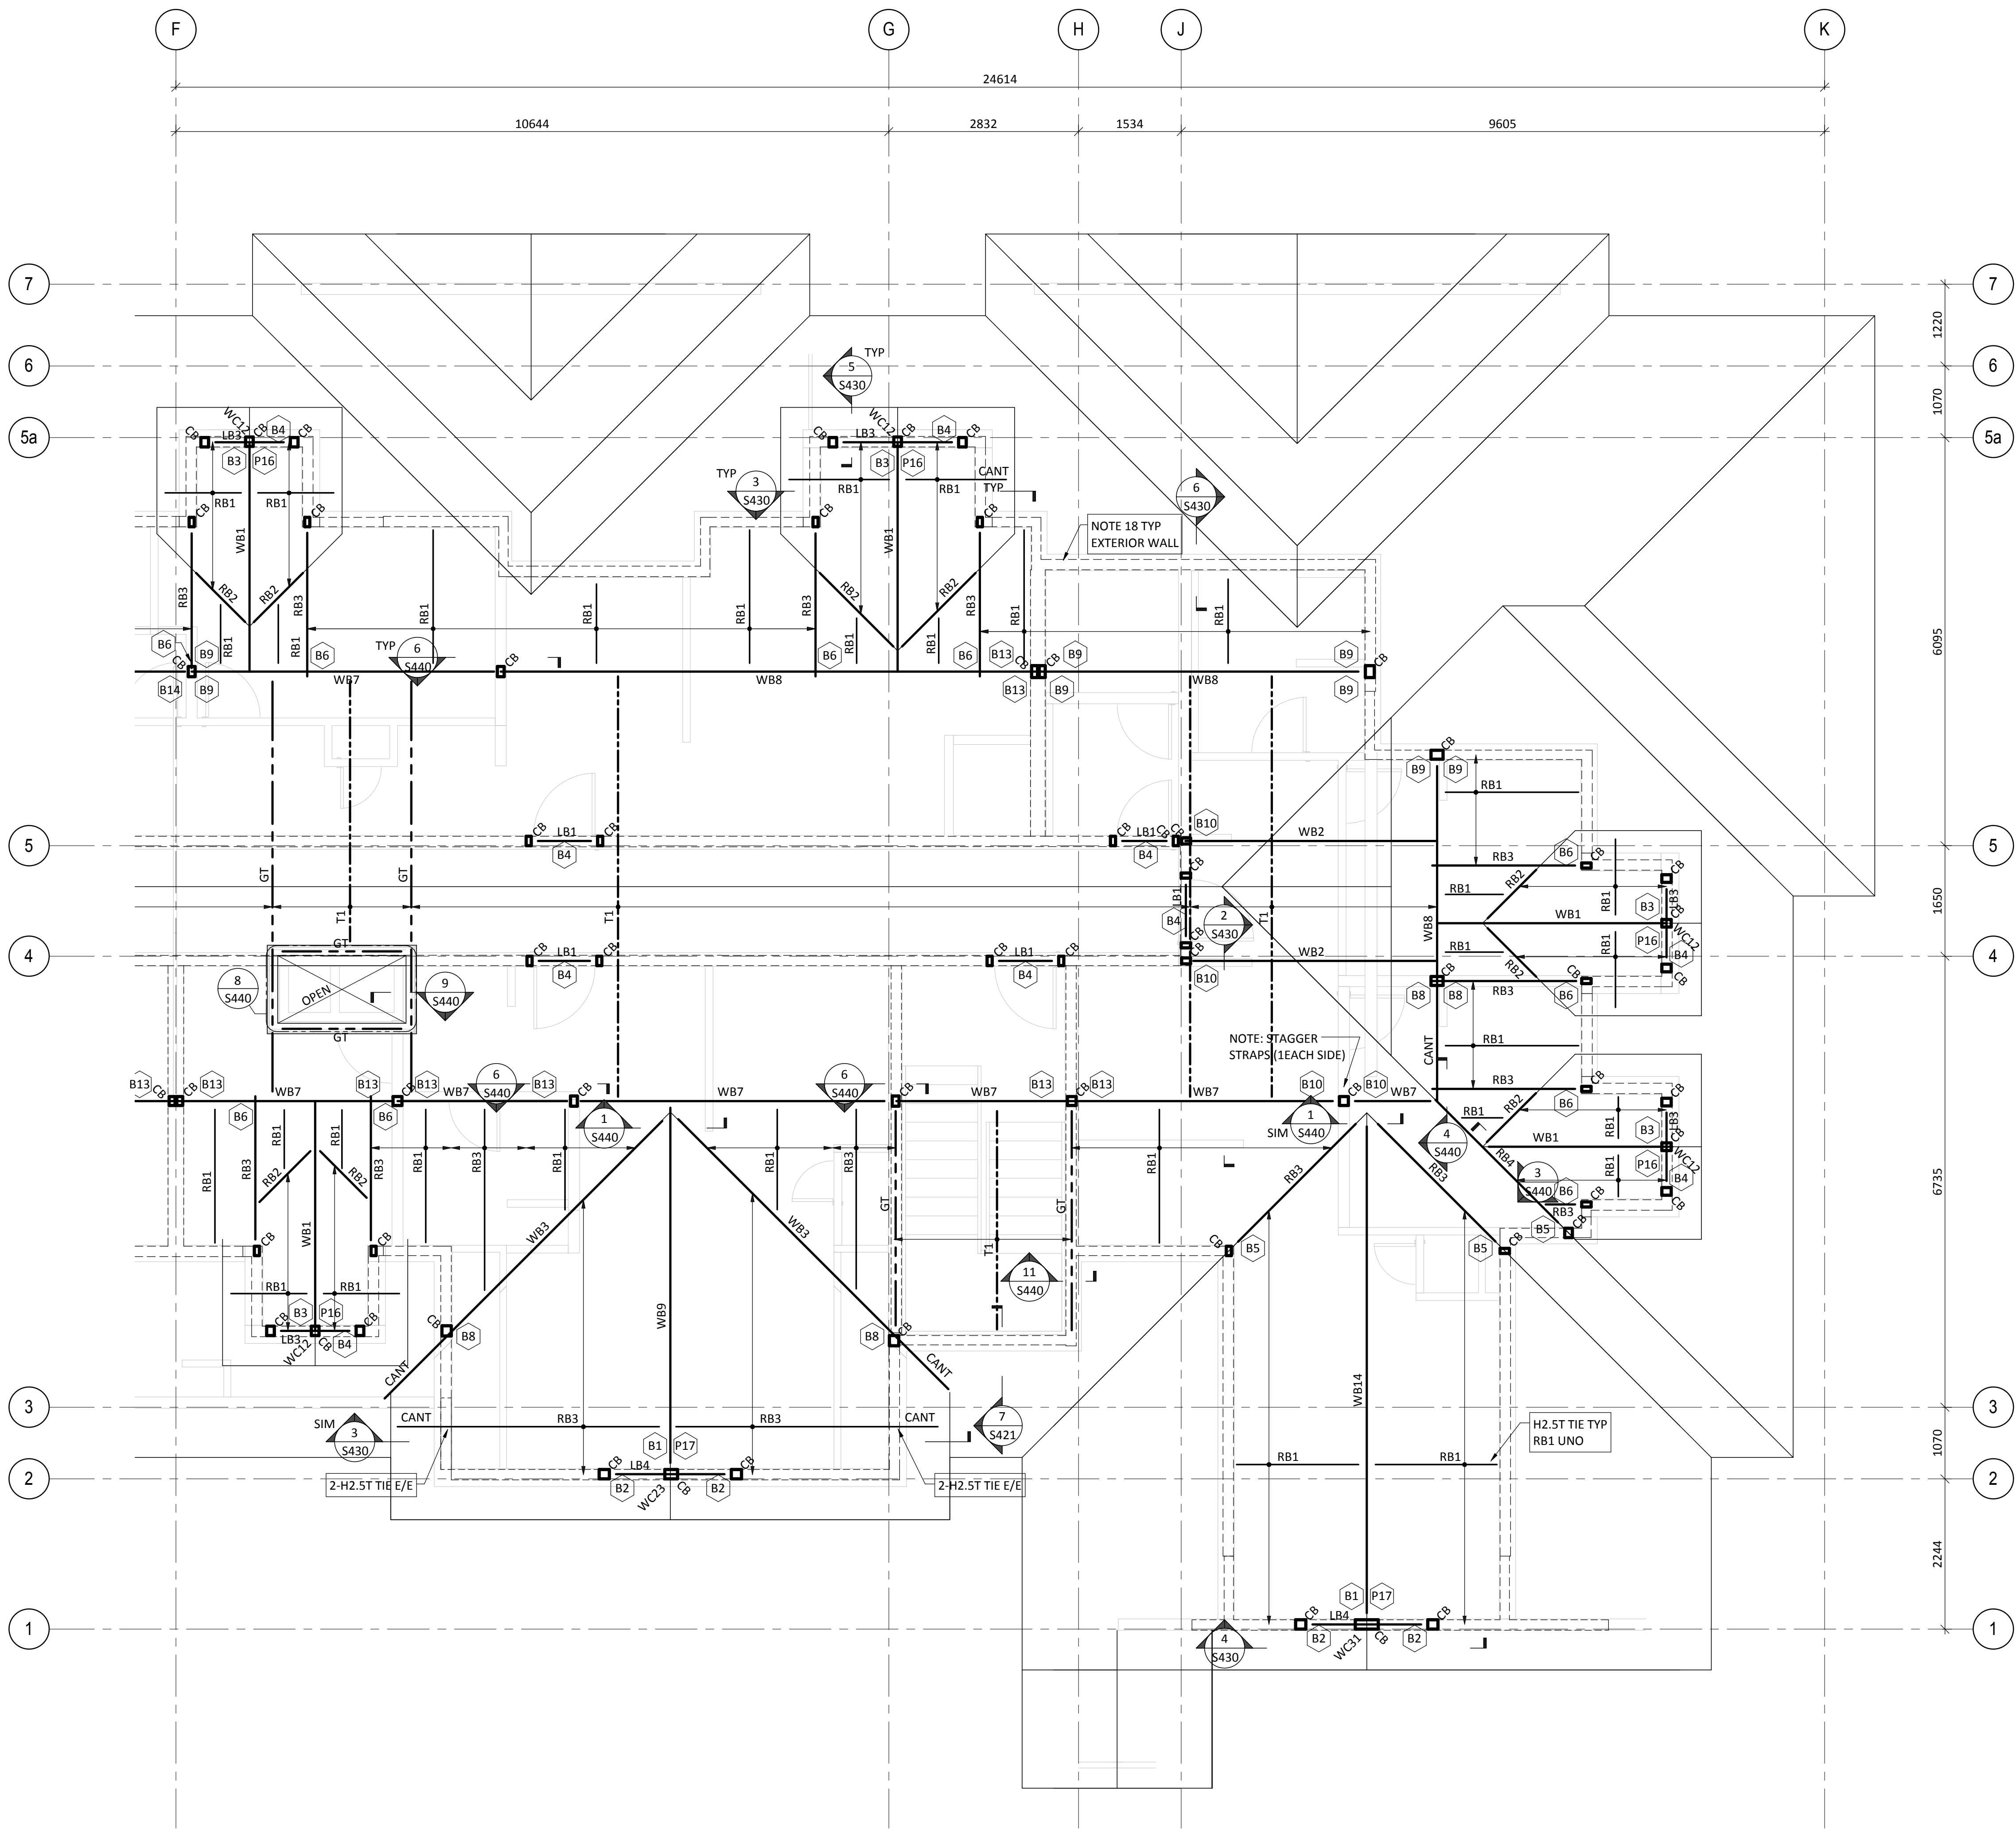1:50

NOTES:


1. RIMBOARD TO BE 32mm 1.3E LSL TYP UNO.
2. ROOF SHEATHING TO BE 16mm PLYWOOD FASTENED AS PER PDS.
3. LINTELS AT U/S OF BEAMS/TRUSSES TYP BREAK DOUBLE TOP PLATES AS REQUIRED.
4. ANCHORAGE OF GIRDER TRUSSES TO BEAMS, LINTELS & POSTS AS PER TRUSS SUPPLIERS RECOMMENDATION.
5. - FRAMING NOTED ON PLAN AS "GT" REPRESENTS A PRE-ENGINEERED GIRDER TRUSS.
- FRAMING NOTED ON PLAN AS "T1" REPRESENTS A PRE-ENGINEERED TRUSS @ 610 o/c. (TRUSS SPACING TO BE COORDINATED BY ROOF SUPPLIER).
- FRAMING NOTED "DJ" REPRESENTS MEMBERS TO BE DESIGNED BY FLOOR SUPPLIER.

UPLIFT NOTES: NOTED ON PLAN AS FOLLOWS:

1. 4 - HTS16 CONNECTING BEAM TO POST
2. 1 - MSTC48B3 E/E CONNECTING LINTEL TO POST
3. 1 - HTS 16 CONNECTING BEAM TO POST.
4. 1 - LSTA24 E/E CONNECTING LINTEL TO POST
5. 1 - HTS16 CONNECTING BEAM TO POST
6. 1 - H2.5T TIE E/E
7. 2 - H2.5T TIE CONNECTING BEAM TO POST
8. VGT W/ 16MM THREADED ROD CONNECTING BEAM TO HDUS-SDS2.5 ON POST
9. VGTR/L W/ 16MM THREADED ROD CONNECTING BEAM TO HDUS-SDS2.5 ON POST
10. MSTC48B3 CONNECTING BEAM TO POST.
11. LGT2 CONNECTING GIRDER TRUSS TO POST. TBC BY TRUSS SUPPLIER
12. MSTC66 STRAP CONNECTING POST TO POST
13. HDUS-SDS2.5 W/ 16MM THREADED ROD CONNECTING BEAM TO HDUS-SDS2.5 ON POST
14. HDQ8-SDS3 W/ 22MM THREADED ROD CONNECTING BEAM TO HDQ8-SDS3 ON POST
15. 2 - MSTA30 STRAPS CONNECTING BEAM TO POST
16. 1 - HTS 16 CONNECTING POST TO LINTEL
17. 4 - HTS 16 CONNECTING POST TO LINTEL
18. FASTEN BOTTOM PLATE TO BEAM BELOW WITH 8MMX150LG RSS SCREWS @ 200 O.C. MAX.

UPLIFT NOTE NUMBER AS PER BELOW

- (B) - BEAM/LINTEL/TRUSS TO POST BELOW CONNECTION
(P) - POST TO BEAM/LINTEL BELOW CONNECTION

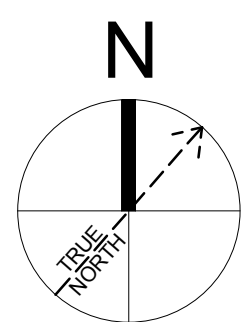

5	2016-12-08	ISSUED FOR TENDER	AD	IW
4	2016-12-08	ISSUED FOR BUILDING PERMIT	AD	IW
3	2016-09-02	ISSUED FOR 99%	AD	IW
2	2016-06-14	ISSUED FOR 66%	AD	IW
No.	Date/Date	Description/Description	Drawn by Dessine par	Approved Approuve

Revision / Revision	
A	detail number numero de detail
B	source drawing no. de dessin no.
C	detail on drawing no. detail sur dessin no.

Consultant's Name
Nom de l'expert-conseil

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Eng. Stamp
Sceau de l'ingénieur

Public Works and
Government Services
Canada

Travaux publics et
Services gouvernementaux
Canada

Client Services Team
Southern Alberta
Operations Branch

Le Client Entretien l'Équipe
Alberta Méridional
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Client/client

Parks Canada
Agency

L'Agence Parcs
Canada

Western and
Northern Region

Ouest et Nord
du Canada

Staff Housing Phase 2
Waterton Lakes National
Park

ROOF FRAMING
PLAN - EAST

Surveyed by/Arpente par	Drawn by/Dessine par	Date/Date
KL	AD	12/02/16
Designed by/Concept par	Reviewed by/Revisé par	Scale/Echelle
	IW	As indicated

PWGSC Project Manager/Administrateur de Projets TPSCG

Client Acceptance/Acceptation du client

Approved by/Approuve par

Project Responsible/Officier/Responsable

PWGSC Project Manager/Administrateur de Projets TPSCG

Project No./No. du projet

Asset No./No. du bien

Sheet No./
No. de la feuille

Drawing Reference No./No. de référence du dessin


C015-0870

Fil # 945


S214

SHEARWALL SCHEDULE			
MARK	SHEATHING	NAILS	NAIL SPACING
SW1	15.5mm PLYWWOD	3.66ØX75LG	150 o/c AT PANEL EDGES
SW2	15.5mm PLYWWOD	3.66ØX75LG	75 o/c AT PANEL EDGES
SW3	15.5mm PLYWWOD	3.66ØX75LG	50 o/c AT PANEL EDGES


- NOTE:
- PLYWOOD ON SIDE OF WALL WITH TEXT TYPICAL.
 - ALL SHEARWALLS GREATER THAN 2440 IN HEIGHT TO BE BLOCKED AT PANEL EDGES.
 - PANEL JOINTS ARE TO BE OFFSET TO FALL ON DIFFERENT MEMBERS OR FRAMING IS TO BE 64mm OR THICKER AND NAILS ON EACH SIDE SHALL BE STAGGERED.
 - ALL SHEARWALLS TO HAVE 2 PLY POST EACH END TYP UNO.
 - SHEARWALLS LOCATED ON SIDE OF WALL WITH TEXT TYP UNO.
 - VERTICAL PENETRATIONS NOT PERMITTED THROUGH SHEARWALLS TYP.
 - SW'X'-Y' INDICATES SHEARWALL:
 - X = SHEATHING THICKNESS AND NAILING PATTERN, REFER TO SCHEDULE
 - Y = HOLDOWN REQUIRED EACH END, REFER TO SCHEDULE.

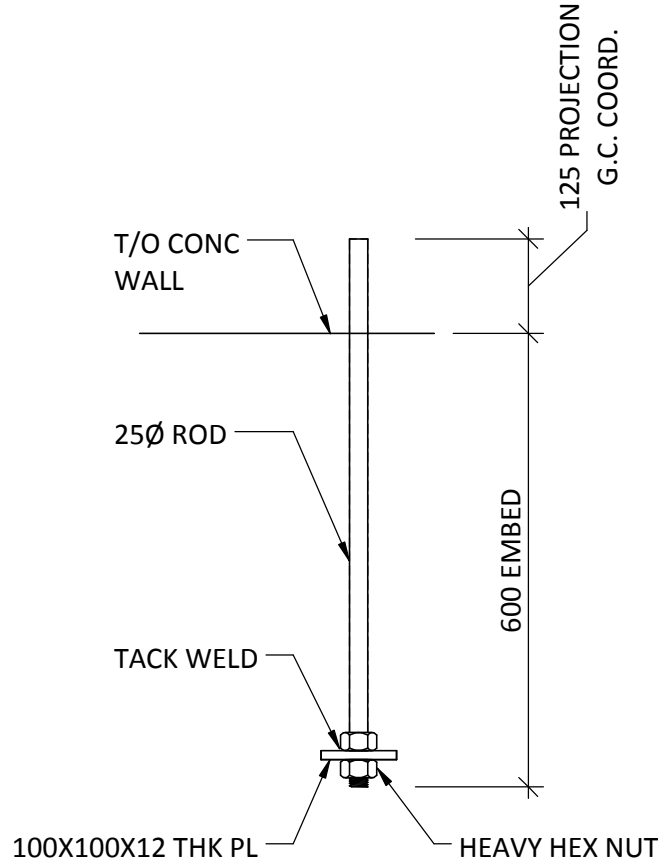


ANCHOR BOLT 1 (AB1)

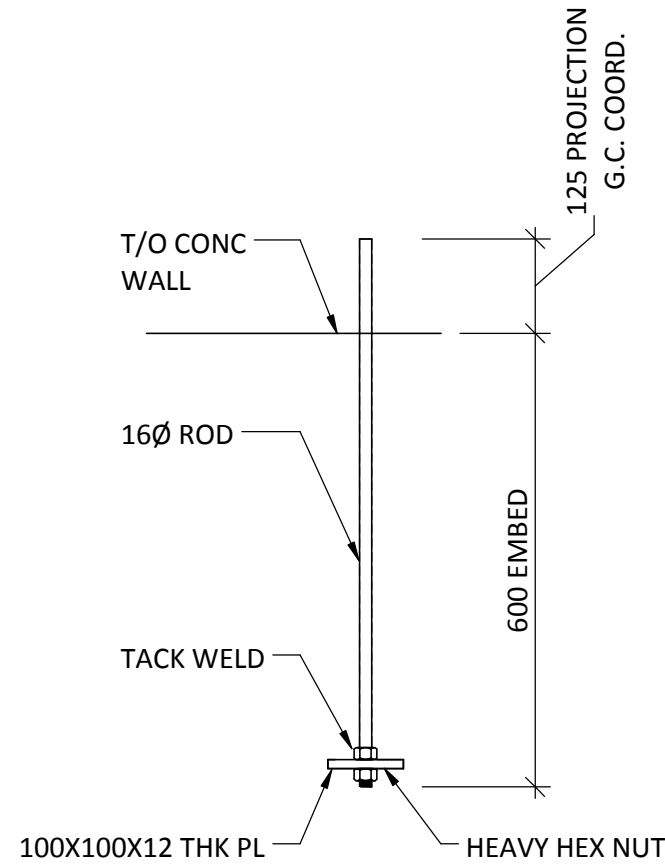

ANCHOR BOLT 2 (AB2)

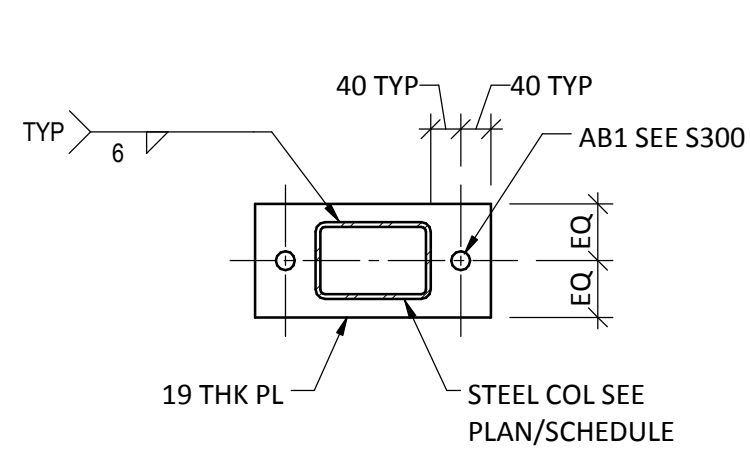

BP1

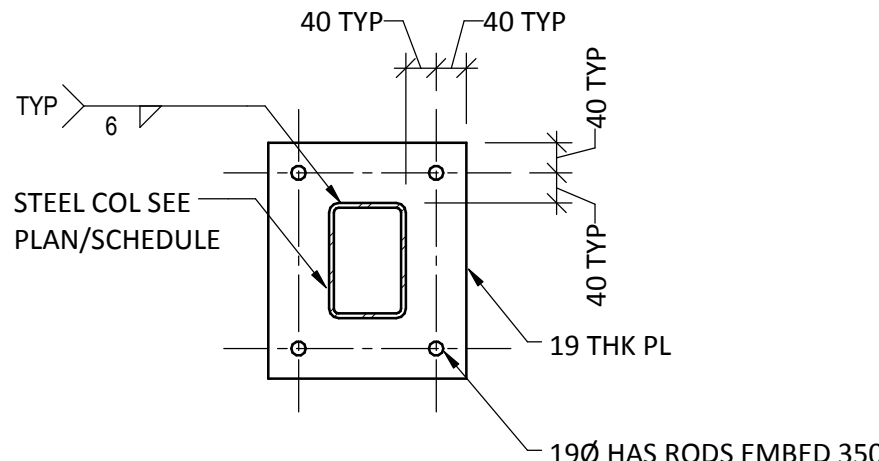

BP2

HOLDOWN SCHEDULE			
HOLDOWN MARK	HOLDOWN	HOLDOWN EMBEDMENT (mm)	COMMENTS
A	MSTC4883	--	EACH END CONNECTING POST TO BEAM BELOW
B	MSTC66	--	EACH END CONNECTING POST TO POST BELOW
D	2-MSTCM60 STRAPS	--	EACH END w/ TITEN SCREWS CONNECTING POST TO COLUMN WALL BELOW
E	2-MSTC4883	--	EACH END CONNECTING POST TO BEAM BELOW
F	3-MSTCM60 STRAPS	--	EACH END w/ TITEN SCREWS CONNECTING POST TO CONCRETE BELOW
G	1-MSTCM60 STRAP	--	EACH END w/ TITEN SCREWS CONNECTING POST TO CONCRETE BELOW
H	1-HDU8-SDS2.5 w/ 19Ø HAS ROD	350 w/ HILTI HY-200 SAFESET	EACH END CONNECTING POST TO FOUNDATION WALL BELOW
J	HDU11-SDS2.5 w/ 25Ø HAS ROD	450 w/ HILTI HY-200 SAFESET	--
K	HDU11-SDS2.5 w/ AB1		POST INSTALLED ANCHOR NOT ACCEPTABLE, ANCHOR MUST BE CAST IN PLACE

WOOD BEAM SCHEDULE		
MARK	SIZE	COMMENTS
WB1	2 PLY - 45X241	2.0E LVL
WB2	2 PLY - 45X302	2.0E LVL
WB3	133X241	2.2E PSL
WB4	3 PLY - 45X302	2.0E LVL
WB5	178X406	2.0E PSL
WB6	133X406	2.0E PSL
WB7	3 PLY - 45X457	2.0E LVL
WB8	178X457	2.0E PSL
WB9	4 PLY - 45X356	2.0E LVL
WB10	2 PLY - 45X406	2.0E LVL
WB11	178X483	2.2E PSL
WB12	178X406	2.2E PSL
WB13	89X235	ROUGH SAWN CEDAR
WB14	365X418	20F-E D. FIR L GLULAM
WB15	3 PLY - 45X406	2.0E LVL
WB16	3 PLY - 45X483	2.0E LVL
WB17	89X406	1.55E LSL
WB18	133X406	SHEARWALL DIAPHRAM CONNECTOR BEAMS
WB19	2 PLY - 45X356	2.0E LVL
WB20	2 PLY - 89X355	No.2 GRADE CEDAR
WB21	2 PLY - 89X355	SELECT STRUCTURAL GRADE CEDAR
WB22	3 PLY - 45X235	2.0E LVL
WB23	1 PLY - 45X235	2.0E LVL

- NOTES:
- BEAM LAMINATIONS AS PER FLOOR SUPPLIERS RECOMMENDATIONS.
 - WB# CONT INDICATES CONTINUOUS BEAM OVER SUPPORT.
 - 'DJ' - MEMBER TO BE DESIGNED BY FLOOR SUPPLIER (DOUBLE JOIST TYP UNO).

LINTEL BEAM SCHEDULE		
MARK	SIZE	COMMENTS
LB1	2 PLY - 38X235	SPF No.2
LB2	3 PLY - 38X235	SPF No.2
LB3	2 PLY - 45X184	2.0E LVL
LB4	3 PLY - 45X241	2.0E LVL
LB5	3 PLY - 38X286	SPF No.2

RAFTER BEAM SCHEDULE			
MARK	SIZE	SPACING	COMMENTS
RB1	38X235	610 o/c MAX	SPF No.2
RB2	38X235		SPF No.2
RB3	2 PLY - 38X235	610 o/c MAX	SPF No.2
RB4	89X241		2.2E PSL

NOTE: RAFTER SIZE AND SPACING TO BE CONFIRMED BY ROOF SUPPLIER. SHOP DRAWING SUBMITALS SHALL INCLUDE RAFTERS.

FLOOR JOIST SCHEDULE			
MARK	SIZE	SPACING	COMMENTS
J1	38X235	400 o/c	SPF No.2
J2	38X184	400 o/c	SPF No.2
J3	406 DP FLOOR JOIST	488 o/c MAX	PRE-ENGINEERED

NOTE: SIZE AND SPACING TO BE CONFIRMED BY FLOOR SUPPLIER


WOOD COLUMN SCHEUDLE				
MARK	SIZE	JACK STUDS	KING STUDS	COMMENTS
WC1	38X89	1	1	SPF No.2
WC2	38X89	--	2	SPF No.2
WC3	38X140	1	1	SPF No.2
WC4	38X140	2	--	SPF No.2
WC5	38X140	--	2	SPF No.2
WC6	38X89	3	--	SPF No.2
WC7	38X89	--	3	SPF No.2
WC8	38X140	1	2	SPF No.2
WC9	38X140	1	3	SPF No.2
WC10	38X140	2	1	SPF No.2
WC11	38X140	3	--	SPF No.2
WC12	38X140	3	--	SPF No.2
WC13	38X140	--	3	SPF No.2
WC14	38X89	4	--	SPF No.2
WC15	38X89	--	4	SPF No.2
WC16	38X140	2	2	SPF No.2
WC17	38X140	3	1	SPF No.2
WC18	38X140	4	--	SPF No.2
WC19	38X140	--	4	SPF No.2
WC20	38X89	--	5	SPF No.2
WC21	38X140	1	4	SPF No.2
WC22	38X140	3	2	SPF No.2
WC23	38X140	5	--	SPF No.2
WC24	38X140	3	6	SPF No.2
WC25	38X140	--	5	SPF No.2
WC26	38X140	5	--	SPF No.2
WC27	38X140	--	1	SPF No.2
WC28	38X140	--	6	SPF No.2
WC29	38X140	1	6	SPF No.2
WC30	38X140	3	4	SPF No.2
WC31	38X140	9	--	SPF No.2
WC32	178X178	--	1	No.1 GRADE CEDAR
WP1	89X133	1	--	1.8E PSL
WP2	133X133	1	--	1.8E PSL
WP3	89X178	1	--	1.8E PSL
WP4	133X178	1	--	1.8E PSL
WP5	178X178	1	--	1.8E PSL

- NOTES:
- BEAMS TO BEAR DIRECTLY ON STRUCTURAL COMPOSITE LUMBER COLUMNS (JACK STUDS) TYPICAL. STRUCTURAL COMPOSITE LUMBER COLUMNS TO BEAR DIRECTLY ON BEAM/CONCRETE BELOW. WOOD PLATES NOT PERMITTED BELOW STRUCTURAL COMPOSITE LUMBER COLUMNS TYP.
 - BEAM TO BEAR FULLY ON CRIPPLE STUDS INDICATED (IE: BEAMS WITH 4 JACK STUDS INDICATED THEREFORE REQUIRE 150mm BEARING). WOOD PLATES ARE NOT PERMITTED BETWEEN U/S OF BEAM AND TOP OF JACK STUDS TYP.

STEEL COLUMN SCHEDULE		
MARK	SIZE	COMMENTS
SC1	HSS 152X102X4.8	w/ 300LGX20 THK CAP PL REFER TODetail 7/5440 FOR WIDTH
SC2	HSS 152X102X6.4	SEE SECTION 1/5421


LOAD BEARING WALL SCHEDULE (UNO) (STUD SIZE & SPACING)			
WALL TYPE	BASEMENT TO MAIN	MAIN TO LOFT	LOFT TO ROOF
EXTERIOR WALLS	--	38x140 @ 400 c/c (DOUBLE 38X140 TOP & BOT PLATES)	38x140 @ 400 c/c (DOUBLE 38X140 TOP & BOT PLATES)
INTERIOR WALLS	38x140 @ 400 c/c (DOUBLE 38X140 TOP & BOT PLATES)	38x140 @ 400 c/c (DOUBLE 38X140 TOP & BOT PLATES)	--
DEMISING WALLS (B/W SUITES)	--	38x89 @ 400 c/c (DOUBLE 38X89 TOP & BOT PLATES)	38x89 @ 400 c/c (DOUBLE 38X89 TOP & BOT PLATES)
CORRIDOR/ STAIRWELL	2 38x89 @ 300 c/c STAGGERED (DOUBLE 38X140 TOP & BOT PLATE)	38x89 @ 200 c/c STAGGERED (DOUBLE 38X140 TOP & BOT PLATES)	38x89 @ 300 c/c STAGGERED (DOUBLE 38X140 TOP & BOT PLATES)

- NOTE:
- ALL WALLS TO BE SPF No.2 OR BETTER.
 - BACK TO BACK DEMISING WALLS TO HAVE STUDS STAGGERED TYP.
 - STUD WALLS HAVE BEEN SIZED FOR 82% CAPACITY BASED ON ARCHITECTURAL WALL ASSEMBLY RESTRICTIONS.

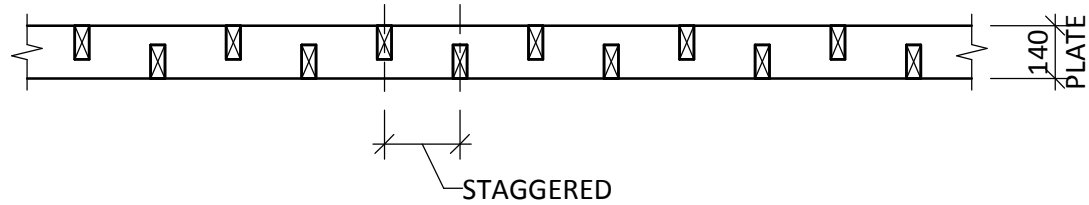


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4	2016-12-08	ISSUED FOR BUILDING PERMIT	AD	IW					
3	2016-09-02	ISSUED FOR 99%	AD	IW					
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No.	Date/Date	Description/Description	Drawn by/Dessiné par	Approved/Approuvé					
Revision / Revision									
		A detail number numero de detail							
		B source drawing no. de dessin no.							
		C detail on drawing no. detail sur dessin no.							
Consultant's Name Nom de l'expert-conseil			Eng. Stamp Sceau de l'ingénieur						
ENTUITIVE									
209 - 8th Avenue SW, Suite 300 Calgary, AB T2P 1B5 403-878-1270			Professional Engineer Ingénieur Professionnel - 198 0779						
		Public Works and Government Services Canada	Travaux publics et Services gouvernementaux Canada						
		Client Services Team Southern Alberta Operations Branch	Le Client Entretien l'Équipe Alberta Méridional Branche d'Opérations						
Canada									
Client/client		Parks Canada Agence	L'Agence Parcs Canada						
		Western and Northern Region	Ouest et Nord du Canada						
Project title/Titre du projet									
Staff Housing Phase 2 Waterton Lakes National Park									
Drawing title/Titre du dessin									
SCHEDULES									
Surveyed by/Arpenté par	Drawn by/Dessiné par	Date/Date							
	AD	12/02/16							
Designed by/Concept par	Reviewed by/Revisé par	Scale/Echelle							
KL	IW	As indicated							
PWGSC Project Manager/Administrateur de Projets TPSGC									
Randy Boldt									
Client Acceptance/Acceptation du client		Approved by/Approuvé par							
Project No./No. du projet		Asset No./No. du bien	Sheet No./ No. de la feuille						
C015-0870		File # 945							
Drawing Reference No./No. de référence du dessin		S300							


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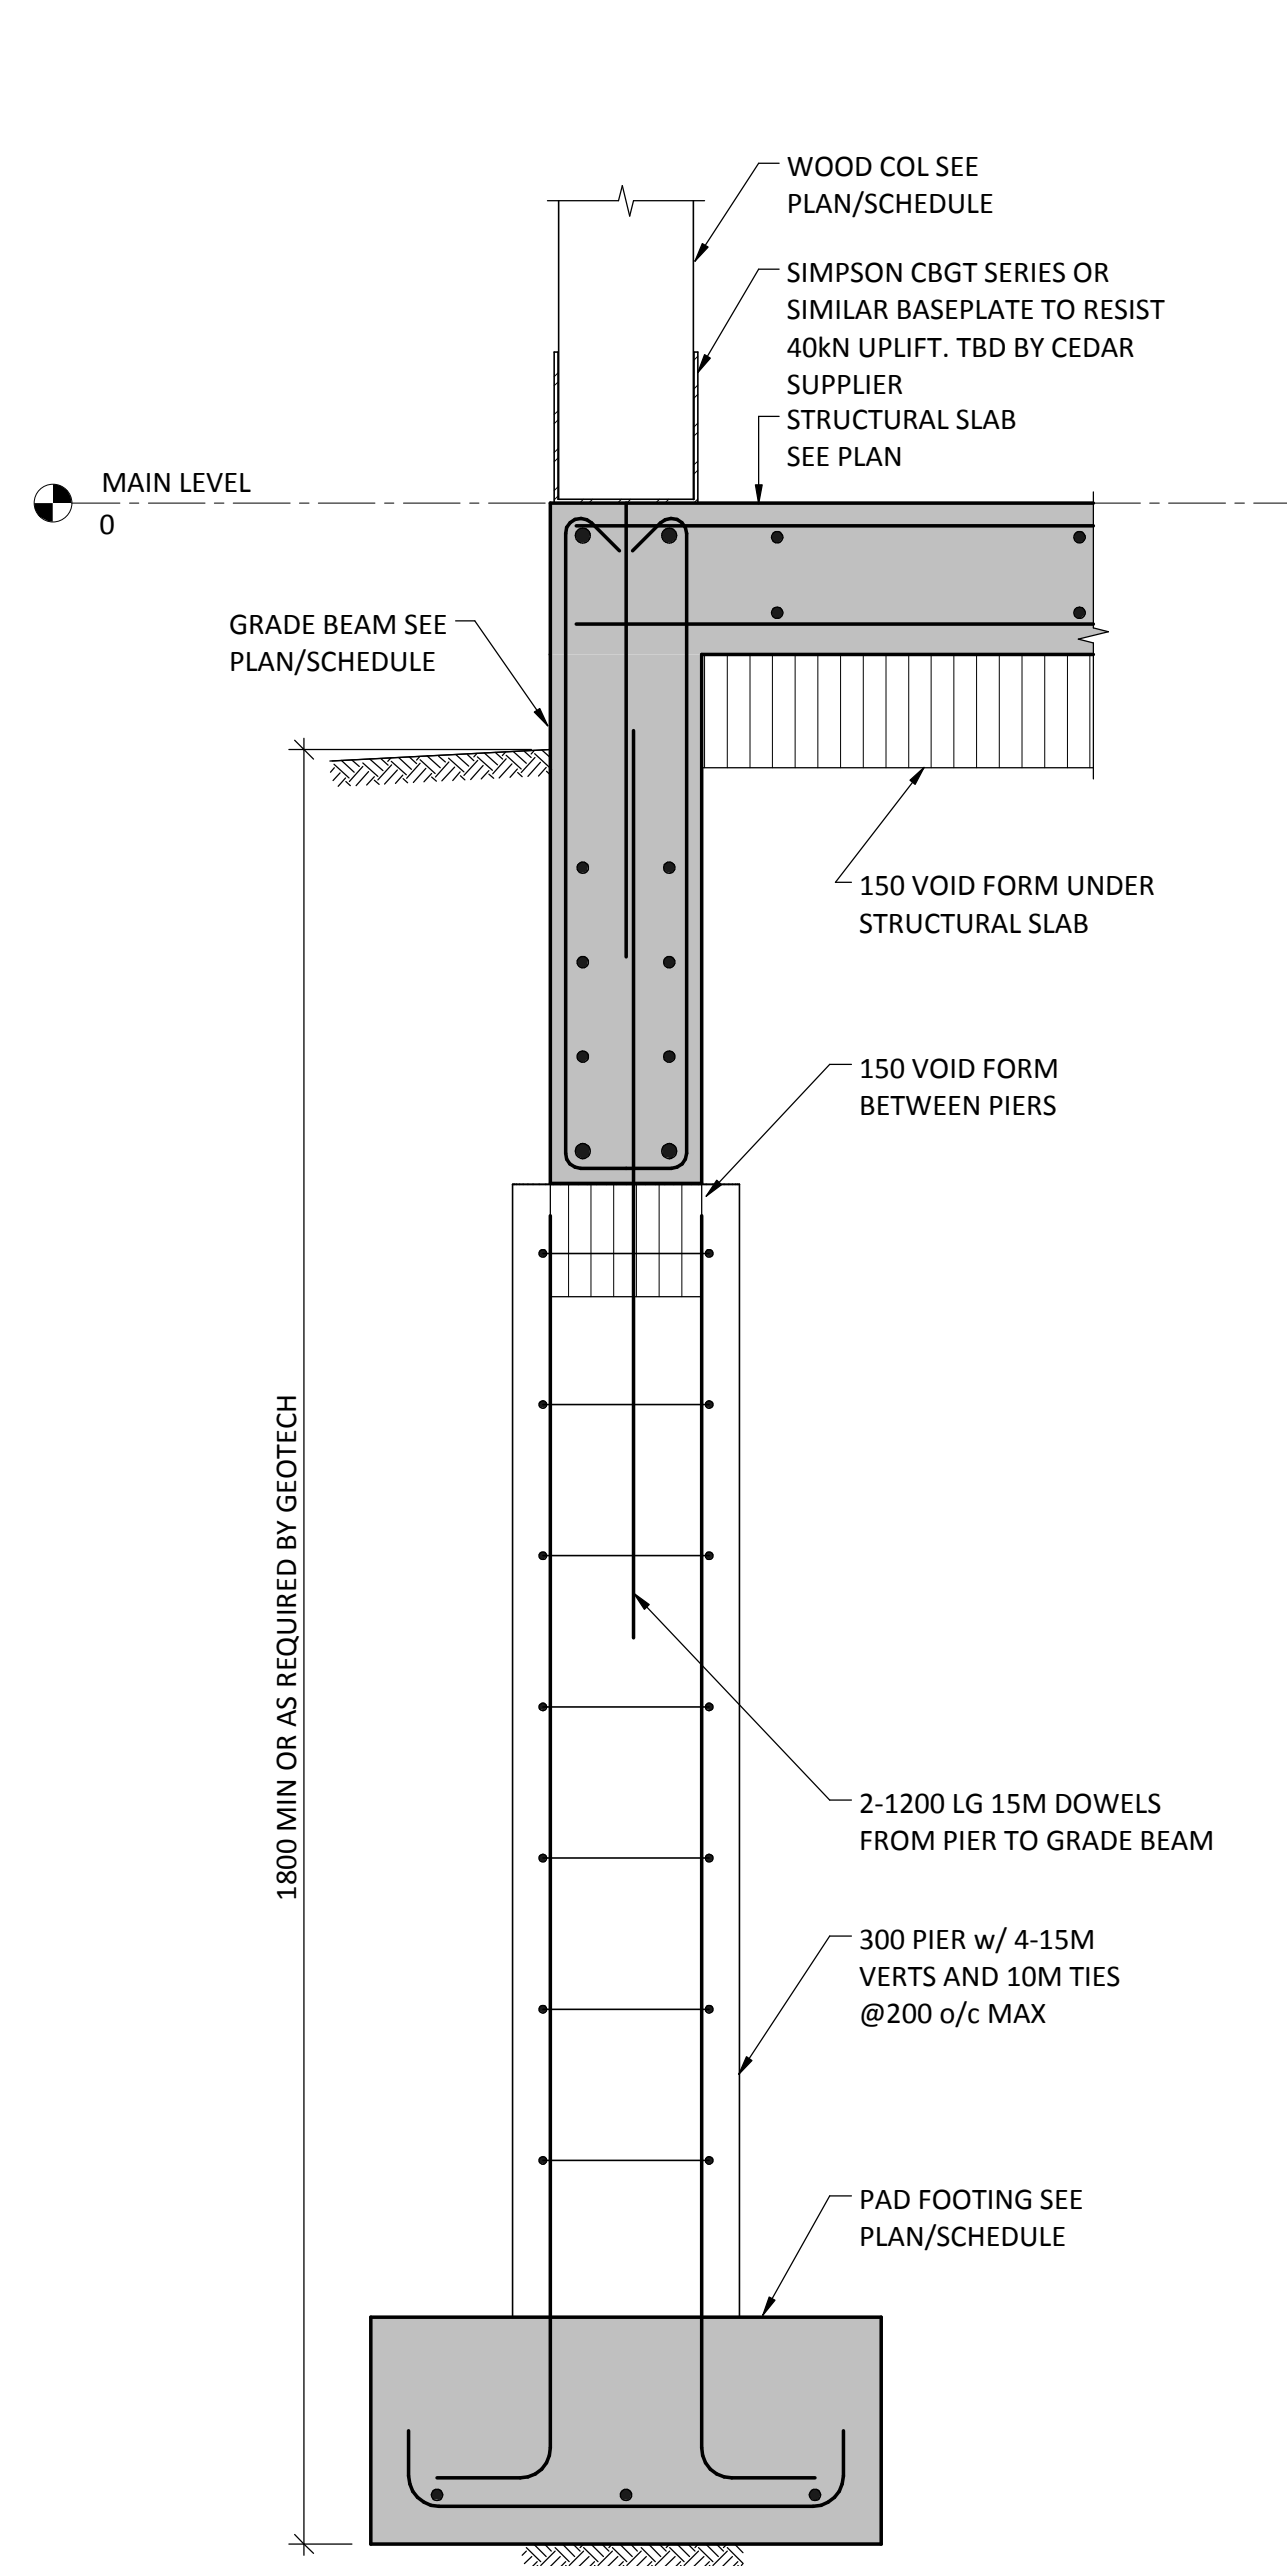
1
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TYPICAL FOUNDATION WALL
JOIST PERPENDICULAR

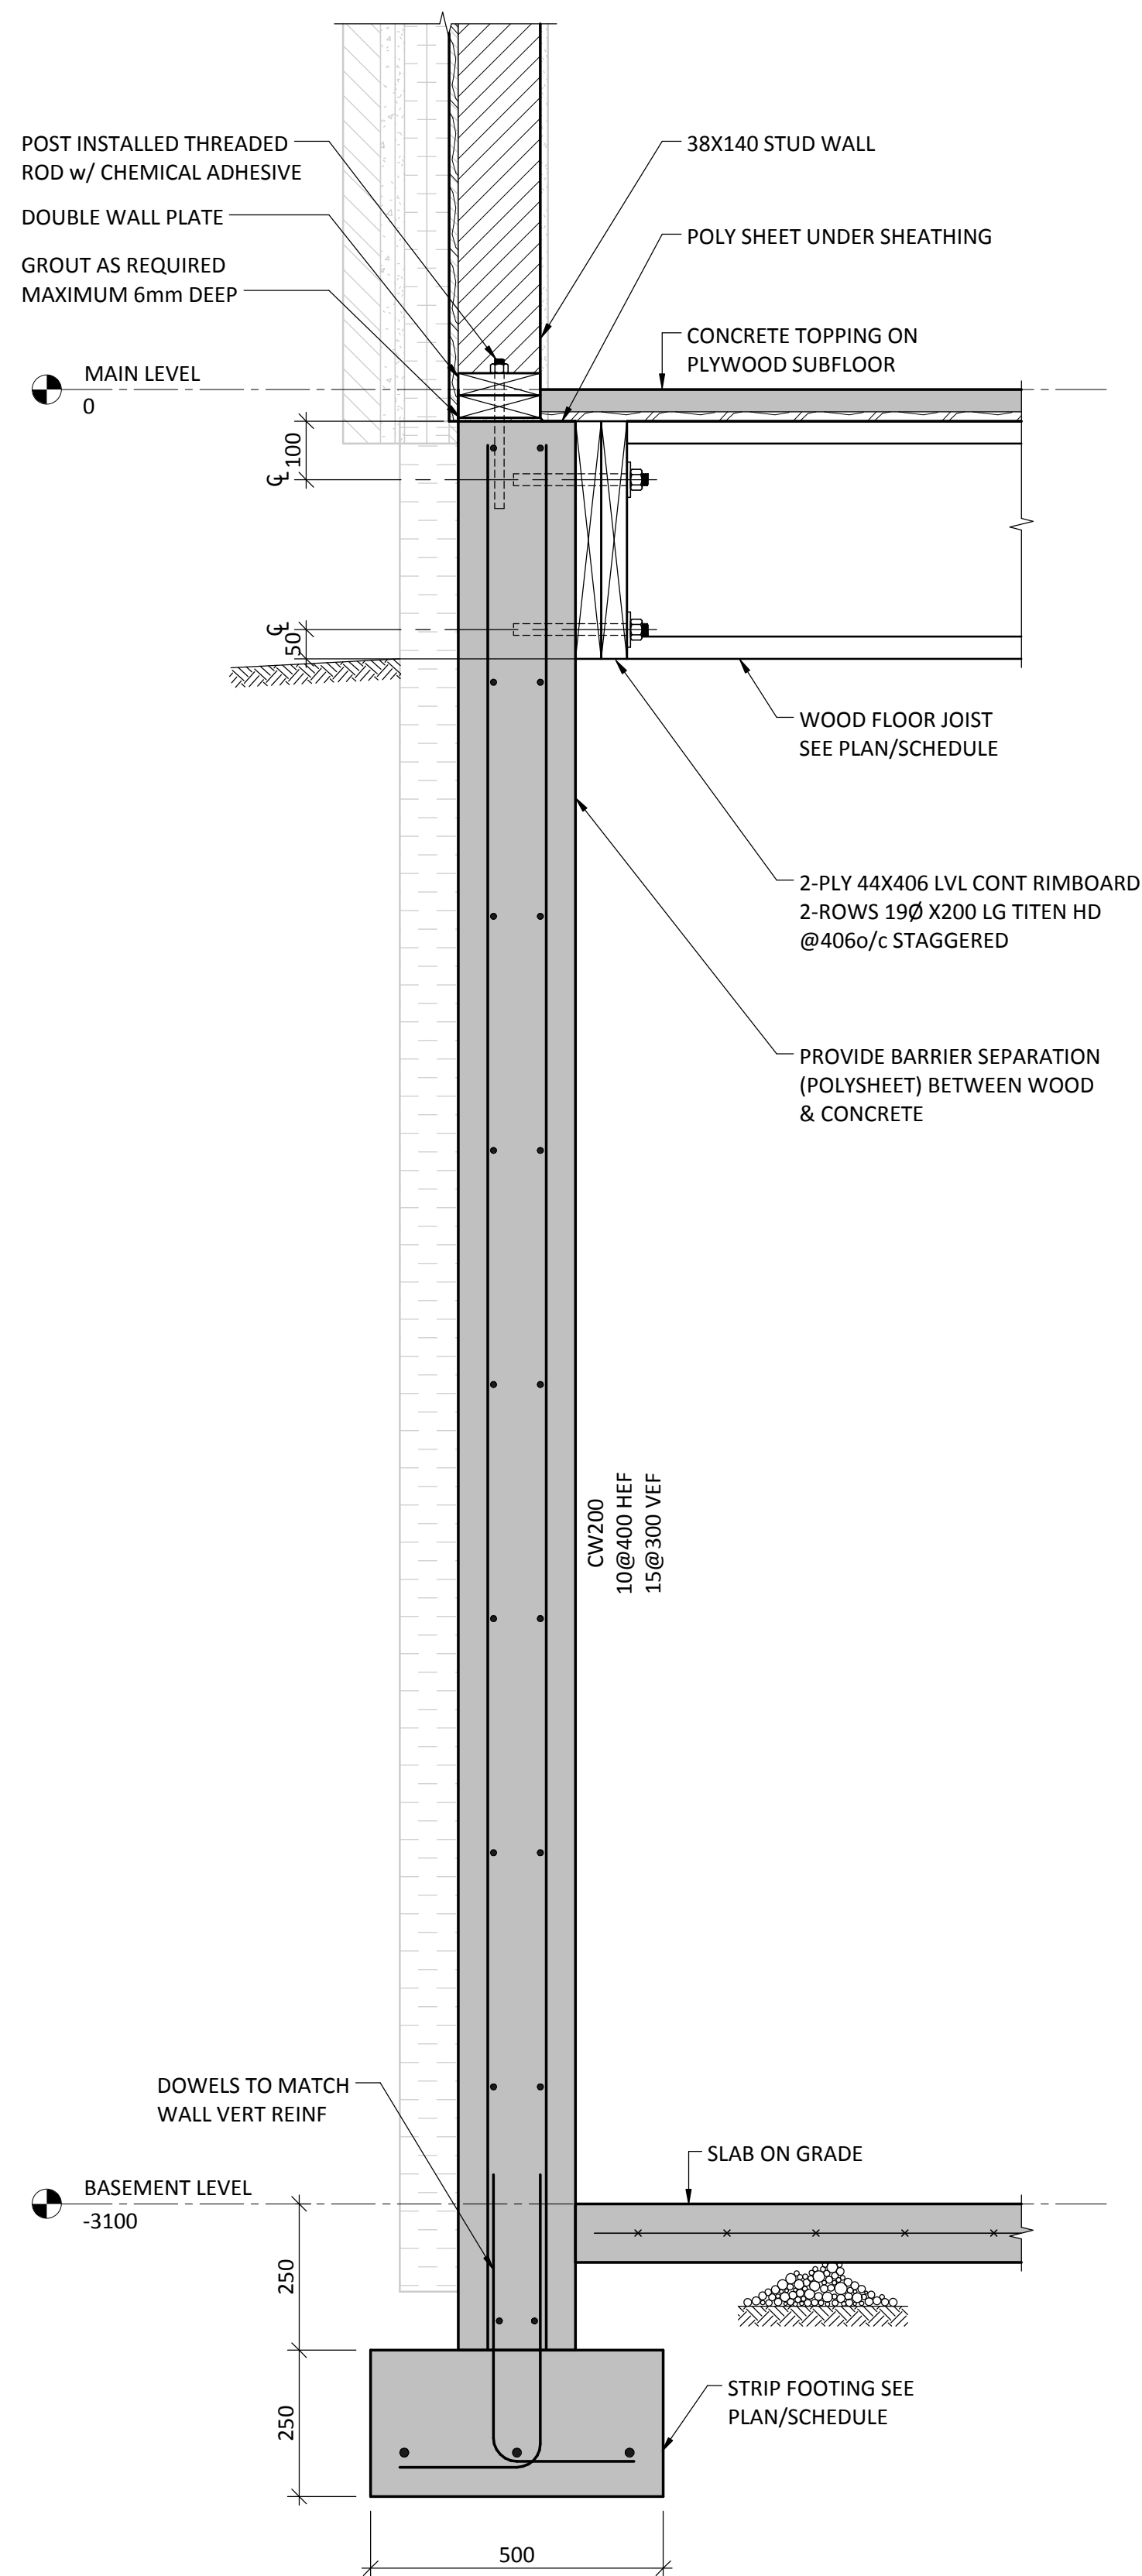


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TYPICAL FOUNDATION WALL
JOISTS PARALLEL

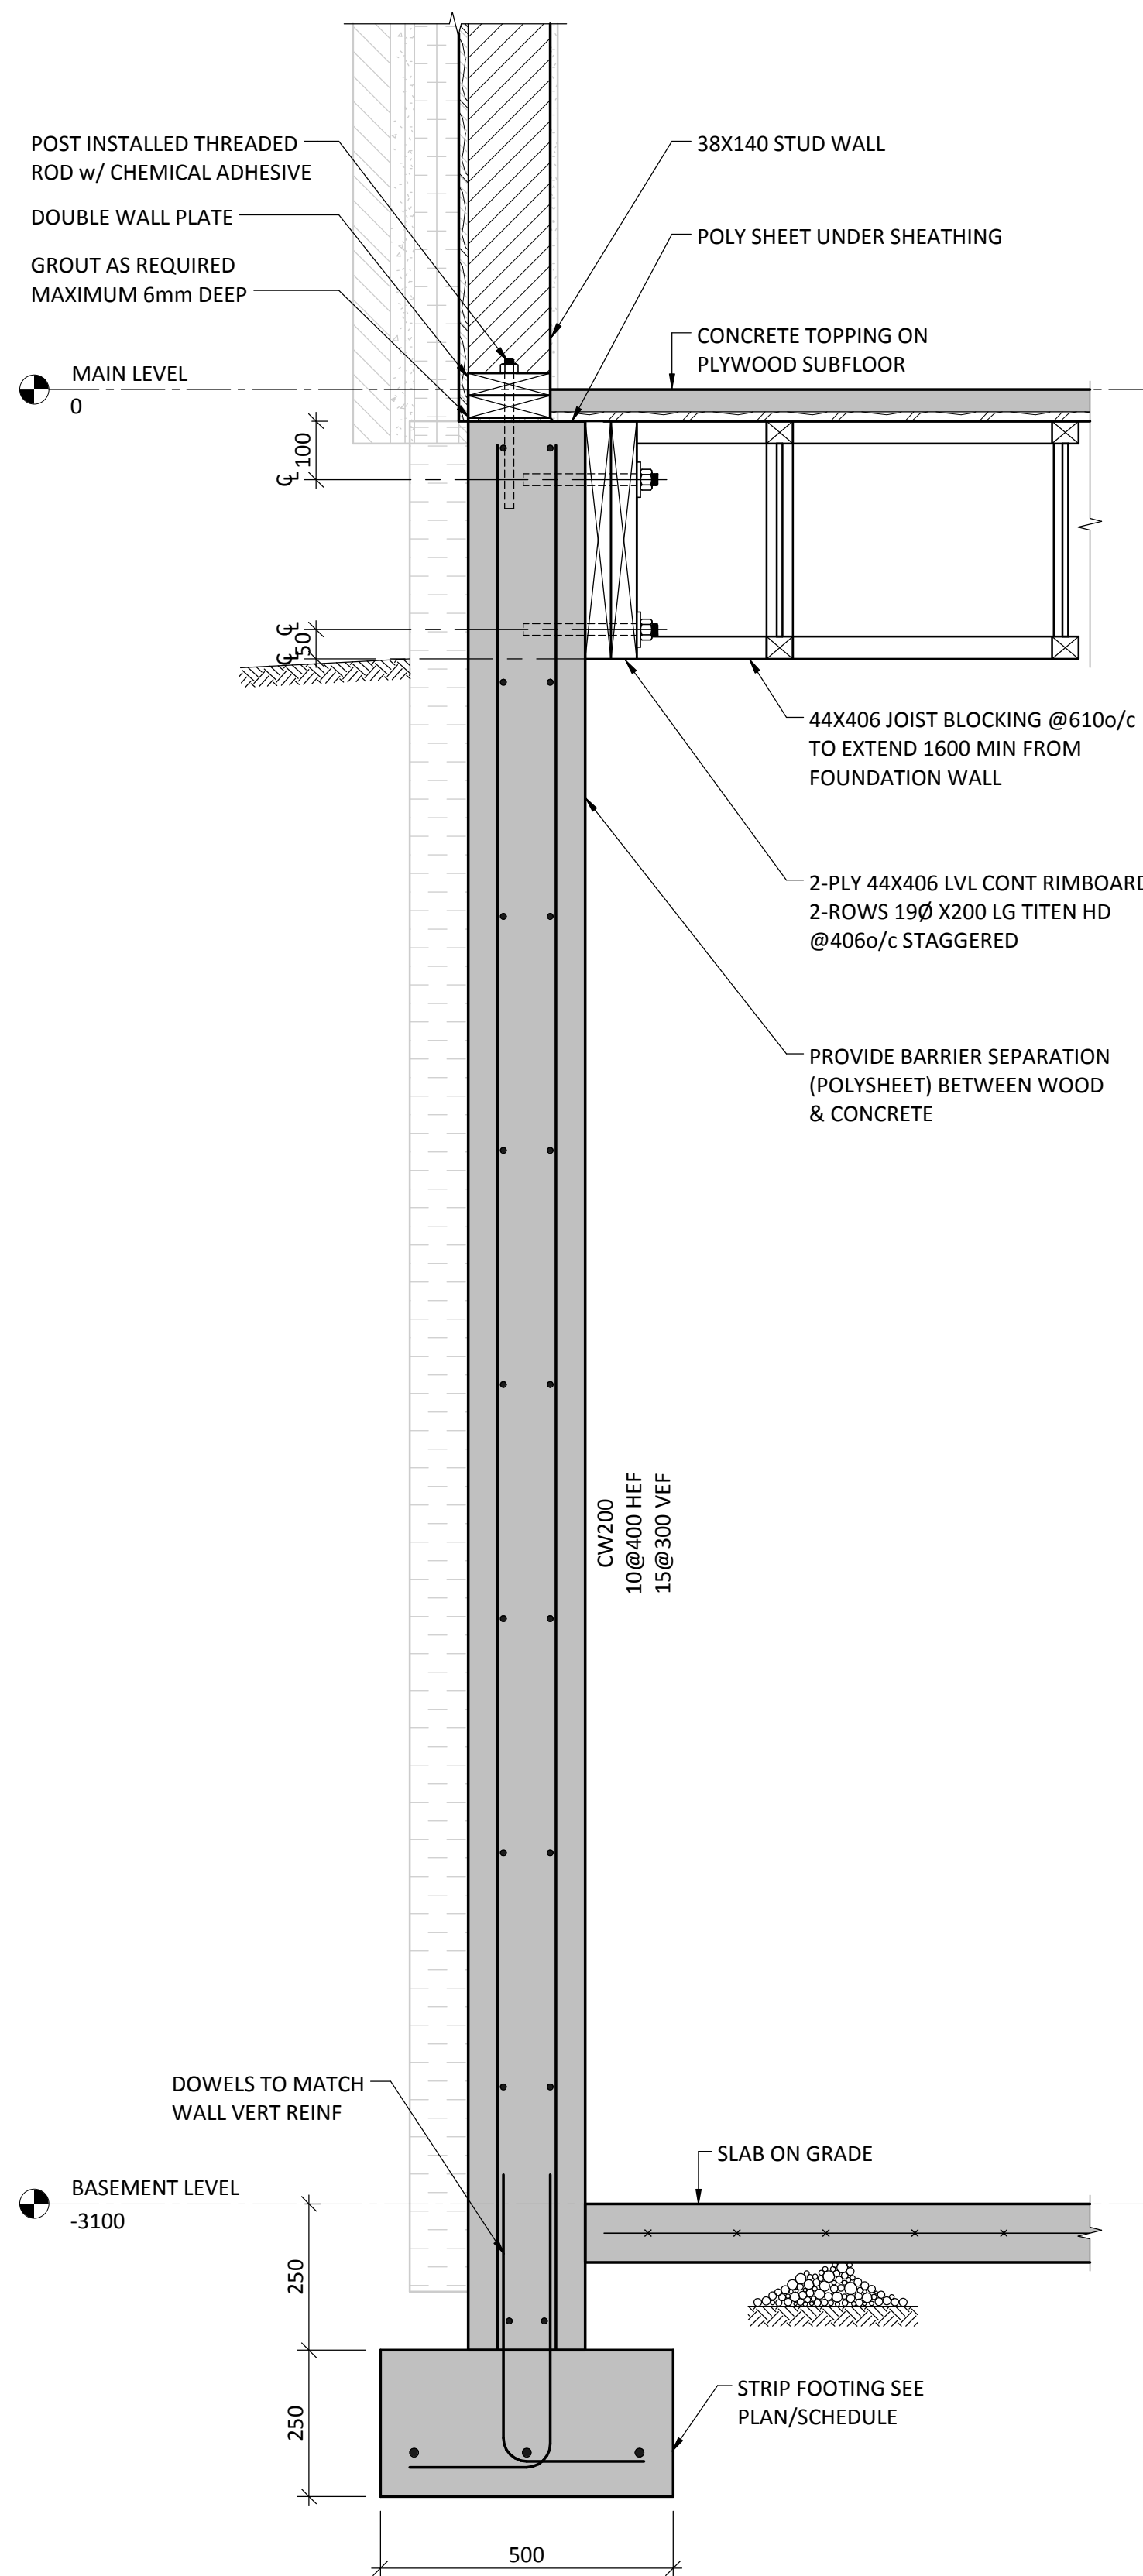


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1:10
TYPICAL INTERIOR BEARING WALL SECTION

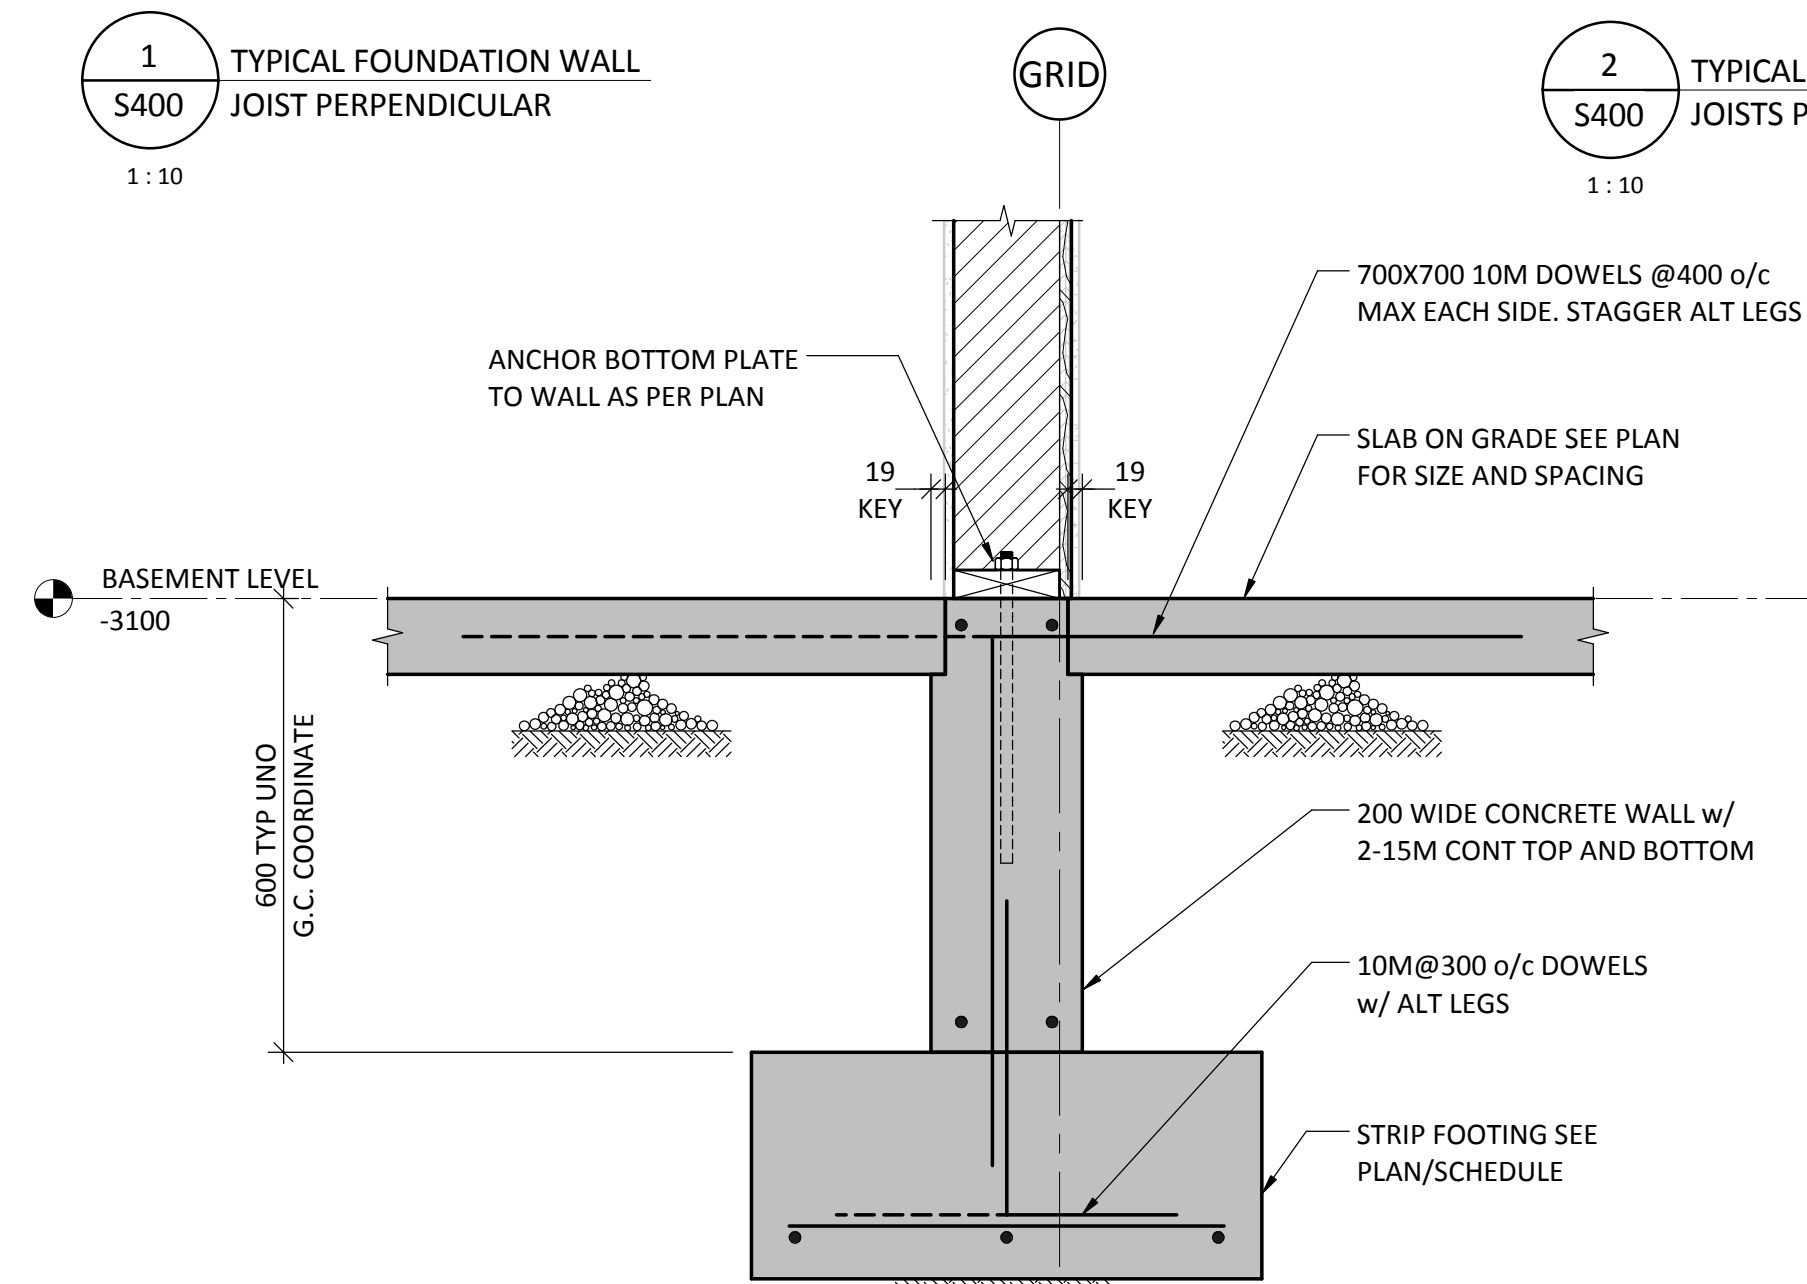


3
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GRADE BEAM DETAILS AT PIER SUPPORTS

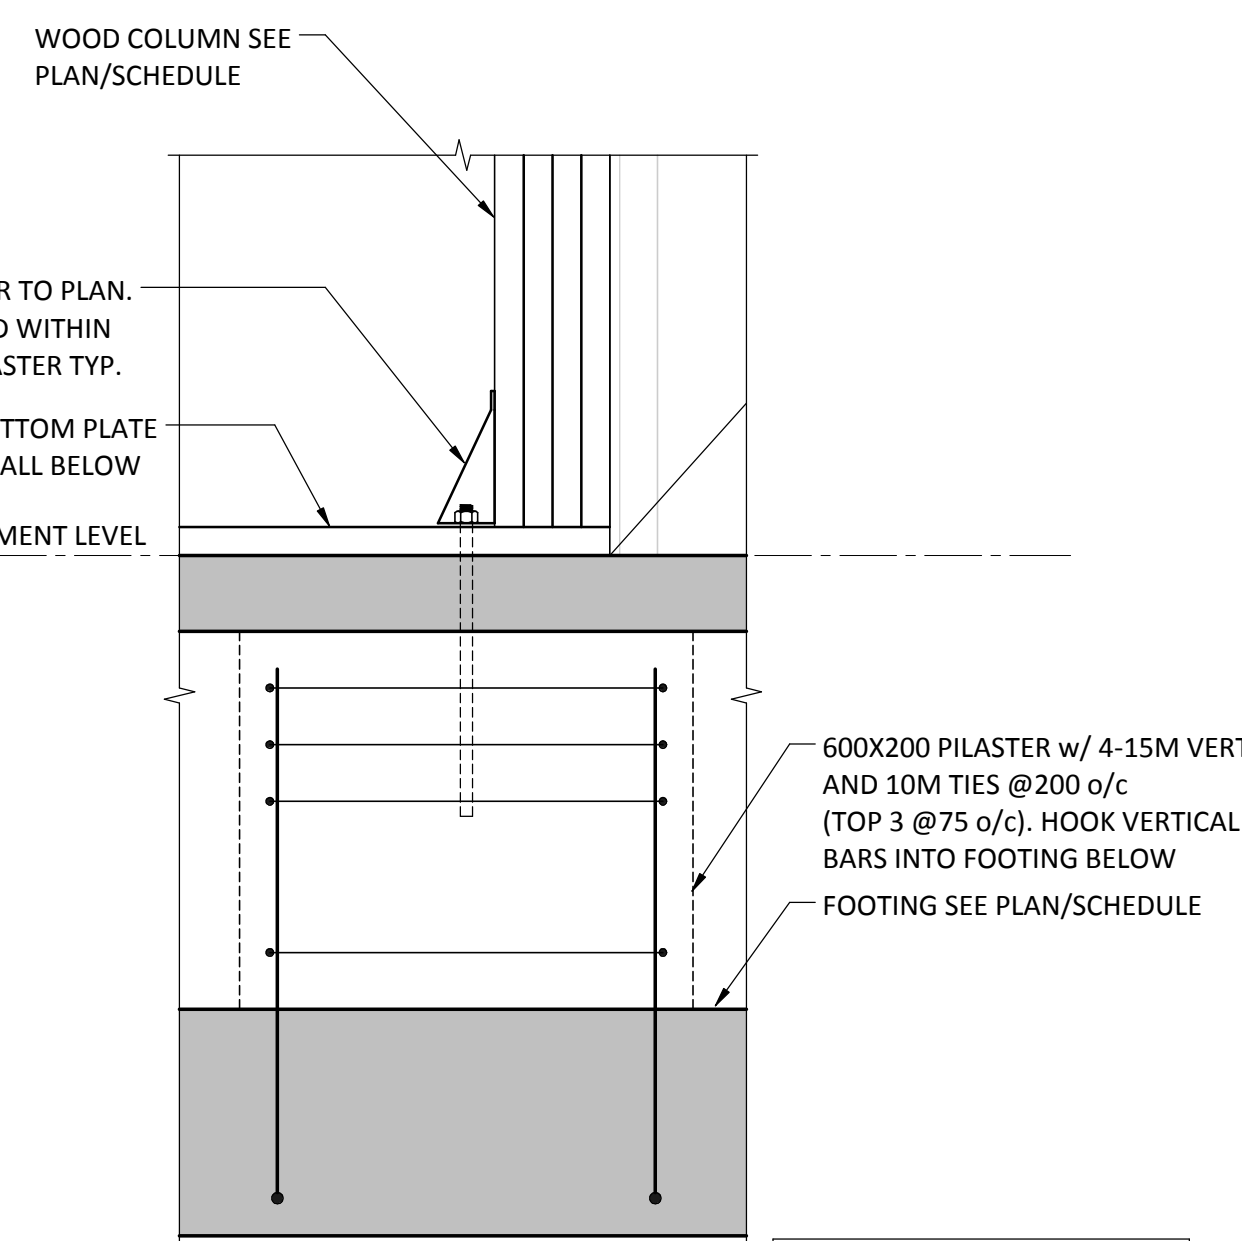


5
S400
1:10
TYPICAL INTERIOR HOLDOWN DETAIL

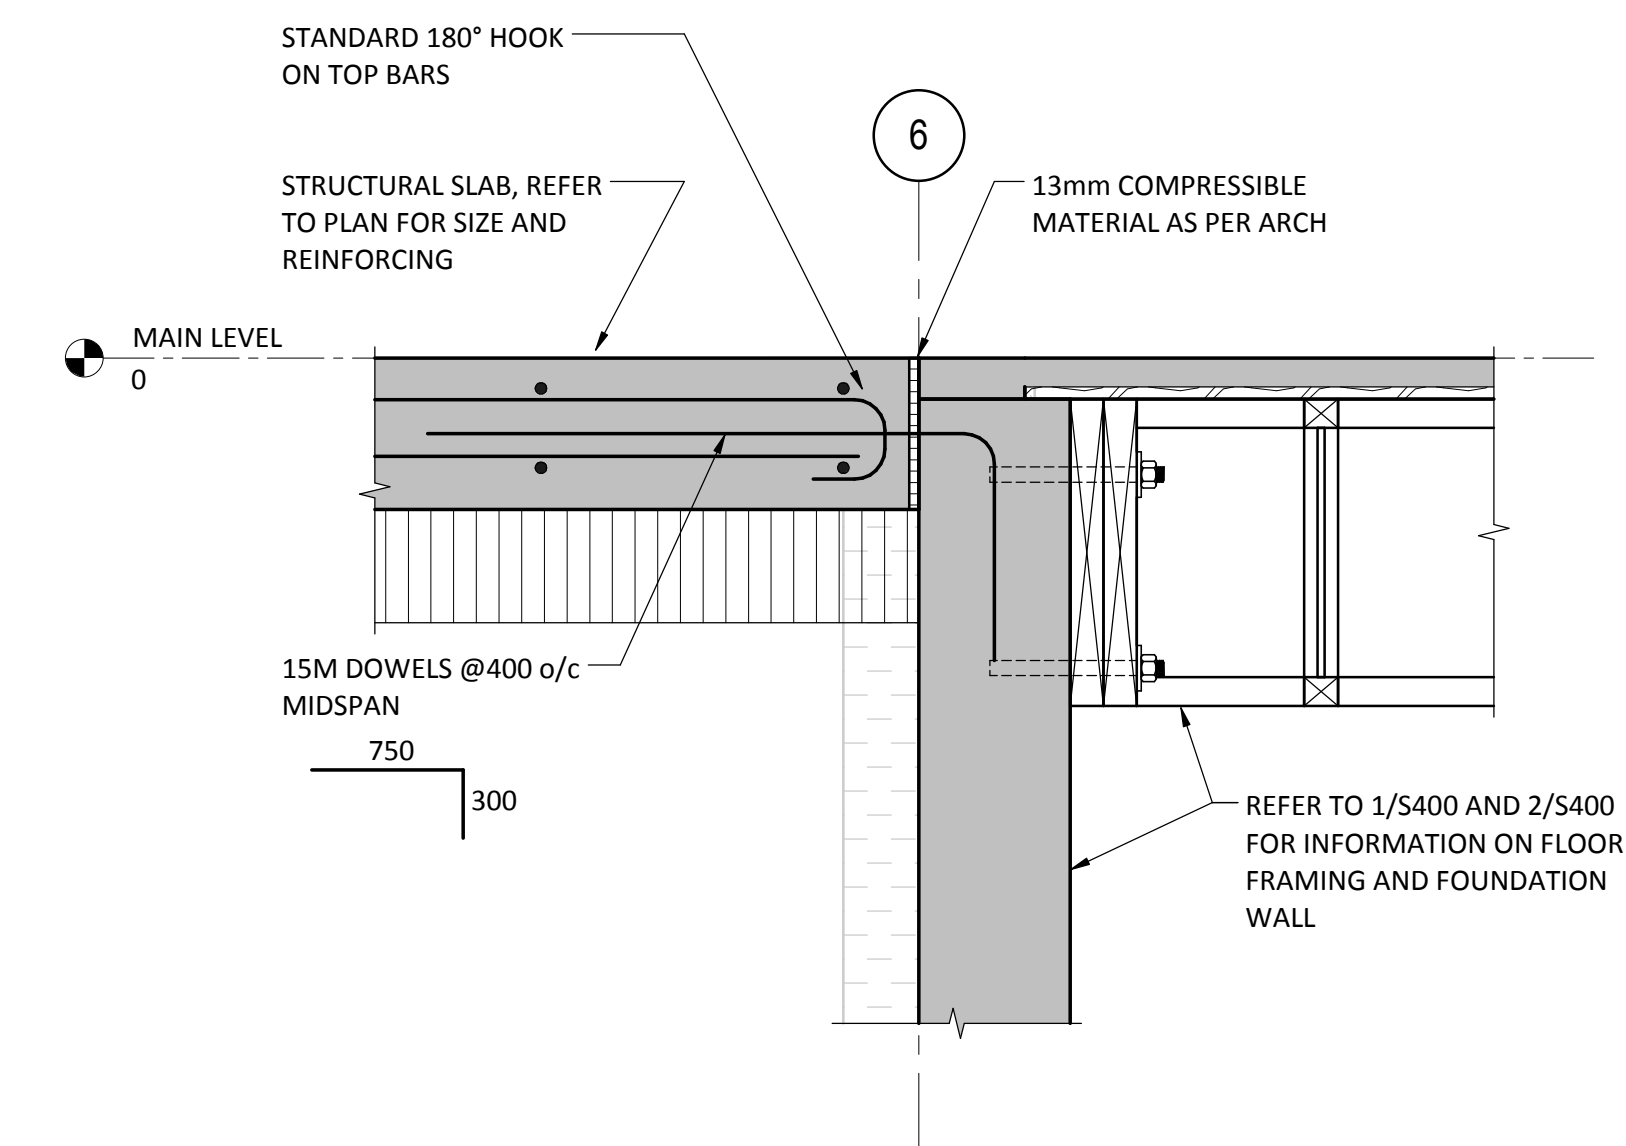

6
S400
1:10
DETAIL AT STRUCTURAL SLAB/BUILDING INTERFACE

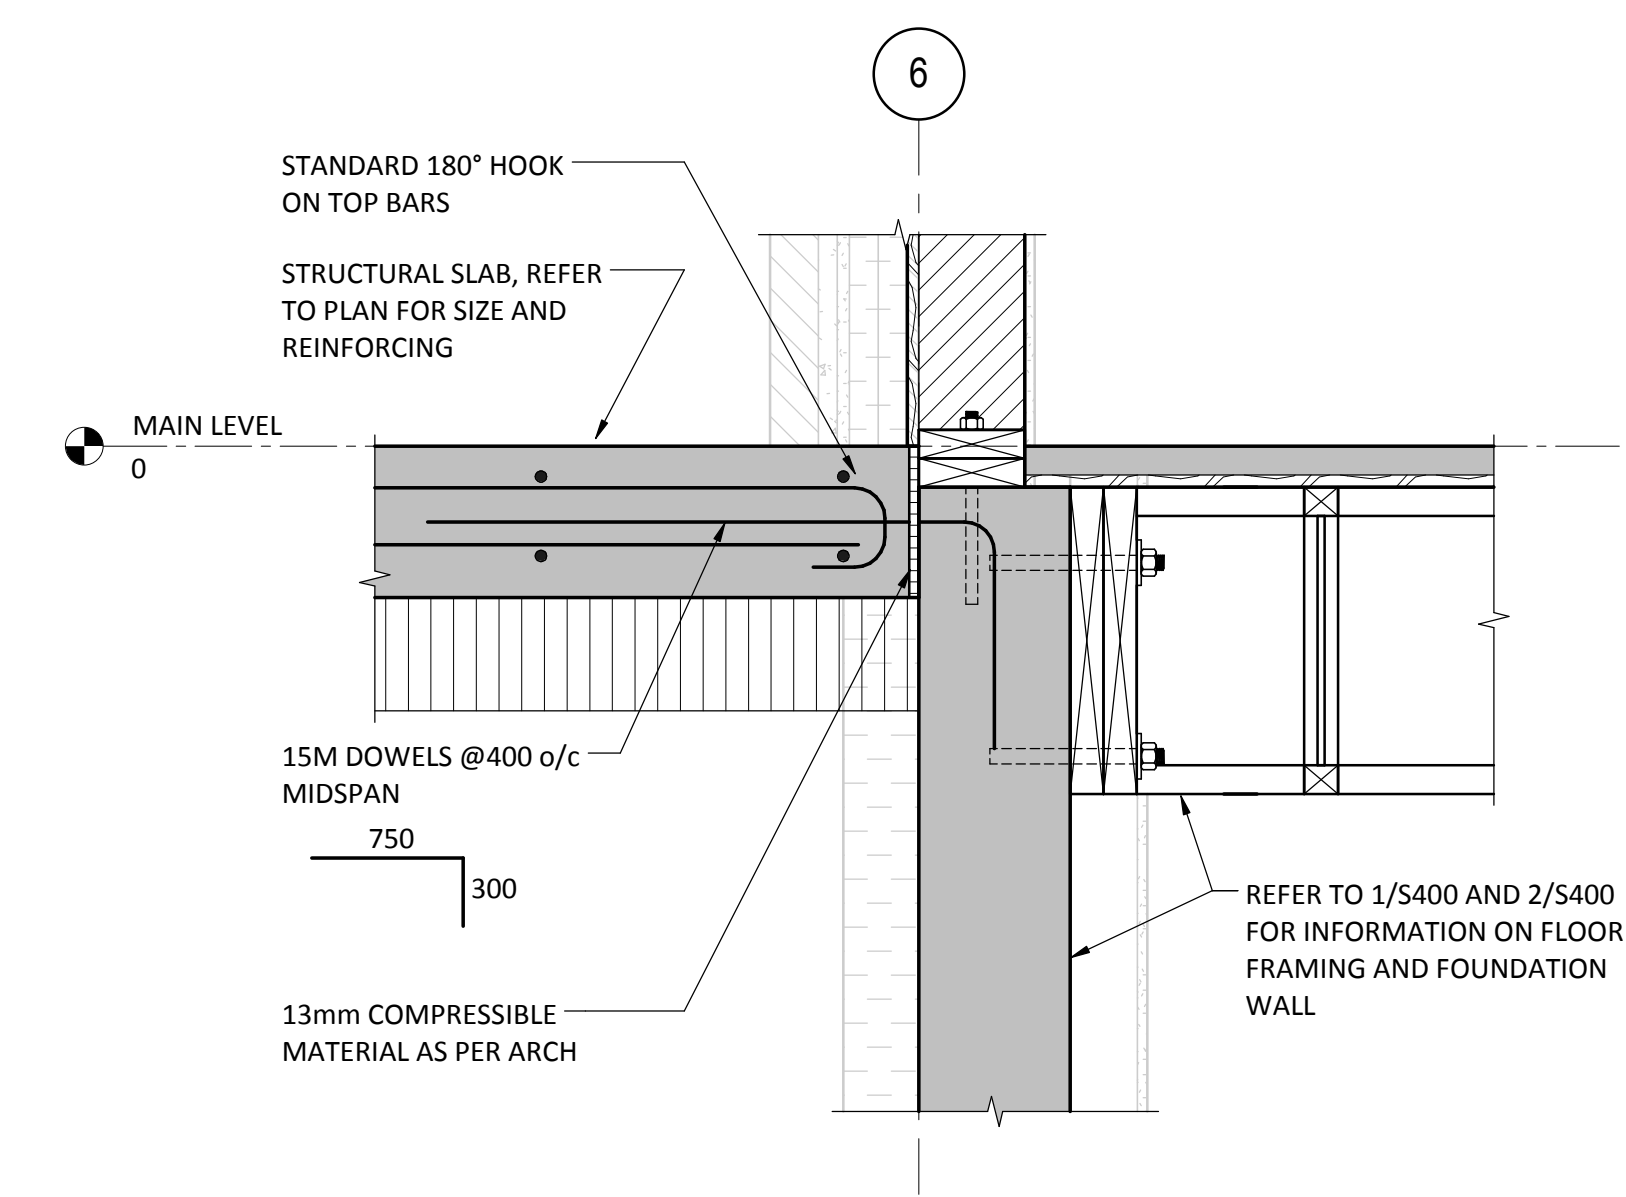

7
S400
1:10
DETAIL AT STRUCTURAL SLAB/BUILDING INTERFACE

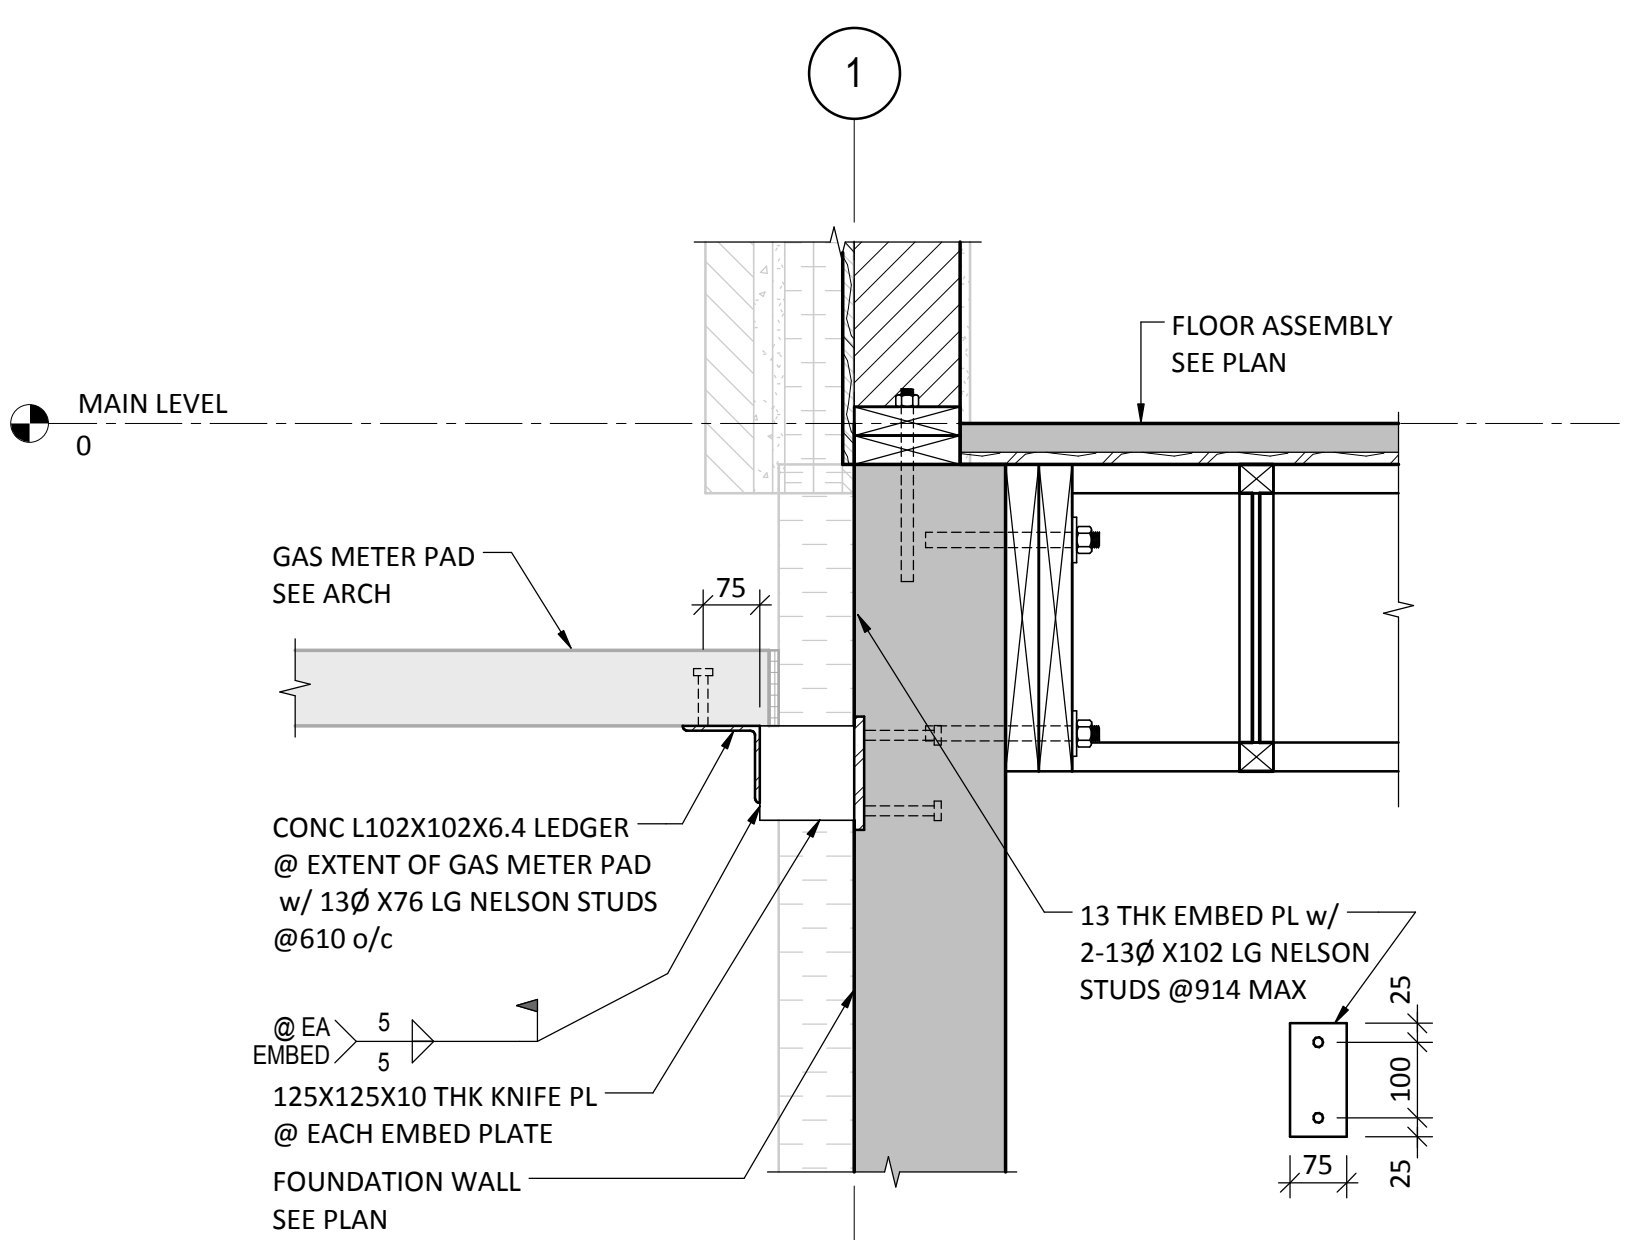

8
S400
1:10
EXTERIOR SLAB SUPPORT
@ GAS METER PAD

NOTE: EMBED PLATE AND LEDGER ANGLE ASSEMBLIES TO BE GALVANIZED. CORROSION PROTECTION TO BE RESTORED AFTER FIELD WELDING w/ ZINGA PAINT OR EQUIVALENT

No.	Date/Date	Description/Description	Drawn by Dessiné par	Approved Approuvé
5	2016-12-08	ISSUED FOR TENDER	AD	IW
4	2016-12-08	ISSUED FOR BUILDING PERMIT	AD	IW
3	2016-09-02	ISSUED FOR 99%	AD	IW

Revision / Revision	
A	detail number numéro de détail
B	source drawing no. de dessin no.
C	detail on drawing no. détail sur dessin no.

Consultant's Name
Nom de l'expert-conseil

ENTUITIVE

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Calgary, AB T2P 1B5
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Eng. Stamp
Sceau de l'ingénieur

PROFESSIONAL ENGINEER
INGÉNIEUR PROFESSIONNEL

Public Works and Government Services Canada
Travaux publics et Services gouvernementaux Canada

Client Services Team Southern Alberta Operations Branch
Le Client Entretien l'Équipe Alberta Méridionale Branche d'Opérations

Canada

Client/client
Parks Canada Agency
L'Agence Parcs Canada

Western and Northern Region
Ouest et Nord du Canada

Project title/Titre du projet


**Staff Housing Phase 2
Waterton Lakes National Park**

Drawing title/Titre du dessin

SECTIONS & DETAILS


Surveyed by/Arpenté par KL	Drawn by/Dessiné par AD	Date/Date 12/02/16
Designed by/Concept par	Reviewed by/Revisé par IW	Scale/Echelle 1:10
PWGSC Project Manager/Administrateur de Projets TPSGC Randy Boldt		
Client Acceptance/Acceptation du client Approved by/Approuvé par		
Task Responsible/Responsable de la tâche		
Project No./No. du projet C015-0870	Asset No./No. du bien Fil # 945	Sheet No./No. de la feuille S400
Drawing Reference No./No. de référence du dessin		

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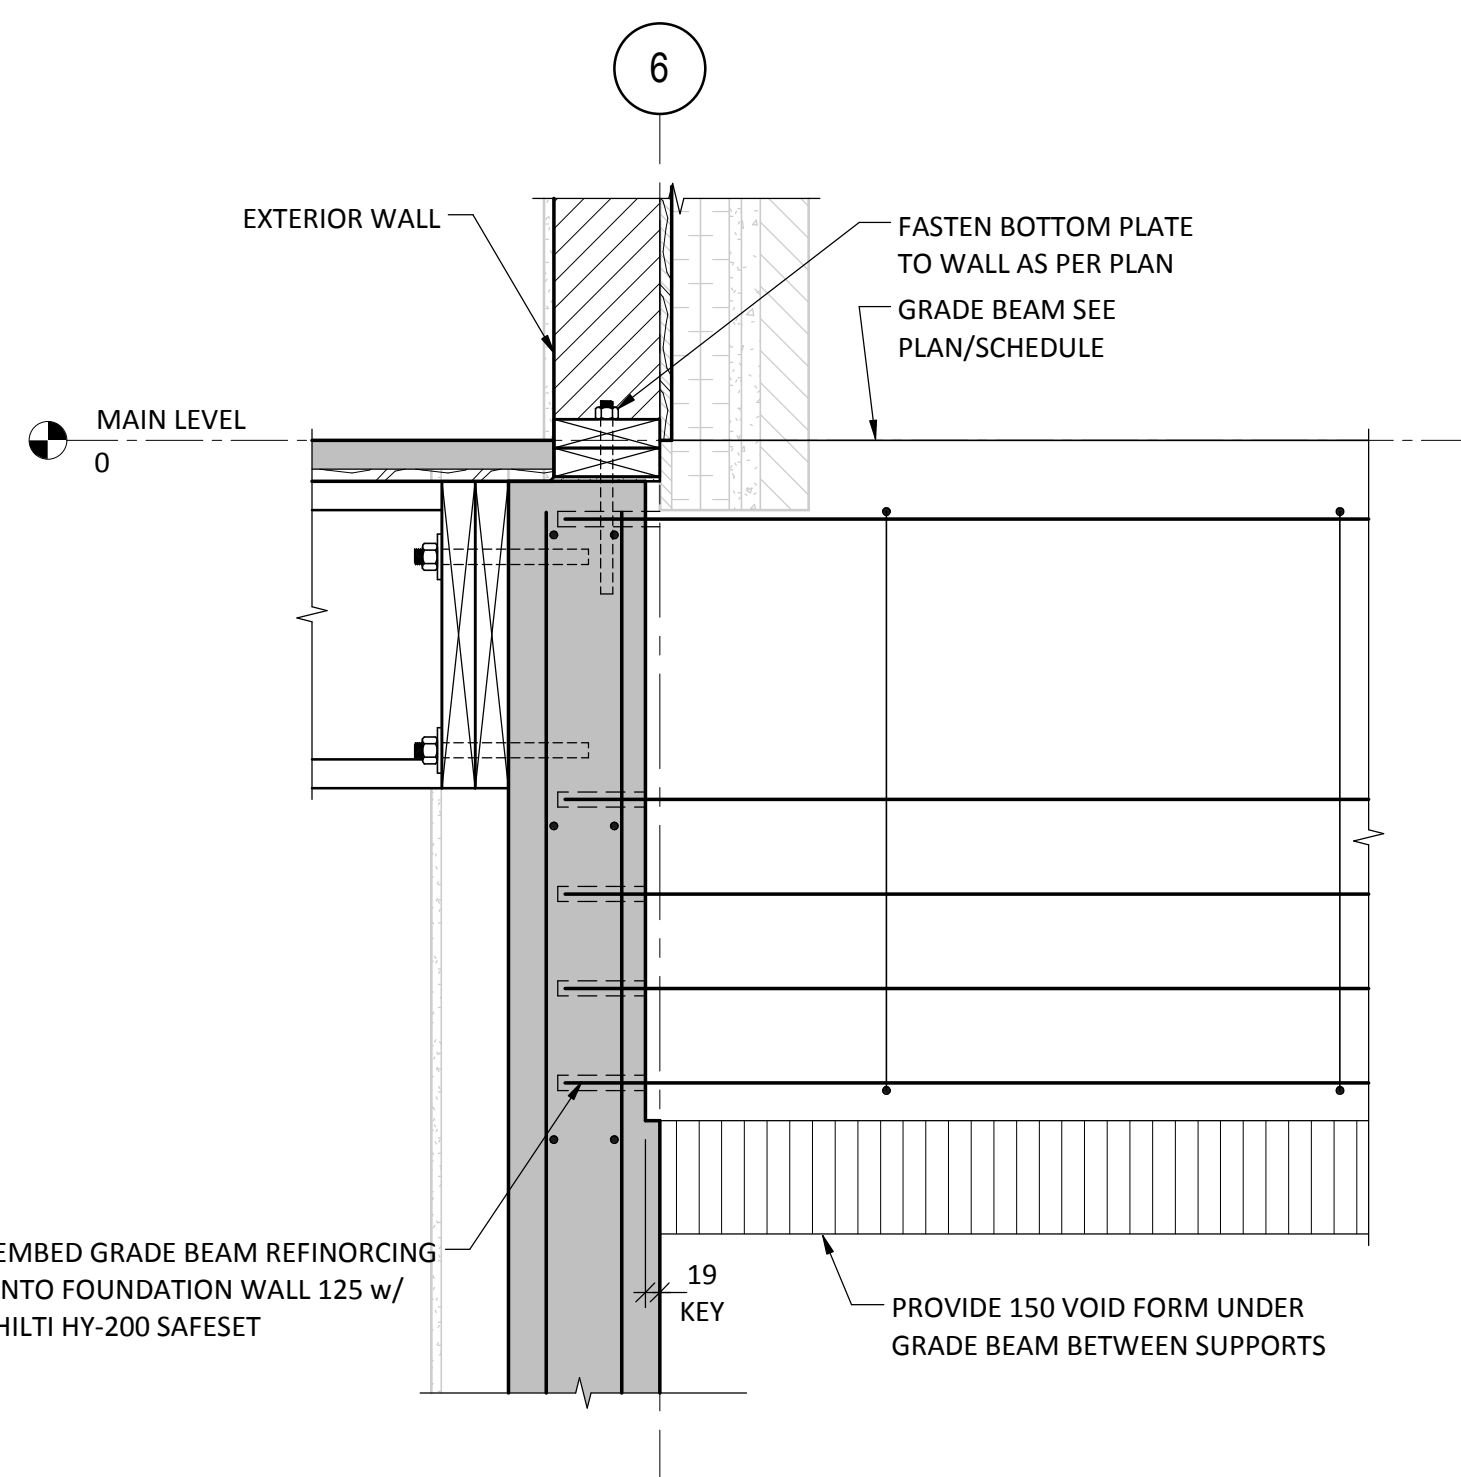


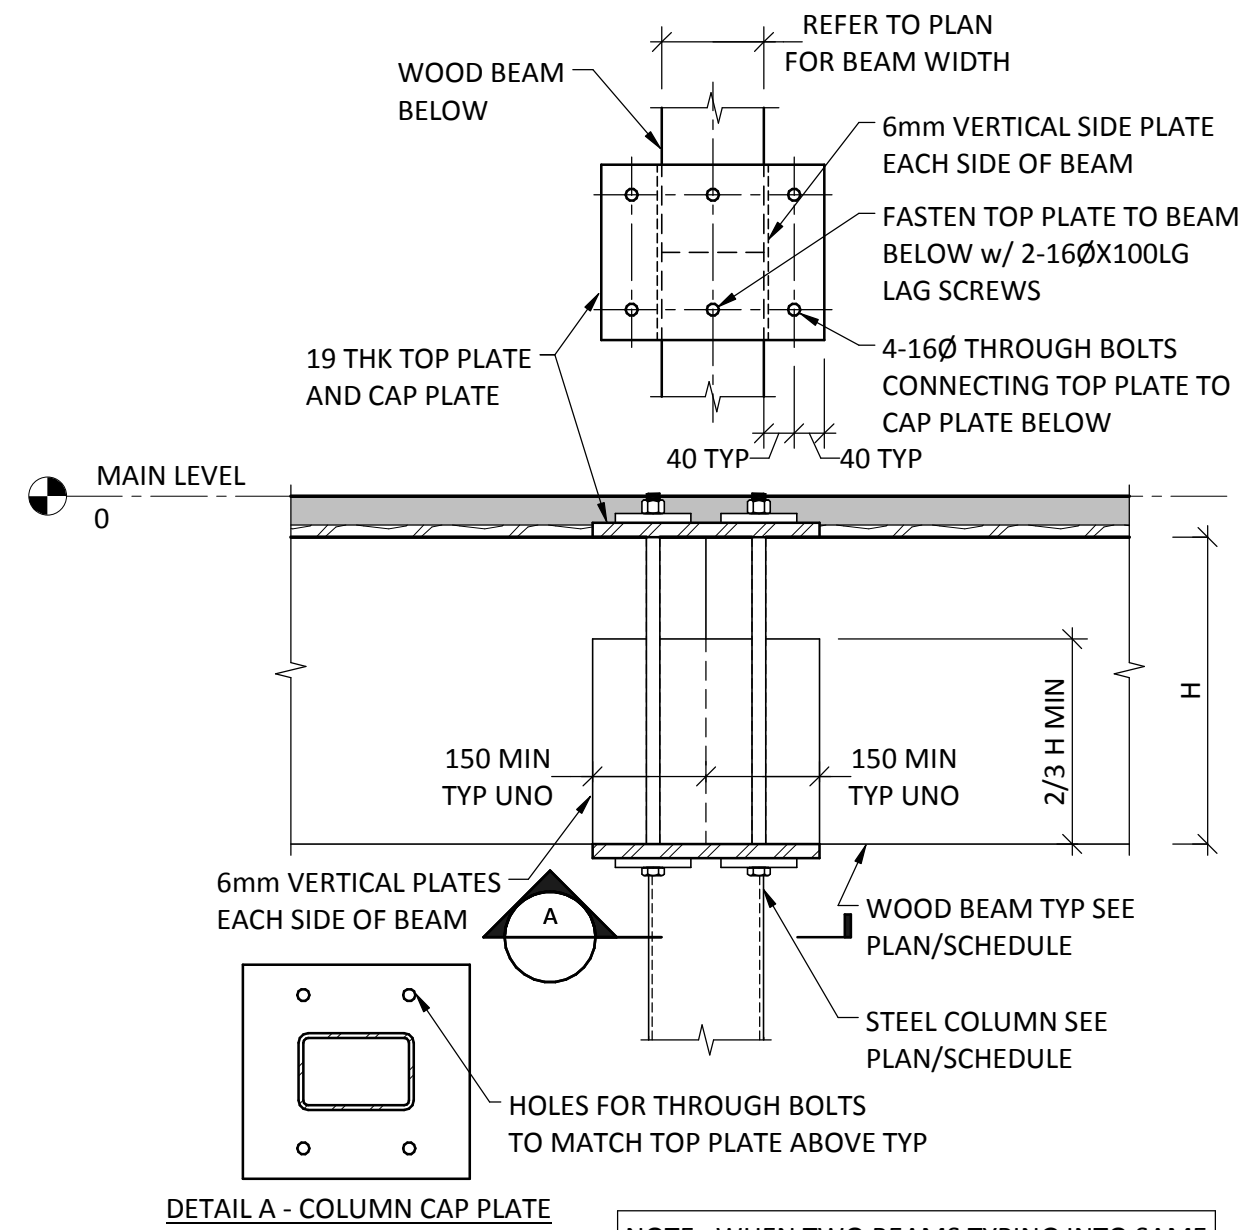DETAIL A - COLUMN CAP PLATE


1
S410
1:10
TYPICAL WOOD BEAM TO STEEL
COLUMN CONNECTION - MAIN FLOOR

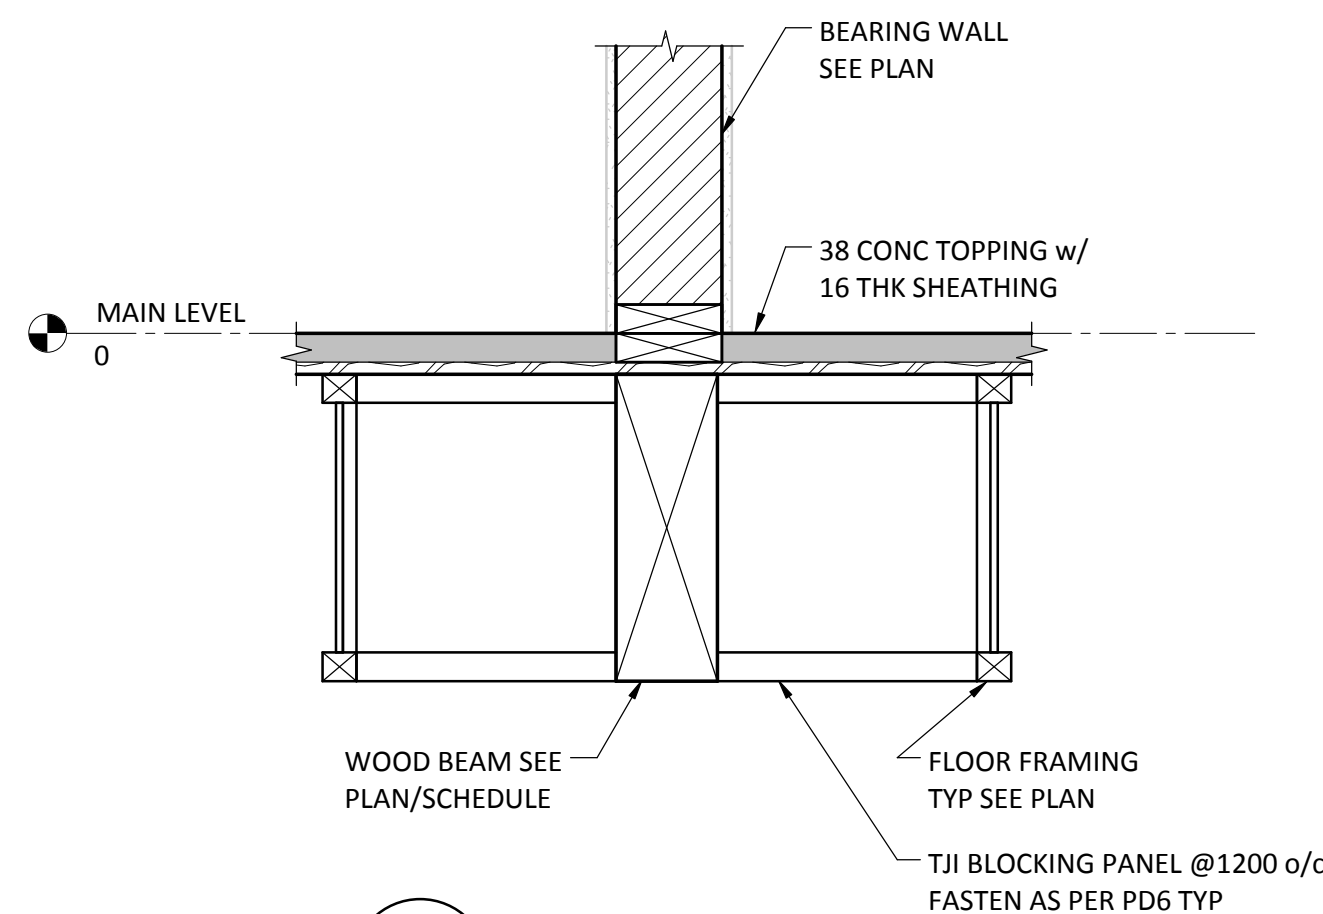


6
S410
1:10
TYPICAL INTERIOR FLUSH BEAM
WITH FLOOR FRAMING PARALLEL




10
S410
1:10
GRADE BEAM TO FOUNDATION WALL CONNECTION DETAIL

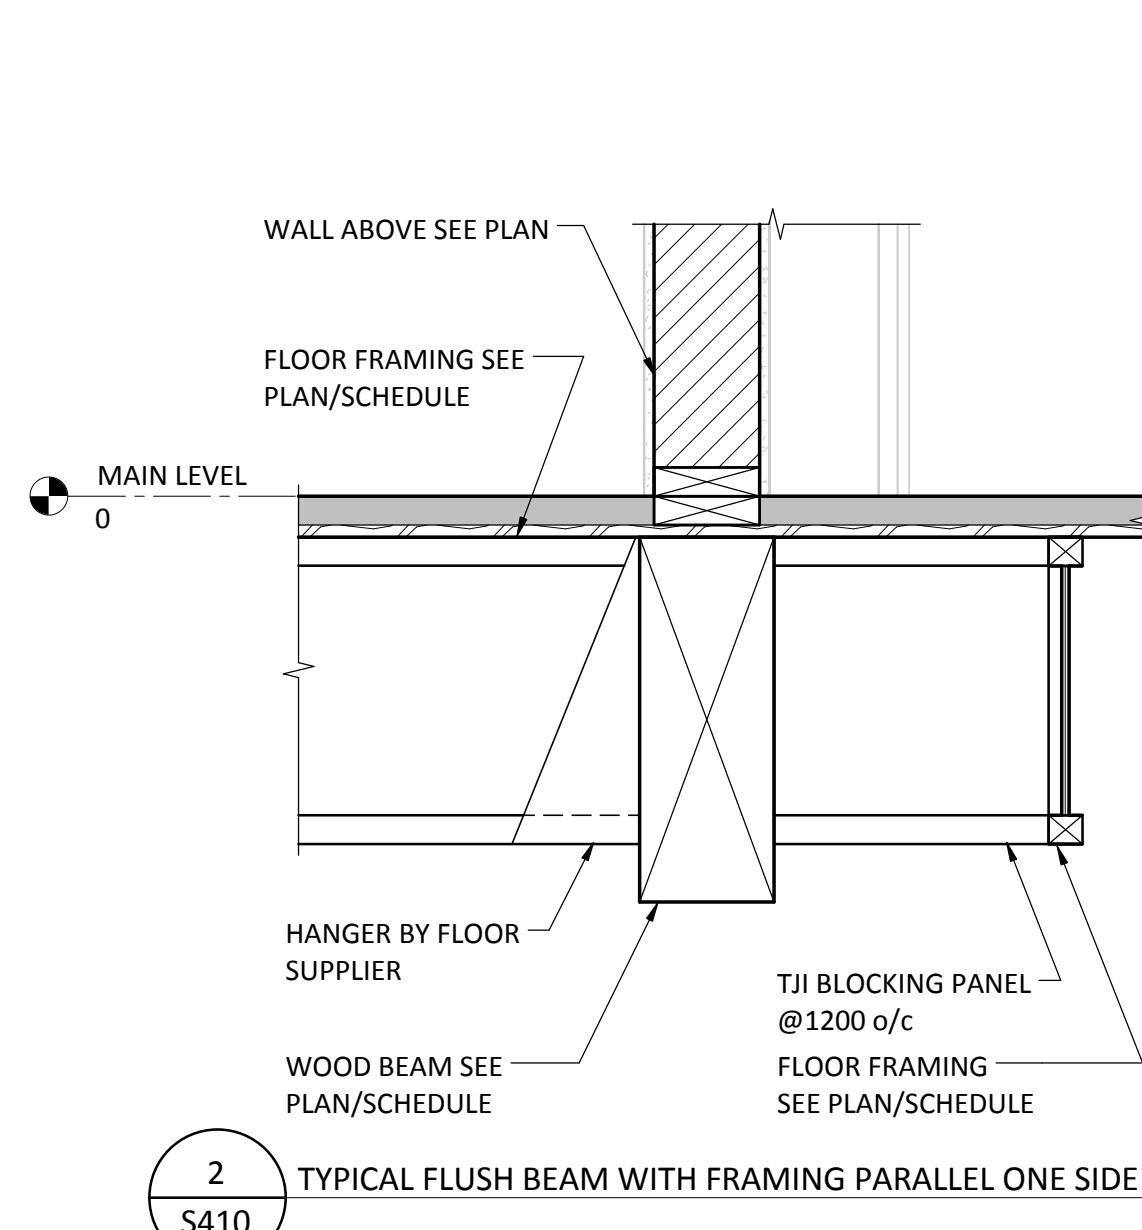


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S410
1:10
TYPICAL FLUSH BEAM WITH FRAMING PARALLEL ONE SIDE

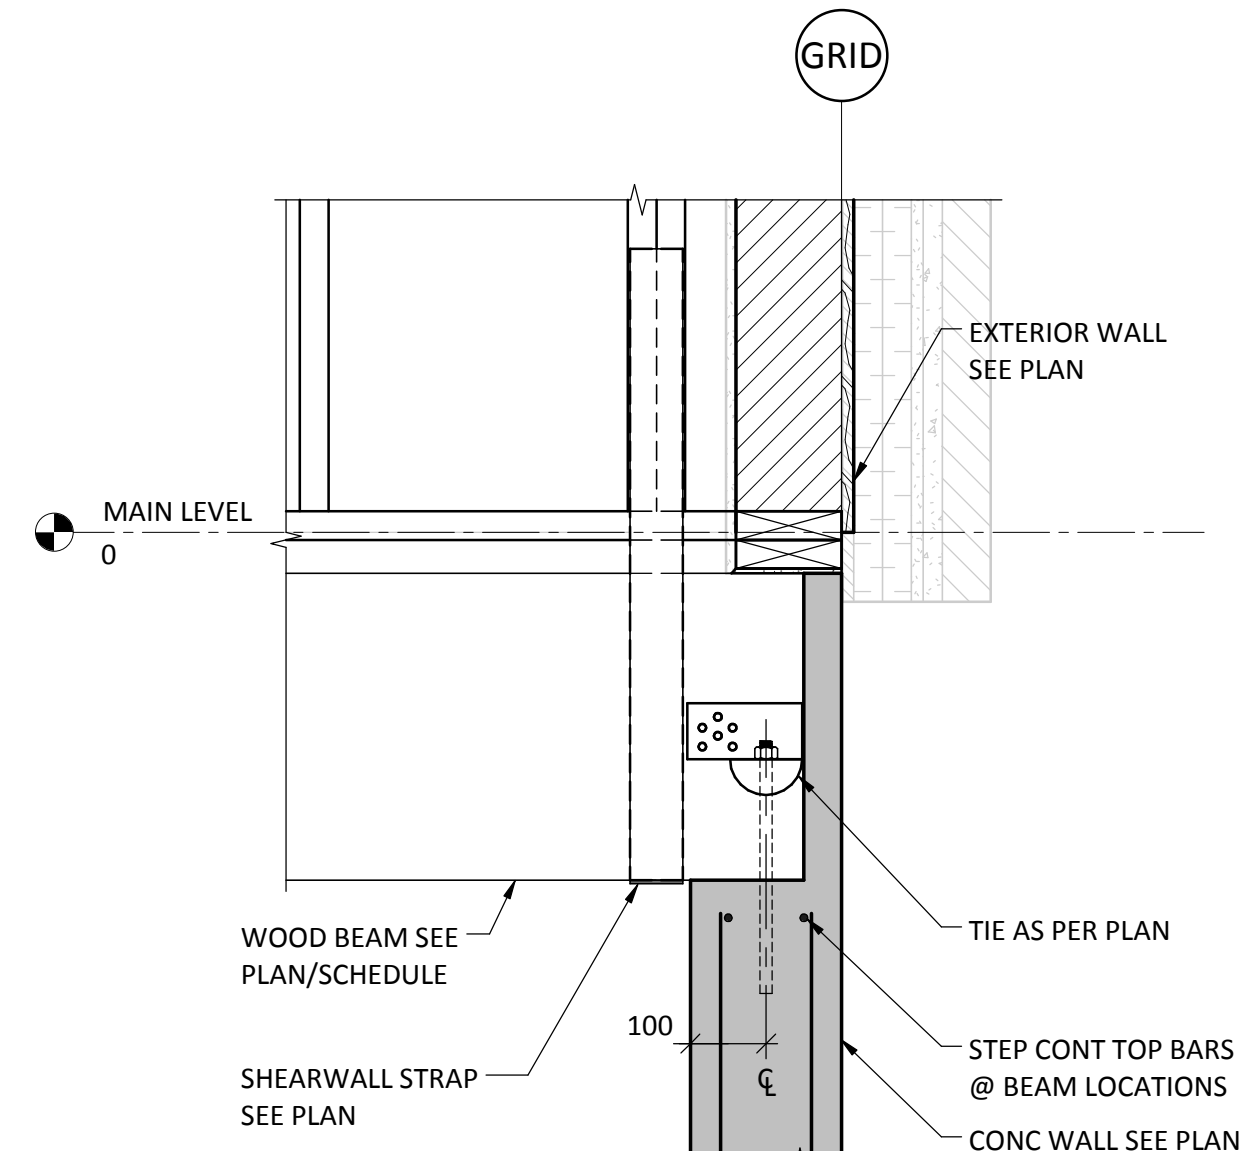


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1:10
TYPICAL CONC BEAM POCKET

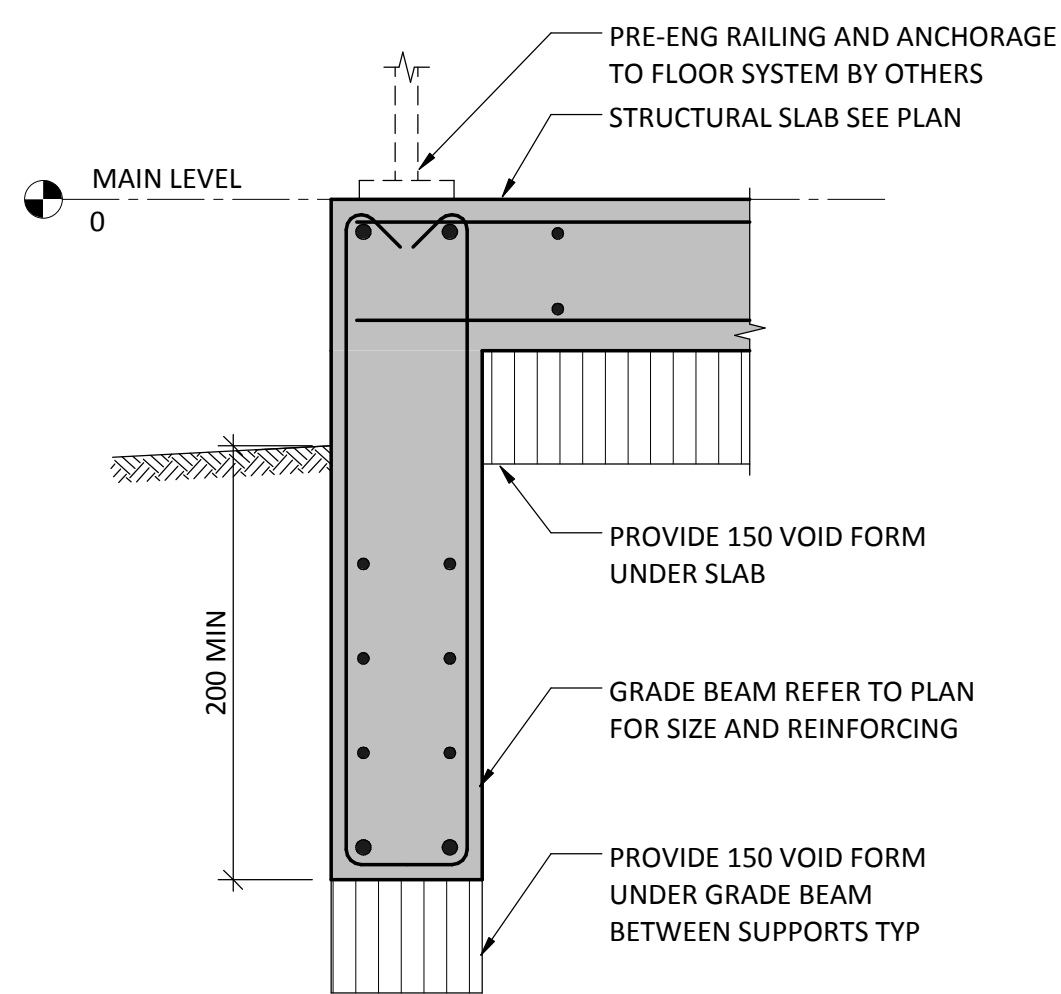


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S410
1:10
TYPICAL RAISED ENTRANCE GRADE BEAM
@ PERIMETER

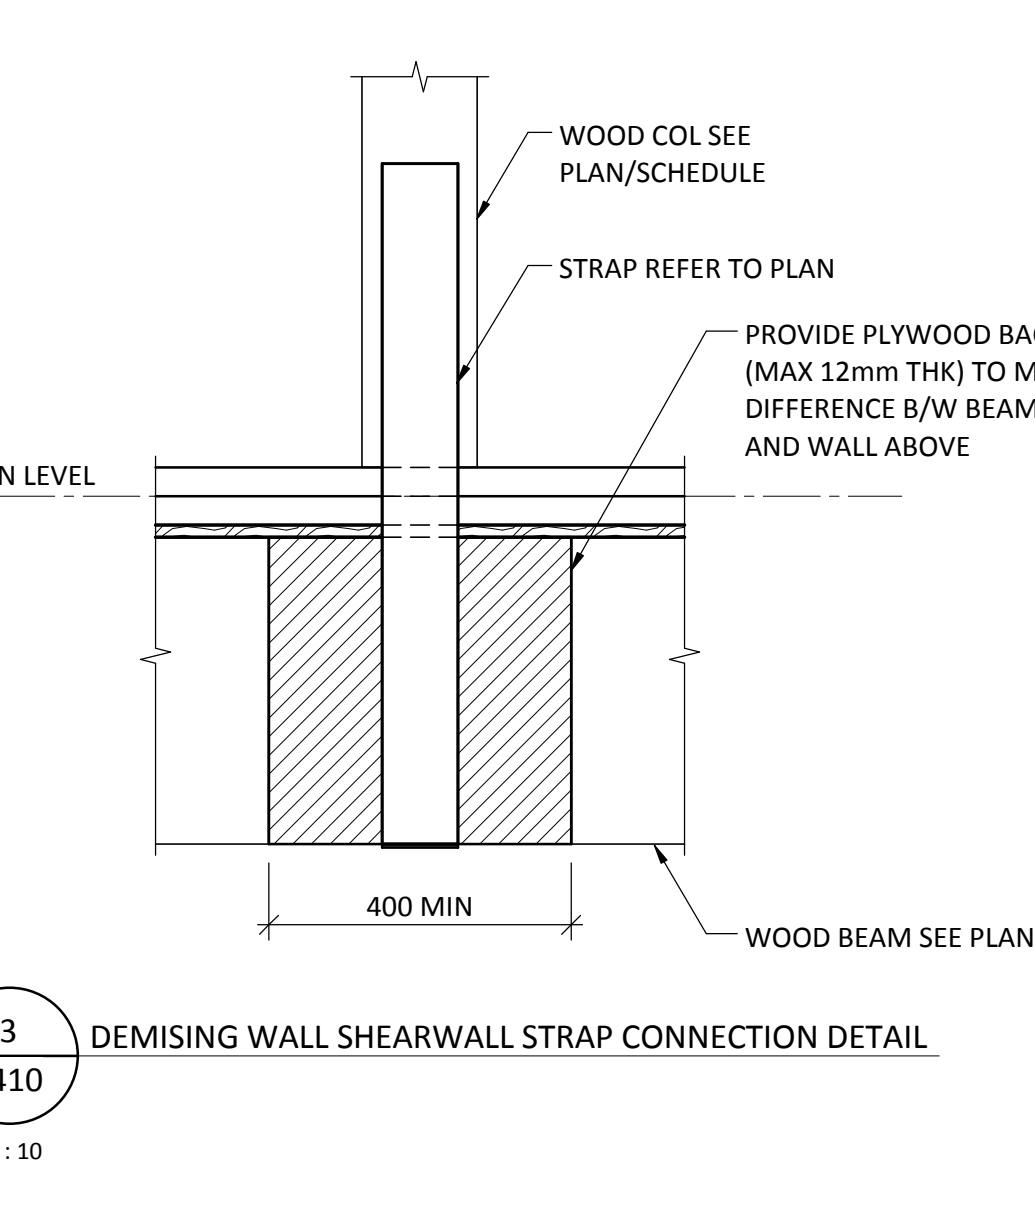


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1:10
DEMISING WALL SHEARWALL STRAP CONNECTION DETAIL

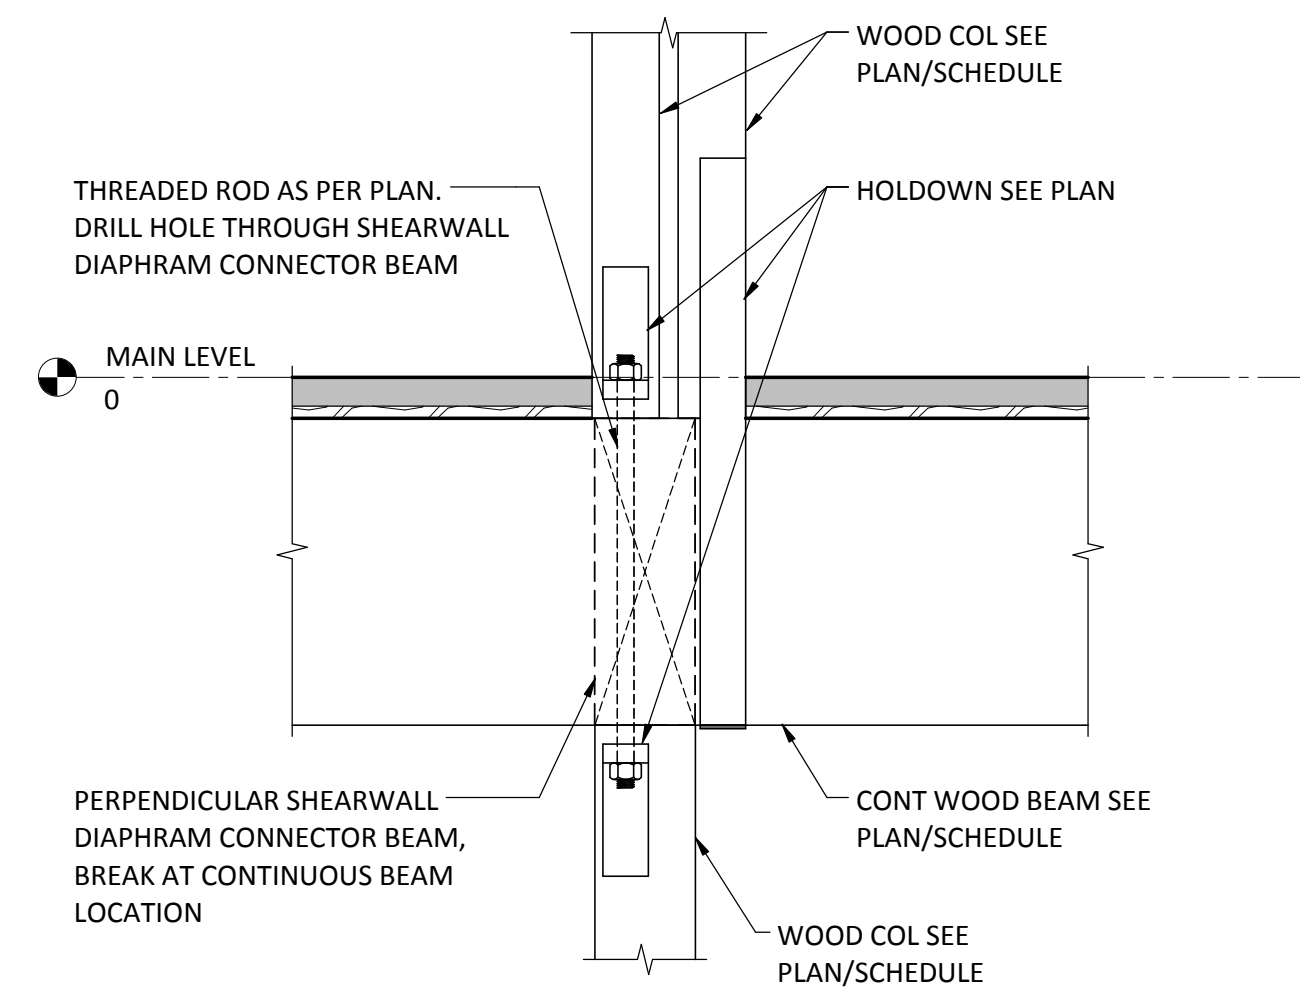


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CONTINUOUS BEAM UPLIFT CONNECTION DETAIL

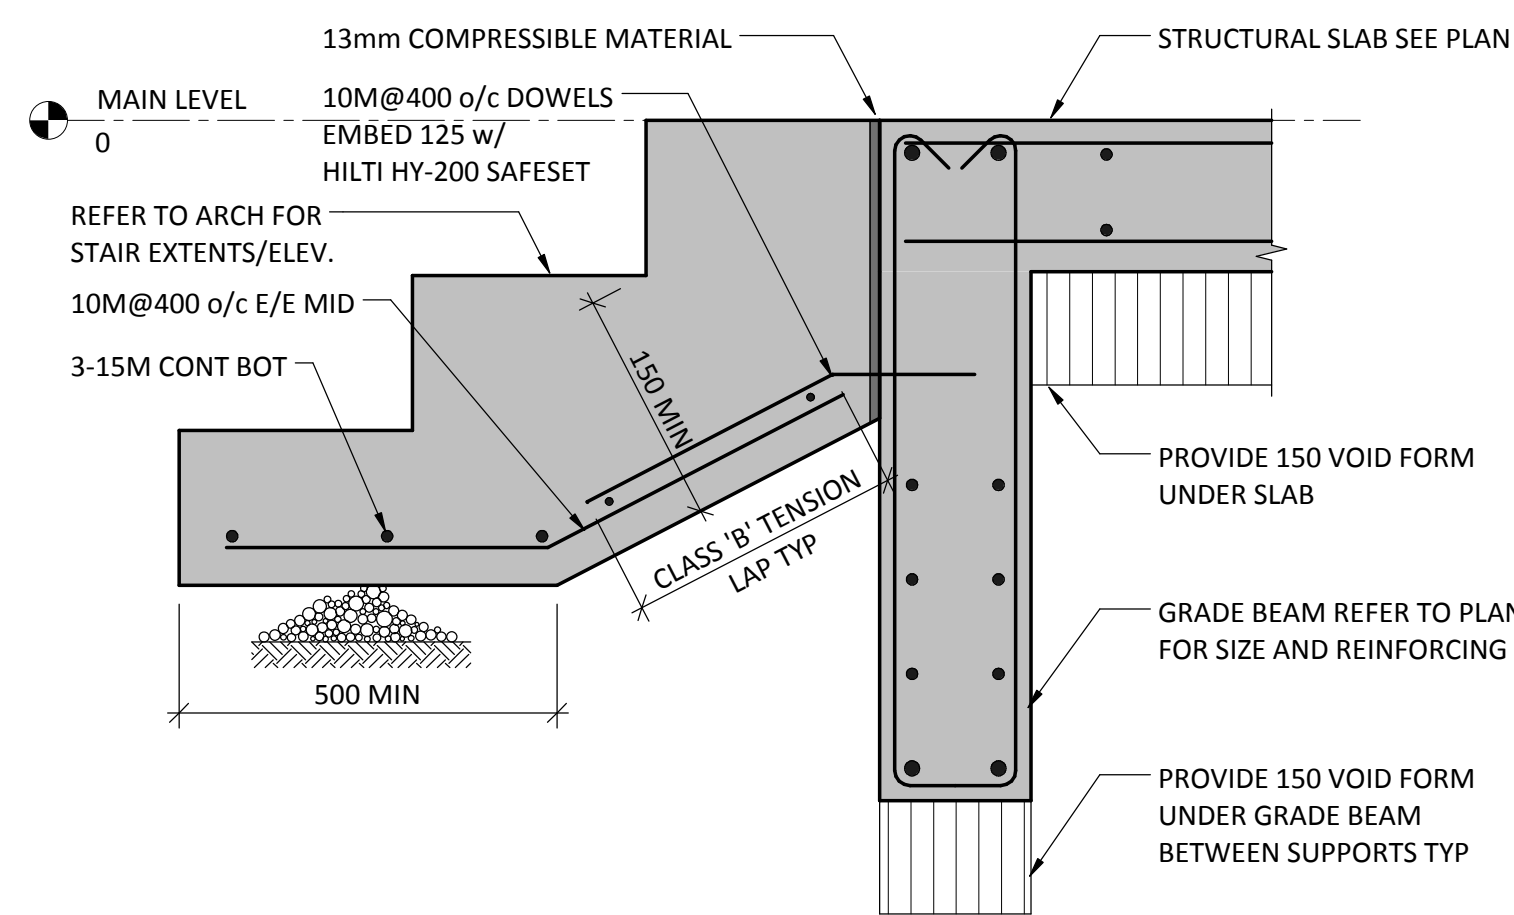


12
S410
1:10
TYPICAL RAISED ENTRANCE GRADE BEAM
@ STAIR

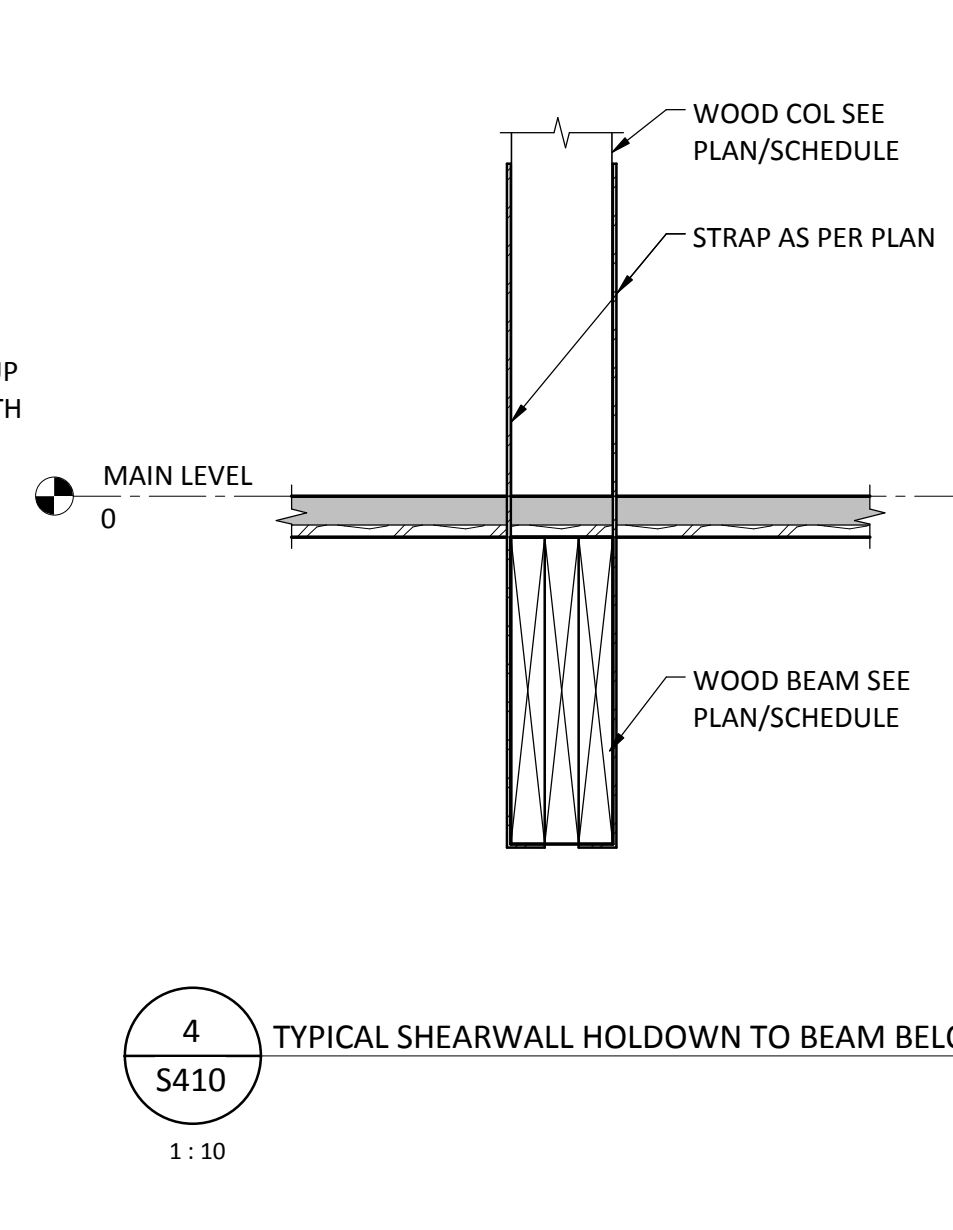

4
S410
1:10
TYPICAL SHEARWALL HOLDDOWN TO BEAM BELOW

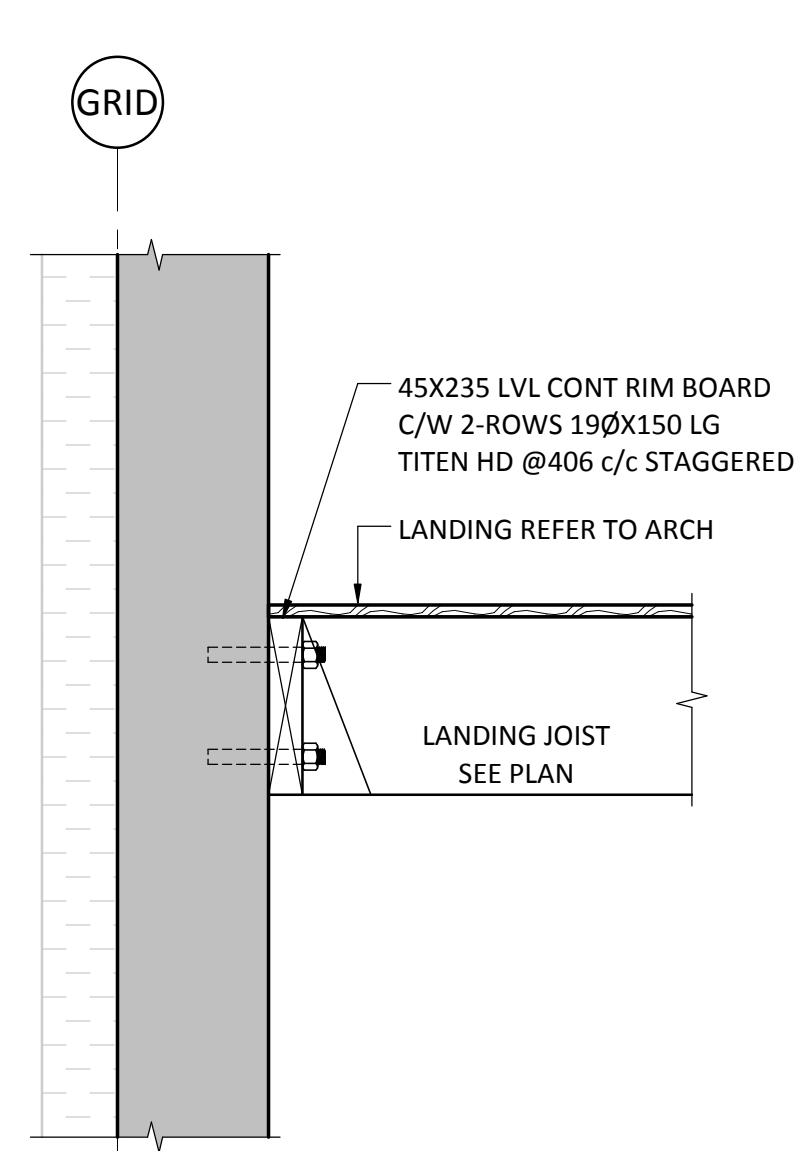

9
S410
1:10
TYPICAL LEDGER TO FOUNDATION WALL DETAIL

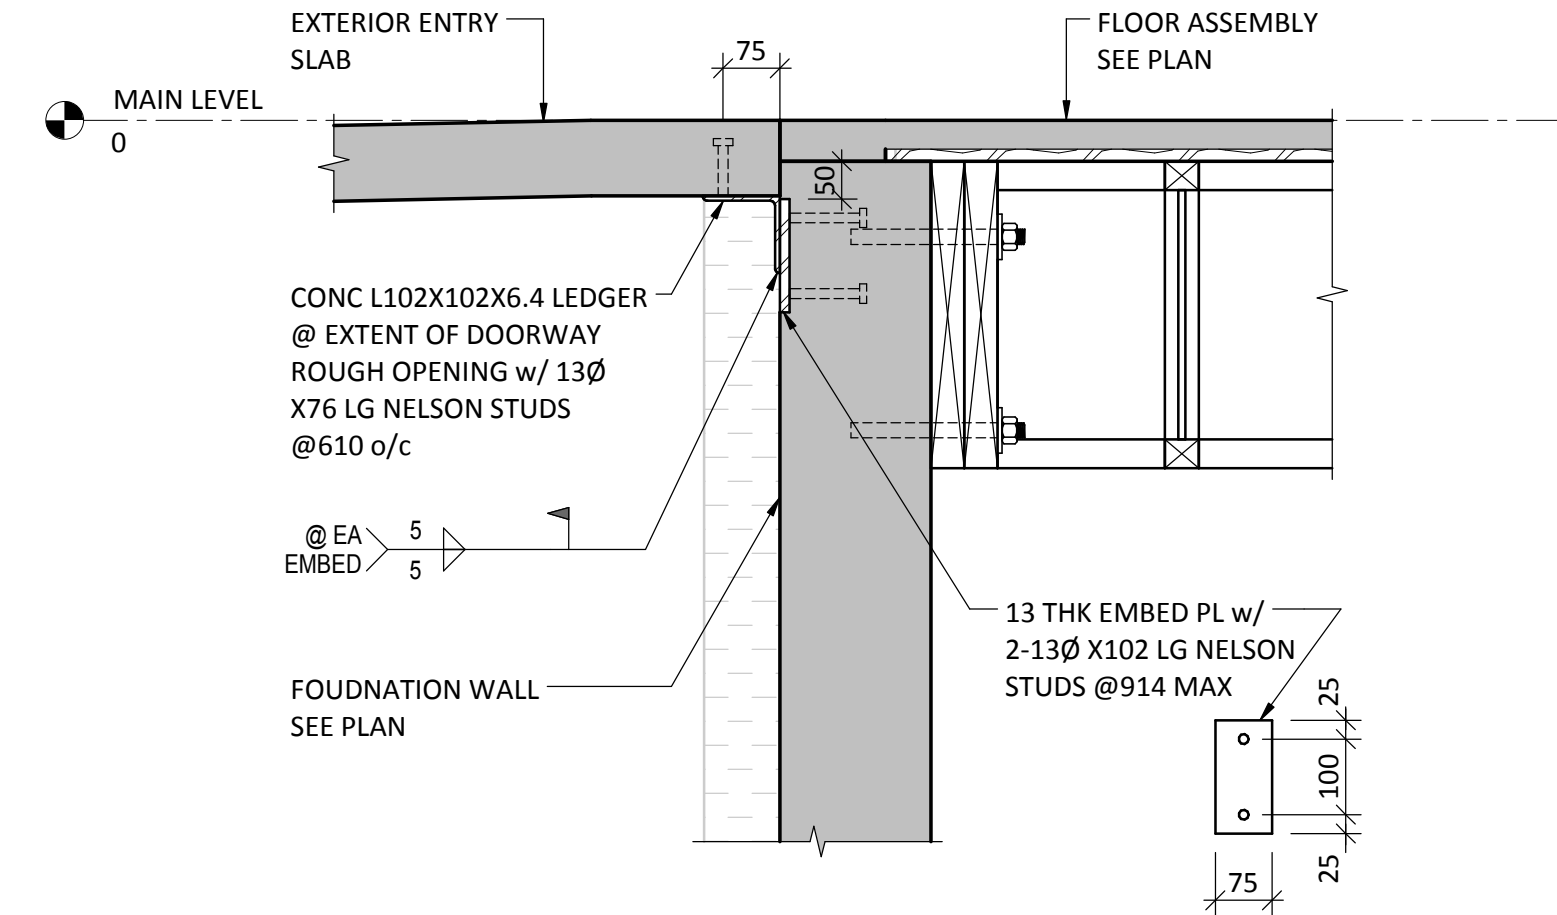

13
S410
1:10
TYPICAL EXTERIOR SLAB
SUPPORT @ ENTRANCES

NOTE: EMBED PLATE AND LEDGER ANGLE
ASSEMBLIES TO BE GALVANIZED.
CORROSION PROTECTION TO BE
RESTORED AFTER FIELD WELDING
w/ ZINGA PAINT OR EQUIVALENT

No.	Date/Date	Description/Description	Drawn by Dessiné par	Approved Approuvé
5	2016-12-08	ISSUED FOR TENDER	AD	IW
4	2016-12-08	ISSUED FOR BUILDING PERMIT	AD	IW
3	2016-09-02	ISSUED FOR 99%	AD	IW

Revision / Revision	
A	detail number numéro de détail
B	source drawing no. de dessin no.
C	detail on drawing no. détail sur dessin no.

Consultant's Name Nom de l'expert-conseil	Eng. Stamp Sceau de l'ingénieur
ENTUITIVE	
209 - 8th Avenue SW, Suite 300 Calgary, AB T2P 1B5 403-878-1270	


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Client Services Team Southern Alberta Operations Branch	Le Client Entretien l'Équipe Alberta Méridionale Branche d'Opérations

Client/client	Parks Canada Agence	L'Agence Parcs Canada
	Western and Northern Region	Ouest et Nord du Canada


Project title/Titre du projet	Staff Housing Phase 2 Waterton Lakes National Park
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Drawing title/Titre du dessin	SECTIONS & DETAILS
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

Surveyed by/Arpenté par	Drawn by/Dessiné par	Date/Date
AD	AD	12/02/16
Designed by/Concept par	Reviewed by/Revisé par	Scale/Echelle
KL	IW	1:10
PWGSC Project Manager/Administrateur de Projets TPSGC		
Randy Boldt		
Client Acceptance/Acceptation du client		
Approved by/Approuvé par		
Task Responsible/Officer/Agent Responsable		
PWGSC Project Manager/Administrateur de Projets TPSGC		
Project No./No. du projet	Asset No./No. du bien	Sheet No./ No. de la feuille
C015-0870	File # 945	
Drawing Reference No./No. de référence du dessin		S410

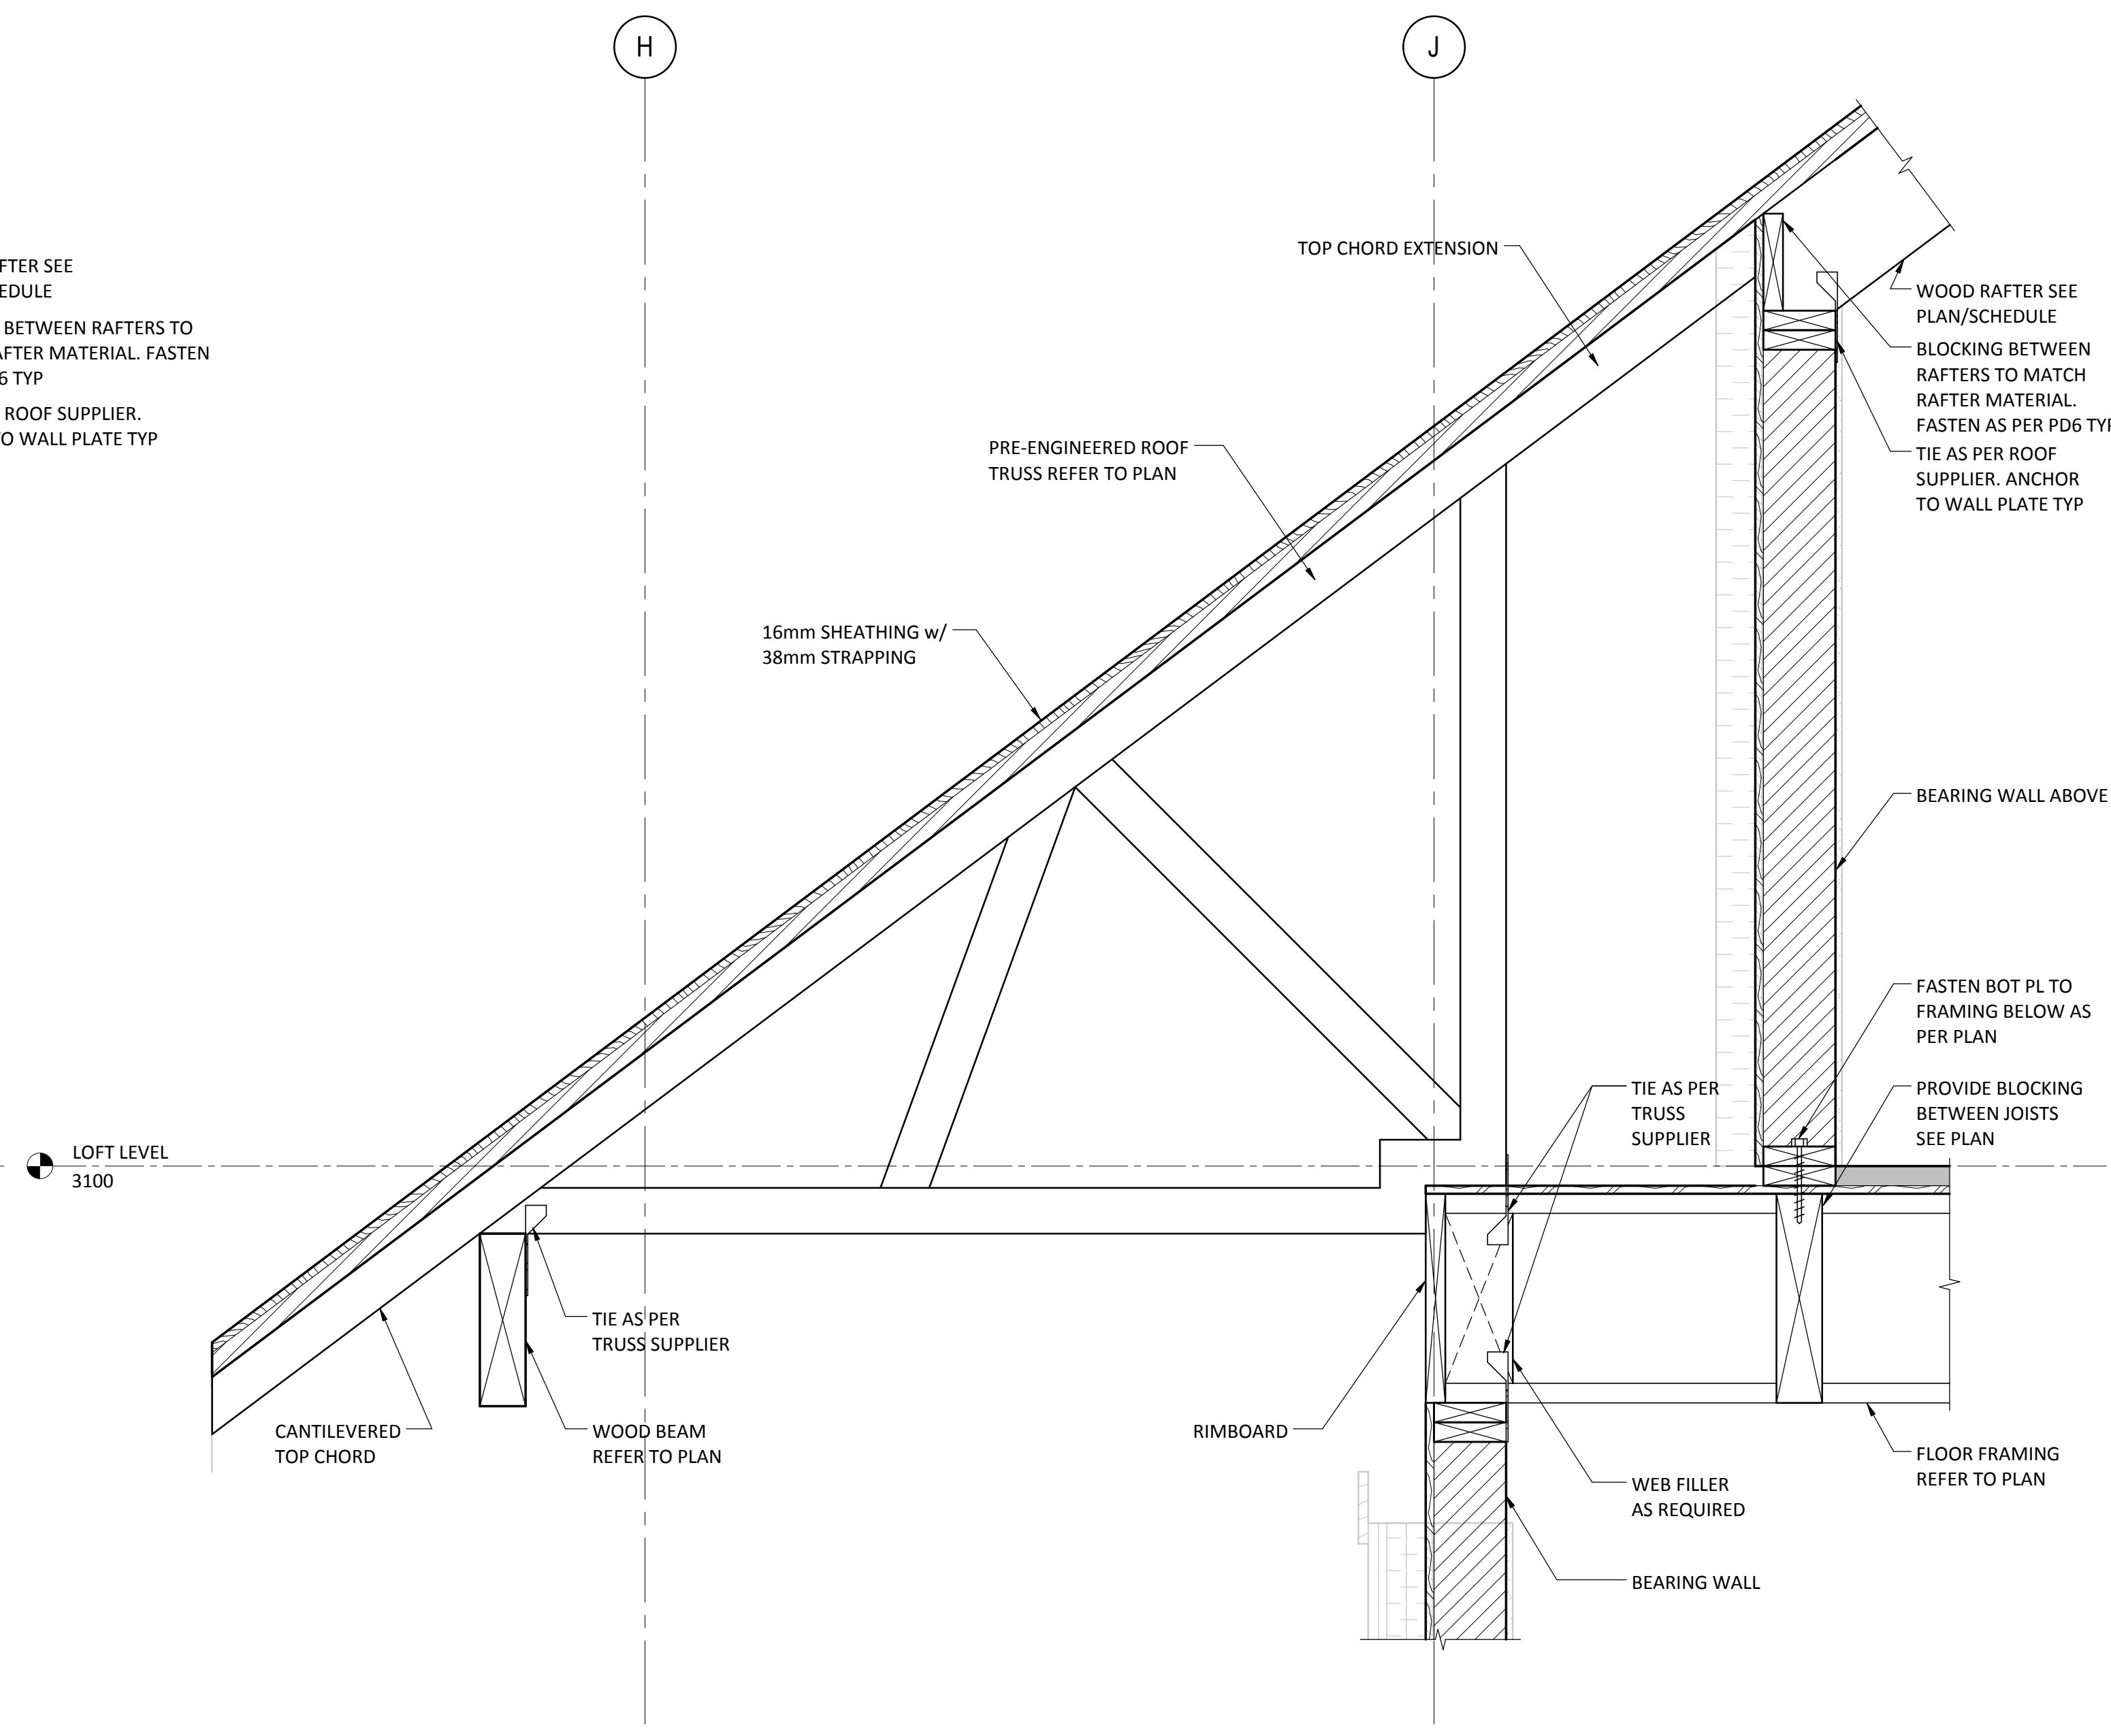

2 OVERBUILT ROOF DETAIL
S420
1 : 10

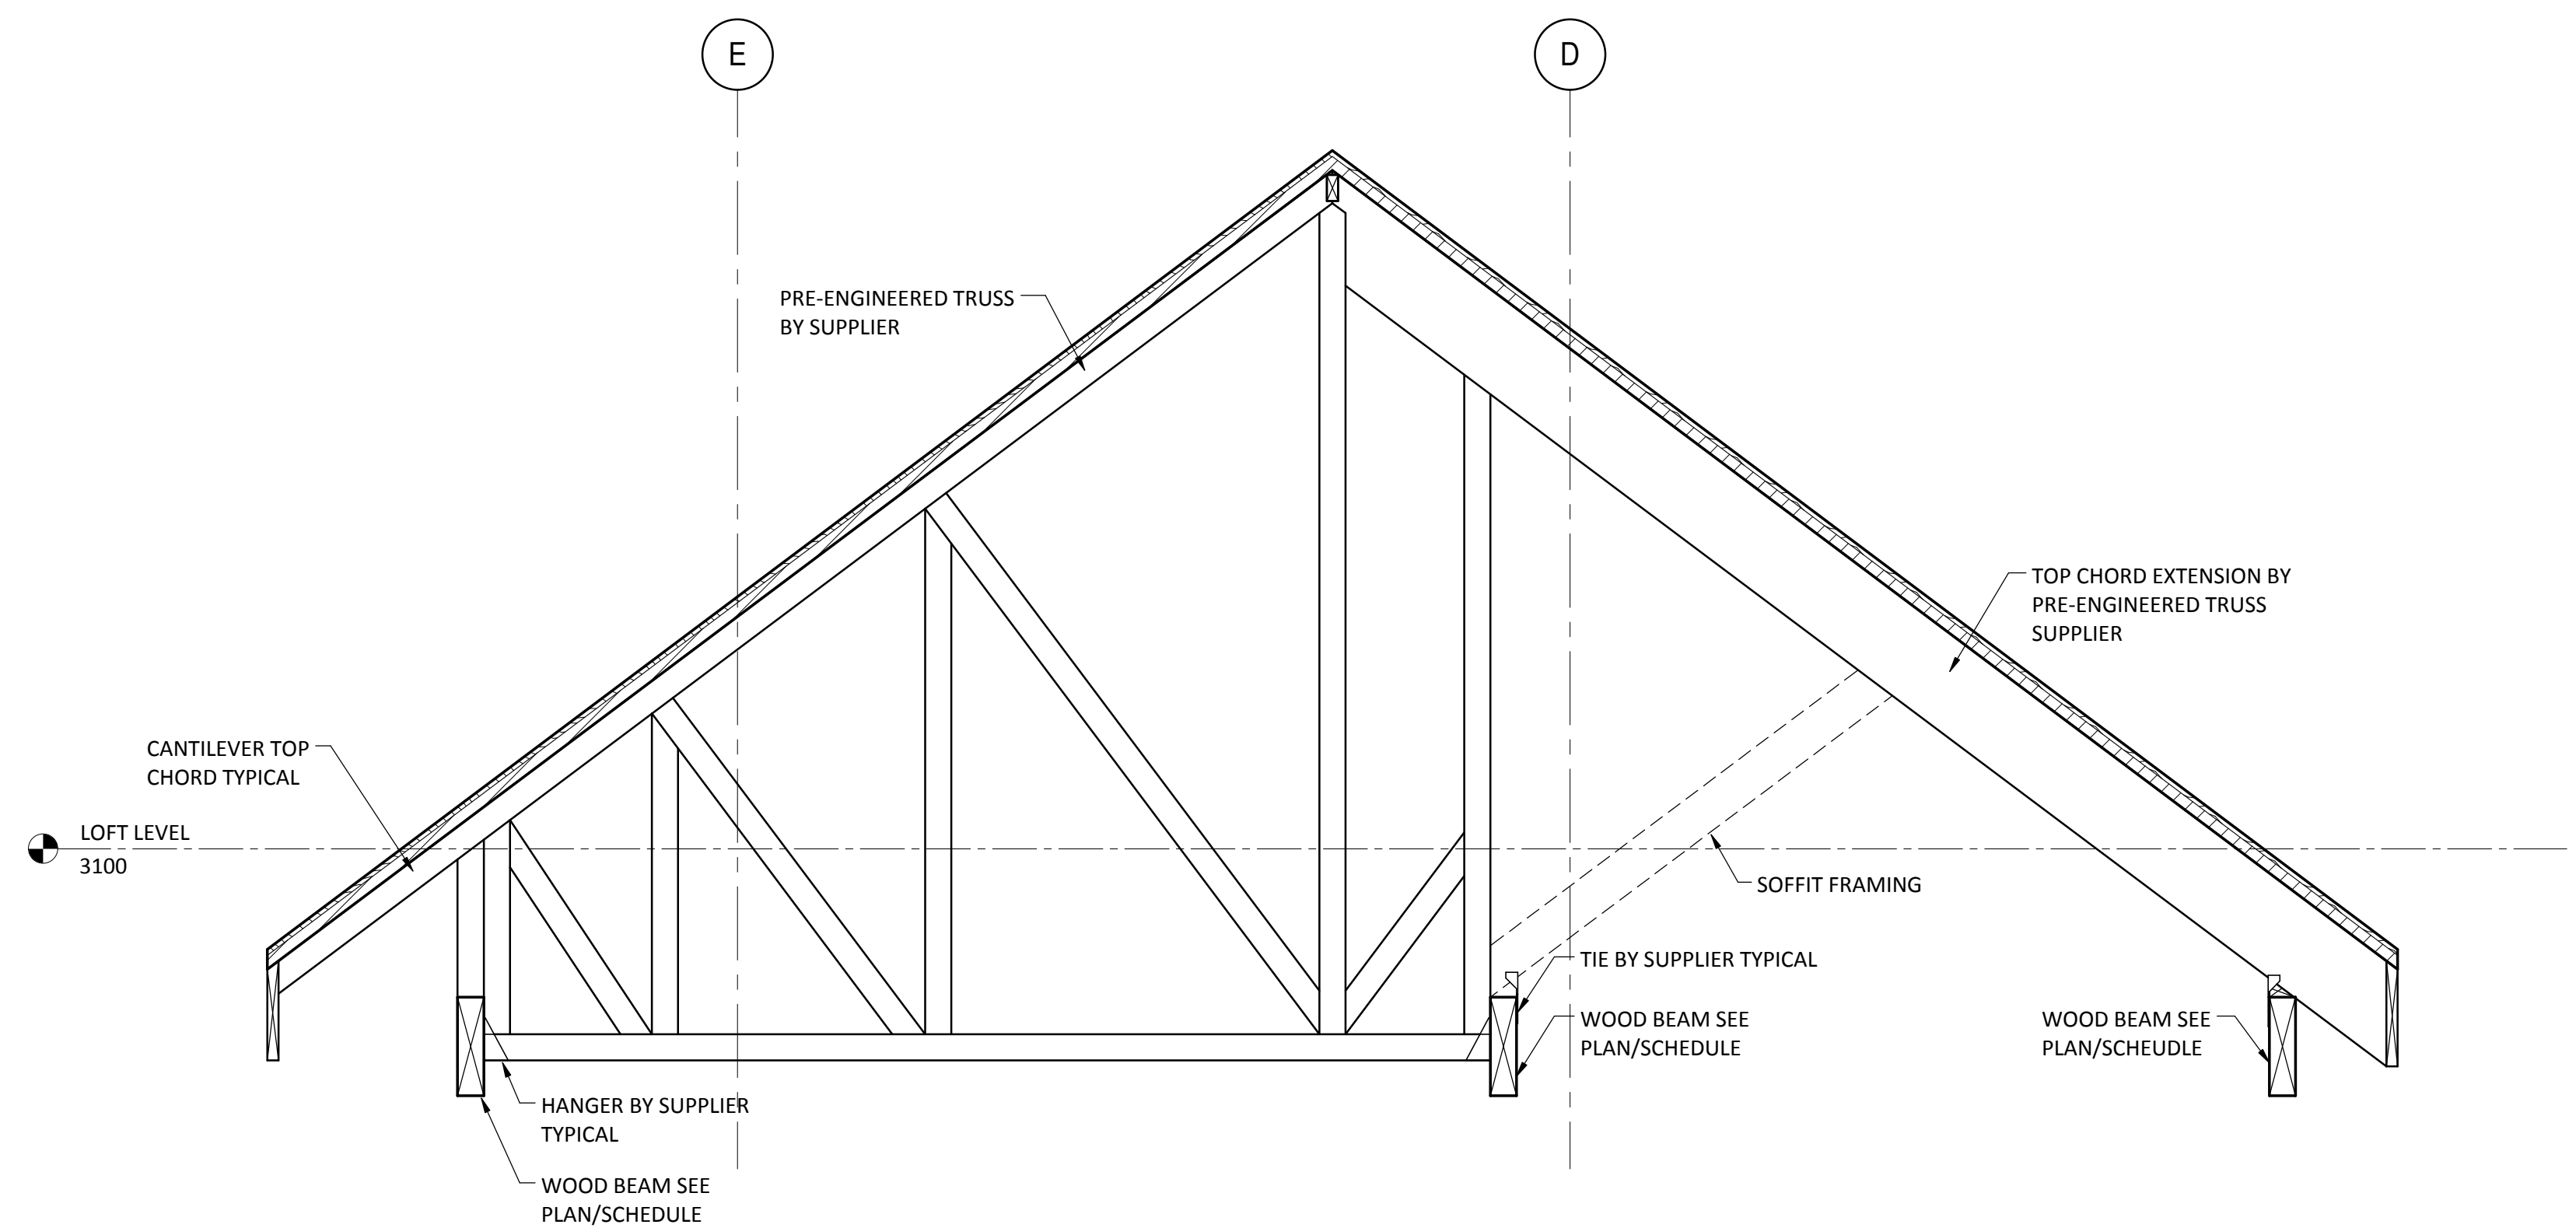

3
S420
1 : 10

	Revision / Revision	
	A detail number numero de detail B source drawing no. de dessin no. C detail on drawing no. detail sur dessin no.	

	Public Works and Government Services Canada	Travaux publics et Services gouvernementaux Canada
	Client Services Team Southern Alberta Operations Branch	Le Client Entretien l'Équipe Alberta Méridional Branche d'Opérations

Client/client 	Parks Canada Agence	L'Agence Parcs Canada
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Project title/Titre du projet

Staff Housing Phase 2 Waterton Lakes National Park

Surveyed by/Arpente par AD	Drawn by/Dessine par AD	Date/Date 12/02/16
Designed by/Concept par KL	Reviewed by/Revise par IW	Scale/Echelle As indicated

Randy Boldt

Client Acceptance/Acceptation du client	Approved by/Approuvé par
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Park Responsible Officer/Agent Responsable	PWSC Project Manager/Administrateur de Projets IPSGC
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Project No./No. du projet	Asset No./No. du bien	Sheet No./
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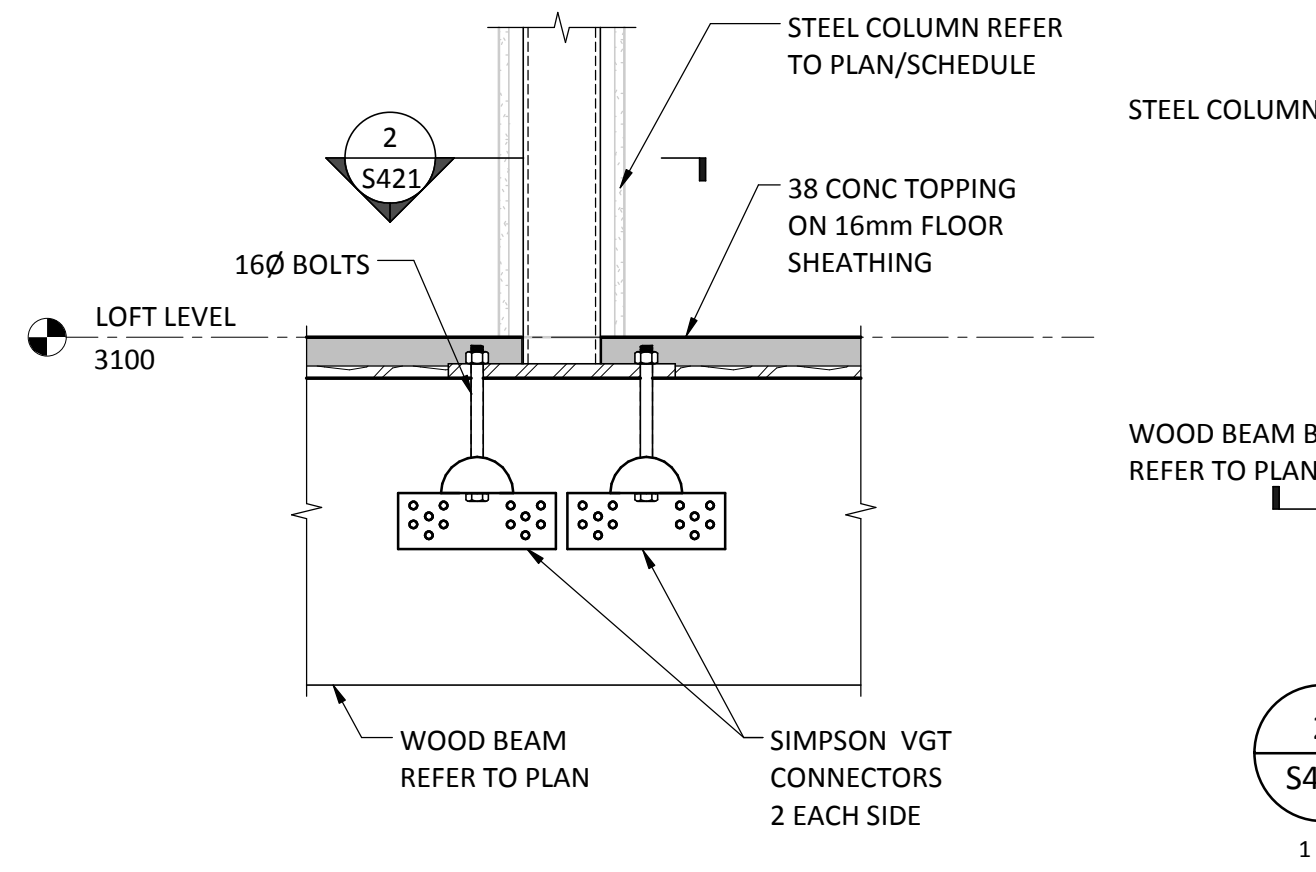
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Drawing Reference No./No. de reference du dessin	S420
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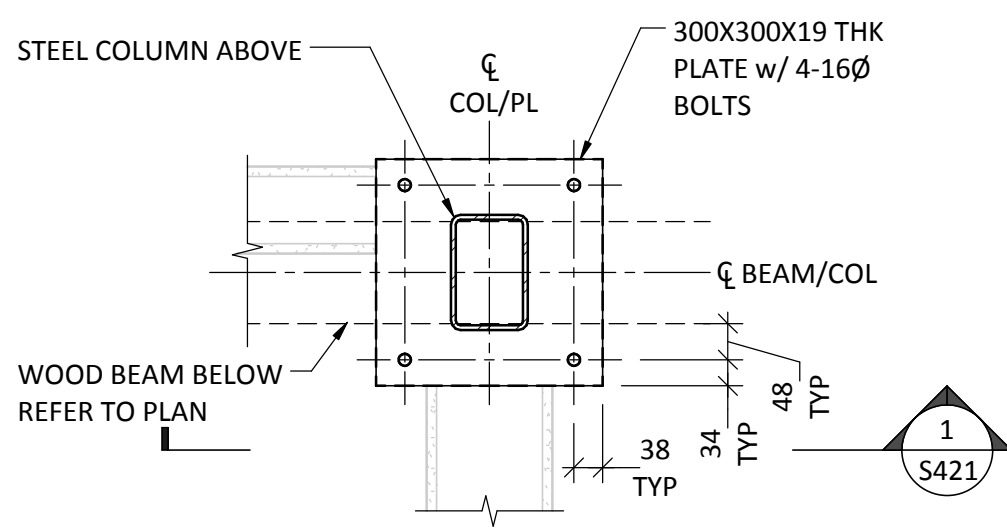
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1
S421
1 : 10


TYPICAL STEEL COLUMN TO WOOD BEAM CONNECTION

NOTE:
1. BASE PLATE TO SIT DIRECTLY ON BEAM TYP.
INSTALLATION ON SHEATHING NOT ACCEPTABLE.
2. FLOOR JOISTS NOT SHOWN FOR CLARITY.




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S421
1 : 10

TYPICAL STEEL COLUMN BASEPLATE DETAILS

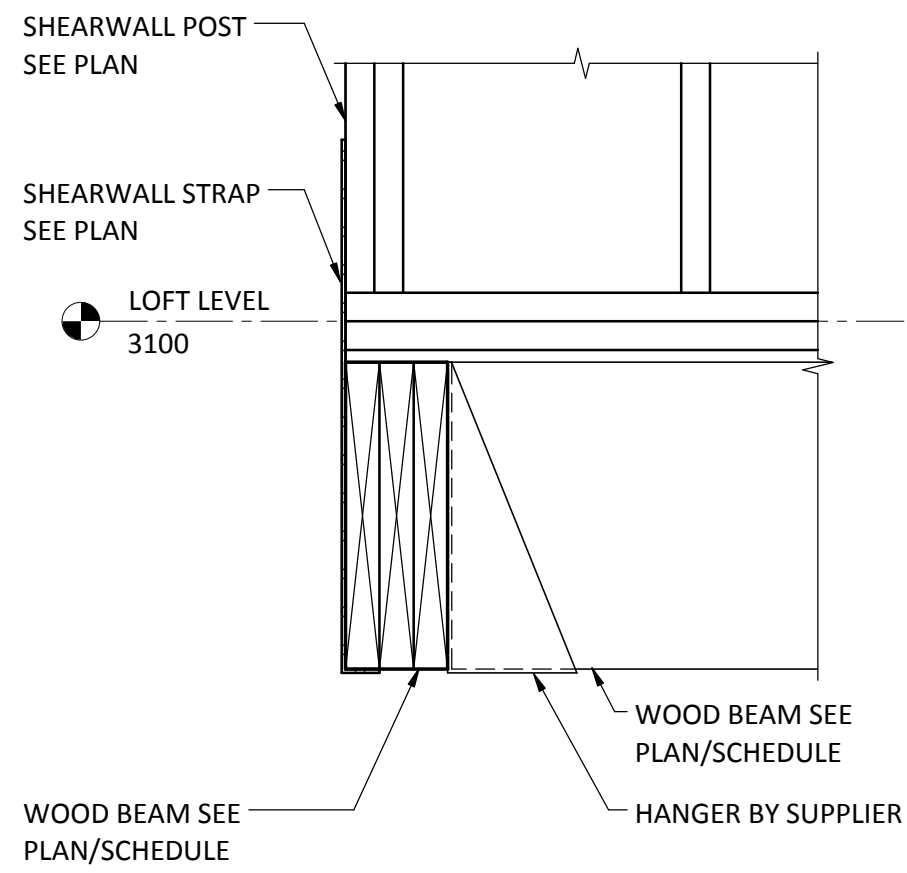


3
S421
1 : 10

SHEARWALL CONNECTION DETAIL

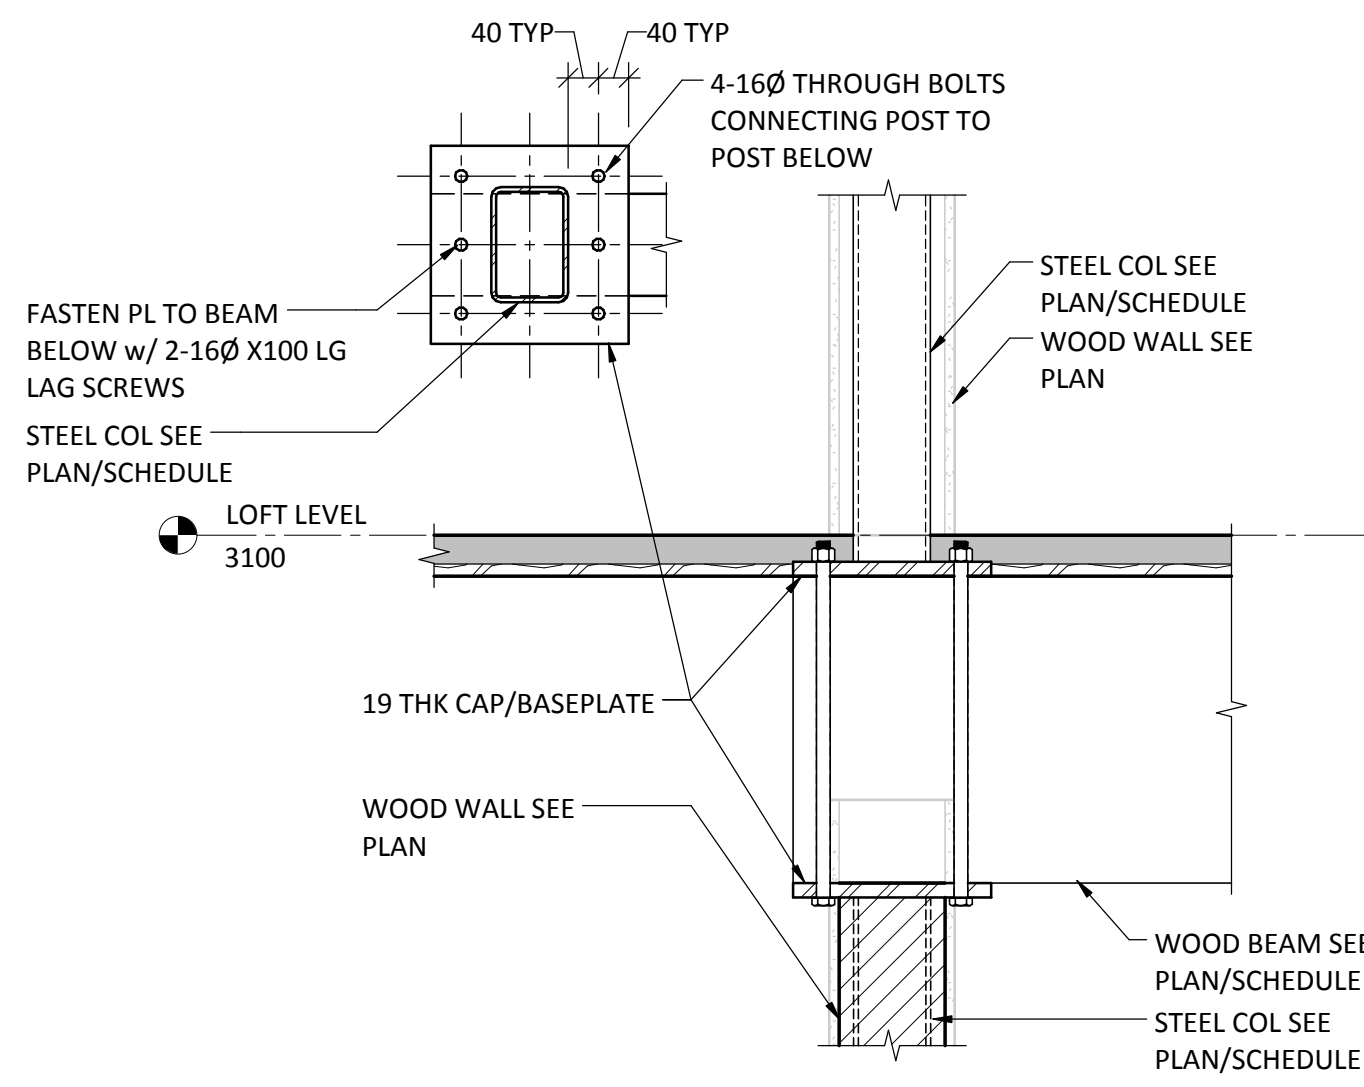


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S421
1 : 10

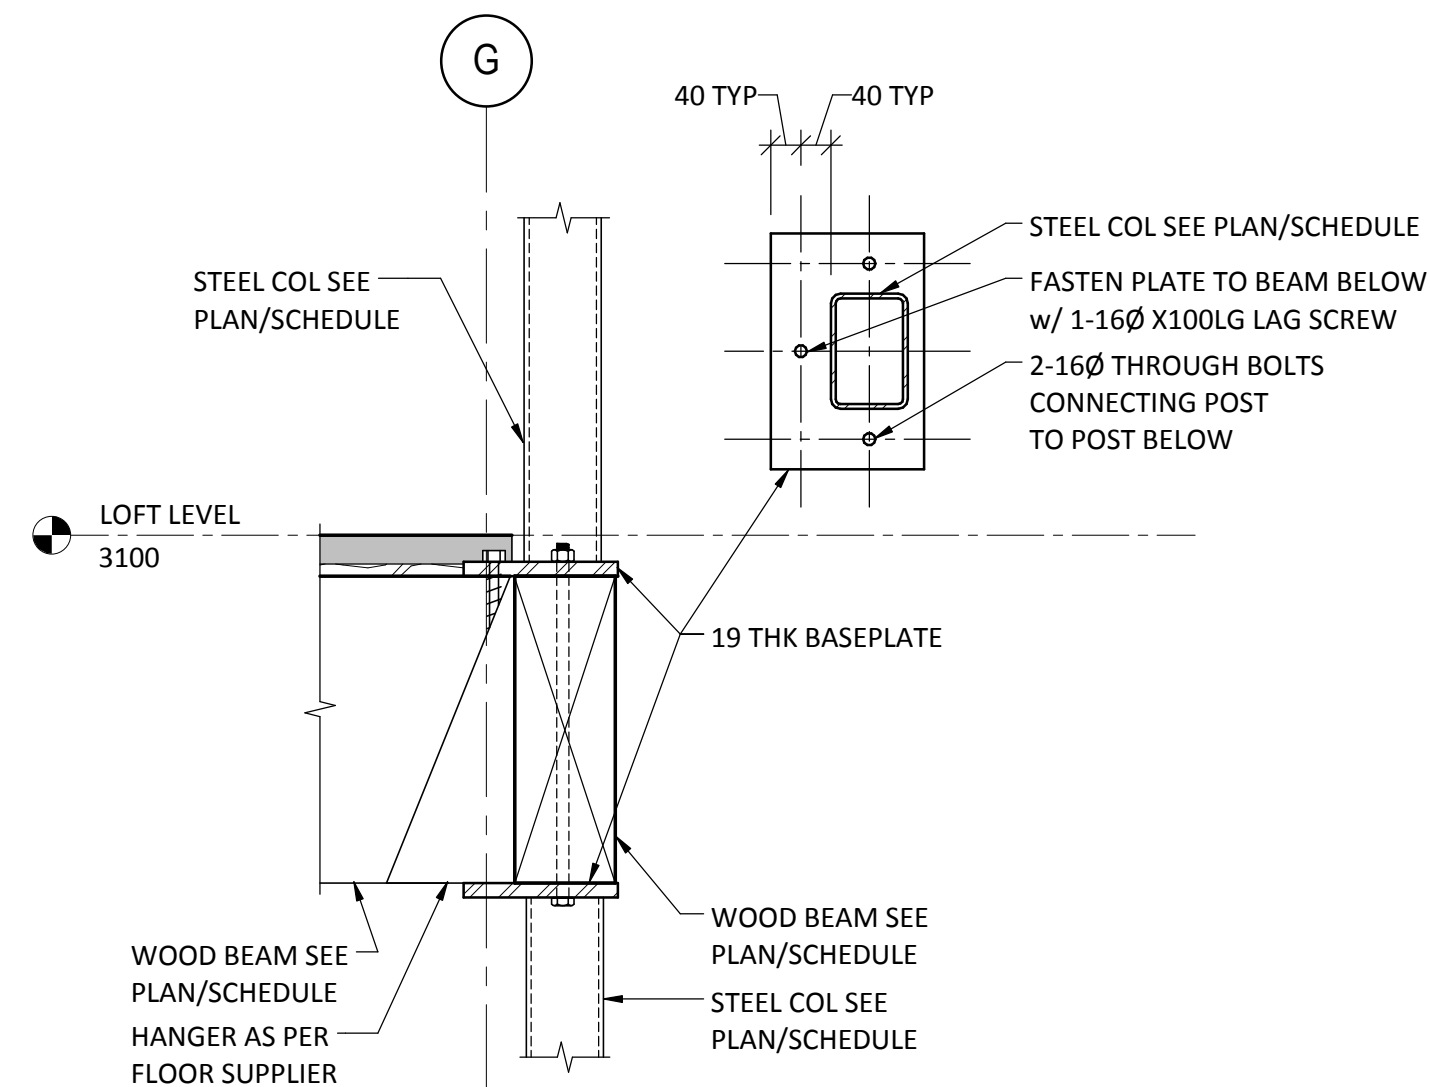

5
S421
1 : 10


STEEL COLUMN TRANSFER AT STAIRWELL

NOTE: SHEARWALLS NOT SHOWN FOR CLARITY

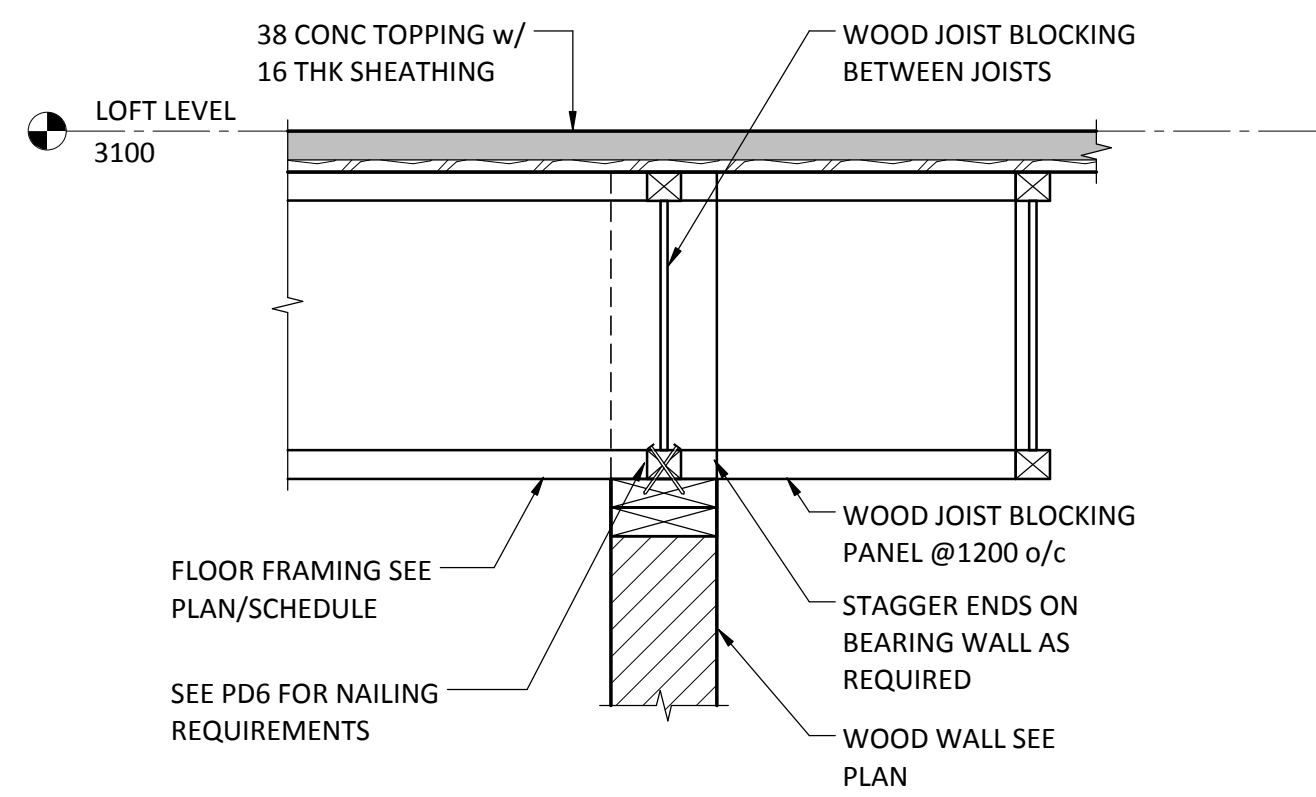

6
S421
1 : 10

TYPICAL INTERIOR BEARING WALL

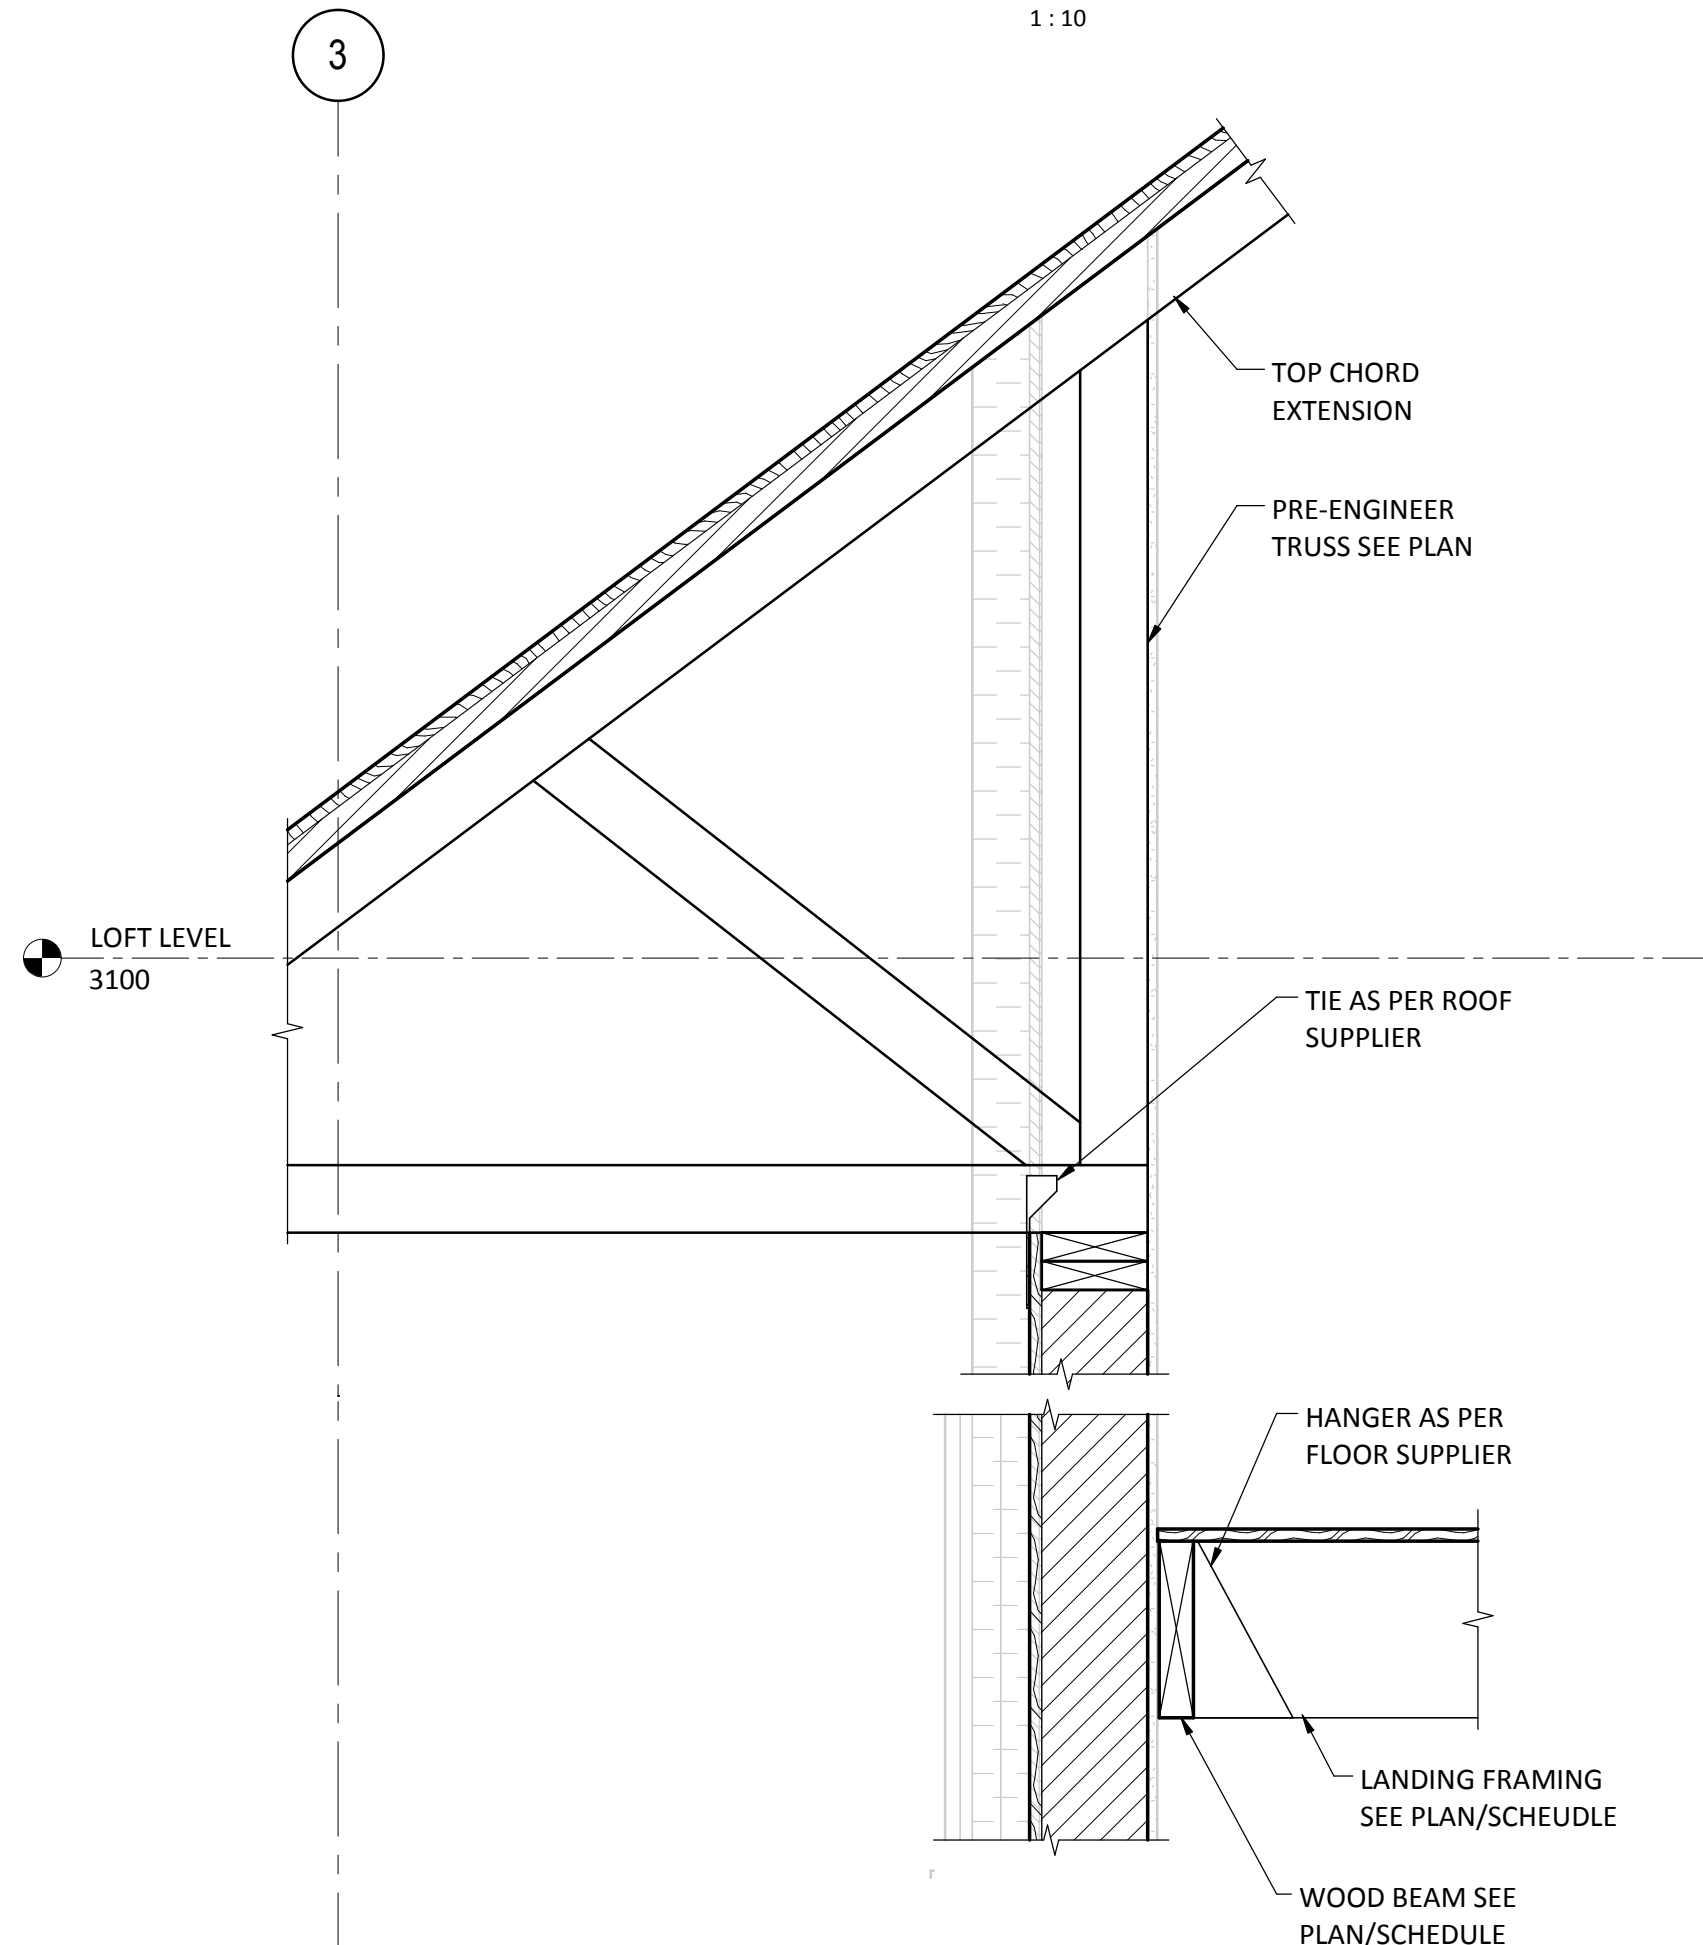

7
S421
1 : 10

STAIRWELL WALL ROOF FRAMING DETAILS

5	2016-12-08	ISSUED FOR TENDER	AD	IW
4	2016-12-08	ISSUED FOR BUILDING PERMIT	AD	IW
3	2016-09-02	ISSUED FOR 99%	AD	IW
No.	Date/Date	Description/Description	Drawn by Dessiné par	Approved Approuvé

Revision / Revision	
A	detail number numero de detail
B	source drawing no. de dessin no.
C	detail on drawing no. detail sur dessin no.

Consultant's Name
Nom de l'expert-conseil

ENTUITIVE
209 - 8th Avenue SW, Suite 300
Calgary, AB T2P 1B5
403-878-1270

Eng. Stamp
Sceau de l'ingénieur

Public Works and Government Services Canada	Travaux publics et Services gouvernementaux Canada
Client Services Team Southern Alberta Operations Branch	Le Client Entretient l'Équipe Alberta Méridional Branche d'Opérations

Canada

Client/client	Parks Canada Agence Canada	L'Agence Parcs Canada
	Western and Northern Region	Ouest et Nord du Canada

Project title/Titre du projet


Staff Housing Phase 2 Waterton Lakes National Park

Drawing title/Titre du dessin

SECTIONS & DETAILS


Surveyed by/Arpenté par AD	Drawn by/Dessiné par AD	Date/Date 12/02/16
Designed by/Concept par KL	Reviewed by/Revisé par IW	Scale/Echelle 1 : 10
PWGSC Project Manager/Administrateur de Projets TPSGC Randy Boldt		
Client Acceptance/Acceptation du client		Approved by/Approuvé par
Park Responsible Officer/Agent Responsable		PWGSC Project Manager/Administrateur de Projets TPSGC
Project No./No. du projet C015-0870	Asset No./No. du bien Fil # 945	Sheet No./ No. de la feuille S421
Drawing Reference No./No. de référence du dessin		

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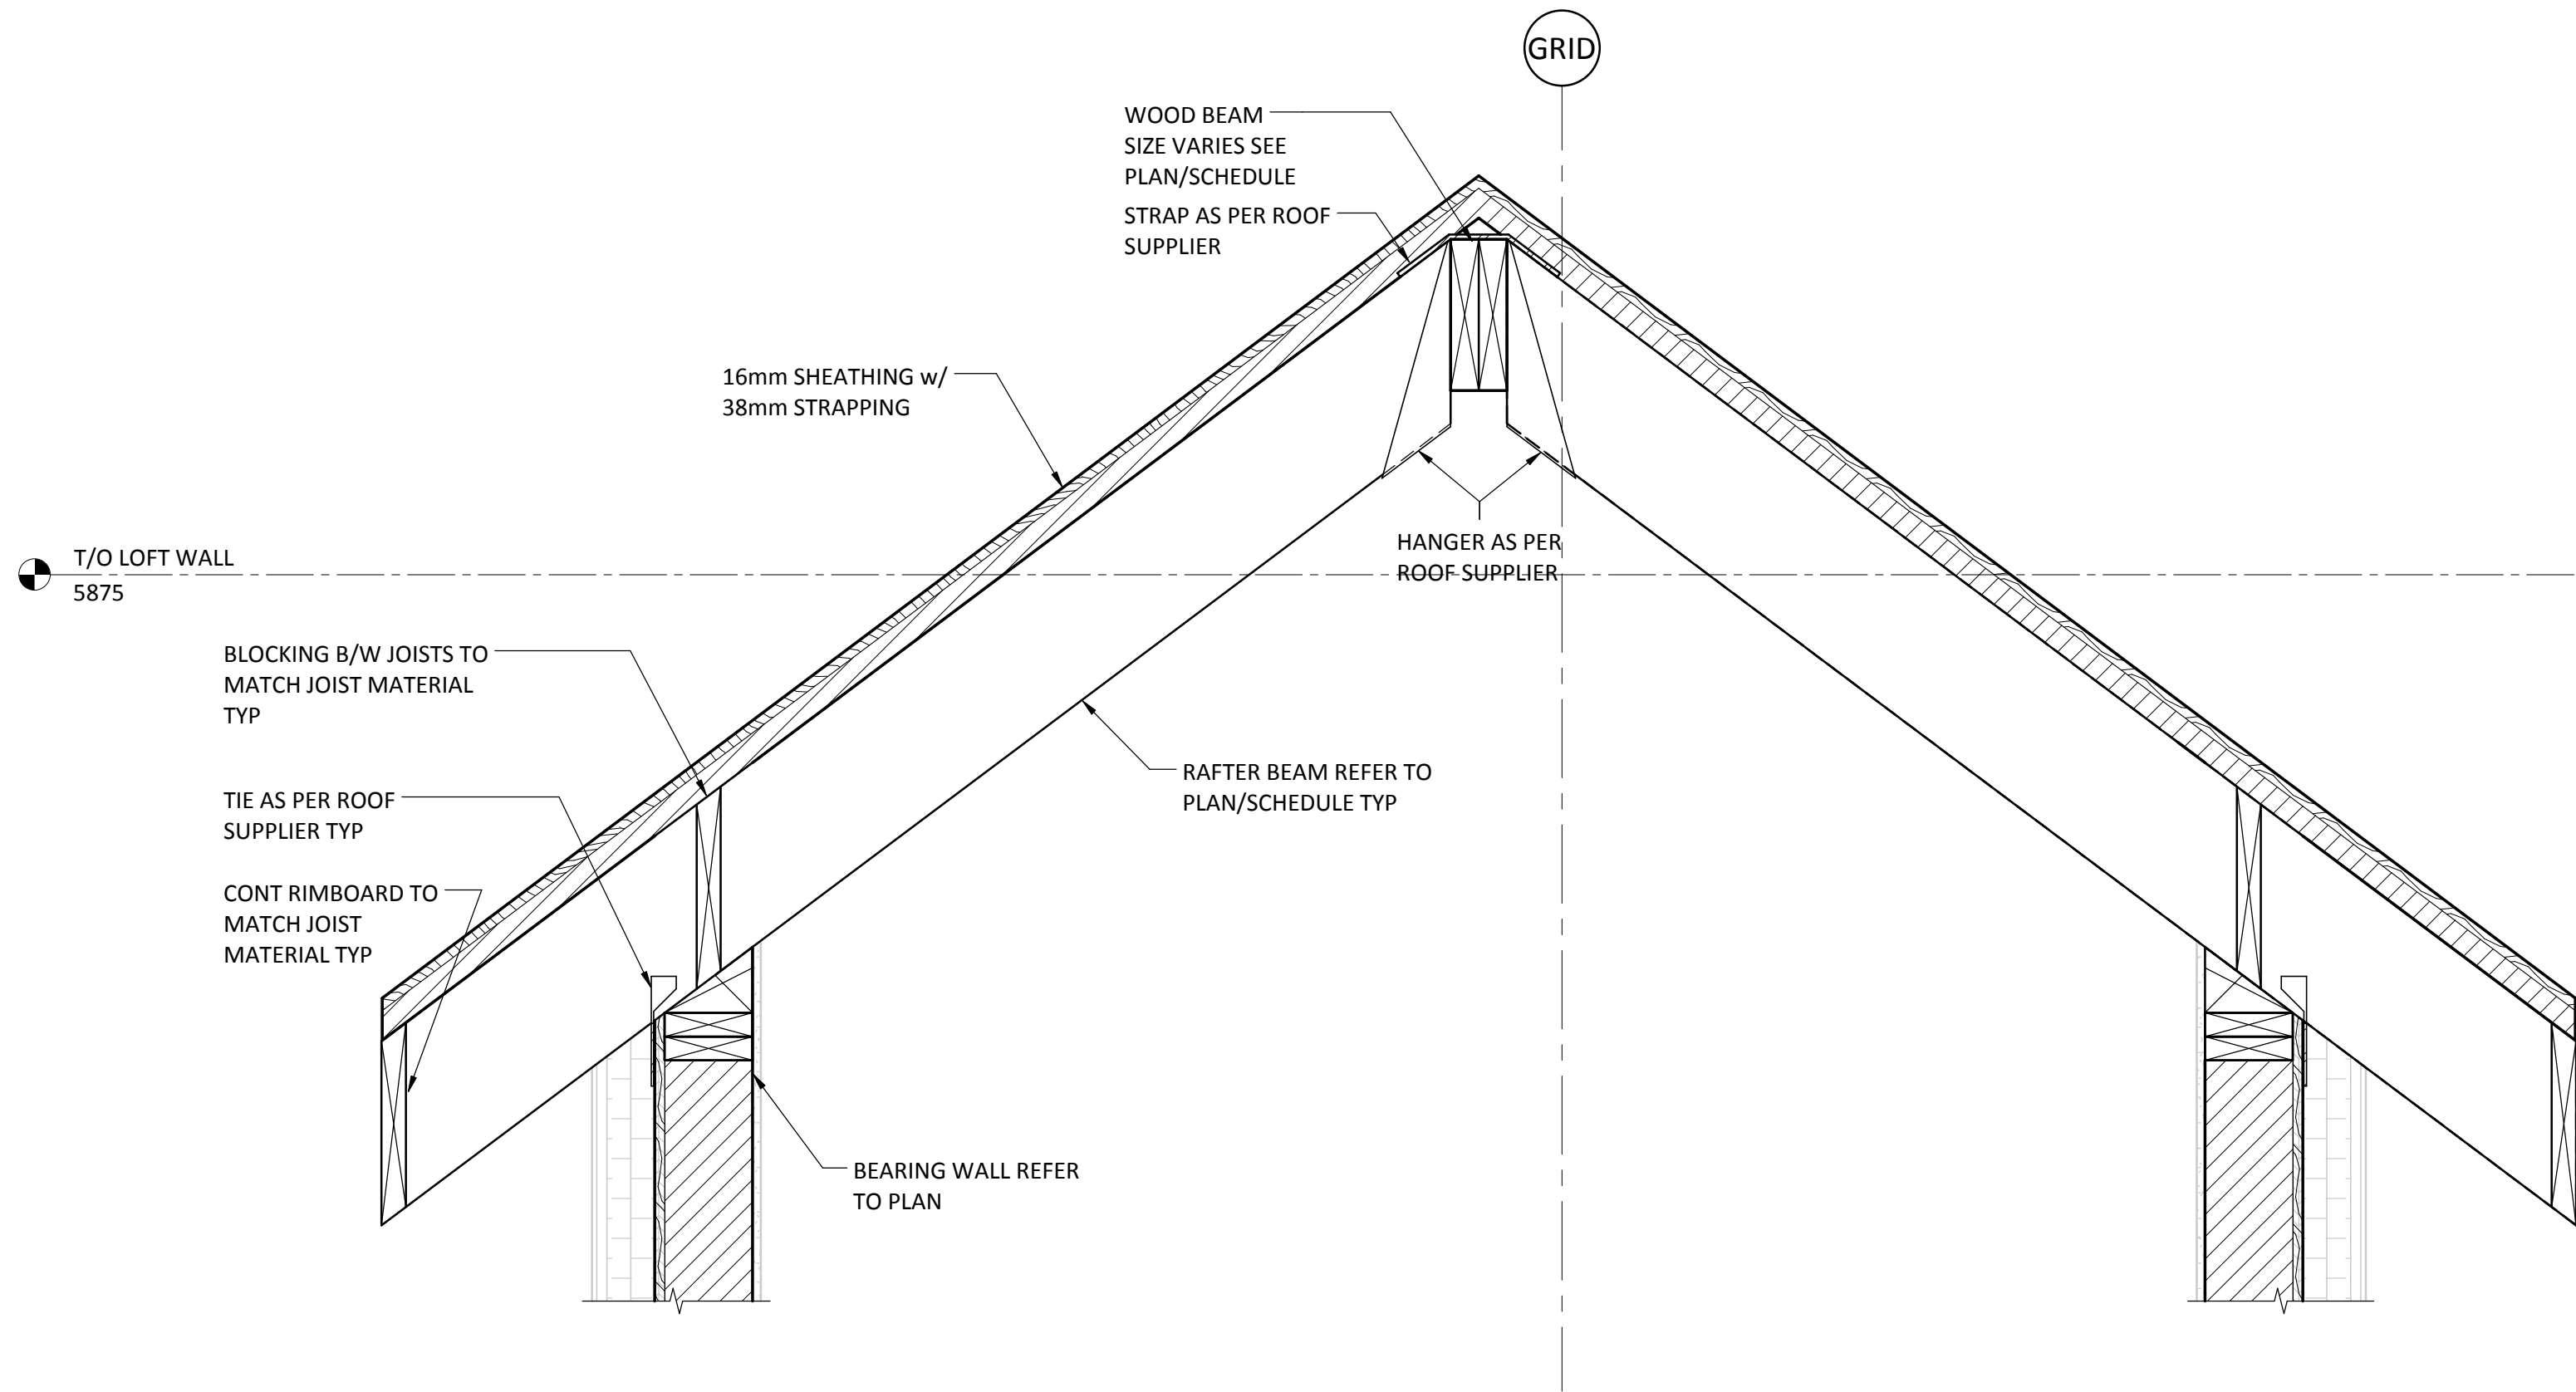


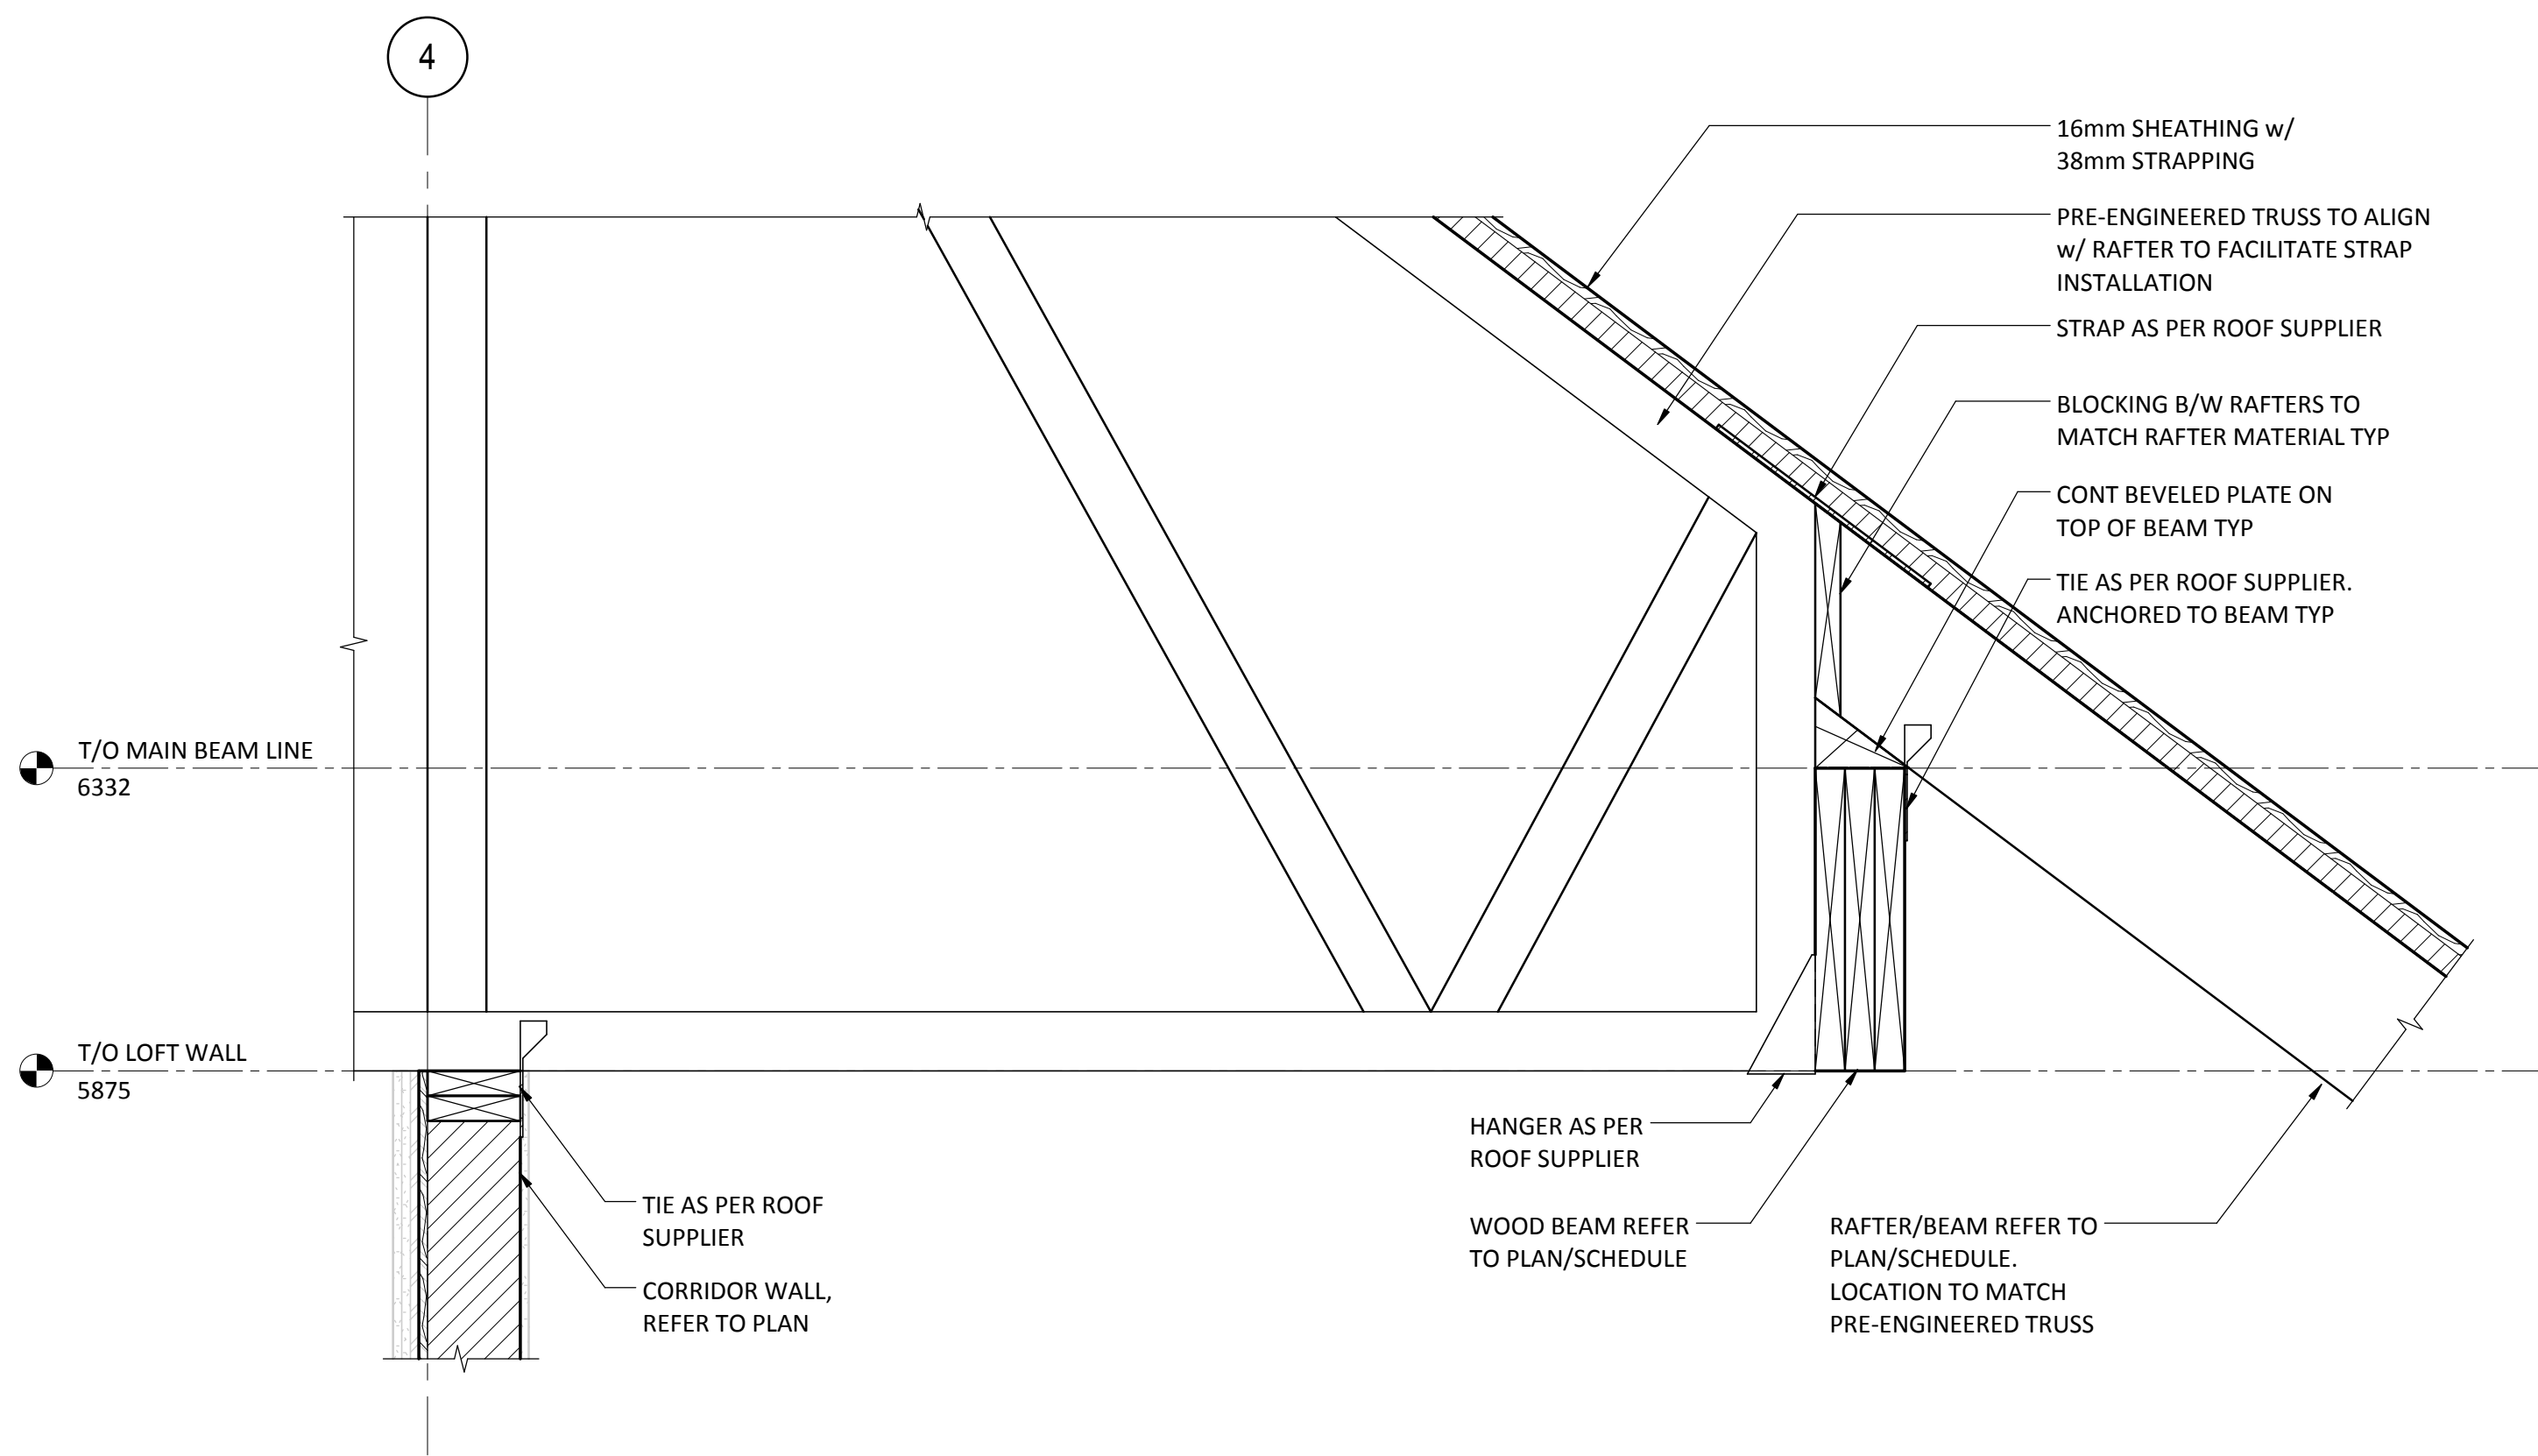1
S430
1:10
TYPICAL MAIN BEAM LINE FRAMING


NOTE: TRUSS DESIGNER TO COORDINATE WITH MECHANICAL FOR DUCTWORK TO AVOID CONFLICT WITH TRUSS CHORDS/MEMBERS TYP.

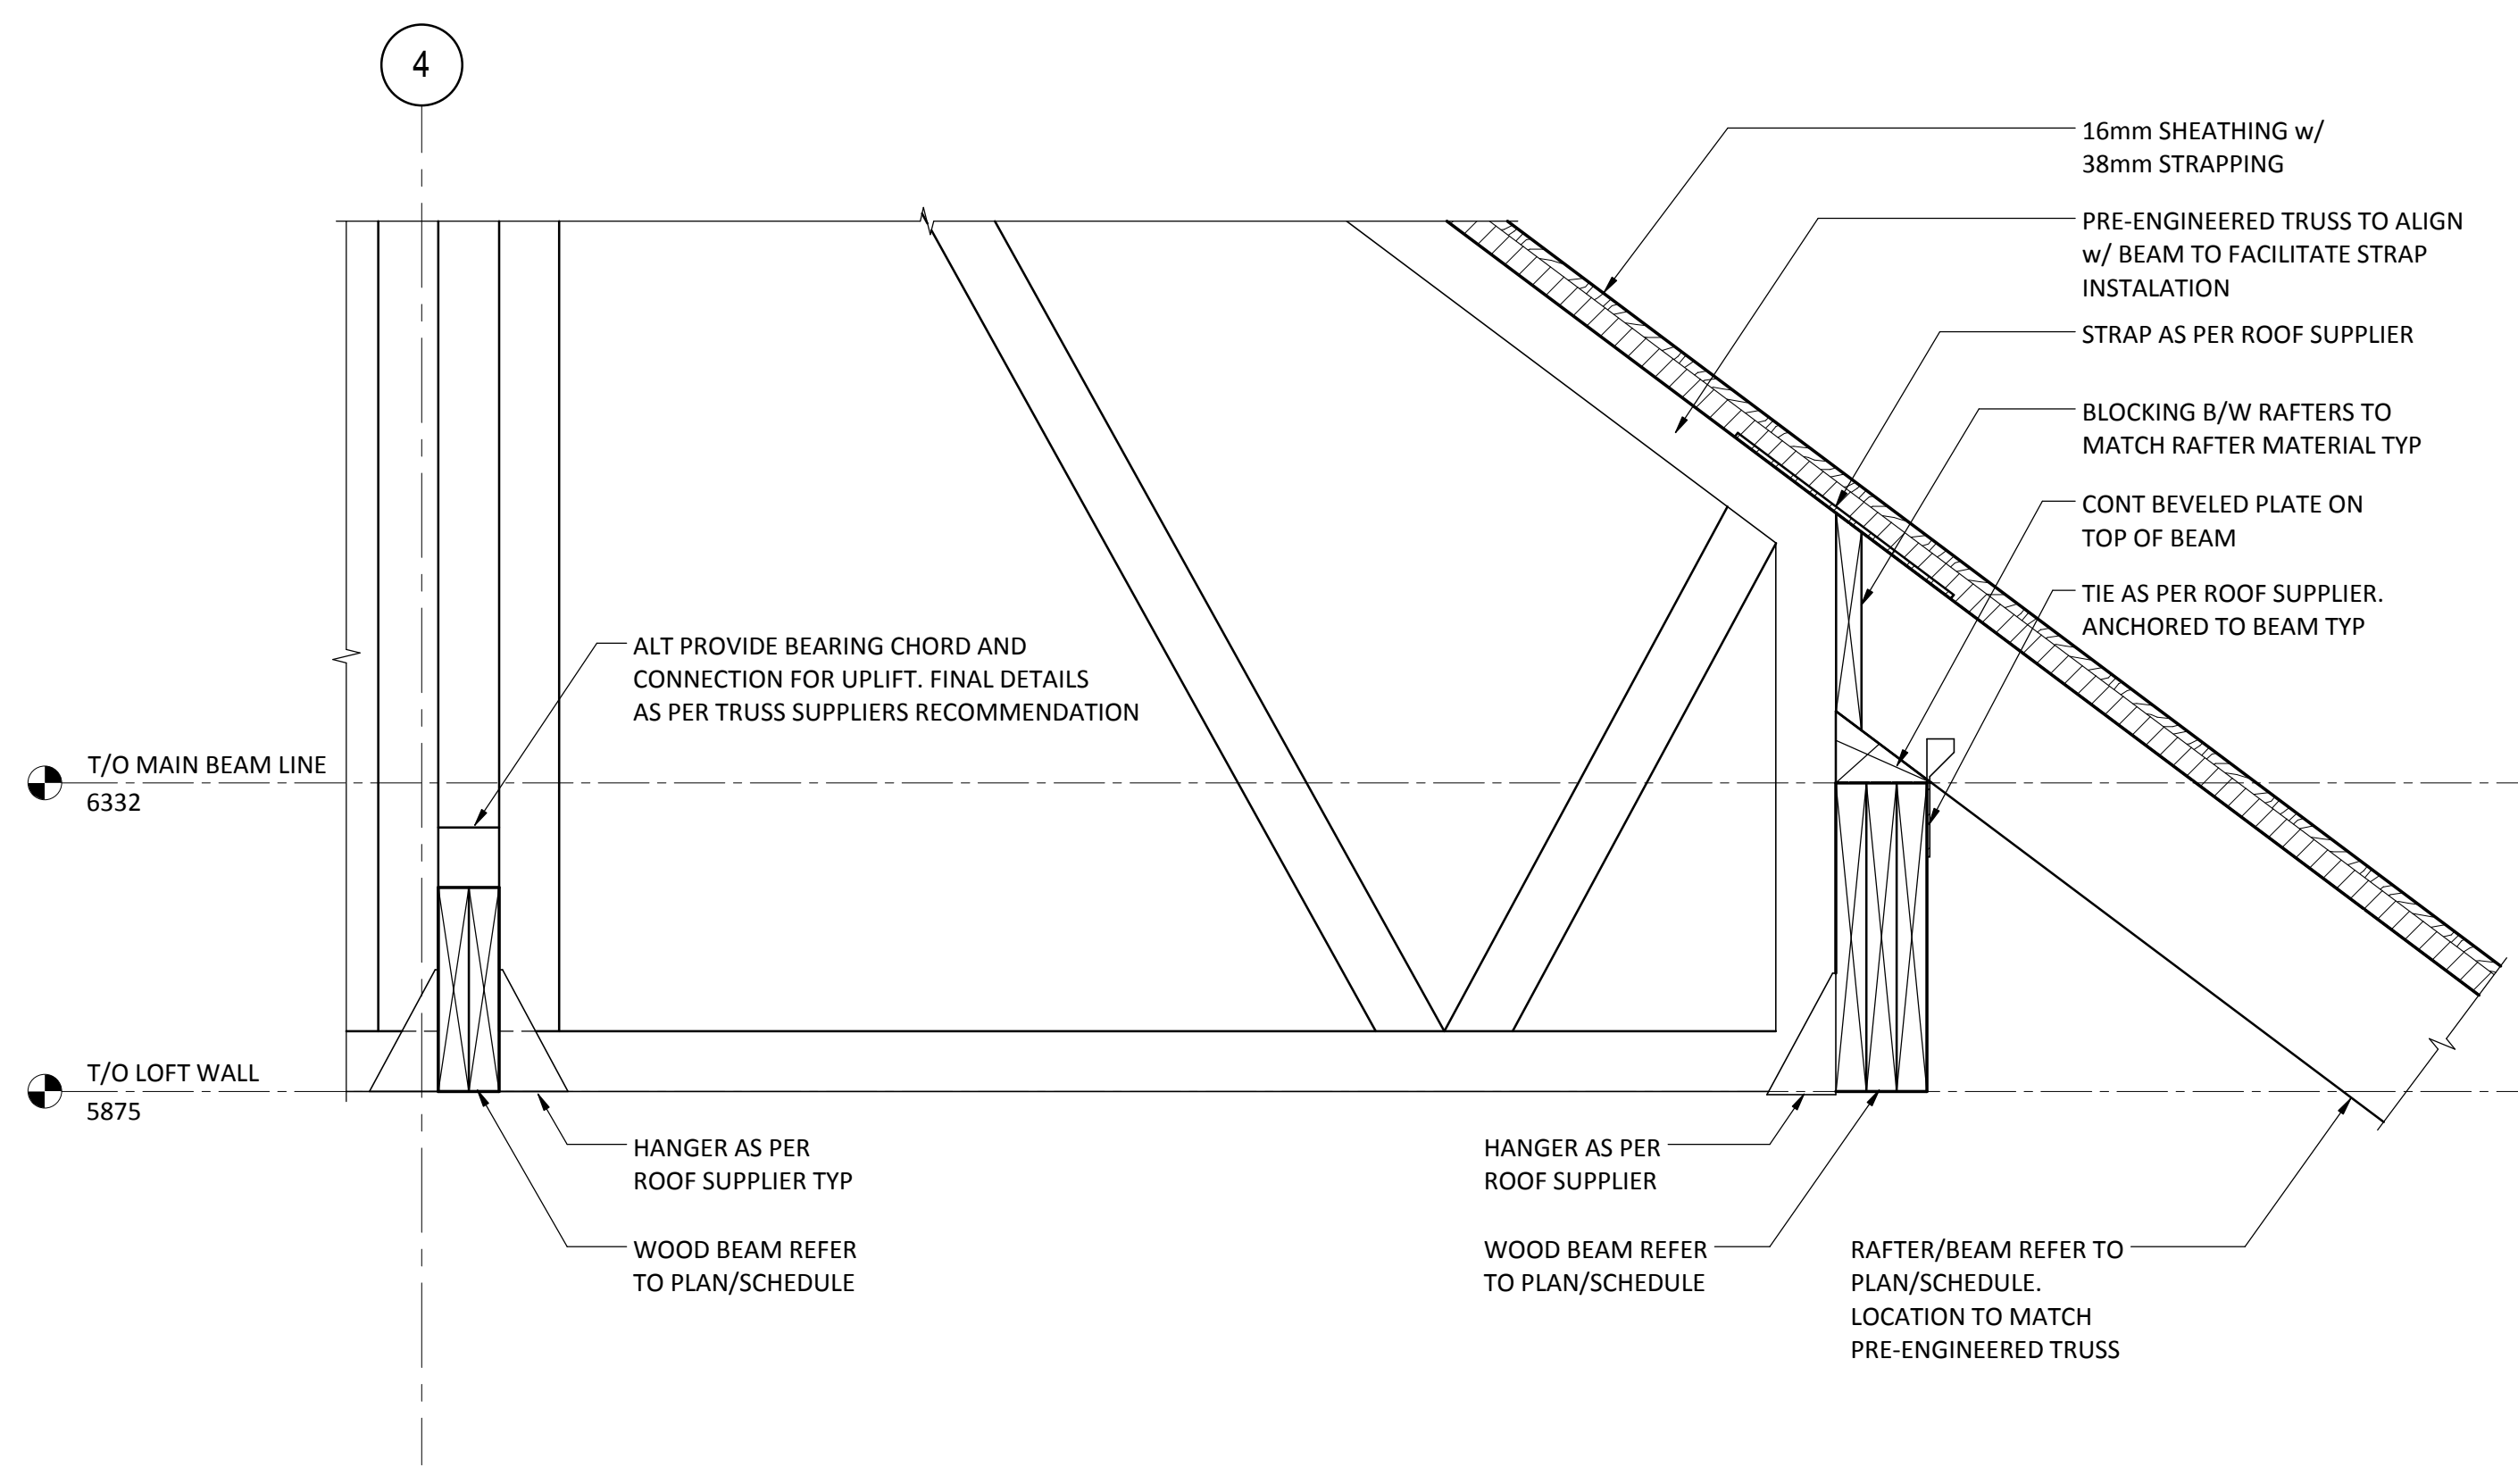


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S430
1:10
TYPICAL MAIN BEAM LINE FRAMING




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S430
1:10
TYPICAL DORMER FRAMING

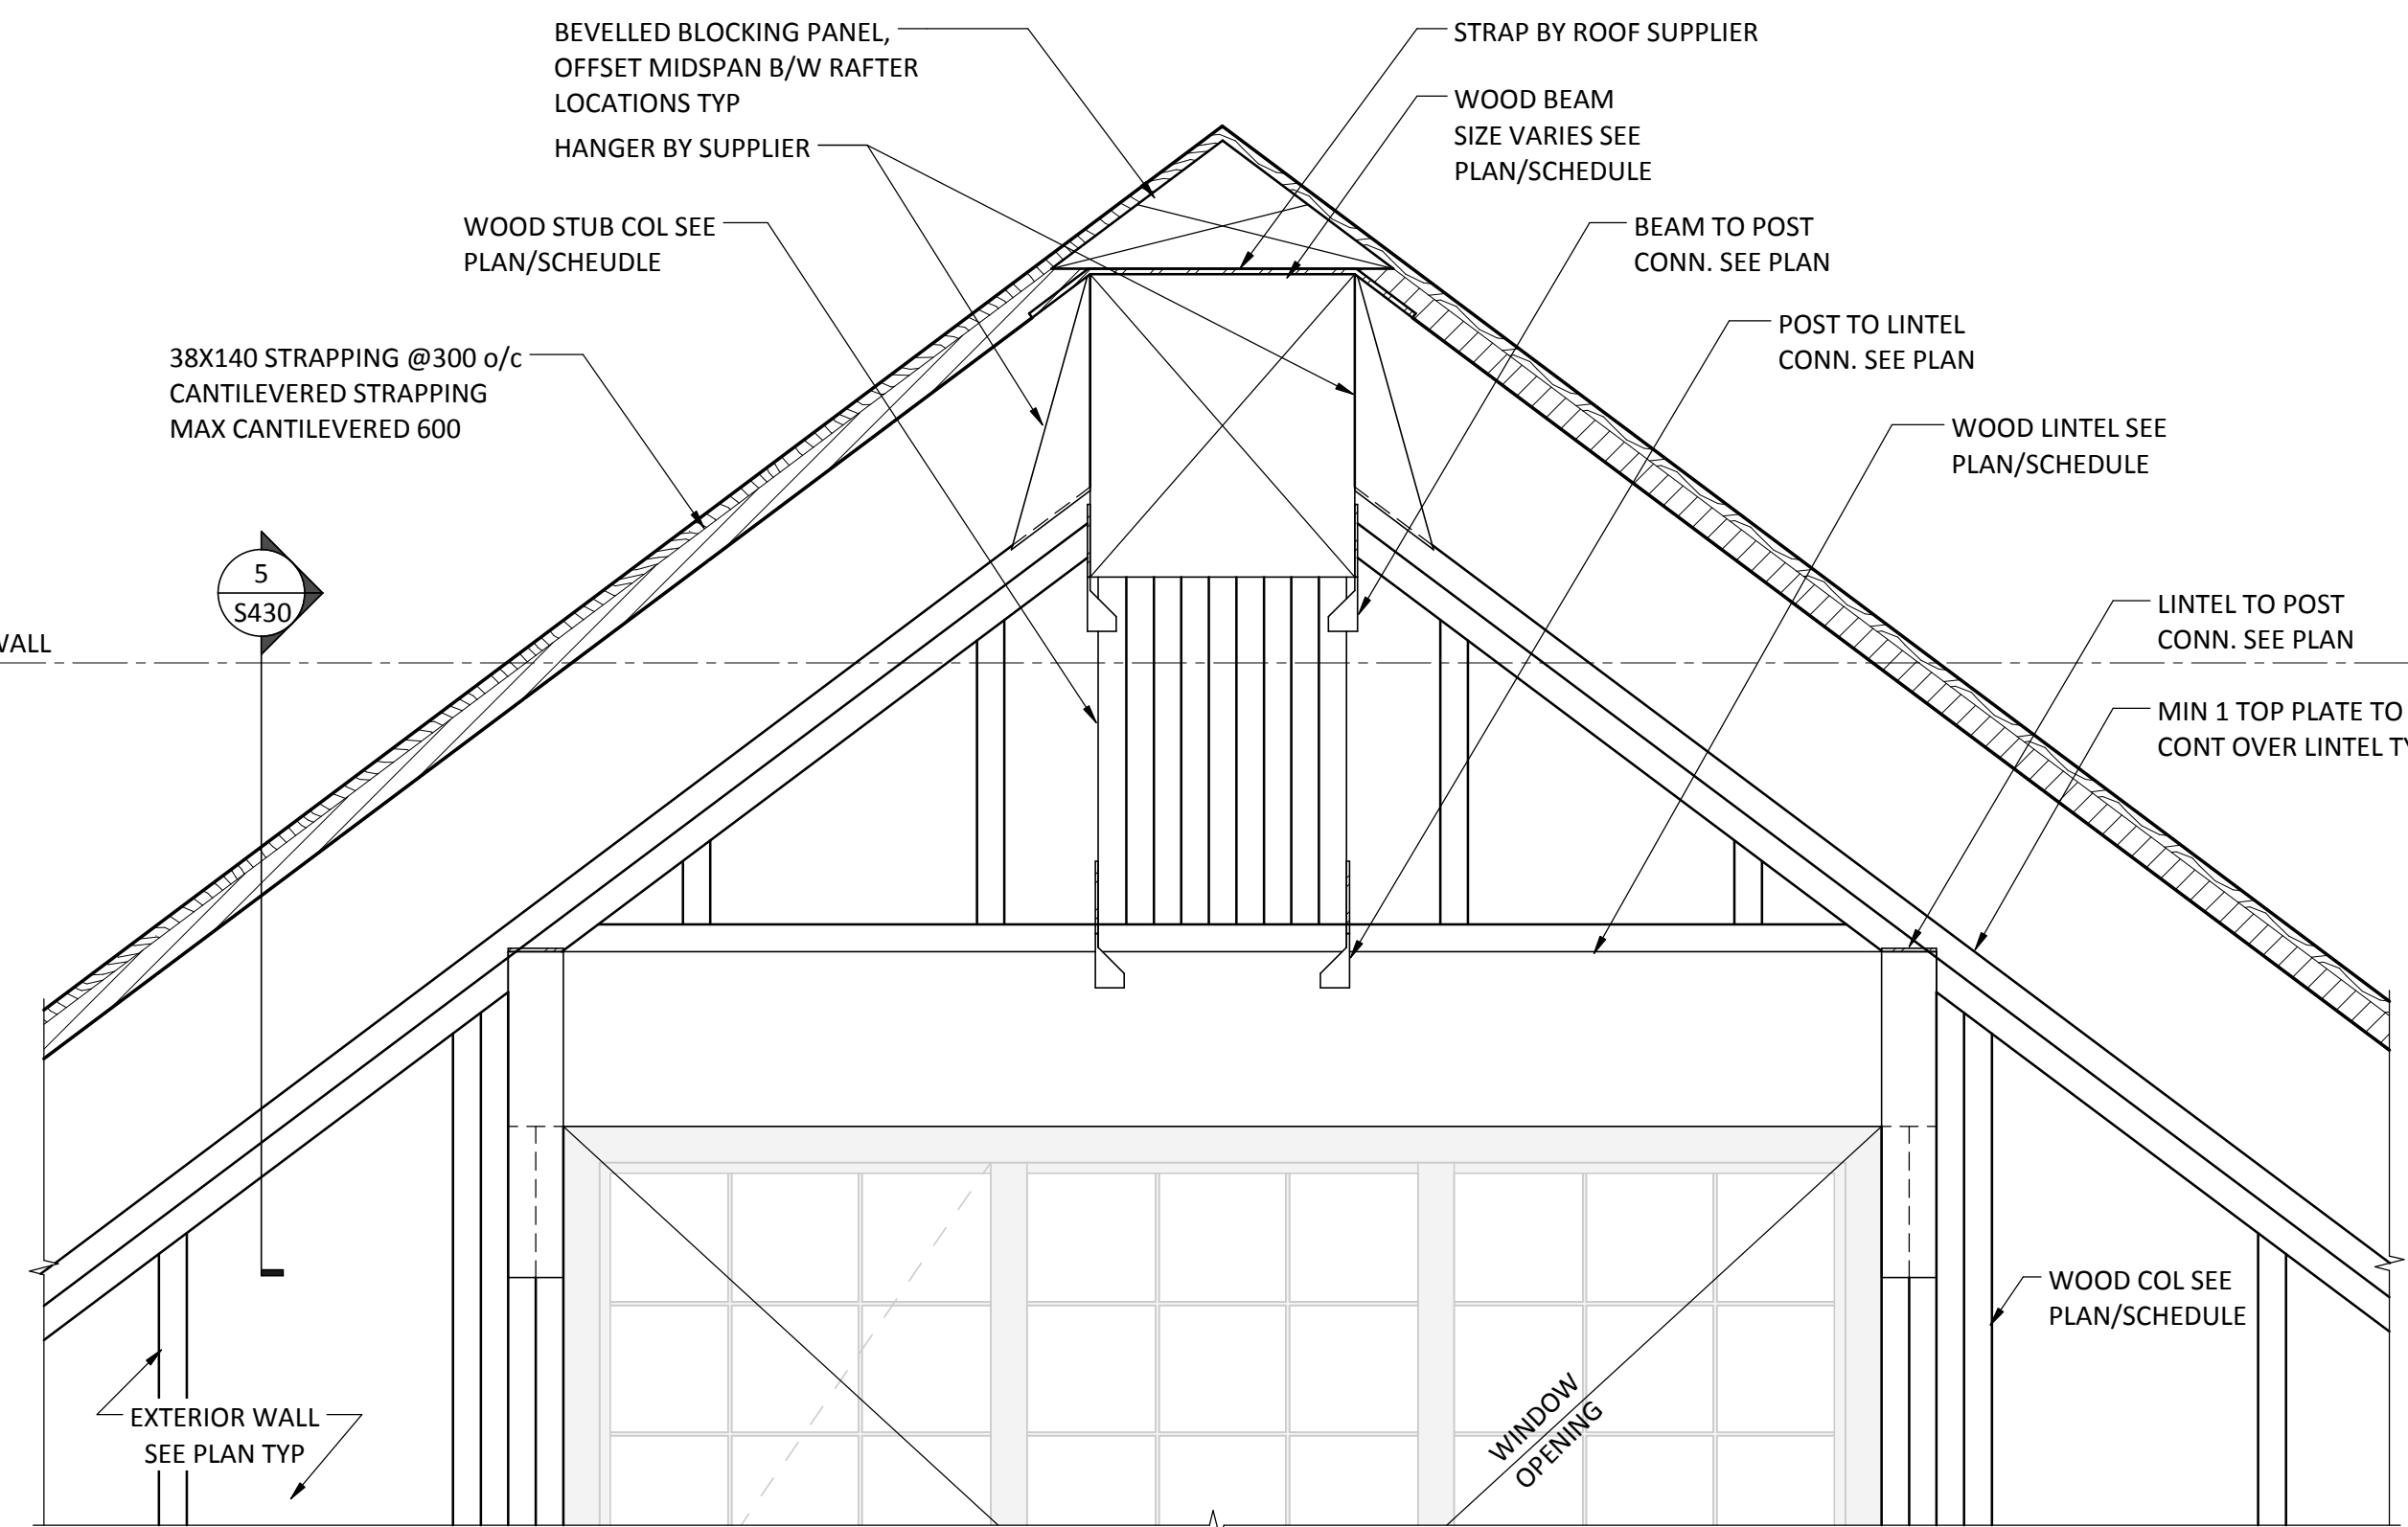


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S430
1:10
TYPICAL LINTEL WINDOW ELEVATION

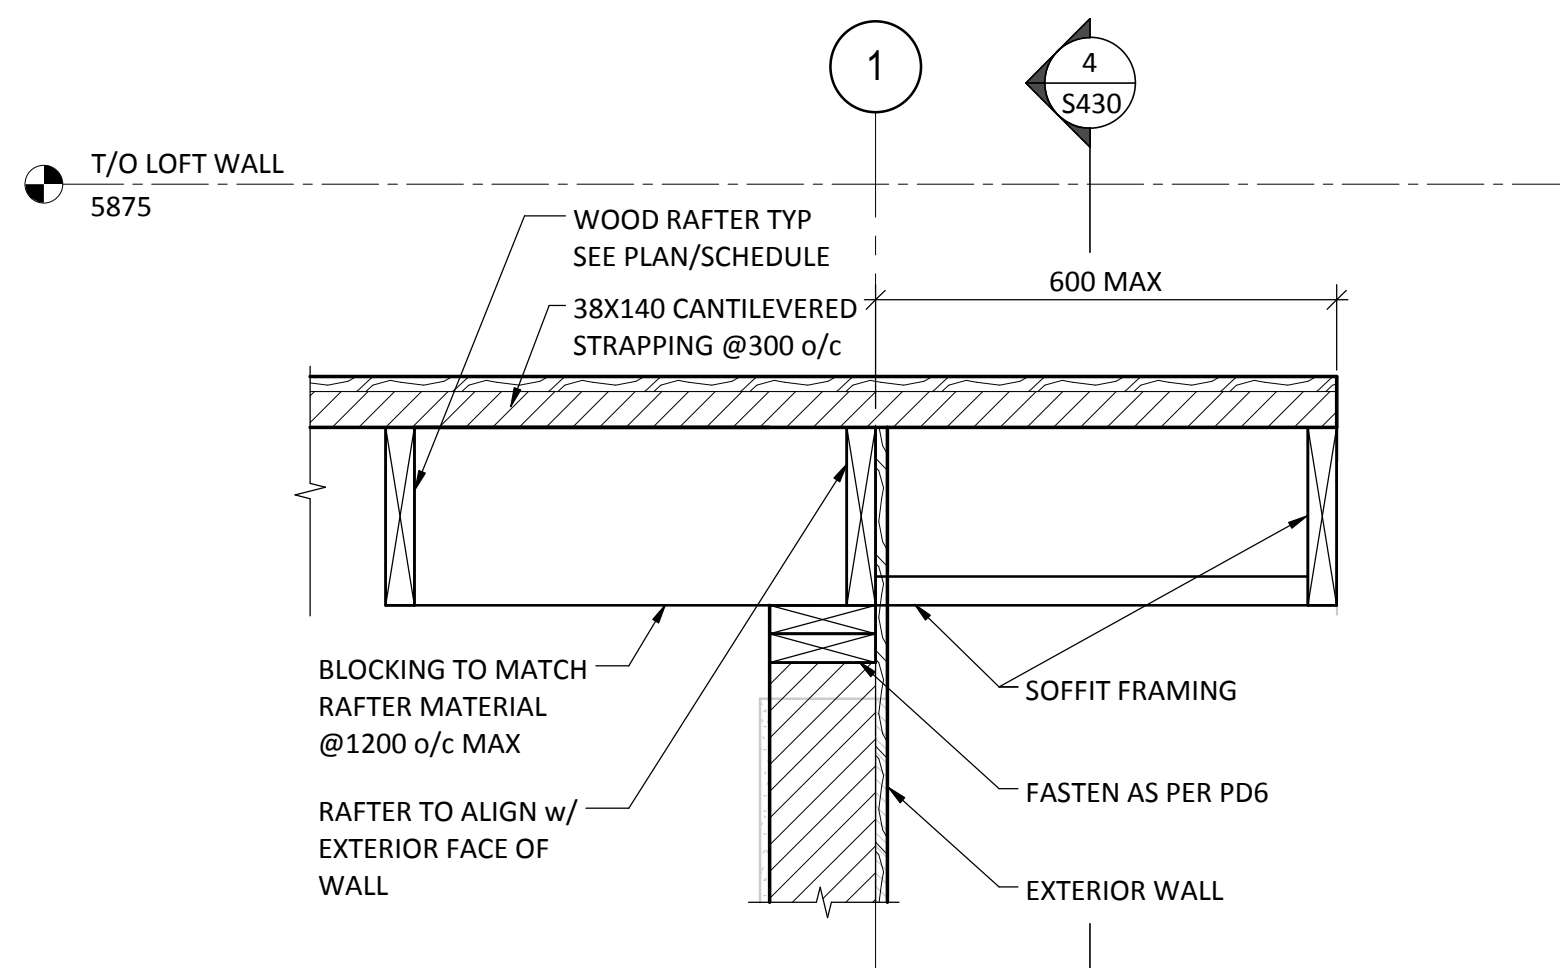


5
S430
1:10

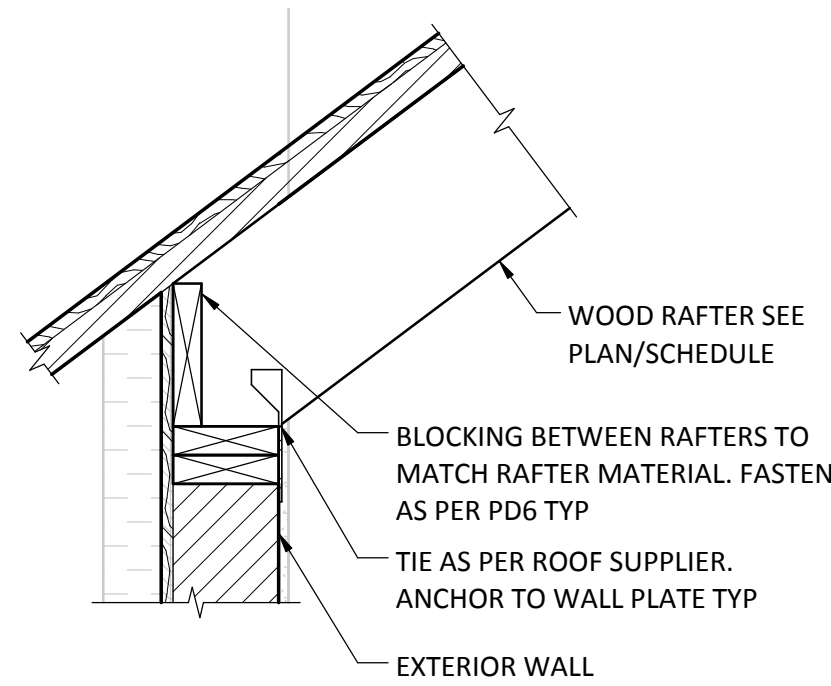


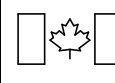
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S430
1:10
TYPICAL EXTERIOR WALL DETAIL @ CATHEDRAL CEILING


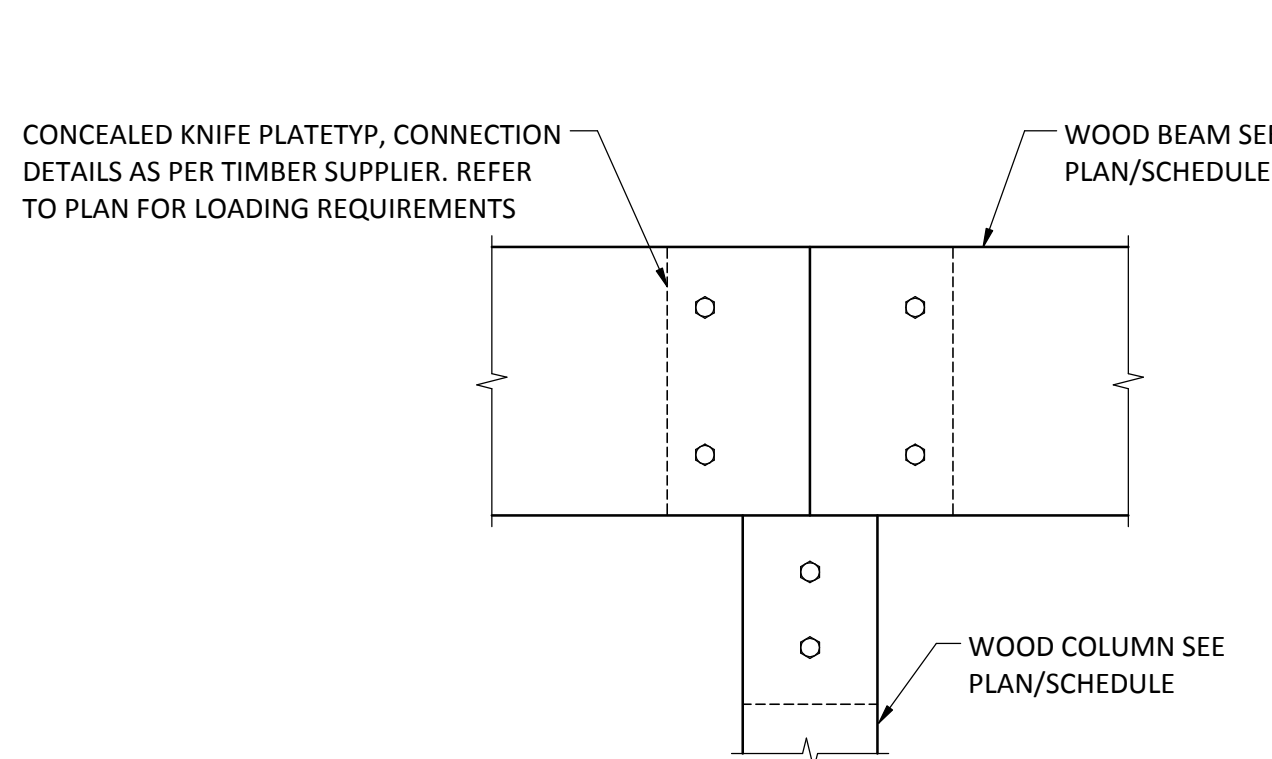



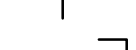


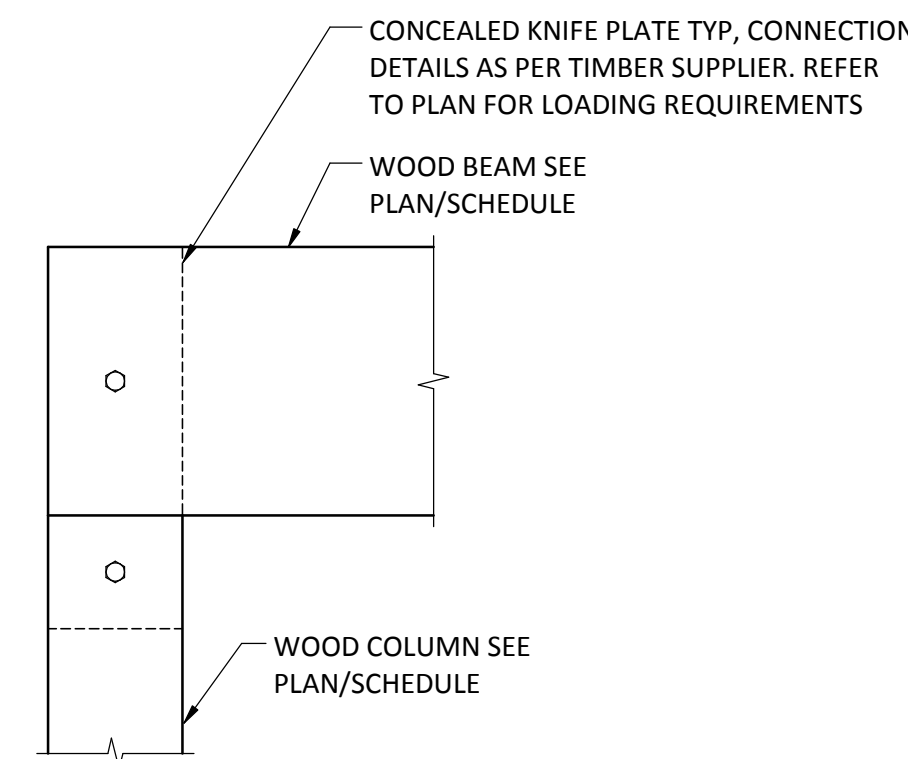



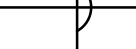
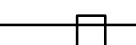

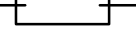

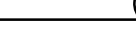
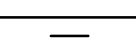





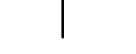


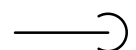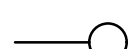


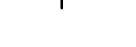



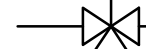
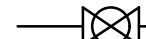
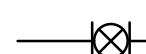

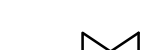




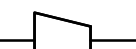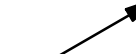


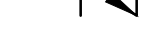
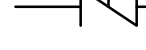


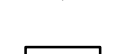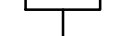




















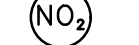

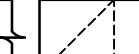
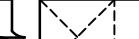



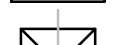



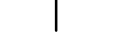








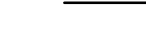
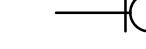
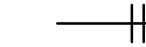





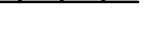

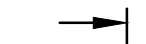
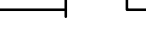

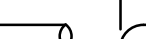
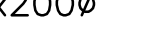
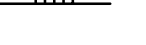





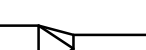


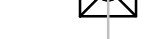

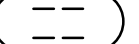
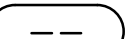
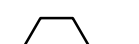





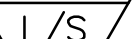




7
S430
1:10
TIMBER CONNECTION DETAILS

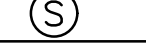


NOTE: CONNECTION DETAILS SHOWN HERE ARE SCHEMATIC ONLY. FINAL CONNECTION DESIGN TO RESIST FORCES INDICATED AS PER TIMBER ENGINEERS RECOMMENDATION

5	2016-12-08	ISSUED FOR TENDER	AD	IW
4	2016-12-08	ISSUED FOR BUILDING PERMIT	AD	IW
3	2016-09-02	ISSUED FOR 99%	AD	IW
No.	Date/Date	Description/Description	Drawn by Dessiné par	Approved Approuvé
Revision / Revision				
A detail number numero de detail				
B source drawing no. de dessin no.				
C detail on drawing no. detail sur dessin no.				
Consultant's Name Nom de l'expert-conseil			Eng. Stamp Sceau de l'ingénieur	
ENTUITIVE				
209 - 8th Avenue SW, Suite 300 Calgary, AB T2P 1B5 403-878-1270				
 Public Works and Government Services Canada			Travaux publics et Services gouvernementaux Canada	
Client Services Team Southern Alberta Operations Branch			Le Client Entretien l'Équipe Alberta Méridional Branche d'Opérations	
Canada				
Client/client			Parks Canada Agence	
			L'Agence Parcs Canada	
Western and Northern Region			Ouest et Nord du Canada	
Project title/Titre du projet				
Staff Housing Phase 2 Waterton Lakes National Park				
Drawing title/Titre du dessin				
SECTIONS & DETAILS				
Surveyed by/Arpenté par	Drawn by/Dessiné par	Date/Date		
KL	AD	12/02/16		
Designed by/Concept par	Reviewed by/Revisé par	Scale/Echelle		
	IW	1:10		
PWGSC Project Manager/Administrateur de Projets TPWGC				
Randy Boldt				
Client Acceptance/Acceptation du client			Approved by/Approuvé par	
Task Responsible/Officier/Agent Responsable			PWGSC Project Manager/Administrateur de Projets TPWGC	
Project No./No. du projet			Asset No./No. du bien	Sheet No./ No. de la feuille
C015-0870			File # 945	S430
Drawing Reference No./No. de référence du dessin				


GENERAL PIPING	GENERAL PIPING (CONT.)	FIRE PROTECTION	VENTILATION FIXTURE
<div><div></div>PIPE DROP</div> <div><div></div>PIPE RISE</div> <div><div></div>BOTTOM TAKE-OFF</div> <div><div></div>TOP TAKE-OFF</div> <div><div></div>TEE CONNECTION</div> <div><div></div>CAP</div> <div><div></div>FLANGED SPOOL PIECE</div> <div><div></div>UNION/FLANGED CONNECTION</div> <div><div></div>RUNNING TRAP</div> <div><div></div>FIXTURE TRAP</div> <div><div></div>DIRECTION OF FLOW</div> <div><div></div>PIPE SIZE</div> <div><div></div>MULTI-PIPE SIZE</div> <div><div></div>EXPANSION JOINT</div> <div><div></div>PRESSURE/TEMP WELL</div> <div><div></div>PIPE BREAK</div> <div><div></div>GUIDE</div> <div><div></div>ANCHOR</div> <div><div></div>CONCENTRIC REDUCER</div> <div><div></div>ECCENTRIC REDUCER</div> <div><div></div>SANITARY VENT</div> <div><div></div>TEMPERATURE SENSOR</div> <div><div></div>PRESSURE SENSOR</div> <div><div></div>DIFFERENTIAL PRESSURE SENSOR</div> <div><div></div>PRESSURE GAUGE WITH SHUTOFF COCK</div> <div><div></div>FLOW SWITCH</div> <div><div></div>SENSOR AVERAGING PROBE</div> <div><div></div>AIR SEPARATOR</div> <div><div></div>AIR SCOOP</div> <div><div></div>BACK FLOW PREVENTER</div> <div><div></div>BLOW OFF STRAINER</div> <div><div></div>STRAINER</div> <div><div></div>AUTOMATIC AIR VENT</div>	<div><div></div>2 WAY CONTROL VALVE</div> <div><div></div>3 WAY CONTROL VALVE</div> <div><div></div>BALANCING VALVE</div> <div><div></div>CIRCUIT BALANCING VALVE</div> <div><div></div>PLUG VALVE</div> <div><div></div>ISOLATION VALVE</div> <div><div></div>PRESSURE REDUCING VALVE</div> <div><div></div>RELIEF OR SAFETY VALVE</div> <div><div></div>SOLENOID VALVE</div> <div><div></div>DIFFERENTIAL PRESSURE VALVE</div> <div><div></div>SUPERVISED VALVE</div> <div><div></div>STEAM TRAPS</div> <div><div></div>SWING GATE CHECK VALVE</div> <div><div></div>TRIPLE DUTY VALVE</div> <div><div></div>SUCTION GUIDE</div>	<div><div></div>FIRE EXTINGUISHER</div> <div><div></div>FIRE EXTINGUISHER C/W SEMI RECESSED CABINET</div> <div><div></div>FIRE EXTINGUISHER C/W SURFACE MOUNT CABINET</div> <div><div></div>FIRE HOSE CABINET</div> <div><div></div>FIRE DEPARTMENT SIAMESE CONNECTION</div> <div><div></div>UPRIGHT SPRINKLER</div> <div><div></div>PENDANT SPRINKLER</div> <div><div></div>CONCEALED SPRINKLER</div> <div><div></div>SIDEWALL HEAD SPRINKLER</div> <div><div></div>SIDEWALL HEAD DRY SPRINKLER</div>	<div><div></div>CEILING FAN</div> <div><div></div>FAN</div> <div><div></div>SIDE WALL FAN</div> <div><div></div>FREEZE-STAT</div> <div><div></div>DIFFERENTIAL PRESSURE SENSOR</div> <div><div></div>THERMOSTAT</div> <div><div></div>THERMOSTAT C/W LOCKABLE COVER</div> <div><div></div>THERMOSTAT C/W REMOTE TEMPERATURE SENSOR</div> <div><div></div>HUMIDISTAT</div> <div><div></div>CARBON MONOXIDE SENSOR</div> <div><div></div>CARBON DIOXIDE SENSOR</div> <div><div></div>NITROGEN DIOXIDE SENSOR</div> <div><div></div>SUPPLY AIR DUCT (UP & DOWN)</div> <div><div></div>RETURN AIR DUCT (UP & DOWN)</div> <div><div></div>EXHAUST AIR DUCT (UP & DOWN)</div> <div><div></div>OUTSIDE OR COMBUSTION AIR (UP & DOWN)</div> <div><div></div>RETURN GRILLE</div> <div><div></div>EXHAUST GRILLE</div> <div><div></div>SUPPLY DIFFUSER</div> <div><div></div>ROUND DUCT RISER</div> <div><div></div>ROUND DUCT DROP</div> <div><div></div>BALANCING DAMPER</div> <div><div></div>FIRE DAMPER</div> <div><div></div>SMOKE DAMPER</div> <div><div></div>COMBINATION FIRE/SMOKE DAMPER</div> <div><div></div>MOTORIZED DAMPER</div>
	PLUMBING FIXTURE	VENTILATION DUCT WORK	
	<div><div></div>THERMOMETER</div> <div><div></div>METER</div> <div><div></div>FLOOR DRAIN</div> <div><div></div>HUB DRAIN</div> <div><div></div>ROOF DRAIN</div> <div><div></div>PUMP</div> <div><div></div>CLEAN-OUT</div> <div><div></div>IN FLOOR CLEANOUT</div> <div><div></div>HOSE BIBB</div> <div><div></div>SIGHT GLASS</div> <div><div></div>MICRON FILTER</div> <div><div></div>EMERGENCY EYEWASH</div> <div><div></div>CHEMICAL POT FEEDER</div> <div><div></div>RADIANT PANEL</div> <div><div></div>RADIANT CABINET</div>	<div><div></div>THERMAL LINING (INSULATION)</div> <div><div></div>ACOUSTICAL LINING (INSULATION)</div> <div><div></div>RECTANGULAR DUCT</div> <div><div></div>ROUND DUCT</div> <div><div></div>FLAT OVAL DUCT</div> <div><div></div>FLEXIBLE DUCT CONNECTION</div> <div><div></div>BRAIDED FLEXIBLE PIPE CONNECTOR</div> <div><div></div>DOUBLE SPHERE RUBBER PIPE CONNECTOR</div> <div><div></div>VARIABLE VOLUME TERMINAL UNIT</div> <div><div></div>TRANSITION</div> <div><div></div>RECTANGULAR TO ROUND TRANSITION</div> <div><div></div>TURNING VANES</div> <div><div></div>SMOKE DETECTORS</div> <div><div></div>DUCT REHEAT COIL</div> <div><div></div>RELIEF VENT</div> <div><div></div>CHIMNEY</div> <div><div></div>INDICATES DIRECTION OF AIR FLOW</div> <div><div></div>AIR FLOW MEASURING STATION</div>	
			TAGS
			<div><div></div>FIXTURE AND EQUIPMENT TAG</div> <div><div></div>EMCS POINT IDENTIFICATION TAG</div> <div><div></div>KEY NOTES</div> <div><div></div>REVISION No.</div> <div><div></div>RADIATION TAG TYPE</div> <div><div></div>FIN LENGTH (mm) CAPACITY (kW)</div> <div><div></div>AIR GRILL TAG</div> <div><div></div>S - SUPPLY</div> <div><div></div>R - RETURN</div> <div><div></div>E - EXHAUST</div> <div><div></div>T - TRANSFER</div>

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- GENERAL NOTES:**
- FOR FINAL BUILDING LOCATION, DIMENSIONS, AND PARKING LAYOUT, REFER TO LATEST ARCHITECTURAL DRAWINGS.
 - PRIOR TO COMMENCING INSTALLATION WITHIN THE BUILDING, VERIFY THE LOCATION AND INVERT ELEVATIONS OF ALL SERVICE LINES WITH AUTHORITIES HAVING JURISDICTION TO ENSURE SERVICES CAN BE INSTALLED AS SHOWN.
 - DEPTH OF BURY FOR ALL WATER MAINS SHALL NOT BE LESS THAN 3.0M TO TOP OF PIPE UNLESS NOTED OTHERWISE.
 - ALL CROSS CONNECTIONS MUST BE EITHER ELIMINATED OR PROTECTED AGAINST BACKFLOW BY THE INSTALLATION OF A CROSS CONNECTION CONTROL DEVICE. ALL CROSS CONNECTION CONTROL DEVICES MUST BE INSTALLED IN ACCORDANCE WITH THE WATER UTILITY BY-LAW 22M82 AND THE NATIONAL PLUMBING CODE OF CANADA.
 - ALL ELEVATIONS ARE REFERENCED TO 1200m DATUM.
 - MECHANICAL CONTRACTOR IS RESPONSIBLE FOR ALL SERVICES TO 1.0M BEYOND THE BUILDING. COORDINATE SERVICE LOCATIONS AND ELEVATIONS WITH CIVIL CONTRACTOR.
 - REFER TO CIVIL DRAWINGS FOR SITE SERVICING AND GRADING DETAILS.

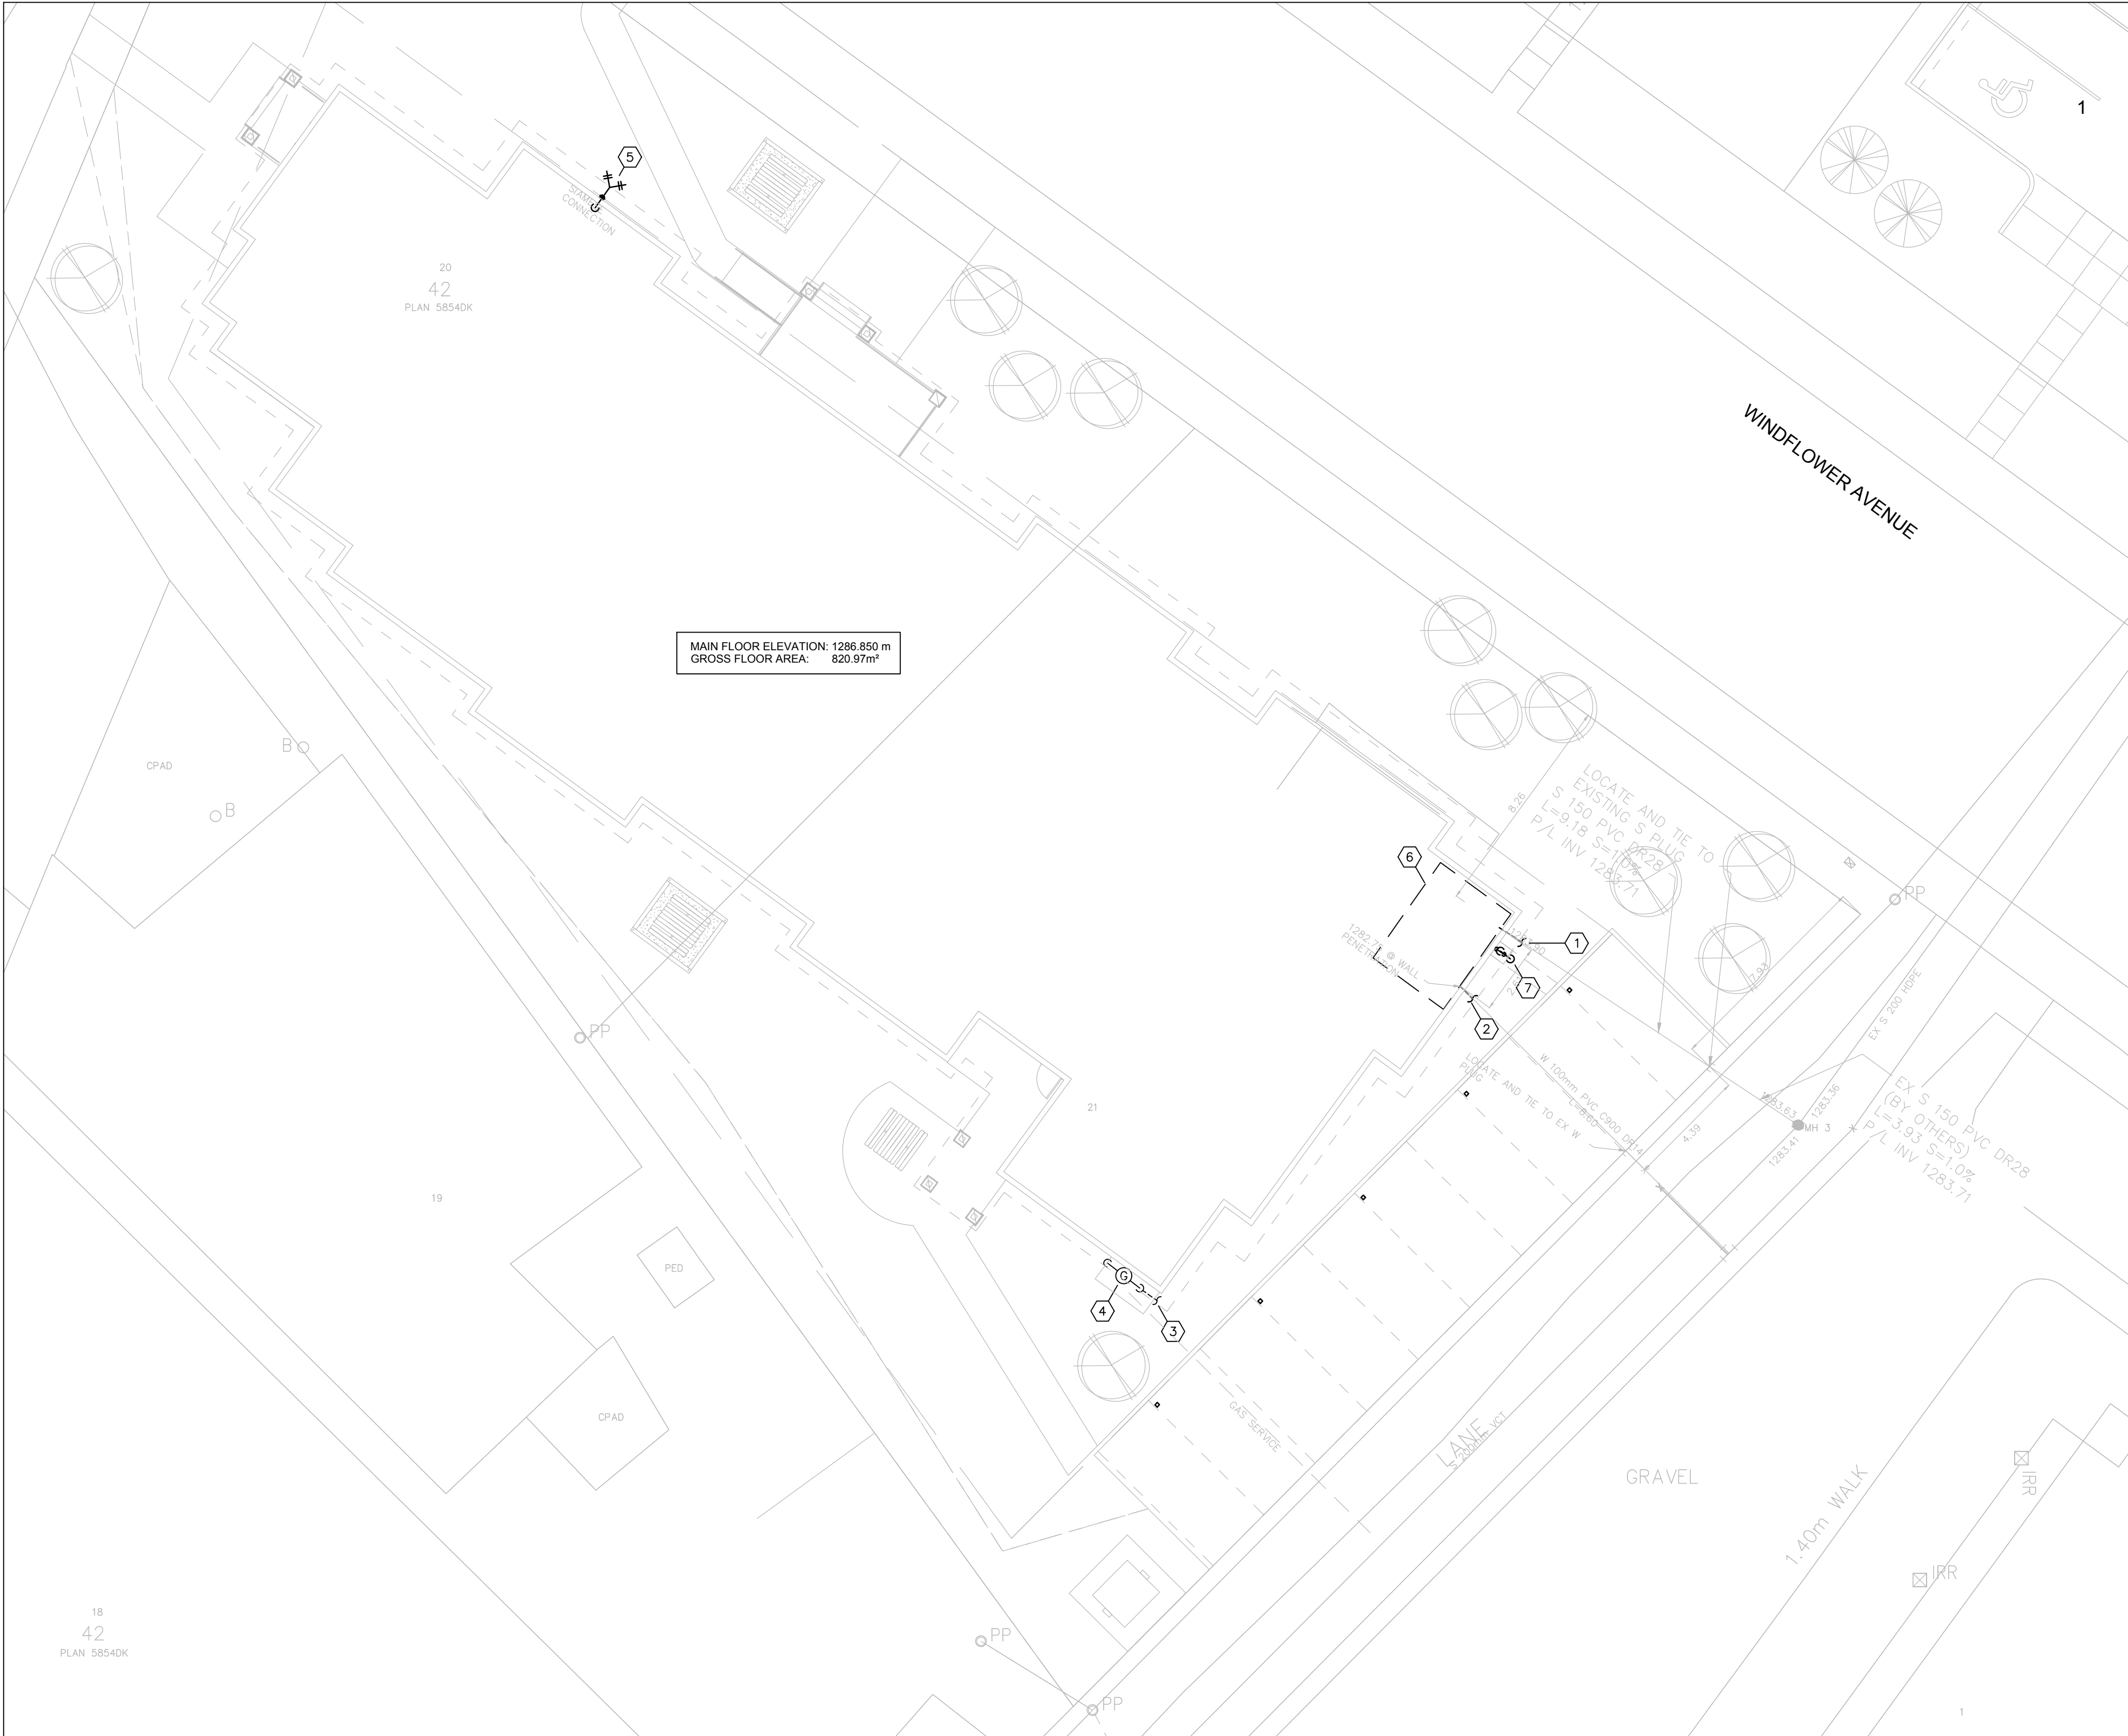

GAS SCHEDULE:

EQUIPMENT	INPUT	
	MBH	KW
DOMESTIC WATER HEATER (DWH-1)	150	44.0
DOMESTIC WATER HEATER (DWH-2)	150	44.0
BOILER (B-1)	999	292.7
BOILER (B-2)	999	292.7
TOTAL:	2298	673.3
GAS METER OUTLET PRESSURE - 14 kPa (2 psi)		
MINIMUM DISTANCE BETWEEN GAS LINE AND UNDERGROUND SERVICES - 6'-6" (2000mm)		

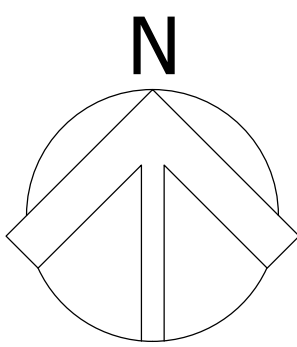PRIOR TO COMMENCING INSTALLATION WITHIN THE BUILDING, VERIFY THE LOCATION AND INVERT ELEVATIONS OF SERVICE LINES INCLUDING SANITARY SEWER, STORM SEWER, WATER MAINS, AND GAS MAINS WITH AUTHORITIES HAVING JURISDICTION TO ENSURE SERVICES CAN BE INSTALLED AS SHOWN.

- KEY NOTES:**
- 150mm SANITARY LEAVING BUILDING INVERT=1283.80m.
 - 100mm WATER SERVICE ENTERING BUILDING. REFER TO CIVIL SITE SERVICING PLAN FOR CONTINUATION.
 - INCOMING HIGH PRESSURE GAS SERVICE. REFER TO CIVIL SITE SERVICING PLAN FOR CONTINUATION.
 - GAS METER ASSEMBLY MOUNTED ON CONCRETE PAD. ENSURE CLEARANCE OF MINIMUM 1.0m FROM REGULATOR TO ANY BUILDING OPENING. ENTER BUILDING WITH 14 kPa GAS SERVICE.
 - FIRE DEPARTMENT SIAMESE CONNECTION.
 - OUTLINE OF WATER METER ROOM.
 - 50mm WEEPING TILE DISCHARGE.

100mm INCOMING WATER NOTES:

- THE SPACE ABOVE, 600mm BEHIND, AND THE ACCESS IN FRONT OF THE METER SETTING SHALL BE CLEAR AND FREE OF OBSTRUCTION. 2m HEADROOM MUST BE PROVIDED IN THIS AREA. PROVIDE ADEQUATE PIPE SUPPORT.
- THE BY-PASS, INLET AND OUTLET VALVES SHALL BE A RESILIENT SEATED RISING SPINDLE (OS & Y) FLANGED GATE VALVE, CSA APPROVED.
- THE MASTER CONTROL VALVE SHALL BE ONE OF THE FOLLOWING:
 - RESILIENT SEATED RISING SPINDLE (OS & Y) FLANGED GATE VALVE (UL OR ULC LISTED) FOR FIRE LINES AND CSA APPROVED FOR DOMESTIC LINES.
 - SHORT-BODY, RUBBER SEATED FLANGED OR LUG WATER TYPE BUTTERFLY VALVE C/W HAND WHEEL, REDUCTION GEAR OPERATOR, POSITION INDICATOR (UL OR ULC LISTED) PROVIDED THEY ARE NOT IN A SUCTION LINE FOR FIRE PUMP(S).
- ENTRANCE PIPE MATERIAL THROUGH THE OUTSIDE WALL AND THROUGH THE FLOOR SHALL BE DUCTILE IRON PIPE AWWA C151 (LATEST EDITION) CLASS 52 OR APPROVED EQUAL. BURIED FITTINGS (90° ELBOW) SHALL BE CAST OR DUCTILE IRON CONFORMING TO AWWA C110 (LATEST EDITION) OR APPROVED EQUAL. SERVICE ENTRIES THROUGH THE FLOOR (INCLUDING ANCHOR DETAILS) SHALL BE DESIGNED BY A PROFESSIONAL ENGINEER AND DETAILED ON THE MECHANICAL SITE PLAN. (ANCHOR RODS SHALL BE 18-B STAINLESS STEEL. WHERE A STANDARD 3m LENGTH OF ROD REQUIRES EXTENSION, AN APPROVED STAINLESS HEXAGON NUT COUPLING SHALL BE INSTALLED AT THE UPPER END OF THE ROD).
- WATERWORKS WILL NOT TURN ON WATER UNLESS ANCHOR DETAILS HAVE BEEN INSPECTED BY THE WATERWORKS INSPECTOR PRIOR TO PLACEMENT OF CONCRETE AND/OR BACKFILL.
- AN APPROVED PREMISE ISOLATING CROSS CONNECTION CONTROL DEVICE SHALL BE INSTALLED IMMEDIATELY AFTER THE WATER METER SETTING ON ALL COMMERCIAL, INDUSTRIAL AND MULTI FAMILY RESIDENTIAL (3 UNITS OR MORE) SERVICES.


FOR DOMESTIC SERVICES THAT REQUIRE A 24 HOUR UNINTERRUPTED WATER SUPPLY, A PARALLEL CROSS CONNECTION CONTROL DEVICE ARRANGEMENT (SEE SHEET No. 27) MUST BE INSTALLED TO FACILITATE ANNUAL TESTING AND ROUTINE MAINTENANCE OF THE CROSS CONNECTION CONTROL DEVICE(S).

- BY-PASS IS NOT REQUIRED FOR IRRIGATION METERS. THE BY PASS PIPE SHALL BE THE SAME SIZE AS THE MAIN PIPE.
- THE BY-PASS VALVE SHALL BE INSTALLED ON THE VERTICAL PIPE SECTION AS SHOWN.
- WATER CONNECTIONS (IE DRAIN DOWN VALVE OR HOSE BIBB ETC.) SHALL NOT BE PERMITTED BEFORE THE APPROVED CROSS CONNECTION CONTROL DEVICE. FOR INQUIRY CALL 311.
- AN APPROVED PREMISES-ISOLATING CROSS CONNECTION CONTROL DEVICE SHALL BE INSTALLED IMMEDIATELY AFTER THE WATER METER OUTLET VALVE ON ALL IRRIGATION SERVICES.
- METERS MUST BE INSTALLED IN A METER/MECHANICAL ROOM WITHIN REASONABLE DISTANCE OF A FLOOR DRAIN. METER LOCATIONS MUST BE APPROVED BY WATER RESOURCES.

50mm DOMESTIC WATER METER NOTES:

- PIPING ON EACH SIDE OF METER MUST BE ADEQUATELY SUPPORTED TO THE SATISFACTION OF THE WATERWORKS METER SECTION.
- PIPING FOR METER MUST BE ON A HORIZONTAL PLANE.
- MINIMUM DISTANCE OF 300mm BETWEEN ANY WALL AND A METER OR METER TRIE.
- VALVES ARE REQUIRED ADJACENT TO METERS (INLET AND OUTLET SIDE).
- ALTERNATE ARRANGEMENT OF PIPING AND VALVING MUST HAVE THE APPROVAL OF THE WATERWORKS METER SECTION PRIOR TO INSTALLATION.
- THE AREA FOR 600mm IN FRONT OF THE METER SHALL BE FREE OF OBSTRUCTION TO ALLOW FOR CONVENIENT READING AND SERVICING OF THE METER. 2 METER HEADROOM MUST BE PROVIDED IN THIS AREA.
- METERS MUST BE INSTALLED IN THE MECHANICAL ROOM AND WITHIN REASONABLE DISTANCE OF A FLOOR DRAIN. IN NO CASE SHALL A METER BE INSTALLED IN A BATHROOM, BEDROOM, CRAWL SPACE, GARAGE OR UNDER A STAIRWELL. METER LOCATIONS MUST BE APPROVED BY WATERWORKS.
- METER SPACERS TO BE SUPPLIED BY CITY OF CALGARY (FOR USE WITHIN CITY LIMITS) PHONE 311.
- ALL FITTINGS AND PIPE ARE TO BE BRASS OR SOLDERED COPPER.
- SERVICE VALVES, MAIN VALVES OR ANY OTHER CITY OWNED WATERWORKS APPURTENANCES SHALL BE OPERATED BY WATER SERVICES PERSONNEL ONLY.
- THE BY-PASS VALVE SHALL BE A FULL PORT GATE VALVE (A BALL VALVE IS NOT ACCEPTABLE). ALL OTHER VALVES SHALL BE FULL PORT GATE OR BALL VALVES.
- AN APPROVED PREMISE ISOLATING CROSS CONNECTION CONTROL DEVICE SHALL BE INSTALLED IMMEDIATELY AFTER THE WATER METER SETTING ON ALL COMMERCIAL, INDUSTRIAL AND MULTI FAMILY RESIDENTIAL (3 UNITS OR MORE) SERVICES.


1 SITE PLAN - MECHANICAL
M1001 SCALE: 1:150

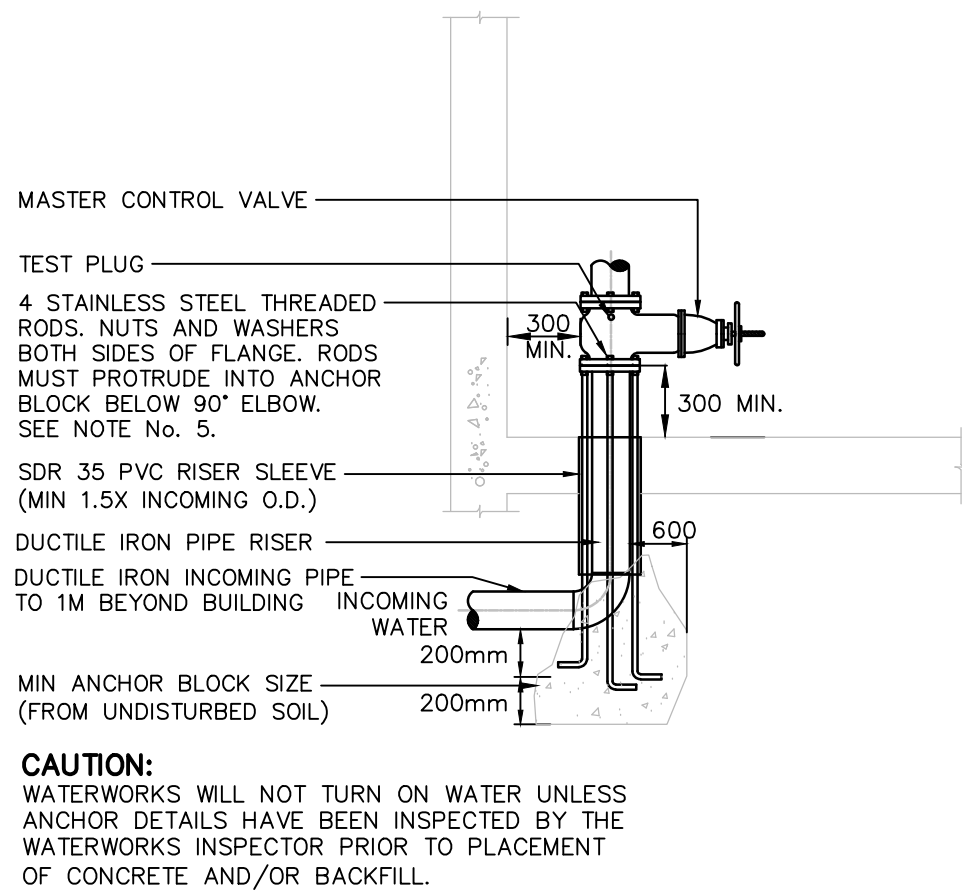

NOTES:


- THE MASTER CONTROL VALVE SHALL BE ONE OF THE FOLLOWING:
 - RESILIENT SEATED RISING SPINDLE (OS & Y) FLANGED GATE VALVE (UL OR ULC LISTED) FOR FIRE LINES AND CSA APPROVED FOR DOMESTIC LINES.
 - SHORT-BODY, RUBBER SEATED FLANGED OR LUG WATER TYPE BUTTERFLY VALVE C/W HAND WHEEL, REDUCTION GEAR OPERATOR, POSITION INDICATOR (UL OR ULC LISTED) PROVIDED THEY ARE NOT IN A SUCTION LINE FOR FIRE PUMP(S).
- ENTRANCE PIPE MATERIAL THROUGH THE OUTSIDE WALL AND THROUGH THE FLOOR SHALL BE DUCTILE IRON PIPE AWWA C153 (LATEST EDITION) CLASS 53 OR APPROVED EQUAL. BURIED FITTINGS (90° ELBOW) SHALL BE CAST OR DUCTILE IRON CONFORMING TO AWWA C110 (LATEST EDITION) OR APPROVED EQUAL. ALL SERVICE ENTRIES (INCLUDING ANCHOR DETAILS) SHALL BE DESIGNED BY A PROFESSIONAL ENGINEER AND DETAILED ON THE DEVELOPMENT SITE SERVICING PLAN (DSSP). (ANCHOR RODS SHALL BE 18-B STAINLESS STEEL. WHERE A STANDARD 3m LENGTH OF ROD REQUIRES EXTENSION, AN APPROVED STAINLESS HEXAGON NUT COUPLING SHALL BE INSTALLED AT THE UPPER END OF THE ROD).
- PROVIDE ADEQUATE PIPE SUPPORT. REFER TO DEVELOPMENT SITE SERVICING PLAN (DSSP) GUIDELINES (2.8.8.3 PIPING SUPPORT)
- INTERNAL PLUMBING STUB TO TERMINATE A MINIMUM OF 2.0m OUT FROM EXTERIOR WALL OR FOOTING. ENTRANCE OF PIPE THROUGH WALL SHALL BE PERPENDICULAR (90°) TO WALL.
- ANCHOR RODS TO BE 2" FOR 100mm - 200mm SERVICE, 1" FOR 250mm - 300mm SERVICE AND 1" FOR 350mm - 400mm SERVICE.
- A RESTRAINED FLANGE ADAPTOR MAY MAY BE USED TO CONNECT THE RISER OR WALL ENTRY PIPE TO THE MASTER CONTROL VALVE. RESTRAINED FLANGE ADAPTOR SHALL BE EBAA SERIES 2100 MEGA FLANGE OR APPROVED EQUAL.

2 ANCHORAGE THROUGH FLOOR DETAIL
M101 SCALE: N.T.S.

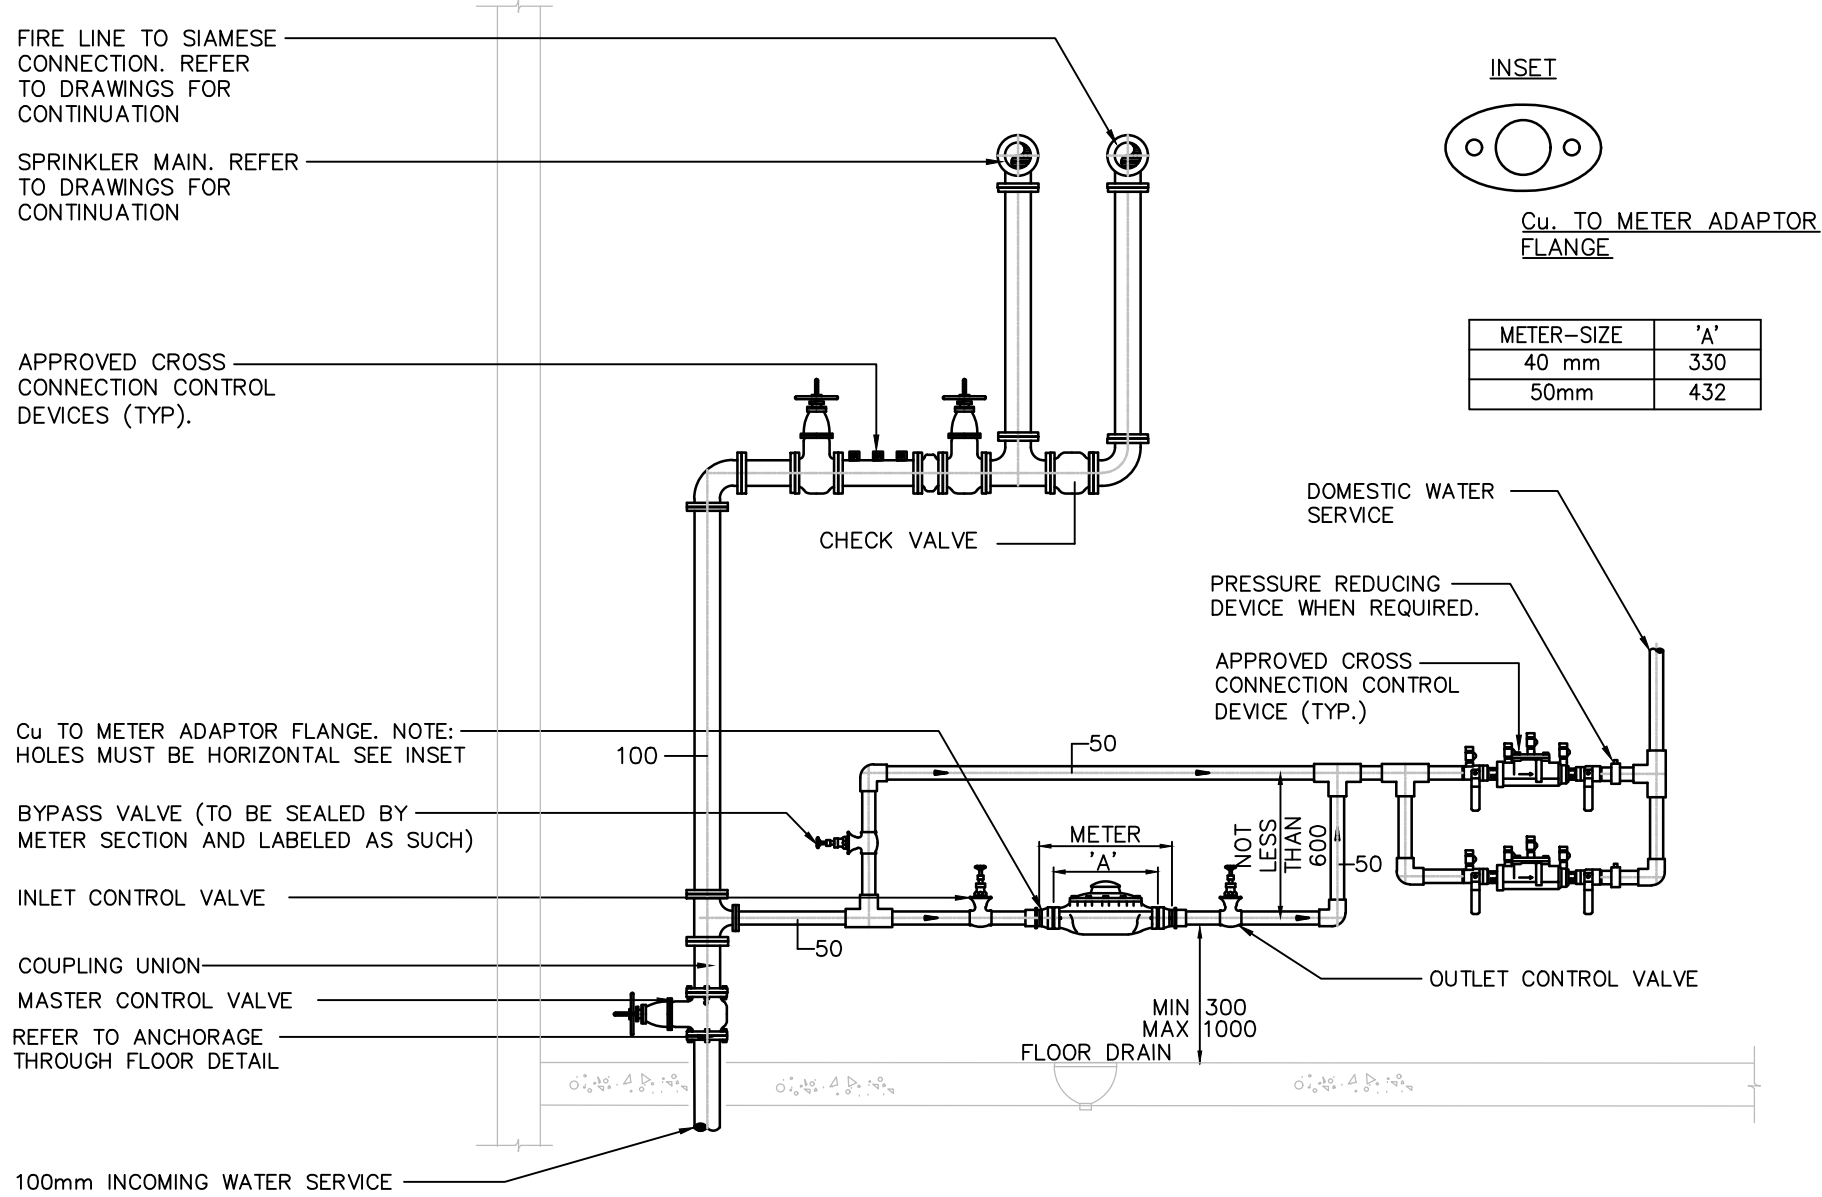

3 WATER METER DETAIL
M101 SCALE: N.T.S.

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MUNICIPAL ADDRESS: WATERTON, WATERTON LAKES
NATIONAL PARK
LEGAL LAND DESC.: LOTS 20 & 21 BLOCK 42

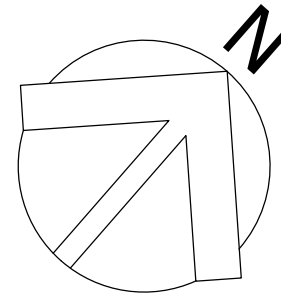1. ALL SANITARY PIPING TO RUN $\frac{1}{2}$ " SLOPE UNLESS OTHERWISE NOTED.
2. DRAWING IS DIAGRAMMATIC ONLY. CONTRACTOR TO INSTALL ALL DRAINS AND VENTS NOT SHOWN TO BE INSTALLED IN ACCORDANCE WITH NATIONAL PLUMBING CODE. CONTRACTOR TO PROVIDE AN ACCURATE AS-BUILT REFLECTING SUCH.
3. 20mm HEATING GLYCOL CONNECTIONS FOR ALL PERIMETER RADIATION, FORCE FLOW HEATERS, AND UNIT HEATERS UNLESS OTHERWISE NOTED.
4. COORDINATE ALL CLEAN-OUT LOCATIONS AND EXTENSIONS AS REQUIRED WITH PLAN ABOVE.
5. CONTRACTOR TO MAINTAIN MAXIMUM HEADROOM AT ALL TIMES.

①	900x900x1200 DEEP CAST-IN-PLACE WEEPING TILE SANITARY PIT C/W <u>P-6</u> & <u>P-7</u> .	⑧	100% INCOMING DOMESTIC WATER MAIN RAISER TO WATER METER ROOM ABOVE.
②	900x900x1200 DEEP CAST-IN-PLACE SANITARY SANITARY PIT C/W <u>P-8</u> & <u>P-9</u> .	⑨	PROVIDE SUB-SLAB WALL VENTING 150# PVC PIPE AT LOCATIONS SHOWN. REFER TO STRUCTURAL DRAWINGS FOR INSTALLATION DETAIL.
③	TRANSITION PERFORATED WEEPING TILE INTO SOLID PIPE BEFORE ENTERING BUILDING ENVELOPE.	⑩	SANITARY PIPING FROM BASEMENT FIXTURES TO SANITARY PIT (TYPICAL).
④	50# WEEPING TILE & SANITARY SANITARY PIT VENT UP TO FLOOR ABOVE.	⑪	PROVIDE OUTLET LINE SLEEVES FOR SANITARY PIPES RUNNING UNDERNEATH STRIP FOOTING.
⑤	RADON GAS EXTRACTION PIT BELOW THICKENED SLAB. COORDINATE WITH STRUCTURAL DRAWINGS FOR FINAL LOCATION. REFER TO DETAIL 11/M402.	⑫	65# PUMPED SANITARY LINE UP TO METER ROOM ABOVE.
⑥	150# RADON GAS VENT PIPE, STUB UP AND CAP IN BASEMENT FLOOR ABOVE.	⑬	100% INCOMING WEEPING TILE LINE AT 12803.06m. PROVIDE OUTLET LINE SLEEVE FOR PORTION UNDERNEATH FOUNDATION.
⑦	100# WEEPING TILE DRAIN PUMPED UP TO FLOOR ABOVE.		

No.	Date/Date	Description/Description	Drawn by Dessine par	Approved Approuve
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Consultant's Name Nom de l'expert-conseil	Eng. Stamp Sceau de l'ingenieur
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Client/client
 Parks Canada
 Agency L'Agence Parcs
 Canada

Project title/Titre du projet

**Staff Housing Phase 2
Waterton Lakes National
Park**


Surveyed by/Arpente par C.M.P.	Drawn by/Dessine par C.M.P.	Date/Date 2016-04-21
Designed by/Concept par C.M.P.	Reviewed by/Revise par A.G.K.	Scale/Echelle AS INDICATED

Client Acceptance/Acceptation du client	Approved by/Approuvé par
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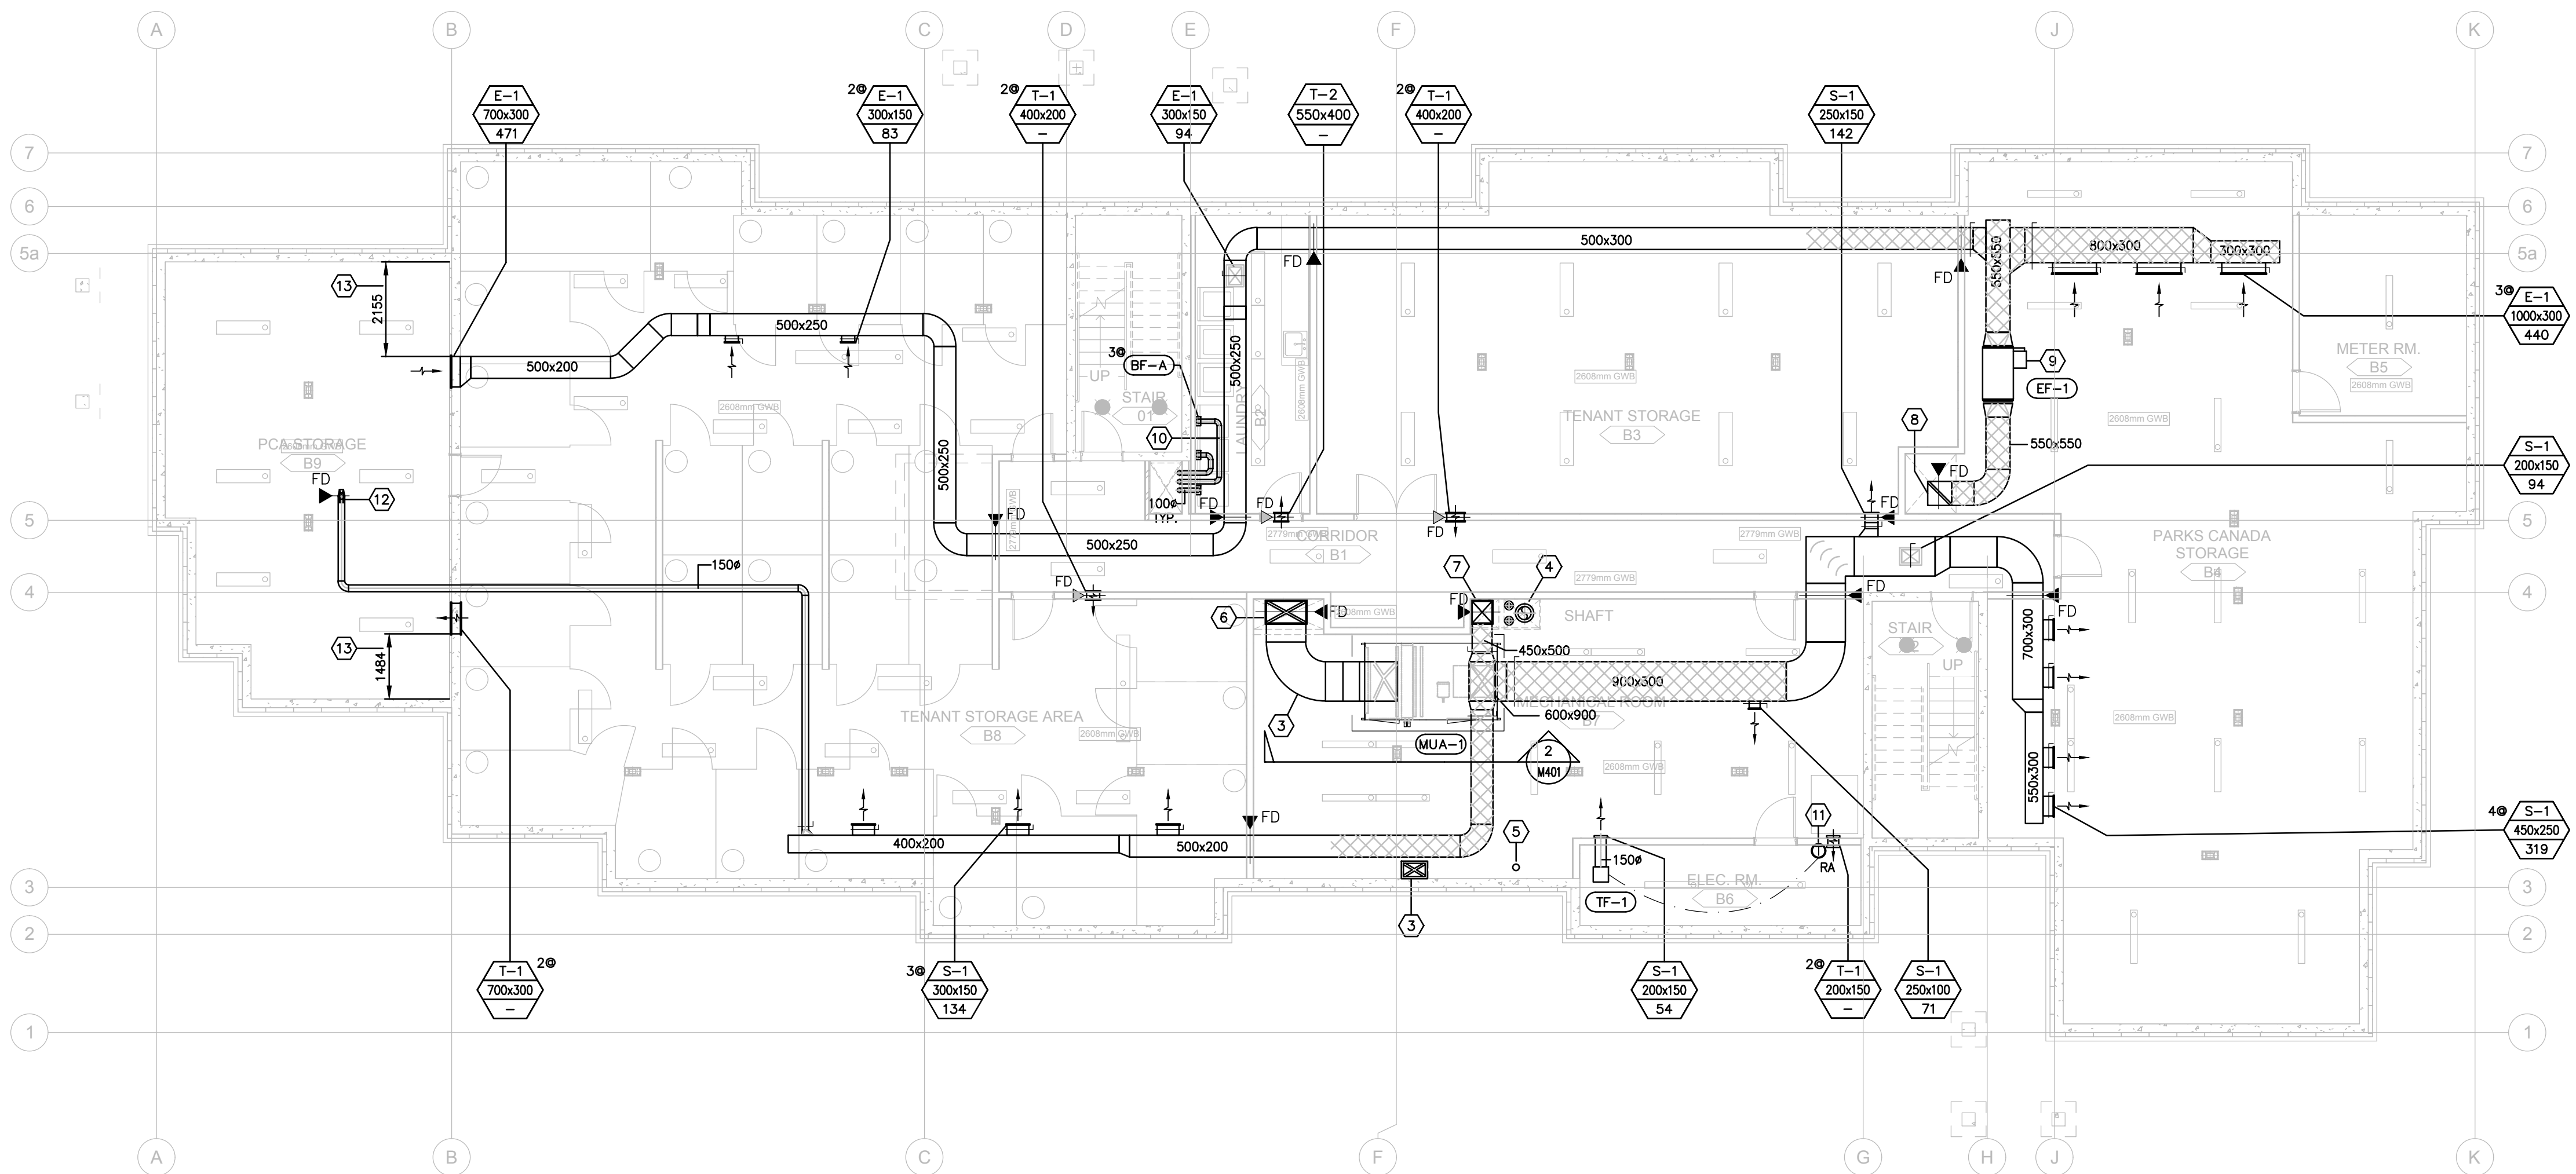
Parc responsable Orçel/Agent responsable		PRUSC Project Manager/Administrateur de projets PRUSC	
Project No. /No. du projet	Asset No. /No. du bien	Sheet No. /	

Drawing Reference No./No. de reference du dessin M201

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1 BASEMENT FLOOR PLAN - PLUMBING AND HEATING
SCALE: 1:100

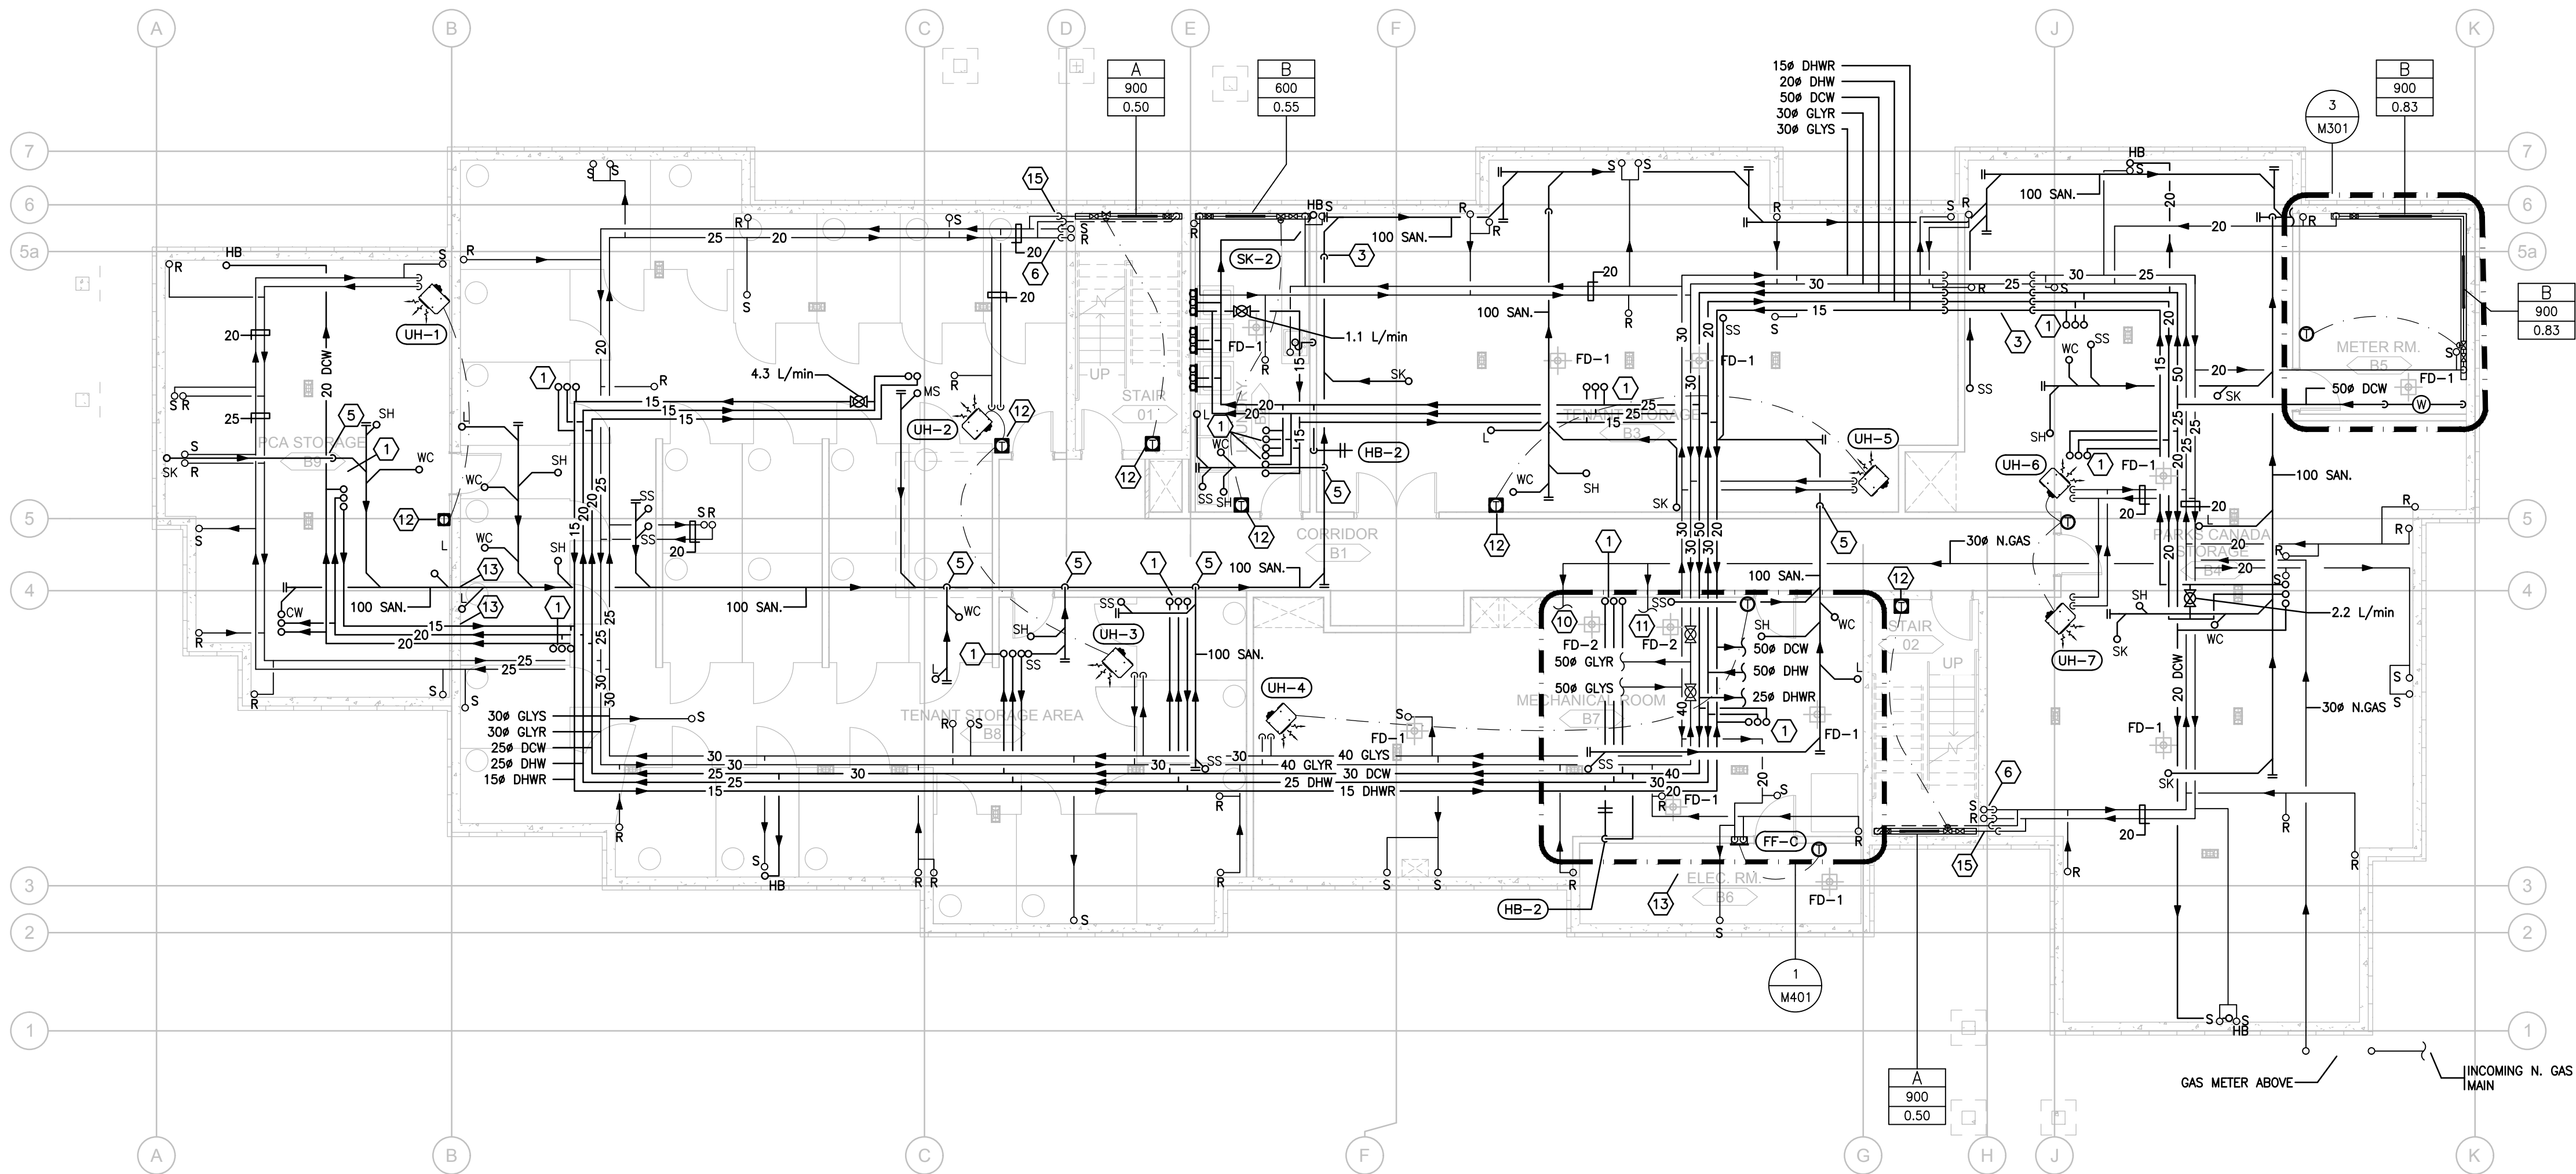


2 BASEMENT FLOOR PLAN - VENTILATION
SCALE: 1:100

GENERAL NOTES:

- ALL SANITARY PIPING TO RUN @1% SLOPE UNLESS OTHERWISE NOTED.
- DRAWING IS DIAGRAMMATIC ONLY, CONTRACTOR TO INSTALL ALL DRAINS AND VENTS NOT SHOWN TO BE INSTALLED IN ACCORDANCE WITH NATIONAL PLUMBING CODE. CONTRACTOR TO PROVIDE AN ACCURATE AS-BUILT REFLECTING SUCH.
- 20mm HEATING GLYCOL CONNECTIONS FOR ALL PERIMETER RADIATION, FORCE FLOW HEATERS, AND UNIT HEATERS UNLESS OTHERWISE NOTED.
- COORDINATE ALL CLEAN-OUT LOCATIONS AND EXTENSIONS AS REQUIRED WITH PLAN ABOVE.
- CONTRACTOR TO MAINTAIN MAXIMUM HEADROOM AT ALL TIMES.

KEY NOTES:

- 20 DCW, 20 DHW & 15 DHWR LINES UP TO SUITES ABOVE.
- 50# SANITARY VENT AND 50# WEeping TILE VENT FROM BASEMENT, UP TO CURVED ROUND PIPE ON SLOPED ROOF.
- DROP SANITARY PIPE BELOW DUCTWORK.
- RISE PIPE UP ABOVE DUCTWORK.
- RISE PIPE UP ABOVE DUCTWORK INTO JOIST SPACE.
- RISE GLYCOL SUPPLY AND RETURN LINES INTO JOIST SPACE.
- CONTRACTOR TO SUPPLY DRIP PAN UNDERNEATH PIPING IN ELECTRICAL ROOM.
- DOMESTIC HOT WATER RETURN PIPING C/W BALANCING VALVE.
- WEeping TILE DISCHARGE TO GRADE. REFER TO DETAIL 4/M402.
- 25# N.GAS TO BOILERS. REFER TO DETAIL 3/M401 FOR CONTINUATION.
- 12# N.GAS TO DOMESTIC WATER HEATERS. REFER TO DETAIL 4/M401 FOR CONTINUATION.
- PROVIDE LOCKABLE THERMOSTAT COVER.
- PROVIDE PRE-CAST PIPING SLEEVES THROUGH CONCRETE WALL, COORDINATE WITH STRUCTURAL & ARCHITECTURAL.
- PROVIDE DRIP PAN UNDER PIPING IN ELECTRICAL ROOM (TYPICAL).
- DROP SUPPLY AND RETURN PIPING DOWN TO STAIR LANDING LEVEL TO FEED RADIANT CABINET.

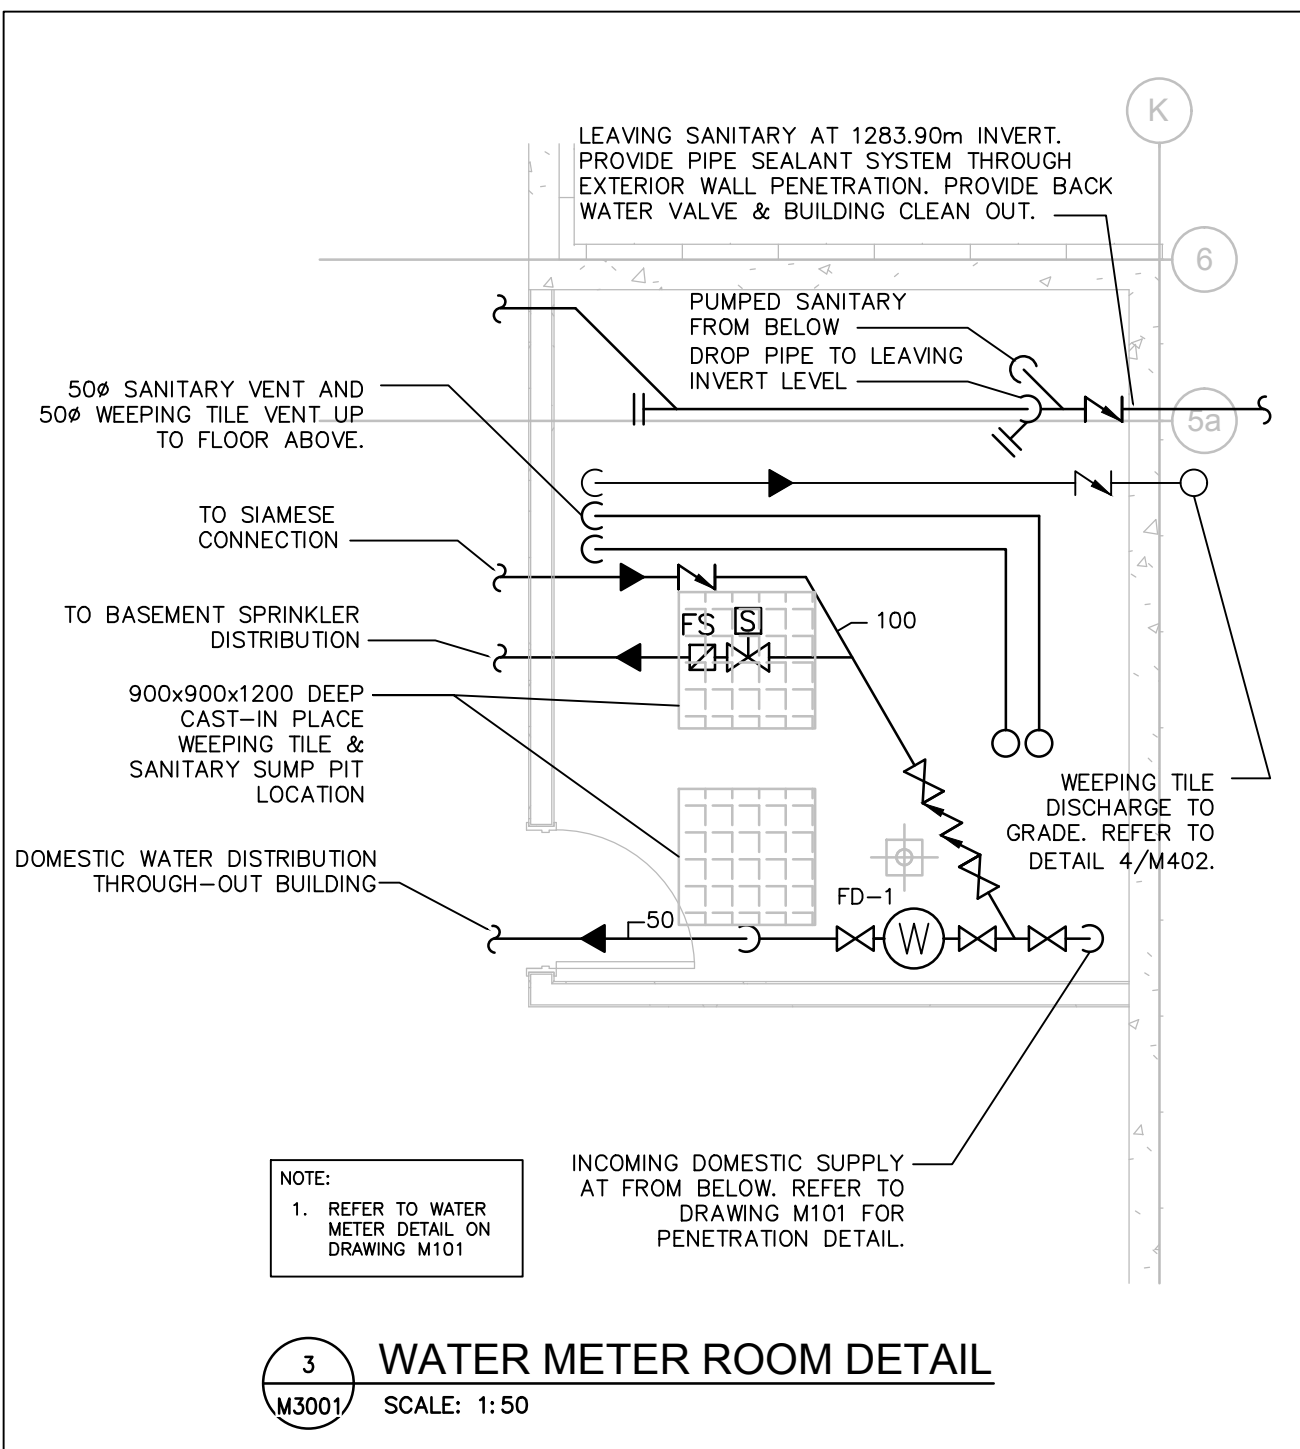

GENERAL NOTES:

- ALL BASEMENT DUCTWORK TO RUN AS TIGHT TO BASEMENT CEILING SPACE AS POSSIBLE UNLESS OTHERWISE NOTED.
- CONTRACTOR TO MAINTAIN MINIMUM HEADROOM OF 2150mm THROUGHOUT BASEMENT CORRIDOR.
- CONTRACTOR TO MAINTAIN MINIMUM HEADROOM OF 2050mm THROUGHOUT BASEMENT OCCUPIABLE STORAGE SPACE.

KEY NOTES:

- MAKE-UP AIR UNIT MUA-1 MOUNTED ON 100mm HOUSE KEEPING PAD.
- PROVIDE ACOUSTIC INSULATION FOR SUPPLY AIR DUCT AS SHOWN.
- 500x300 COMBUSTION AIR INTAKE C/W 50mm INSULATION IN FIRE RATED ENCLOSURE. TERMINATION 450mm ABOVE FINISHED FLOOR. PROVIDE 600mm HIGH COLD AIR TRAP.
- RUN 300# AL29-4C BOILER FLUE & TWO 100# PVC DHW HEATER FLUE IN FIRE-RATED SHAFT. PROVIDE 2" INSULATION ON ALL FLUE VENTING. REFER TO DRAWING 1/M401 FOR ROUTING.
- 150mm CAPPED RADON GAS ROUGH-IN FROM BELOW.
- 900x500 OUTSIDE AIR INTAKE, C/W FIRE DAMPER AT MAIN FLOOR PENETRATION & 50mm THERMAL INSULATION FROM TOP OF SHAFT TO CONNECTION WITH MAKE-UP AIR UNIT. PROVIDE ACOUSTICAL LINING UP TO LOFT FLOOR.
- 450x500 SUPPLY AIR DUCT RISE IN MECHANICAL SHAFT TO FLOORS ABOVE. PROVIDE FIRE DAMPER AND ACOUSTICAL LINING UP TO LOFT FLOOR.
- 550x550 BASEMENT EXHAUST AIR DUCT IN MECHANICAL SHAFT TO ATTIC SPACE. PROVIDE ACOUSTICAL LINING UP TO LOFT FLOOR AND C/W FIRE DAMPER AT MAIN FLOOR PENETRATION.
- BASEMENT EXHAUST FAN EF-1 MOUNTED FROM STRUCTURE C/W VIBRATION ISOLATION AND FLEXIBLE CONNECTIONS.
- DRYER EXHAUST DUCTING UP TO SECOND FLOOR C/W FIRE WRAPPING OF ENTIRE LENGTH (3 TYP.)
- INTERCONNECT REVERSE ACTING THERMOSTAT TO TRANSFER FAN EF-2 IN ELECTRICAL ROOM.
- 150# SUPPLY DUCT TO SUIT ABOVE. TRANSITION TO 200x100 FOR GRILLE CONNECTION.
- MAINTAIN OPENING EDGE DISTANCE FROM BASEMENT EXTERIOR WALL AS SHOWN.

SITE INFORMATION

MUNICIPAL ADDRESS: WATERTON, WATERTON LAKES
NATIONAL PARK
LEGAL LAND DESC.: LOTS 20 & 21 BLOCK 42

5	16-12-08	ISSUED FOR TENDER	C.M.P.	A.G.K.
4	16-12-08	ISSUED FOR BP	C.M.P.	A.G.K.
3	16-09-02	ISSUED FOR 99% REVIEW	C.M.P.	A.G.K.
2	16-06-14	ISSUED FOR 66% REVIEW	C.M.P.	A.G.K.
1	16-05-05	ISSUED FOR 33% REVIEW	C.M.P.	A.G.K.

No.	Date/Date	Description/Description	Drawn by Dessiné par	Approved Approuvé
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Revision / Revision	
A	detail number numéro de détail
B	source drawing no. de dessin no.
C	detail on drawing no. détail sur dessin no.

Consultant's Name
Nom de l'expert-conseil

Eng. Stamp
Sceau de l'ingénieur



Public Works and
Government Services
Canada

Travaux publics et
Services gouvernementaux
Canada

Client Services Team
Southern Alberta
Operations Branch

Le Client Entretien d'Équipe
Alberta Méridionale
Branche d'Opérations

Client/client
Parks Canada
Agence

L'Agence Parcs
Canada

Western and
Northern Region

Ouest et Nord
du Canada

Project title/Titre du projet
**Staff Housing Phase 2
Waterton Lakes National
Park**

Drawing title/Titre du dessin
**BASEMENT PLAN -
MECHANICAL**

Surveyed by/Arpenté par
C.M.P.

Drawn by/Dessiné par
C.M.P.

Reviewed by/Revisé par
A.G.K.

Date/Date
2016-04-21

Scale/Echelle
AS INDICATED

PWGSC Project Manager/Administrateur de Projets TP50C
Randy Boldt

Client Acceptance/Acceptation du client
Approved by/Approuvé par

Per Responsible Officer/Agent Responsable
PWGSC Project Manager/Administrateur de Projets TP50C


Project No./No. du projet
39000

Asset No./No. du bien
Asset No. 945

Sheet No./
No. de la feuille
M301

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\\fs1\proj\04\23\045\B1\Group\001-01 Waterton Lakes National Park - Staff Housing Phase 2\Drawings\03 2016-04-28 Final\B1-2\M302- Fire Protection.dwg Date: 07-2016 1:14:00m

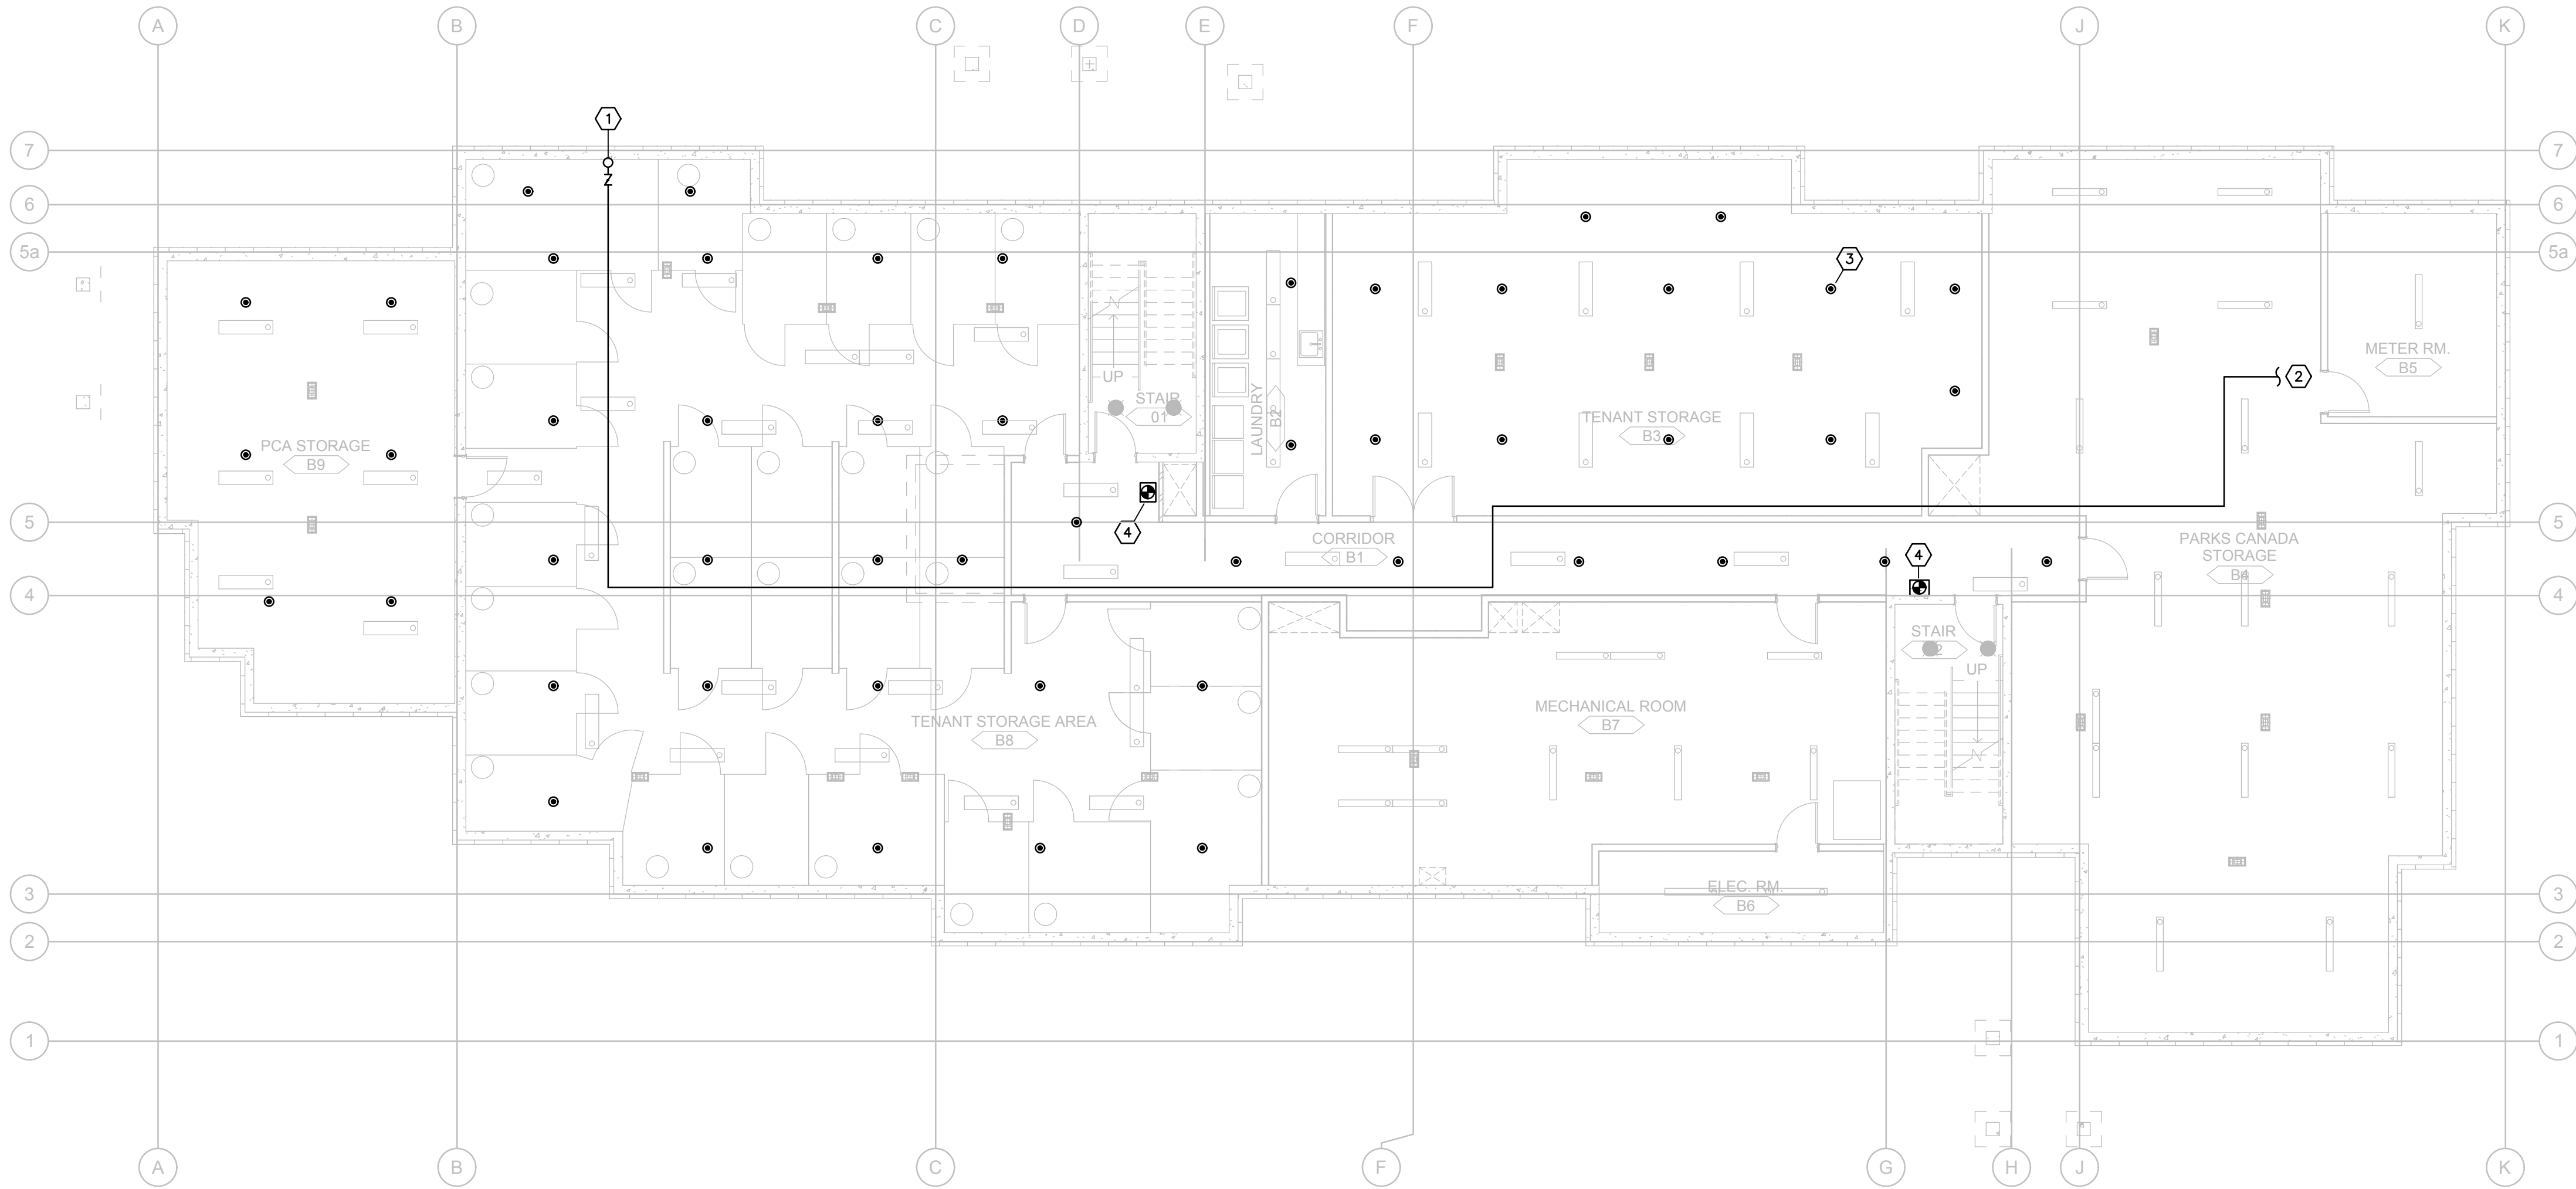

1 BASEMENT FLOOR PLAN - FIRE PROTECTION
SCALE: 1:100

GENERAL NOTES:

1. ADD SPRINKLERS ABOVE AND BELOW OBSTRUCTIONS W/ 1200mm WIDTH & OVER.
2. SPRINKLERS TO BE INSTALLED IN ACCORDANCE WITH BOTH NFPA 13 AND/OR NFPA 13R. CONFIRM NUMBER OF HEADS REQUIRED PRIOR TO SUBMITTING PRICE. COORDINATE HEADS WITH ELECTRICAL, STRUCTURAL, AND ARCHITECTURAL DRAWINGS. SPRINKLER SYSTEM TO BE HYDRAULICALLY SIZED FOR LIGHT AND ORDINARY HAZARD OCCUPANCIES IN COMPLIANCE WITH NFPA 13. SPRINKLER HEADS SHOWN ON DRAWING ARE FOR COORDINATION ONLY. FINAL HEAD COUNT WILL BE THE RESPONSIBILITY OF THE SPRINKLER CONTRACTOR.
3. COORDINATE FINAL LOCATION OF FIRE EXTINGUISHER CABINETS WITH ARCHITETURAL DRAWINGS.
4. FINAL FIRE PROTECTION DRAWINGS TO BE SUBMITTED BY FIRE PROTECTION CONTRACTOR.
5. CONTRACTOR TO MAINTAIN MAXIMUM HEADROOM AT ALL TIMES.
6. COORDINATE LOCATION OF SPRINKLER HEADS WITH ELECTRICAL LIGHTING LAYOUT.
7. SPRINKLER CONTRACTOR SHALL DESIGN SYSTEM IN ACCORDANCE TO NFPA 13R STANDARDS UNDERSTANDING THE EXISTING HYDRANT FLOW TEST MEASURED AT 58 PSI STATIC PRESSURE AND 36 PSI RESIDUAL PRESSURE AT 900 GPM FLOW RATE. CONTRACTOR SHALL HYDRAULICALLY DESIGN SYSTEM FOR THIS PRESSURE CONDITION.

KEY NOTES:

- ① 100# SIAMSE CONNECTION RISER TO FLOOR ABOVE.
- ② 100# SIAMSE CONNECTION TO SPRINKLER TREE. REFER TO WATER METER DETAIL ON DWG M301 FOR CONTINUATION.
- ③ UPRIGHT SPRINKLER HEADS TYP.
- ④ SURFACE MOUNTED FIRE EXTINGUISHER CABINET TYP.

SITE INFORMATION

MUNICIPAL ADDRESS: WATERTON, WATERTON LAKES
NATIONAL PARK
LEGAL LAND DESC.: LOTS 20 & 21 BLOCK 42

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2	16-06-14	ISSUED FOR 66% REVIEW	C.M.P.	A.G.K.
1	16-05-05	ISSUED FOR 33% REVIEW	C.M.P.	A.G.K.

No.	Date/Date	Description/Description	Drawn by dessiné par	Approved Approuvé
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Consultant's Name Nom de l'expert-conseil	Eng. Stamp Sceau de l'ingénieur

Public Works and Government Services Canada	Travaux publics et Services gouvernementaux Canada
Client Services Team Southern Alberta Operations Branch	Le Client Entretien l'Équipe Alberta Méridionale Branche d'Opérations

Canada

Client/client Parks Canada Agency	L'Agence Parcs Canada
Western and Northern Region	Ouest et Nord du Canada

Project title/Titre du projet
**Staff Housing Phase 2
Waterton Lakes National
Park**

Drawing title/Titre du dessin
**BASEMENT PLAN -
FIRE PROTECTION**

Surveyed by/Arpenté par C.M.P.	Drawn by/Dessiné par C.M.P.	Date/Date 2016-04-21
Designed by/Concept par C.M.P.	Reviewed by/Revisé par A.G.K.	Scale/Echelle AS INDICATED

PWGSC Project Manager/Administrateur de Projets TPSCC
Randy Boldt


Client Acceptance/Acceptation du client Approved by/Approuvé par

Task Responsible Officer/Agent Responsable PWGSC Project Manager/Administrateur de Projets TPSCC


Project No./No. du projet 39000	Asset No./No. du-bien Asset No. 945	Sheet No./ No. de la feuille M302
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Drawing Reference No./No. de référence du dessin

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1 MAIN FLOOR PLAN - PLUMBING AND HEATING
SCALE: 1:100

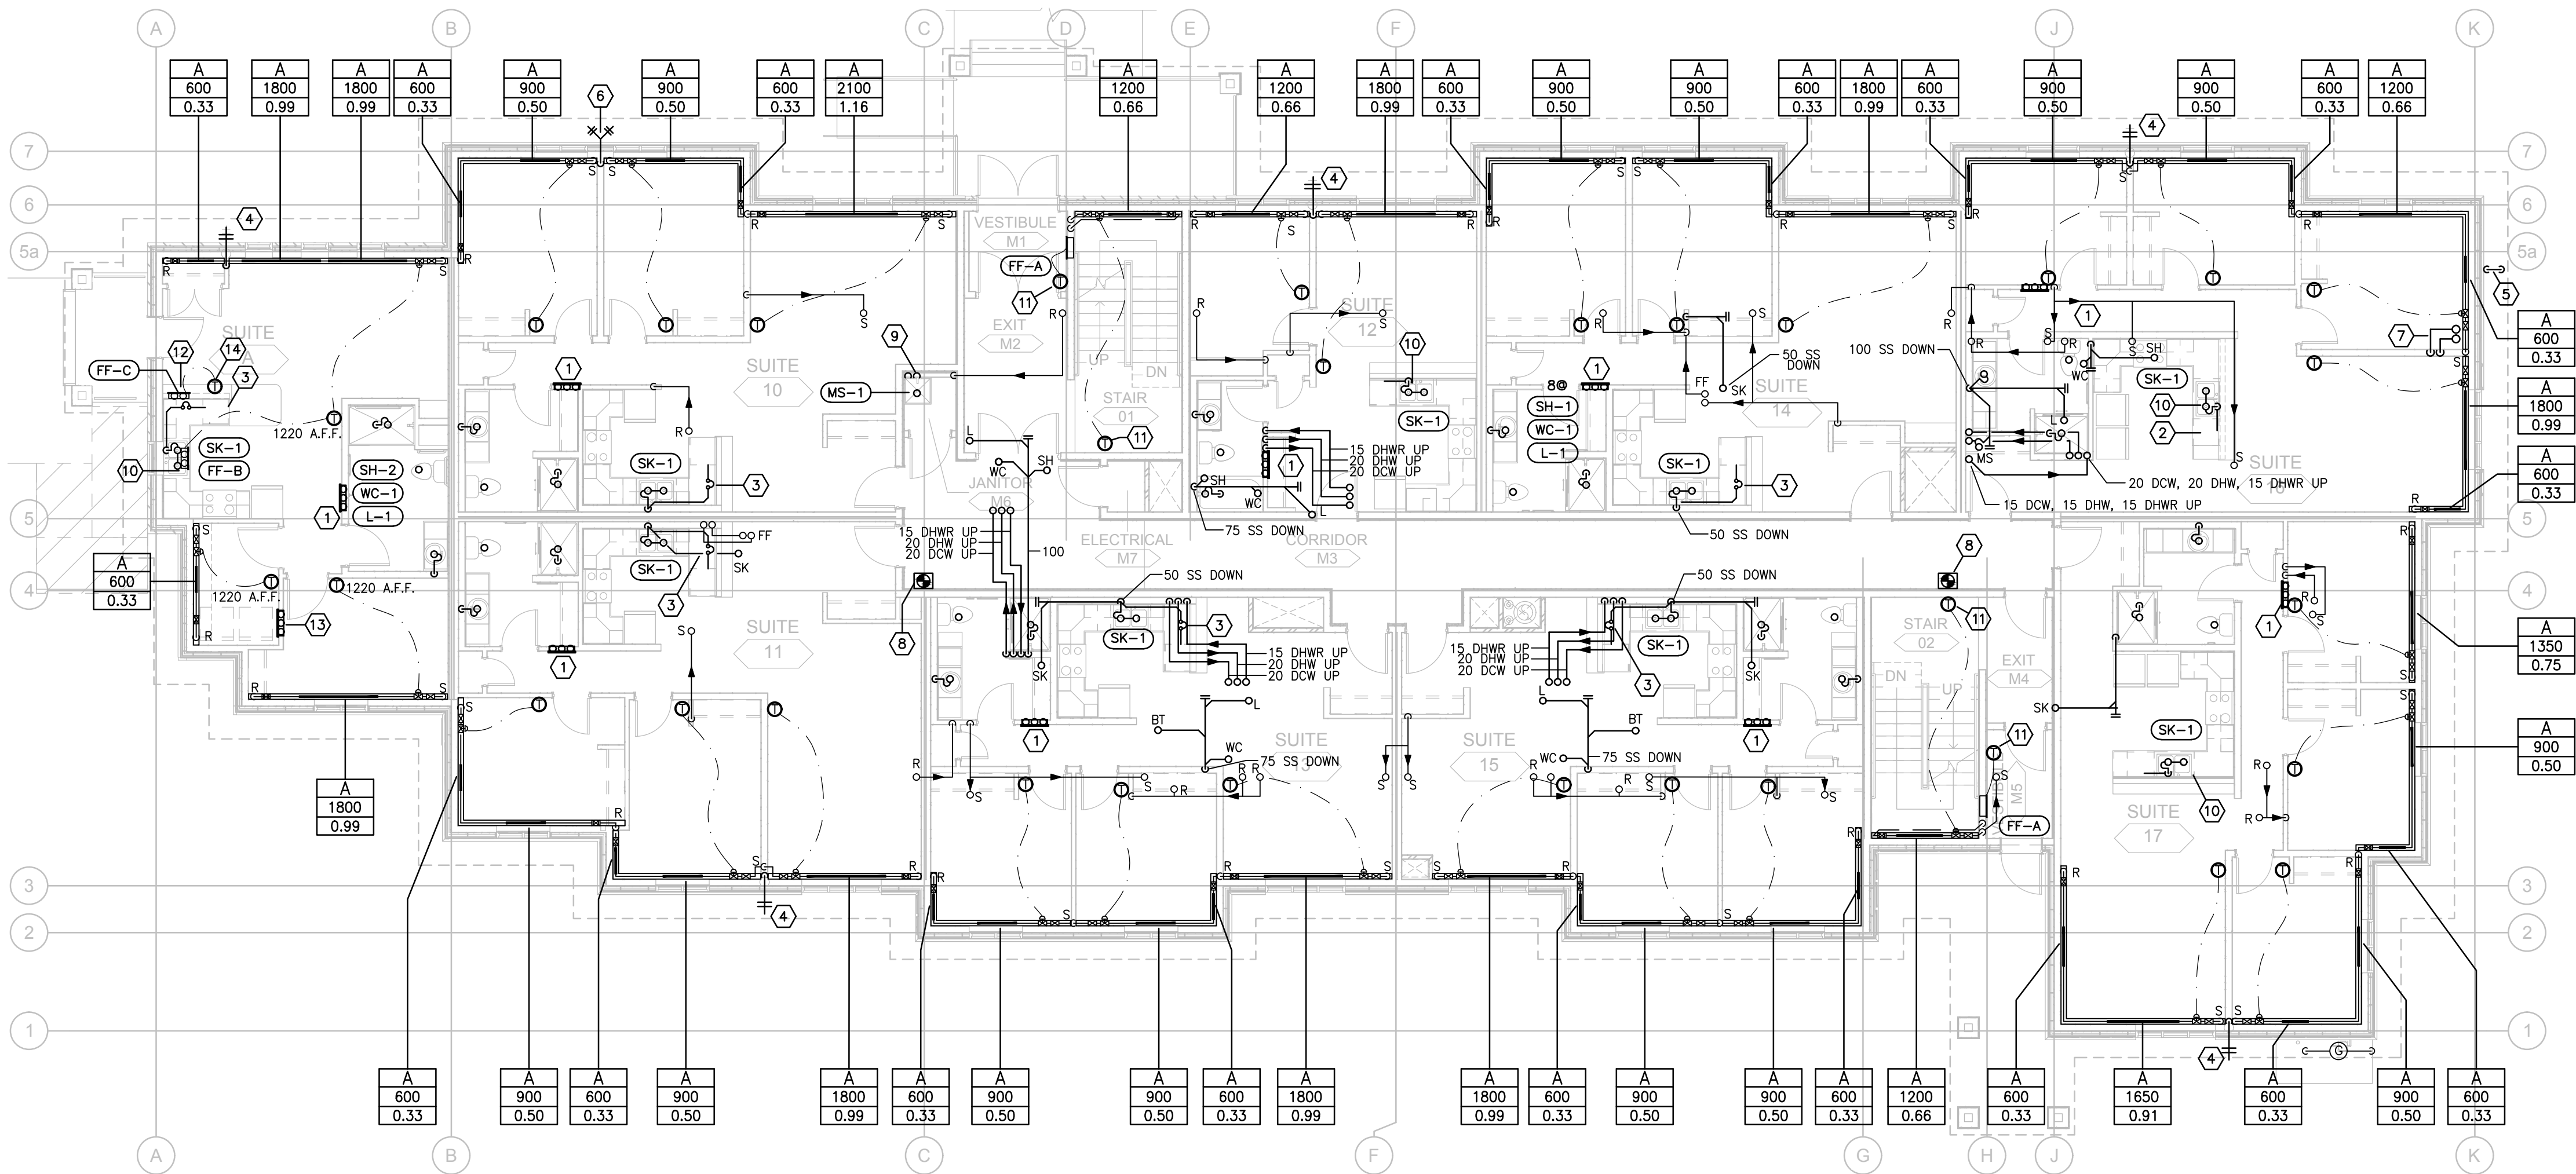


2 MAIN FLOOR PLAN - VENTILATION
SCALE: 1:100

GENERAL NOTES:

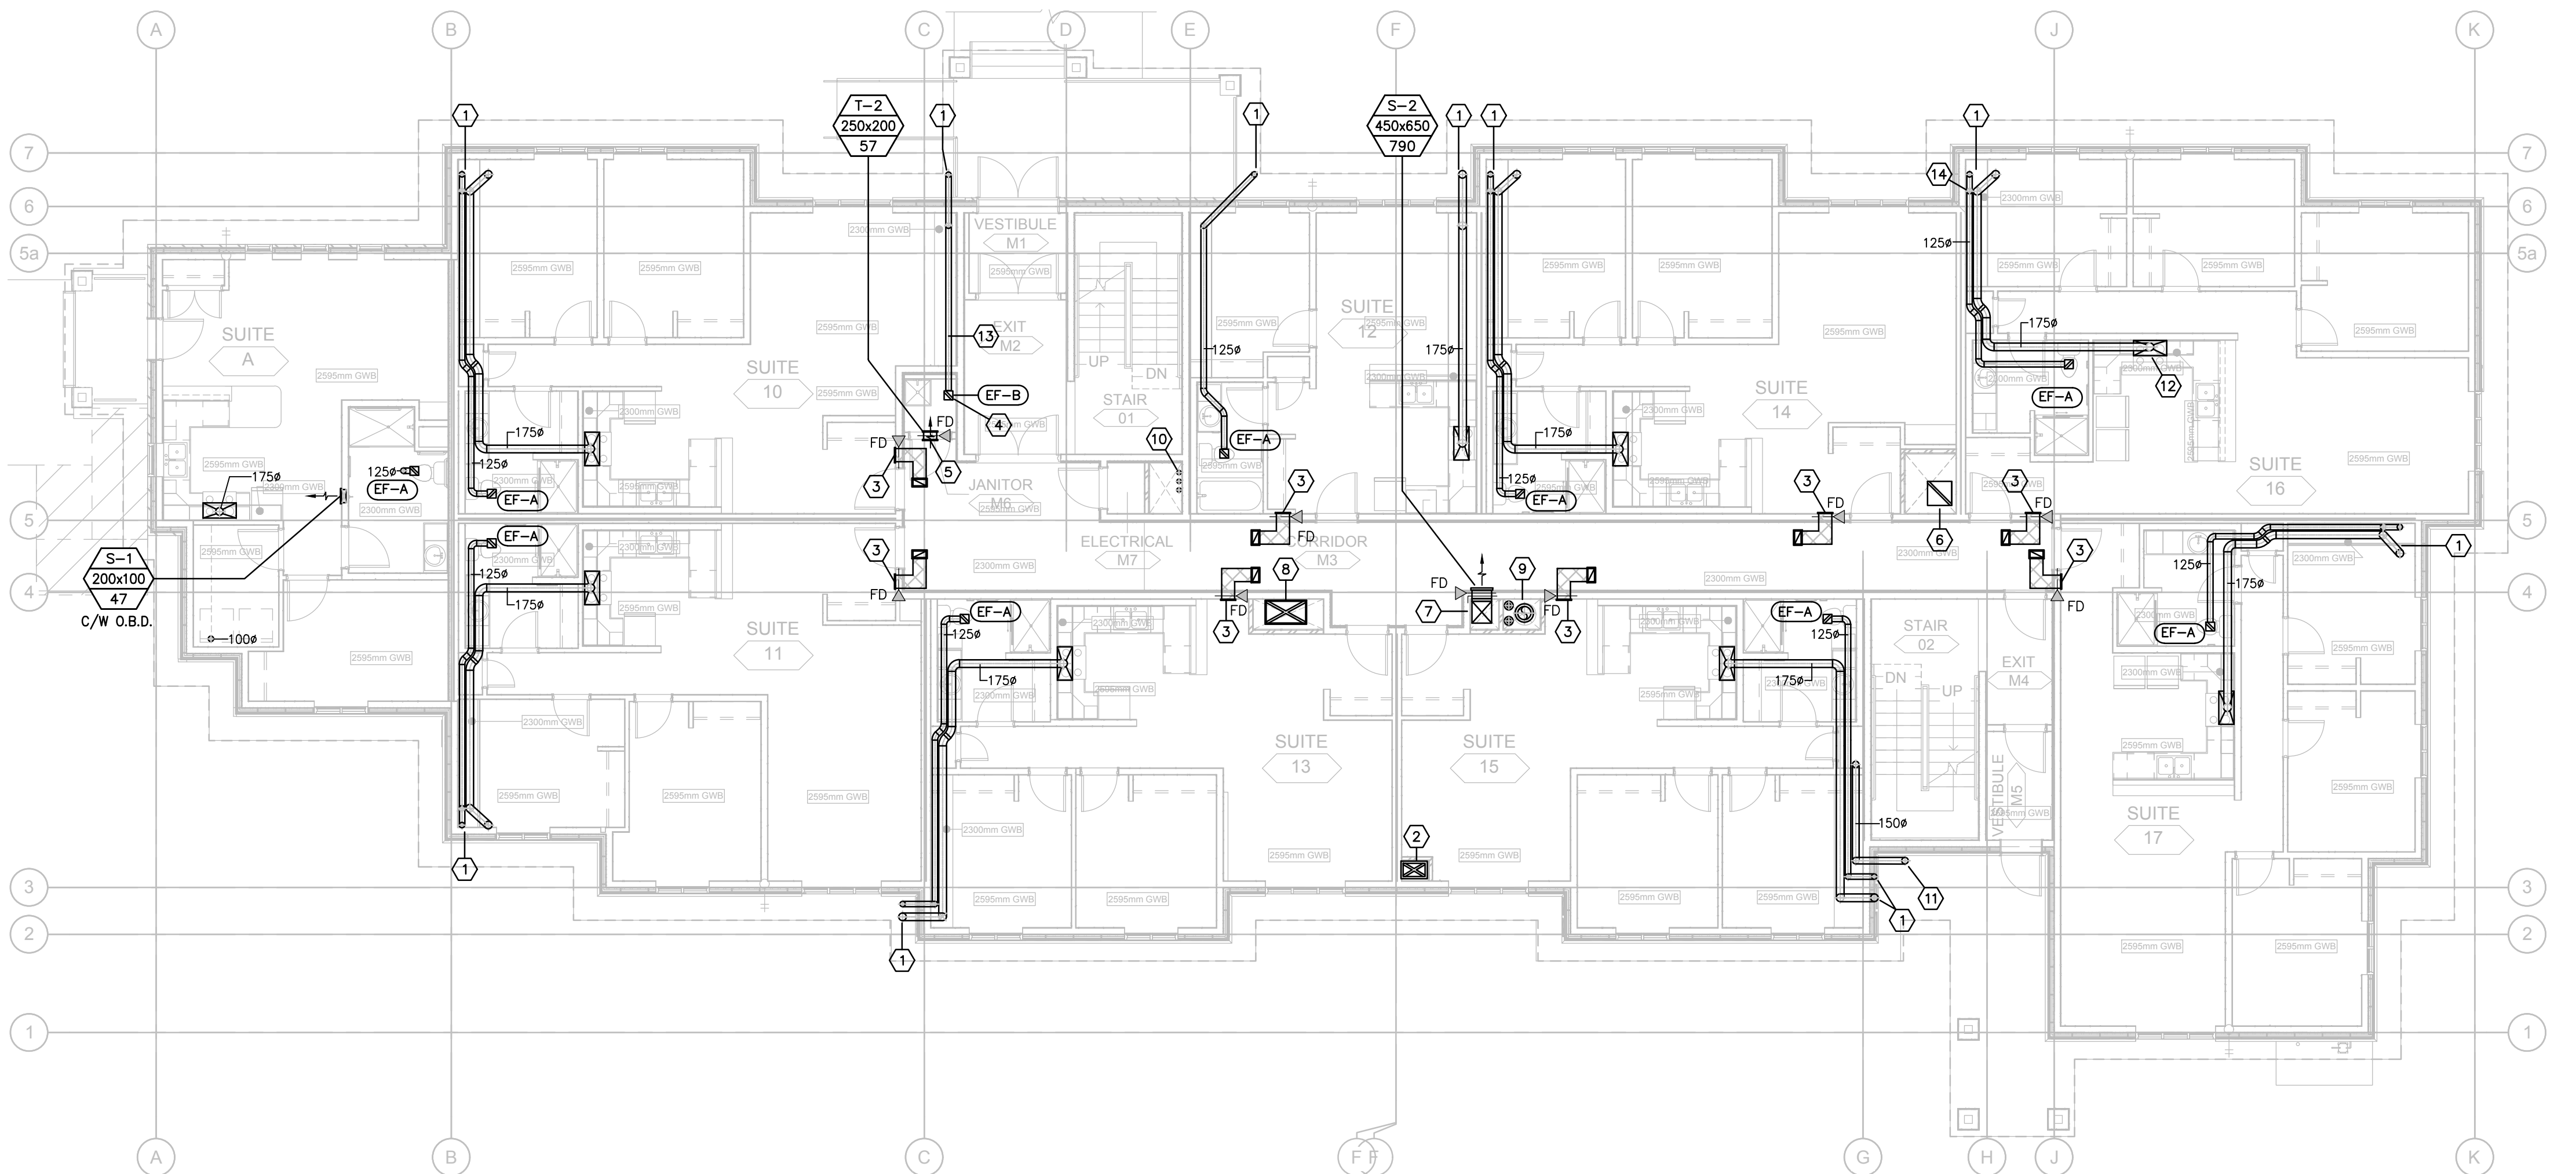1. ALL SANITARY PIPING TO RUN @1% SLOPE UNLESS OTHERWISE NOTED.
2. DRAWING IS DIAGRAMMATIC ONLY. CONTRACTOR TO INSTALL ALL DRAINS AND VENTS NOT SHOWN TO BE INSTALLED IN ACCORDANCE WITH NATIONAL PLUMBING CODE. CONTRACTOR TO PROVIDE AN ACCURATE AS-BUILT REFLECTING SUCH.
3. 20mm HEATING GLYCOL CONNECTIONS FOR ALL PERIMETER RADIATION, FORCE FLOW HEATERS, AND UNIT HEATERS UNLESS OTHERWISE NOTED.
4. COORDINATE ALL CLEAN-OUT LOCATIONS AND EXTENSIONS AS REQUIRED WITH PLAN ABOVE.
5. CONTRACTOR TO MAINTAIN MAXIMUM HEADROOM AT ALL TIMES.
6. ALL SANITARY BRANCH LINES FROM WATER CLOSETS TO BE 75mm.
7. ALL SANITARY BRANCH LINE SIZES FROM KITCHEN SINKS, LAVATORIES, BATHTUBS AND WASHING MACHINES TO BE 40mm.

KEY NOTES:

1. 20 DCW, 20 DHW & 15 DHR LINES FROM BELOW TO SUITE DISTRIBUTION MANIFOLD. PROVIDE WALL ACCESS PANEL FOR SUITE SHUTOFF VALVE. REFER TO DETAIL ON THIS DRAWING.
2. PROVIDE ROUGH-IN AND FINAL CONNECTION TO DISHWASHER (TYPICAL).
3. CONNECT DISHWASHER INTO RUNNING TRAP LINE.
4. 20mm NON-FREEZE HOSE BIBB HBB-1.
5. WEEPING TILE DISCHARGE. REFER TO DETAIL 4/M402.
6. FIRE DEPARTMENT SAMESE CONNECTION. CONNECTION SUPPLIED FROM BASEMENT BELOW.
7. 50# SANITARY SLUMP PIT VENT AND 50# WEEPING TILE VENT FROM BASEMENT, UP TO CURVED ROUND PIPE ON SLOPED ROOF.
8. SURFACE MOUNTED FIRE EXTINGUISHER CABINET TYP.
9. 15 DCW, 15 DHW LINES FROM BELOW TO LOFT FLOOR MOP SINK FAUCET.
10. PROVIDE AIR ADMITTANCE VALVE FOR KITCHEN SINK DRAINS.
11. PROVIDE LOCKABLE THERMOSTAT COVER.
12. ELECTRIC ENTRANCE HEATER. RECESS MOUNTED INTO HALF-WALL IN DOWN BLOW POSITION.
13. CAP WASHER & DRYER ROUGH-INS FOR FUTURE FOR FUTURE WASHER.
14. PROVIDE METAL THERMOSTAT COVER.

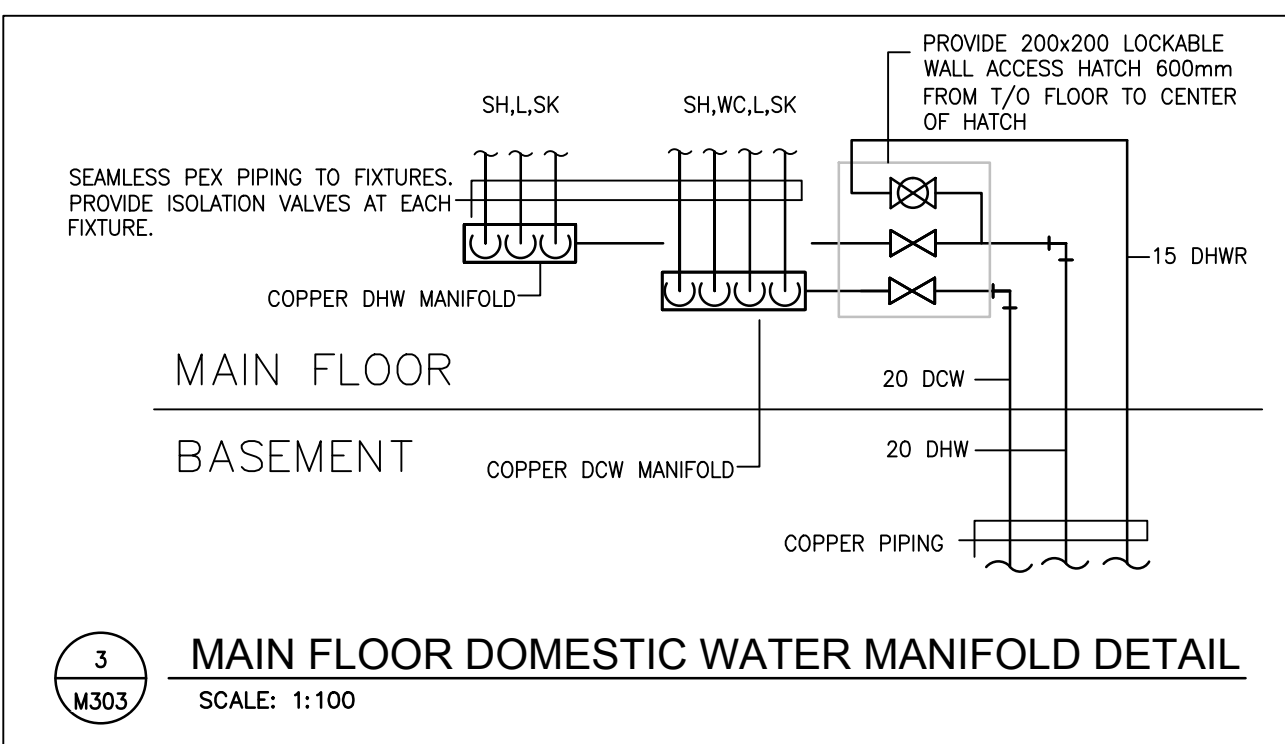

GENERAL NOTES:

1. ALL DUCT WORK TO RUN IN DROPPED CEILINGS AND BULKHEADS. CONTRACTOR TO COORDINATE FINAL DROPPED CEILINGS AND BULKHEADS WITH ARCHITECTURAL DRAWINGS.
2. CONTRACTOR TO MAINTAIN MAXIMUM HEADROOM AT ALL TIMES AND COORDINATE INSTALLATION OF ALL MECHANICAL, ARCHITECTURAL AND STRUCTURAL ELEMENTS.

KEY NOTES:

1. TERMINATE EXHAUST DUCTS WITH VENT CAPS AS SHOWN ON DETAIL 5/M4002. REFER TO ARCHITECTURAL FOR TERMINATION LOCATIONS.
2. 500x300 COMBUSTION AIR INTAKE C/W 50mm INSULATION IN FIRE RATED ENCLOSURE. EXTEND THROUGH DROPPED CEILING, C/W GRILLES AND MULTI-BLADE TYPE FIRE DAMPER (TYP.). REFER TO DETAILS 1/M402 AND 2/M402.
3. RUN 300x150 SUITE TRANSFER AIR DUCTING WITH TWO BENDS IN CORRIDOR DROPPED CEILING, C/W GRILLES AND MULTI-BLADE TYPE FIRE DAMPER (TYP.). REFER TO DETAILS 1/M402 AND 2/M402.
4. EXHAUST FAN EF-B SURFACE MOUNTED EXPOSED BELOW CEILING.
5. DOOR MOUNTED TRANSFER AIR GRILLE C/W FUSE LINK FIRE DAMPER.
6. 550x550 BASEMENT EXHAUST DUCT IN MECHANICAL SHAFT. ACOUSTICALLY LINE UP TO LOFT FLOOR.
7. 450x500 SUPPLY AIR DUCT FROM BELOW. PROVIDE 450x650 TAKE OFF C/W GRILLE & MULTI-BLADE FIRE DAMPER TO MAIN FLOOR CORRIDOR. PROVIDE ACOUSTIC LINING UP TO LOFT FLOOR.
8. 900x500 OUTDOOR AIR INTAKE DUCT. PROVIDE 50mm THERMAL INSULATION FOR FULL LENGTH OF SHAFT & ACOUSTIC LINING UP TO LOFT FLOOR.
9. RUN 300# AL29-AC BOILER FLUE & TWO PVC 100# DHW HEATER FLUE IN FIRE-RATED SHAFT. PROVIDE 50mm INSULATION ON ALL FLUE VENTING.
10. RUN 3x 100# DRYER EXHAUST FROM BELOW INSIDE SHAFT TO ROOF. PROVIDE FIRE INSULATION FROM FLOOR PENETRATION TO DUCT TERMINATION.
11. 150# AIR RELIEF DUCT UP TO SLOPED ROOF. TERMINATE W/ VENT CAP. REFER TO DETAIL 5/M402.
12. REFER TO ARCHITECTURAL DRAWINGS FOR OTR MICROWAVE & RANGE HOOD SPECIFICATION. PROVIDE CONNECTION TO EXHAUST DUCTING (TYPICAL).
13. PROVIDE FIRE WRAPPING ON ENTIRE DUCT.
14. EXHAUST DUCTING TO PENETRATE CEILING AT PERPENDICULARLY (TYPICAL). REDUCE RANGE HOOD EXHAUST DUCTING TO 125# AT CEILING PENETRATIONS. REFER TO DETAIL 12/M402.

SITE INFORMATION

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NATIONAL PARK
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Revision / Revision

A detail number
numéro de détail

B source drawing no.
de dessin no.

C detail on drawing no.
détail sur dessin no.

Consultant's Name
Nom de l'expert-conseil

Eng. Stamp
Sceau de l'ingénieur

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Engineering Ltd.

Public Works and
Government Services
Canada

Travaux publics et
Services gouvernementaux
Canada

Client Services Team
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Alberta Méridional
Branche d'Opérations

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Parks Canada
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L'Agence Parcs
Canada

Western and
Northern Region

Ouest et Nord
du Canada

Project title/Titre du projet

**Staff Housing Phase 2
Waterton Lakes National
Park**

Drawing title/Titre du dessin

**MAIN FLOOR PLAN -
MECHANICAL**

Surveyed by/Arpenté par	Drawn by/Dessiné par	Date/Date
C.M.P.	C.M.P.	2016-04-21
Designed by/Concept par	Reviewed by/Revisé par	Scale/Echelle
C.M.P.	A.G.K.	AS INDICATED

PWGSC Project Manager/Administrateur de Projets TP50C

Client Acceptance/Acception du client

Approved by/Approve par

Permit to Practice/Offre d'acceptation

Project No./No. du projet


Asset No./No. du bien

Sheet No./
No. de la feuille


Drawing Reference No./No. de référence du dessin

M303

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Drawing Reference No./No. de reference du dessin		M304
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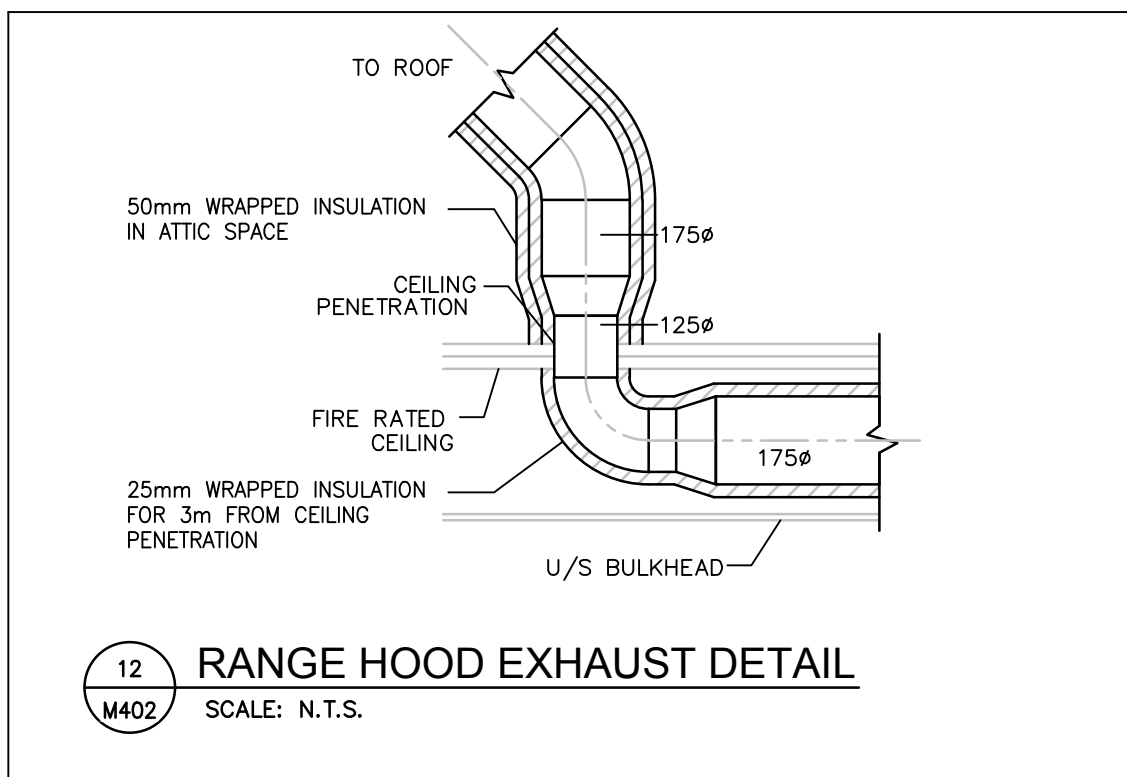
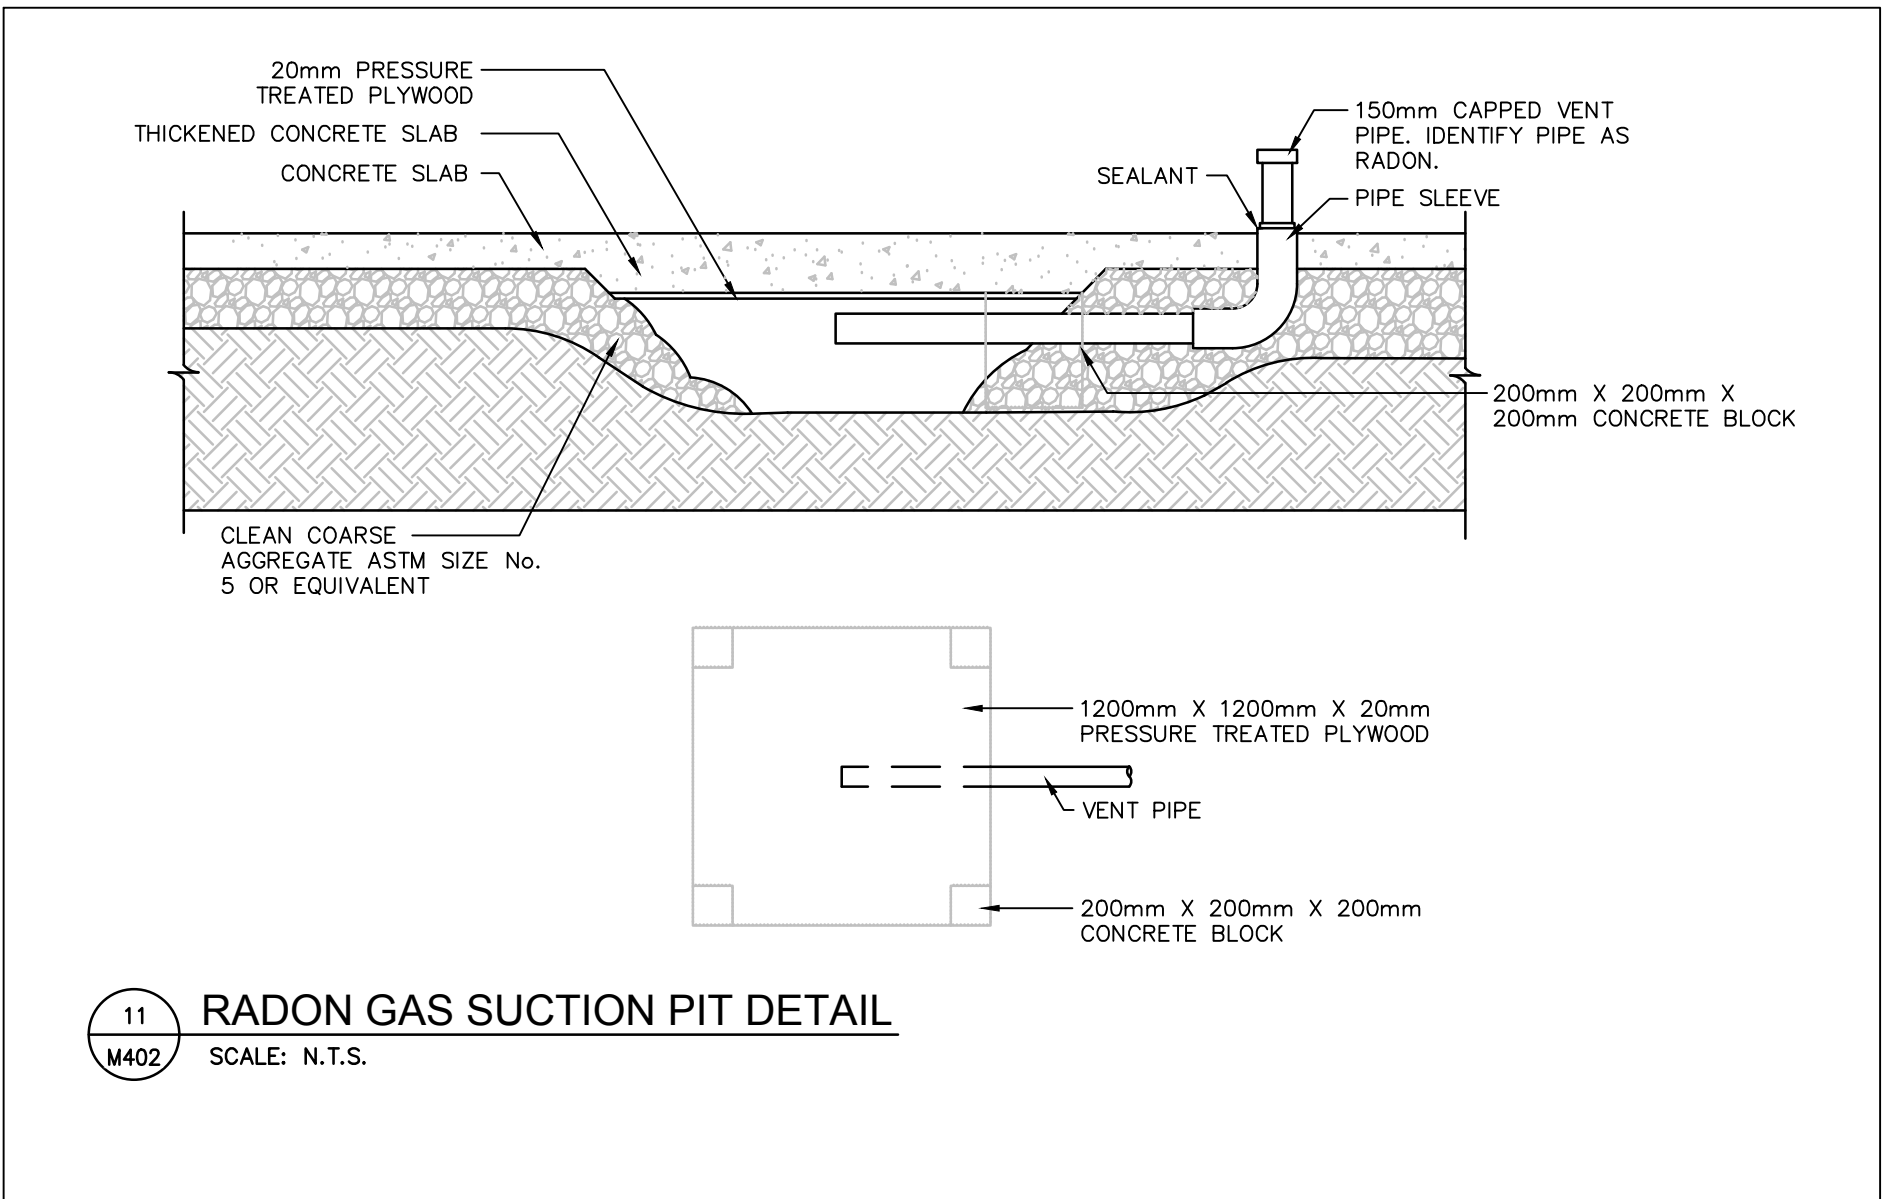
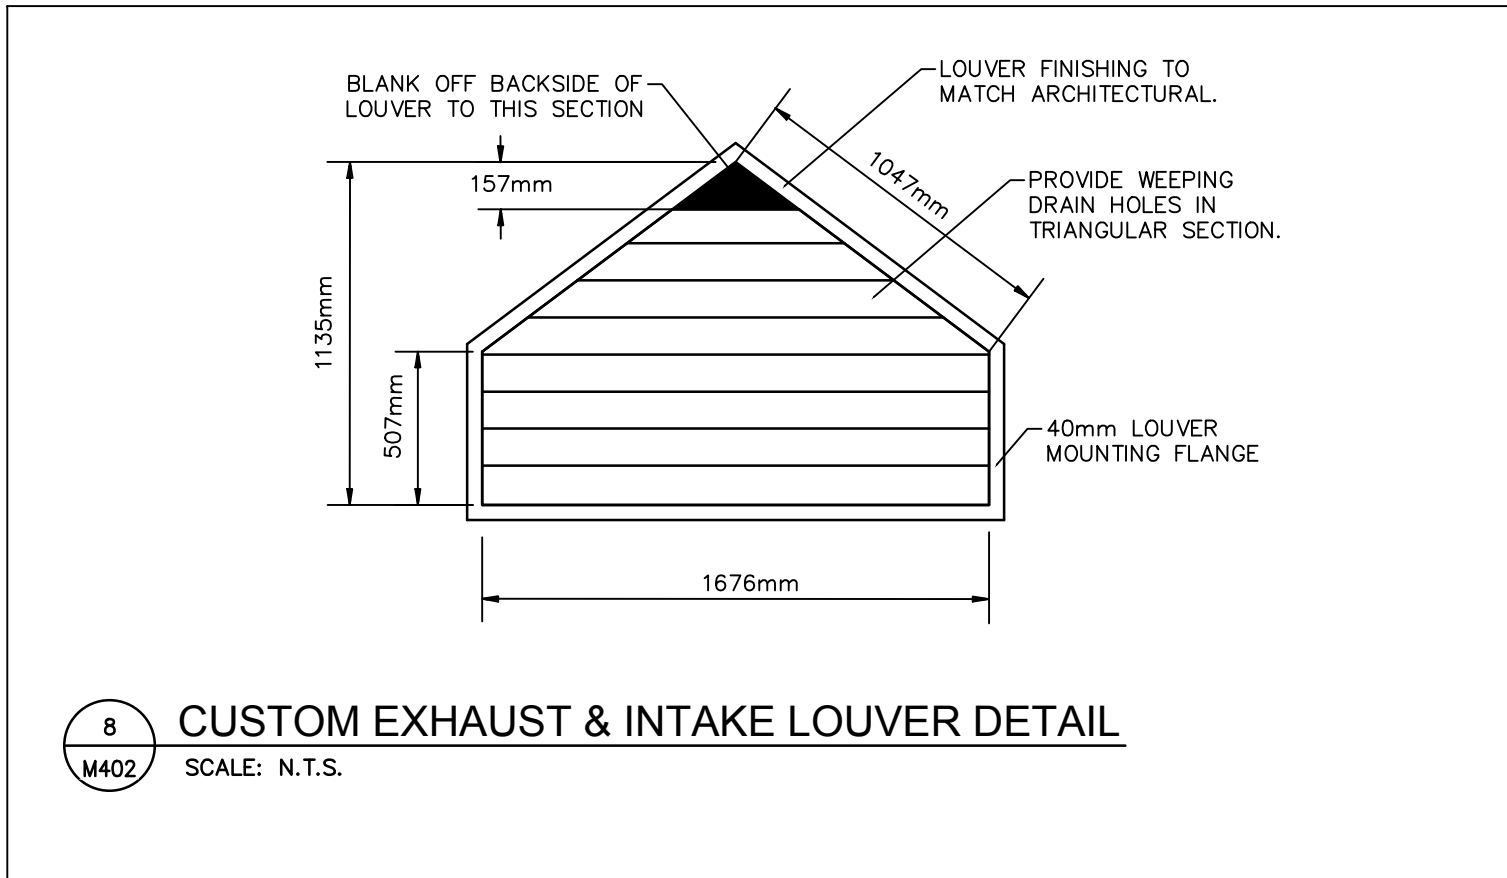
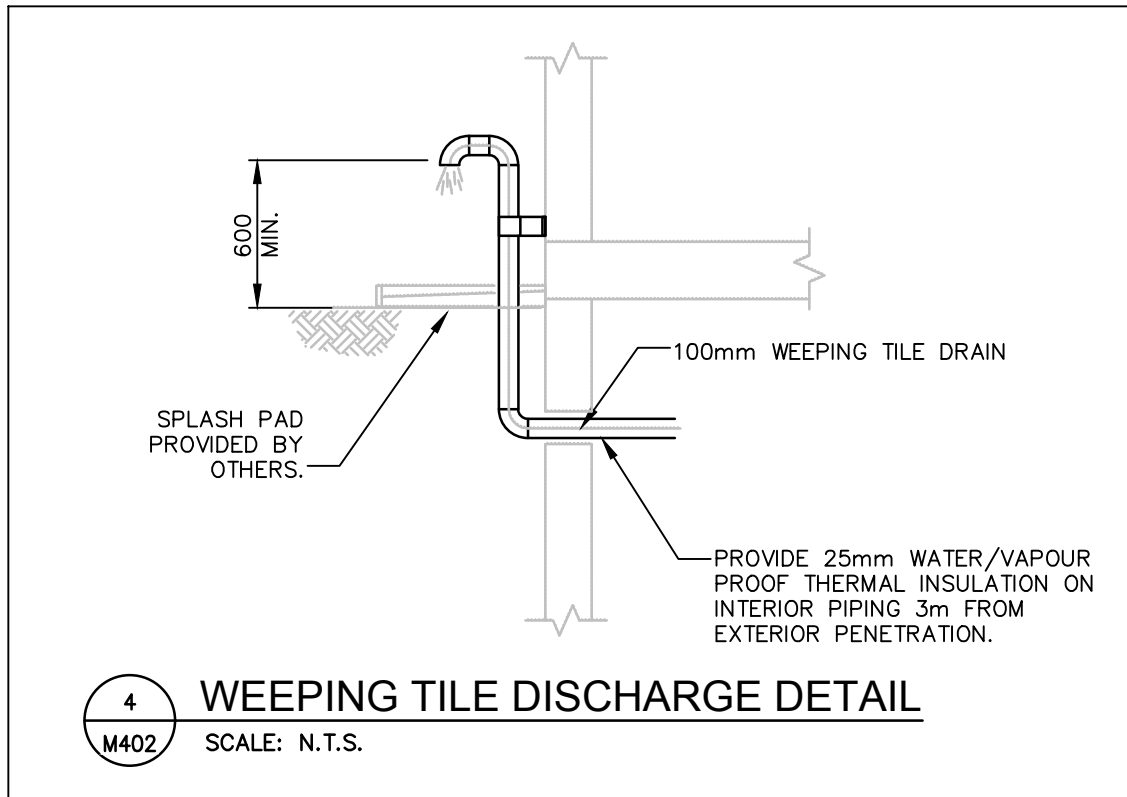
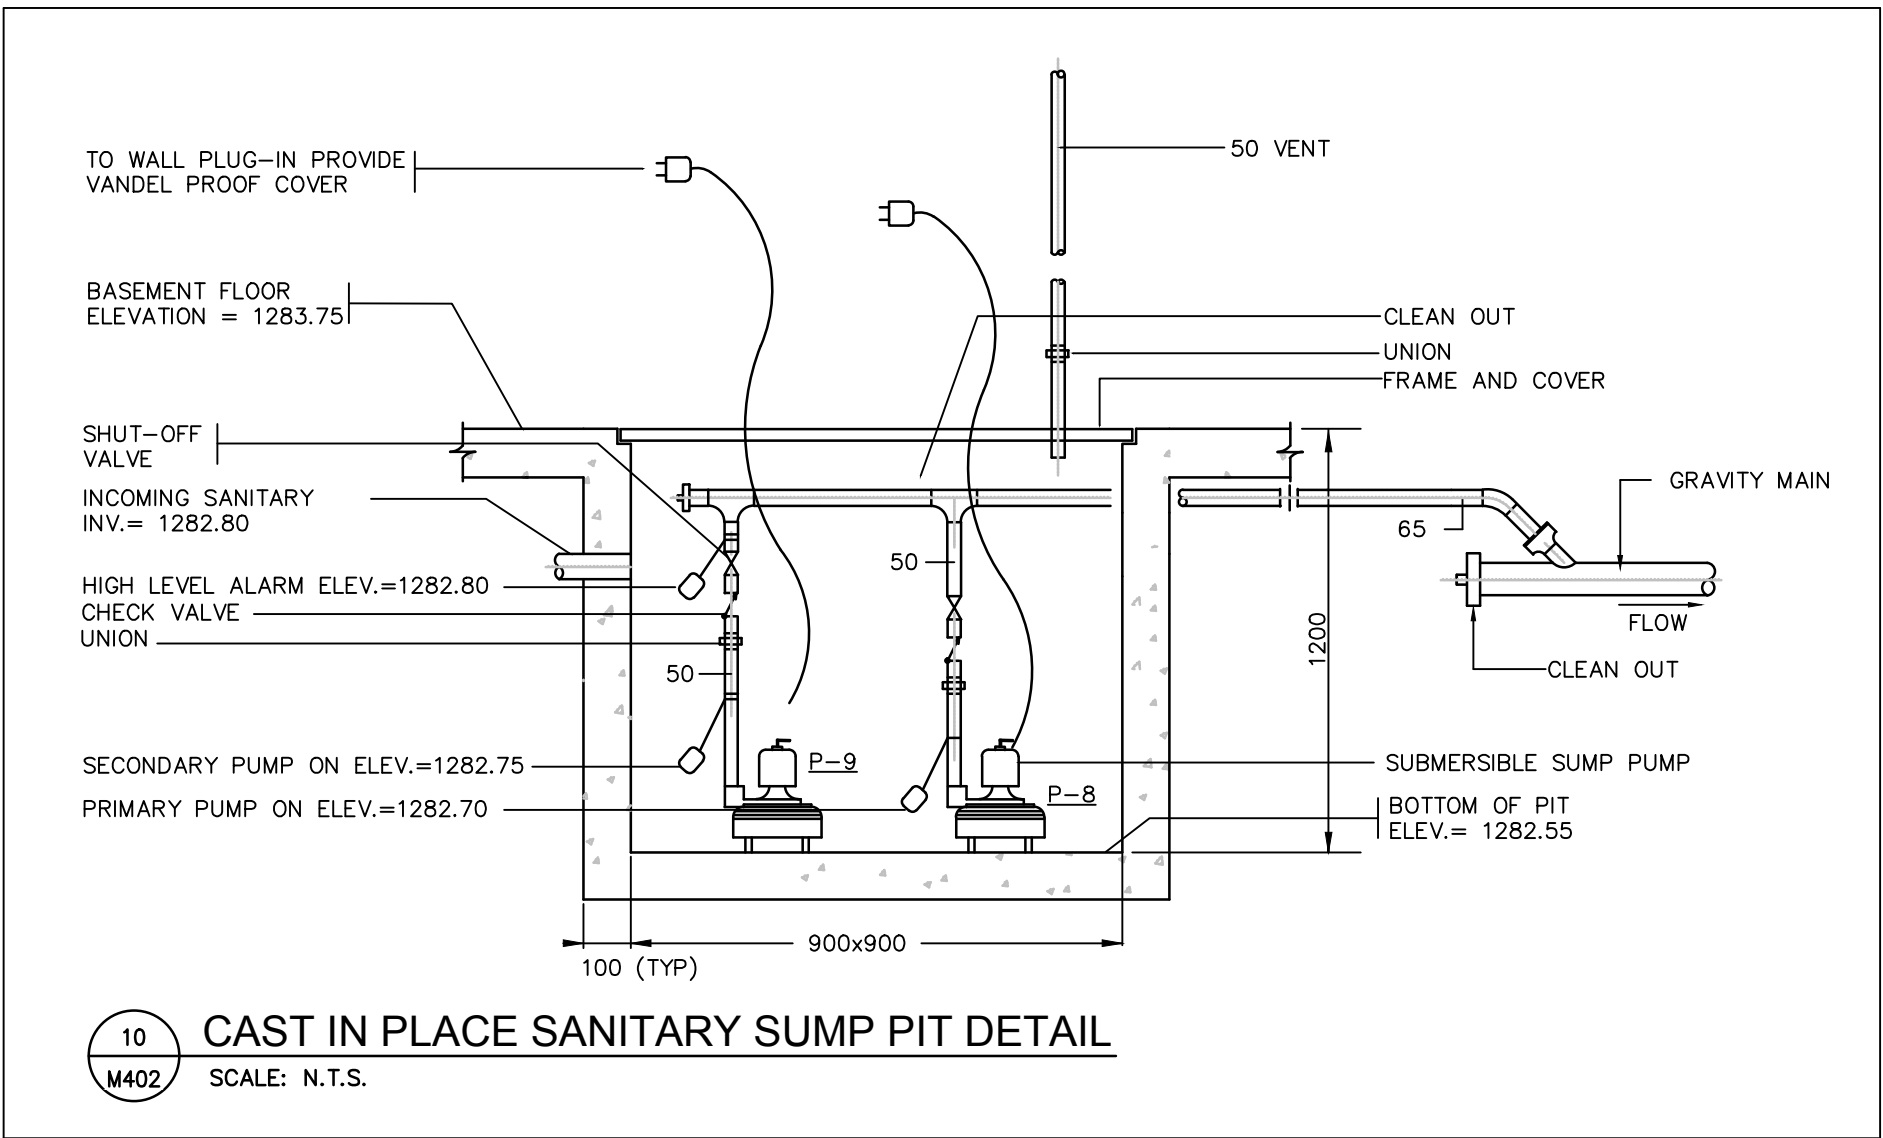
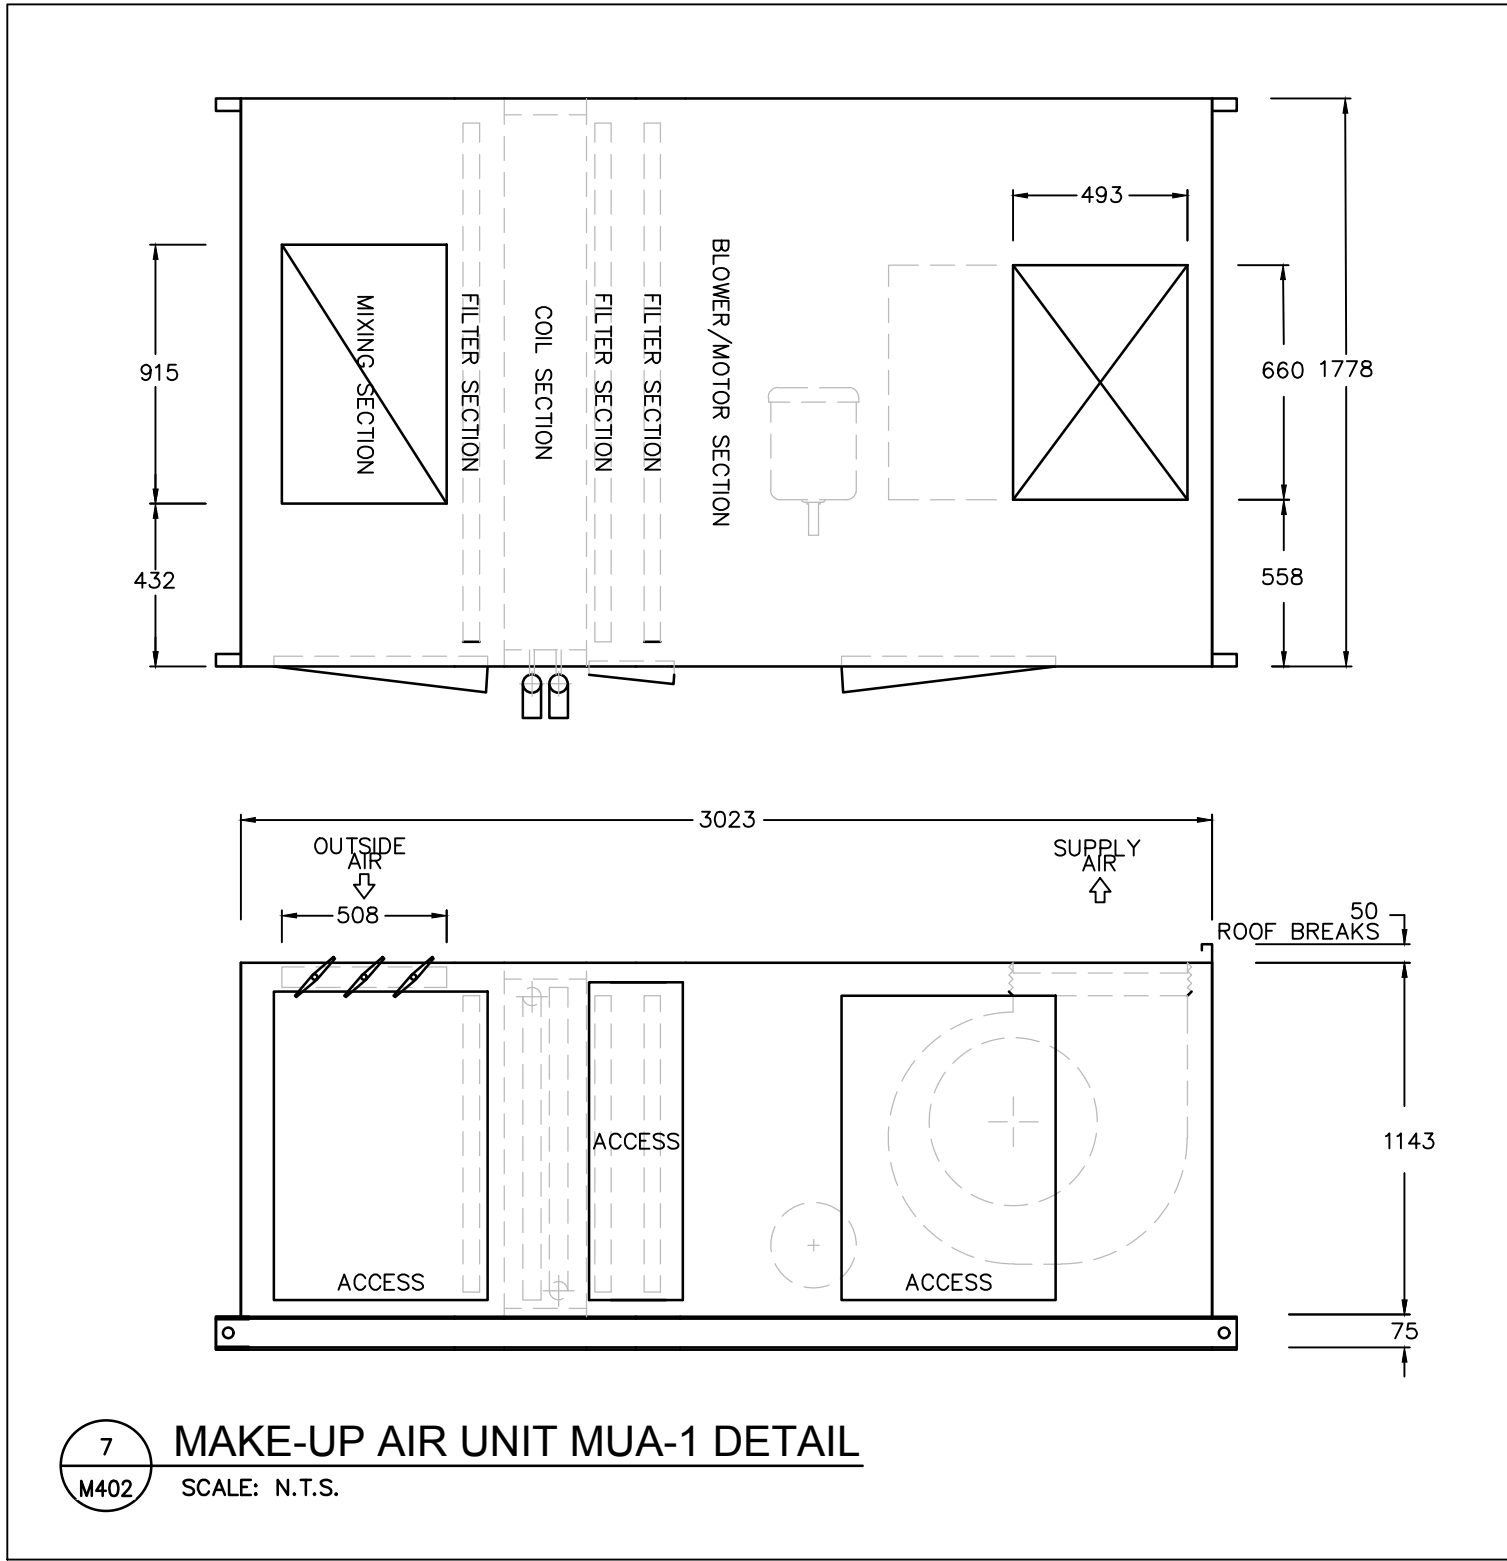
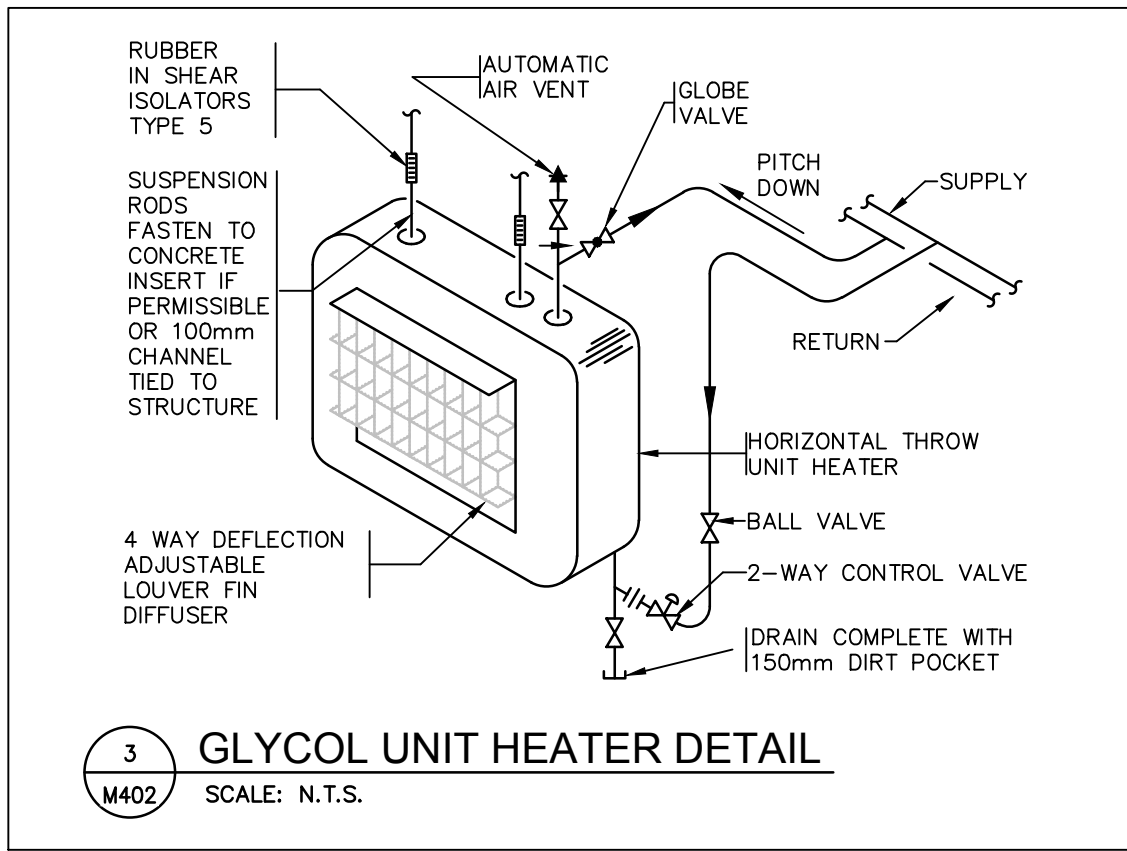
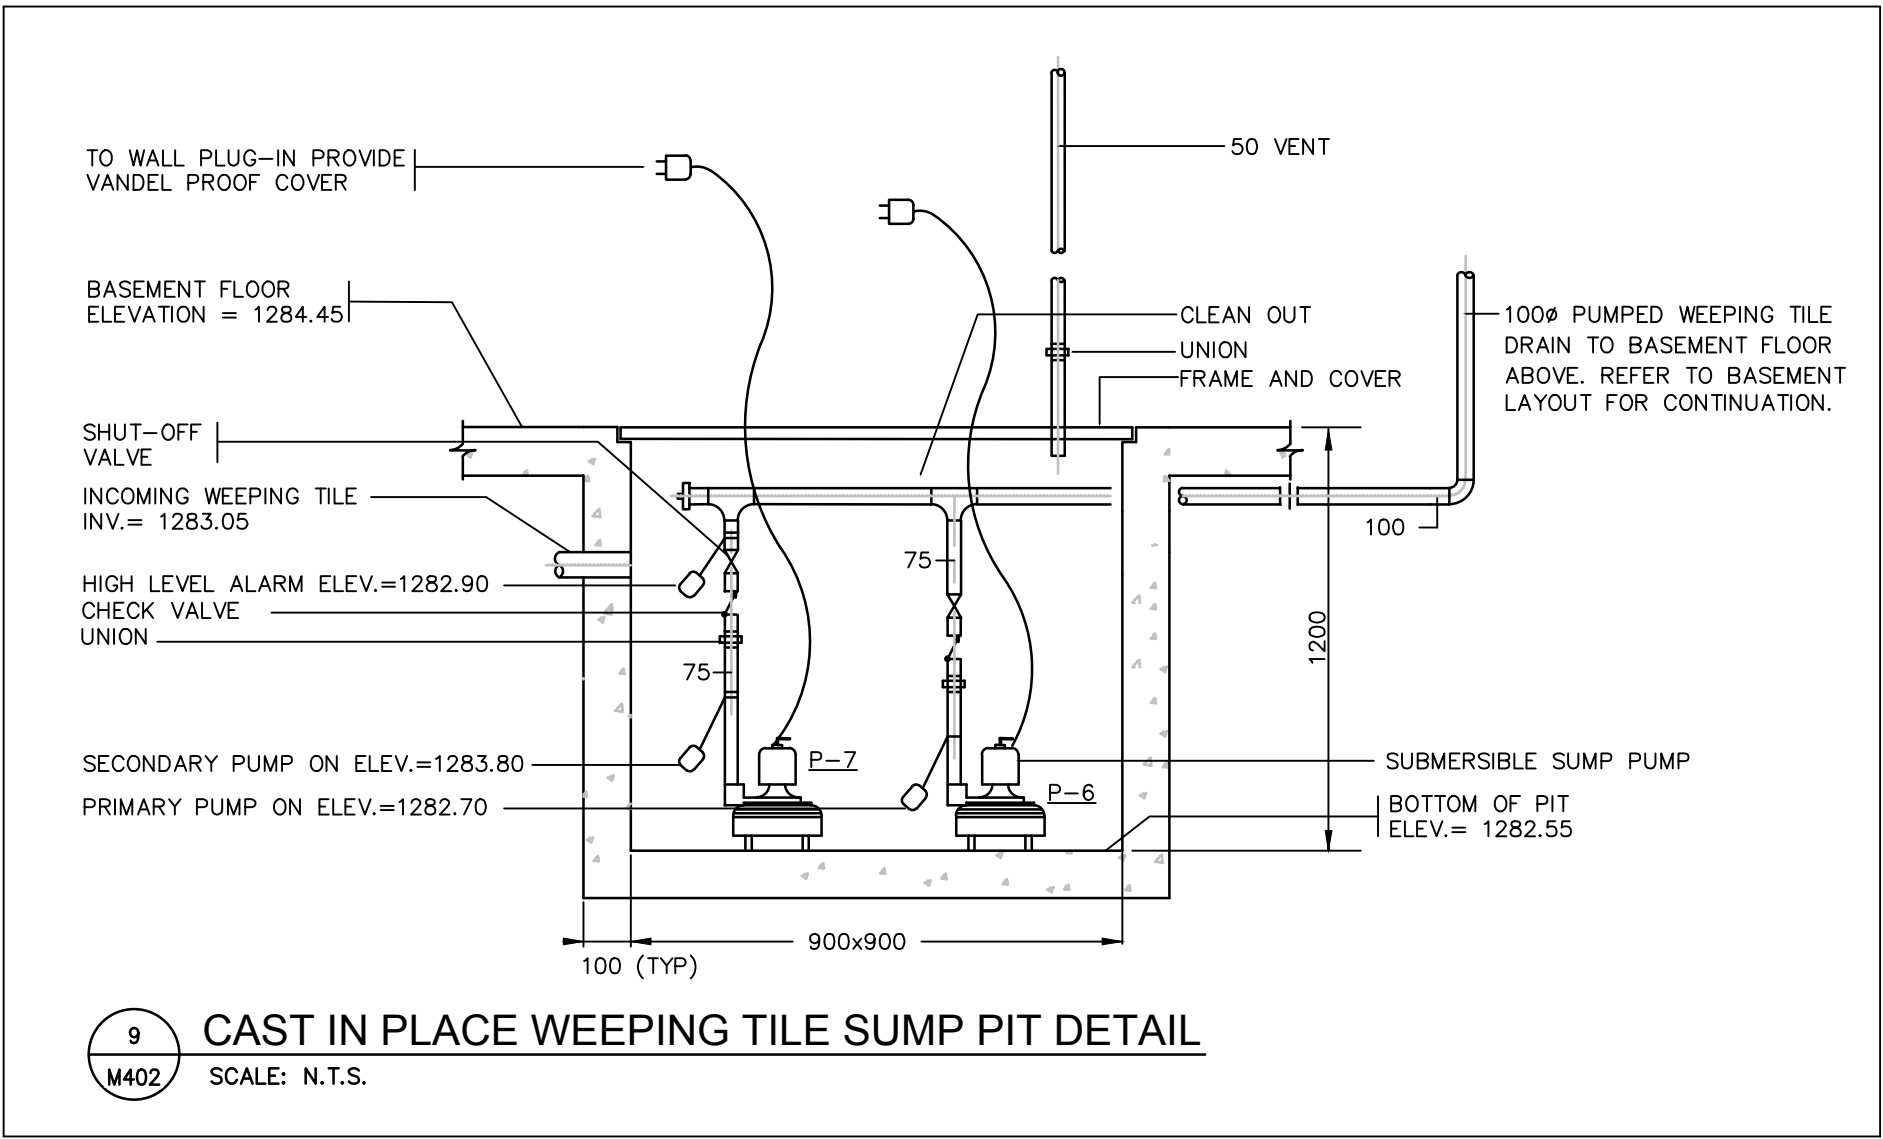
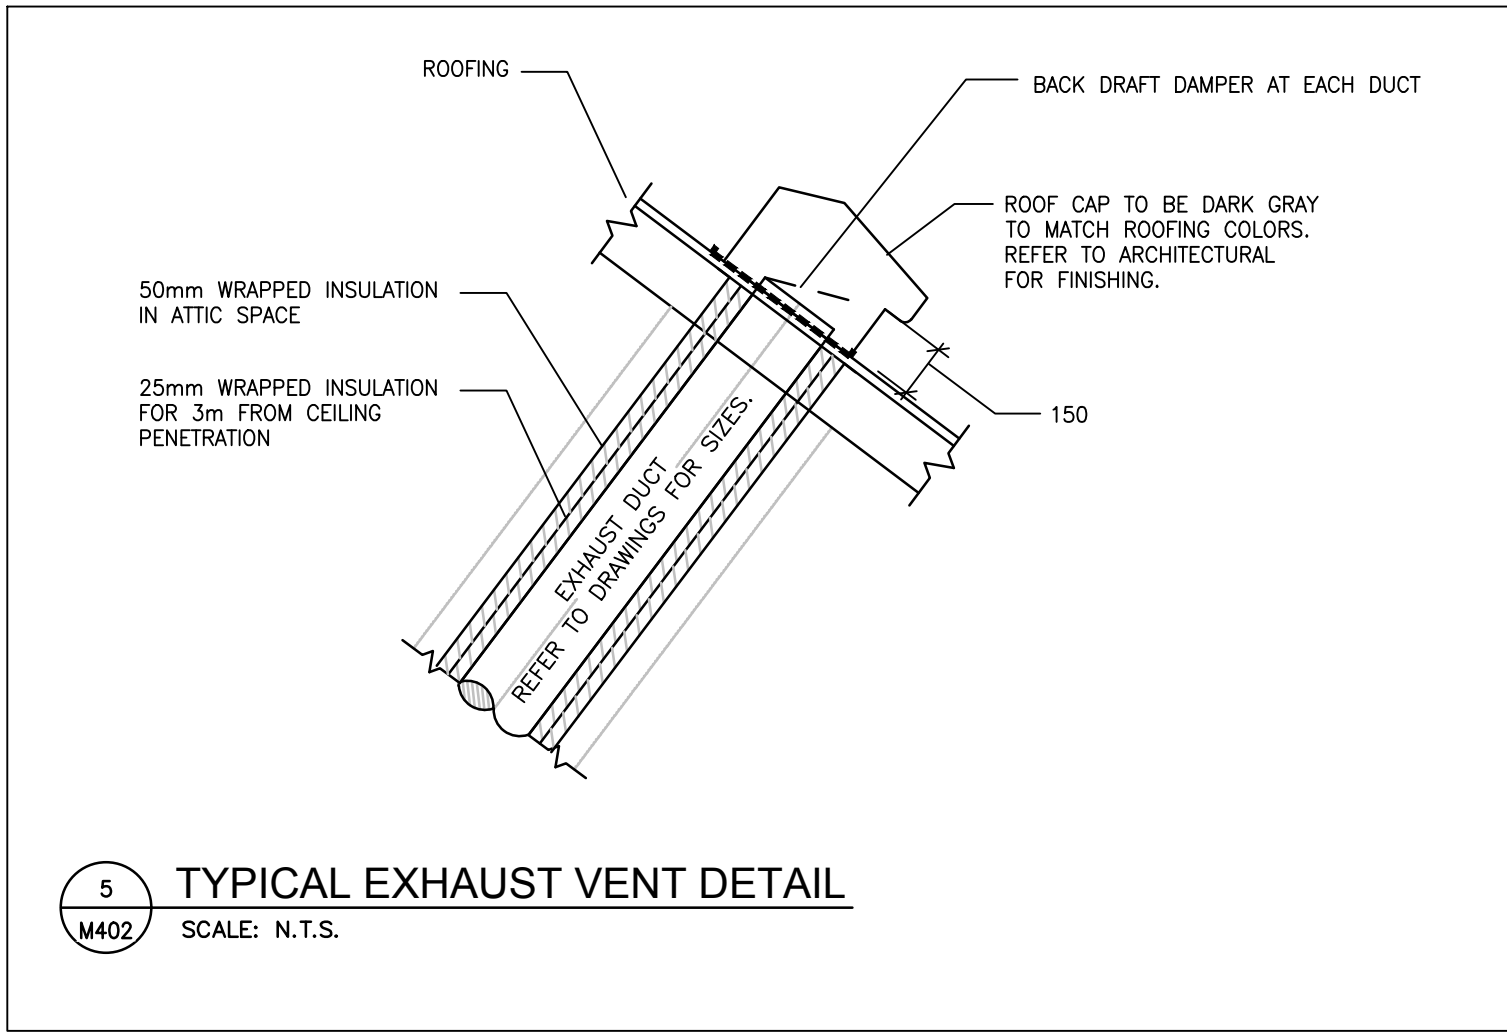
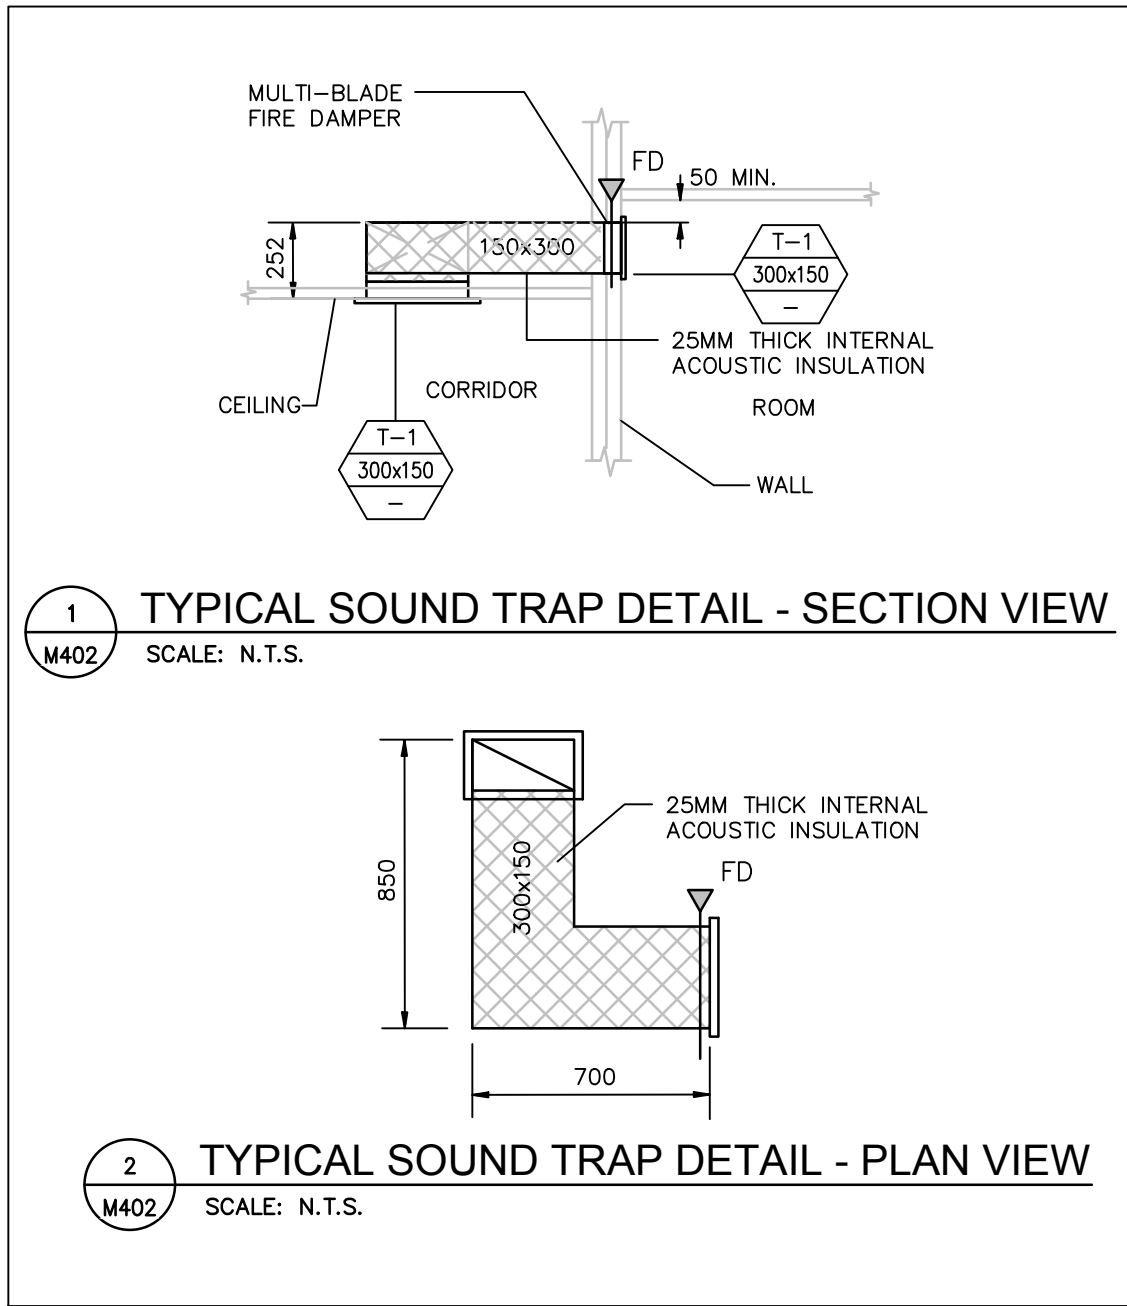
1	125# BROOM EXHAUST DUCT TERMINATION C/W ROOF CAP & BACKDRIFT DAMPER. REFER TO DETAIL 5/M402.	5	100# DRYER EXHAUST DUCT TERMINATION C/W ROOF CAP & BACKDRIFT DAMPER. REFER TO DETAIL 5/M402.
2	175# KITCHEN EXHAUST HOOD TERMINATION C/W ROOF CAP & BACKDRIFT DAMPER. REFER TO DETAIL 5/M402.	6	150# AIR RELIEF DUCT FROM BASEMENT. TERMINATE W/ ROOF CAP REFER TO DETAIL 5/M402.
3	300# BOILER FLUE & 2x 100# DOMESTIC WATER HEATER FLUE IN ARCHITECTURAL CHIMNEY.	7	300x350 COMBUSTION AIR INTAKE GOOSENECK AS SHOWN ON DETAIL 6/M402.
4	150# JANITOR & STORAGE ROOM EXHAUST DUCT TERMINATION. C/W ROOF CAP & BACKDRIFT DAMPER. REFER TO DETAIL 5/M402.		

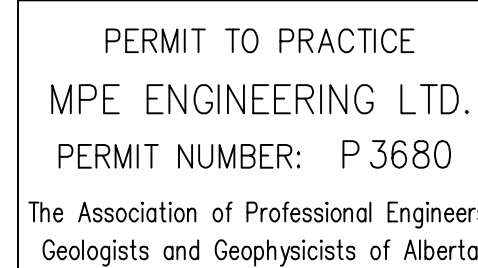		M305
Drawing Reference No./No. de reference du dessin		

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SITE INFORMATION

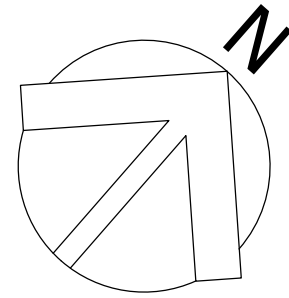MUNICIPAL ADDRESS: WATERTON, WATERTON LAKES NATIONAL PARK
LEGAL LAND DESC.: LOTS 20 & 21 BLOCK 42

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Consultant's Name
Nom de l'expert-conseil

Eng. Stamp
Sceau de l'ingénieur



Public Works and
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Canada

Travaux publics et
Services gouvernementaux
Canada

Client Services Team
Southern Alberta
Operations Branch

Le Client Entretien
Alberta Méridional
Branche d'Opérations

[D&]

Canada

Client/client
Parks Canada
Agence

L'Agence Parcs
Canada

Western and
Northern Region

Ouest et Nord
du Canada

Project title/Titre du projet

Staff Housing Phase 2
Waterton Lakes National
Park

Drawing title/Titre du dessin

MECHANICAL DETAILS

Surveyed by/Arpenté par
C.M.P.

Drawn by/Dessiné par
C.M.P.

Date/Date
2016-04-21

Designed by/Concepté par
C.M.P.

Reviewed by/Revisé par
A.G.K.

Scale/Echelle
AS INDICATED

FWGSC Project Manager/Administrateur de Projets TPSCC
Randy Boldt

Client Acceptance/Acceptation du client
Approved by/Approuvé par

Task Responsible Officer/Agel Responsable
FWGSC Project Manager/Administrateur de Projets TPSCC

Project No./No. du projet
39000

Asset No./No. du-bien
Asset No. 945

Sheet No./
No. de la feuille
M402

Drawing Reference No./No. de référence du dessin

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PLUMBING FIXTURE SCHEDULE				
TAG No.	FIXTURE	DESCRIPTION	TRIM AND ACCESSORIES	
WC-1	TANK TYPE WATER CLOSET – TWO PIECE	PRESSURE–LITE TOILET WITH FLUSHMATE SYSTEM, VTREOUS CHINA, 15" (381) HIGH ELONGATED BOWL, 1.0GPF (3.8 LPF). WHITE REG TANK WITH FLUSHMATE.	ELONGATED TOILET SEAT WITH QUICK DISCONNECT.	
L-1	COUNTER MOUNT LAVATORY	SELF–RIMMING LAVATORY, 20–1/8" (51.1 CM) IN LENGTH AND 16 1/2"" (41.9 CM) IN WIDTH, WITH OVERFLOW. 8" (20.3 CM) CENTERS, 4" (10.2 CM) CENTERS, OR SINGLE–HOLE DRILLING).	DELTA 536–TP–DST ADA COMPLIANT SINGLE HANDLE LAVATORY FAUCET 4" (102MM) CENTERSET, DIAMOND EMBEDDED CERAMIC DISC CARTDRIGE CONTROL MECHANISM. CONTROL HANDLE SHALL RETURN TO NEUTRAL POSITION WHEN VALVE IS TURNED OFF. 1.5GPM (5.7L/MIN) FLOWRATE AT 60PSI STANDARD.	
BT-1	ACRYLIC TUB/SHOWER SURROUND	60"x32" (1524X812.8MM) ONE PIECE ACRYLIC BATH/SHOWER WITH WDE 3–LEVEL CORNER SHELVES. C/W ACCESS PANEL & 3" (76.2MM) ABOVE FLOOR ROUGH–IN.	ROUGH–IN CABLE BATH DRAIN, PVC, 30" (762MM) CABLE WITH TUBING, TRADITIONAL ROTARY TURN BATH DRAIN TRIM. DELTA T13420–QD20–QDN SOLID BRASS FABRICATED BODY FAUCET TRIM, VALVE BODY TO MAINTAIN BALANCED PRESSURE OF HOT AND COLD WATER, 120" MAXIMUM HANDLE ROTATION, FIELD ADJUSTABLE TO LIMIT HANDLE ROTATION INTO HOT WATER ZONE. 1.5GPM (5.7L/MIN).	
SK-1	MULTI PURPOSE DROP IN DOUBLE BASIN STAINLESS STEEL	33"x22"x10" (838X559X255MM) TOP MOUNT DOUBLE–EQUAL BOWL KITCHEN SINK.	DELTA 470–DST SINGLE HANDLE KITCHEN FAUCET FEATURING A SINGLE HOLE MOUNTING CONFIGURATION WITH AN 8" (203.2MM) DECK PLATE. 9" (229MM) LONG SPOUT, INCLUDES DIAMOND COATED CERAMIC CARTRIDGE CONTROL MECHANISM, 53" (1346MM) LONG HOSE WITH 34" (864MM) USABLE LENGTH WITH 3/8" (9.5MM) COMPRESSION FITTINGS. LEVER HANDLE SHALL RETURN TO NEUTRAL POSITION WHEN FAUCET IS TURNED OFF. STANDARD 1.8 GPM (6.8 L/MIN) Ø 414 APO SINK STRAINER, 1 1/2" X 4" (38.1X101.6MM) TAILPIECE, INTEGRATED DOUBLE CHECK VALVE IN SPOUT.	
SK-2	SINGLE BASIN DROP IN STAINLESS UTILITY SINK	BALLAD TOP MOUNT UTILITY SINK, 25"x22" (635X560MM) EXTERIOR DIMENSIONS, 18 GAUGE STAINLESS TOP MOUNT WITH 12" (305MM) DEPTH. INCLUDES INSTALLATON HARDWARE.	DELTA 26C3145 TWO HANDLE HEAVY DUTY CAST BRASS SINK FAUCET C/W 8" (203MM) CENTERS. POLISHED CHROME PLATED FINISH. 1.5GPM (5.7 L/MIN) FLOW CONTROL AERATOR. 8" (203MM) LONG SPOUT.	
FD-1	BASEMENT FLOOR DRAIN	4" (100mm) EPOXY COATED CAST IRON FLOOR DRAIN.	C/W ANCHOR FLANGE, REVERSIBLE MEMBRANE CLAMP WITH PRIMARY AND SECONDARY WEEPHOLES, 1/4" (6) THICK (SPECIFY DIAMETER) NICKEL BRONZE STRAINER.	
FD-2	BASEMENT FLOOR DRAIN	4" (100mm) EPOXY COATED CAST IRON FUNNEL FLOOR DRAIN.	C/W FUNNEL, ANCHOR FLANGE, REVERSIBLE MEMBRANE CLAMP WITH PRIMARY AND SECONDARY WEEPHOLES, 1/4" (6) THICK (SPECIFY DIAMETER) NICKEL BRONZE STRAINER.	
HB-1	NON–FREEZE HOSE BIBB	NON–FREEZE WALL HYDRANT WITH CROME FACE & INTEGRAL VACUUM BREAKER.	NON–FREEZE KEY OPERATED WALL HYDRANT WITH CHROME PLATED FACE, INTEGRAL VACUUM BREAKER, 3/4" (19) HOSE CONNECTION, 3/4" (19) FEMALE x 1" (25) MALE PIPE CONNECTION, ALL BRONZE HEAD, SEAT CASTING AND INTERNAL WORKING PARTS, BRONZE WALL CASING, AND LOOSE KEY.	
HB-2	BASEMENT HOSE BIBB	CAST BRASS HOSE BIBB	BUILT–IN BACKFLOW PROTECTION, INTEGRAL VACUUM BREAKER, DRAINABLE IN COLD WEATHER.	
SH-1	SHOWER	ONE PIECE SHOWER STALL SIZE – 48"x37"x80" (1219MM X 940MM X 2032MM), VACUUM FORMED ACRYLIC REINFORCED WITH FIBERGLASS, SCRATCH, STAIN AND FADE RESISTANT HIGH GLOSS FINISH, CHROME DRAIN IS INCLUDED, FEATURES AN ACRYLIC TOWEL BAR AND 6 LARGE SHELVES, BUILT IN 1" (25) TILE FLANGE ON 3 SIDES, PATTERNED BOTTOM, PROVIDE SLIDING GLASS DOOR W/ CHROME TRIMS. REFER TO ARCHITECTURAL.	ROUGH–IN CABLE BATH DRAIN, PVC, 30" (762MM) CABLE WITH TUBING, TRADITIONAL ROTARY TURN BATH DRAIN TRIM. DELTA T13020–QDN SOLID BRASS FABRICATED BODY FAUCET TRIM, VALVE BODY TO MAINTAIN BALANCED PRESSURE OF HOT AND COLD WATER, 120" MAXIMUM HANDLE ROTATION, FIELD ADJUSTABLE TO LIMIT HANDLE ROTATION INTO HOT WATER ZONE. 1.5GPM (5.7L/MIN).	
SH-2	BARRIER FREE SHOWER	BARRIER FREE SHOWER STALL SIZE – 60"x37"x75" (1524MM X 940MM X 1905MM), VACUUM FORMED ACRYLIC REINFORCED WITH FIBERGLASS, SCRATCH, STAIN AND FADE RESISTANT HIGH GLOSS FINISH, CHROME DRAIN IS INCLUDED, PROVIDE L–SHAPED STAINLESS STEEL GRAB BAR ON EACH SIDE WALL, TWO STAINLESS STEEL GRAB BAR ON BACK WALL, 1" (25.4MM) STAINLESS STEEL CURTAIN ROD, LEFT–HAND SEAT, UPPER AND LOWER TOILETRY SHELVES. SHOWER TRIM INSTALLED ON RIGHT HAND SIDE.	ROUGH–IN CABLE BATH DRAIN, PVC, 30" (762MM) CABLE WITH TUBING, TRADITIONAL ROTARY TURN BATH DRAIN TRIM. DELTA T13020–QDN SOLID BRASS FABRICATED BODY FAUCET TRIM, VALVE BODY TO MAINTAIN BALANCED PRESSURE OF HOT AND COLD WATER, 120" MAXIMUM HANDLE ROTATION, FIELD ADJUSTABLE TO LIMIT HANDLE ROTATION INTO HOT WATER ZONE. 1.5GPM (5.7L/MIN).	
MS-1	MOP SINK	24"x24"x10" (610x610x254mm) HOMOGENOUS ONE–PIECE STONE MOP SERVICE BASIN, C/W 3" (76mm) DRAIN PIPE CONNECTION, STAINLESS STEEL DRAIN BODY, DOME STRAINER & LINT BASKET.	3GPM (18 L/MIN) CHROME PLATED CAST BRASS 2 HANDLE SERVICE FAUCET C/W WALL BRACE, INLINE VACUUM BREAKER, PAIL HOOK, INTEGRAL STOPS, AND 8" (203mm) CENTERS, PROVIDE STAINLESS STEEL MOP HANGER 3" QUICK DRAIN CONNECTOR, HEAVY DUTY HOSE, HOSE BRACKET, & SILICONE SEALANT.	

FORCE FLOW SCHEDULE (HYDRONIC)

TAG No.	LOCATION/SERVICE	AIR SIDE		HEATING				MOTOR				MCA	WEIGHT (kg)	REMARKS
		FLOW (L/s)	PRESS. DROP (Pa)	FLUID	HEATING CAPACITY (kW)	ENT. FLUID (°C)	LVG. FLUID (°C)	FLUID FLOW (L/s)	PRESS. DROP (kPa)	POWER (Watts)	RPM			
FF-A	ENTRANCE & ELECTRICAL ROOM	NORMAL BOOST 39 59	–	50% GLYCOL	1.8	87.8	–	0.063	3.2	40	–	115/1/60	–	10.8
FF-B	BATHROOMS	NORMAL BOOST 19 25	–	50% GLYCOL	0.94	87.8	–	0.063	2.3	25	–	115/1/60	–	5.5
FF-C	ENTRANCE & ELECTRICAL ROOM	NORMAL BOOST 19 25	–	50% GLYCOL	0.96	87.8	–	0.063	2.3	40	–	115/1/60	–	9.5

RADIATION SCHEDULE (BASEBOARD)

TAG No.	LOCATION/SERVICE	ENCLOSURE HEIGHT ft. (mm)	ELEMENT		AVG. WATER TEMP. °F (°C)	CAPACITY Btu/h (kW/m)	REMARKS
			TUBE Ø in (mm)	FIN SIZE in x in (mm x mm)			
TYPE A	RESIDENTIAL SUITES, STAIR LANDING	8 (203.2)	0.75 (19.1)	2.5 x 1.25 (64 x 83)	170.0 (77)	565 (0.54)	SLOPED TOP CABINET, 102mm ABOVE FINISHED FLOOR TO UNDERSIDE OF CABINET.
TYPE B	BASEMENT	14 (355.6)	1.25 (31.8)	4 x 4 (102 x 102)	170.0 (77)	869 (0.84)	SLOPED TOP AND BOTTOM CABINET, 1200mm ABOVE FINISHED FLOOR TO UNDERSIDE OF CABINET UNLESS OTHERWISE INDICATED IN MECHANICAL OR ARCHITECTURAL PLANS.

LOUVER SCHEDULE

TAG No.	FINISH	MOUNTING	REMARKS/DESCRIPTION
L-1	BAKED ENAMEL, COLOUR BY ARCHITECT	DUTCH CABLE EXTERIOR WALL	WIND–DRIVEN RAIN LOUVER EXTRUDED ALUMINUM FREE AREA VELOCITY 5m/s (1000fpm), PRESSURE DROP 248.6kPa (0.3mwg), WATER PENETRATION AT 6.35m/s, 202mm/h RAINFALL AND 22m/s WIND – 99.8% EFFECTIVENESS. C/W INSECT SCREEN. REFER TO DETAIL 8 ON DWG M402 FOR SIZES AND DIMENSIONS.

UNIT HEATER SCHEDULE (HYDRONIC)

TAG No.	LOCATION/SERVICE	AIR SIDE		HEATING				MOTOR				MCA	WEIGHT (kg)	REMARKS
		FLOW (L/s)	PRESS. DROP (Pa)	FLUID	HEATING CAPACITY (kW)	ENT. FLUID (°C)	LVG. FLUID (°C)	FLUID FLOW (L/s)	PRESS. DROP (kPa)	POWER (Watts)	RPM			
UH-1	PARKS STORAGE B9	260	–	50% GLYCOL	6.6	87.8	–	0.09	0.9	37	1500	115/1/60	–	40
UH-2	TENANT STORAGE B8	260	–	50% GLYCOL	6.6	87.8	–	0.09	0.9	37	1500	115/1/60	–	40
UH-3	TENANT STORAGE B8	260	–	50% GLYCOL	6.6	87.8	–	0.09	0.9	37	1500	115/1/60	–	40
UH-4	MECHANICAL ROOM B7	260	–	50% GLYCOL	6.6	87.8	–	0.09	0.9	37	1500	115/1/60	–	40
UH-5	TENANT STORAGE B3	260	–	50% GLYCOL	6.6	87.8	–	0.09	0.9	37	1500	115/1/60	–	40
UH-6	PARKS STORAGE B4	260	–	50% GLYCOL	6.6	87.8	–	0.09	0.9	37	1500	115/1/60	–	40
UH-7	PARKS STORAGE B4	260	–	50% GLYCOL	6.6	87.8	–	0.09	0.9	37	1500	115/1/60	–	40

GRILLE & DIFFUSER SCHEDULE

TAG No.	FINISH	MOUNTING	REMARKS/DESCRIPTION
S-1	WHITE POWDER COAT	WALL / CEILING	LOUVERED SUPPLY DOUBLE DEFLECTION STEEL CONSTRUCTION, 3/4 IN. [19] BLADE SPACING, FRONT BLADES PARALLEL TO LONG DIMENSION COUNTERSUNK SCREWHOLES A C/W OVAL–HEAD SCREWS
S-2	WHITE POWDER COAT	WALL / CEILING	LOUVERED SUPPLY DOUBLE DEFLECTION STEEL CONSTRUCTION, 3/4 IN. [19] BLADE SPACING, FRONT BLADES PARALLEL TO SHORT DIMENSION COUNTERSUNK SCREWHOLES A C/W OVAL–HEAD SCREWS
E-1	WHITE POWDER COAT	WALL / CEILING	LOUVERED RETURN DOUBLE DEFLECTION STEEL CONSTRUCTION, 3/4 IN. [19] BLADE SPACING, FRONT BLADES PARALLEL TO LONG DIMENSION COUNTERSUNK SCREWHOLES A C/W OVAL–HEAD SCREWS
T-1	WHITE POWDER COAT	WALL / CEILING	LOUVERED RETURN DOUBLE DEFLECTION STEEL CONSTRUCTION, 3/4 IN. [19] BLADE SPACING, FRONT BLADES PARALLEL TO LONG DIMENSION COUNTERSUNK SCREWHOLES A C/W OVAL–HEAD SCREWS
T-2	BP DARK BRONZE, PAINT TO MATCH DOOR	DOOR	STEEL FIRE RATED DOOR GRILLE UP TO 1.5 HR RATING. 71°C LISTED FUSIBLE LINK WITH STAINLESS STEEL OPERATING SPRING AND DEADLOCK BAR. DOOR CUTOUT MUST BE THE SAME SIZE AS LOUVER SIZE. 45% FREE AREA.

TANK SCHEDULE

TAG No.	LOCATION/SERVICE	FLUID	TANK VOLUME gal (L)	MAX ACCEPTANCE VOLUME gal (L)	DIMENSIONS		REMARKS
					DIAMETER in (mm)	LENGTH in (mm)	
TK-1	MECH. ROOM GLYCOL EXPANSION	50% GLYCOL	68 (257)	34 (129)	24 (600)	47 (1194)	VERTICAL ORIENTATION EXPANSION TANK. PROVIDE 100mm HOUSE KEEPING PAD.
TK-2	MECH. ROOM DOMESTIC WATER EXPANSION	HOT WATER	6.4 (24.2)	3.2 (12.1)	12 (300)	14 (350)	VERTICAL ORIENTATION EXPANSION TANK. STRAP MOUNT TO WALL.
TK-3	MECH. ROOM GLYCOL FEED SYSTEM	50% GLYCOL	45 (160)		22 (560)	36 (930)	VERTICAL ORIENTATION GLYCOL FILL TANK. C/W MANUAL CONTROL PUMP – 249 W MOTOR, 120/1/60.

PUMP SCHEDULE

TAG No.	LOCATION	SERVICE	TYPE	FLUID	FLOW gpm (L/s)	HEAD ft. (kPa)	MOTOR HP (kW)	RPM	ELECTRICAL (V/Ph/Hz)	REMARKS
P-1	MECHANICAL ROOM	PRIMARY HEATING	IN–LINE CIRCULATOR	50% GLYCOL	44 (2.8)	5 (0.26)	0.19 (0.19)	1800	115/1/60	C/W 3 SPEED MOTOR.
P-2	MECHANICAL ROOM	PRIMARY HEATING	IN–LINE CIRCULATOR	50% GLYCOL	44 (2.8)	5 (0.26)	0.19 (0.19)	1800	115/1/60	C/W 3 SPEED MOTOR.
P-3	MECHANICAL ROOM	SECONDARY HEATING	IN–LINE	50% GLYCOL	76 (4.79)	25 (74.73)	1 (0.75)	1705	208/1/60	C/W INTEGRATED SINGLE PHASE VFD, INTEGRAL CONTROLLER, BUILT–IN DIFFERENTIAL–PRESSURE & TEMPERATURE SENSOR.
P-4	MECHANICAL ROOM	SECONDARY HEATING	IN–LINE	50% GLYCOL	76 (4.79)	25 (74.73)	1 (0.75)	1705	208/1/60	C/W INTEGRATED SINGLE PHASE VFD, INTEGRAL CONTROLLER, BUILT–IN DIFFERENTIAL–PRESSURE & TEMPERATURE SENSOR.
P-5	MECHANICAL ROOM	DOMESTIC HOT WATER RECIRC.	IN–LINE CIRCULATOR	WATER	44 (0.2)	5 (20.9)	0.10 (0.08)	–	115/1/60	C/W TIME CLOCK.
P-6	BASEMENT	STORM SUMP PUMP	SUBMERSIBLE PUMP	STORM WATER	100 (6.39)	15 (44.8)	0.75 (0.56)	1725	115/1/60	C/W 3 FLOAT SYSTEM.
P-7	BASEMENT	STORM SUMP PUMP	SUBMERSIBLE PUMP	STORM WATER	100 (6.39)	15 (44.8)	0.75 (0.56)	1725	115/1/60	C/W 3 FLOAT SYSTEM.
P-8	BASEMENT	SANITARY SUMP PUMP	SANITARY PUMP	SANITARY WATER	15 (0.9)	8 (23.9)	0.33 (0.25)	3450	115/1/60	C/W 3 FLOAT SYSTEM.
P-9	BASEMENT	SANITARY SUMP PUMP	SANITARY PUMP	SANITARY WATER	15 (0.9)	8 (23.9)	0.33 (0.25)	3450	115/1/60	C/W 3 FLOAT SYSTEM.

BOILER SCHEDULE

TAG No.	LOCATION/SERVICE	TYPE	FUEL	INPUT (INC. ALTITUDE CORRECTION) MBH (kW)	OUTPUT (INC. ALTITUDE CORRECTION) MBH (kW)	FLUID TYPE	FLUID TEMP. IN °F (°C)	FLUID TEMP. OUT °F (°C)	FLUID FLOW gpm (L/s)	PRESS. DROP PSI (kPa)	VOLTAGE	WEIGHT lbs (kg)	REMARKS
B-1	BASEMENT MECHANICAL ROOM	85% EFFICIENCY	N.GAS	909 (267.0)	688 (201.7)	50% GLYCOL	150.0 (66)	190.0 (88)	43.9 (2.8)	1	120/1/60	603 273	MODULATING BURNER WITH 5:1 TURN DOWN, COPPER–FINNED TUBE HEAT EXCHANGER. C/W BAROMETRIC DAMPER, OPERATING CONTROL AND DATA LOGGING.
B-2	BASEMENT MECHANICAL ROOM	85% EFFICIENCY	N.GAS	909 (267.0)	688 (201.7)	50% GLYCOL	150.0 (66)	190.0 (88)	43.9 (2.8)	1	120/1/60	603 273	MODULATING BURNER WITH 5:1 TURN DOWN, COPPER–FINNED TUBE HEAT EXCHANGER. C/W BAROMETRIC DAMPER, OPERATING CONTROL AND DATA LOGGING.

DOMESTIC WATER HEATER SCHEDULE (GAS)

TAG No.	LOCATION	FUEL	INPUT MBH (kW)	RECOVERY RATE gal/hr @ 100 °F RISE (L/hr @ 56°C RISE)	STORAGE CAPACITY GAL (L)	ELECTRICAL (V/Ph/Hz)	MCA	WEIGHT lbs (kg)	REMARKS
DWH-1	BASEMENT MECHANICAL ROOM	N.GAS	150 (43.96)	148 (560.92)	100 (378.5)	120/1/60	FRAC	523 (237.23)	HIGH EFFICIENCY MODULATING BURNER. HEAT EXCHANGER TO BE INTERNALLY & EXTERNALLY GLASS COATED. C/W LCD DISPLAY, SYSTEM DIAGNOSTICS & RUN TIME HISTORY. C/W CONDENSATE NEUTRALIZATION TANK.
DWH-2	BASEMENT MECHANICAL ROOM	N.GAS	150 (43.96)	148 (560.92)	100 (378.5)	120/1/60	FRAC	523 (237.23)	HIGH EFFICIENCY MODULATING BURNER. HEAT EXCHANGER TO BE INTERNALLY & EXTERNALLY GLASS COATED. C/W LCD DISPLAY, SYSTEM DIAGNOSTICS & RUN TIME HISTORY. C/W CONDENSATE NEUTRALIZATION TANK.

FAN SCHEDULE

TAG No.	LOCATION	SERVICE	AIR FLOW CFM (L/s)	E.S.P. in. w.c. (Pa)	MOTOR HP (kW)	RPM	ELECTRICAL (V/Ph/Hz)	MOUNTING ARR'GT	WEIGHT lbs (kg)	REMARKS
EF-1	BASEMENT	BASEMENT VENTILATION	4550 (2146)	0.75 (186.6)	1 (0.75)	1725	208/1/60	CEILING HUNG	565 (256)	CEILING HUNG VANE AXIAL BELT DRIVE FAN C/W INTEGRAL SOUND TRAP IN HOUSING, SOUND LEVEL 58dB.
EF-A	BATHROOM	BATHROOM VENTILATION	115 (54)	0.125 (31.1)	0.12 (0.09)	630	115/1/60	RECESSED CEILING	24 (11)	RECESSED CEILING MOUNTED EXHAUST FAN C/W ON/OFF SWITCH.
EF-B	JANITOR ROOMS INDOOR STORAGE	VENTILATION FAN	157 (66)	0.125 (31.1)	0.13 (0.1)	710	115/1/60	CEILING MOUNTED	23.7 (10.5)	CEILING SURFACE MOUNTED VENTILATION FAN.
BF-A	BASEMENT LAUNDRY	DRYER BOOSTER FAN	115 (61.4)	0.76 (189.1)	0.11 (0.08)	2500	115/1/60	WALL MOUNTED	–	WALL MOUNTED AS PER MANUFACTURER SPECIFICATIONS. CONNECTION TO DRYER CONTROL BOX BY ELECTRICAL. C/W LINT TRAP.
TF-1	BASEMENT ELECTRICAL ROOM	TRANSFER FAN	157 (66)	0.125 (31.1)	0.13 (0.1)	710	115/1/60	CEILING MOUNTED	23.7 (10.5)	CEILING SURFACE MOUNTED TRANSFER FAN C/W REVERSE ACTING THERMOSTAT.

MAKE–UP AIR UNIT SCHEDULE (HYDRONIC)


UNIT No.	LOCATION	SERVICE	AIR				MCA	HEATING							WEIGHT lbs (kg)	REMARKS
			CAPACITY cfm (L/s)	E.S.P. in. w.c. (Pa)	MOTOR BHP (kW)	MOTOR HP (kW)		ELECTRICAL (V/Ph/Hz)	EDBT. °F. (°C)	LDBT. °F. (°C)	EW. °F. (°C)	LWT. °F. (°C)	FLUID GPM (L/s)	PRESSURE DROP (kPa)		
MUA-1	BASEMENT MECHANICAL ROOM	BUILDING	7050 (3326)	1.5 (374)	6.1 (4.5)	7.5 (5.6)	208/1/60	46.8	668.7 (–31.0)	50% GLYCOL	73.5 (23.1)	190 (87.8)	50 (71.3)	8.6 (25.6)	2,685 (1218)	C/W SUMMER & WINTER FILTERS. PROVIDE MERV 13 FINAL FILTER. TERMINAL BLOCKS TO ACCEPT NO.6 AWG.

SITE INFORMATION

MUNICIPAL ADDRESS: WATERTON, WATERTON LAKES NATIONAL PARK
LEGAL LAND DESC.: LOTS 20 & 21 BLOCK 42

5	16-12-08	ISSUED FOR TENDER	C.M.P.	A.G.K.
4	16-12-08	ISSUED FOR BP	C.M.P.	A.G.K.
3	16-09-02	ISSUED FOR 99% REVIEW	C.M.P.	A.G.K.
2	16-06-14	ISSUED FOR 66% REVIEW	C.M.P.	A.G.K.
1	16-05-05	ISSUED FOR 33% REVIEW	C.M.P.	A.G.K.

No.	Date/Date	Description/Description	Drawn by dessiné par	Approved approuvé
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Revision / Revision	
A detail number numero de detail	
B source drawing no. de dessin no.	
C detail on drawing no. detail sur dessin no.	
Consultant's Name Nom de l'expert-conseil	Eng. Stamp Sceau de l'ingenieur
	

 Public Works and Government Services Canada	Travaux publics et Services gouvernementaux Canada
Client Services Team Southern Alberta Operations Branch	Le Client Entretien d'Équipe Alberta Méridionale Branche d'Opérations

Canada

Client/client  Parks Canada Agency	L'Agence Parcs Canada
Western and Northern Region	Ouest et Nord du Canada

Project title/Titre du projet

Staff Housing Phase 2
Waterton Lakes National Park

Drawing title/Titre du dessin

MECHANICAL SCHEDULES


Surveyed by/Arpenté par C.M.P.	Drawn by/Dessiné par C.M.P.	Date/Date 2016-04-21
Designed by/Concepté par C.M.P.	Reviewed by/Revisé par A.G.K.	Scale/Echelle N.T.S.

PWOSC Project Manager/Administrateur de Projets TPSSC

Client Acceptance/Acceptation du client		Approved by/Approuvé par Randy Boldt
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Perceivable Officer/Agel Responsable	Project Manager/Administrateur de Projets TPSSC
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Project No./No. du projet 39000	Asset No./No. du-bien Asset No. 945	Sheet No./
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MUNICIPAL ADDRESS: WATERTON, WATERTON LAKES
NATIONAL PARK
LEGAL LAND DESC.: LOTS 20 & 21 BLOCK 42

No.	Date/Date	Description/Description	Drawn by Dessine par	Approved Approuve
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Consultant's Name Nom de l'expert-conseil	Eng. Stamp Sceau de l'ingenieur
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Client/client 	Parks Canada Agency	L'Agence Parcs Canada
	Western and Northern Region	Ouest et Nord du Canada


Drawing Title/Titre du dessin

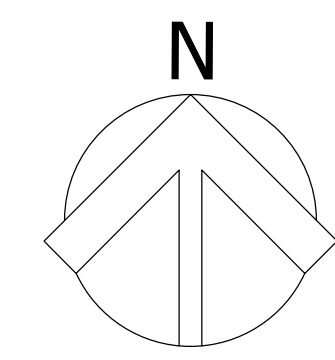SITE PLAN - ELECTRICAL LAYOUT

PWGSC Project Manager/Administrateur de Projets TPSGC	
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Park Responsible Officer/Agent Responsable	PWOSC Project Manager/Administrateur de Projets TPSSCO

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SITE INFORMATION


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NATIONAL PARK
LEGAL LAND DESC.: LOTS 20 & 21 BLOCK 42

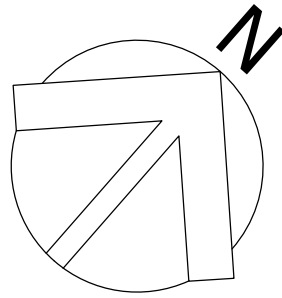GENERAL NOTES:

1. LIGHTING ON CIRCUIT B-5 WITHIN CORRIDOR AND STAIRCASES TO BE CONTROLLED BY MOTION SENSOR SWITCHING INDICATED

KEY NOTES:

1. SUPPLY AND INSTALL DSC-300 DRYER RECEPTACLE. WIRE-UP COMPLETE WITH BOOSTER FAN ABOVE. TYPICAL FOR 3 DRYERS

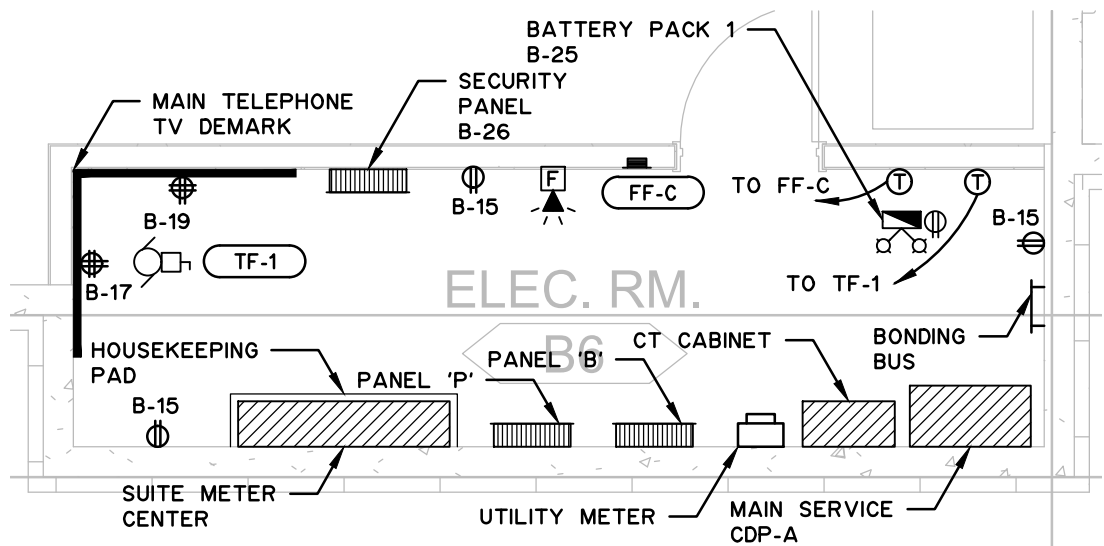

ELECTRICAL ROOM B6
ELECTRICAL LAYOUT

3
E200
SCALE: 1:50

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BASEMENT FLOOR PLAN
LIGHTING LAYOUT

1
E200
SCALE: 1:100

BASEMENT FLOOR PLAN
POWER AND SYSTEMS LAYOUT

2
E200
SCALE: 1:100

5	16-12-08	ISSUED FOR TENDER	L.L.L.	K.O.K.
4	16-12-08	ISSUED FOR BP	L.L.L.	K.O.K.
3	16-09-02	ISSUED FOR 99% REVIEW	L.L.L.	J.M.T.
2	16-06-14	ISSUED FOR 66% REVIEW	L.L.L.	J.M.T.
1	16-05-05	ISSUED FOR 33% REVIEW	L.L.L.	J.M.T.

No.	Date/Date	Description/Description	Drawn by / dessiné par	Approved / Approuvé
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Revision / Revision

A	A
C	C
B	B
C	C

Consultant's Name
Nom de l'expert-conseil



Public Works and
Government Services
Canada

Travaux publics et
Services gouvernementaux
Canada

Client Services Team
Southern Alberta
Operations Branch

Le Client Entretien
Alberta Méridional
Branche d'Opérations

Canada

Client/client
Parks Canada
Agence

L'Agence Parcs
Canada

Western and
Northern Region

Ouest et Nord
du Canada

Project title/Titre du projet
Staff Housing Phase 2
Waterton Lakes National
Park

Drawing title/Titre du dessin
BASEMENT FLOOR
PLAN ELECTRICAL
LAYOUT

Surveyed by/Arpenté par
L.L.L.

Drawn by/Dessiné par
L.L.L.

Designed by/Concepté par
J.M.T.

Reviewed by/Revisé par
K.O.K.

Scale/Echelle
AS INDICATED

FWGSC Project Manager/Administrateur de Projets TPSCC
Randy Boldt


Client Acceptance/Acception du client
Approved by/Approuvé par

Permit to Practice
MPE ENGINEERING LTD.
PERMIT NUMBER: P3680

Project No./No. du projet
39000

Asset No./No. du-bien
Asset No. 945

Sheet No./
No. de la feuille
E200

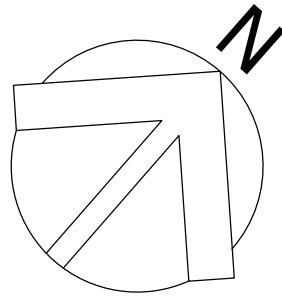

SITE INFORMATION


MUNICIPAL ADDRESS: WATERTON, WATERTON LAKES
NATIONAL PARK
LEGAL LAND DESC.: LOTS 20 & 21 BLOCK 42


KEY NOTES:

1. ROUGH IN FOR FUTURE CAMERAS, PROVIDE AND INSTALL BOX AND CONDUIT BACK TO SECURITY PANEL LOCATION. COORDINATE LOCATIONS WITH ARCHITECT AND OWNER ON SITE
2. SECURITY DEVICES TO BE FED FROM 24VDC TRANSFORMER POWERED FROM THE CORRESPONDING 120VAC CIRCUIT. SEE DETAILS 7/E600 AND 8/E600
3. RADIATION THERMOSTAT

GENERAL NOTES:

1. ELECTRICAL CONTRACTOR TO SUPPLY AND INSTALL 120V CIRCUITS TO LOW VOLTAGE TRANSFORMERS FOR MECHANICAL THERMOSTATS. CO-ORDINATE WITH MECHANICAL CONTROLS CONTRACTOR FOR LOCATIONS
2. MOTION SENSORS TO CONTROL LIGHTING ON NOTED CIRCUIT THAT IS WITHIN THE SAME ENCLOSED STAIRCASE OR CORRIDOR

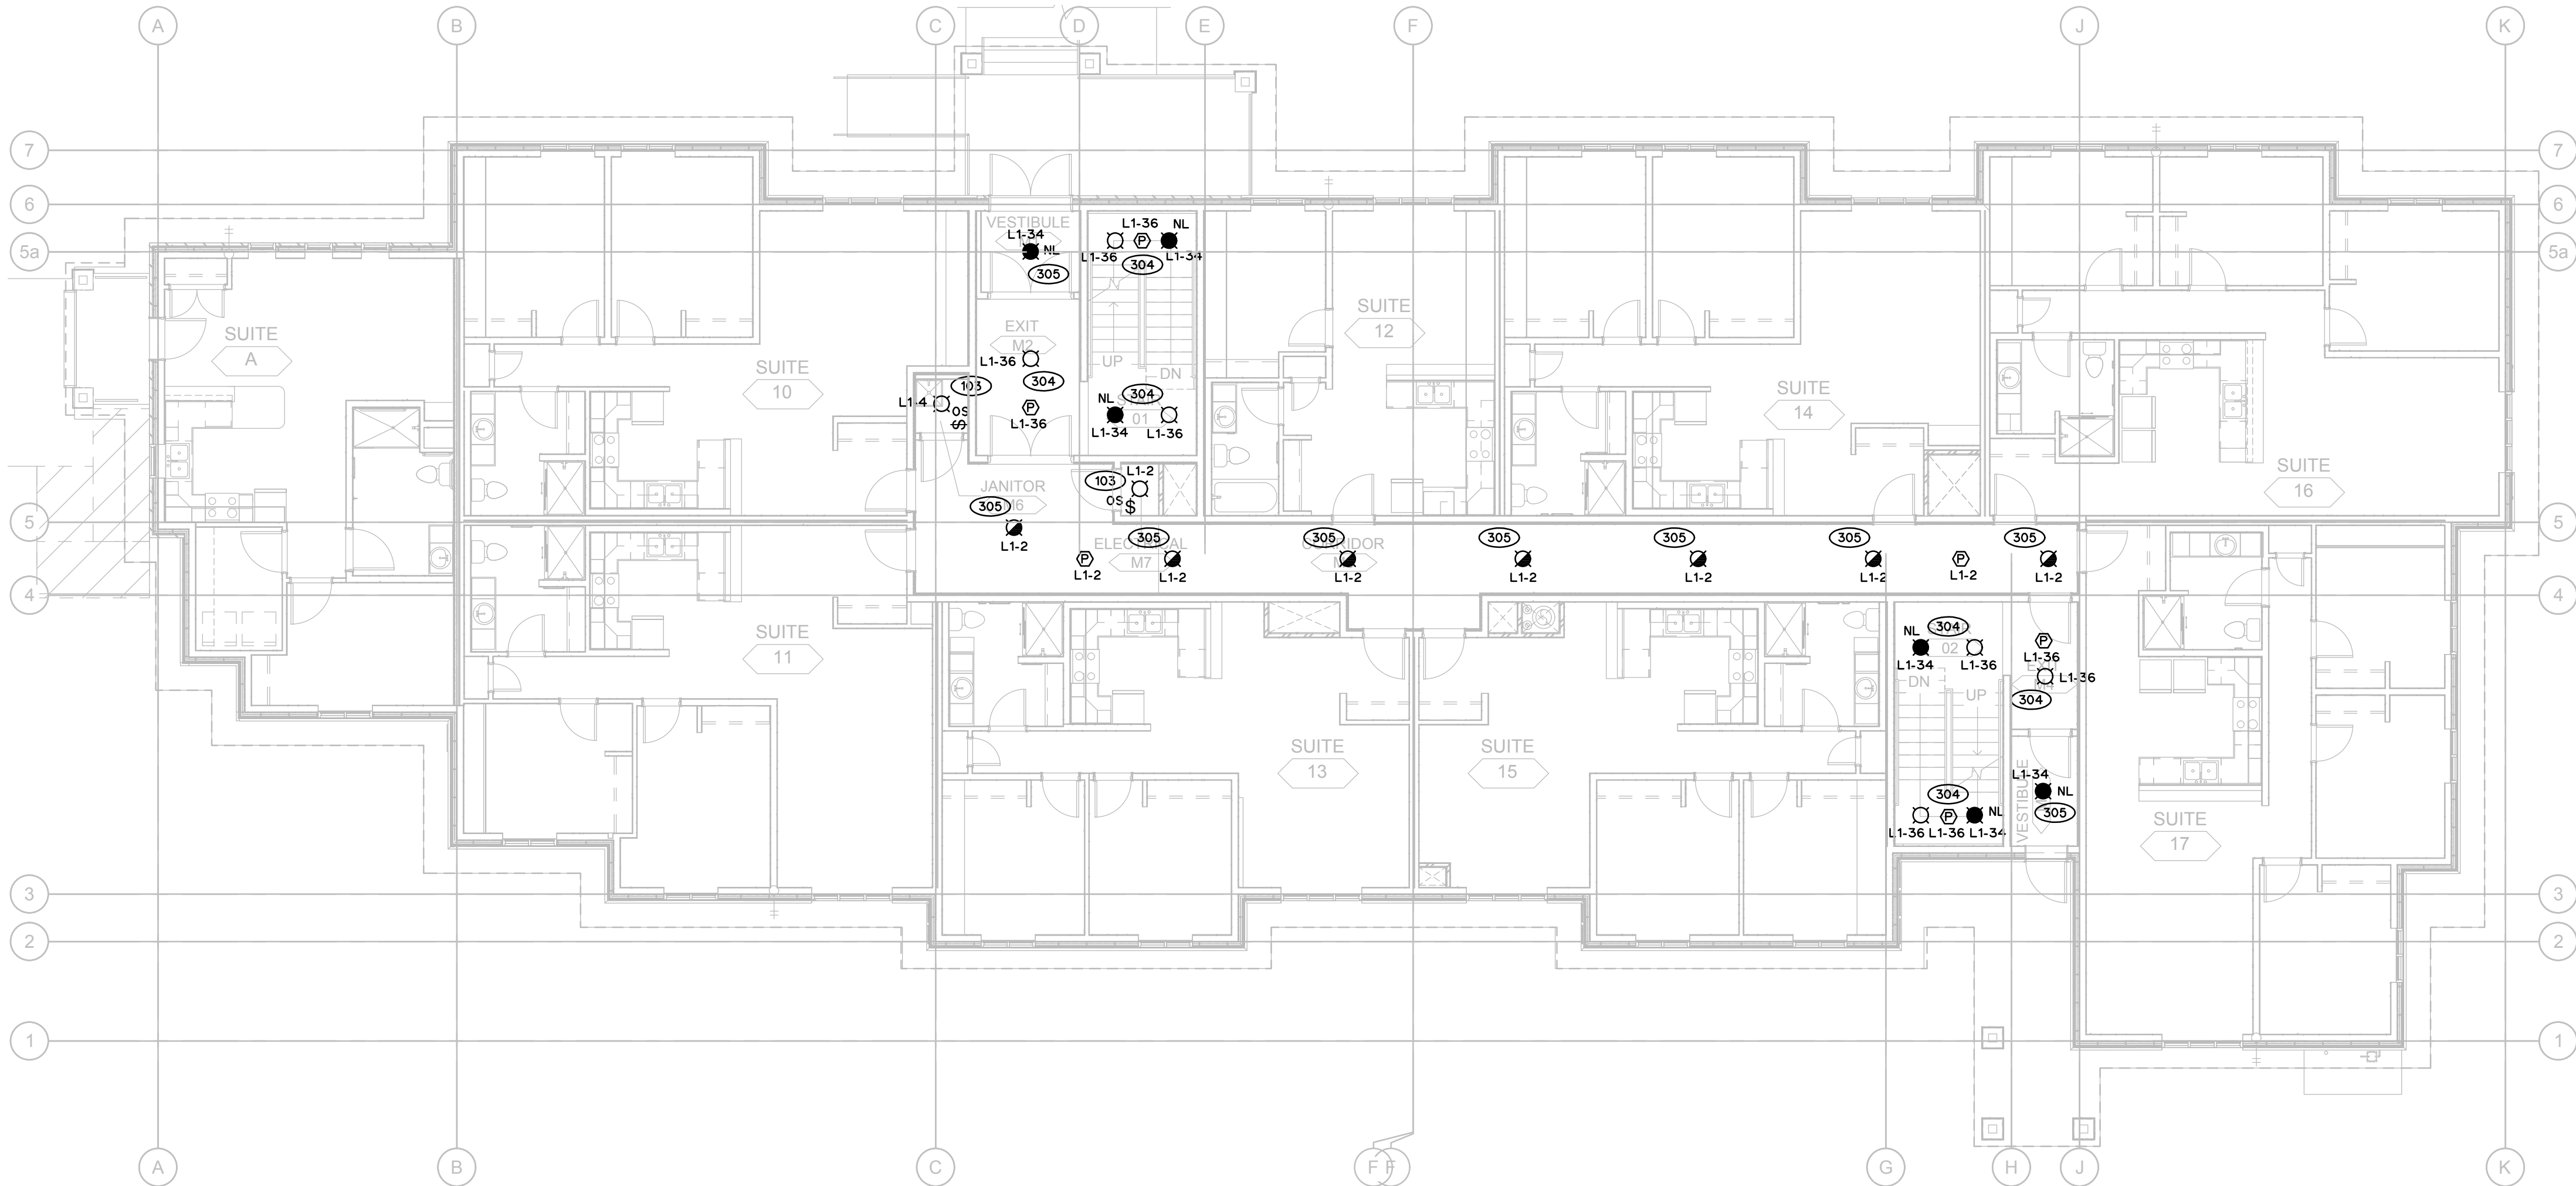

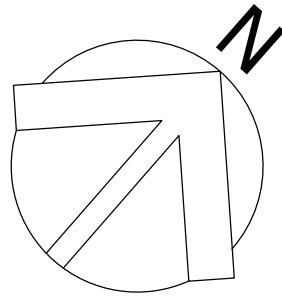

SITE INFORMATION

MUNICIPAL ADDRESS: WATERTON, WATERTON LAKES
NATIONAL PARK
LEGAL LAND DESC.: LOTS 20 & 21 BLOCK 42

KEY NOTES:

- ① MOTORIZED DAMPER IN ATTIC ON EXHAUST DUCT.
INTERCONNECT WITH EXHAUST FAN EF-1
- ② MOTORIZED DAMPER IN ATTIC ON INTAKE DUCT.
INTERCONNECT WITH MAKE UP AIR MUA-1
- ③ EXTERIOR WALL MOUNTED PHOTOCELL FOR EXTERIOR
LIGHTING CONTROL

LOFT FLOOR PLAN
LIGHTING LAYOUT

SCALE: 1/100

LOFT FLOOR PLAN
POWER AND SYSTEMS LAYOUT

SCALE: 1/100

5	16-12-08	ISSUED FOR TENDER	L.L.L.	K.O.K.
4	16-12-08	ISSUED FOR BP	L.L.L.	K.O.K.
3	16-09-02	ISSUED FOR 99% REVIEW	L.L.L.	J.M.T.
2	16-06-14	ISSUED FOR 66% REVIEW	L.L.L.	J.M.T.
1	16-05-05	ISSUED FOR 33% REVIEW	L.L.L.	J.M.T.

No.	Date/Date	Description/Description	Drawn by Dessine par	Approved Approuve
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Revision / Revision	
A	detail number numero de detail
B	source drawing no. de dessin no.
C	detail on drawing no. detail sur dessin no.

Consultant's Name
Nom de l'expert-conseil



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du Canada

Project title/Titre du projet

Staff Housing Phase 2
Waterton Lakes National
Park

Drawing title/Titre du dessin

LOFT FLOOR PLAN
ELECTRICAL LAYOUT

Surveyed by/Arpente par L.L.L.	Drawn by/Dessine par L.L.L.	Date/Date 2016-04-21
Designed by/Concept par J.M.T.	Reviewed by/Revisé par K.O.K.	Scale/Echelle AS INDICATED

FWGSC Project Manager/Administrateur de Projets TPSCC

Client Acceptance/Acceptation du client


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Project No./No. du projet
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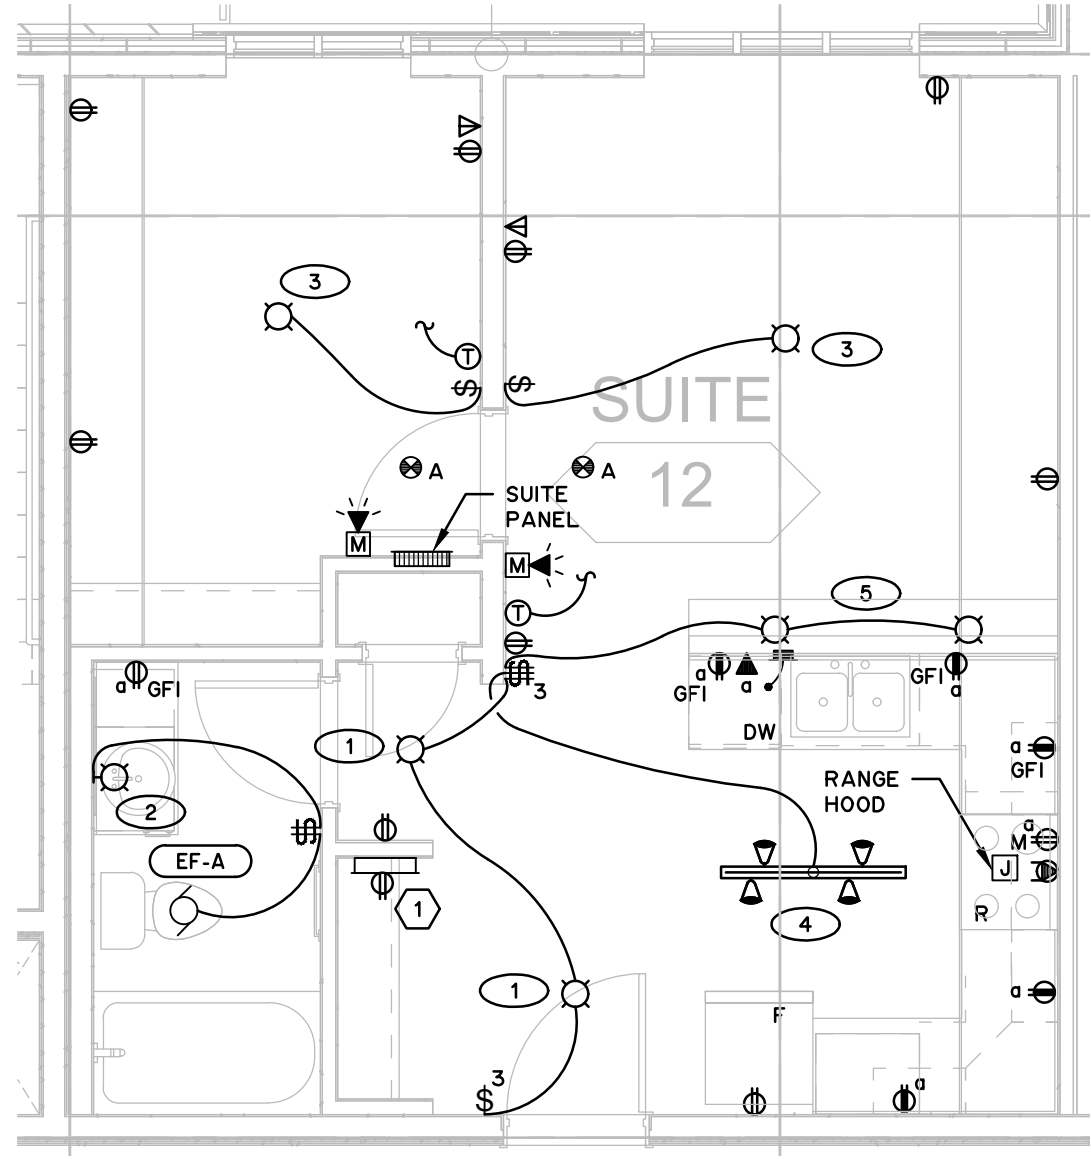
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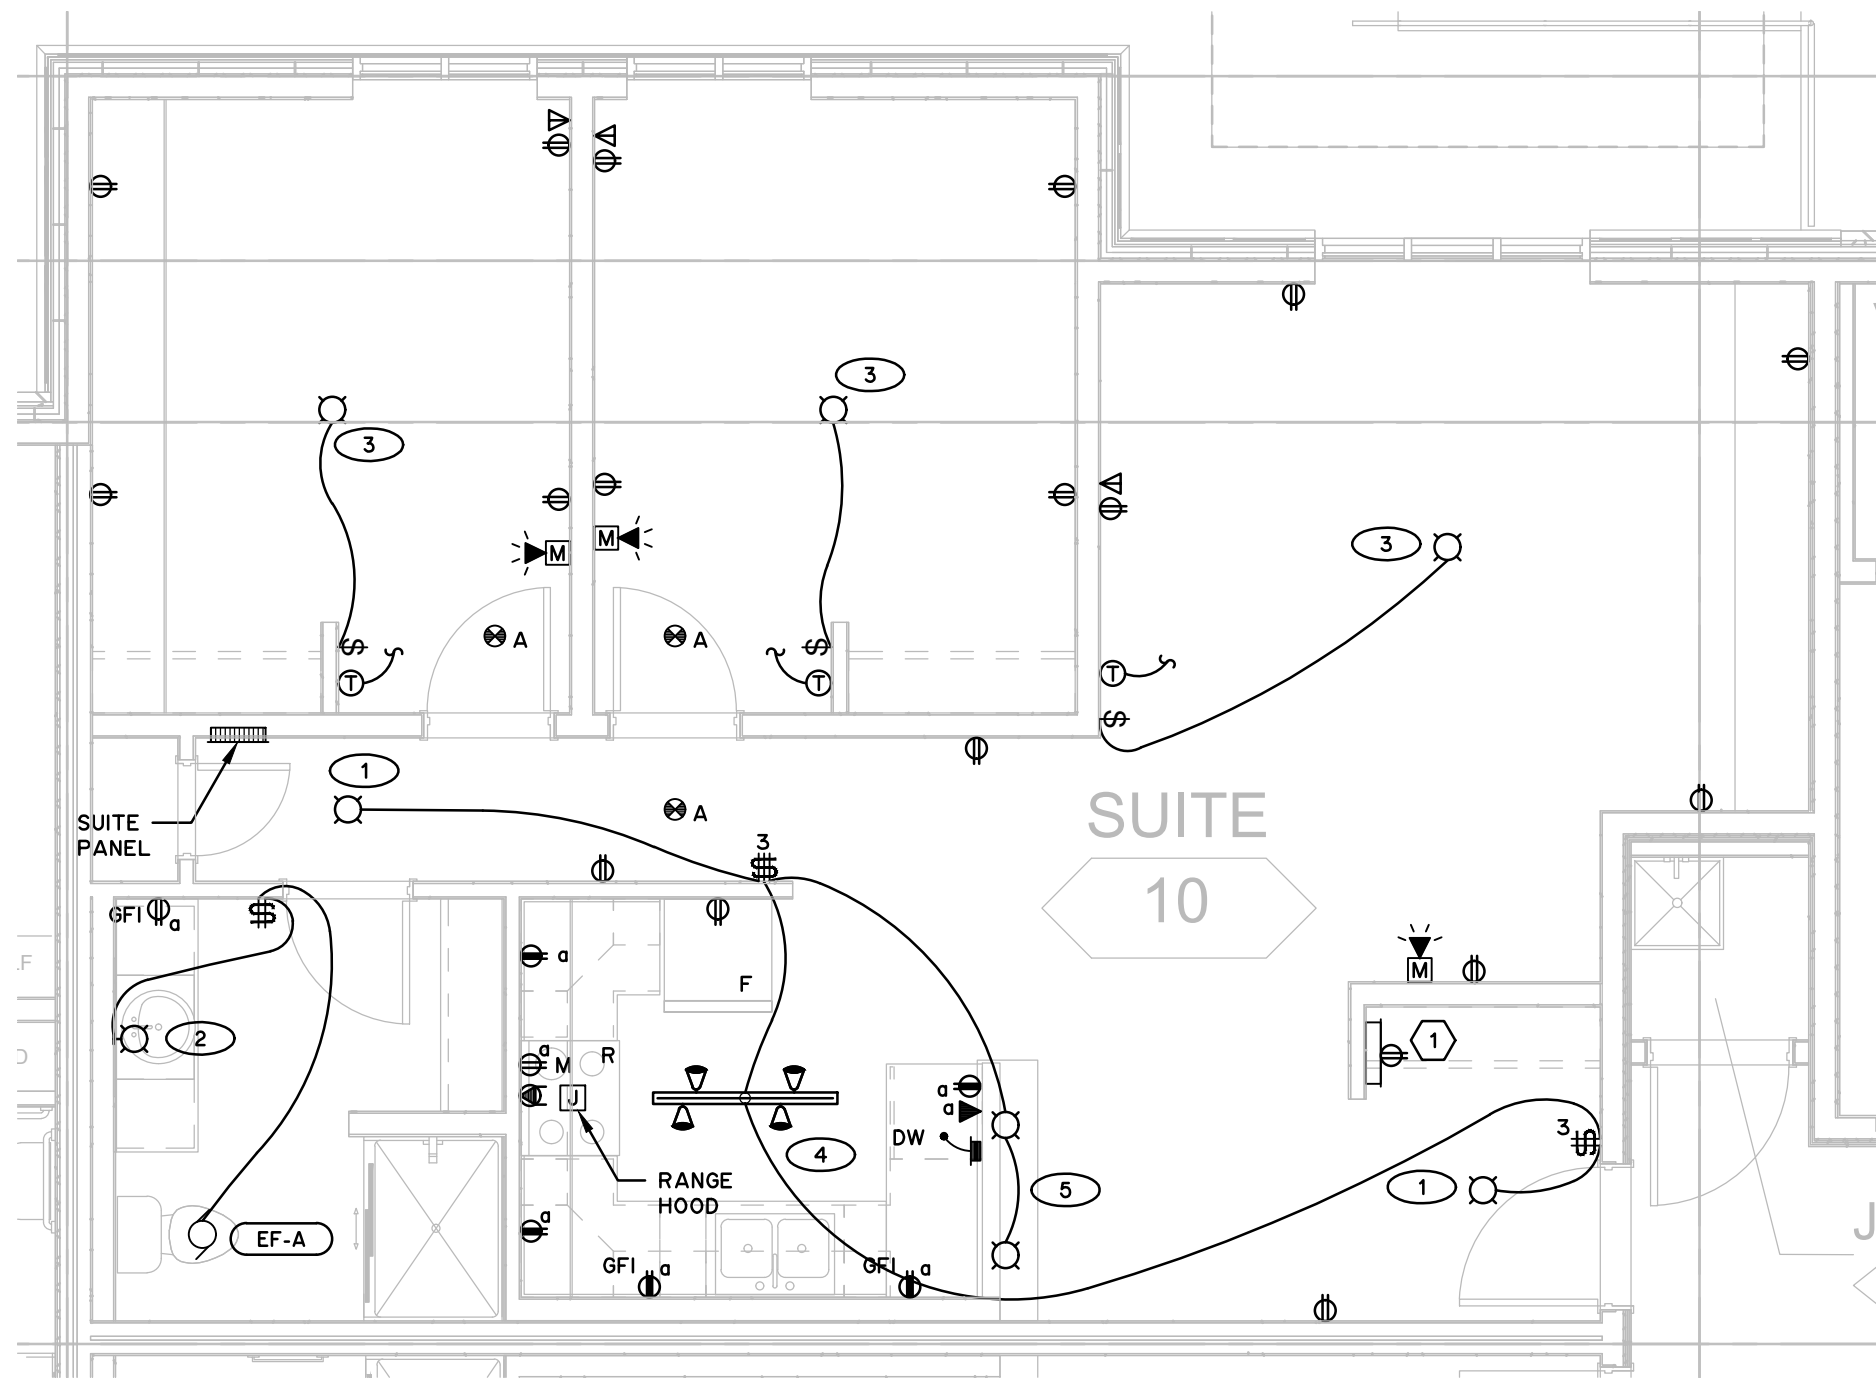
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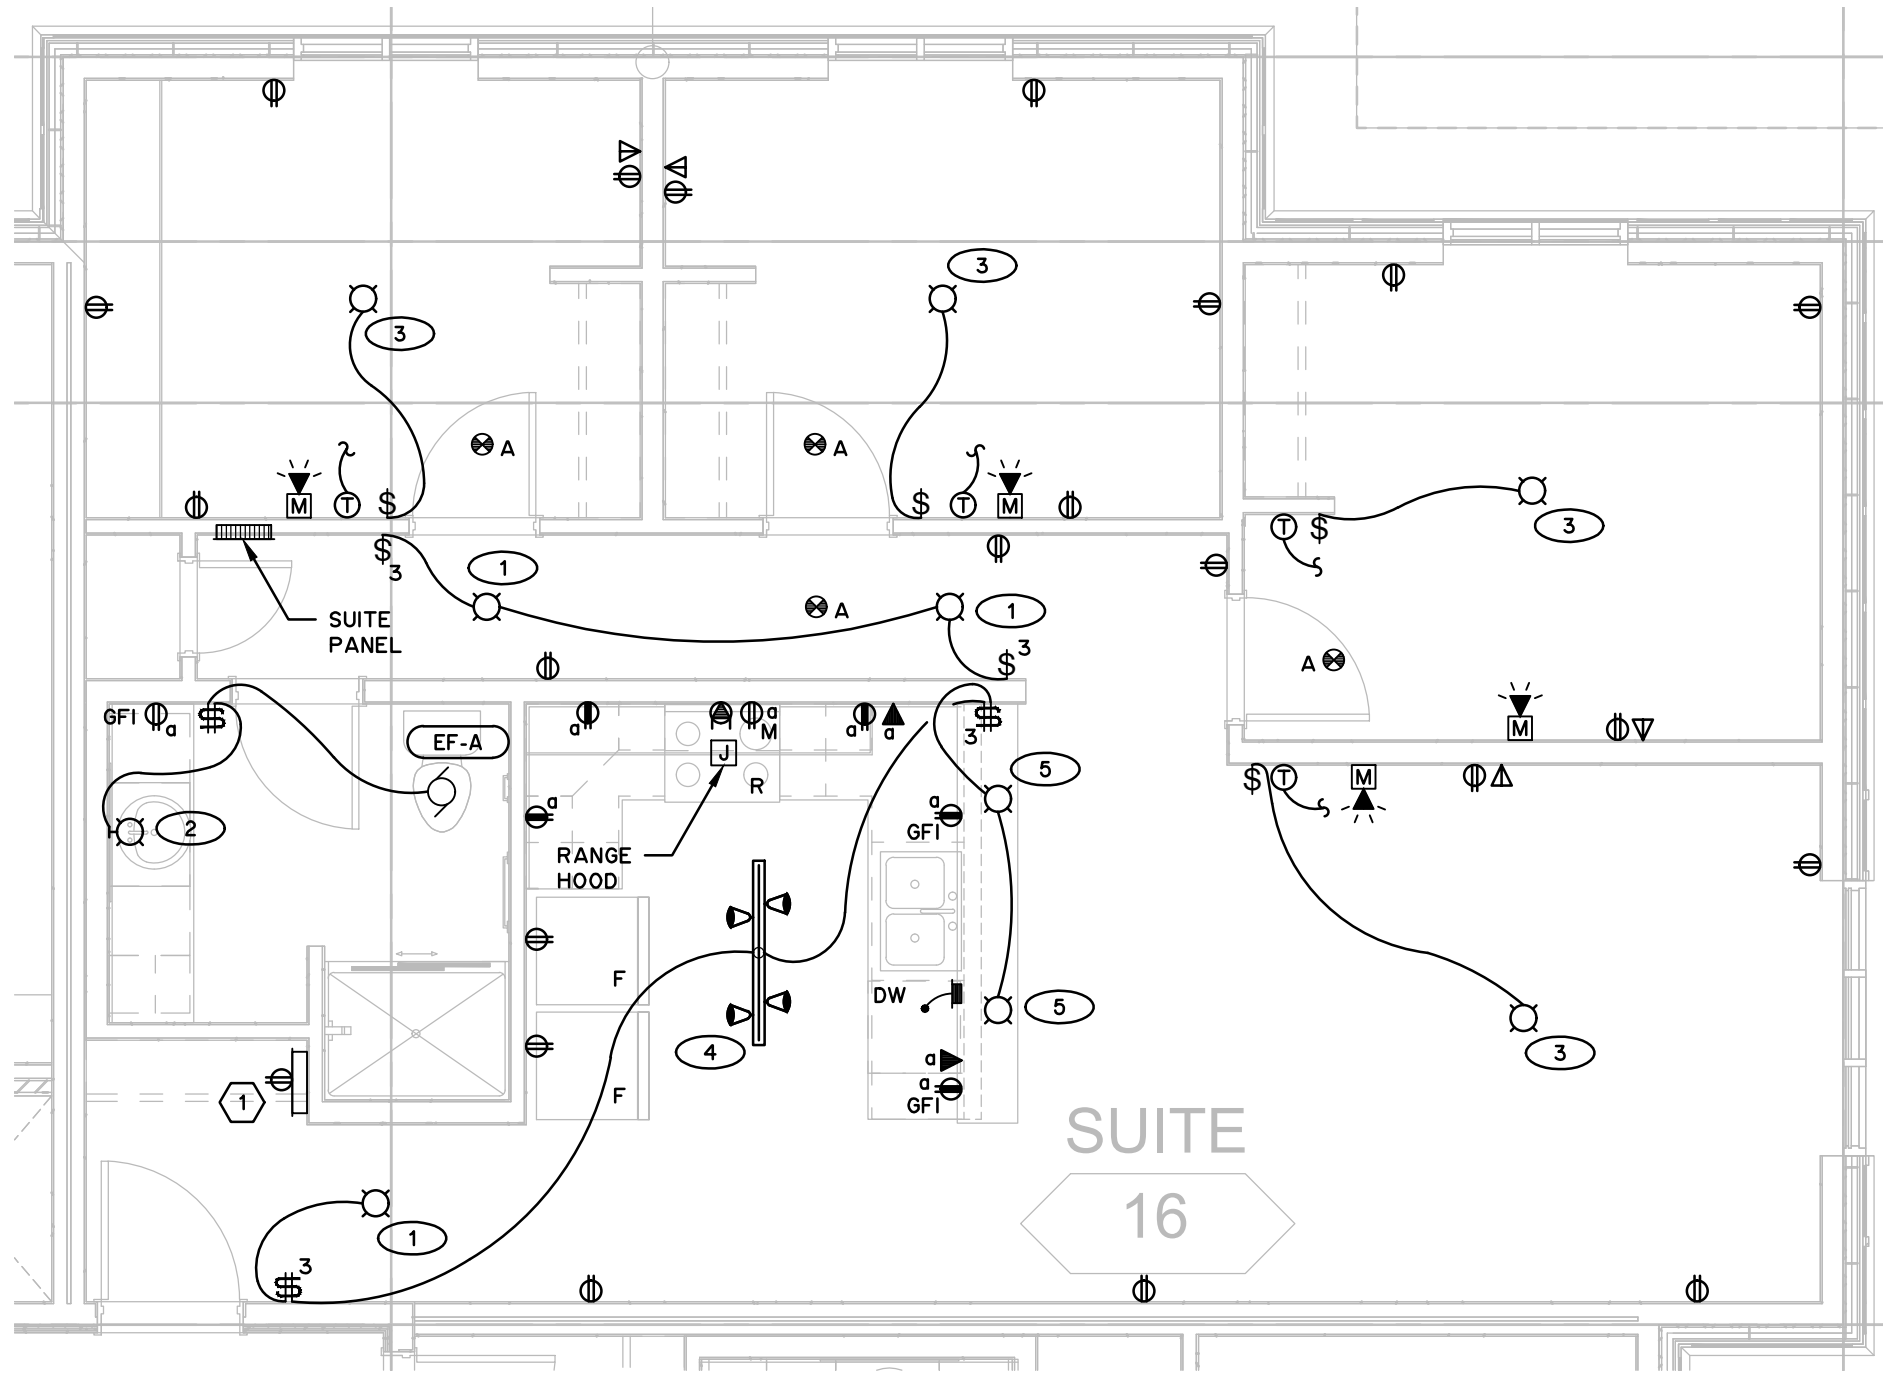
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MAIN FLOOR PLAN
TYPICAL SUITE 'A'
SCALE: 1:50




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MAIN FLOOR PLAN
TYPICAL SUITE '12'
SCALE: 1:50




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E300
MAIN FLOOR PLAN
TYPICAL SUITE '10'
SCALE: 1:50

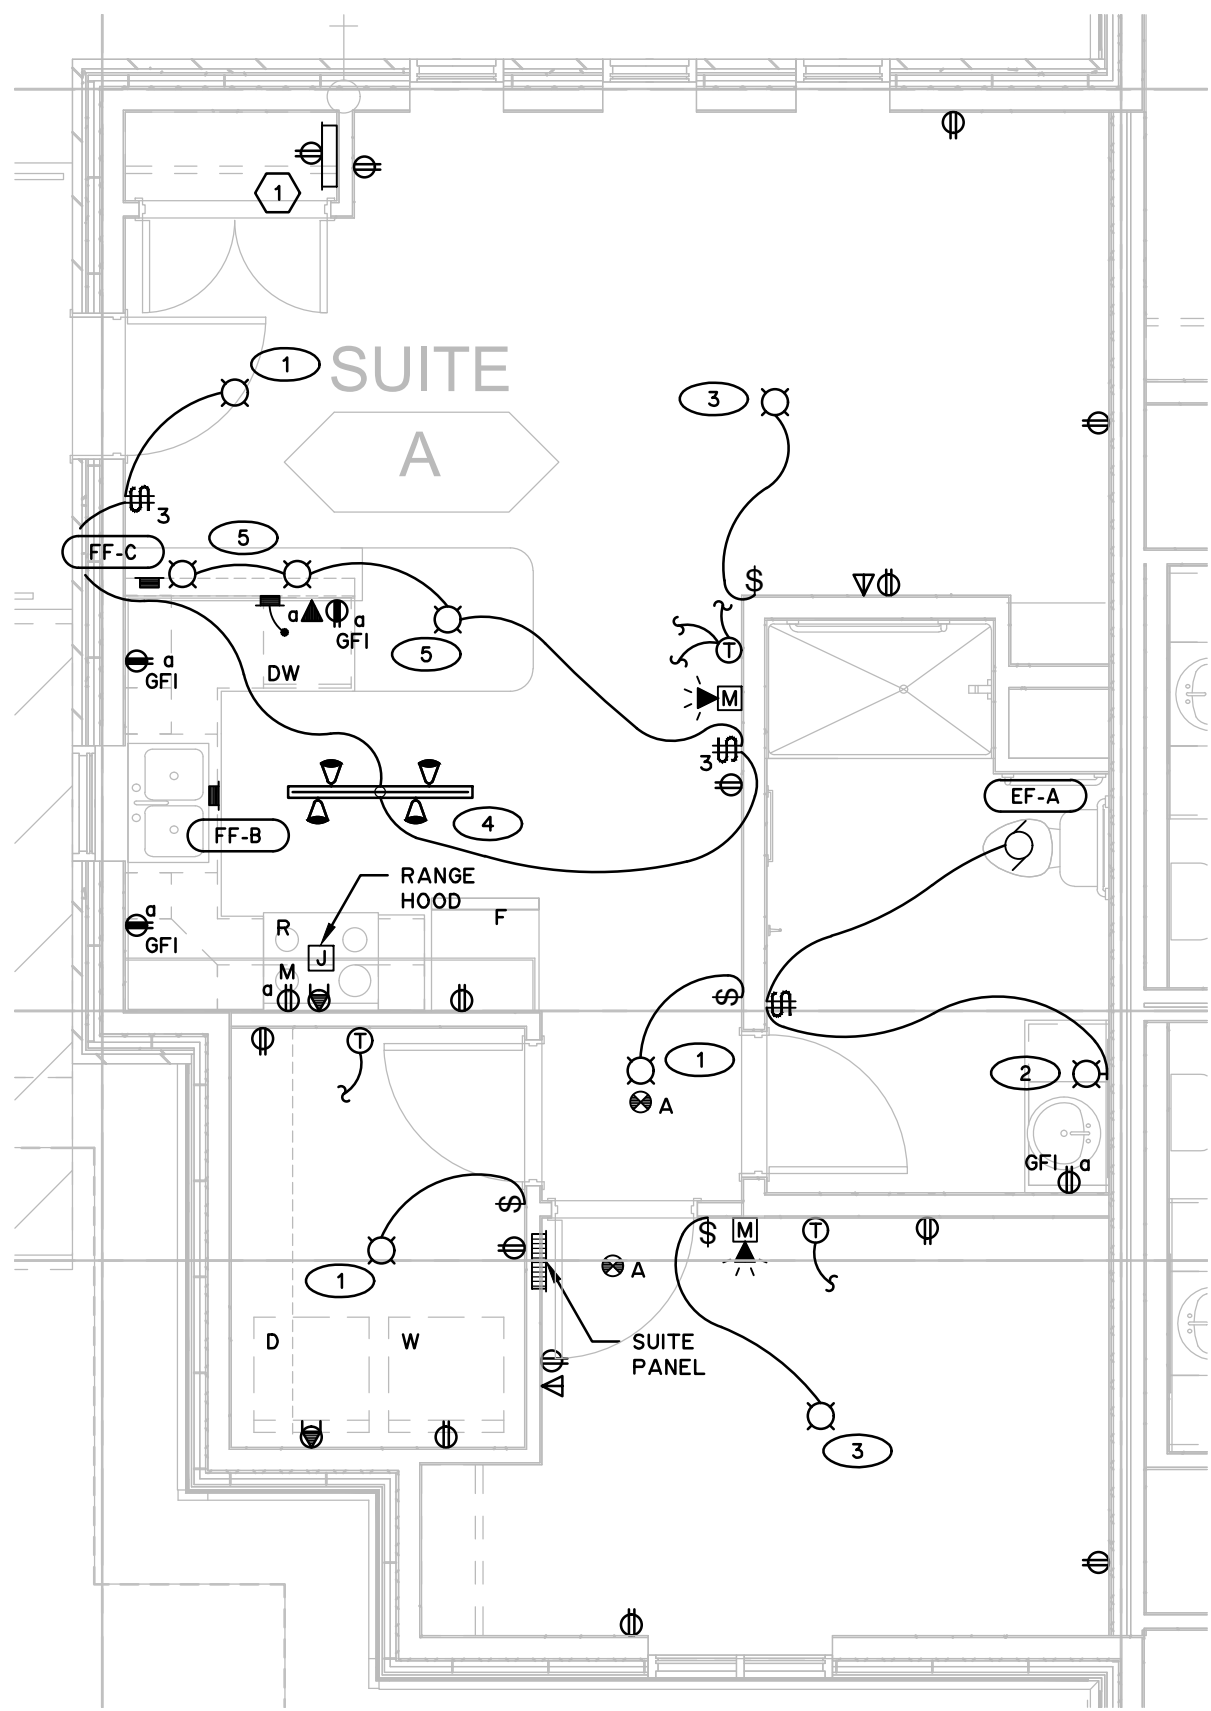


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E300
MAIN FLOOR PLAN
TYPICAL SUITE '16' AND '17'
SCALE: 1:50

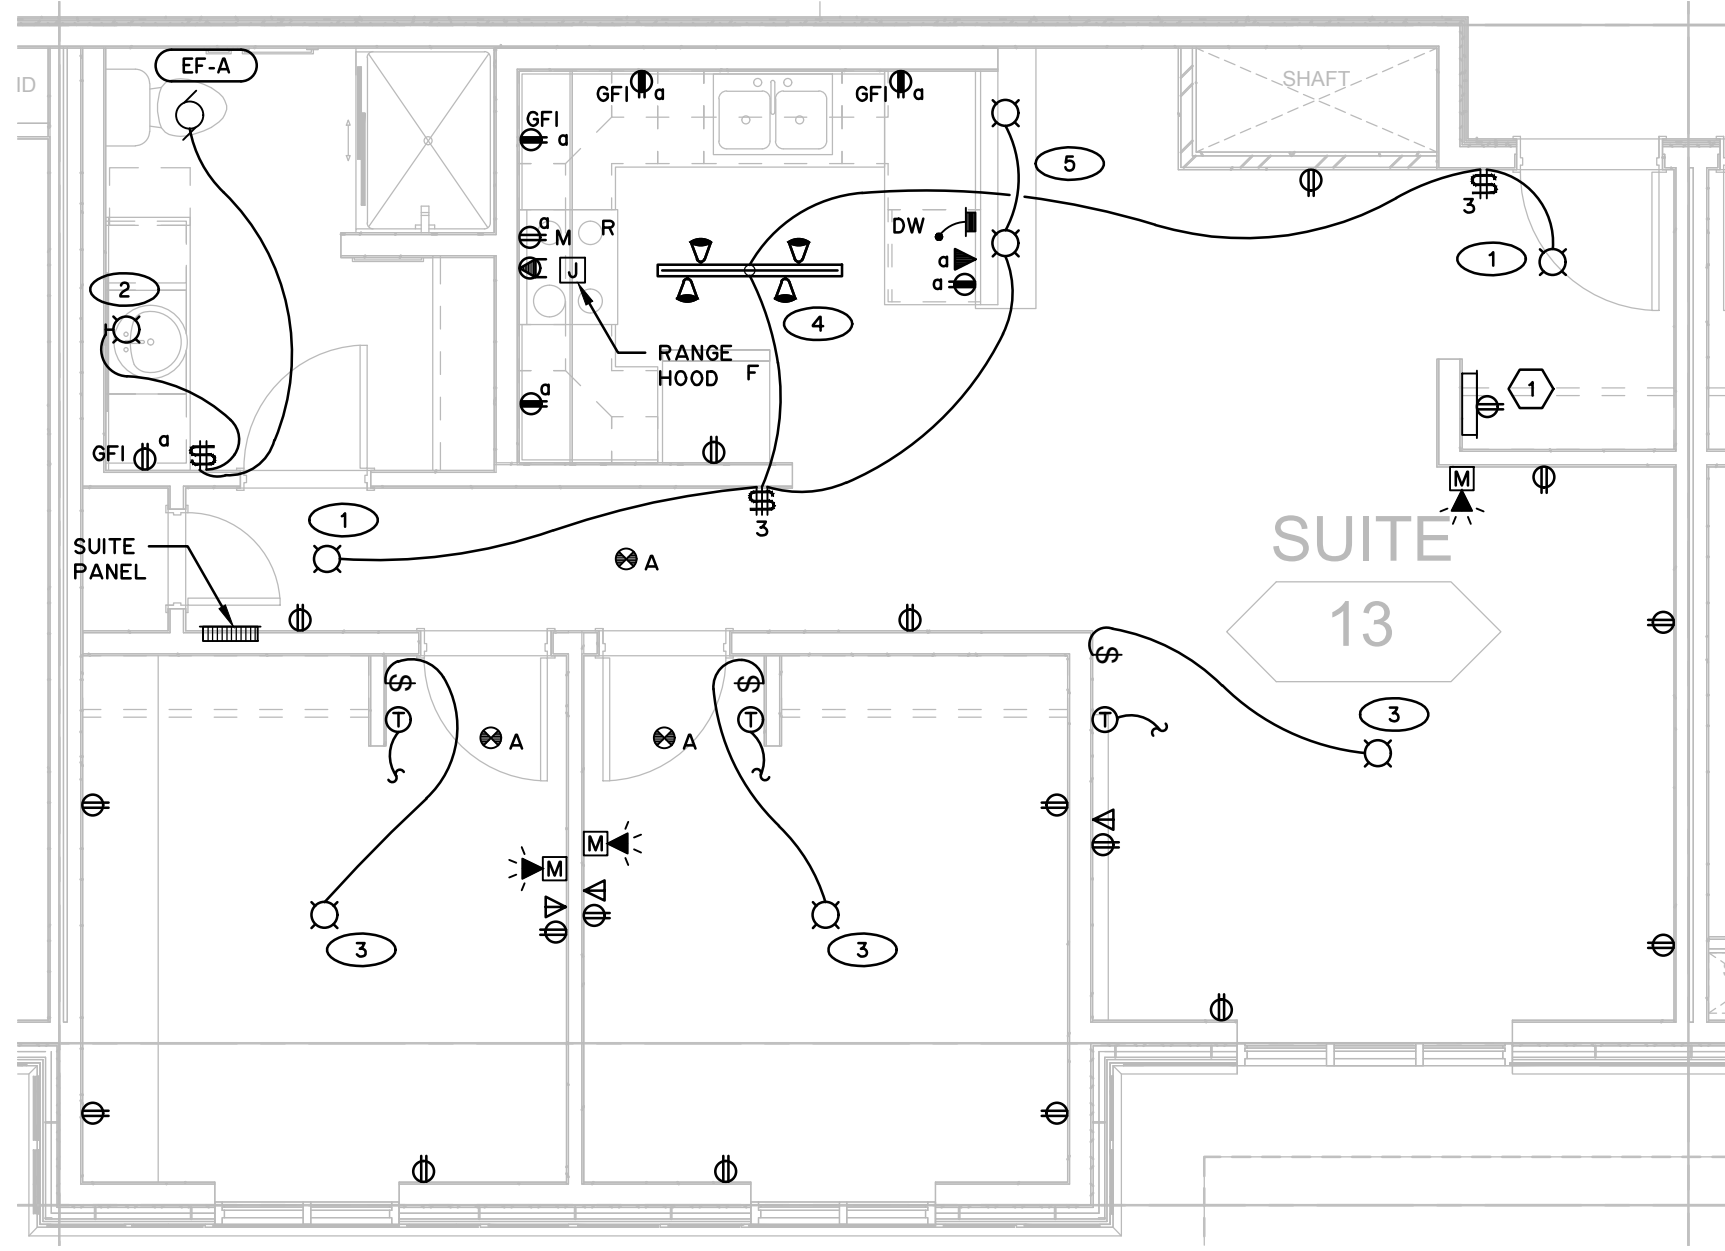

5
E300
MAIN FLOOR PLAN
TYPICAL SUITE '13' AND '15'
SCALE: 1:50

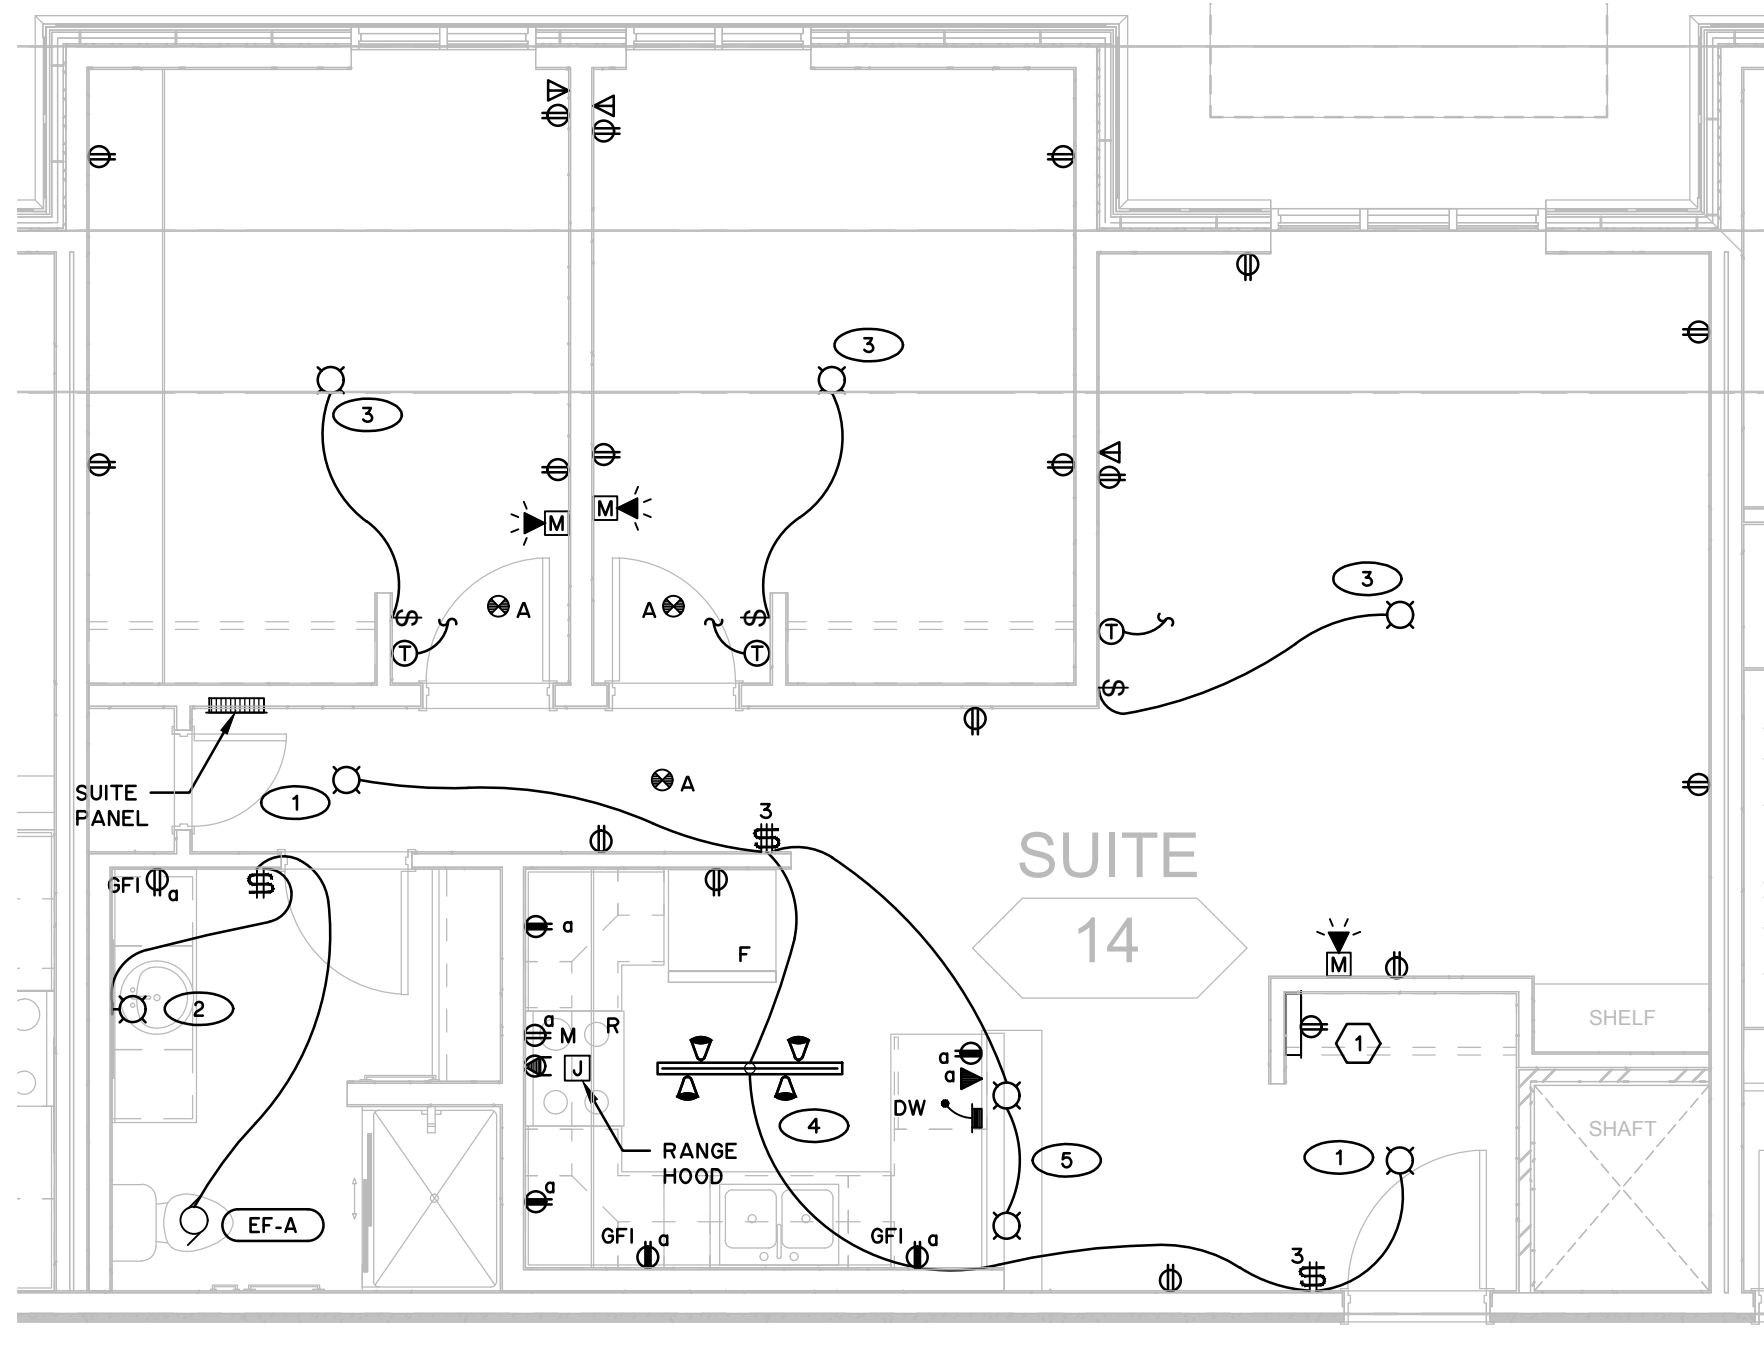

6
E300
MAIN FLOOR PLAN
TYPICAL SUITE '14'
SCALE: 1:50

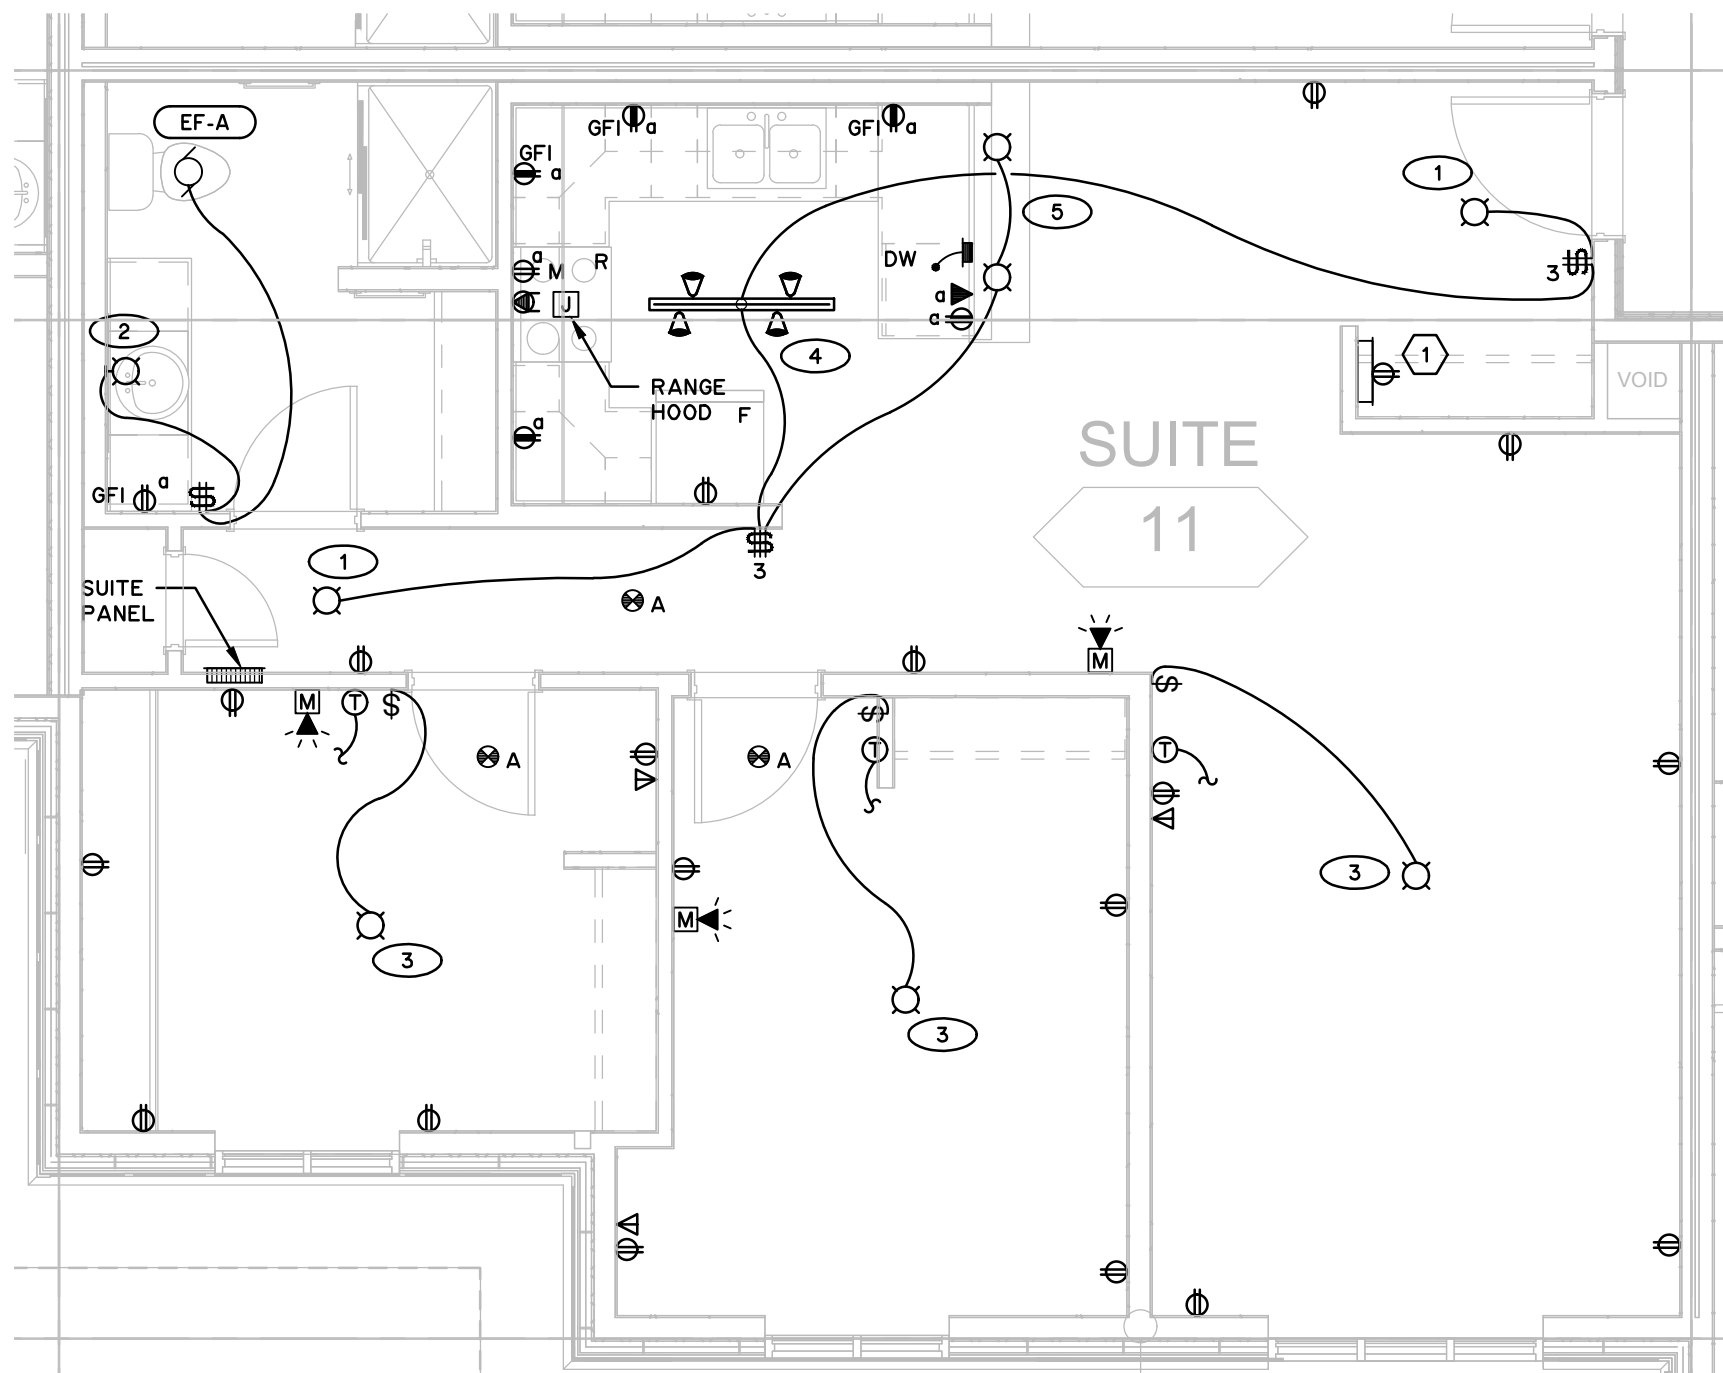

7
E300
MAIN FLOOR PLAN
TYPICAL SUITE '11'
SCALE: 1:50

KEY NOTES:

- 1 DATA/VOICE/TV NETWORK DISTRIBUTION PANEL TO BE 356x711mm STRUCTURED MEDIA BOX AND RECESSED MOUNTED IN ENTRY CLOSET OF EACH SUITE. 610mm ABOVE FINISHED FLOOR. CONTRACTOR TO RUN ALL SUITE VOICE/DATA/CABLE TV DEVICE CABLEING TO THIS BOX. PROVIDE AND INSTALL 120V DUPLEX RECEPTACLE MOUNTED INSIDE ENCLOSURE

GENERAL NOTES:

1. CONFIRM LOCATION AND MOUNTING HEIGHTS OF ALL DEVICES PRIOR TO ROUGH-IN
2. ALL DEVICES LOCATED ON PARTY WALLS DIVIDING SUITES SHALL NOT BE MOUNTED BACK TO BACK BUT SHALL BE MOUNTED A MINIMUM OF 1 STUD WIDTH APART
3. SMOKE ALARMS IN SUITE TO BE 120V HARD WIRED, CONNECTED TO LIGHTING CIRCUIT AND COMPLETE WITH DUAL SENSING FOR SMOKE AND CARBON MONOXIDE. MULTIPLE SMOKE DETECTORS IN THE SAME SUITE ARE TO BE INTERCONNECTED
4. RUN 3x10.8 NMDSO FROM RANGE TO SUITE ELECTRICAL PANEL (OR 'BX')
5. CO-ORDINATE ALL KITCHEN ELECTRICAL OUTLETS WITH GENERAL CONTRACTOR AND MILLWORK CONTRACTOR PRIOR TO ROUGH-IN
6. WIRE ALL BATHROOM DEVICES TO LOAD SIDE OF GFI RECEPTACLE
7. ALL SUITE DIMMERS SHALL BE MOUNTED IN 103mm SQUARE BACK BOXES C/W SINGLE GANG PLASTER RING AND SHALL BE LUTRON S-600P
8. ALL SWITCHES AND DIMMERS GANGED TOGETHER SHALL BE MOUNTED IN A MULTI-GANG BOX C/W ONE PIECE FACEPLATE
9. PROVIDE ARC FAULT PROTECTED BREAKERS FOR RECEPTACLES IN ALL SLEEPING AREAS AS REQUIRED BY CODE
10. INSTALL TAMPER RESISTANT RECEPTACLES IN ALL LOCATIONS BELOW COUNTER HEIGHT AS REQUIRED BY THE CURRENT C.E.C.
11. FINAL LOCATION OF ALL SUITE PANELS TO BE CO-ORDINATED ON SITE WITH CONSULTANT PRIOR TO ROUGH-IN
12. COORDINATE LIGHTING LAYOUT WITH JOIST LAYOUT. PROVIDE SCHEMATIC OF LAYOUT PRIOR TO INSTALLATION TO CONSULTANT FOR REVIEW
13. ELECTRICAL CONTRACTOR TO SUPPLY AND INSTALL 120V CIRCUIT TO LOW VOLTAGE TRANSFORMER FOR RADIATION THERMOSTATS. CO-ORDINATE WITH MECHANICAL CONTROLS CONTRACTOR FOR LOCATIONS

SITE INFORMATION

MUNICIPAL ADDRESS: WATERTON, WATERTON LAKES
NATIONAL PARK
LEGAL LAND DESC.: LOTS 20 & 21 BLOCK 42

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No.	Date/Date	Description/Description	Drawn by Dessiné par	Approved Approuvé
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Revision / Revision
A detail number numéro de détail
B source drawing no. de dessin no.
C detail on drawing no. détail sur dessin no.

Consultant's Name
Nom de l'expert-conseil



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Western and
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du Canada

Project title/Titre du projet

Staff Housing Phase 2
Waterton Lakes National
Park

Drawing title/Titre du dessin

TYPICAL SUITE PLANS
ELECTRICAL LAYOUT

Surveyed by/Arpenté par L.L.L.	Drawn by/Dessiné par L.L.L.	Date/Date 2016-04-21
Designed by/Concept par J.M.T.	Reviewed by/Revisé par K.O.K.	Scale/Echelle AS INDICATED

PWGSC Project Manager/Administrateur de Projets TPSCC

Randy Boldt

Client Acceptance/Acceptation du client

Approved by/Approuvé par

Permit to Practice


Project No./No. du projet

Asset No./No. de l'actif


Sheet No./No. de la feuille

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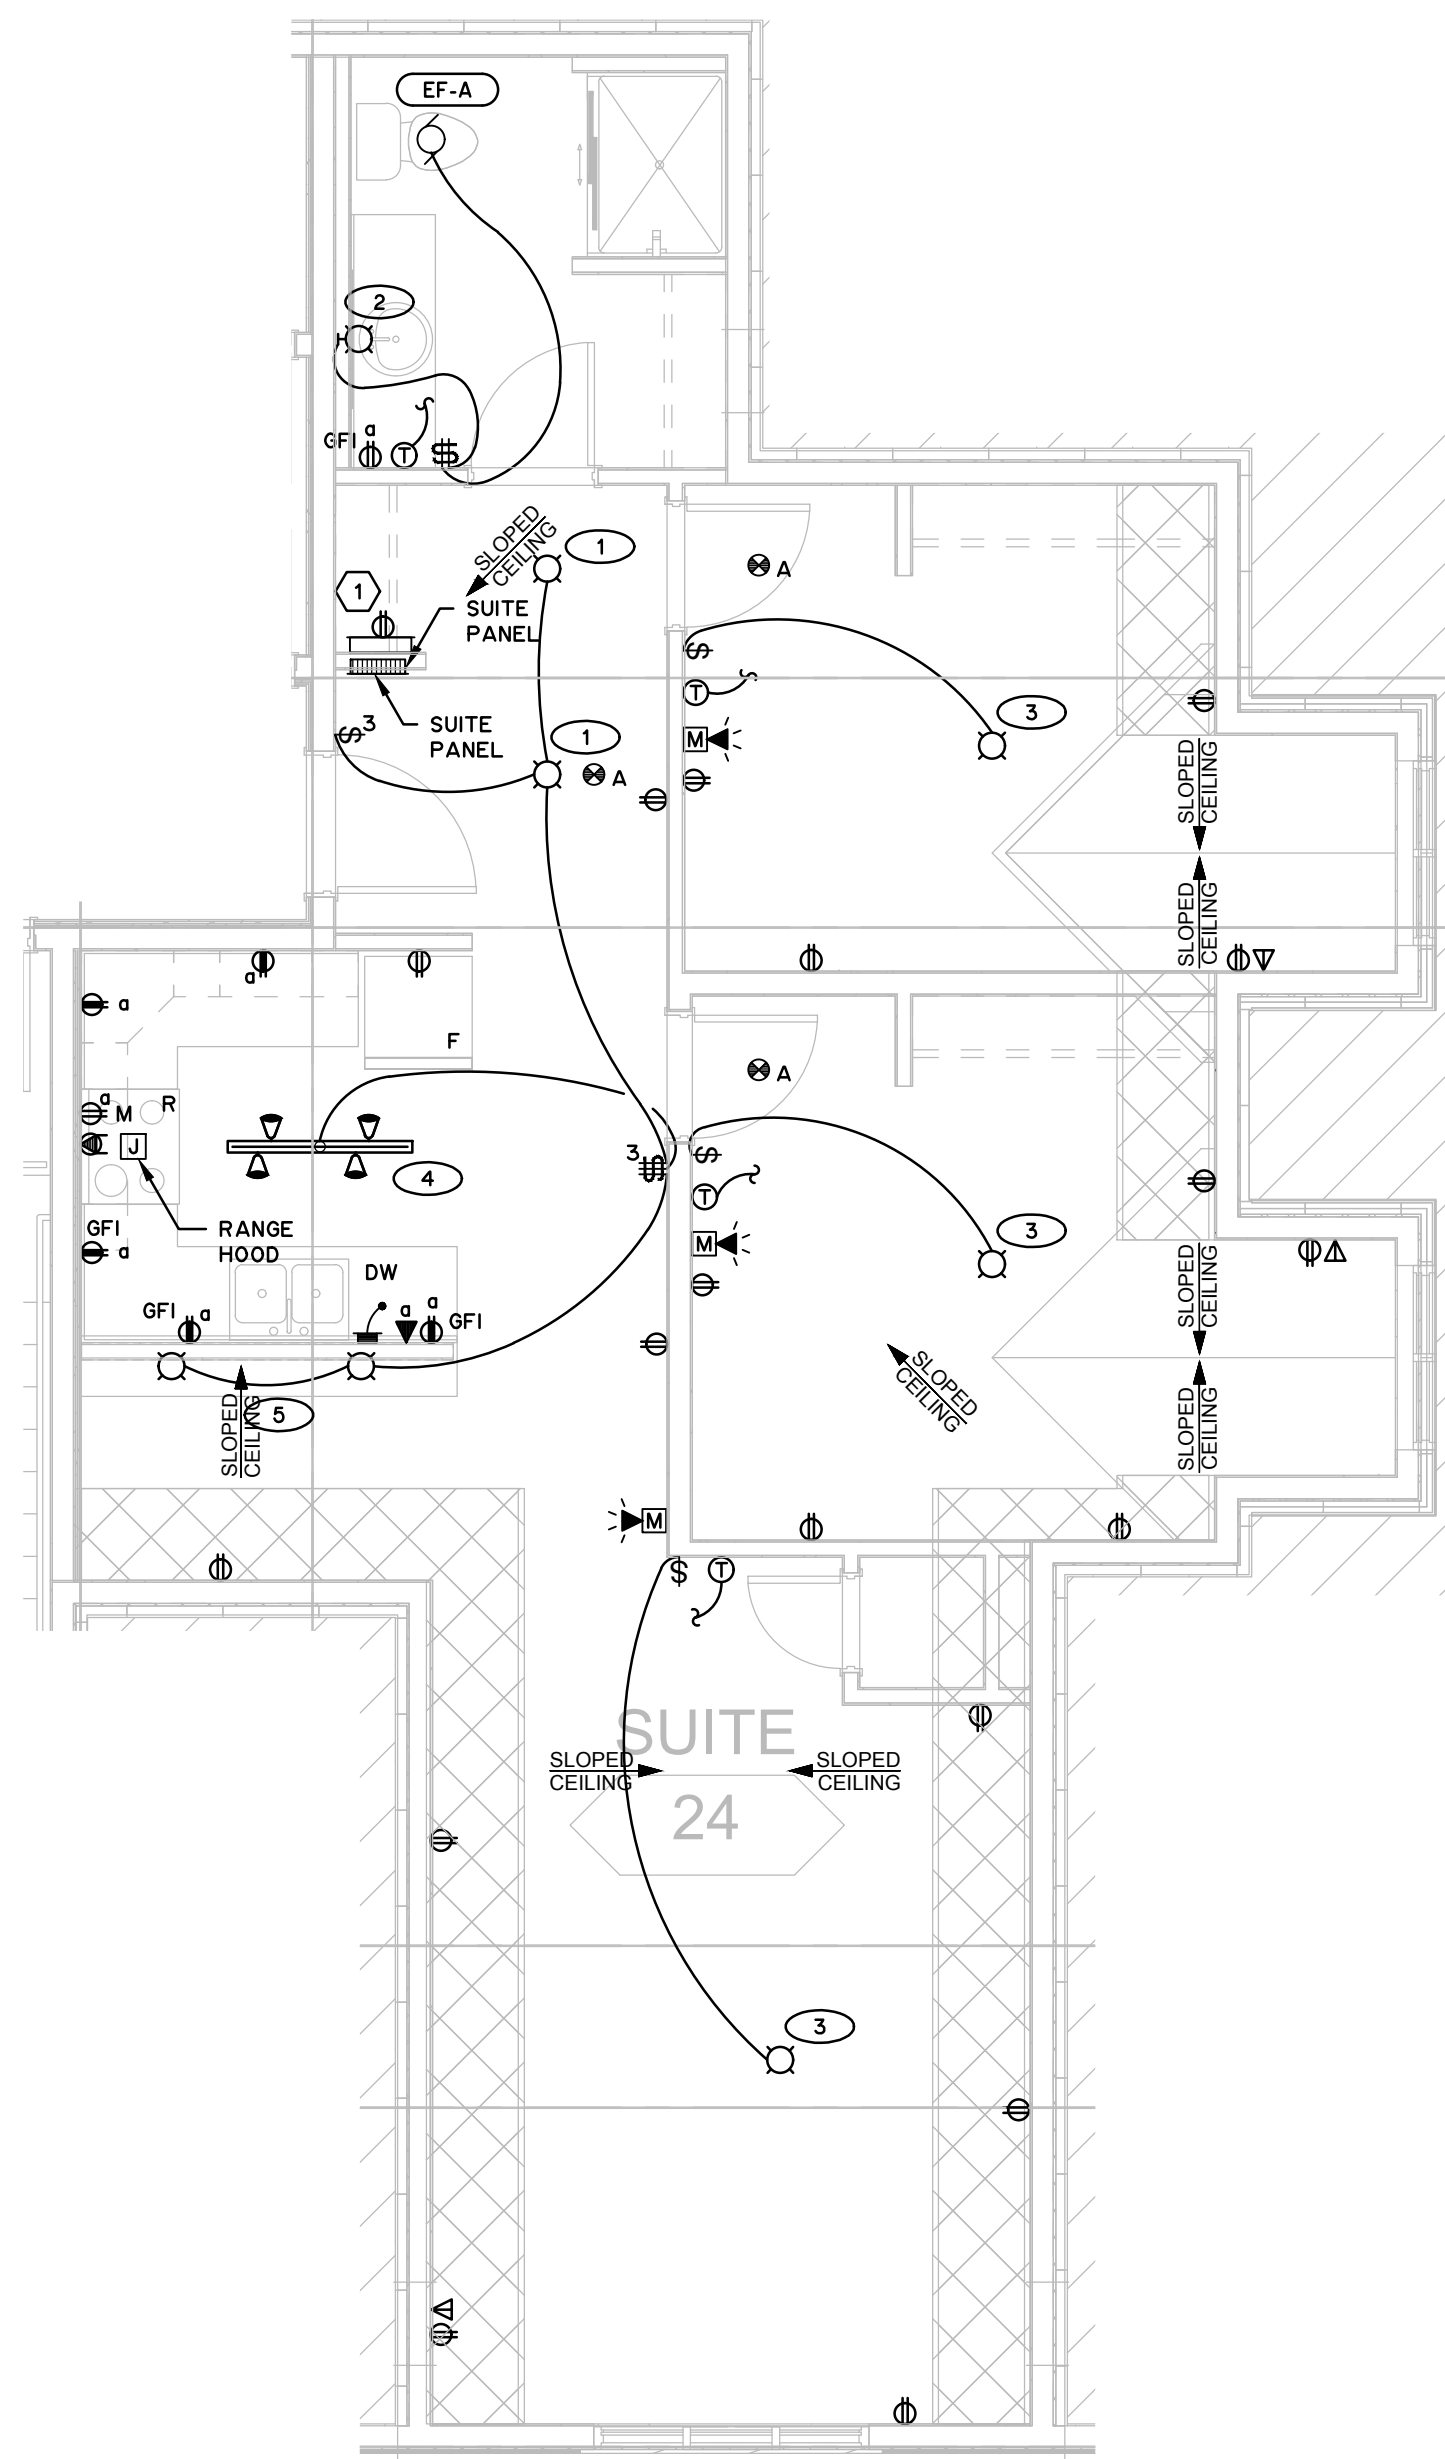
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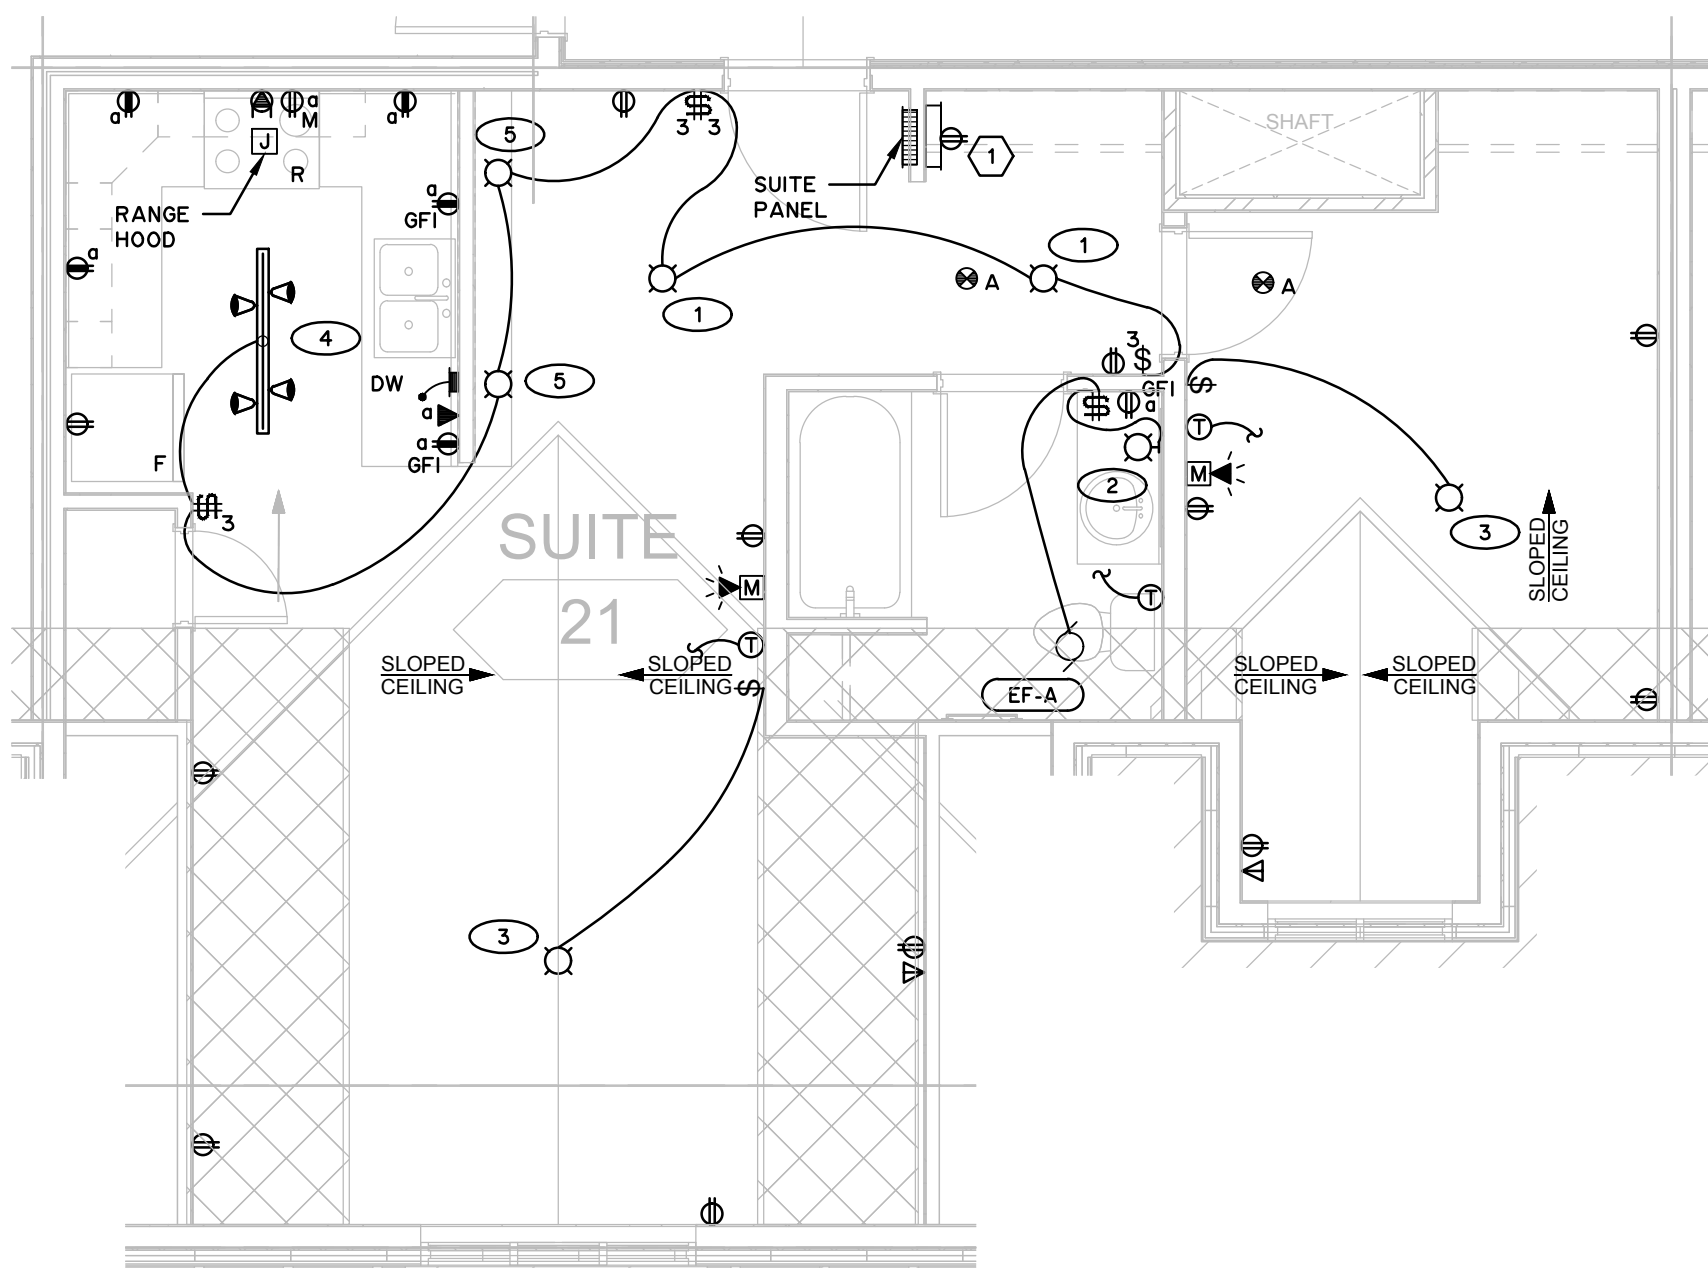
1
E301
LOFT FLOOR PLAN
TYPICAL SUITE '20'
SCALE: 1:50

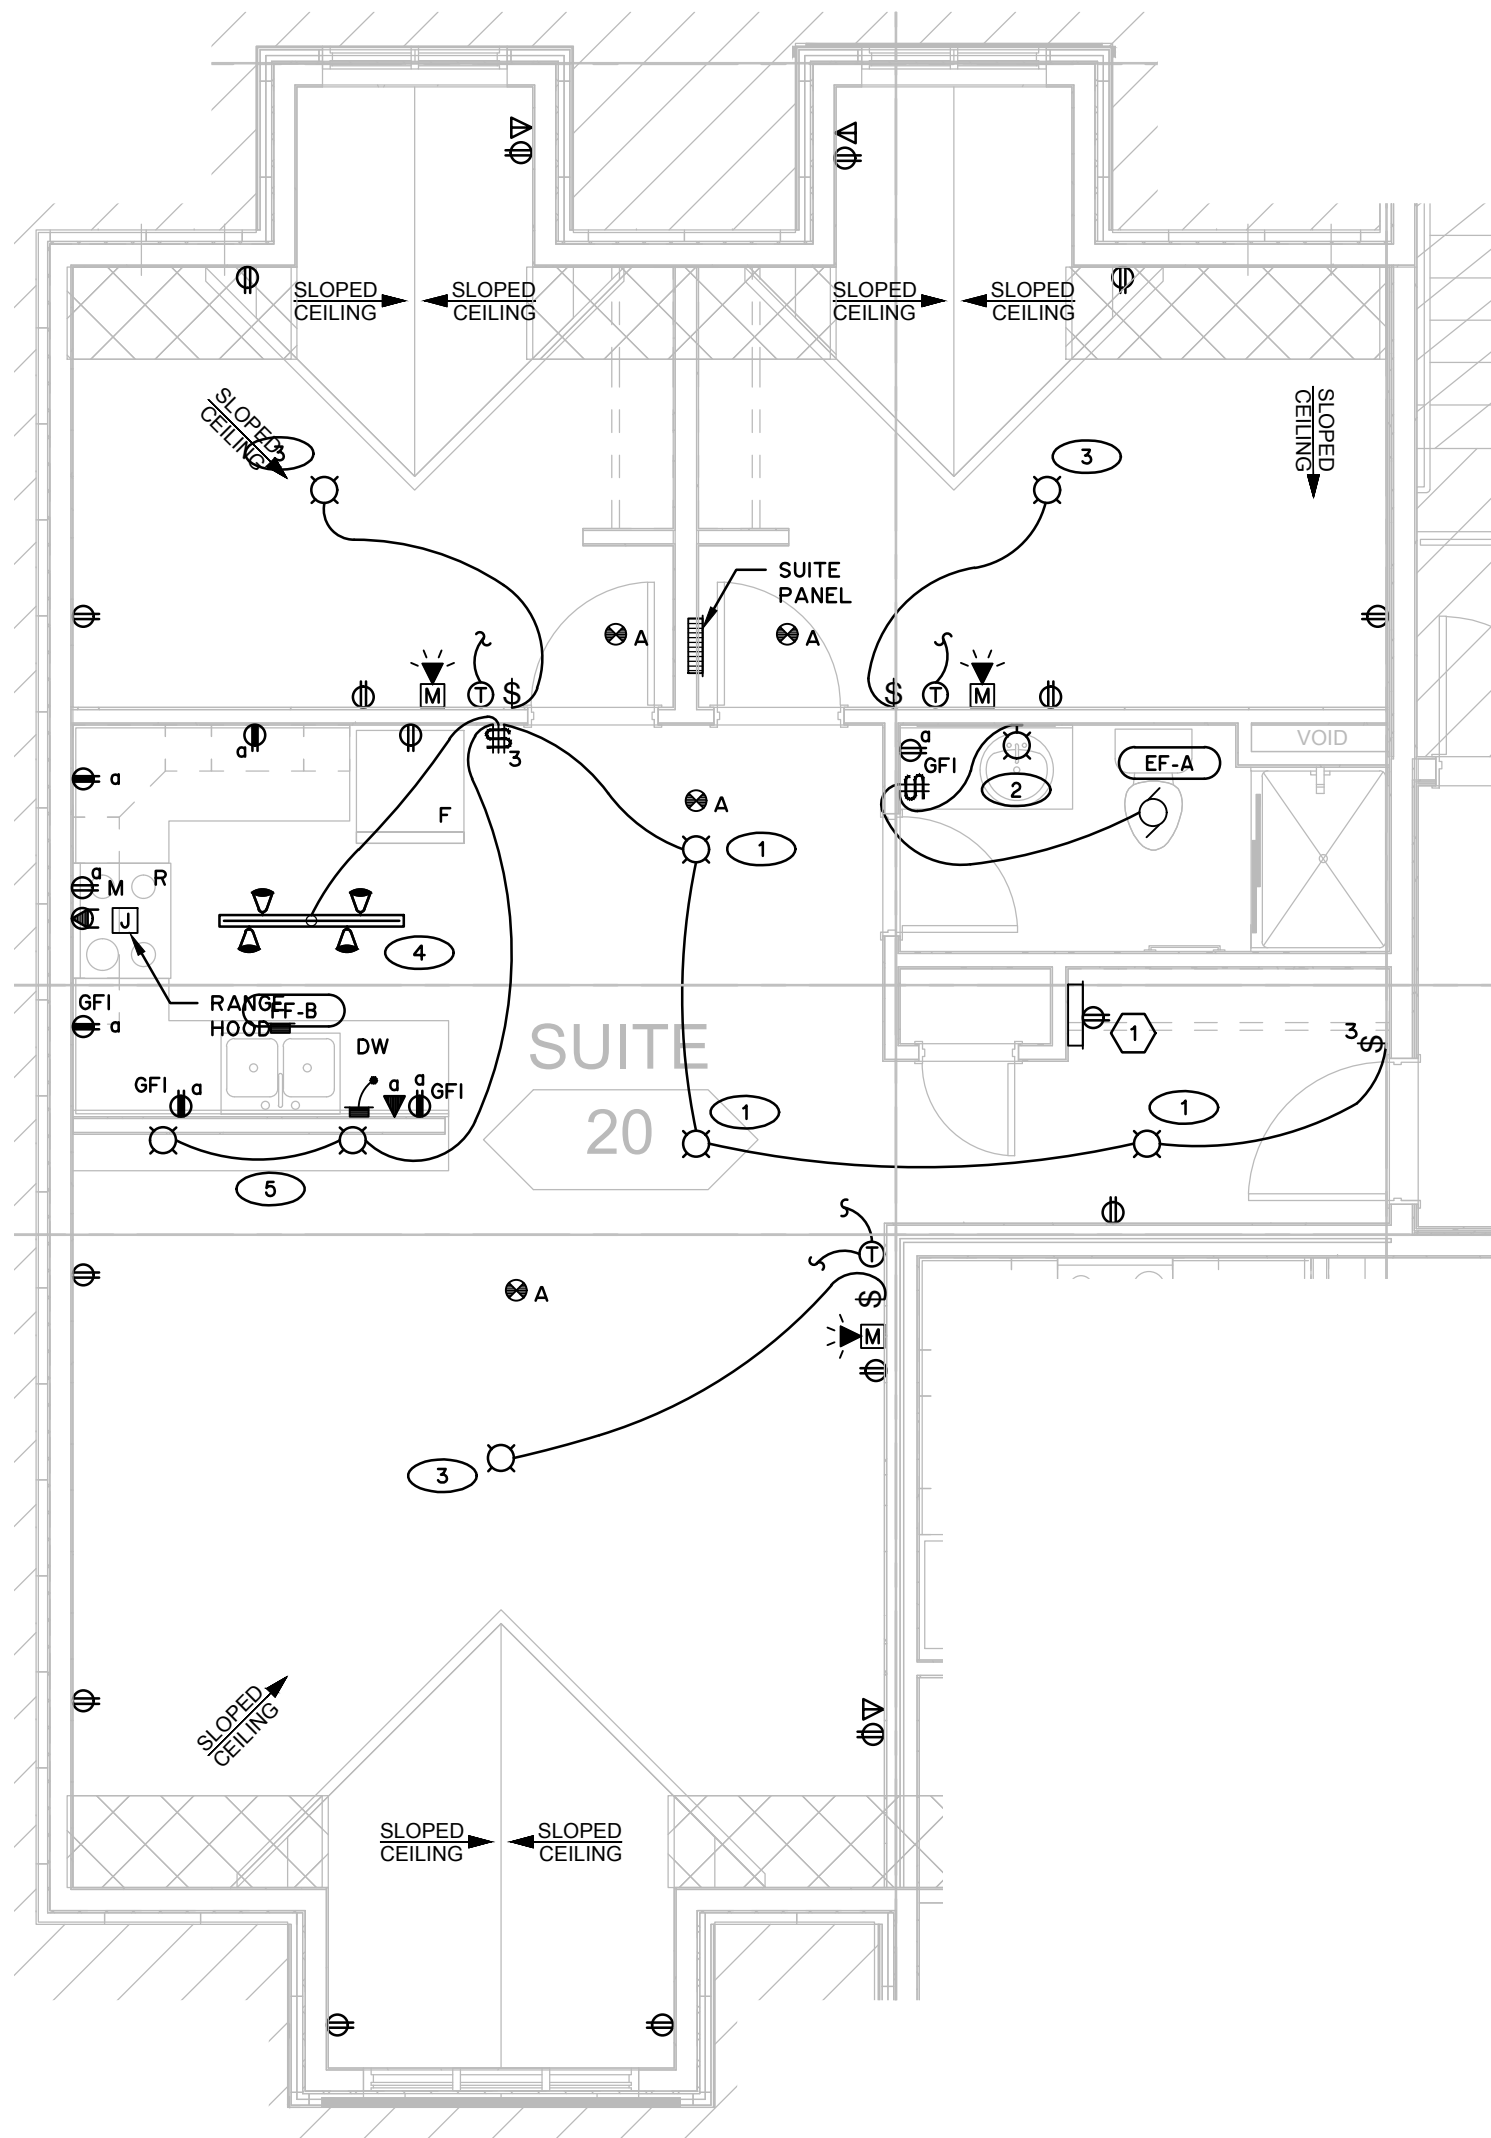

2
E301
LOFT FLOOR PLAN
TYPICAL SUITE '22'
SCALE: 1:50

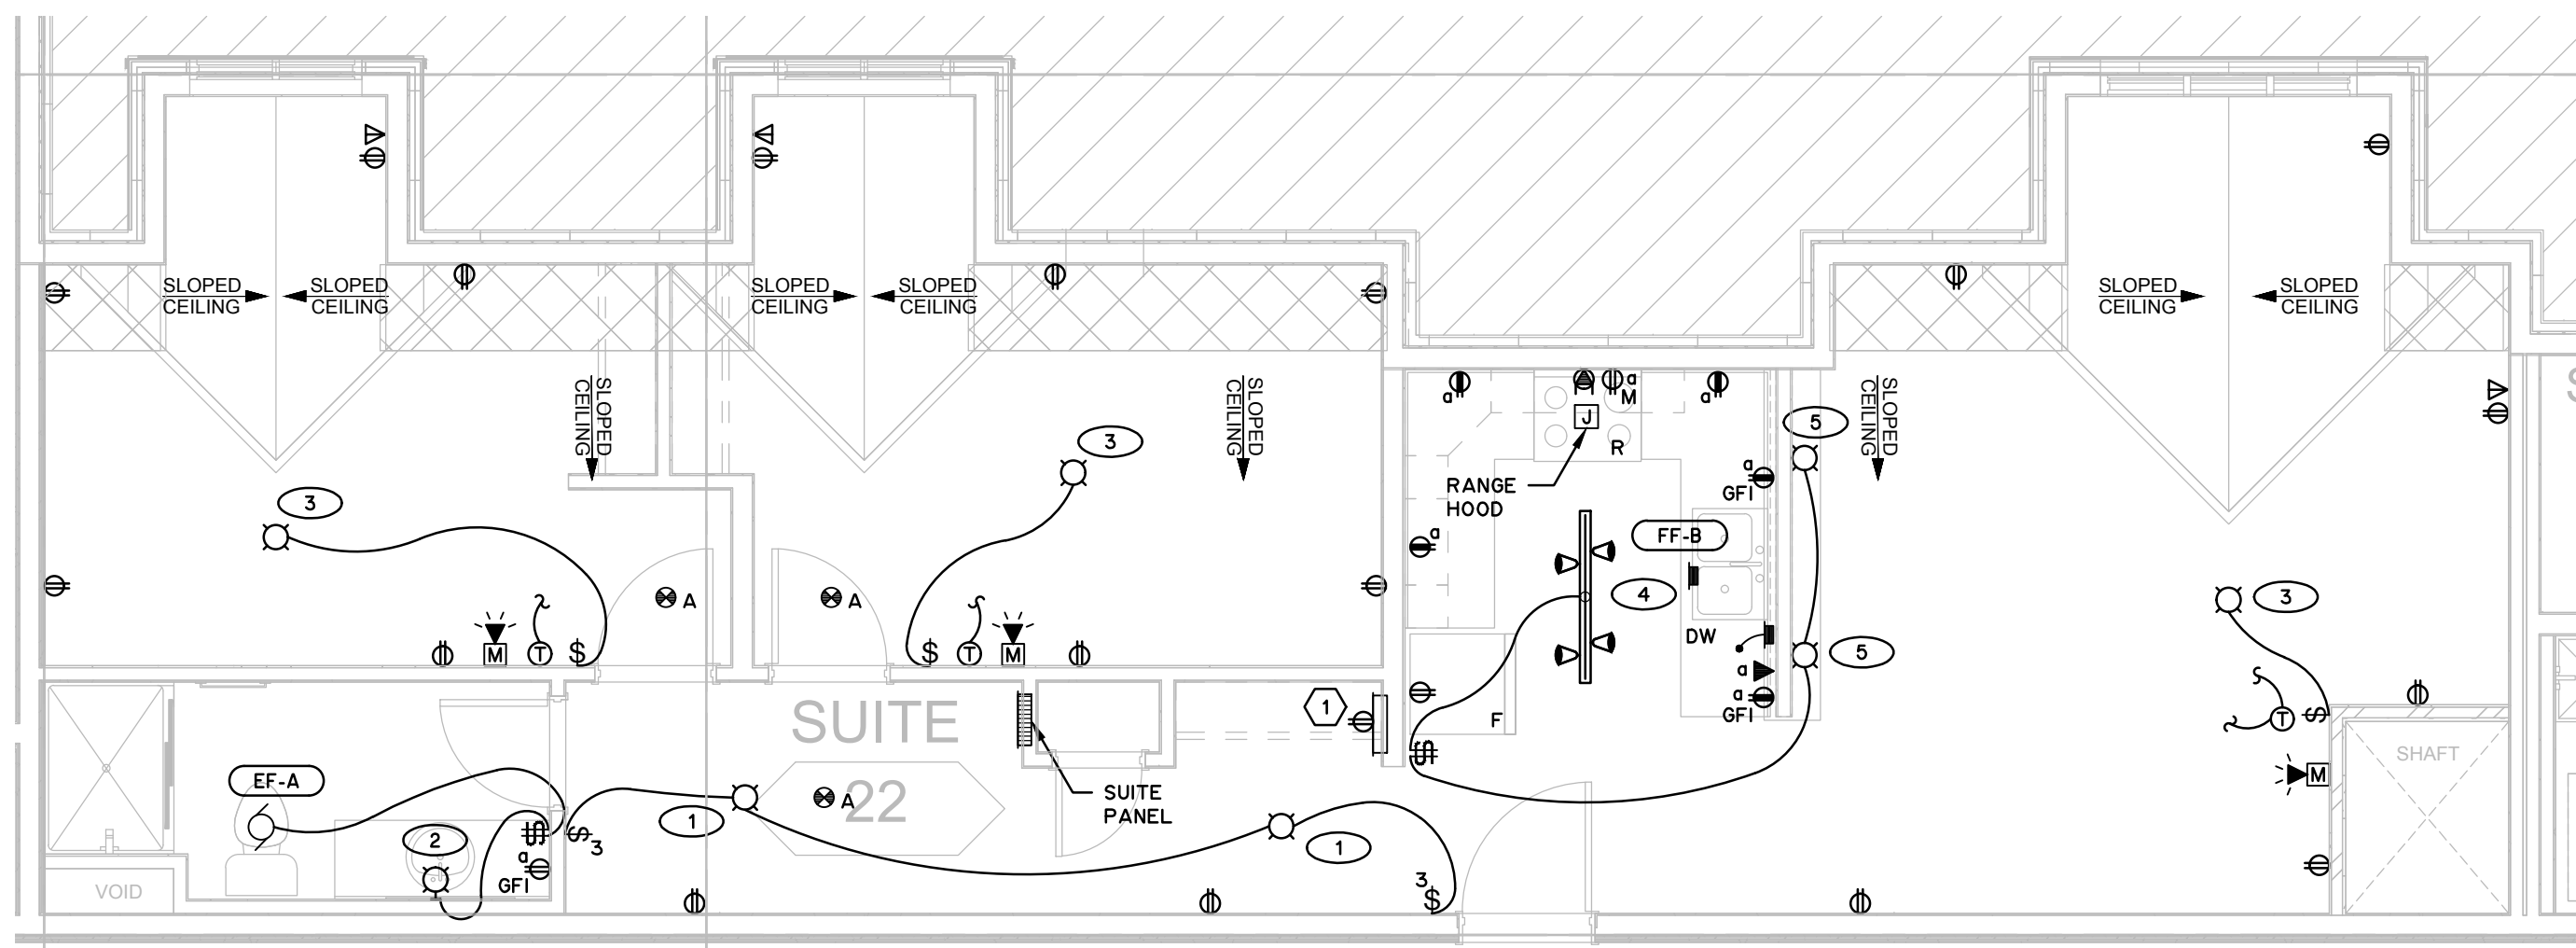

3
E301
LOFT FLOOR PLAN
TYPICAL SUITE '24'
SCALE: 1:50



4
E301
LOFT FLOOR PLAN
TYPICAL SUITE '21'
SCALE: 1:50

KEY NOTES:

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SITE INFORMATION

MUNICIPAL ADDRESS: WATERTON, WATERTON LAKES
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LEGAL LAND DESC.: LOTS 20 & 21 BLOCK 42

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Revision / Revision

A	A
C	C

Consultant's Name
Nom de l'expert-conseil



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Sceau de l'ingénieur

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Project title/Titre du projet

Staff Housing Phase 2
Waterton Lakes National
Park

Drawing title/Titre du dessin

TYPICAL SUITE PLANS
ELECTRICAL LAYOUT

Surveyed by/Arpenté par	Drawn by/Dessiné par	Date/Date
J.M.T.	L.L.L.	2016-04-21
Designed by/Concept par	Reviewed by/Revisé par	Scale/Echelle
J.M.T.	K.O.K.	AS INDICATED

PWGSC Project Manager/Administrateur de Projets TPSCC

Client Acceptance/Acceptation du client

Approved by/Approuvé par

Per Responsible Officer/Agel Responsable

Project No./No. du projet

Asset No./No. du bien

Sheet No./
No. de la feuille

Drawing Reference No./No. de référence du dessin

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EMERGENCY LIGHTING BATTERY PACK SCHEDULE							
BATTERY PACK No.	EXIT SIGN LOAD	SINGLE HEAD LOAD	DOUBLE HEAD LOAD	TOTAL LOAD	SPECIFICATION	LOCATION	
BP-1	5 UNIT 10 WATTS	0 UNITS 0 WATTS	12 UNITS 144 WATTS	156 WATTS	AS LUMACELL RG12S220 /2LD10-A/T	BASEMENT ELECTRICAL ROOM	
BP-2	6 UNITS 36 WATTS	UNITS 0 WATTS	13 UNITS 156 WATTS	192 WATTS	AS LUMACELL RG12S220 /2LD10-A/T	MAIN FLOOR ELECTRICAL CLOSET	

No.	GENERAL DESCRIPTION	LOCATION	LOAD	VOLTS	PHASE	FEEDER/PROTECTION	CIRCUIT	NOTES
B-1	BOILER	MECHANICAL ROOM B5	FRAC	120	1	24x.12 RW90-CU IN 21mmC TO 15A-1P BREAKER	B-31	PROVIDE CONTROL CIRCUIT. PROVIDE MOBILE ON/OFF TOGGLE SWITCH. CONNECT UP LOW WATER CUTOFFS
B-2	BOILER	MECHANICAL ROOM B5	FRAC	120	1	24x.12 RW90-CU IN 21mmC TO 15A-1P BREAKER	B-33	PROVIDE CONTROL CIRCUIT. PROVIDE MOBILE ON/OFF TOGGLE SWITCH. CONNECT UP LOW WATER CUTOFFS
BFA	DRYER BOOSTER FAN (TYPICAL OF 3)	BASEMENT LAUNDRY	FRAC EACH	120	1	24x.12 RW90-CU IN 21mmC TO REVERSOMATIC DRYER RECEPTACLE	-	PROVIDE MOTOR PROTECTION SWITCH AND REVERSOMATIC DEC-300 RECEPTACLE FOR EACH DRYER. WIRE UP COMPLETE
DWH-1	DOMESTIC WATER HEATER	MECHANICAL ROOM B5	FRAC	120	1	24x.12 RW90-CU IN 21mmC TO 15A-1P BREAKER	B-35	PROVIDE CONTROL CIRCUIT
DWH-2	DOMESTIC WATER HEATER	MECHANICAL ROOM B5	FRAC	120	1	24x.12 RW90-CU IN 21mmC TO 15A-1P BREAKER	B-37	PROVIDE CONTROL CIRCUIT
EF-1	EXHAUST FAN	TENANT STORAGE B4	1 HP	240	1	34x.12 RW90-CU IN 21mmC TO 20A-2P BREAKER	B-39,41	PROVIDE COMBINATION MAGNETIC STARTER AND HOA SWITCH. I/L WITH MUA-1
EF-A	EXHAUST FAN	BATHROOMS SUITES	FRAC	120	1	24x.12 NM90-CU IN FREE AIR TO LINE SIDE OF NEIGHBORING LIGHT CIRCUIT	SUITE PANEL	PROVIDE WALL SWITCH. FAN TO SHARE NEIGHBORING LIGHT CIRCUIT
EF-B	EXHAUST FAN	INSIDE STORAGE M6 AND L19	FRAC	120	1	24x.12 RW90-CU IN 21mmC TO 15A-1P BREAKER	L1-38	PROVIDE PROTECTION SWITCH. WIRE TO LINE VOLTAGE THERMOSTAT. ALWAYS ON
FF-A	FORCE FLOW	ENTRANCE M1, M5	40 W	120	1	24x.12 RW90-CU IN 21mmC TO 15A-1P BREAKER	L1-32	PROVIDE MOTOR PROTECTION SWITCH. WIRE TO LINE VOLTAGE THERMOSTAT. COORDINATE W/ CONTROLS CONTRACTOR
FF-B	FORCE FLOW	BATHROOMS AND KITCHENS ON 2ND FLOOR	25 W	120	1	24x.12 NM90-CU IN FREE AIR TO LINE SIDE OF NEIGHBORING LIGHT CIRCUIT	SUITE PANEL	I/L WITH SUITE THERMOSTAT. PROVIDE MOTOR PROTECTION SWITCH. HEATER TO SHARE NEIGHBORING LIGHT CIRCUIT
FF-C	FORCE FLOW	ELECTRICAL ROOM AND SUITE 'A'	40 W	120	1	24x.12 RW90-CU IN 21mmC TO 15A-1P BREAKER	B-18	PROVIDE MOTOR PROTECTION SWITCH. WIRE TO LINE VOLTAGE THERMOSTAT. COORDINATE W/ CONTROLS CONTRACTOR
MUA-1	MAKE-UP AIR UNIT	MECHANICAL ROOM B5	46.8 MCA	240	1	34x.6 RW90-CU IN 27mmC TO 80A-2P BREAKER	B-49,51	PACKAGED UNIT CW VFD. WIRE TO DISC SWITCH FIRST THEN TO VFD. I/L WITH DUCT SMOKE DETECTOR
P-1	HEATING PUMP FOR B-1	MECHANICAL ROOM B7	1/4 HP	120	1	24x.12 RW90-CU IN 21mmC TO 15A-1P BREAKER	B-20	PROVIDE MAGNETIC STARTER CW. PROTECTION SWITCH. HOA SWITCH AND PILOT LIGHTS. I/L WITH BOILER B-1
P-2	HEATING PUMP FOR B-2	MECHANICAL ROOM B7	1/4 HP	120	1	24x.12 RW90-CU IN 21mmC TO 15A-1P BREAKER	B-22	PROVIDE MAGNETIC STARTER CW. PROTECTION SWITCH. HOA SWITCH AND PILOT LIGHTS. I/L WITH BOILER B-2
P-3	HEATING PUMP	MECHANICAL ROOM B7	1 HP	240	1	34x.12 RW90-CU IN 21mmC TO 20A-2P BREAKER	B-36,38	PACKAGED UNIT. PROVIDE DISCONNECT SWITCH AT UNIT. I/L WITH BMS
P-4	HEATING PUMP	MECHANICAL ROOM B7	1 HP	240	1	34x.12 RW90-CU IN 21mmC TO 20A-2P BREAKER	B-40,42	PACKAGED UNIT. PROVIDE DISCONNECT SWITCH AT UNIT. I/L WITH BMS
P-6	RECIRC PUMP FOR DWH	MECHANICAL ROOM B7	FRAC	120	1	24x.12 RW90-CU IN 21mmC TO 15A-1P BREAKER	B-24	PROVIDE MOTOR PROTECTION SWITCH CW. PILOT LIGHT. I/L WITH BMS
P-6	STORM SUMP PUMP	MECHANICAL ROOM B5	3/4 HP	120	240	24x.12 RW90-CU IN 21mmC TO 30A-1P BREAKER	B-28	PROVIDE COMBINATION MAGNETIC STARTER AND HOA SWITCH. WIRE UP FLOATS. I/L WITH BMS.
P-7	STORM SUMP PUMP	MECHANICAL ROOM B5	3/4 HP	120	1	24x.12 RW90-CU IN 21mmC TO 30A-1P BREAKER	B-30	PROVIDE COMBINATION MAGNETIC STARTER AND HOA SWITCH. WIRE UP FLOATS. I/L WITH BMS.
P-8	SANITARY SUMP PUMP	MECHANICAL ROOM B5	1/3 HP	120	1	24x.12 RW90-CU IN 21mmC TO 15A-1P BREAKER	B-32	PROVIDE COMBINATION MAGNETIC STARTER AND HOA SWITCH. WIRE UP FLOATS. I/L WITH BMS.
P-9	SANITARY SUMP PUMP	MECHANICAL ROOM B5	1/3 HP	120	1	24x.12 RW90-CU IN 21mmC TO 15A-1P BREAKER	B-34	PROVIDE COMBINATION MAGNETIC STARTER AND HOA SWITCH. WIRE UP FLOATS. I/L WITH BMS.
TF-1	TRANSFER FAN	ELECTRICAL ROOM B6	FRAC	120	1	24x.12 RW90-CU IN 21mmC TO 15A-1P BREAKER	B-56	PROVIDE PROTECTION SWITCH. WIRE TO REVERSE ACTING THERMOSTAT
TK-3	GYCOL TANK PUMP	MECHANICAL ROOM B5	0.25 KW	120	1	24x.12 RW90-CU IN 21mmC TO 15A-1P BREAKER	B-46	PROVIDE MOTOR PROTECTION SWITCH CW. PILOT LIGHT
UH-1	UNIT HEATER	OPEN STORAGE B9	FRAC	120	1	24x.12 RW90-CU IN 21mmC TO 15A-1P BREAKER	B-43	PROVIDE PROTECTION SWITCH. WIRE TO LINE VOLTAGE THERMOSTAT.
UH-2	UNIT HEATER	TENANT STORAGE B8	FRAC	120	1	24x.12 RW90-CU IN 21mmC TO 15A-1P BREAKER	B-43	PROVIDE PROTECTION SWITCH. WIRE TO LINE VOLTAGE THERMOSTAT.
UH-3	UNIT HEATER	TENANT STORAGE B8	FRAC	120	1	24x.12 RW90-CU IN 21mmC TO 15A-1P BREAKER	B-45	PROVIDE PROTECTION SWITCH. WIRE TO LINE VOLTAGE THERMOSTAT.
UH-4	UNIT HEATER	MECHANICAL ROOM B7	FRAC	120	1	24x.12 RW90-CU IN 21mmC TO 15A-1P BREAKER	B-45	PROVIDE PROTECTION SWITCH. WIRE TO LINE VOLTAGE THERMOSTAT.
UH-5	UNIT HEATER	TENANT STORAGE B3	FRAC	120	1	24x.12 RW90-CU IN 21mmC TO 15A-1P BREAKER	B-54	PROVIDE PROTECTION SWITCH. WIRE TO LINE VOLTAGE THERMOSTAT.
UH-6	UNIT HEATER	PARKS STORAGE B4	FRAC	120	1	24x.12 RW90-CU IN 21mmC TO 15A-1P BREAKER	B-54	PROVIDE PROTECTION SWITCH. WIRE TO LINE VOLTAGE THERMOSTAT.
UH-7	UNIT HEATER	PARKS STORAGE B4	FRAC	120	1	24x.12 RW90-CU IN 21mmC TO 15A-1P BREAKER	B-54	PROVIDE PROTECTION SWITCH. WIRE TO LINE VOLTAGE THERMOSTAT.


LUMINAIRE FIXTURE SCHEDULE						
No.	GENERAL DESCRIPTION	LOCATION	LAMPS	VOLTAGE	SPECIFICATION/COMMENTS	
1	SURFACE MOUNT CORRIDOR / ENTRANCE LIGHT FIXTURE	SUITES - CORRIDORS / ENTRANCES	3 9W LED 1100 LUMEN 3000K	120	COOPER, LITHONIA, WAC LIGHTING, OR APPROVED EQUIVALENTS PER SPECIFICATIONS	
2	BATHROOM VANITY LIGHT FIXTURE	SUITES - BATHROOMS	MID-FLEX LED 2400 LUMEN 3000K	120	COOPER, LITHONIA, WAC LIGHTING, OR APPROVED EQUIVALENTS PER SPECIFICATIONS	
3	SURFACE MOUNT BEDROOM LIGHT FIXTURE	SUITES - BEDROOMS/LIVING ROOM	24W LED 2000 LUMEN 3000K	120	COOPER, LITHONIA, WAC LIGHTING, OR APPROVED EQUIVALENTS PER SPECIFICATIONS	
4	SURFACE MOUNT TRACK KITCHEN LIGHT FIXTURE	SUITES - KITCHEN	5 INTEGRAL SPOT HEADS 300K LED	120	COOPER, LITHONIA, WAC LIGHTING, OR APPROVED EQUIVALENTS PER SPECIFICATIONS	
6	SUSPENDED PENDANT KITCHEN COUNTER LIGHT FIXTURE	SUITES - KITCHEN COUNTER	400 LUMEN 3000K LED	120	COOPER, LITHONIA, WAC LIGHTING, OR APPROVED EQUIVALENTS PER SPECIFICATIONS	
101	1220mm CEILING MOUNTED WRAP AROUND FLUORESCENT LIGHT FIXTURE	BASEMENT - PUBLIC AREAS	2x32 WATT 4100K T-8	120	COOPER, LITHONIA, WAC LIGHTING, OR APPROVED EQUIVALENTS PER SPECIFICATIONS	
102	1220mm CEILING MOUNTED FLUORESCENT STRIP WITH WIREGUARD	BASEMENT - SERVICE ROOMS	2x32 WATT 4100K T-8	120	COOPER, LITHONIA, WAC LIGHTING, OR APPROVED EQUIVALENTS PER SPECIFICATIONS	
103	KEYLESS LAMPHOLDER	MAIN FLOOR - SERVICE ROOMS	16 WATT E26 LED BULB 4100K	120	COOPER, LITHONIA, WAC LIGHTING, OR APPROVED EQUIVALENTS PER SPECIFICATIONS	
104	1220mm CEILING MOUNTED FLUORESCENT STRIP WITH WIREGUARD	SECOND FLOOR - STORAGE ROOM, JANITOR ROOM	1x32 WATT 4100K T-8	120	COOPER, LITHONIA, WAC LIGHTING, OR APPROVED EQUIVALENTS PER SPECIFICATIONS	
301	RECESSED 4" POTLIGHT FIXTURE, SUITABLE FOR OUTDOOR MOUNTING	EXTERIOR CANOPY - ALL SIDES	650 LUMEN 3000K LED	120	COOPER, LITHONIA, WAC LIGHTING, OR APPROVED EQUIVALENTS PER SPECIFICATIONS	
302	EXTERIOR WALL MOUNTED LIGHT FIXTURE	EXTERIOR OF BUILDING - FACING GRAVEL LANE	47W LED 3800 LUMEN 3000K	120	COOPER, LITHONIA, WAC LIGHTING, OR APPROVED EQUIVALENTS PER SPECIFICATIONS	
303	WALL MOUNTED STAIRCASE LED FIXTURE	STAIRCASE RISER	19W LED 1515 LUMEN 3000K	120	COOPER, LITHONIA, WAC LIGHTING, OR APPROVED EQUIVALENTS PER SPECIFICATIONS	
304	280mm CEILING MOUNTED STAIRCASE LED FIXTURE	STAIRCASE RISER	19W LED 1515 LUMEN 3000K	120	COOPER, LITHONIA, WAC LIGHTING, OR APPROVED EQUIVALENTS PER SPECIFICATIONS	
305	RECESSED 6" POTLIGHT FIXTURE SUITABLE FOR DRYWALL MOUNTING	PUBLIC AREAS	1200 LUMENS LED 3000K	120	COOPER, LITHONIA, WAC LIGHTING, OR APPROVED EQUIVALENTS PER SPECIFICATIONS	
306	RECESSED 4" DIRECTIONAL POTLIGHT FIXTURE, SUITABLE FOR OUTDOOR MOUNTING	EXTERIOR FRONT CANOPY	650 LUMEN 3000K LED	120	COOPER, LITHONIA, WAC LIGHTING, OR APPROVED EQUIVALENTS PER SPECIFICATIONS	

MUNICIPAL ADDRESS: WATERTON, WATERTON LAKES
NATIONAL PARK
LEGAL LAND DESC.: LOTS 20 & 21 BLOCK 42

No.	Date/Date	Description/Description	Drawn by Dessine par	Approved Approuve
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A	detail number numero de detail
B	source drawing no. de dessin no.
C	detail on drawing

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Sceau de l'ingenieur

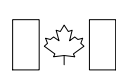

Le Client Entretien l'Équipe
Alberta Méridional
Branche d'Opérations

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Canada

Ouest et Nord
du Canada

Staff Housing Phase 2 Waterton Lakes National Park

ELECTRICAL SCHEDULES

Drawn by/Dessine par

L.L.L.	2016-04-21
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Designed by
J.M.T.

Reviewed by/Revise p
K.O.K.

Randy Boldt

Approved by/Approuve par

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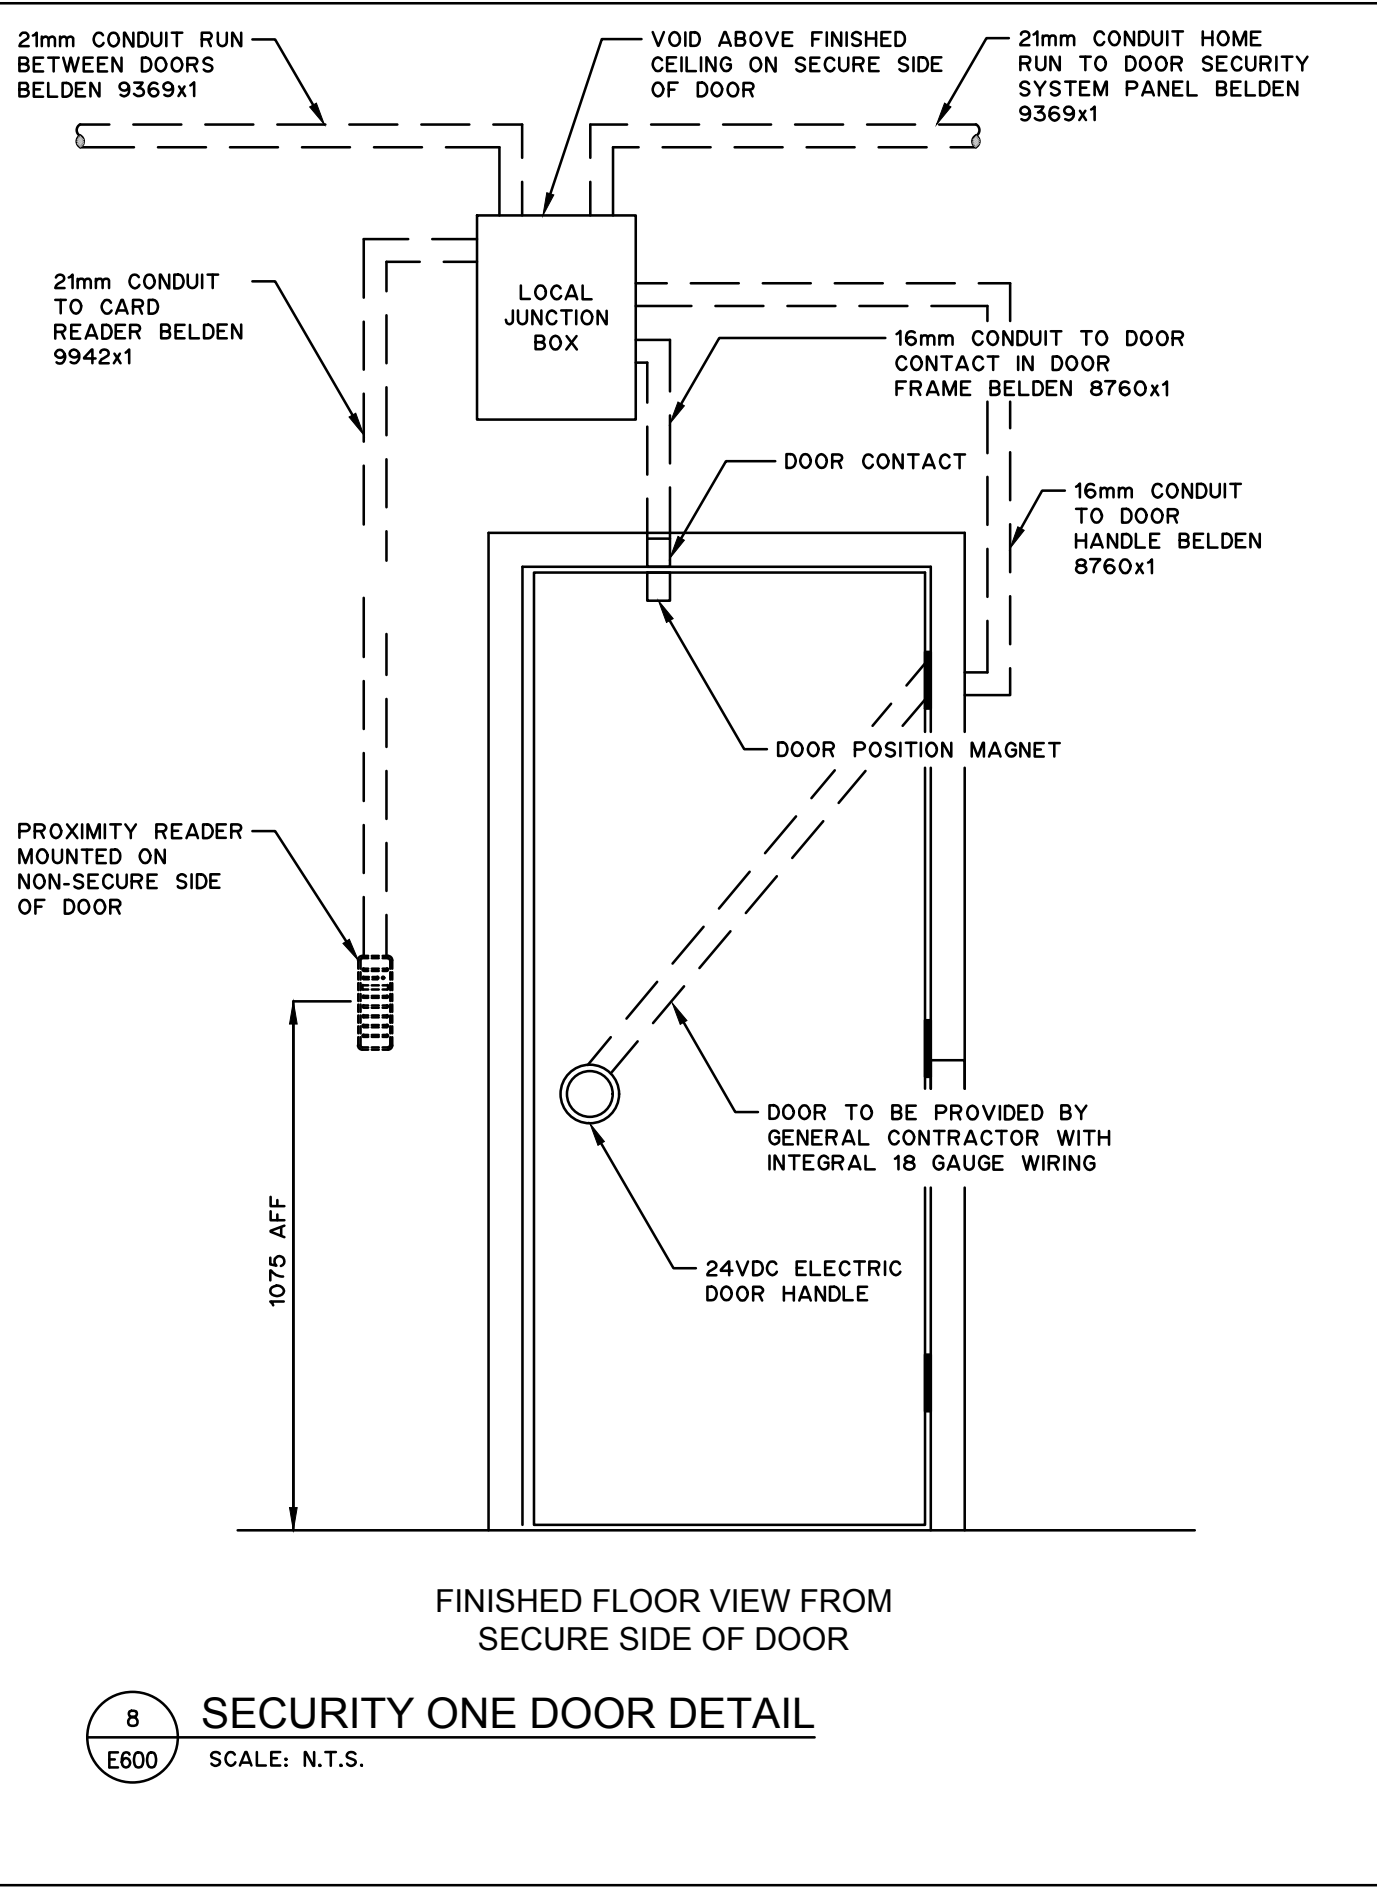
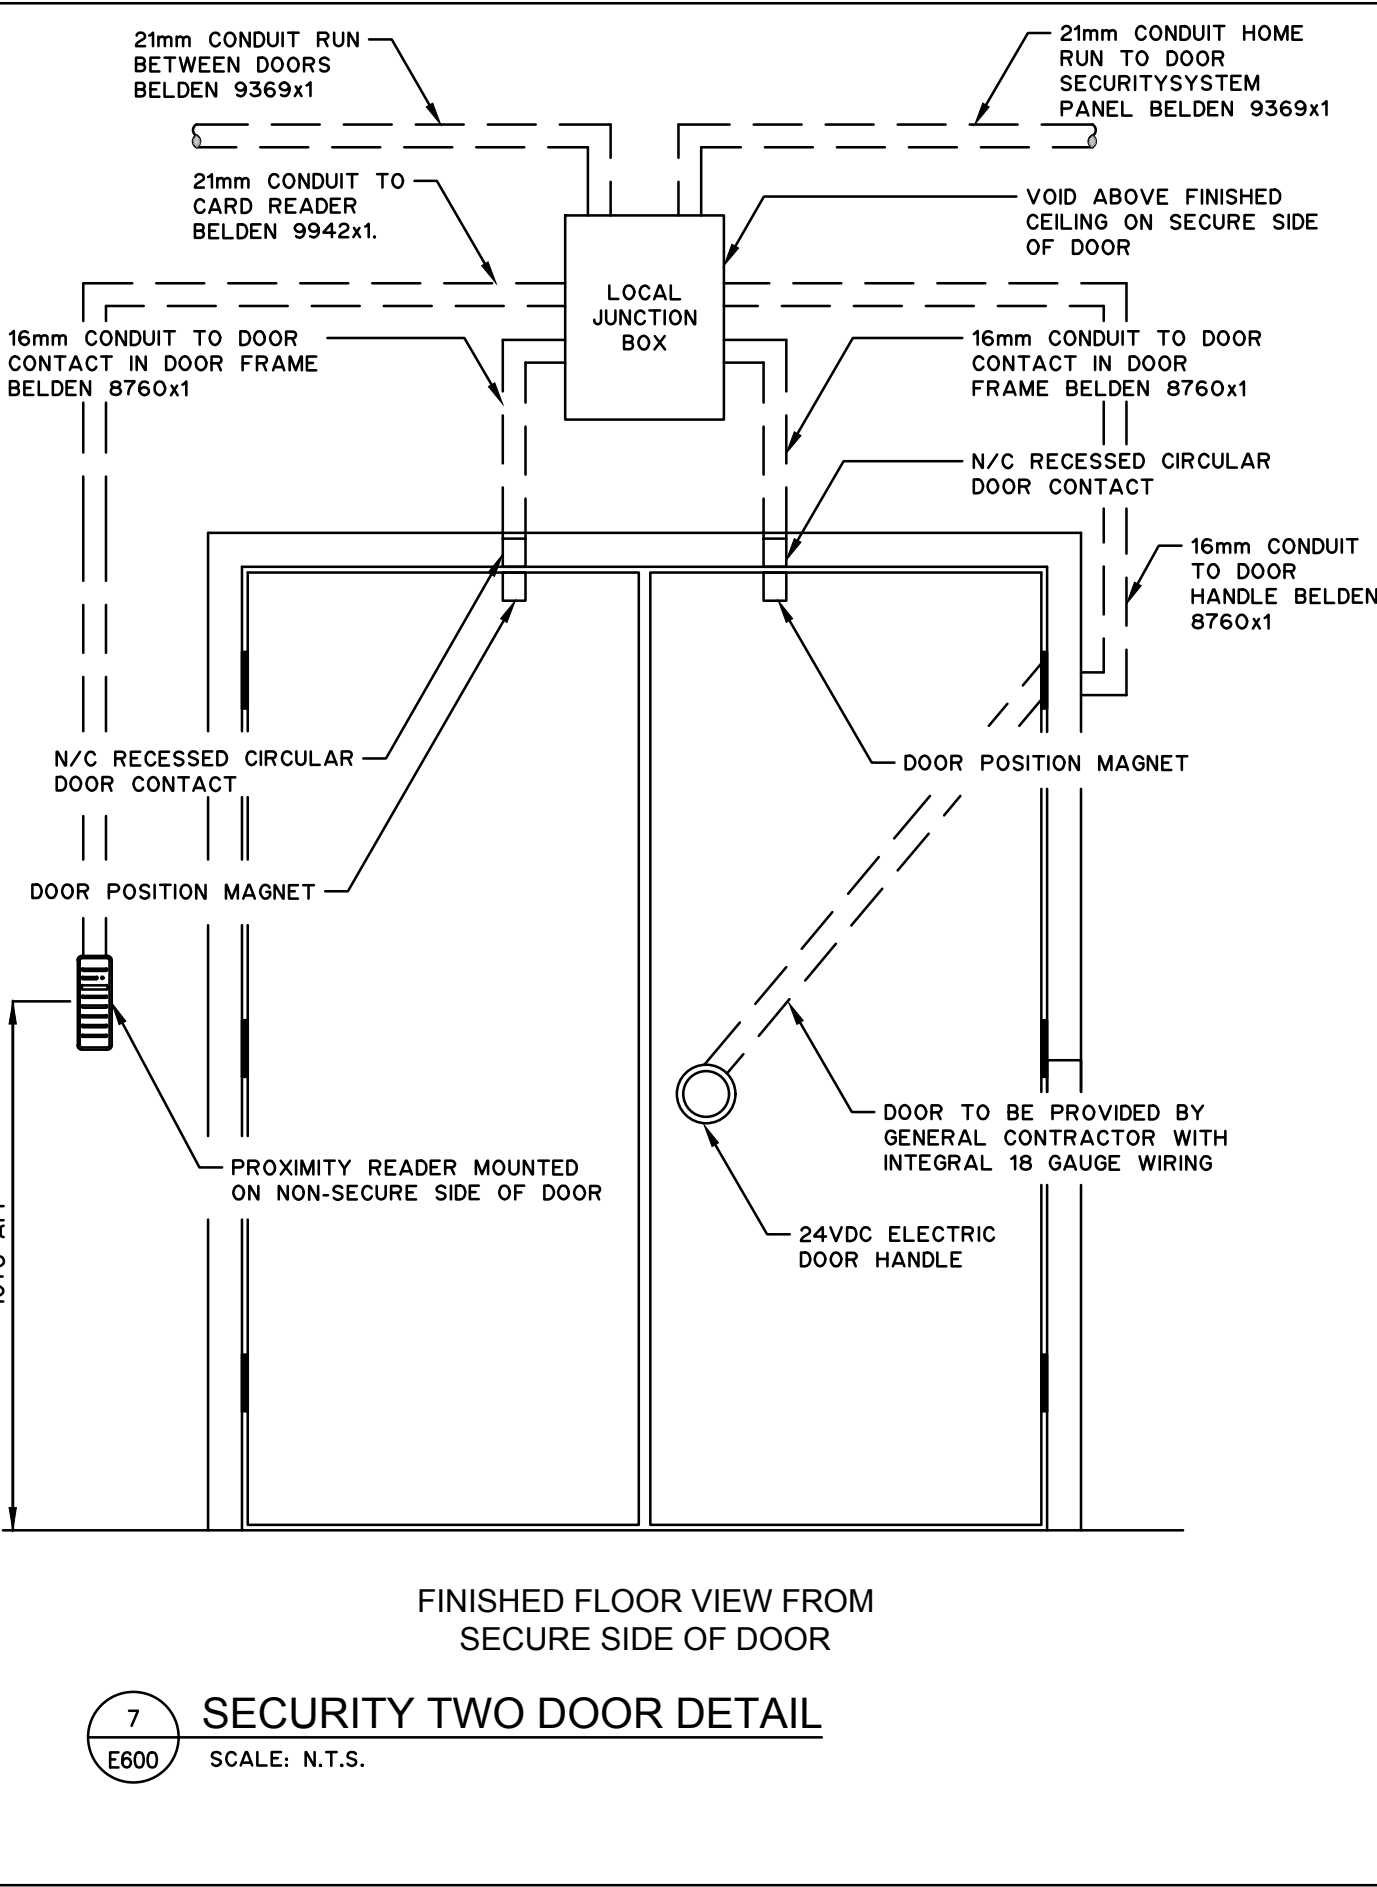
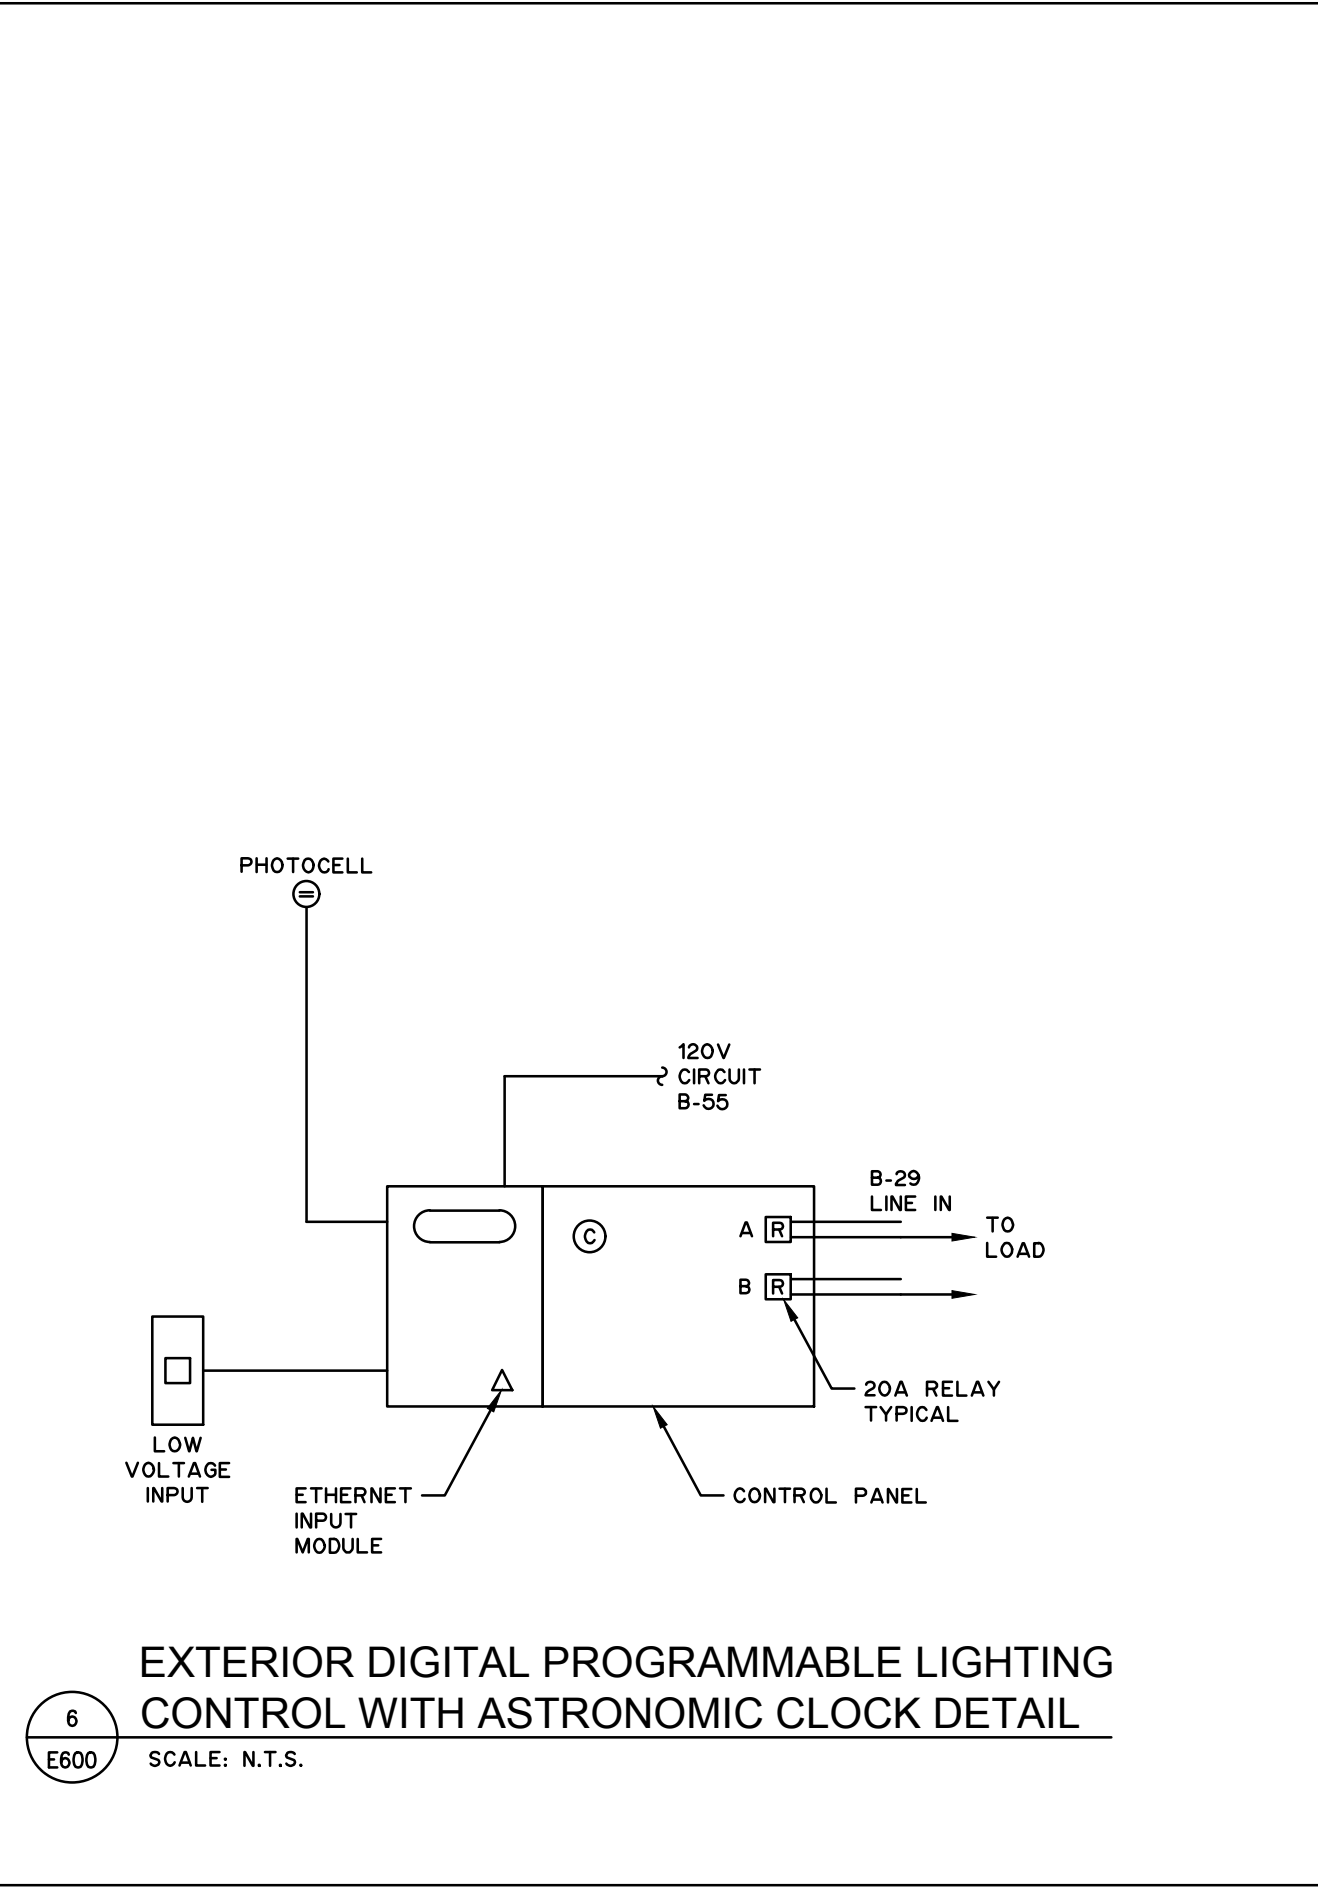
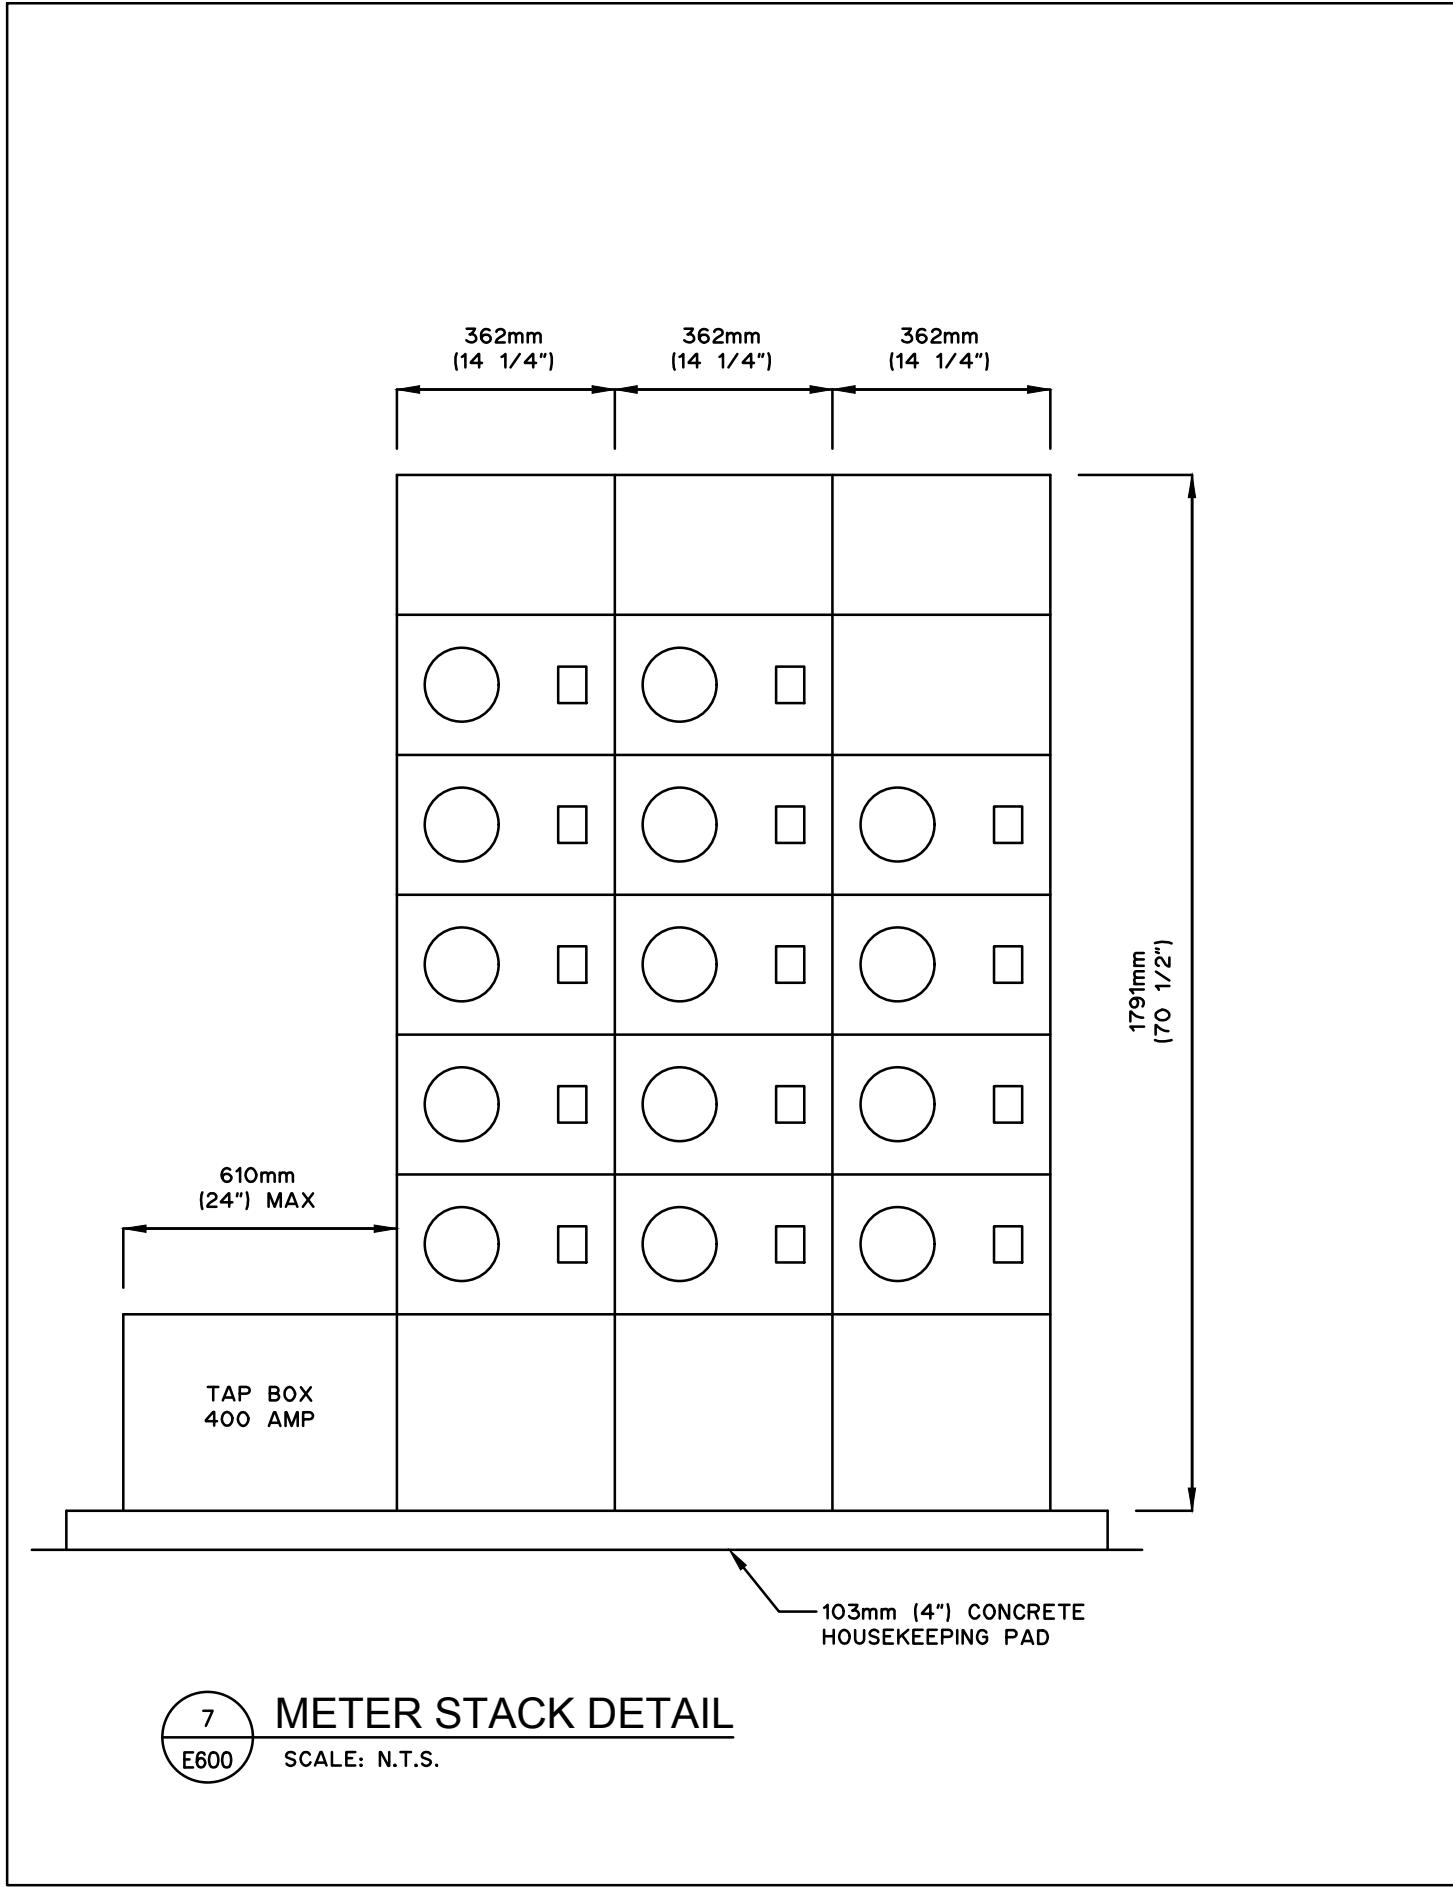
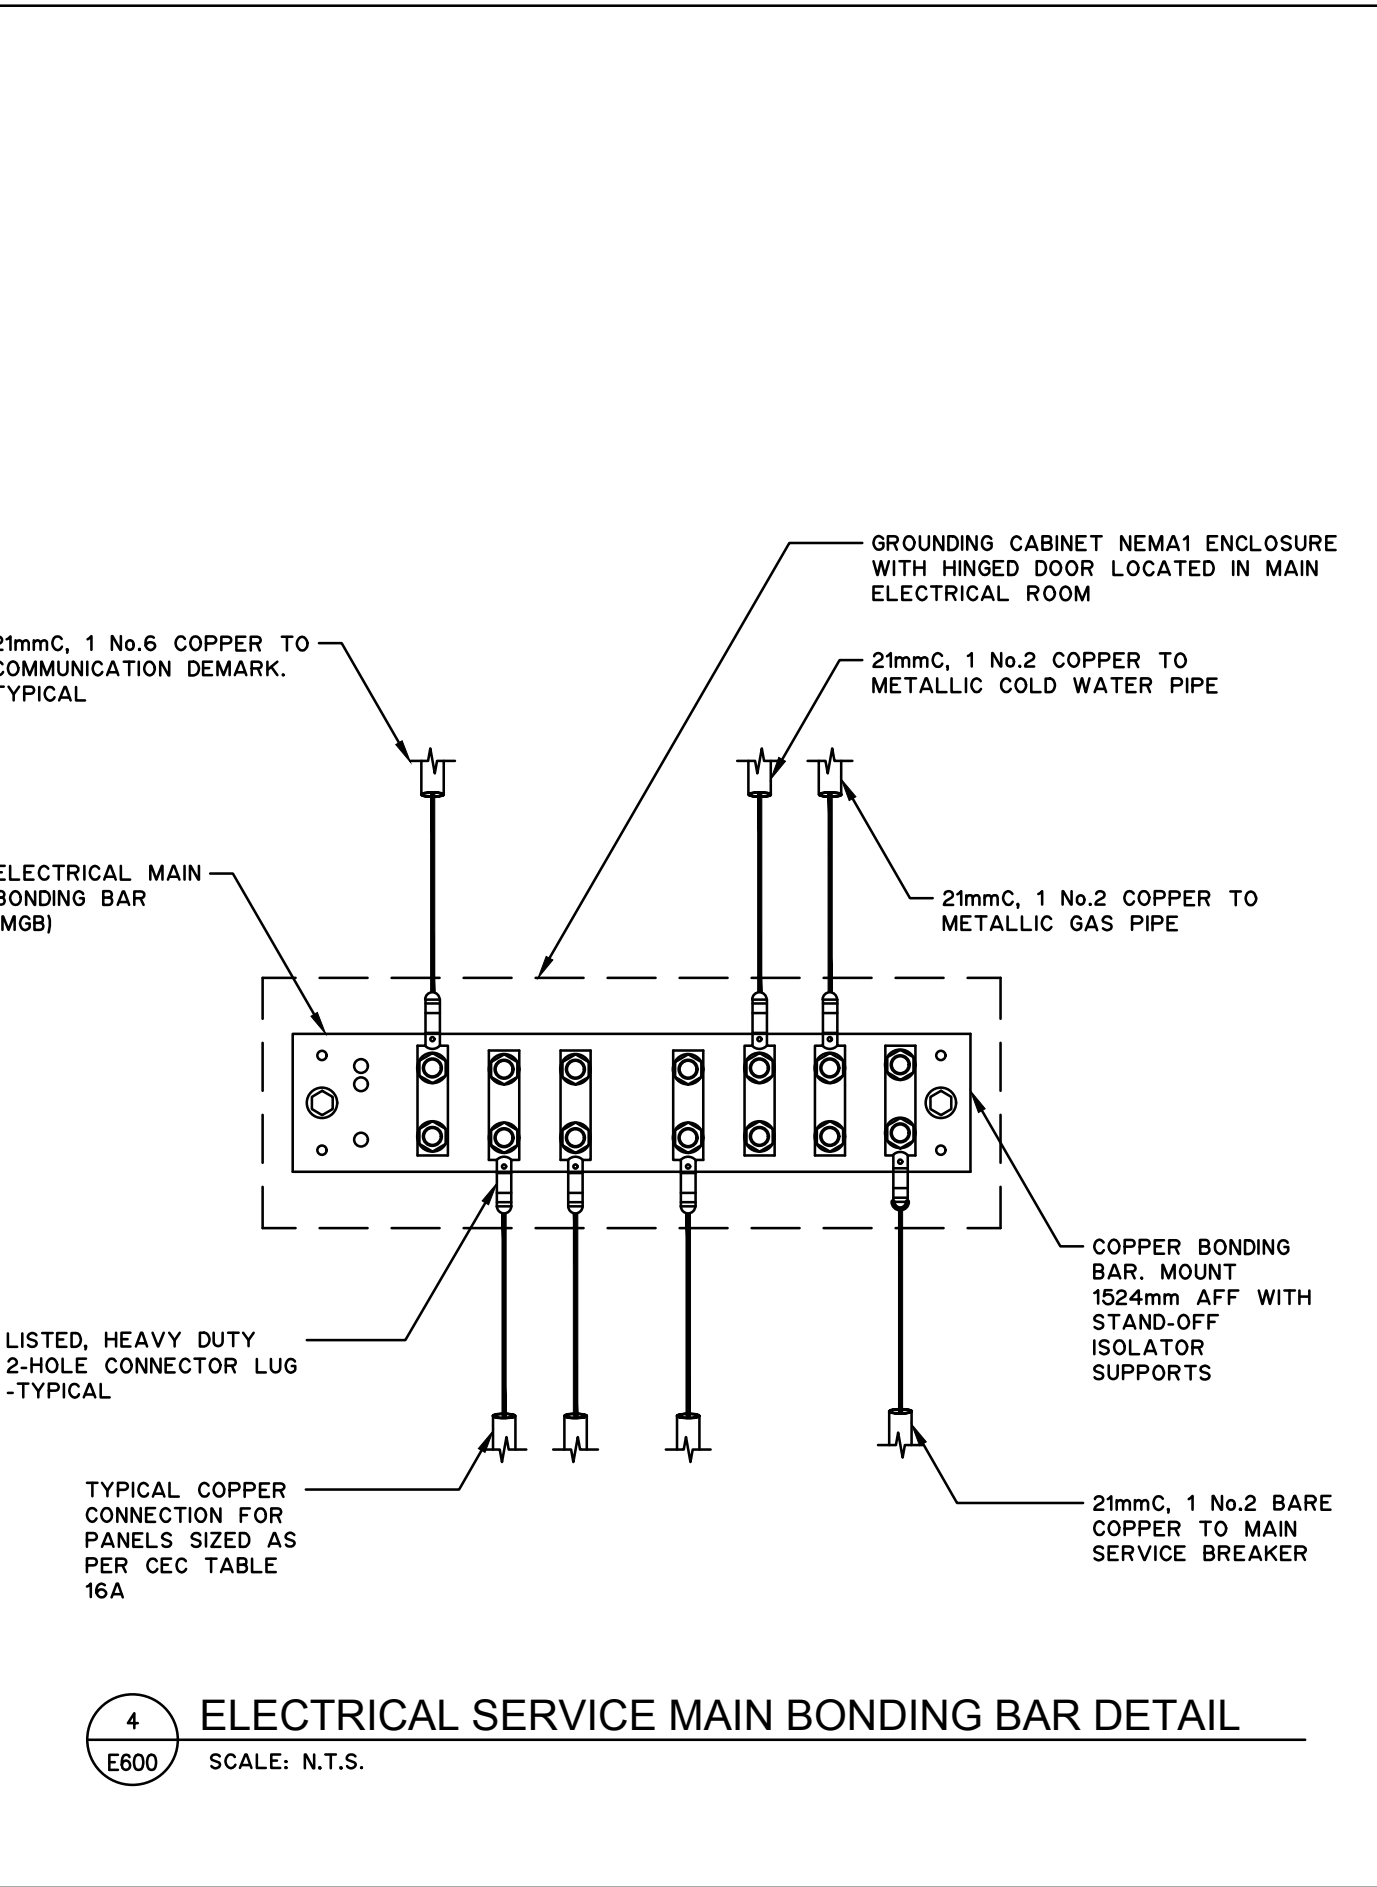
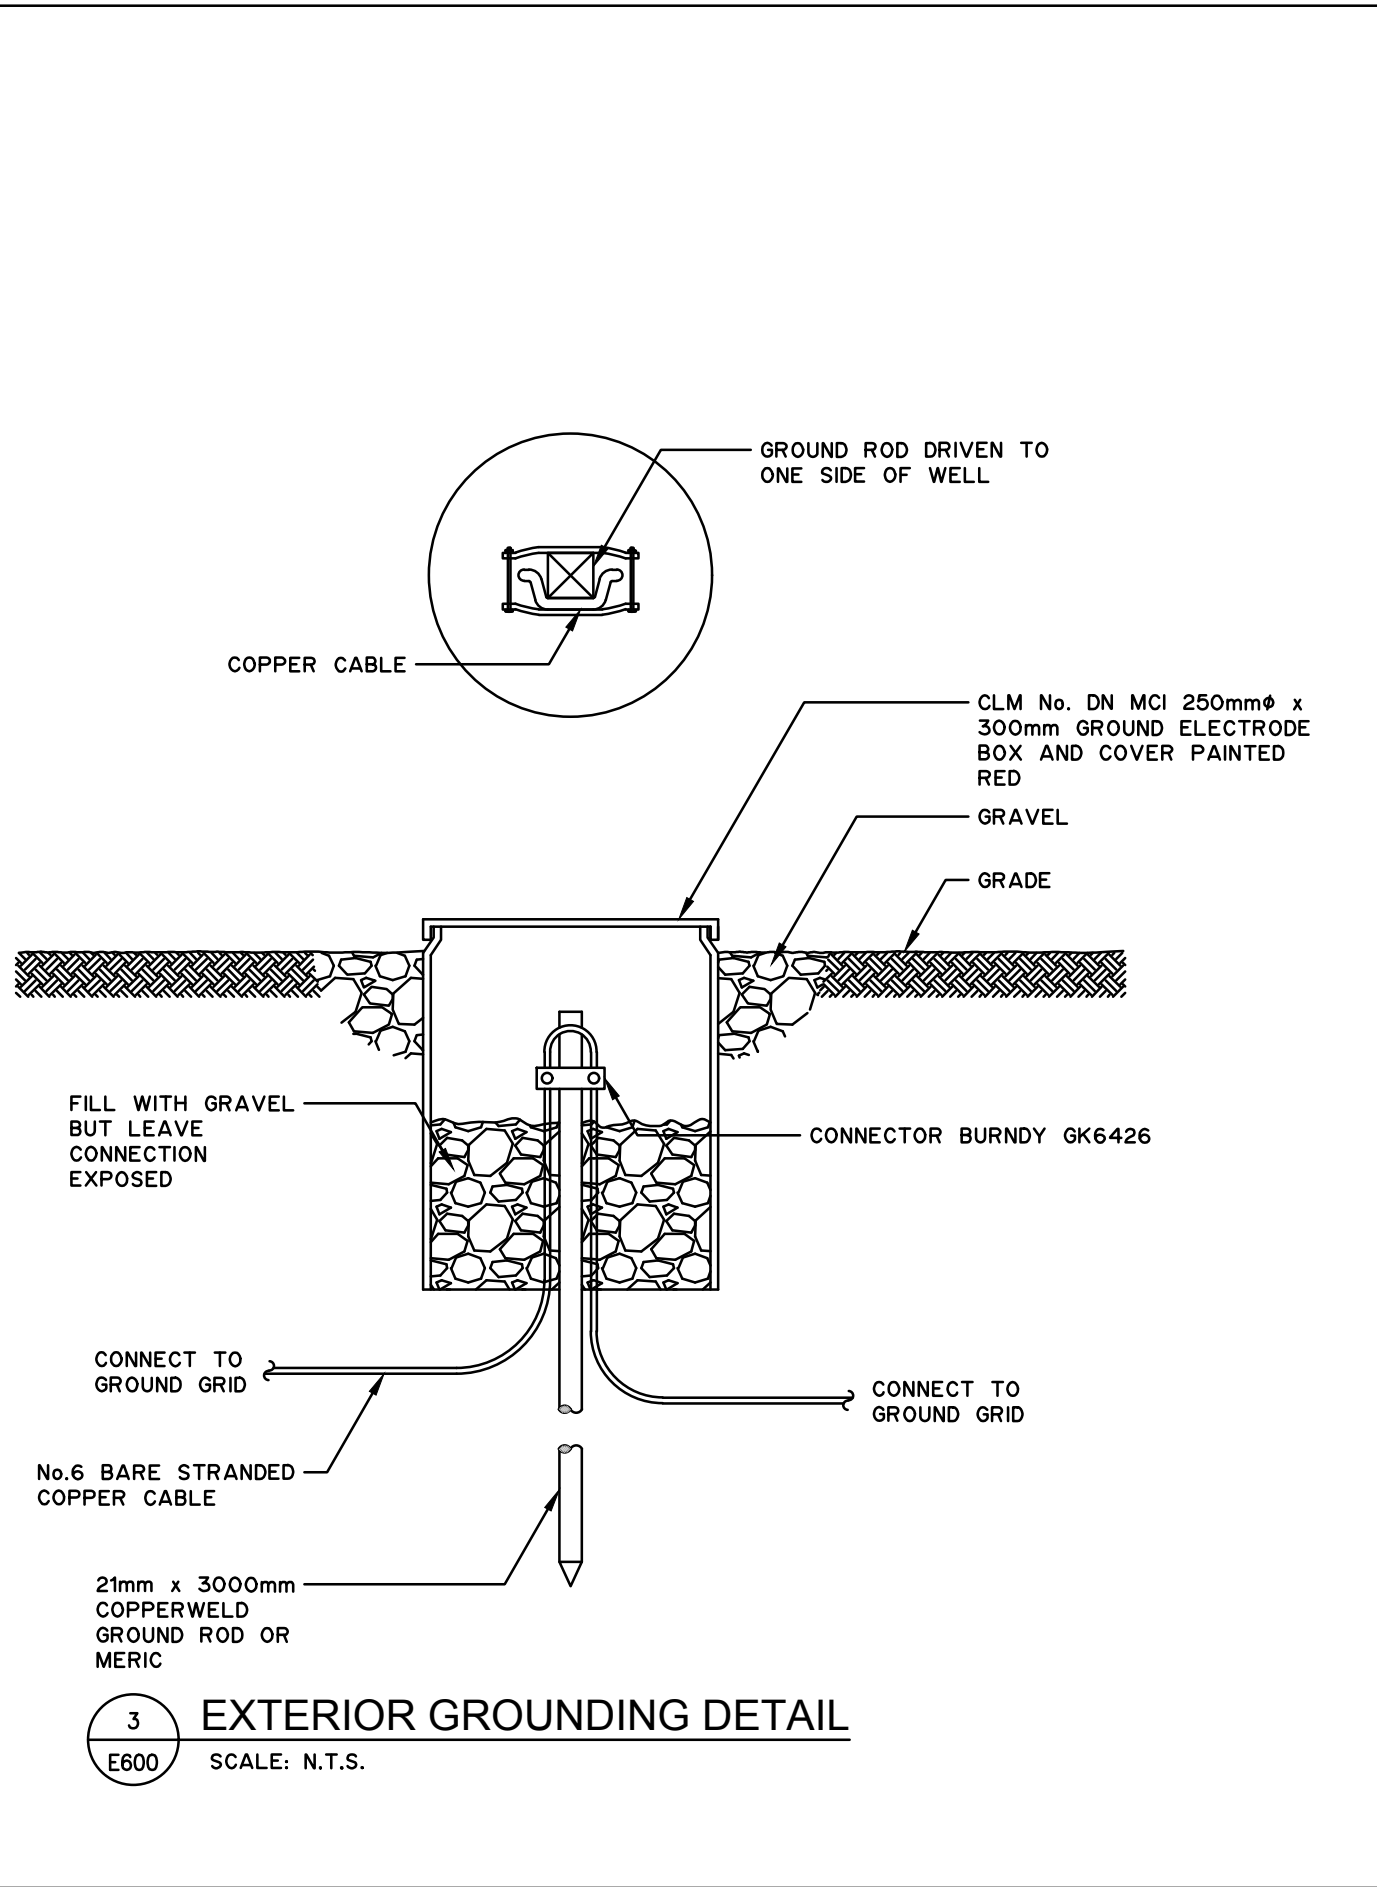
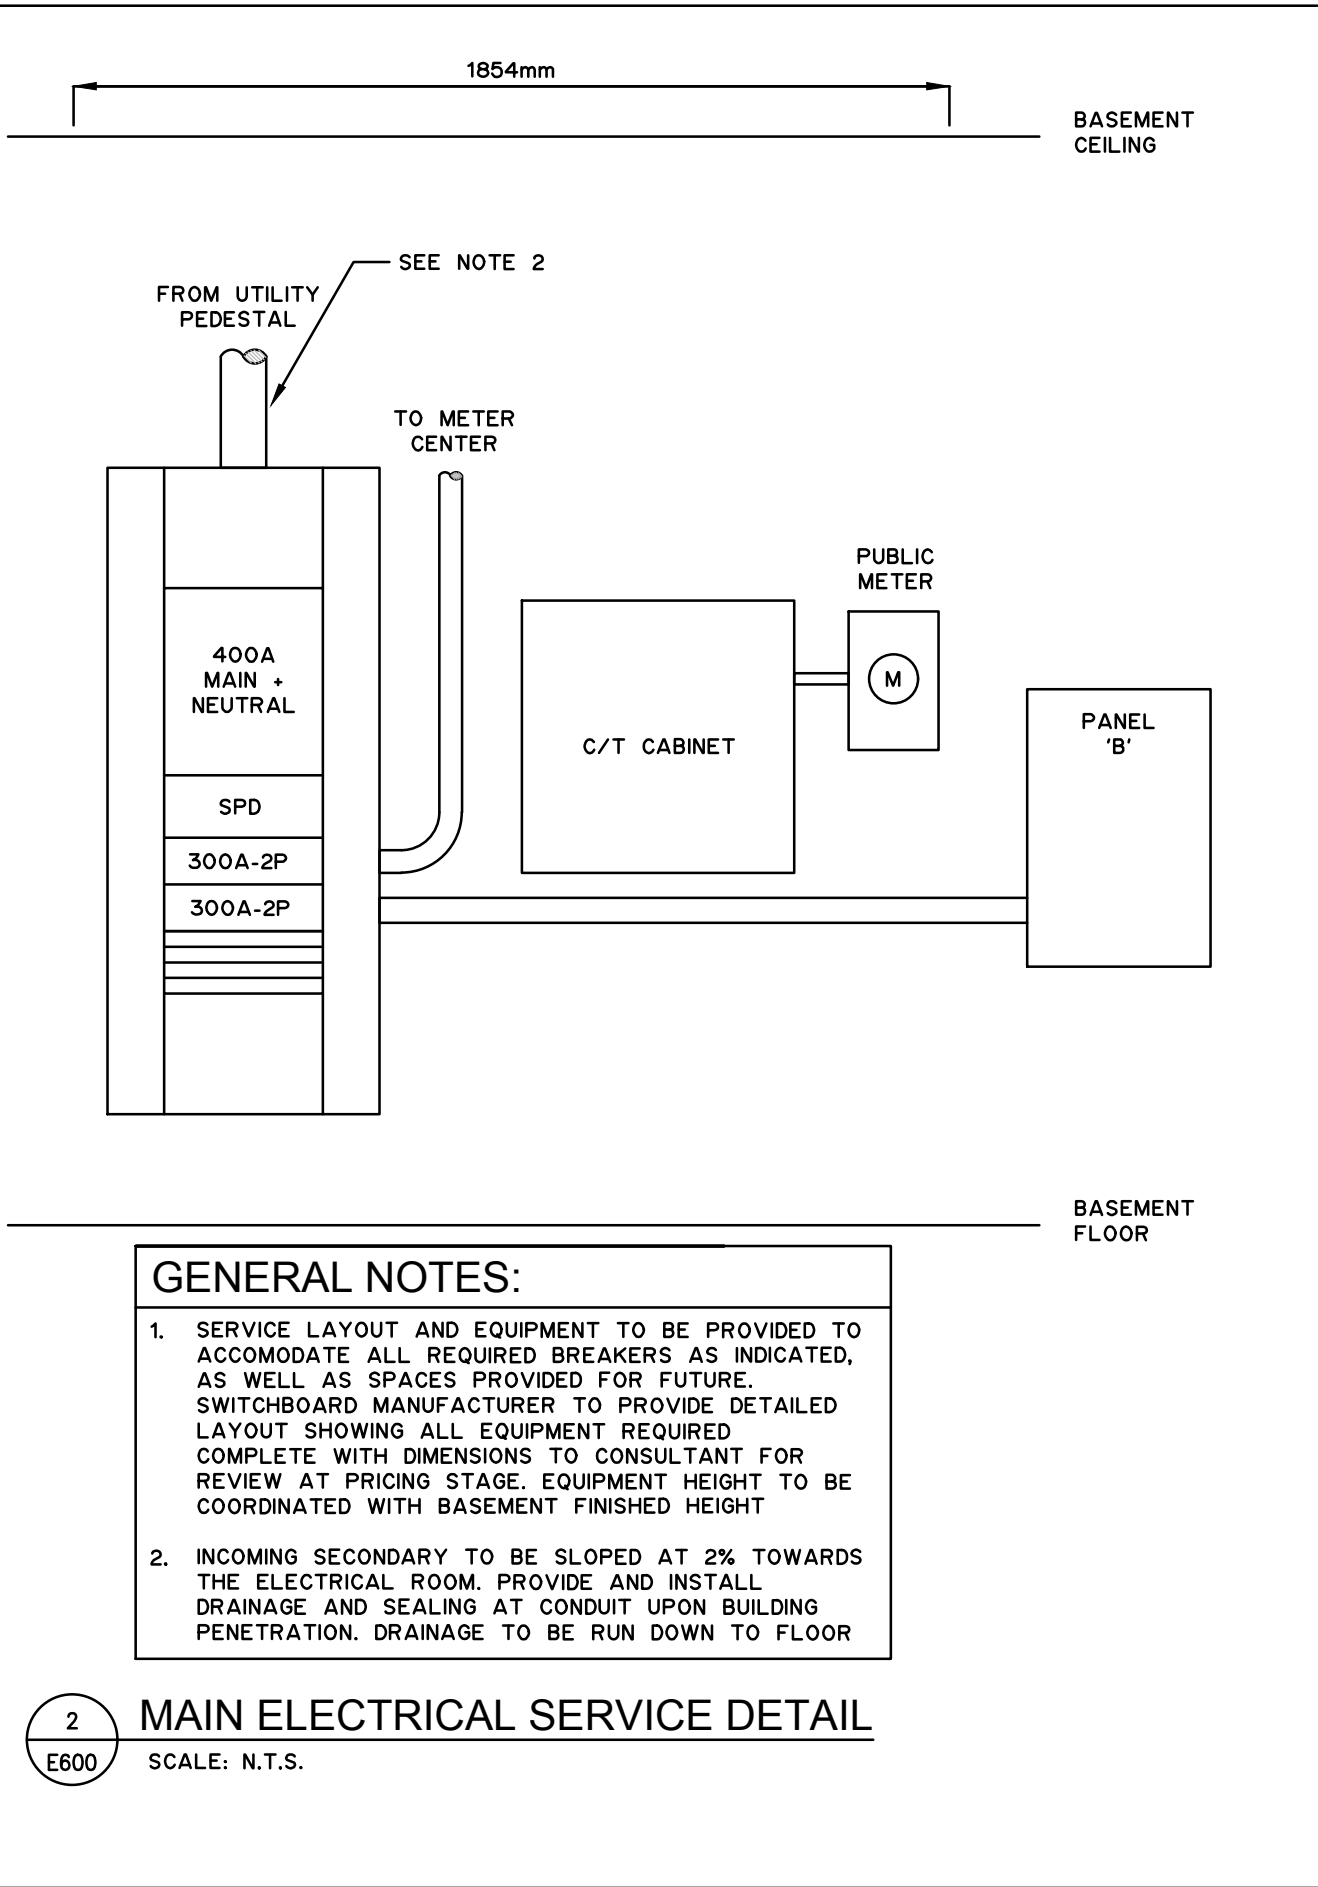
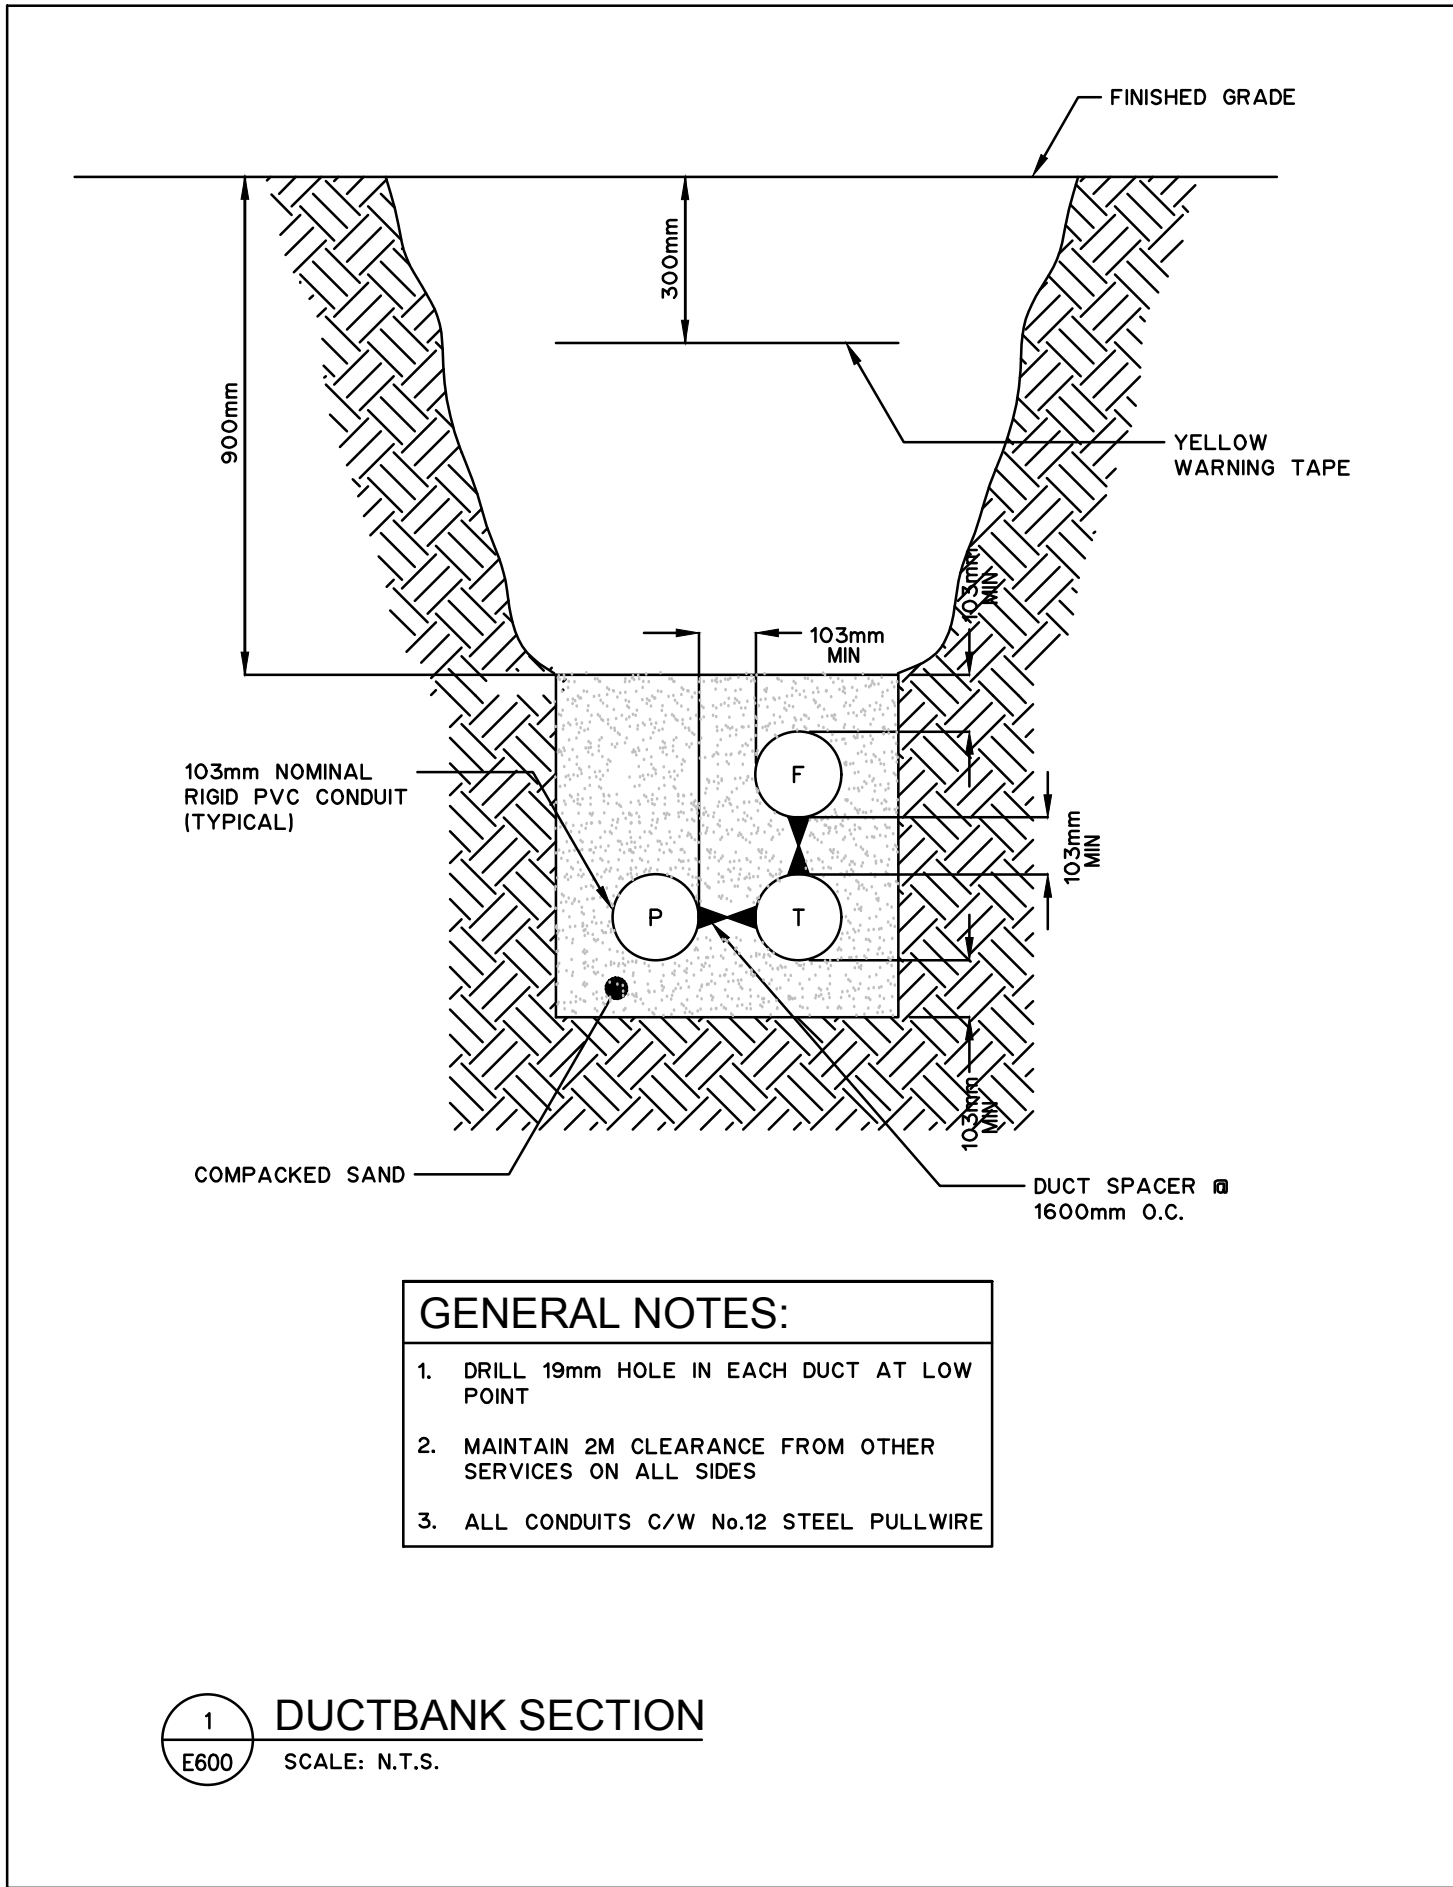
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No. de la feuille

	E500
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du dessin

E500



SITE INFORMATION

MUNICIPAL ADDRESS: WATERTON, WATERTON LAKES NATIONAL PARK
LEGAL LAND DESC.: LOTS 20 & 21 BLOCK 42

5	16-12-08	ISSUED FOR TENDER	LL.L.	K.O.K.
4	16-12-08	ISSUED FOR BP	LL.L.	K.O.K.
3	16-09-02	ISSUED FOR 99% REVIEW	LL.L.	J.M.T.
2	16-06-14	ISSUED FOR 66% REVIEW	LL.L.	J.M.T.
1	16-05-05	ISSUED FOR 33% REVIEW	LL.L.	J.M.T.

No.	Date/Date	Description/Description	Drawn by dessiné par	Approved Approuvé
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Revision / Revision	
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Consultant's Name
Nom de l'expert-conseil

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Western and
Northern Region

Ouest et Nord
du Canada

Project title/Titre du projet

Staff Housing Phase 2
Waterton Lakes National
Park

Drawing title/Titre du dessin

ELECTRICAL DETAILS

Surveyed by/Arpente par	Drawn by/Dessine par	Date/Date
L.L.L.	L.L.L.	2016-04-21

Designed by/Concept par	Reviewed by/Revisé par	Scale/Echelle
J.M.T.	K.O.K.	AS INDICATED

PWGSC Project Manager/Administrateur de Projets TPSCC

Client Acceptance/Acceptation du client

Approved by/Approve par

Per Responsible Officer/Agel Responsable

Project No./No. du projet

Asset No./No. du bien

Sheet No./
No. de la feuille

Drawing Reference No./No. de reference du dessin


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PERMIT NUMBER: P 3680
The Association of Professional Engineers,
Geologists and Geophysicists of Alberta

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LEGEND

PROPERTY LINE

EXISTING CONIFEROUS TREE TO REMAIN

EXISTING DECIDUOUS TREES TO REMAIN

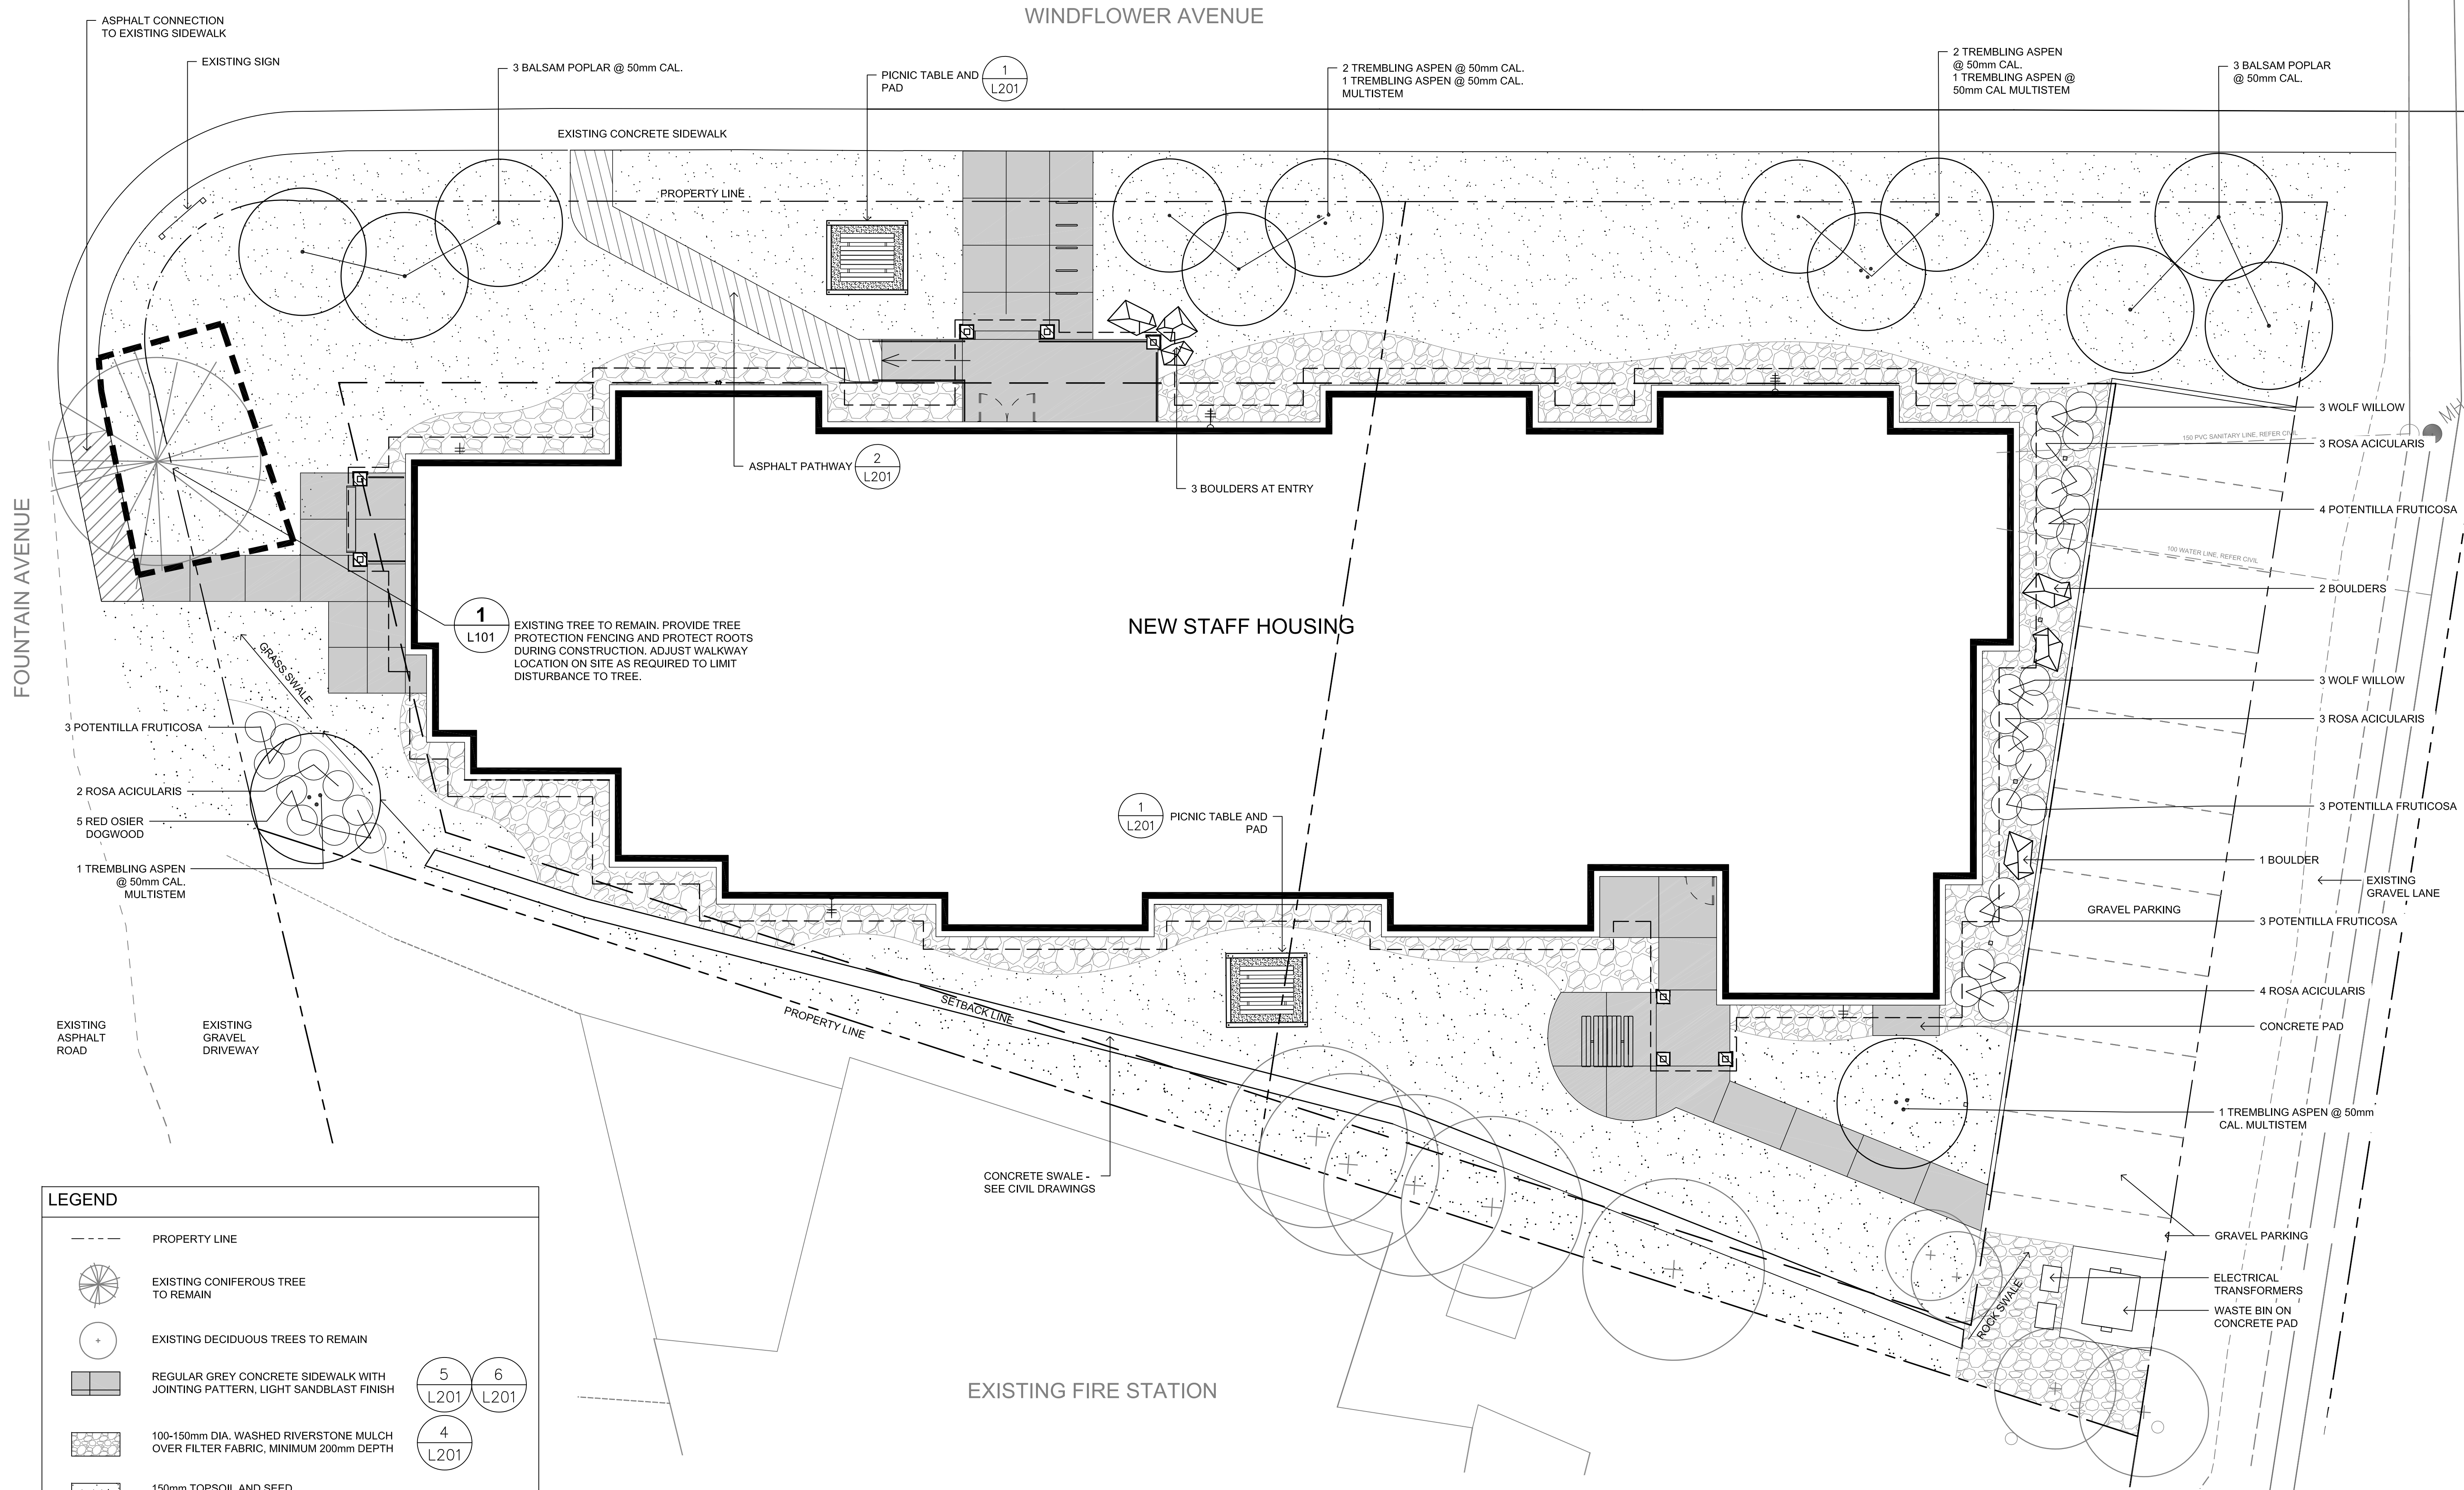REGULAR GREY CONCRETE SIDEWALK WITH JOINTING PATTERN, LIGHT SANDBLAST FINISH

100-150mm DIA. WASHED RIVERSTONE MULCH OVER FILTER FABRIC, MINIMUM 200mm DEPTH

150mm TOPSOIL AND SEED
LOW MAINTENANCE NATURAL SEED MIX:
30% CANADA BLUE GRASS
30% HARD FESCUE
30% ALPINE BLUE GRASS
10% MANHATTAN III PERENNIAL RYEGRASS (NURSE CROP)

POA COMPRESSA
FESTUCA LONGIFOLIA
POA AMPLA
LOLIUM PERENNE

DECIDUOUS TREES

SHRUB PLANTING, 600mm DEPTH SOIL MIX PLANTING BED, 75mm DEPTH WOOD CHIP MULCH WHERE NOT IN RIVERSTONE MULCH

BOULDERS, MINIMUM 1000 x 750 x 450mm HT. QTY: 6

PICNIC TABLE QTY: 2

BICYCLE RACKS QTY: 5

NOTE: ALL TREE AND SHRUB PLANTINGS TO BE ENCLOSED WITH TEMPORARY FENCING TO PREVENT DEER BROWING UNTIL PLANT ESTABLISHMENT. SEE CIVIL DRAWINGS FOR SWALE DETAILS

5 L201

6 L201

4 L201

1 L201

3 L201

PHASE 2 PLANTING SCHEDULE

QTY.	BOTANICAL NAME	COMMON NAME	SIZE	CONDITION
DECIDUOUS TREES				
6	POPULUS BALSAMIFERA	BALSAM POPLAR	50mm CAL.	B&B
4	POPULUS TREMULOIDES	TREMBLING ASPEN	50mm CAL.	B&B
4	POPULUS TREMULOIDES	TREMBLING ASPEN	50mm CAL.	B&B, MULTI-STEM, 3 STEM MIN.
DECIDUOUS SHRUBS				
5	CORNUS SERICEA	RED OSIER DOGWOOD	400mm HT.	#2 CONT.
6	ELAEAGNUS COMMUTATA	WOLF WILLOW	400mm HT.	#2 CONT.
13	POTENTILLA FRUTICOSA	POTENTILLA (NO CULTIVARS)	400mm HT.	#2 CONT.
12	ROSA ACICULARIS	COMMON ROSE	400mm HT.	#2 CONT.

TREE CALCULATIONS

TOTAL EXISTING TREES ON SITE	19
TREES TO BE REMOVED	13
REQUIRED REPLACEMENT TREES (3:1)	39
PROPOSED TREES	14
TREES TO BE SUPPLIED BY CONTRACTOR FOR PLANTING BY PCA ELSEWHERE IN THE PARK	25

1 L101

TREE PROTECTION FENCING

SCALE 1:40

1650mm

80mm

TREE OR OTHER VEGETATION TO BE RETAINED

DRIP LINE

METAL T-BAR FOR PROTECTIVE FENCING - SPACE AT 2400mm O.C. AND AT CORNERS

WIRE MESH ATTACHED TO METAL T-BAR W/ CABLE TIES AT 250mm O.C. - MIN. 1650mm HEIGHT

0 5 10 Meters

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4 2016-12-08 ISSUED FOR BUILDING PERMIT MD BB

3 2016-09-02 ISSUED FOR 99% MD BB

2 2016-06-14 ISSUED FOR 86% MD BB

1 2016-05-05 ISSUED FOR 33% TY BB

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C detail on drawing no. detail sur dessin no.

Consultant's Name Nom de l'expert-conseil

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Canada

Client/client Parks Canada Agency

L'Agence Parcs Canada

Western and Northern Region

Ouest et Nord du Canada

Project title/Titre du projet

Staff Housing Phase 2 Waterton Lakes National Park

Drawing title/Titre du dessin

LANDSCAPE PLAN

Surveyed by/Arpenté par MD

Designed by/Concept par BB

Drawn by/Dessiné par MD

Reviewed by/Revisé par BB

Date/Date 2016-12-08

Scale/Echelle 1:100

PWOSC Project Manager/Administrateur de Projets TPSCG

Randy Boldt

Client Acceptance/Acceptation du client

Approved by/Approuvé par

Park Responsible Officer/Agent Responsable

PWOSC Project Manager/Administrateur de Projets TPSCG



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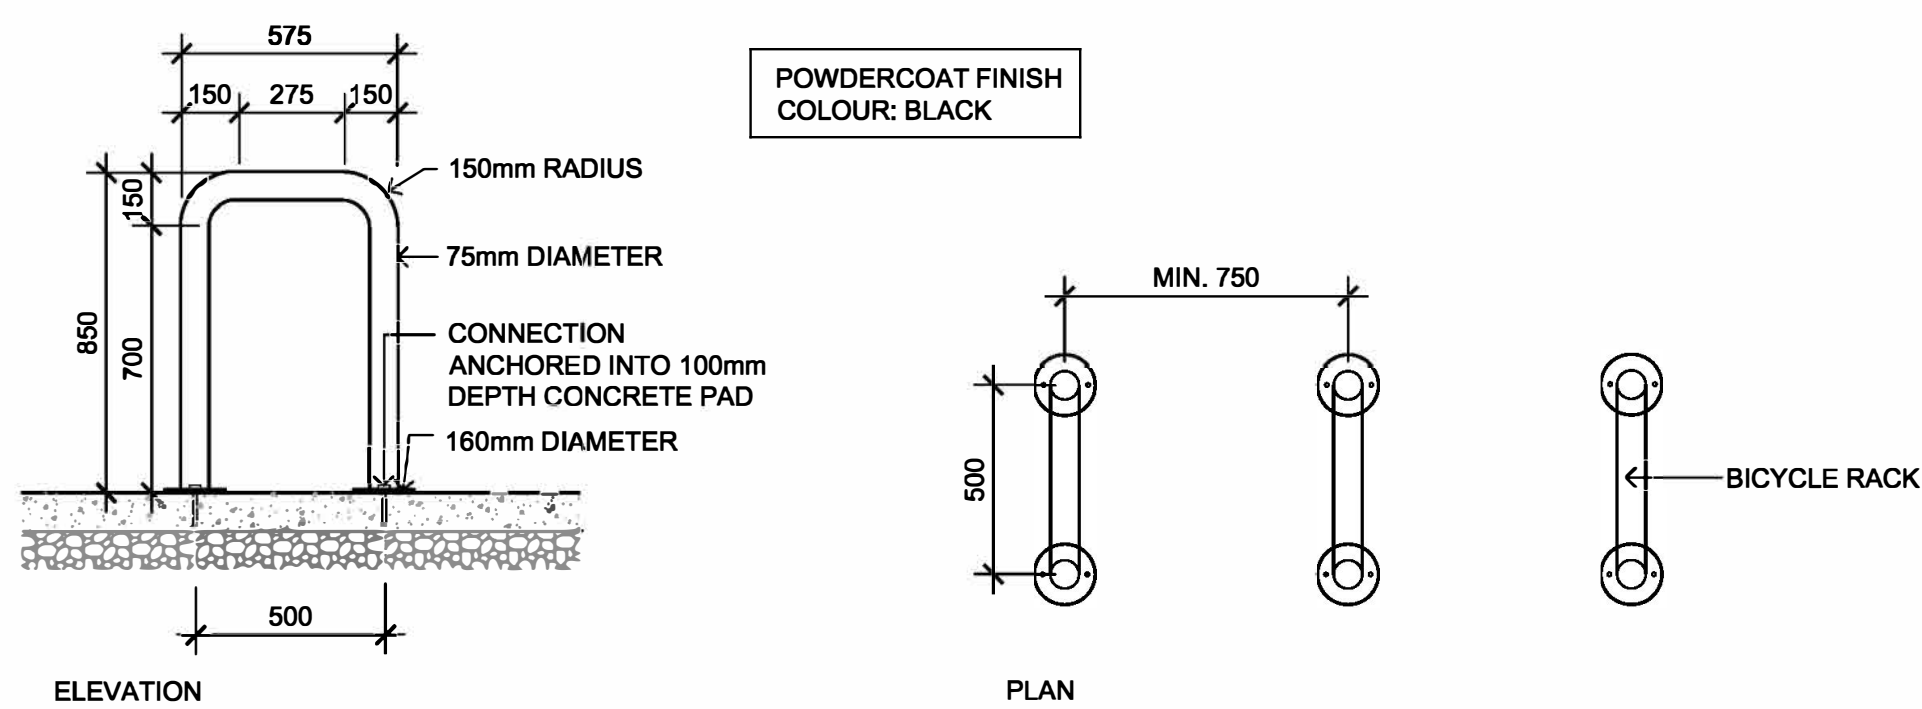
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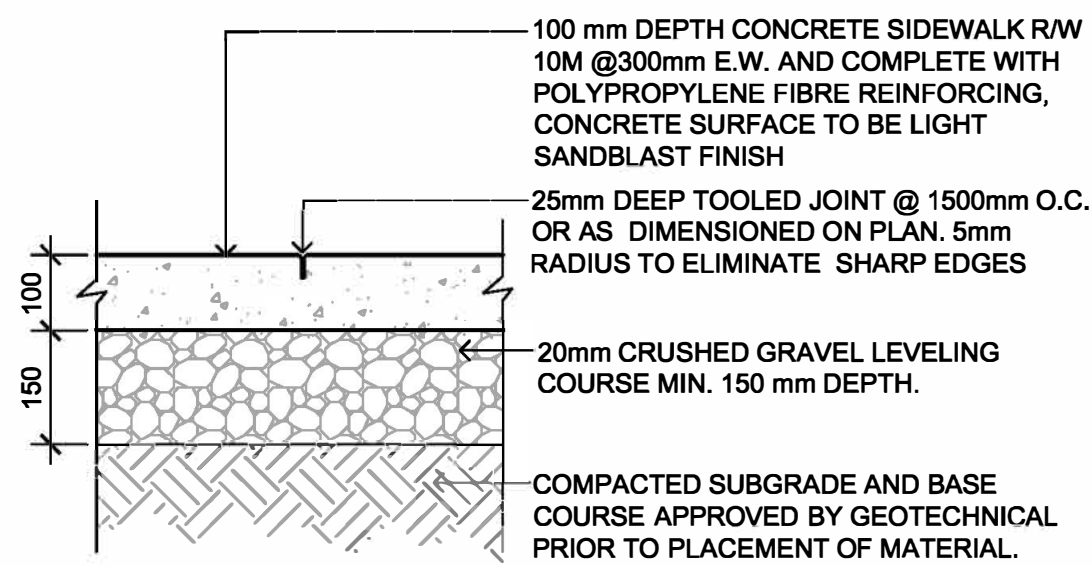
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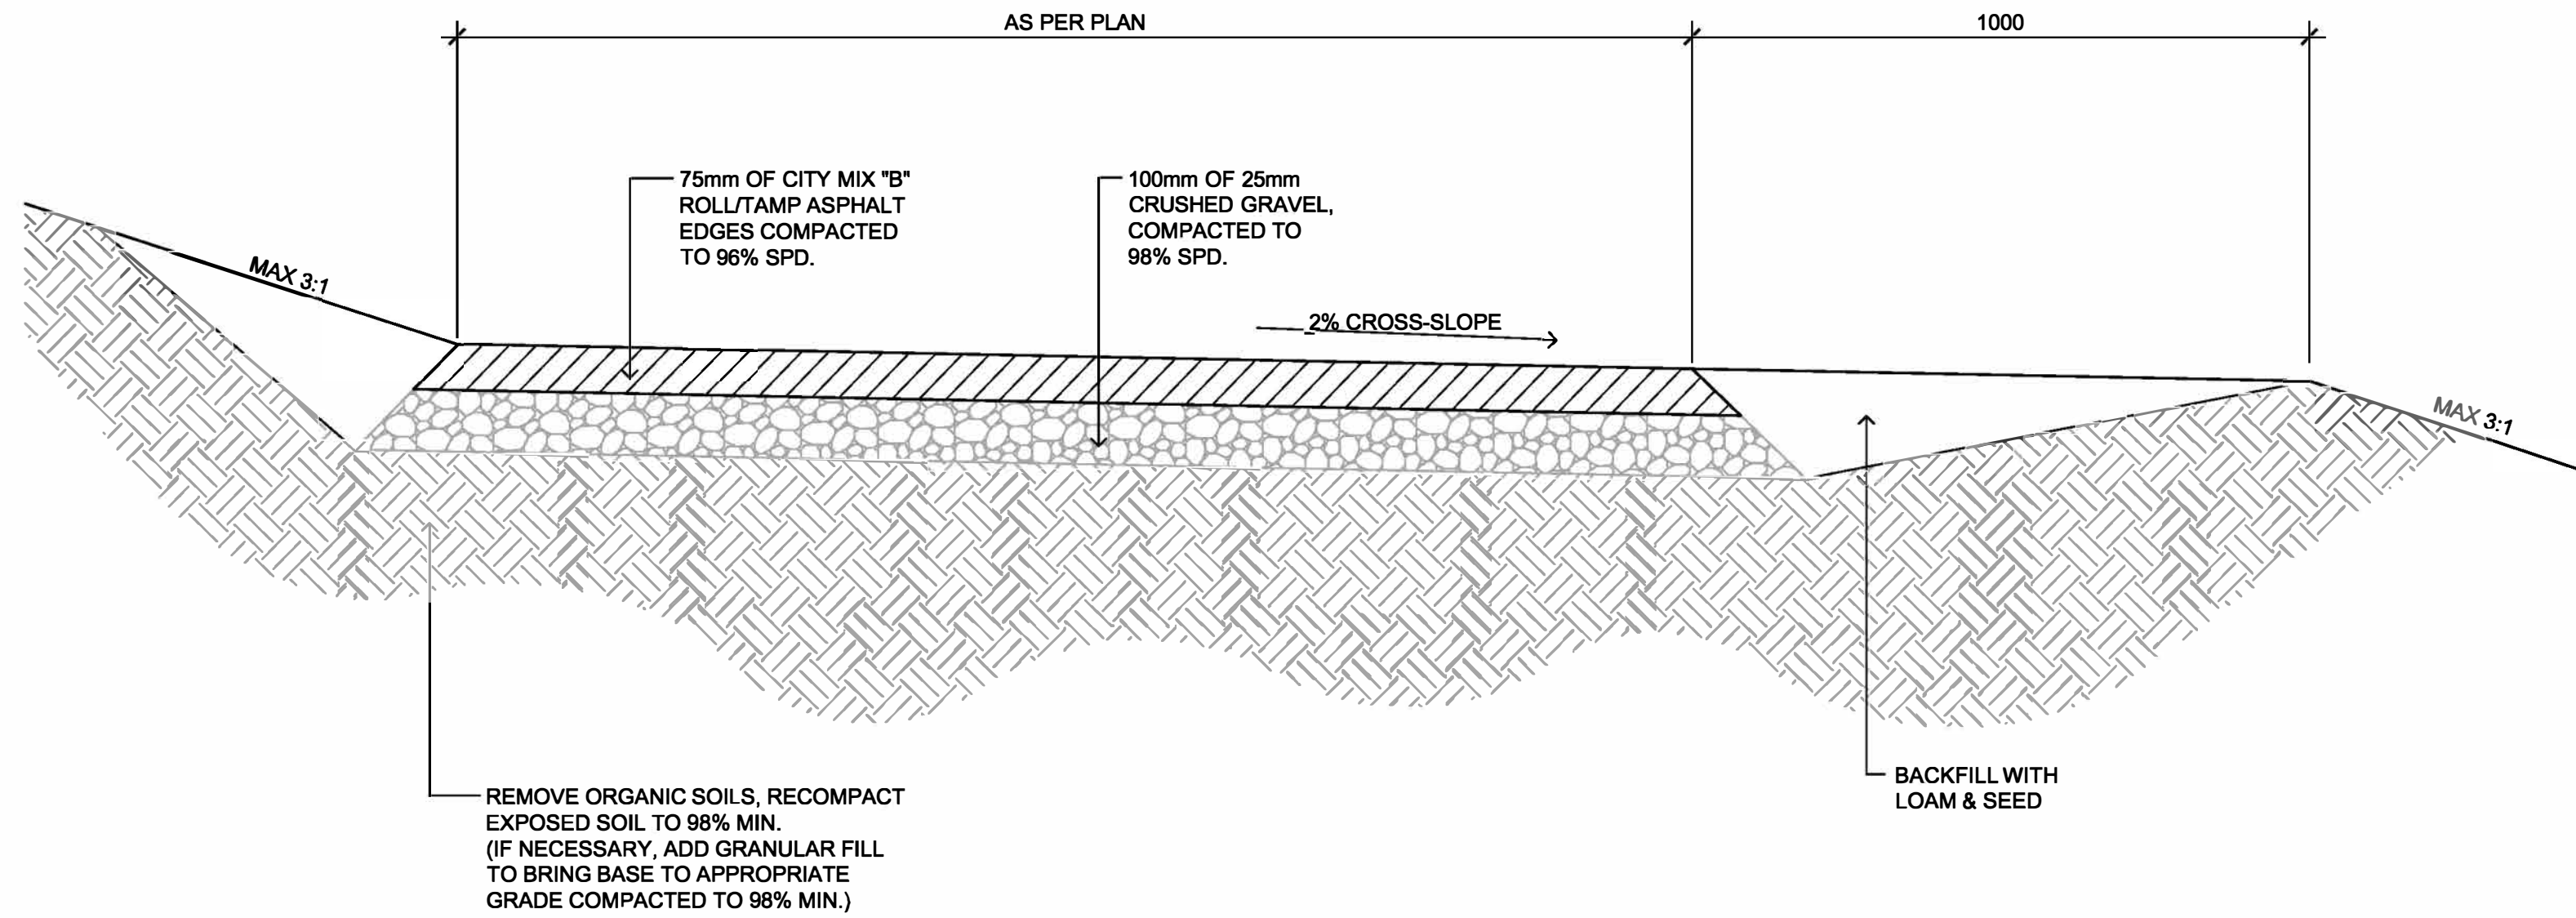
1 PICNIC TABLE ON GRAVEL PAD
SCALE 1: 20




3 BICYCLE RACK
SCALE 1: 20




5 CONCRETE SIDEWALK – CONTROL JOINT
SCALE 1: 10

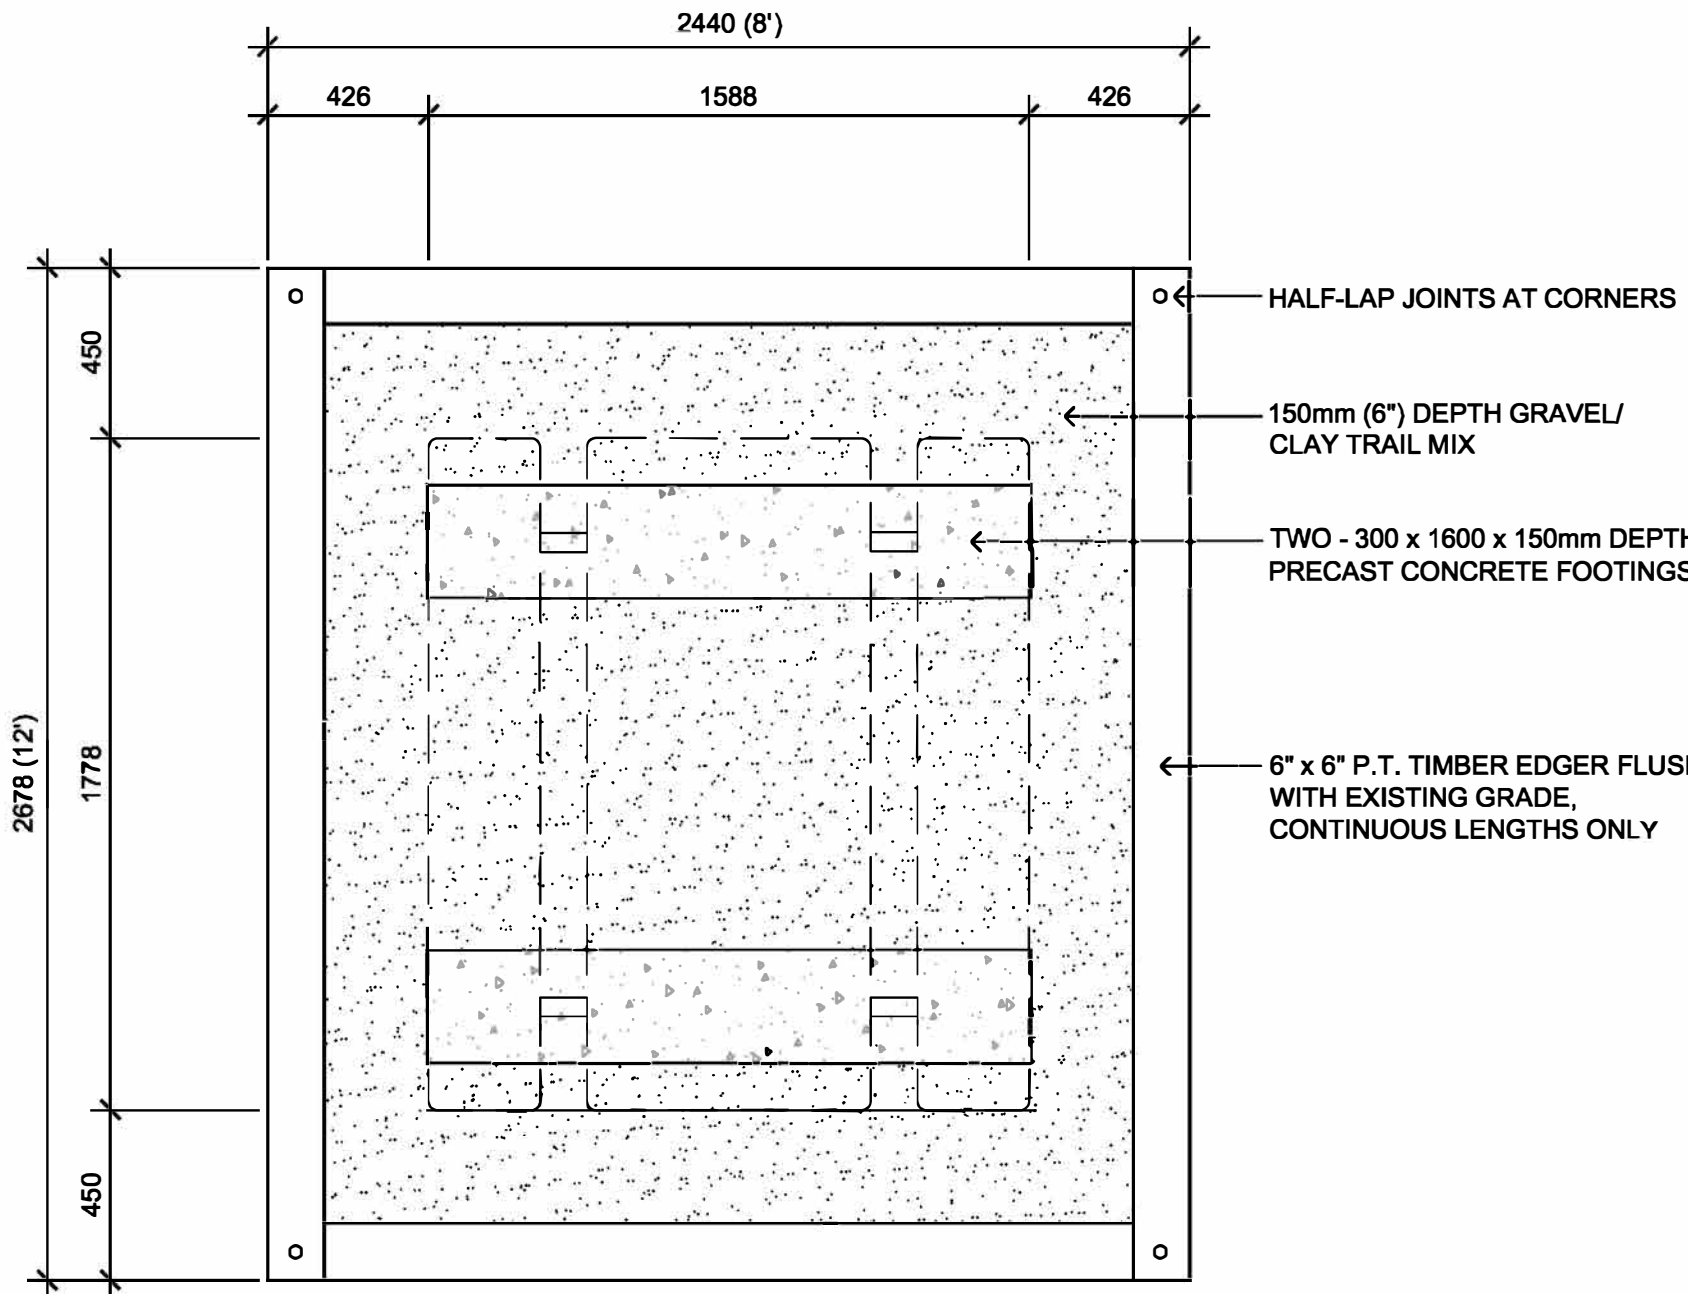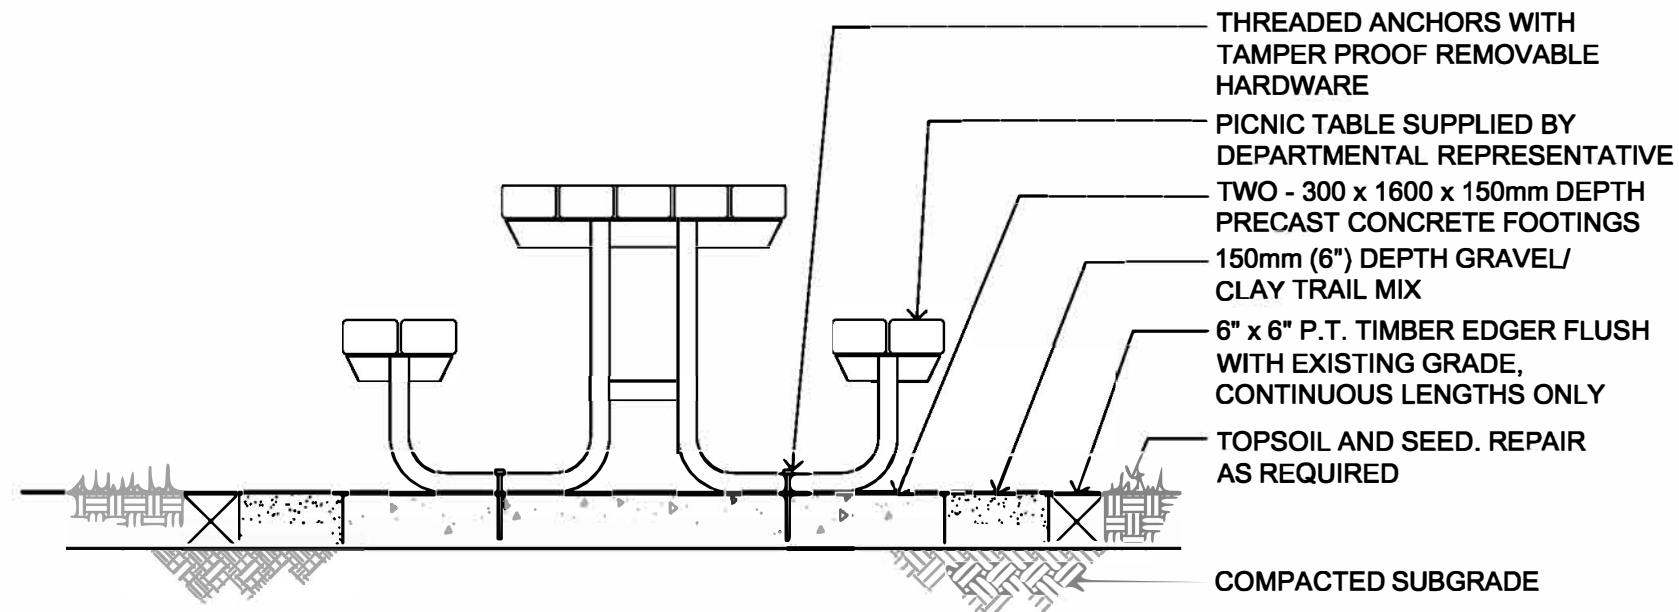

2 ASPHALT PATH
SCALE 1: 10

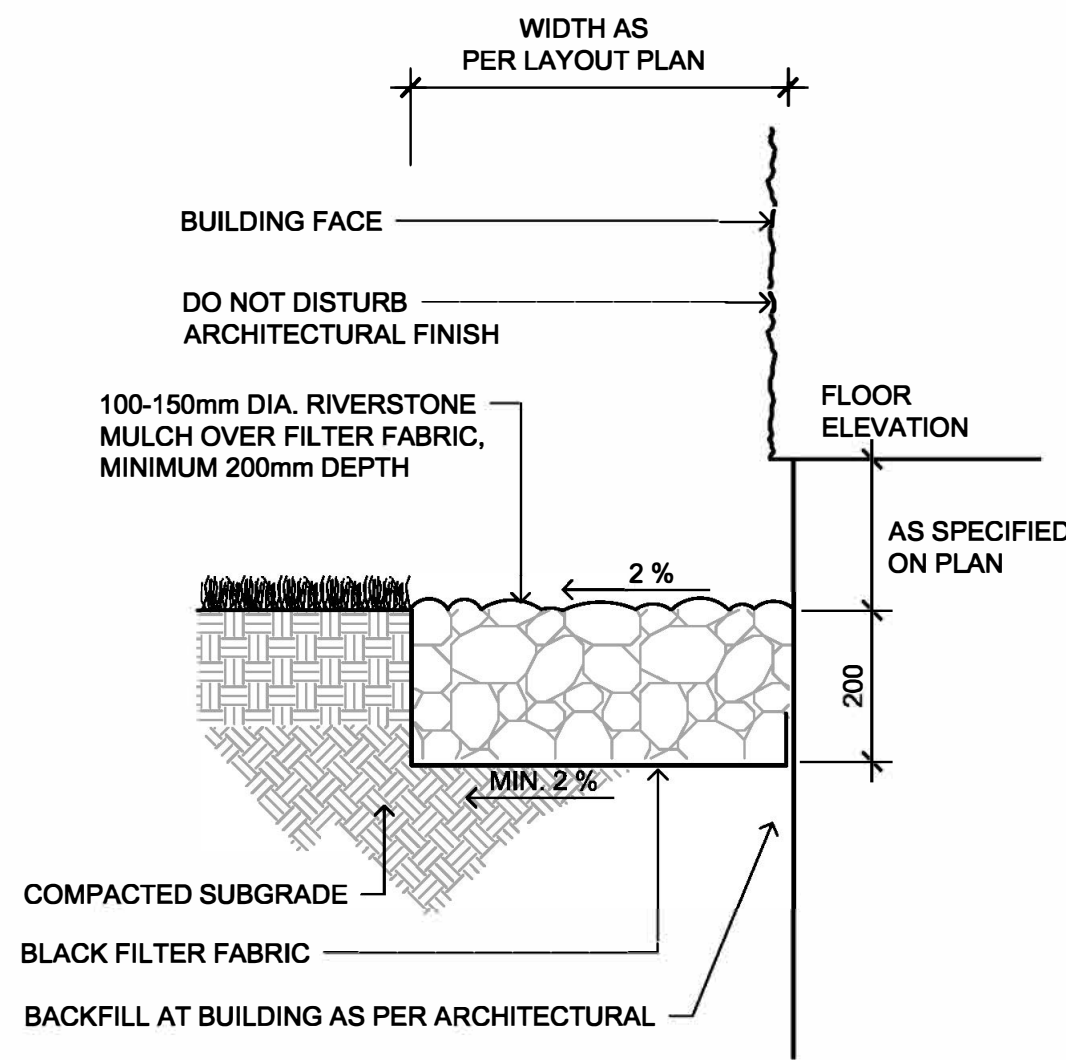

4 GRAVEL MAINTENANCE PLINTH
SCALE 1: 10

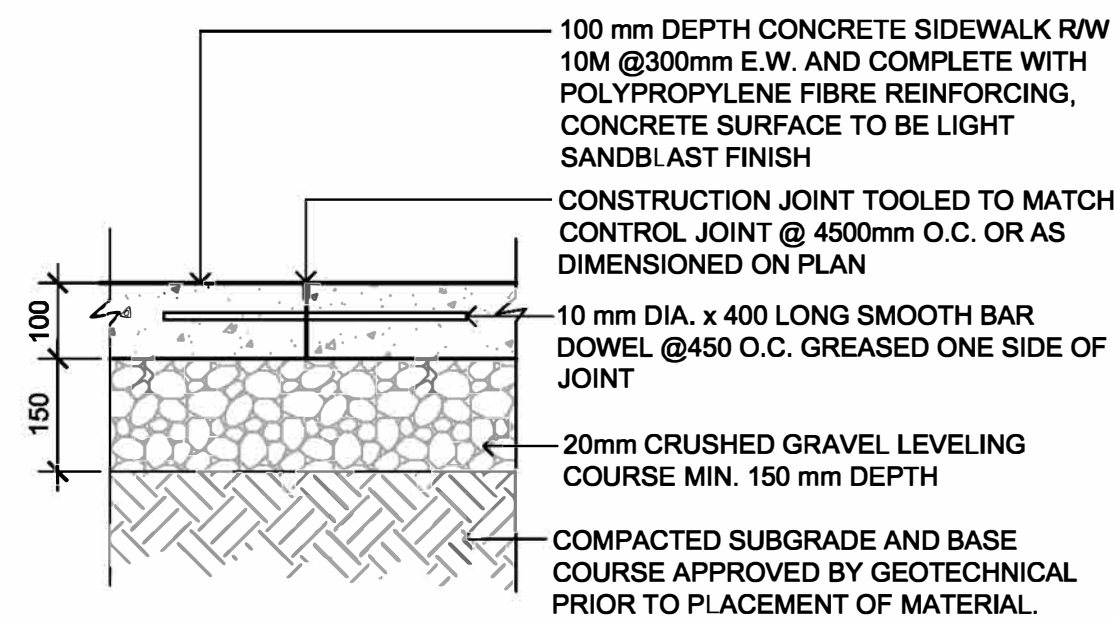

6 CONCRETE SIDEWALK – CONSTRUCTION JOINT
SCALE 1: 10

Key Plan



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3	2016-09-02	ISSUED FOR 96%	MD	BB
2	2016-06-14	ISSUED FOR 86%	MD	BB
1	2016-05-05	ISSUED FOR 33%	TY	BB

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Sean Baker

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Staff Housing Phase 2 Waterton Lakes National Park

Drawing Title/Titre du dessin

LANDSCAPE DETAILS

Surveyed by/Arpenté par	Drawn by/Dessiné par	Date/Date
BB	MD	2016-12-08
Designed by/Concept par	Reviewed by/Revisé par	Scale/Echelle
BB	BB	AS NOTED

PWGCSC Project Manager/Administrateur de Projets TPSCG

Client Acceptance/Acceptation du client	Approved by/Approuvé par
	Randy Boldt

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39000	FII # 945	
Drawing Reference No./No. de reference du dessin		L201