




SECTION 1
SCALE: N.T.S.

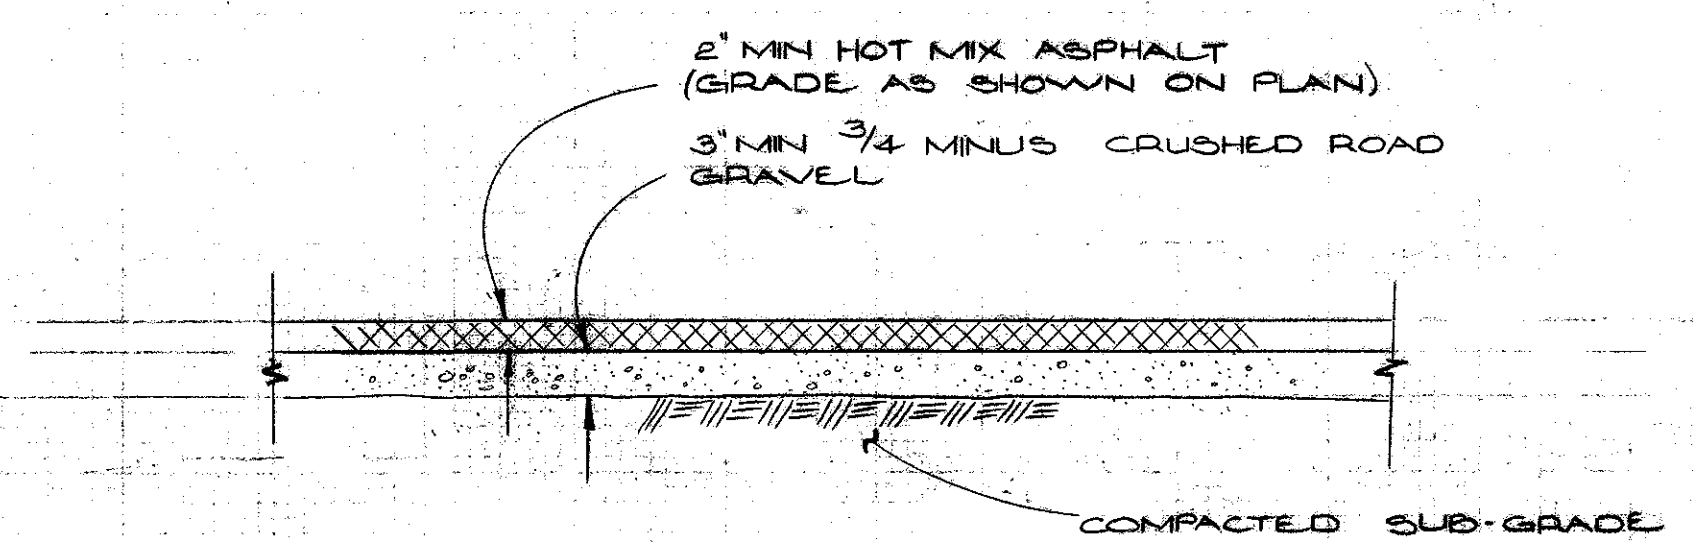

TYPICAL PAVEMENT SECTION
SCALE: N.T.S.

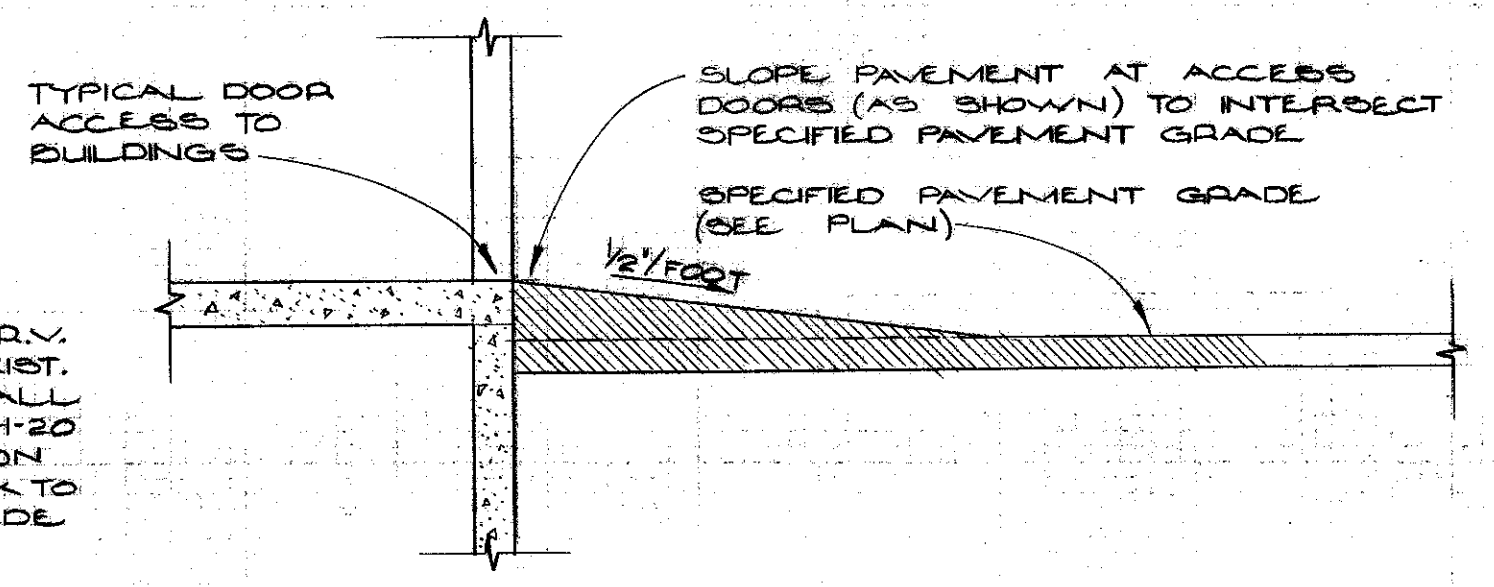

TYPICAL PAVED APRON AT ACCESS DOORS
SCALE: N.T.S.

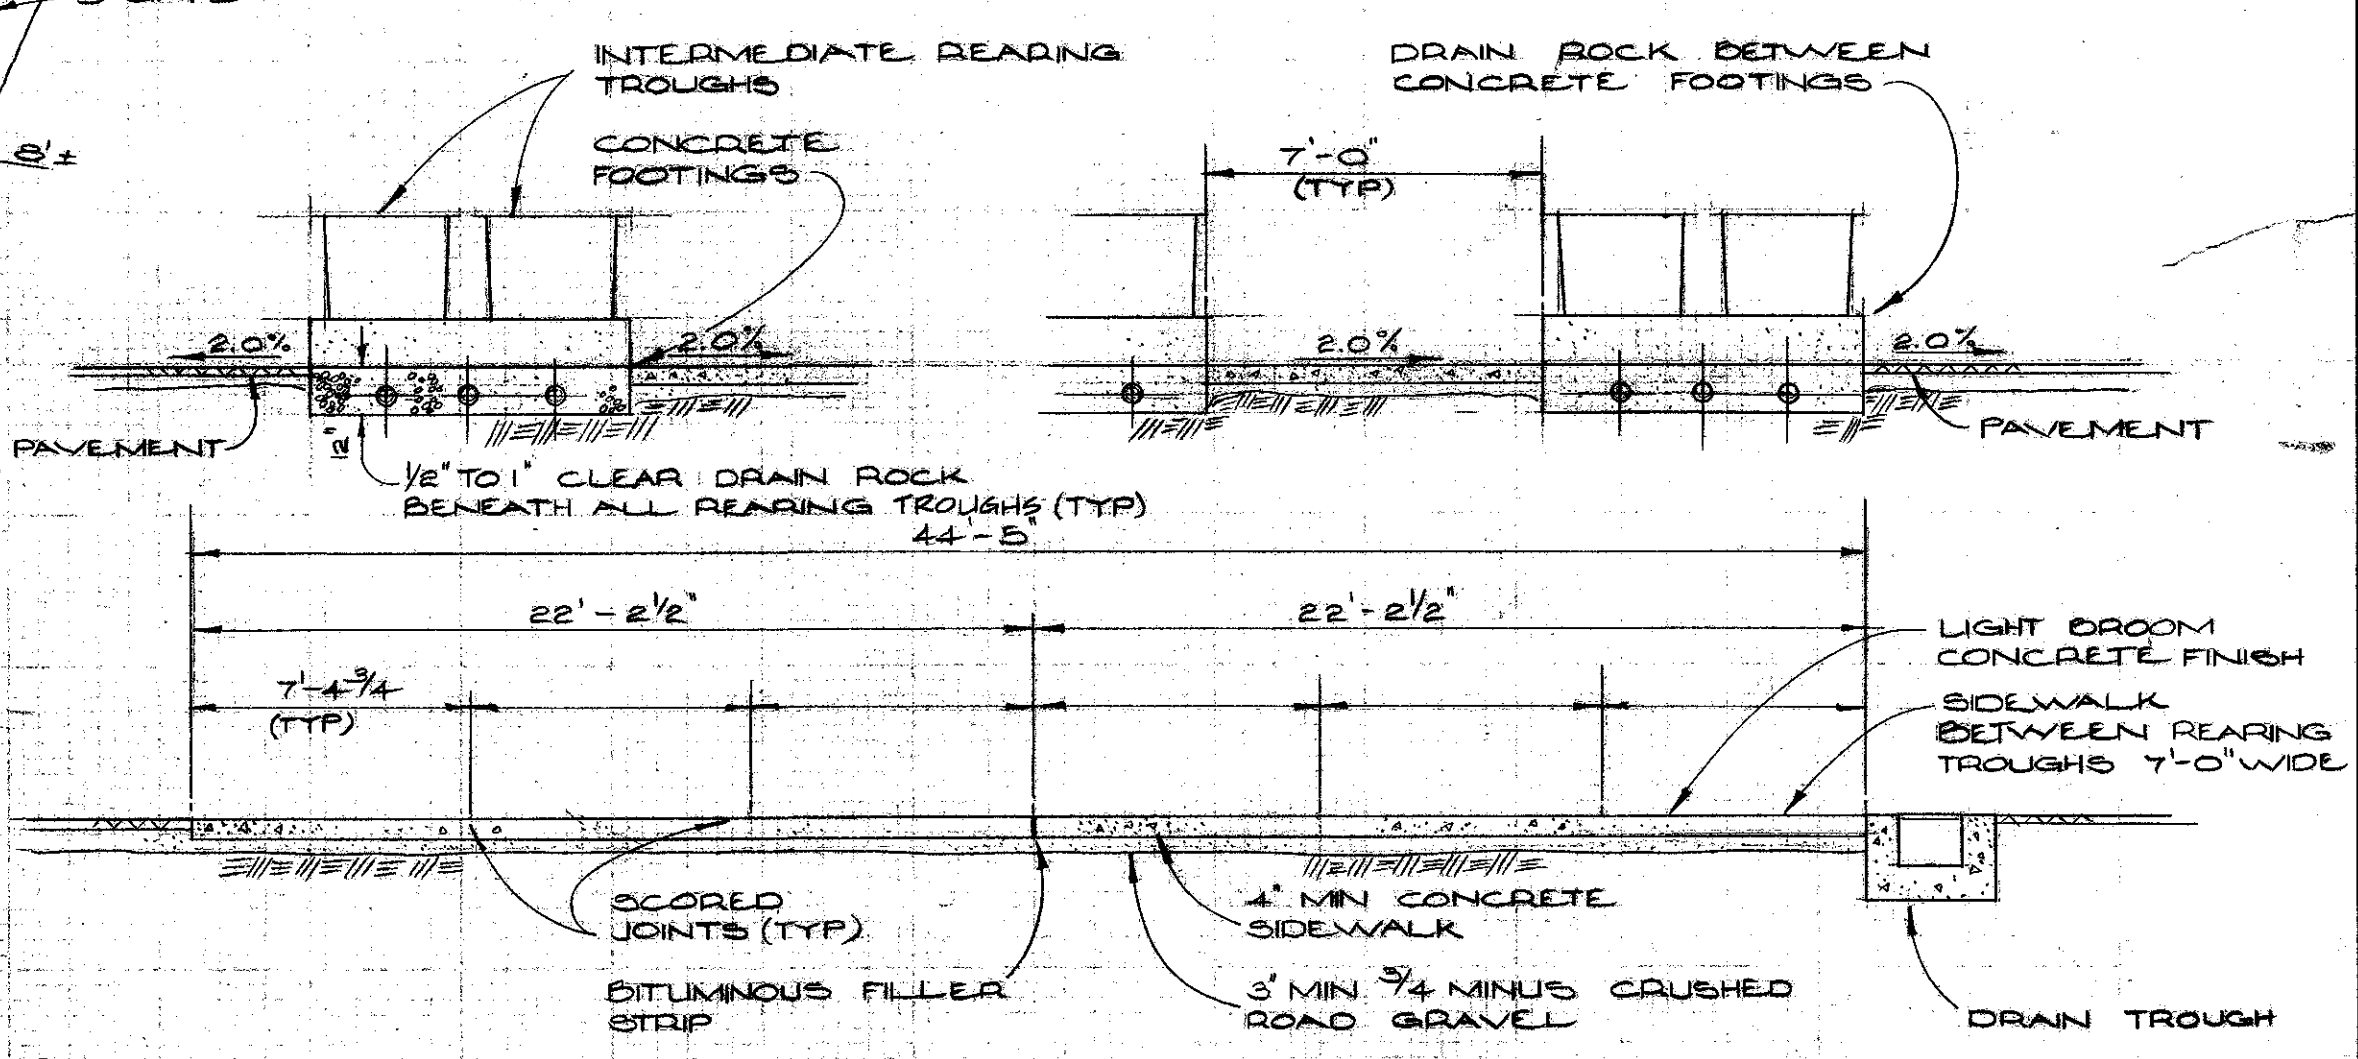


INTERMEDIATE REARING TROUGH
SIDEWALK DETAILS
SCALE: N.T.S.

- NOTES**
- 1 WITH THE EXCEPTION OF THE AREA IMMEDIATELY ADJACENT TO THE VEHICLE STORAGE BUILDING, THE HATCHERY SITE HAS BEEN GRADED TO APPROXIMATE ELEVATION 73.50
 - 2 EXCAVATION WILL BE REQUIRED IN THE GENERAL VICINITY OF THE VEHICLE STORAGE BUILDING AS DETERMINED BY THE EXISTING CONTOURS AND THE SPECIFIED FINISHED PAVEMENT GRADES.
 - 3 PAVEMENT DESIGN GRADES DO NOT ALLOW FOR PAVEMENT ACCESS RAMPS AT DOOR OPENINGS. SEE DETAIL THIS SHEET.
 - 4 GRADE PAVEMENT UNIFORMLY BETWEEN ELEVATIONS SHOWN

SITE PLAN - PAVEMENT
SCALE: 1" = 30'-0"

- KEY**
- ⊙ GRATING, M.I. TOP
 - SOLID M.I. TOP
 - CATCH BASIN
 - CONCRETE
 - CONCRETE ELECTRICAL BOXES
- 7375.X DENOTES ELEVATION OF FINISHED PAVEMENT

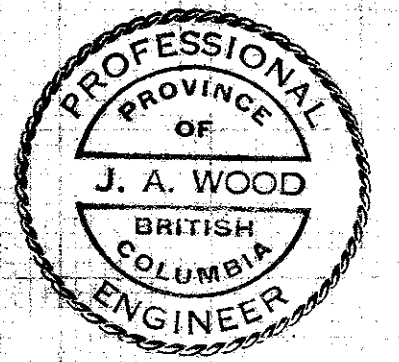

REVISIONS	ISSUE	DATE	DRN	CHD	APPD	DESCRIPTION

DEPARTMENT OF THE ENVIRONMENT
FISHERIES AND MARINE SERVICE

DESIGNED: [Signature]
DRAWN: [Signature]
CHECKED: [Signature]

RECOMMENDED: [Signature] APPROVED: [Signature] APPROVED: [Signature]


KERR WOOD LEIDL ASSOCIATES LTD.
CONSULTING ENGINEERS

April 6, 1979

DEPARTMENT OF THE ENVIRONMENT
PUNTLIDGE RIVER HATCHERY
SITE LAYOUT, PAVING AND
SECURITY FENCE PLAN

K.W.L. DWG. NO: 19.7B.7

SCALE: AS SHOWN
DRAWING No: 31-0-300
SHEET 03 OF 08 ISSUE A

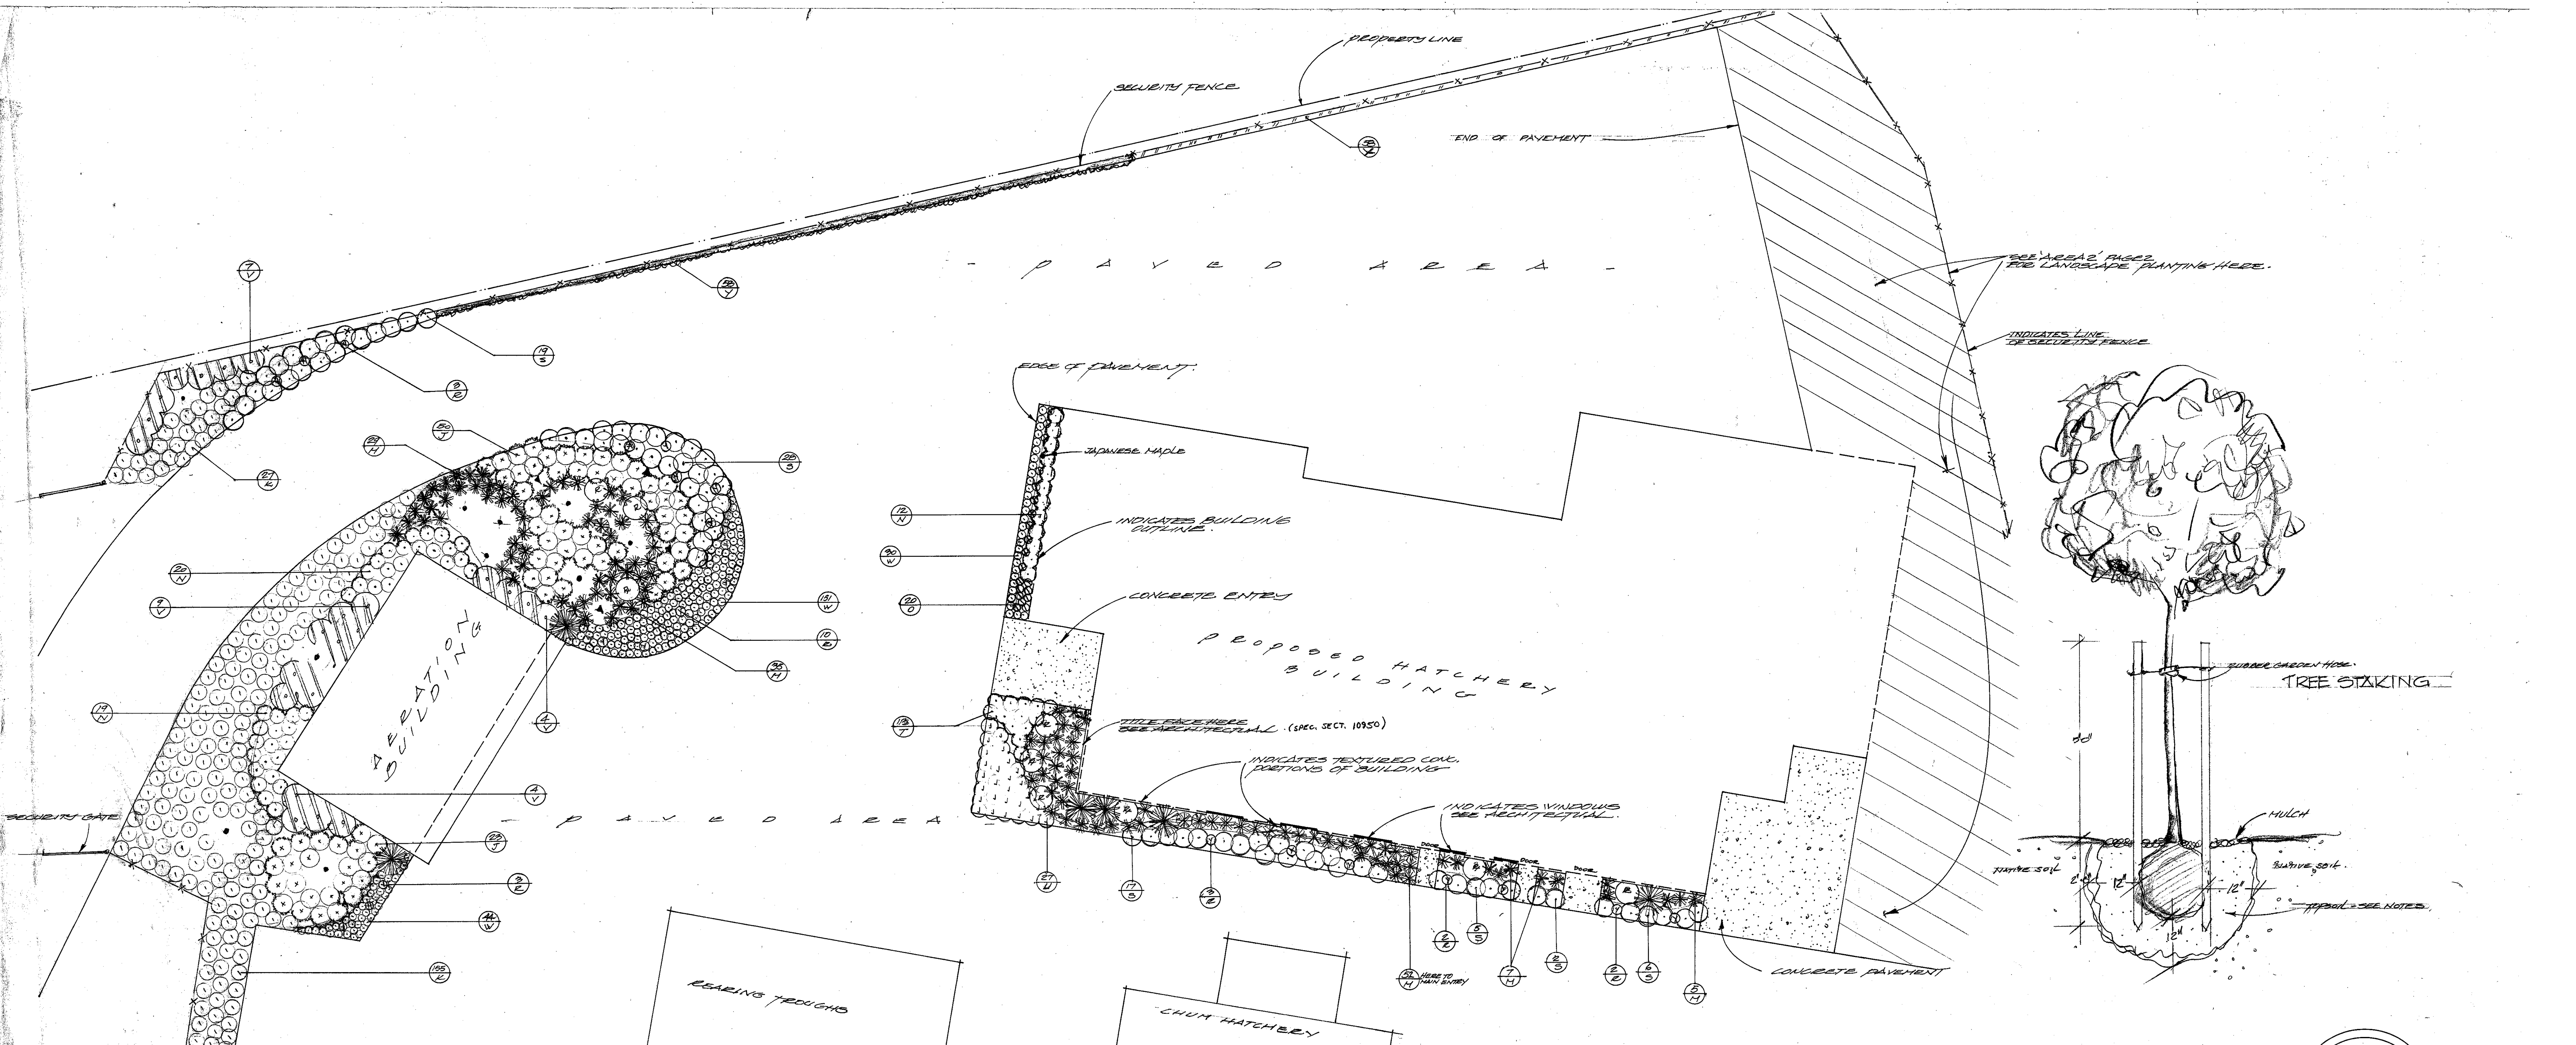


PLANTING SCHEDULE

SYMBOL	QTY	BOTANICAL NAME	COMMON NAME	SIZE	CONDITION	REMARKS
A	7	ACER PALMATUM ATROPURPUREUM	RED JAPANESE MAPLE	3.5 m	80% CANOPY	SEMI-BURIED
B	5	ACER PALMATUM DISSECTUM	LACINIAE JAPANESE MAPLE	60 cm	35 cm PER	STAKED
C	6	PINUS NIGRA	AUSTRALIAN PINE	2 m	75 cm BOX	BURIED
D	6	PINUS THUNBERGII	JAPANESE BLACK PINE	2 m	85 cm BOX	BURIED
E	5	CHAMAECYPARIS NOOTLATENSIS	NOOTKA CYPRESS	1.75 m	CONTAINER	
J	73	CYTIUS PRAECOX	WAXWING/BIRD BROOM	50 cm	21 cm PER	
K	314	PERIVUS LAUCOCERISUS ZAOSLANA	ZADEL LAUREL	25 cm	15 cm PER	
L	6	PINUS ARISTATA	DWARF PINE - BASTLECONE	1 m	55 cm TIG	SPECIMEN
H	123	PINUS HUSSO HUSSO	HUSSO PINE	60 cm	20 cm PER	FULL
N	51	MAHONIA AQUIFOLIUM	OREGON GRAPE	50 cm	27 cm PER	MULTIPLE
O	20	MAHONIA AQUIFOLIUM COMPACTA	DWARF AQUIFOLIUM	25 cm	21 cm PER	MULTIPLE
P	4	RHOODODENDRON B. B. HINE	WHITE STANDARD - BROADLEAF EVERGREEN	1.25 m	60 cm BOX	SEE NOTES
Q	4	RHOODODENDRON VULCAN FLAME	RED	1.25 m	60 cm BOX	"
R	23	YUCCA FILAMENTOSA	ADAM'S NEEDLE	50 cm	27 cm PER	"
S	53	JUNIPERUS CHINENSIS SARGENTII	LOW JUNIPER	50 cm	27 cm PER	
T	13	JUNIPERUS CHINENSIS PETERIANA ALBA	GOLDEN PETER JUNIPER	50 cm	27 cm PER	
U	27	JUNIPERUS HORIZONTALIS WILTONII	BLUE BUSH JUNIPER	50 cm	27 cm PER	
V	24	FORSYTHIA OATA TETRAGOLD	FORSYTHIA	60 cm	21 cm PER	
W	215	LOTONEASTER CONSPICUUS DECORUS	NECKLACE COPONIASTER	25 cm	15 cm PER	
X	152	HEDERA COLCHICA CENTRAL VARIETAL	VARIETAL FRENCH IVY	15 cm	PER 15 cm PER	
Y	53	HEDERA HELIX	ENGLISH IVY	15 cm	PER 15 cm PER	

AREA 1 SHRUB PLACEMENT WITH GROUND COVERS


GENERAL NOTES & SPECIFICATIONS

- ALL PLANT MATERIAL TO MEET B.C.N.F.A. STANDARDS
- TOPSOIL TO BE PROVIDED 4" MIN. DEPTH IN ALL SEEDED LAWN AREAS
- PIT FOR TREES 12" IN ALL DIRECTIONS THAN ROOT BALL
- PIT FOR SHRUBS 6" MIN. (IN ALL DIRECTIONS) THAN ROOT BALL
- TOPSOIL 12" DEPTH IN ALL SHRUB & GROUND COVER AREAS
- TOPSOIL SHALL BE NATURAL FERTILE AGRICULTURE SOIL CAPABLE OF SUSTAINING PLANT GROWTH & IS TO BE REASONABLY FREE FROM STONES, SLUDGE, & ONE HANDFULL EXCESSIVE WEEDS & OTHER EXTRANEOUS MATTER
- USE 1/2 PART SOIL MIX FOR RHODODENDRON
- USE 10 LB. 12-4-8 FERTILIZER PER 1000 SQ. FT. OF LAWN
- USE 30 LB. FINE SAND/MULCH SLODGE - ONE HANDFULL PER SHRUB - 2 PER TREE
- USE 2" THICK MULCH OR BARK MULCH ON PLANTED AREAS
- 7" IN ALL GROUND COVER AREAS
- STAKE - RED MAPLE w/ DOUBLE 2x2 CEDAR STAKES
- STAKE - JAPANESE MAPLE w/ 5/8" DIA. 2x2 CEDAR STAKE
- GUY - ALL PINES & CYPRESSES WHERE NECESSARY
- SAVE & PROTECT ALL EXISTING TREES & PLANTS
- LAWN TO BE SEEDED WITH BUCKLER BLENDS PAKLAND MIX & APPLIED AS PER DIRECTIONS

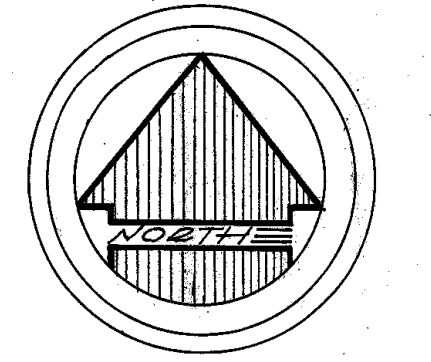


SCALE 1" INCH = 1' ON
 DWG. NO. 31-6-302
 SHEET 07 OF 68
 DRAWN BY: ROBT. PATTERSON

DEPARTMENT OF THE ENVIRONMENT
 FISHERIES AND MARINE SERVICE
 RECOMMENDED APPROVED APPROVED

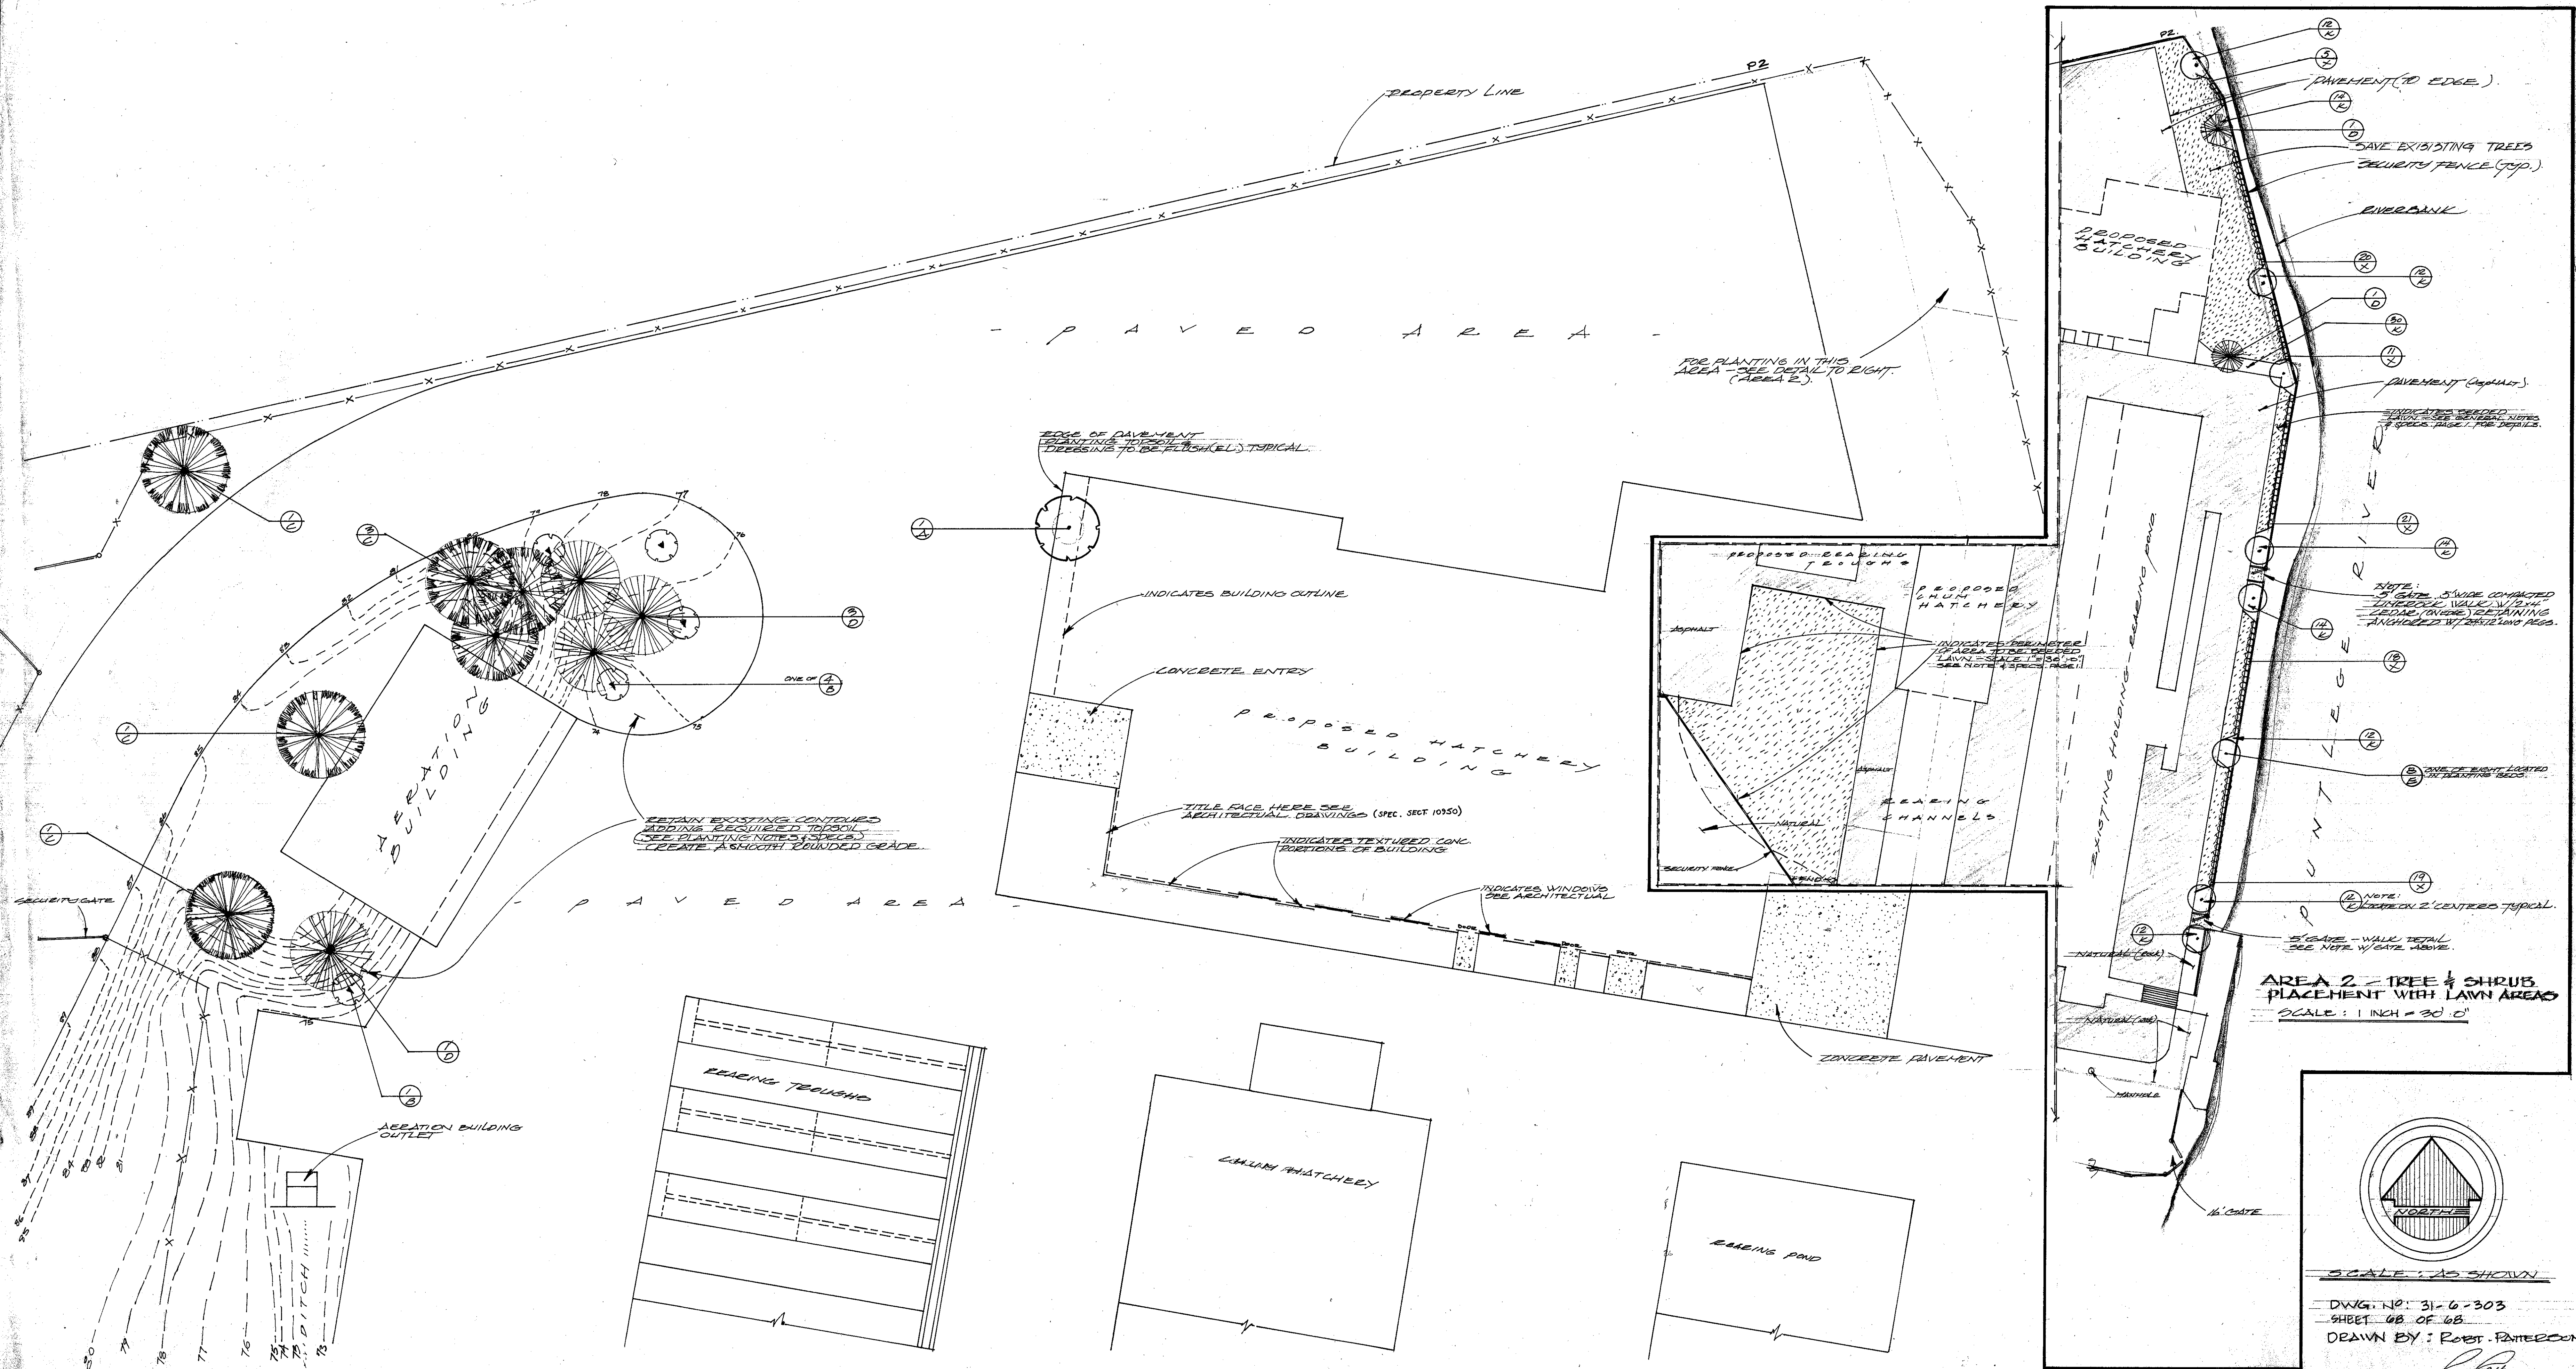

AREA 1 - TREE PLACEMENT & GRADING FEATURES SCALE: 1 INCH = 10' 0"

AREA 2 - TREE & SHRUB PLACEMENT WITH LAWN AREAS
SCALE: 1 INCH = 30' 0"

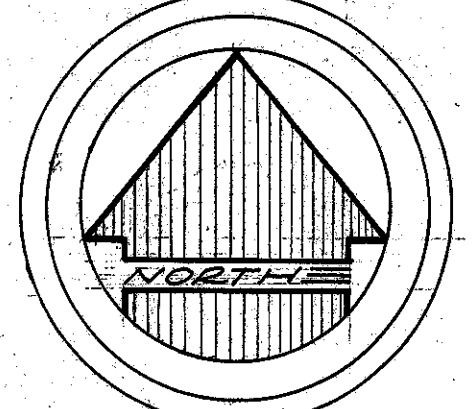
 NORTH

SCALE: AS SHOWN

DWG. NO: 31-6-303
 SHEET 08 OF 08
 DRAWN BY: ROBT. PATTERSON

DEPARTMENT OF THE ENVIRONMENT
FISHERIES AND MARINE SERVICE



