

**DRAWING LIST**  
Number Revision Description

- G-002 C General – Site – Key Plan and Drawing List
- G-003 0 General – Site – Site Plan and Notes
- M-002 0 Mechanical – Aeration Building – Piping Demolition
- M-003 0 Mechanical – Aeration Building – Piping Plan, Sections & Bill of Materials
- M-004 0 Mechanical – Aeration Building – Ventilation – Plan & Details
- M-005 0 Mechanical – Aeration Building – Turbine & Piping Details
- P-001 0 Process – Aeration Building - Schematic and Control Strategy
- P-002 0 Process – Aeration Building – Process and Instrumentation Diagram
- S-002 0 Structural - Aeration Building - Control Room Partition Wall
- E-001 F Electrical – Hatchery & Aeration Buildings – Single Line Diagram
- E-002 D Electrical – Hatchery & Aeration Buildings – Wall Elevations
- E-003 C Electrical – Aeration Building – Control Cabinet Layout
- E-004 E Electrical – Aeration Building – Control Cabinet Power
- E-005 E Electrical – Aeration Building – Control Cabinet I/O-1
- E-006 E Electrical – Aeration Building – Control Cabinet I/O-2
- E-007 B Electrical – Aeration Building – Control Cabinet I/O-3
- E-008 D Electrical – Aeration Building – Control Cabinet I/O-4
- E-009 C Electrical – Aeration Building – Control Cabinet I/O-5
- E-010 B Electrical – Conduit Section Details
- E-011 D Electrical – Aeration Building – Electrical Equipment Layout
- E-012 B Electrical – Aeration Building – Induction Generator Protection & Control Schematic
- E-100 B Cable Schedule

Plotted by: Andrea Path Date: 21-Jun-16 Path: \\nrc\c\working\Projects\MEL\Puntledge\18-5000\Rev\18-5000\REV18.dwg Size: 11111

SCALE 1:1000 0 25 50 75 100m.

**WHITESIDE ENGINEERING LTD.**  
WATER UTILITY CONSULTING

**FISHERIES AND OCEANS CANADA**  
REAL PROPERTY AND TECHNICAL SUPPORT

DWG. NO.	DRAWING REFERENCES	NOTES	NO.	DATE	REVISIONS

DESIGNED N. WHITESIDE
DRAWN A. VIZNAR
CHECKED N. WHITESIDE
RECOMMENDED
APPROVED
APPROVED

**PUNTLEDGE RIVER HATCHERY**  
**WATER SUPPLY ENERGY RECOVERY**  
**GENERAL**  
**SITE**  
**KEY PLAN & DRAWING LIST**

SCALE AS NOTED
DATE 21-Jun-16
DRAWING NUMBER <b>G-002</b>
REVISION <b>C</b>


**C 16-NOV-2016 DRAWING LIST REVISED**  
 B 21-JUN-2016  
 O 14-APR-2016  
 DRAWING LIST REVISED  
 ISSUED FOR TENDER











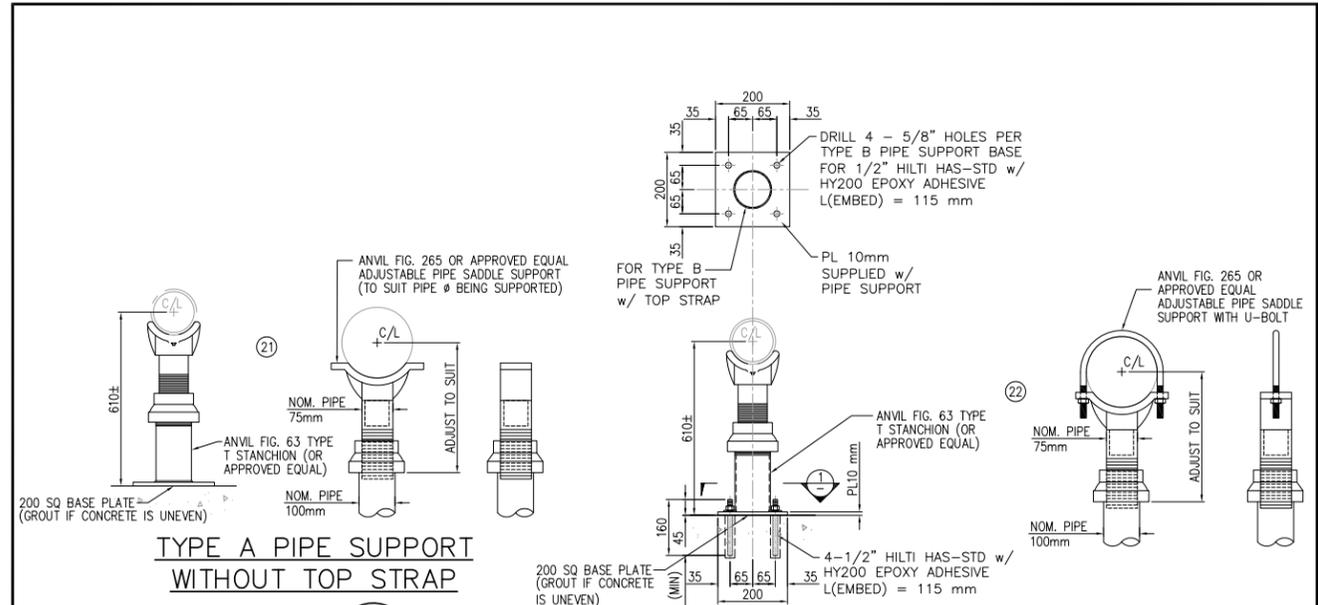

**TYPE A PIPE SUPPORT WITHOUT TOP STRAP**  
**DETAIL A**  
 SCALE: N.T.S. M-003  
 (5 REQUIRED)

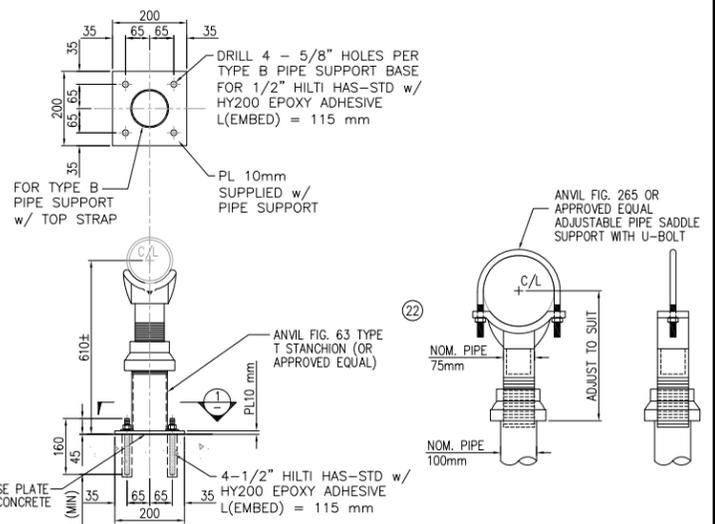


**TYPE B PIPE SUPPORT WITH TOP STRAP**  
**DETAIL B**  
 SCALE: N.T.S. M-003  
 (5 REQUIRED)  
 LOAD CAPACITY 17kN EACH

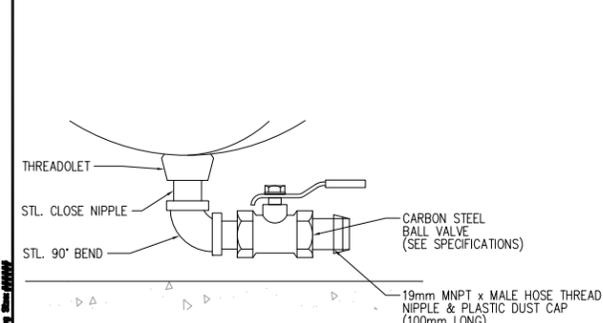


DRAIN SIZE	No. REQ'D	No. REQ'D
19ø	4	PIPE SPECIALS 11, 15, 17, 18

**PIPE DRAIN**  
**DETAIL C**  
 SCALE: N.T.S. M-003

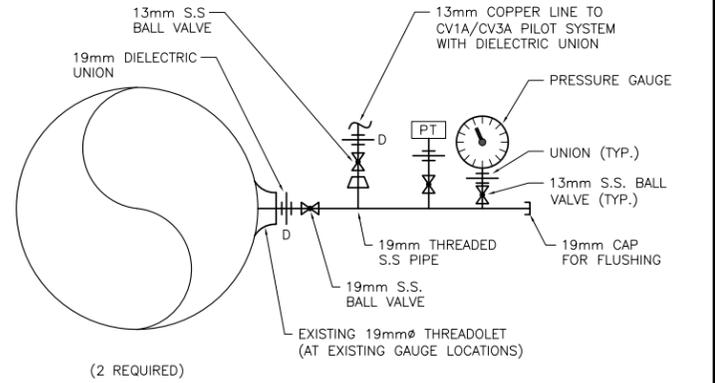


**PRESSURE GAUGE DETAIL D**  
 SCALE: N.T.S. M-003


TAG	DESCRIPTION	LOCATION	PRESSURE GAUGE/TRANSMITTER RANGE (psig)
PT-1	GRAVITY SUPPLY PRESSURE	UPSTREAM OF FLOW METER	0-200 psig (1379kPa)
PT-2	HEAD TANK PRESSURE	600ø HEADER TO REARING HEAD TANK	0-30 psig (207kPa)

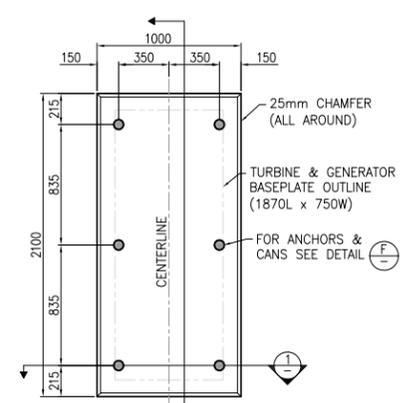


**PLAN - STRUCTURE OUTLINE**  
 SCALE: 1:25

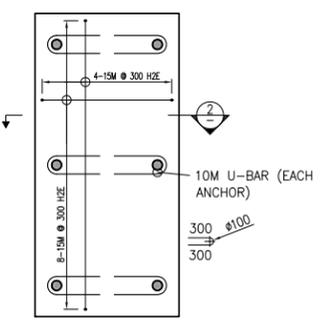


**PLAN - REINFORCEMENT**  
 SCALE: 1:25

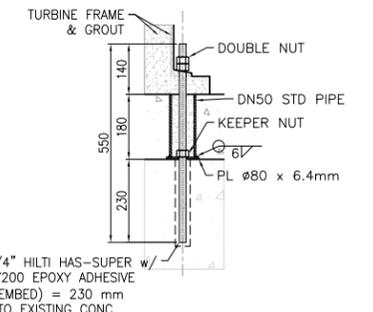


**DETAIL F**  
 SCALE: 1:10

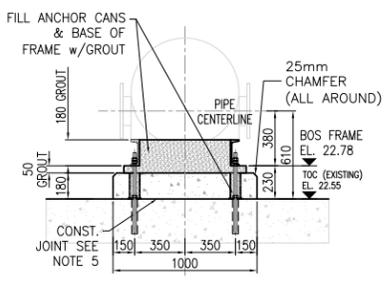

**SECTION 1**  
 SCALE: 1:25

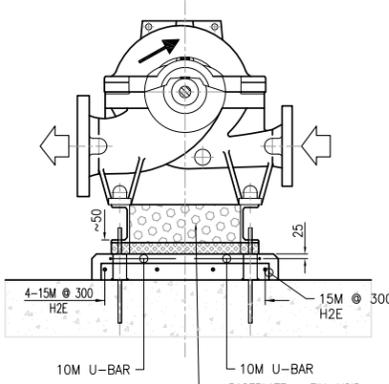

**SECTION 2**  
 SCALE: N.T.S.

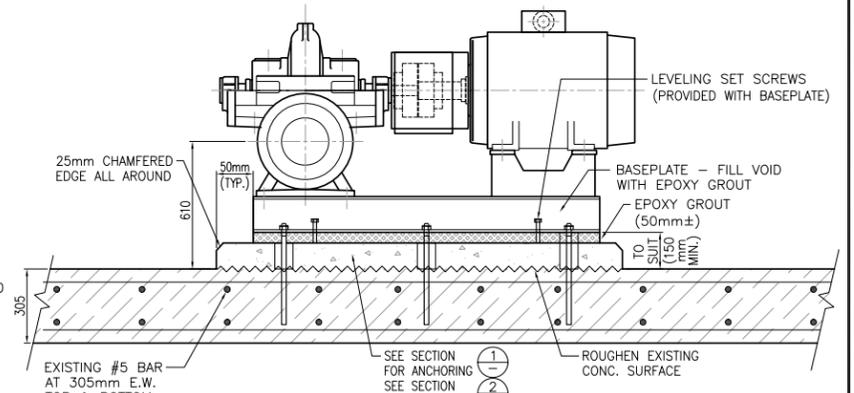

**SECTION 3**  
 SCALE: N.T.S.

**TURBINE INSTALLATION DETAIL E**  
 SCALE: N.T.S. M-003

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NOTES:

- DESIGN CRITERIA
  - CODES AND STANDARDS
    - BRITISH COLUMBIA BUILDING CODE OF CANADA, 2012
    - CAN/CSA A23.3 - DESIGN OF CONCRETE STRUCTURES
  - PERMISSIBLE DESIGN LOADS
    - SEISMIC LOAD: PGA = 0.30, Sa(0.2) = 0.65, Ie = 1.0
    - WET WEIGHT: 18.1 kN
    - MAX PUMP THRUST: 100 kN
    - MAX PUMP TORQUE: 1.6 kN\*m
    - MAX MOTOR START-UP TORQUE: 4.0 kN\*m
- CONCRETE: 28 DAY COMPRESSIVE STRENGTH  $f_c' = 35 \text{ MPa}$ , EXPOSURE CLASS TO CSA A23.1 F1
- REINFORCEMENT: DEFORMED BARS TO CSA G30.18, GRADE 400W  $F_y = 400 \text{ MPa}$
- ALL EMBEDDED METALS SHOULD BE GALVANIZED. ROUGHEN CONSTRUCTION JOINT TO AN AMPLITUDE OF 5 MM. LAITANCE AND THE COARSE AGGREGATE EXPOSED. AFTER ROUGHENING, CLEAN AND WET THE SURFACE THOROUGHLY. PRIOR TO CASTING NEW CONCRETE, THE SURFACE MUST BE DAMP BUT WITH NO MOISTURE "SHEEN". APPLY BONDING AGENT TO THE ROUGHENED SURFACE JUST PRIOR TO CONCRETING.

DWG. NO.	DRAWING REFERENCES	NOTES	NO.	DATE	REVISIONS
			0	14-APR-2016	ISSUED FOR TENDER

DESIGNED	DRAWN	CHECKED	RECOMMENDED	APPROVED
N. WHITESIDE	A. VIZNAR	N. WHITESIDE		

**PUNTLEDGE RIVER HATCHERY**  
**WATER SUPPLY ENERGY RECOVERY**  
**MECHANICAL**  
**AERATION BUILDING**  
**TURBINE & PIPING DETAILS**


SCALE	AS NOTED
	DATE: 19-APR-16
	DRAWING NUMBER: M-005
REVISION	0



	RESERVOIR/SOURCE	<b>MATERIAL CODES:</b> STL - CARBON STEEL
	OVERFLOW	<b>SERVICE CODES:</b> RW (HP) - RAW WATER HIGH PRESSURE RW (LP) - RAW WATER LOW PRESSURE OVF - OVERFLOW
	ISOLATION VALVE (N/C=NORMALLY CLOSED)	<b>PIPE CODE:</b> 300 - RW - STL
	MOTORIZED VALVE	— PIPING MATERIAL CODE
	CONTROL VALVE	— FLUID SERVICE CODE
	TURBINE/GENERATOR UNIT	— PIPE NOMINAL DIA. IN mm
	FLOW TRANSMITTER	

- NOTES:**
- SEE PROCESS NARRATIVE FOR INSTRUMENT TAGS.
  - ALL INSTRUMENTS PROVIDE SIGNALS TO CONTROL ROOM PLC UNLESS NOTED OTHERWISE (WITH HMI DISPLAY)
- FIELD MOUNTED INSTRUMENT (NO DISPLAY)
- FIELD MOUNTED INSTRUMENT (WITH DISPLAY)
- ELECTRICAL SIGNAL

LIST OF INSTRUMENTATION FOR WATER SUPPLY SYSTEM IN AERATION BUILDING				
TAG	DESCRIPTION	EXISTING?	RANGE	USE
FT-01	PENSTOCK FLOW METER	EXISTING	0-56,775 LPM	MEASURES HIGH PRESSURE GRAVITY FLOW FROM PENSTOCK (COMOX LAKE)
FT-02	RIVER SUPPLY FLOW METER	EXISTING	0-56,775 LPM	MEASURES PUMPED FLOW FROM PUNTLEDGE RIVER
LT-01	REARING HEAD TANK LEVEL	EXISTING	0-100%	ALARM, USED TO CONTROL CONTROL VALVES (CV1A, CV3A, OR TCV AS APPROPRIATE)
LT-02	INCUBATION TANK LEVEL	EXISTING	0-100%	ALARM, ALTERNATE SIGNAL USED TO CONTROL CONTROL VALVES (CV1A, CV3A, OR TCV)
PT-01	PENSTOCK SUPPLY PRESSURE	REPLACEMENT	0-200 psi	SHUTDOWN TURBINE IF READING IS LESS THAN SETPOINT (100 psi). ALARM.
PT-02	HEADER PRESSURE	REPLACEMENT	0-30 psi	MONITOR ONLY
RT-01	TURBINE ROTATING SPEED	NEW	0-1800 RPM	USED TO MONITOR SHAFT ROTATIONAL SPEED ESP. AT STARTUP/SHUTDOWN. NORMAL VALUE 1220 RPM. ALARM AT OVERSPEED (VALUE TBD).
TT-01	WATER TEMPERATURE	EXISTING		INCUBATION TANK WATER TEMPERATURE
TT-02	VALVE ROOM THERMOSTAT	REPLACEMENT	0-40°C	TURNS ON MAIN VENTILATION FAN
TT-03	CONTROL ROOM THERMOSTAT	NEW	0-40°C	TURNS ON CONTROL ROOM VENTILATION FAN
TT-04	TURBINE INSIDE BEARING RTD PROBE	NEW	TBD	RTD ON INSIDE BEARING (BETWEEN TURBINE AND GENERATOR)
TT-05	TURBINE BEARING RTD PROBE 2	NEW	TBD	RTD ON OUTSIDE BEARING
TT-06	GENERATOR TEMPERATURE RTD PROBE (PHASE A)	NEW	TBD	RTDs EMBEDDED IN GENERATOR WINDINGS
TT-07	GENERATOR TEMPERATURE RTD PROBE (PHASE B)	NEW	TBD	RTDs EMBEDDED IN GENERATOR WINDINGS
TT-08	GENERATOR TEMPERATURE RTD PROBE (PHASE C)	NEW	TBD	RTDs EMBEDDED IN GENERATOR WINDINGS
XT-01	CV1A VALVE POSITION	REPLACEMENT	0-100% VALVE TRAVEL	MONITOR % OPEN OF VALVE AS MEASURED BY VALVE STEM TRAVEL
XT-03	CV3A VALVE POSITION	REPLACEMENT	0-100% VALVE TRAVEL	MONITOR % OPEN OF VALVE AS MEASURED BY VALVE STEM TRAVEL
XT-05	TCV VALVE POSITION	NEW	0-100%	MONITOR BUTTERFLY VALVE POSITION (% OPEN)
XT-10	VALVE 10 VALVE POSITION	EXISTING	OPEN/CLOSED	BYPASS VALVE, N/O ALLOWS FOR ISOLATION OF REARING HEAD TANKS FROM INCUBATION TANKS

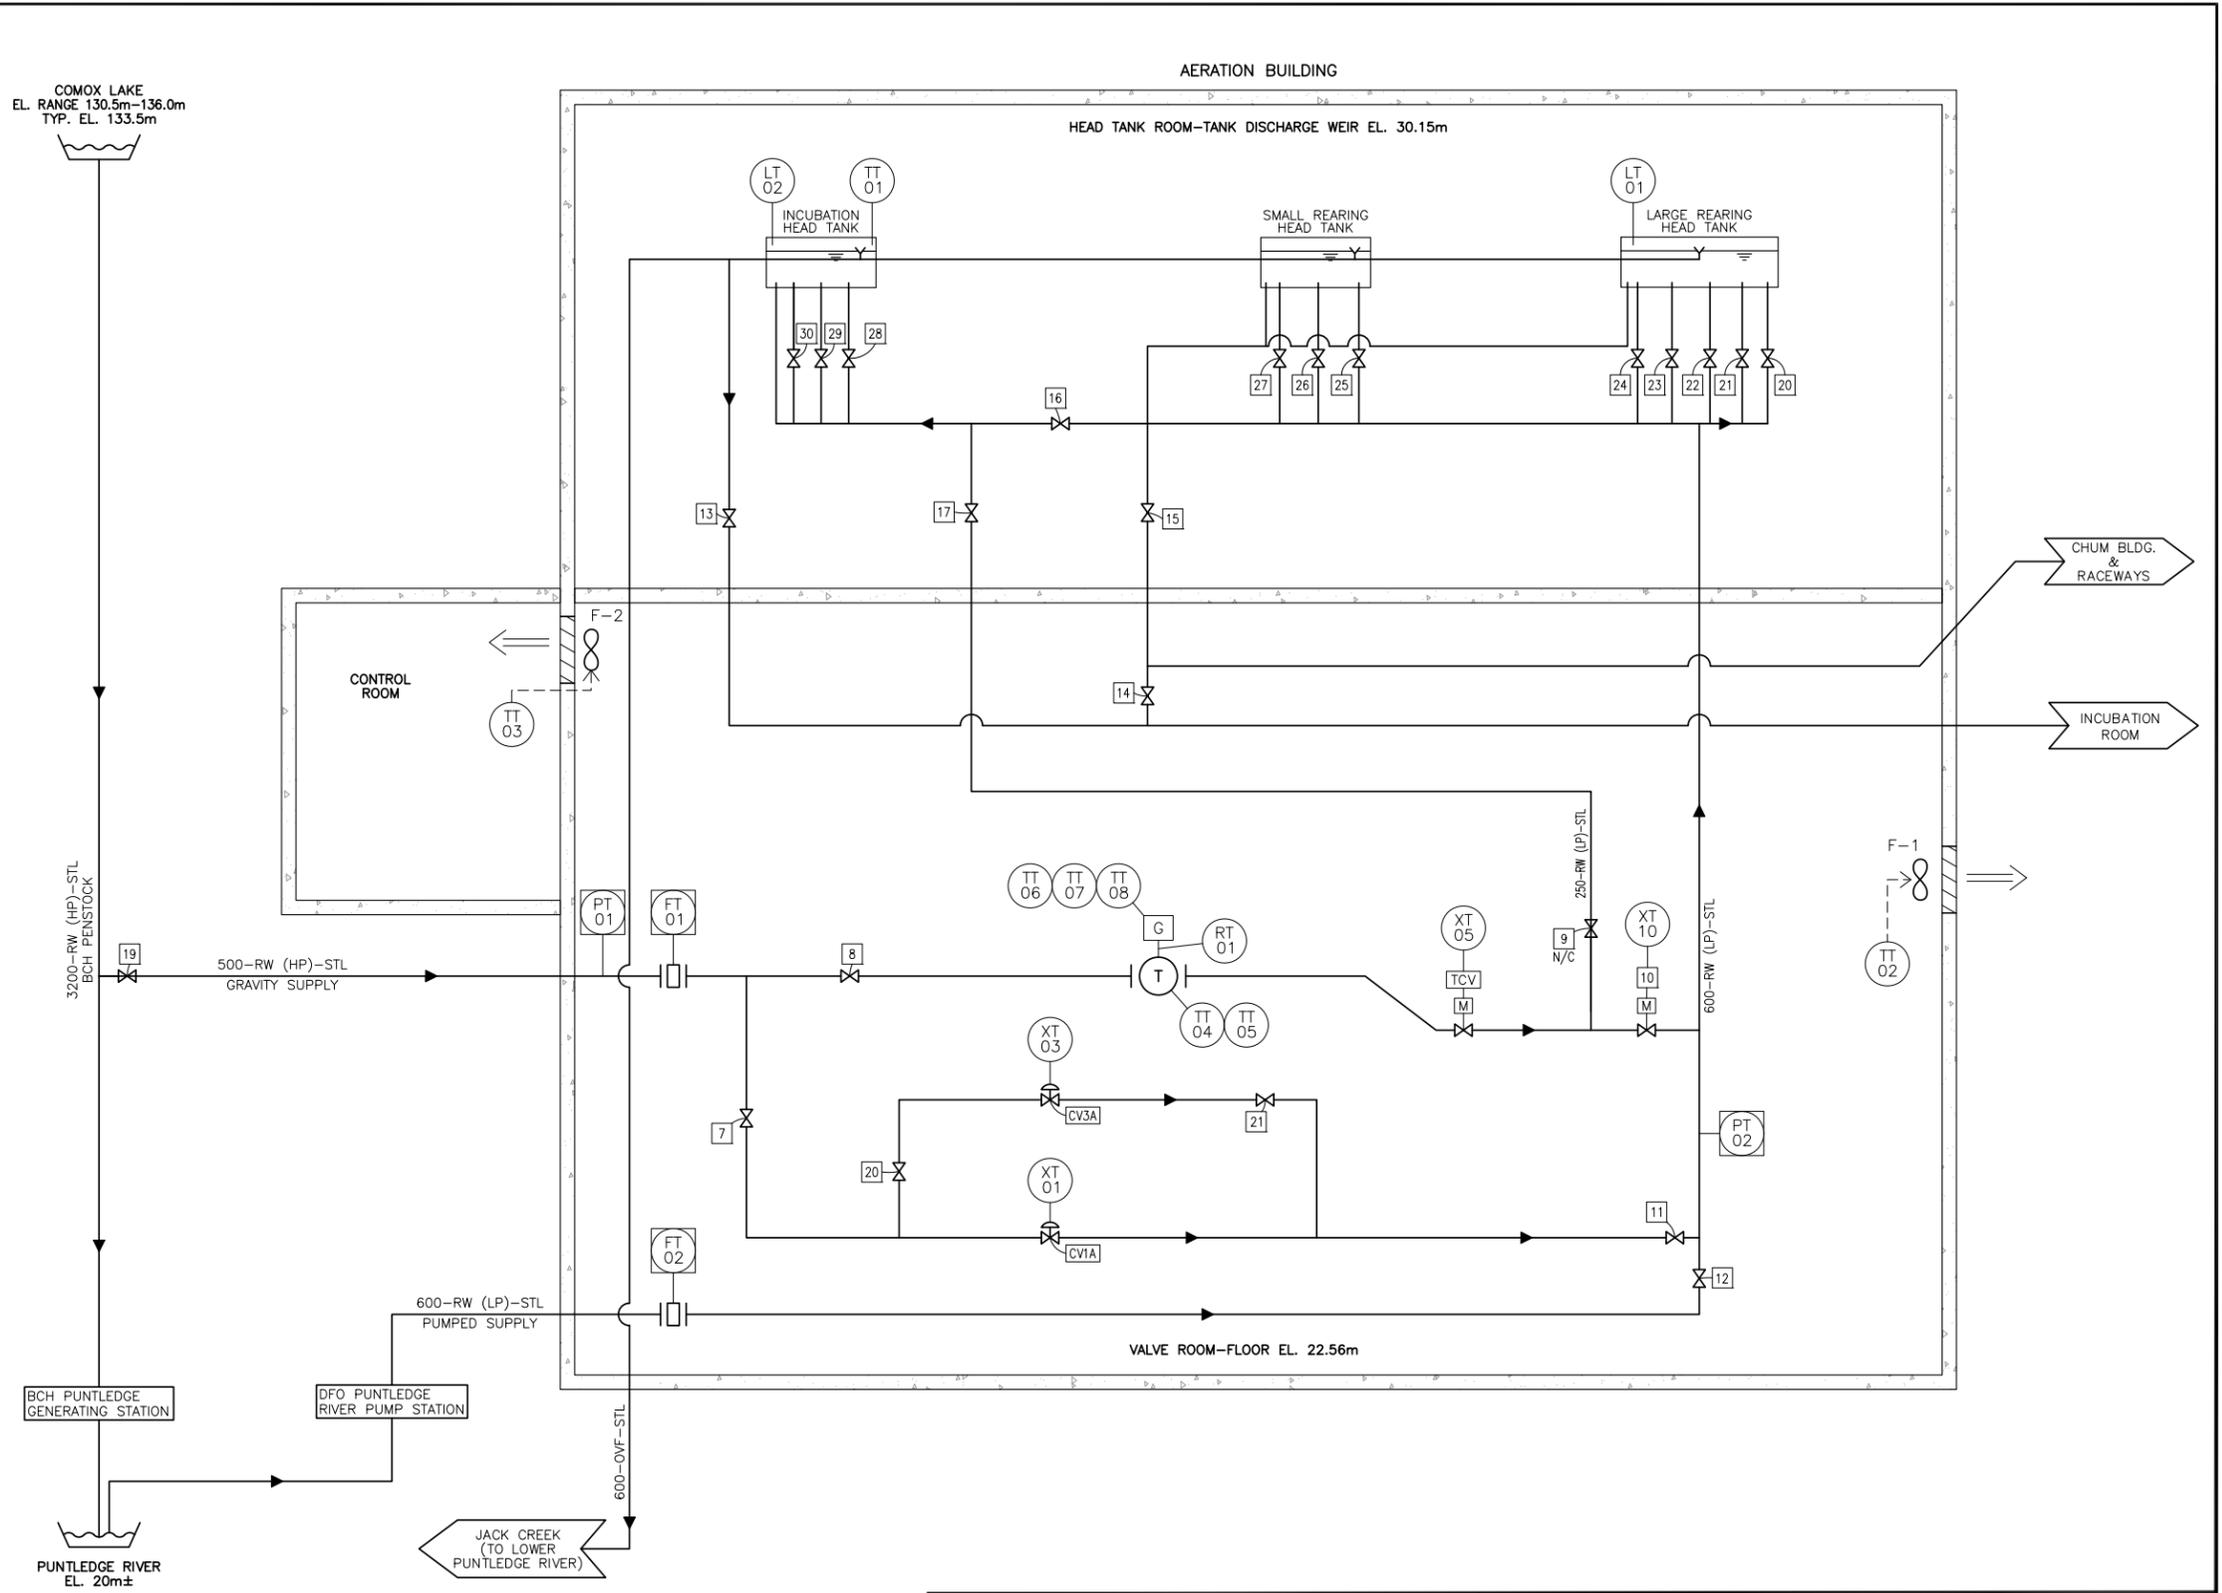

DWG. NO.	DRAWING REFERENCES	NOTES	NO.	DATE	REVISIONS
			0	09-MAY-2016	ISSUED FOR TENDER

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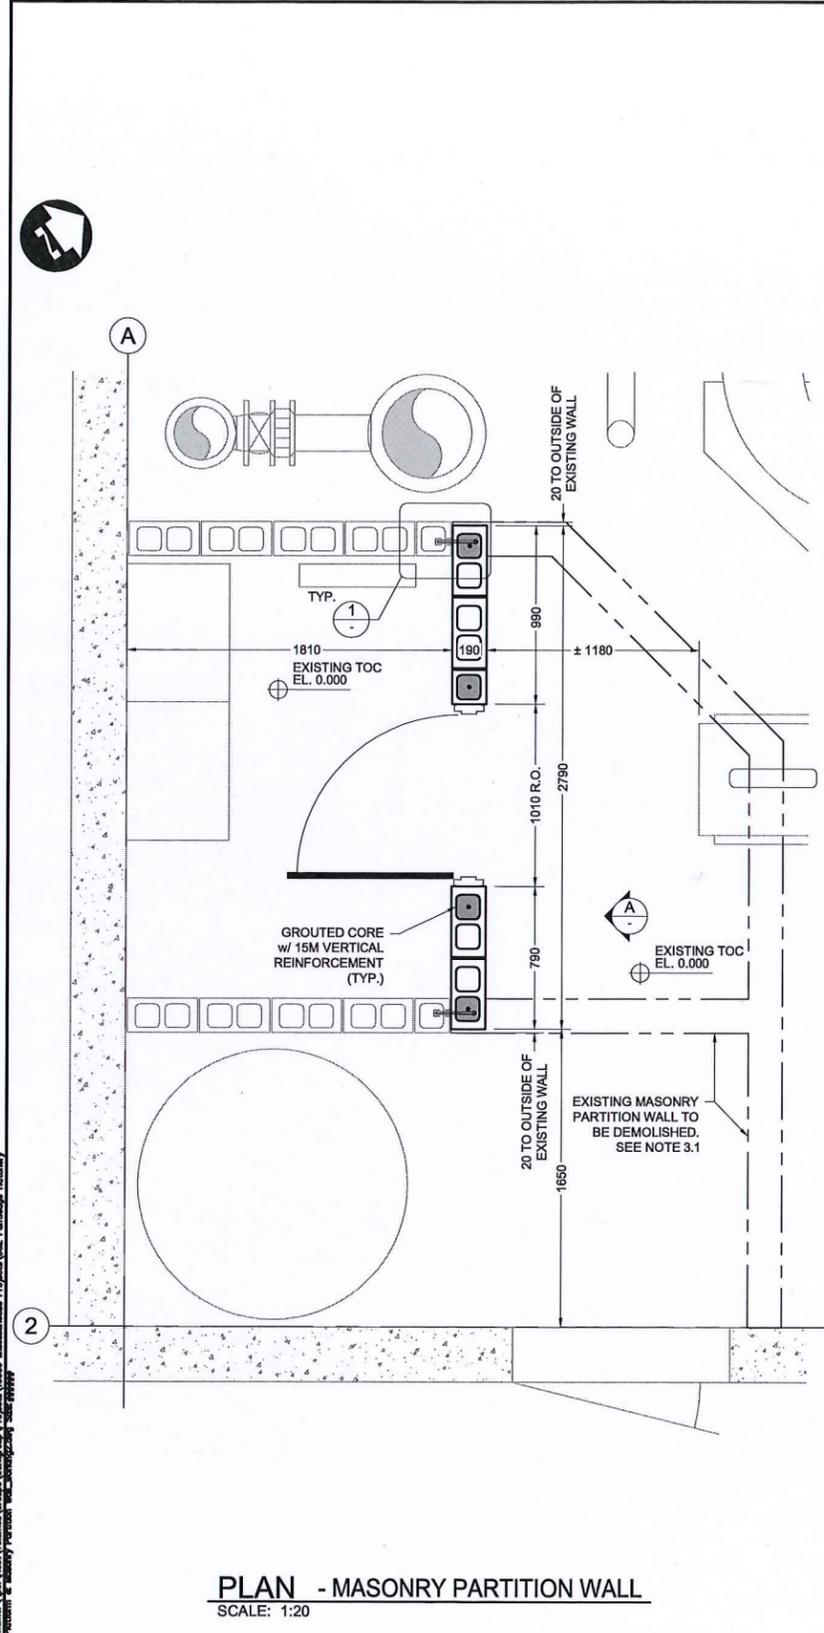
DESIGNED  
N. WHITESIDE  
DRAWN  
A. VIZNAR  
CHECKED  
N. WHITESIDE  
RECOMMENDED  
APPROVED  
APPROVED

**FISHERIES AND OCEANS CANADA**  
REAL PROPERTY AND TECHNICAL SUPPORT


**PUNTLEDGE RIVER HATCHERY  
WATER SUPPLY ENERGY RECOVERY  
PROCESS  
AERATION BUILDING  
PROCESS AND INSTRUMENTATION  
DIAGRAM**

SCALE  
AS NOTED  
DATE  
15-May-16  
DRAWING NUMBER  
**P-002**  
REVISION  
0


Plotted by: Andrea Plot date: 15-May-16 Path: \\P:\Projects\2016\20160515\_Puntledge River Hatchery Water Supply Energy Recovery Process Aeration Building Process and Instrumentation Diagram.dwg




**PLAN - MASONRY PARTITION WALL**  
SCALE: 1:20

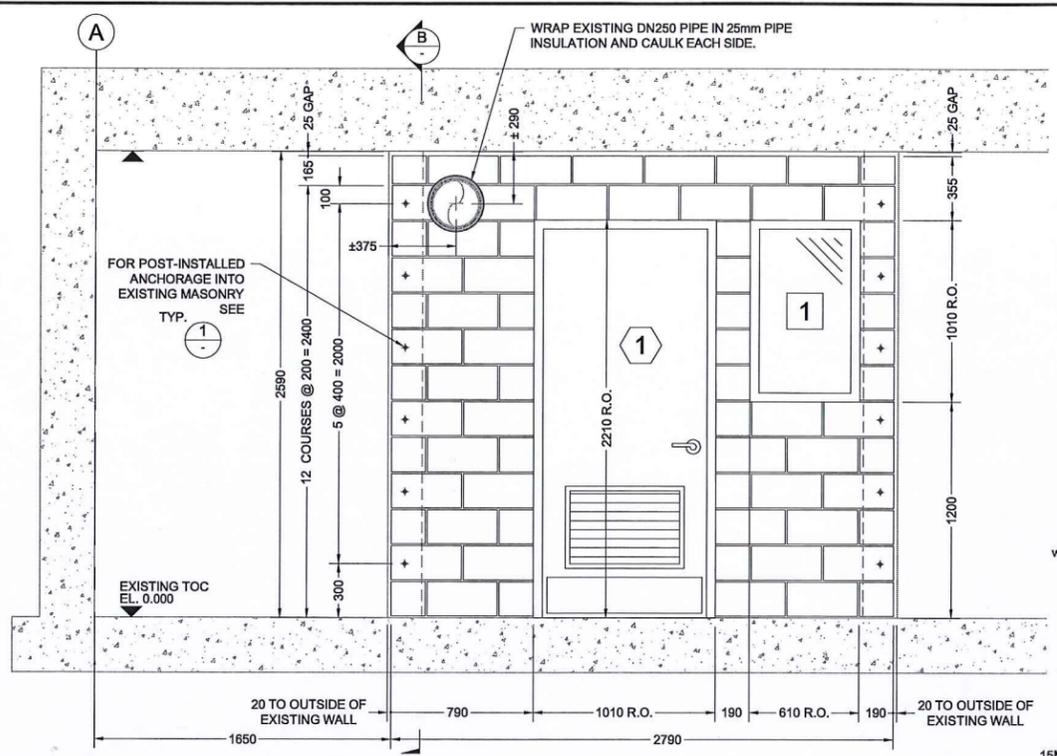

**ELEVATION - STRUCTURE OUTLINE**  
SCALE: 1:20

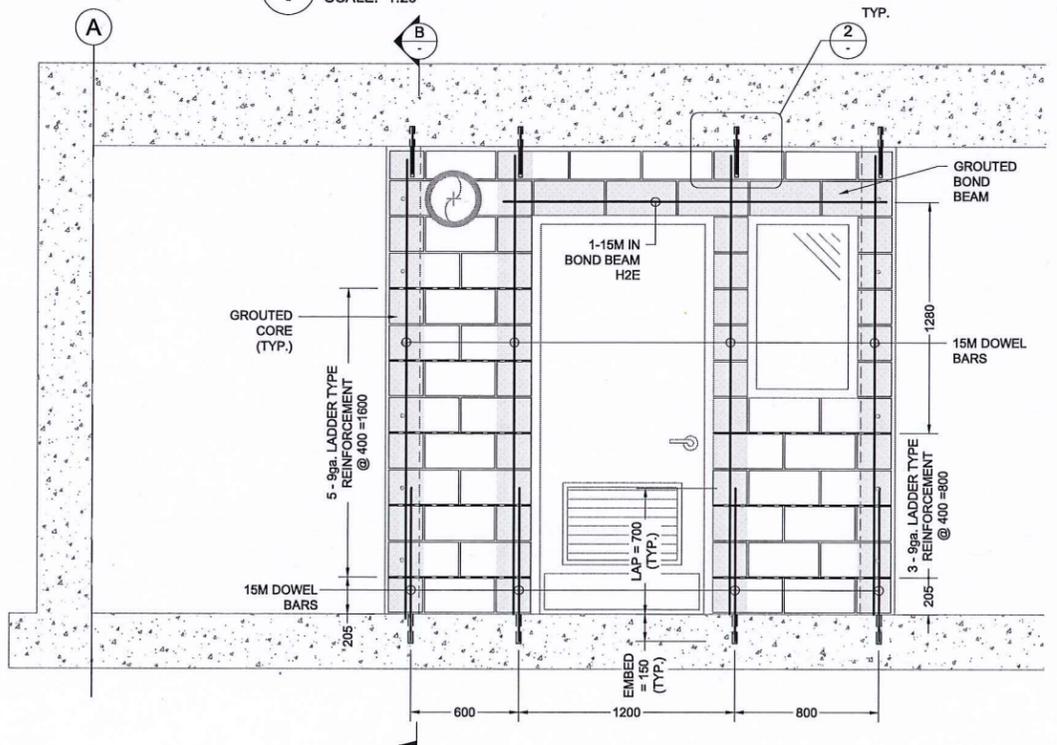


**ELEVATION - REINFORCEMENT**  
SCALE: 1:20

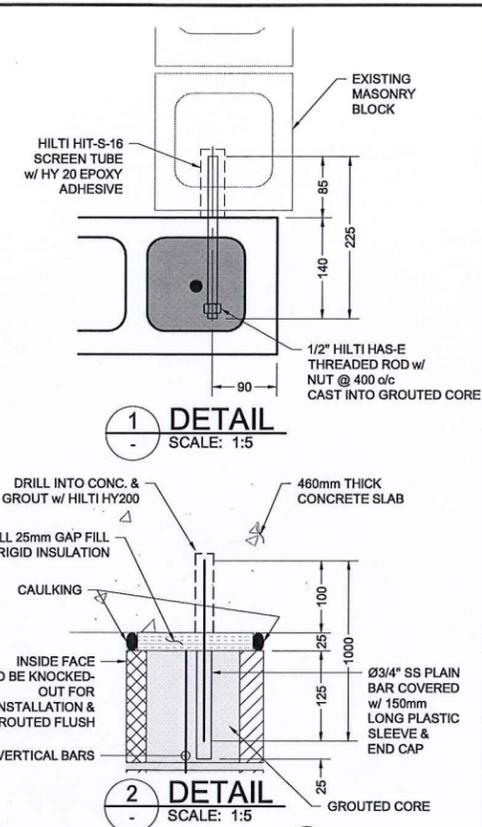

**DETAIL 1**  
SCALE: 1:5

**DETAIL 2**  
SCALE: 1:5

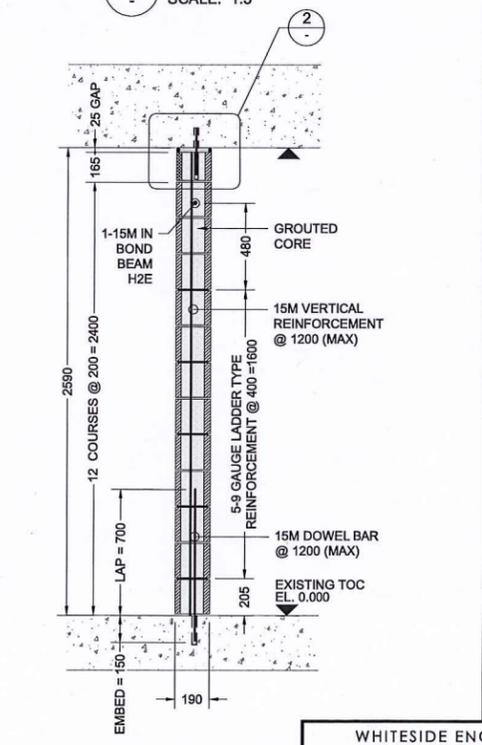

**SECTION B**  
SCALE: 1:20

- NOTES:**
- GENERAL**
    - FOR RECORD DRAWINGS REFER TO DFO DRAWING #31-6-204 TO 31-6-299.
    - LOCAL REFERENCE ELEVATIONS RELATIVE TO TOP OF CONCRETE FLOOR. (TOC FLOOR EL. 0.000m = EL. 22.555m UTM)
    - DESIGN CRITERIA**
      - CODES AND STANDARDS**
        - BRITISH COLUMBIA BUILDING CODE OF CANADA, 2012
        - CAN/CSA S304-14 DESIGN OF MASONRY STRUCTURES
      - PERMISSIBLE DESIGN LOADS**
        - USAGE LOAD (GREATER OF): 0.5 kPa OR 1.0 kN
        - SEISMIC LOAD: PGA = 0.30, Sa(0.2) = 0.65, Ia = 1.0
  - MATERIALS**
    - UNIT MASONRY:**
      - TYPE H/7.5/A/M (COMPRESSIVE STRENGTH ON NET AREA) f<sub>m</sub> = 15MPa
    - MORTAR:**
      - TO CSA A179, TYPE S f<sub>m</sub> = 7.5MPa
    - STAINLESS STEEL ROUND BAR:**
      - TO ASTM A276, TYPE 304 F<sub>y</sub> = 205 MPa
    - REINFORCEMENT:**
      - DEFORMED BARS TO CSA G30.18, GRADE 400W F<sub>y</sub> = 400 MPa
      - LADDER TYPE TO CSA A371 & CSA G30.3 F<sub>y</sub> = 400 MPa
  - EXECUTION**
    - REFER TO FIGURE 5 FOR LIMITS OF DEMOLITION OF EXISTING MASONRY PARTITION WALL.



**DOOR SCHEDULE:**

DOOR NO.	LOCATION	ROUGH OPENINGS WIDTH (mm)	ROUGH OPENINGS HEIGHT (mm)	THICKNESS (mm)	DOOR TYPE
1	CONTROL ROOM	1010	2210	48	LH

- DOOR TYPES:**
- # INDICATES DOOR NUMBERS WHICH APPLY TO EACH FRAME
- DOOR 1:**
- FROM 14ga. SHEET STEEL - FULL MORTISE, 4 1/2 x 4 NRP
  - FLUSH FACED
  - PAINT FINISH
  - 610mm(W) x 405mm(H) LOUVER
- FRAME:**
- FROM 14ga. SHEET STEEL
  - WRAP TYPE JAMB
- HARDWARE (SATIN STAINLESS STEEL FINISH):**
- 3 BUTT HINGE (STANLEY - FULL MORTISE, 4 1/2 x 4 NRP)
  - 1 LATCH SET (BEST UNIVERSAL - 5K SERIES COMMERCIAL LOCK)
  - 1 FLOOR OR WALL STOP
  - 2 SS KICK PLATES
  - 1 CLOSER (STANLEY - D3550 COMMERCIAL DOOR CLOSER)
  - 1 THRESHOLD (PEMCO - 172 SERIES)

**WINDOW SCHEDULE:**

WINDOW NO.	LOCATION	ROUGH OPENINGS WIDTH (mm)	ROUGH OPENINGS HEIGHT (mm)
1	CONTROL ROOM	610	1010

- WINDOW TYPES:**
- # INDICATES WINDOW NUMBERS WHICH APPLY TO EACH TYPE
- WINDOW 1:**

WHITESIDE ENGINEERING LTD.  
WATER UTILITY CONSULTING  
Phone: 604-738-8876 www.whiteside.co

**GEA** Gygax Engineering Associates Ltd.  
105-1118 Commercial Drive  
Vancouver, B.C., Canada V6C 4A3  
Tel: (604) 254-3914 Fax: (604) 254-3939  
e-mail: mail@gea.ca

**FISHERIES AND OCEANS CANADA**  
REAL PROPERTY AND TECHNICAL SUPPORT

**PUNTLEDGE RIVER HATCHERY**  
**WATER SUPPLY ENERGY RECOVERY**  
**STRUCTURAL**  
**AERATION BUILDING**  
**CONTROL ROOM PARTITION WALL**

SCALE AS SHOWN  
DATE 09MAR2016  
DRAWING NUMBER **S-002**  
REVISION **0**




NO.	DATE	REVISIONS
0	15APR2016	ISSUED FOR TENDER
B	23MAR2016	ISSUED FOR REVIEW
A	09MAR2016	ISSUED FOR INTERNAL REVIEW

DESIGNED: T. LOVRIC  
DRAWN: T. LOVRIC  
CHECKED: A. GYGAX  
RECOMMENDED: A. GYGAX  
APPROVED: A. GYGAX

PROFESSIONAL ENGINEER OF BRITISH COLUMBIA  
K. A. GYGAX  
# 21344  
14 APR 2016


Project: Puntledge River Hatchery Water Supply Energy Recovery Structural Aeration Building Control Room Partition Wall  
 Drawing No: S-002  
 Date: 09MAR2016  
 Scale: 1:20  
 Designer: T. Lovric  
 Drafter: T. Lovric  
 Checker: A. Gygax  
 Recommender: A. Gygax  
 Approver: A. Gygax  
 Project Manager: A. Gygax  
 Client: Fisheries and Oceans Canada  
 Location: Puntledge River Hatchery  
 Drawing No: S-002  
 Date: 09MAR2016  
 Scale: 1:20

**PRELIMINARY**  
NOT FOR CONSTRUCTION

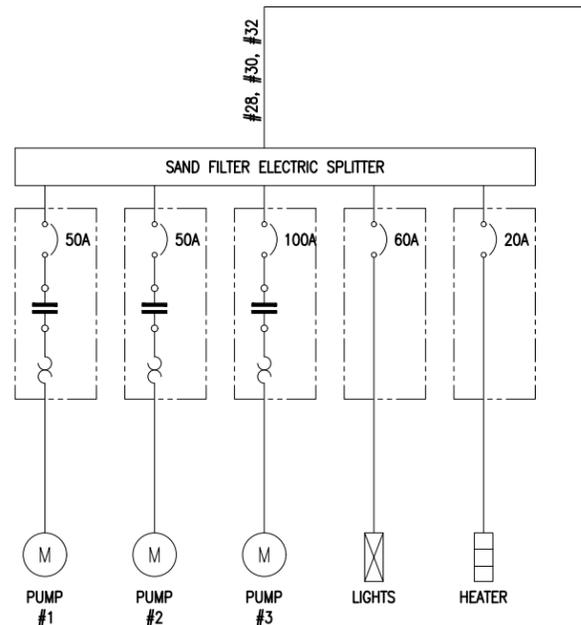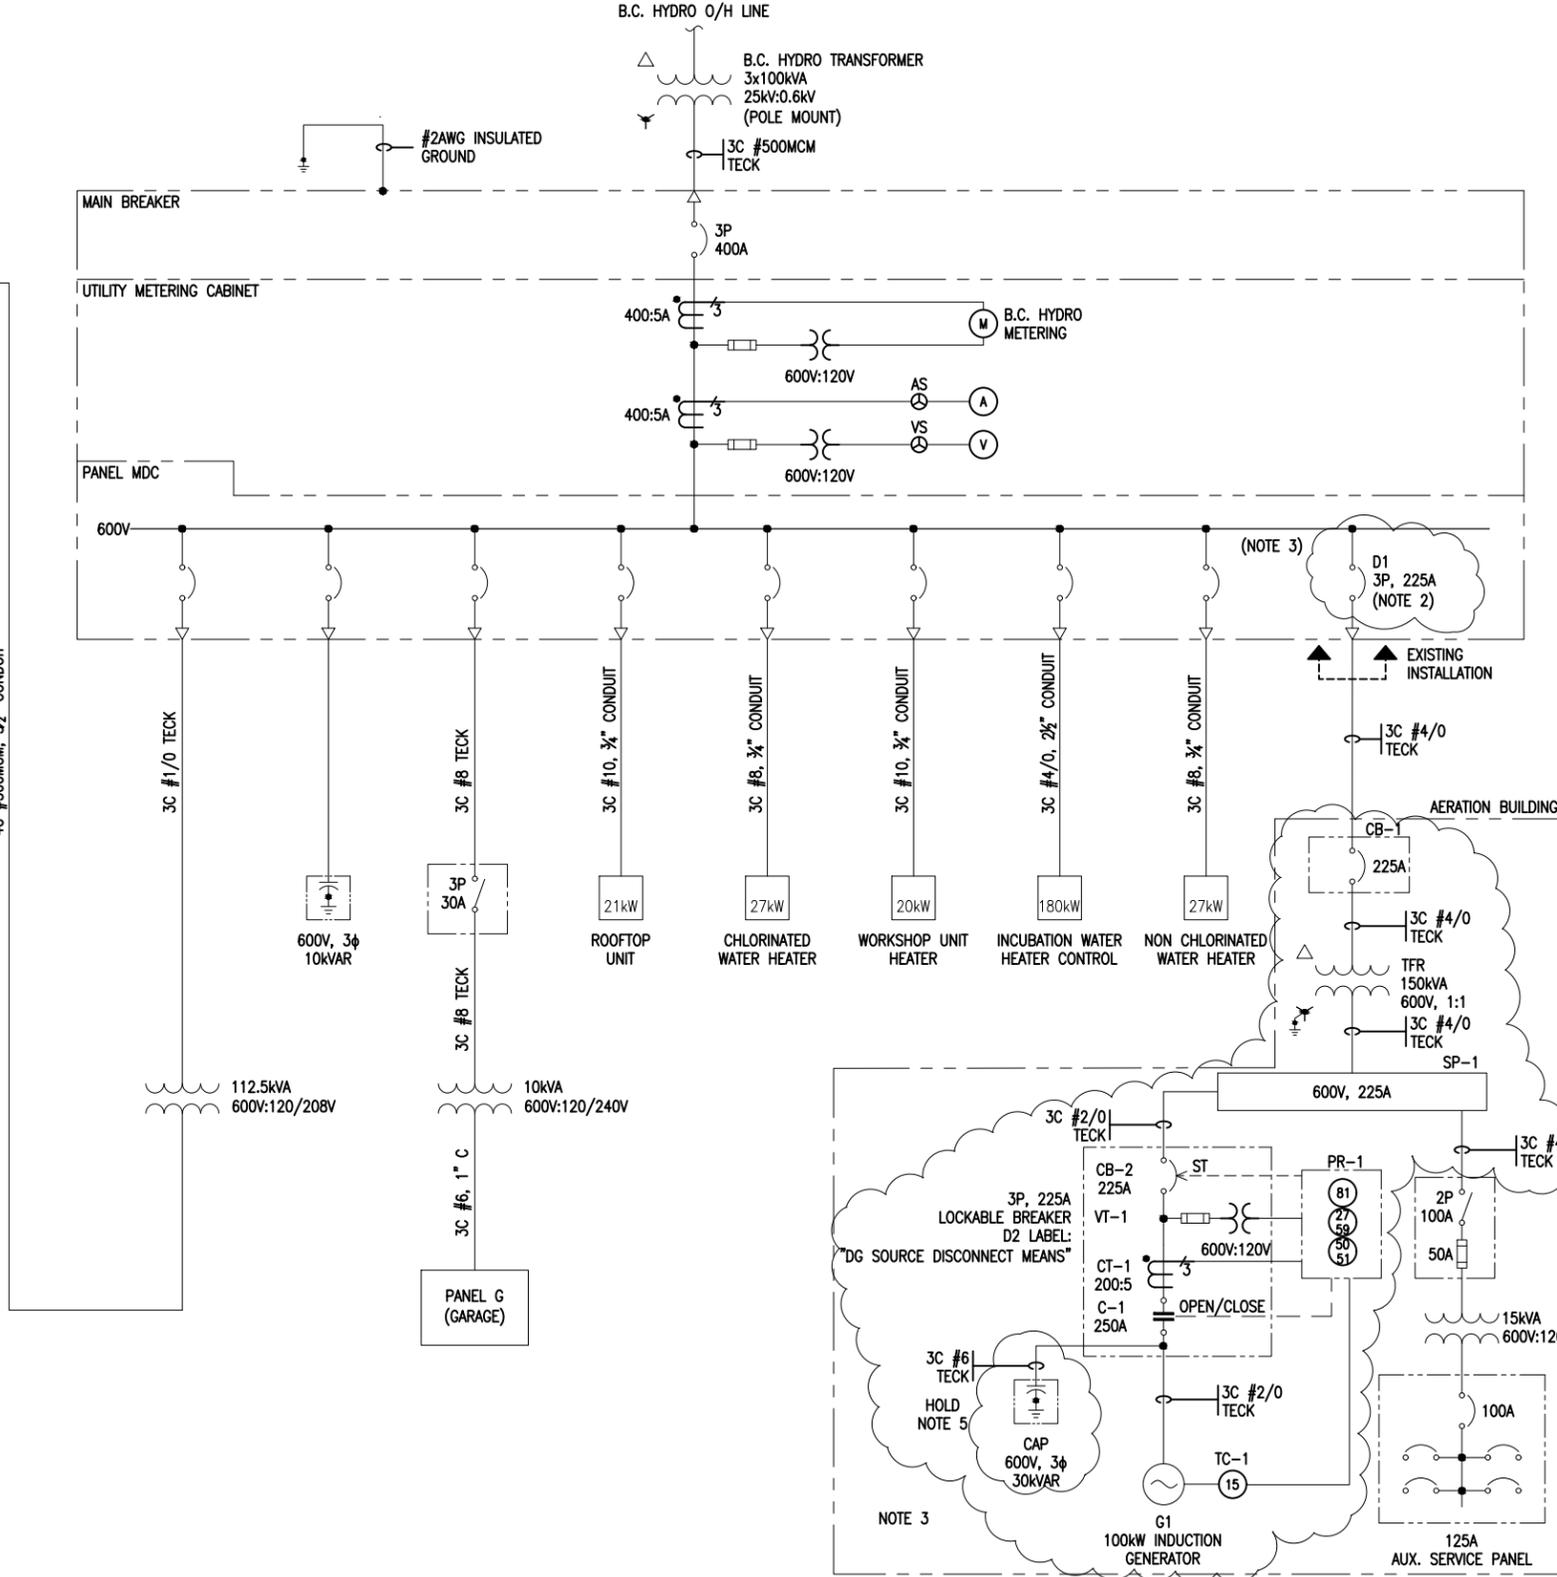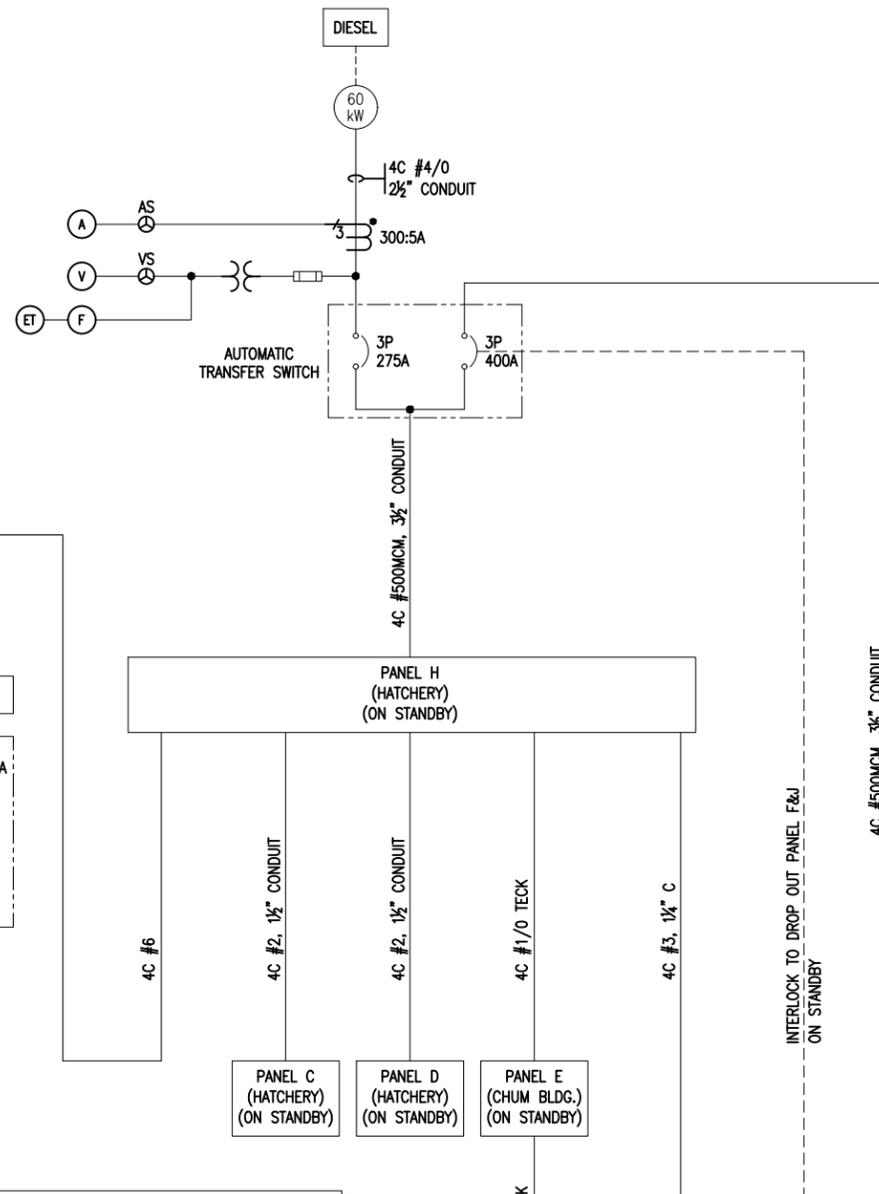

**BILL OF MATERIAL (NOTE 4)**

ITEM	DESCRIPTION	PART NUMBER (OR APPROVED EQUAL)
PR-1	SCHWEITZER SEL-710 PROTECTION RELAY	071001A1B1B71850200
CAP	600 V, 3P, 30KVAR CAPACITOR C/W NEMA 1 ENCLOSURE	ABB C605G30
CB-1	225 A CIRCUIT BREAKER C/W ENCLOSURE	SIEMENS FD63B225, RITTAL WM201608NC SIEMENS CRHOFVD
CB-2	ENCLOSURE (CSA CERTIFICATION REQUIRED)	RITTAL WALL-MOUNT, NEMA 1
C-1	225 A LOCKABLE BREAKER C/W SHUNT TRIP	SIEMENS FD63B225, SIEMENS CRHOFVD
CT-1	200 HP CONTACTOR, NEMA SIZE 5	SIEMENS 40LP32AF
VT-1	200:5A CURRENT XFMRS, 600:120V INSTRUMENT XFMRS	GE 180SHT-201, HPS SP100ACP
SP-1	36" SPLITTER; 600 V, 225 A	
TFR	150 kVA 600:600V (1:1) DRY TYPE TRANSFORMER; DELTA-WYE SOLIDLY GROUNDED, NEMA 2	HAMMOND, DELTA, EATON
UPS	3000 VA UPS, 120/240V INPUT/OUTPUT	ALPHA TECHNOLOGIES CFR3000

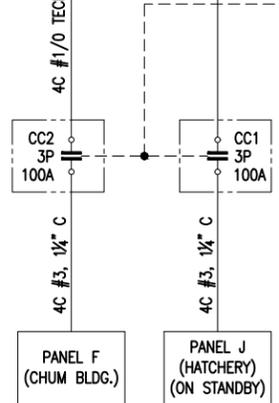

1. THE INFORMATION CONTAINED IN THESE DRAWINGS FOR THE EXISTING INSTALLATION IS BASED ON THE ORIGINAL PROJECT DRAWINGS (DWG 31-6-289). DESIGN AND CALCULATION ARE BY OTHERS.
2. NEW 3P, 225A LOCKABLE CIRCUIT BREAKER D1 LABEL "DG SYSTEM DISCONNECT MEANS".
3. NEW EQUIPMENT REQUIRED FOR NET METERING GENERATION PROJECT SHOWN INSIDE REVISION CLOUD.
4. BILL OF MATERIALS ITEMS MAY BE SUBSTITUTED WITH EQUIVALENT PRODUCTS WITH APPROVAL FROM OWNER OR ENGINEER.
5. POWER FACTOR CORRECTION CAPACITOR TO BE FINALIZED AFTER PUMP (PAT) MODEL HAS BEEN DETERMINED.
6. INSTALLATION TO COMPLY WITH ALL REQUIREMENTS OF CEC-22.1-15
7. ALL CONDUCTORS ARE SIZED BASED ON 90°C AMPACITY. IF EQUIPMENT IS MARKED WITH A LOWER "MAXIMUM CONDUCTOR TERMINATION TEMPERATURE", THEN THE CABLE MUST BE SIZED IN ACCORDANCE WITH C22.1 FOR THAT TEMPERATURE

NO.	DATE	REVISIONS
F	15-NOV-2016	ADDED UPS TO BOM
E	09-NOV-2016	REVISED TO 100KW FOR TENDER
D	05-MAY-2016	REVISED FOR TENDER
C	31-MAR-2016	ISSUED FOR TENDER
B	17-MAR-2016	UPDATED EQUIPMENT DETAILS
A	25-MAR-2016	ISSUED FOR REVIEW

DESIGNED	RD
DRAWN	RB
CHECKED	RD
RECOMMENDED	
APPROVED	


**FISHERIES AND OCEANS CANADA**  
REAL PROPERTY AND TECHNICAL SUPPORT

**PUNTLEDGE RIVER HATCHERY**  
**WATER SUPPLY ENERGY RECOVERY**  
**HATCHERY AND AERATION BUILDINGS**  
**SINGLE LINE DIAGRAM**


SCALE	N.T.S.
DATE	31-MAR-2016
DRAWING NUMBER	E-001
REVISION	F

Plotted by: Billy Daulton, Plot date: 16-Nov-16 Path: \\nas001\c\Users\B.Daulton\Documents\Projects\2016\2016\_Puntledge\_River\_Hatchery\_Energy\_Recovery\Drawings\11116\_E001 - E001\_Puntledge\_River\_Hatchery\_Energy\_Recovery.dwg Size: 44444


**PRELIMINARY**  
NOT FOR CONSTRUCTION

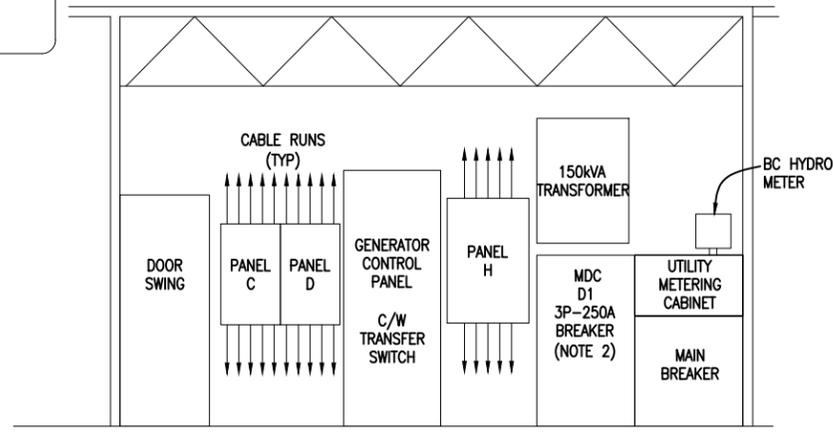


ELEVATION-MECHANICAL ROOM - WEST WALL  
SCALE: N.T.S

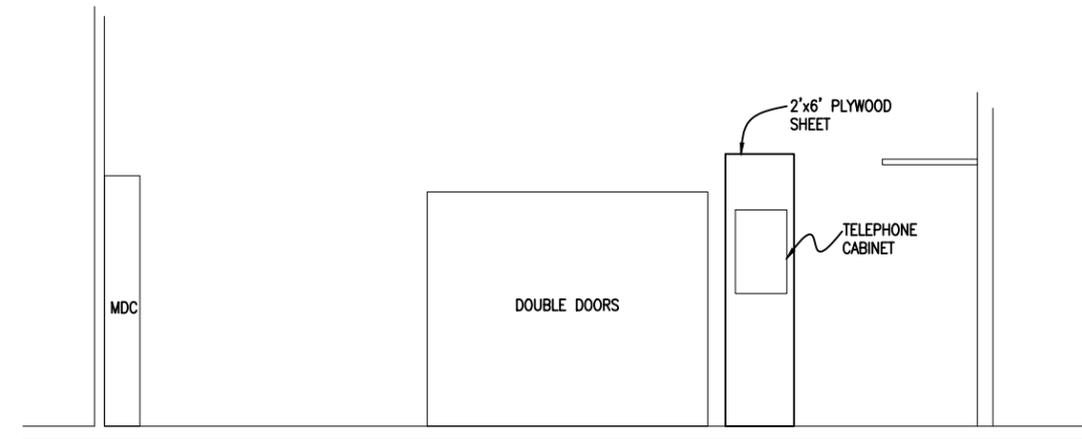


ELEVATION-MECHANICAL ROOM - NORTH WALL  
SCALE: N.T.S

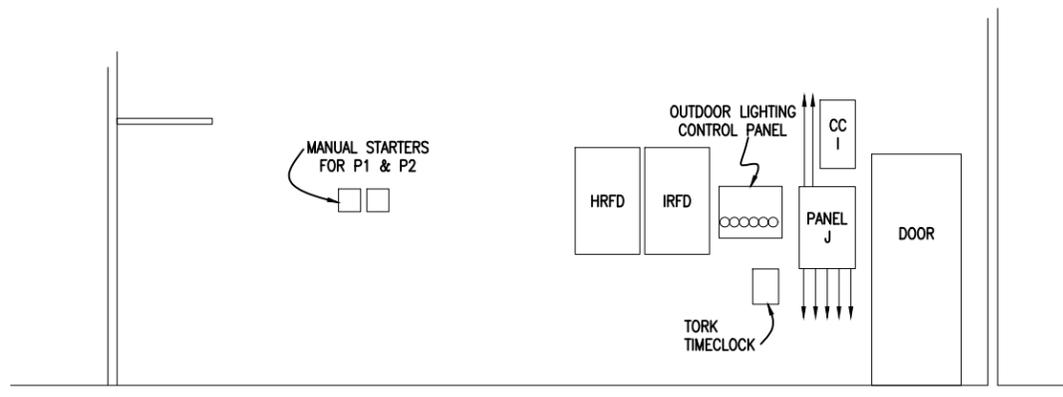

ELEVATION-MECHANICAL ROOM - SOUTH WALL  
SCALE: N.T.S

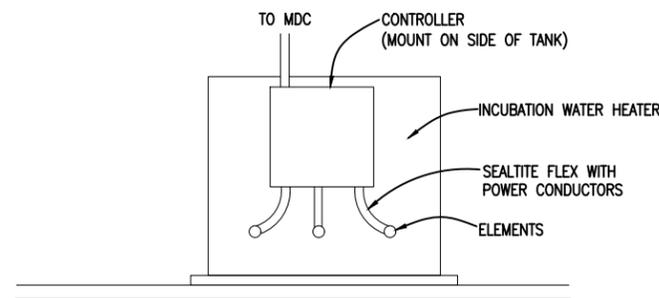

ELEVATION-INCUBATION WATER HEATER  
SCALE: N.T.S

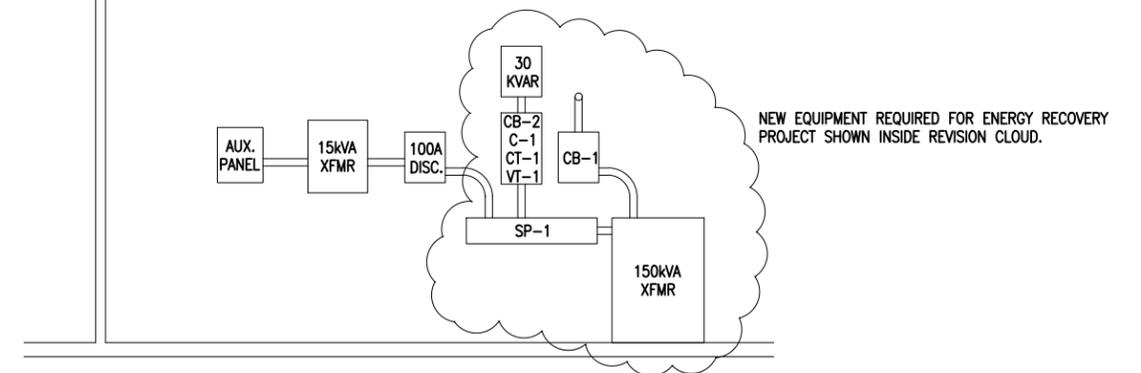

ELEVATION-AERATION ELECTRICAL (STORAGE ROOM)  
SCALE: N.T.S

Plotted by: Billy Daulton, Plot date: 16-Nov-16 Path: /Users/maas/S/Projects/Victoria/WFO/1608/Puntledge Energy Recovery Facility/08 Drawings/STS Drawings/161116 E-001 - E009 Puntledge.dwg Size: 444444

1. THE INFORMATION CONTAINED IN THESE DRAWINGS FOR THE EXISTING INSTALLATION IS BASED ON THE ORIGINAL PROJECT DRAWINGS (DWG 31-6-289). DESIGN AND CALCULATION ARE BY OTHERS.
2. NEW 3P, 250A, LOCKABLE CIRCUIT BREAKER INSTALLED IN EXISTING 'MDC' FEEDER PANEL LABELLED AS 'DG SYSTEM DISCONNECT MEANS'

NO.	DATE	REVISIONS
D	09-NOV-2016	REVISED FOR TENDER
C	05-MAY-2016	REVISED FOR TENDER
B	31-MAR-2016	ISSUED FOR TENDER
A	11-FEB-2016	ISSUED FOR REVIEW

**StruthersTECH**  
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DESIGNED	RD
DRAWN	RB
CHECKED	RD
RECOMMENDED	
APPROVED	
APPROVED	

**FISHERIES AND OCEANS CANADA**  
REAL PROPERTY AND TECHNICAL SUPPORT

**PUNTLEDGE RIVER HATCHERY**  
**WATER SUPPLY ENERGY RECOVERY**  
**ELECTRICAL**  
**HATCHERY AND AERATION BUILDINGS**  
**WALL ELEVATIONS**

SCALE	N.T.S
DATE	31-MAR-16
DRAWING NUMBER	E-002
REVISION	D









DWG. NO. DRAWING REFERENCES

NOTES

NO. DATE REVISIONS

REVISION D

**PRELIMINARY**  
NOT FOR CONSTRUCTION

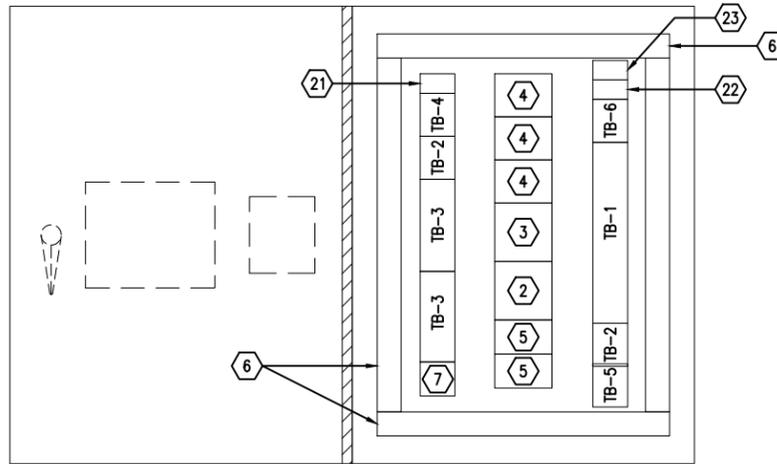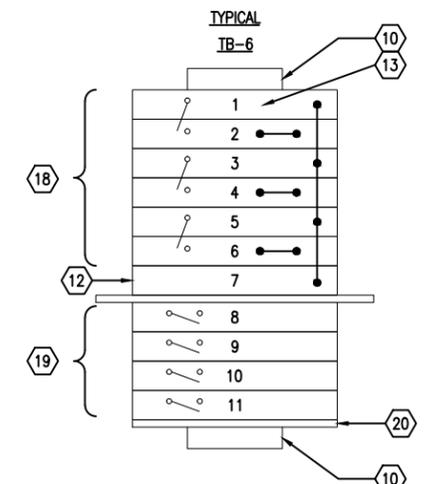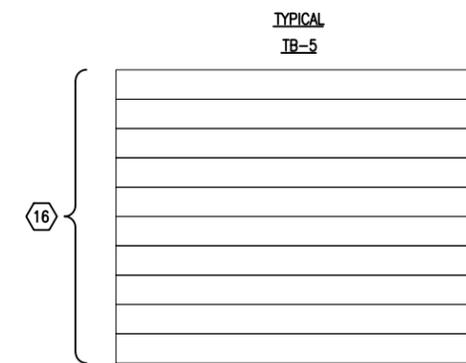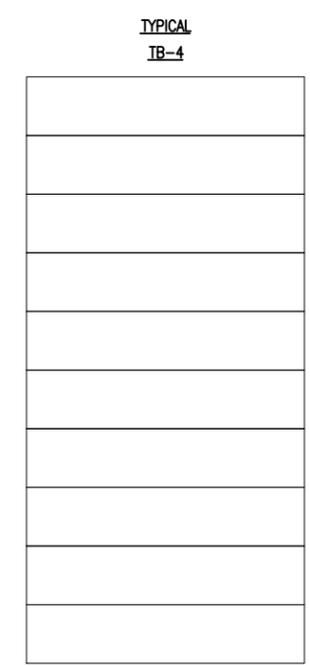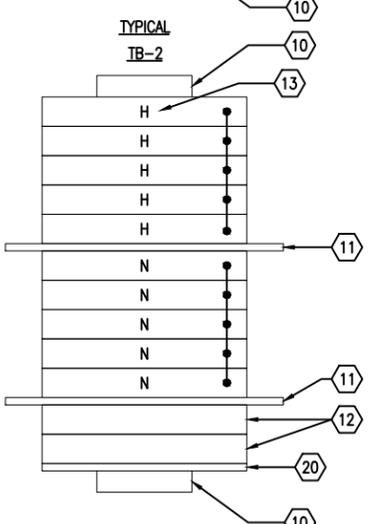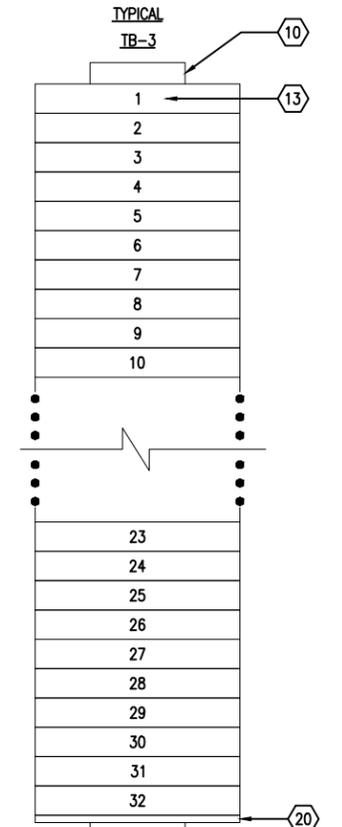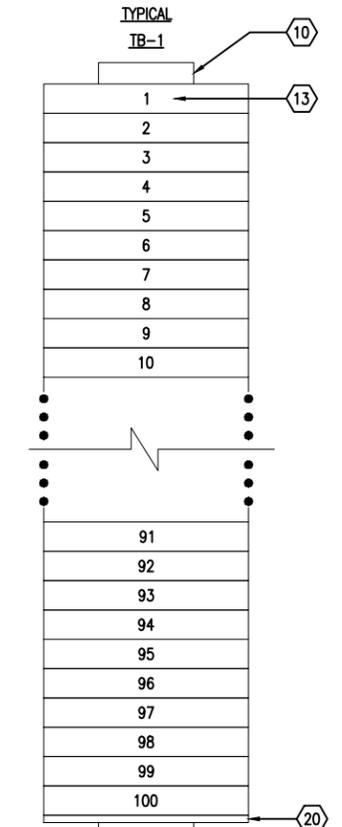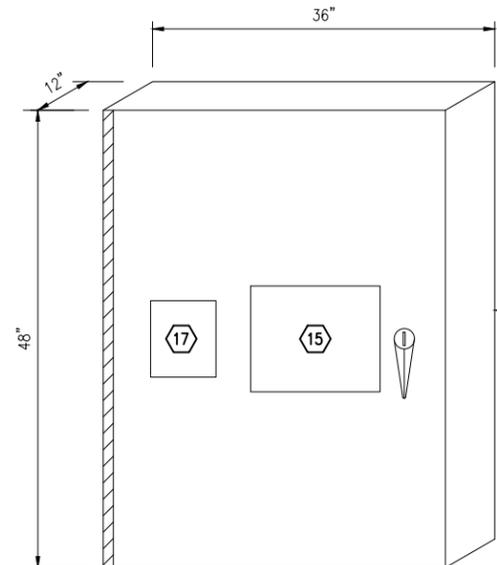

BILL OF MATERIAL		
ITEM	DESCRIPTION	PART NUMBER
1	WALL MOUNT HOFFMAN NEMA 12 ENCLOSURE	A48H36DLP3PT
2	SCHNEIDER SCADAPACK3Q	PBUP4B-102-01-1-1
3	SCHNEIDER DIGITAL I/O EXPANSION	MODULE 5402
4	SCHNEIDER DIFFERENTIAL ANALOG INPUTS	MODULE 5502
5	30W POWER SUPPLY 24VDC	QUINT-PS/3AC/24VDC/40
6	3x4 PANDUIT	F3X4LG6
7	DUPLIX RECEPTACLE 125VAC, 20A	HBL420HR
8	PHOENIX CONTACT FEED-THROUGH TERMINAL BLOCK (SPRING CAGE CONNECTION) AND FUSED TERMINAL BLOCKS	3031212, 3036369
9	PHOENIX CONTACT DISCONNECT TERMINAL BLOCK	3035140
10	PHOENIX CONTACT END CLAMP	1201675
11	PHOENIX CONTACT SEPARATE PLATE	0701105
12	PHOENIX CONTACT GROUND TERMINAL BLOCK	3212202
13	PHOENIX CONTACT TERMINAL BLOCK LABELS	0805807
14	FERRAZ SHAWMUT FUSE HOLDER 1 POLE	USCC11
15	15" PANELMOUNT PC C/W TOUCHSCREEN	ADVANTECH PPC-3150
16	PHOENIX CONTACT INTERPOSING RELAY 24 VDC	2900320
17	SEL-710 PROTECTION RELAY	071001A1B1B71850200
18	PHOENIX CONTACT SHORTING TEST DISCONNECT TERMINAL BLOCK	3212300
19	PHOENIX CONTACT ISOLATING TEST DISCONNECT TERMINAL BLOCK	3046456
20	PHOENIX CONTACT END COVER	3047141
21	MOORE INDUSTRIES SST ISOLATOR SPLITTER	SST / 4-20MA / 4-20MA / 12-42DC / -2HART [DIN]
22	TACHOMETER	Ai-Tek INSTRUMENTS TACHPAK30 T77530
23	VOLTAGE MONITOR	TIMEMARK 16-1-H-S

1. ALL BILL OF MATERIALS ITEMS MAY BE REPLACED WITH AN EQUIVALENT ITEM EXCEPT ITEMS 2, 3, 4, & 21. (SCADAPACK 32, ITS EXPANSION MODULES, & ANALOG SPLITTERS) WITH APPROVAL FROM OWNER OR ENGINEER.

C	15-NOV-2016	REVISED BOM FOR TENDER
B	31-MAR-2016	ISSUED FOR TENDER
A	08-MAR-2016	ISSUED FOR REVIEW



**FISHERIES AND OCEANS CANADA**  
REAL PROPERTY AND TECHNICAL SUPPORT

**PUNTLEDGE RIVER HATCHERY**  
**WATER SUPPLY ENERGY RECOVERY**  
**ELECTRICAL**  
**AERATION BUILDING**  
**CONTROL CABINET LAYOUT**

SCALE	N.T.S.
DATE	31-MAR-16
DRAWING NUMBER	E-003
REVISION	C


Plotted by: Billy Daulton, Plot date: 16-Nov-16 Path: \\resources\S\Calista\GPO\1608\_Puntledge\_Energy\_Recovery\_Facility\3D\_Drawings\3D\_Drawings\161116\_E001 - E003\_Puntledge\_Elec\_Sizes.dwg

DWG. NO. DRAWING REFERENCES

NOTES

NO. DATE REVISIONS

DESIGNED  
JRB  
DRAWN  
SK  
CHECKED  
JRB  
RECOMMENDED  
APPROVED  
APPROVED

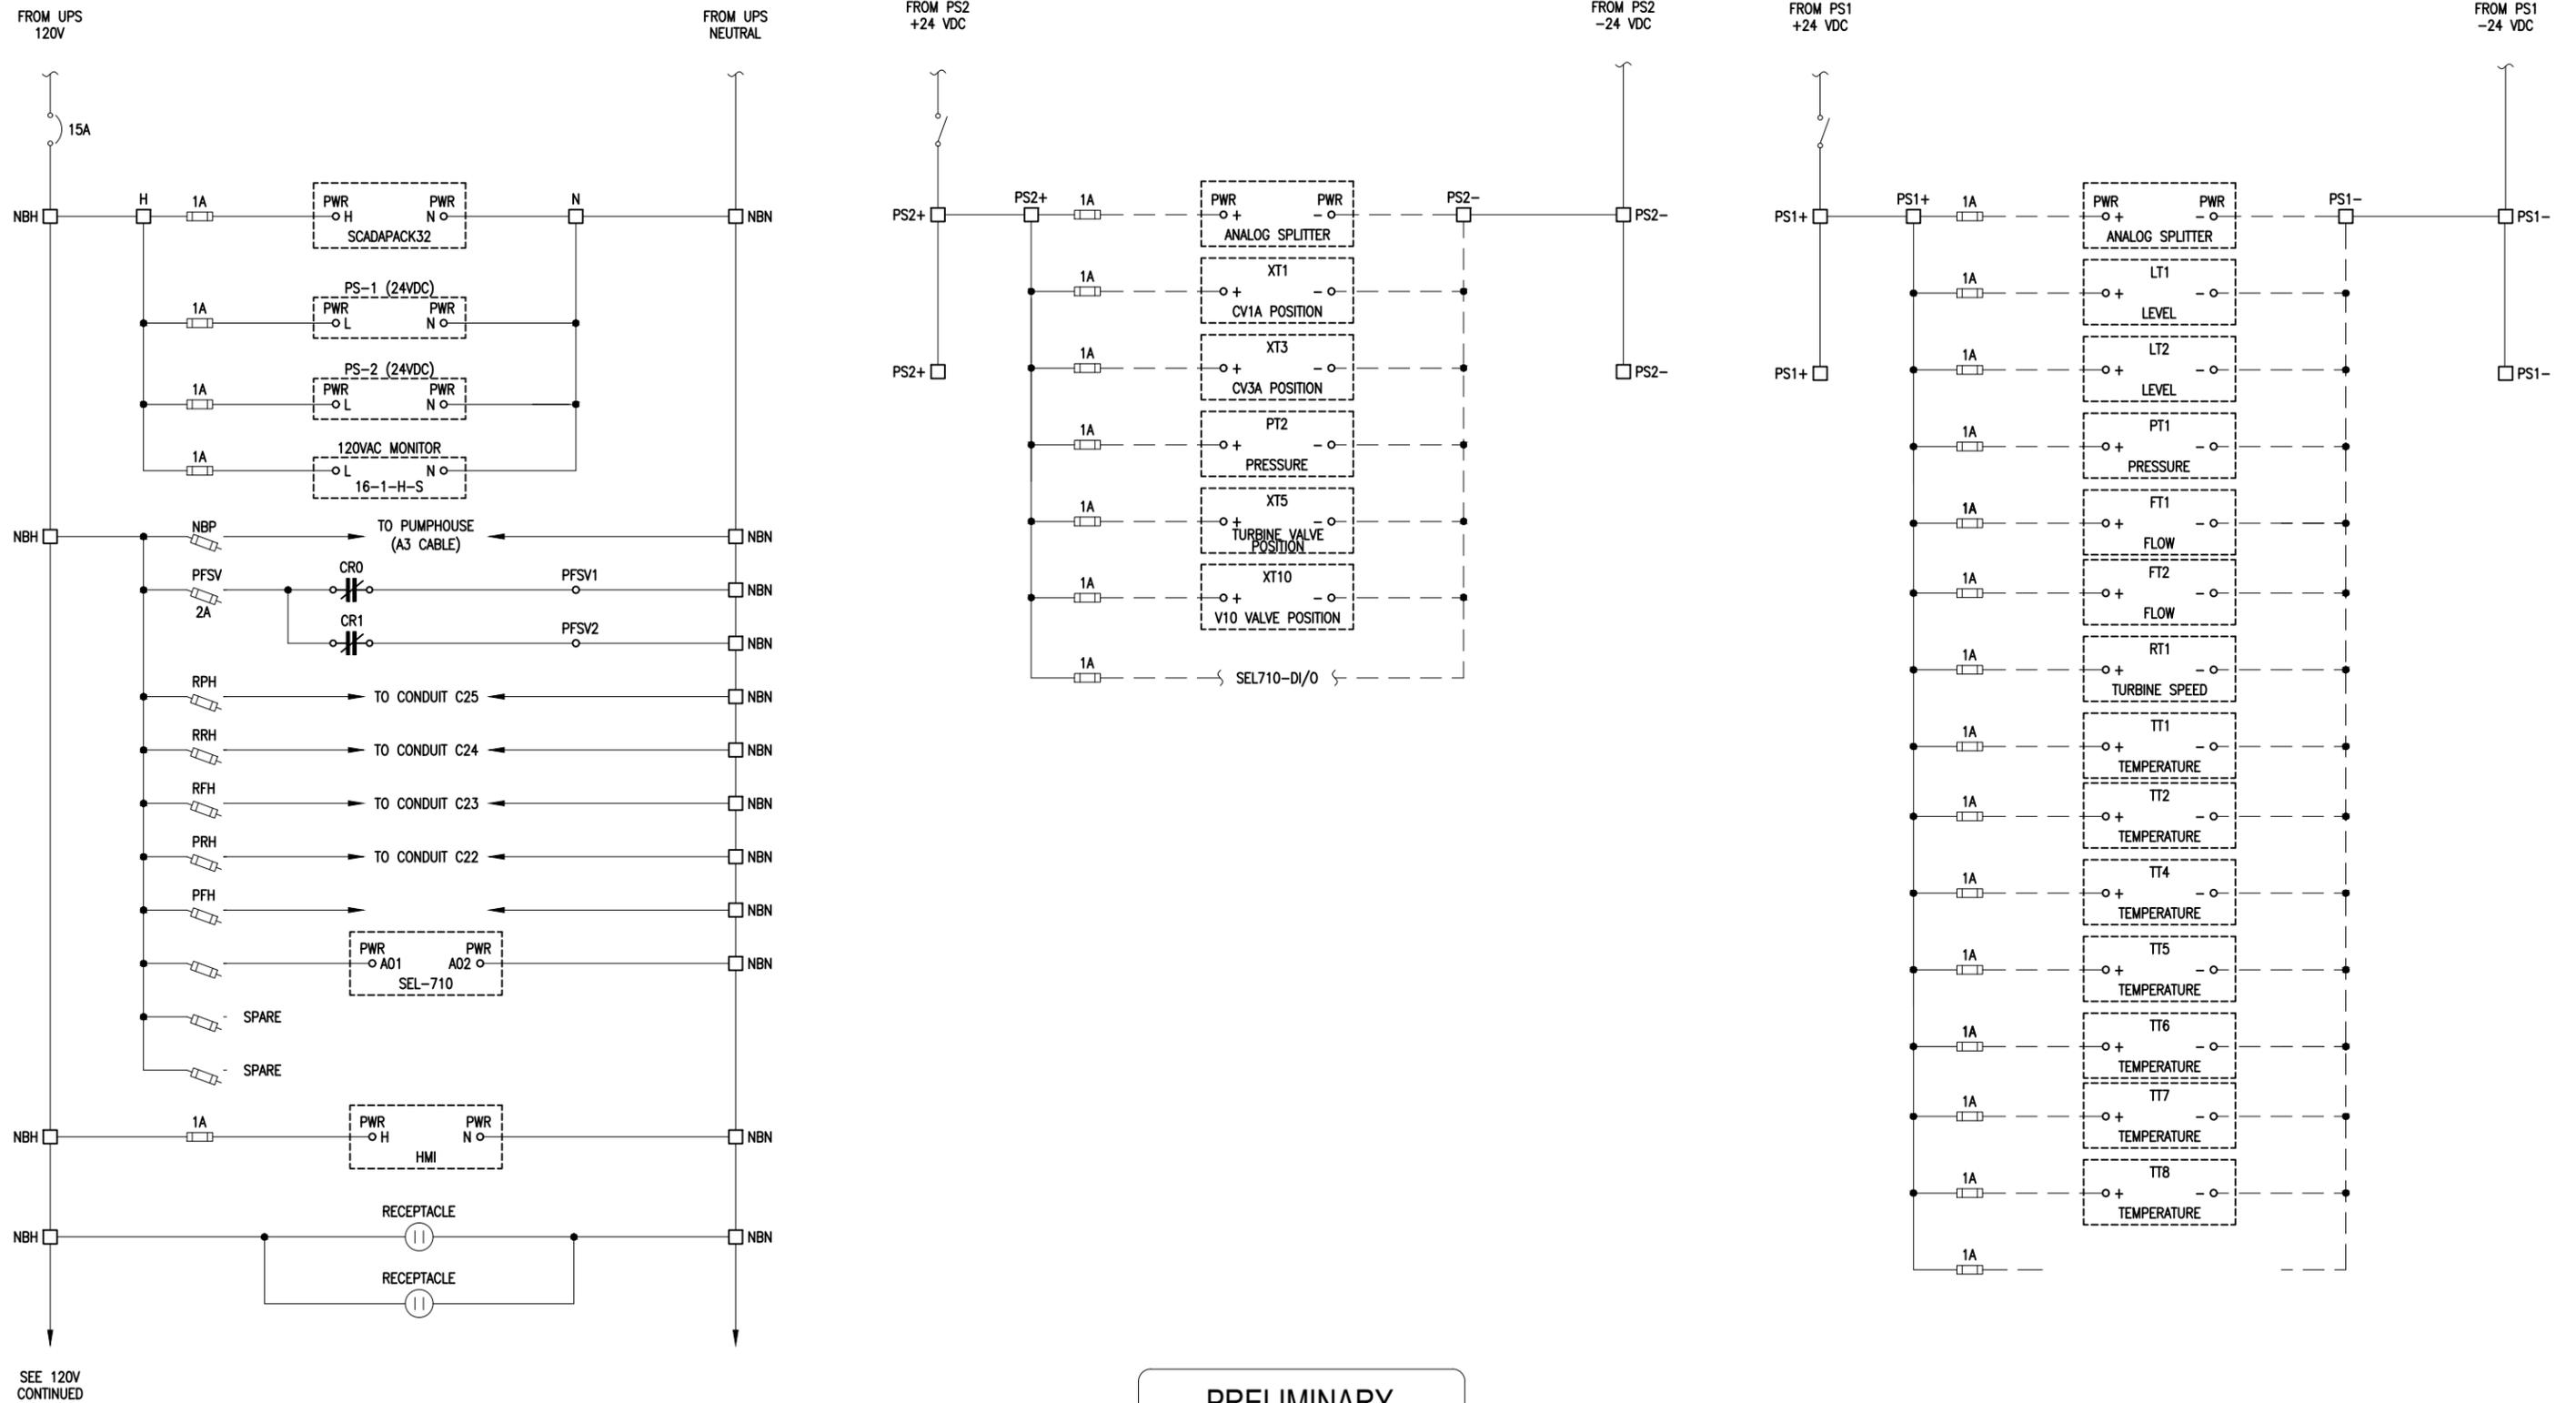

SEE 120V CONTINUED

PRELIMINARY  
NOT FOR CONSTRUCTION



**FISHERIES AND OCEANS CANADA**  
REAL PROPERTY AND TECHNICAL SUPPORT

**PUNTLEDGE RIVER HATCHERY  
WATER SUPPLY ENERGY RECOVERY  
ELECTRICAL  
AERATION BUILDING  
CONTROL CABINET-POWER**


SCALE	N.T.S.
DATE	31-MAR-16
DRAWING NUMBER	E-004
REVISION	E

NO.	DATE	REVISIONS
E	16-NOV-2016	ADDED UPS
D	09-NOV-2016	REVISED FOR TENDER
C	05-MAY-2016	ADDED TACHOMETER
B	31-MAR-2016	ISSUED FOR TENDER
A	08-MAR-2016	ISSUED FOR REVIEW

DWG. NO.	DRAWING REFERENCES	NOTES

Plotted by: Billy Daulton, Plot date: 16-Nov-16 Path: \\msname01\Users\B.Daulton\Public\Projects\2016\2016\_Puntledge\_Energy\_Recovery\_Facility\08\_Drawing\STS\_Drawing\161116\_E001 - E004\_Puntledge\_Eng\_Sas.dwg

DIGITAL INPUTS

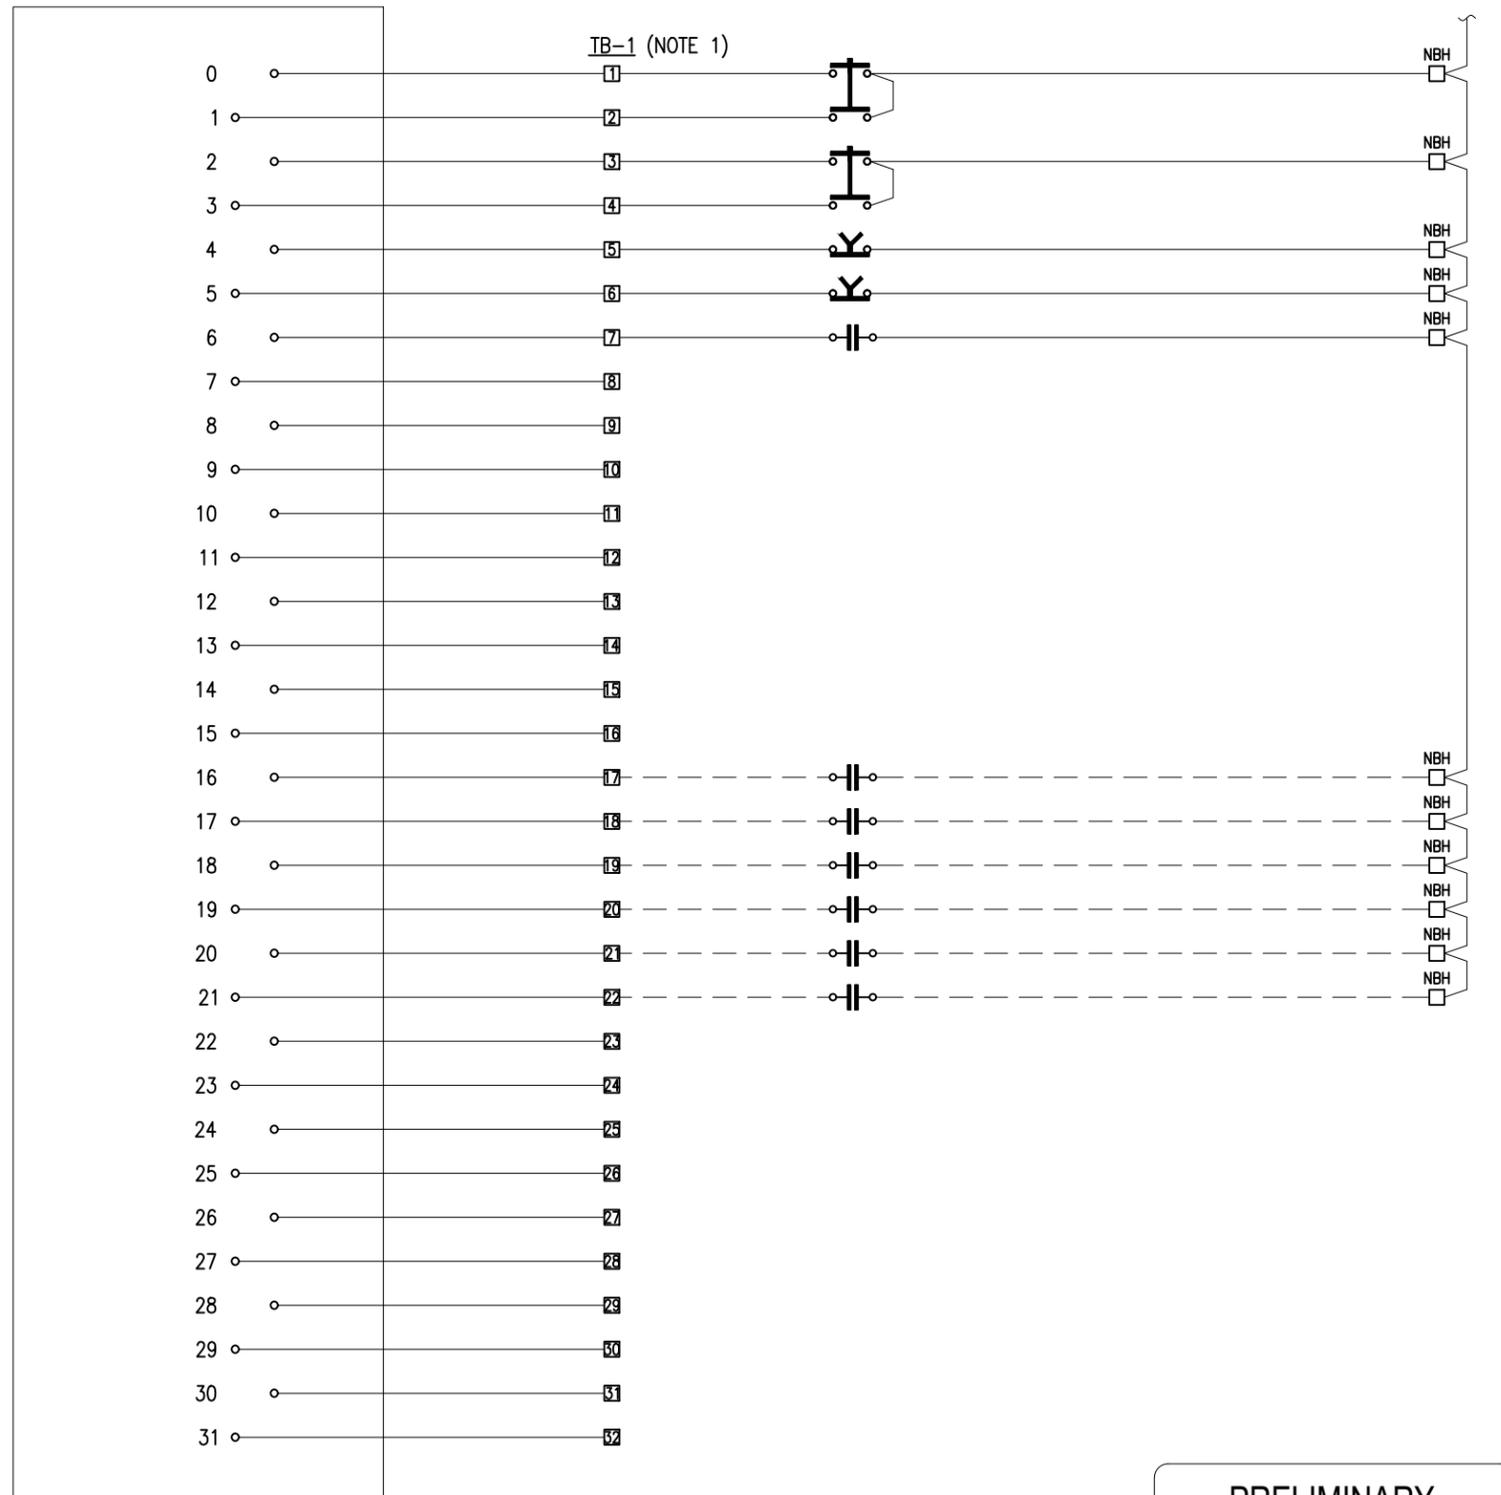

FROM UPS  
120V

LEGEND:  
□ - TERMINAL BLOCK

- CV3A - 8" VALVE AUTO MODE
- CV3A - 8" VALVE MANUAL MODE
- CV1A - 12" VALVE AUTO MODE
- CV1A - 12" VALVE MANUAL MODE
- SELECT POSITION FOR V10 OPEN/CLOSE
- LEAD VALVE SELECTOR - CV1A (10") OR CV3A (12")
- SEL-710 'ALARM'
- SPARE
- V10 - VALVE OPEN POSITION
- V10 - VALVE CLOSED POSITION
- TURBINE CONTROL VALVE - OPEN POSITION
- TURBINE CONTROL VALVE - CLOSED POSITION
- V8 - VALVE OPEN POSITION
- V8 - VALVE CLOSED POSITION
- SPARE

SCADARACK\_32  
PBUP4B-102-01-1-1


PRELIMINARY  
NOT FOR CONSTRUCTION



FISHERIES AND OCEANS CANADA  
REAL PROPERTY AND TECHNICAL SUPPORT

DWG. NO.	DRAWING REFERENCES	NOTES	NO.	DATE	REVISIONS	DESIGNED JRB	SCALE N.T.S.
						DRAWN RB	
		1. SEE DWG E-003 TYPICAL TB-3 FOR LAYOUT IN PANEL	E	16-NOV-16	ADDED UPS	CHECKED JRB	DRAWING NUMBER E-005
			D	09-NOV-2016	REVISED FOR TENDER	RECOMMENDED	REVISION
			C	05-MAY-2016	REVISED FOR TENDER	APPROVED	
			B	31-MAR-2016	ISSUED FOR TENDER	APPROVED	
			A	08-MAR-2016	ISSUED FOR REVIEW	APPROVED	

DIGITAL OUTPUTS

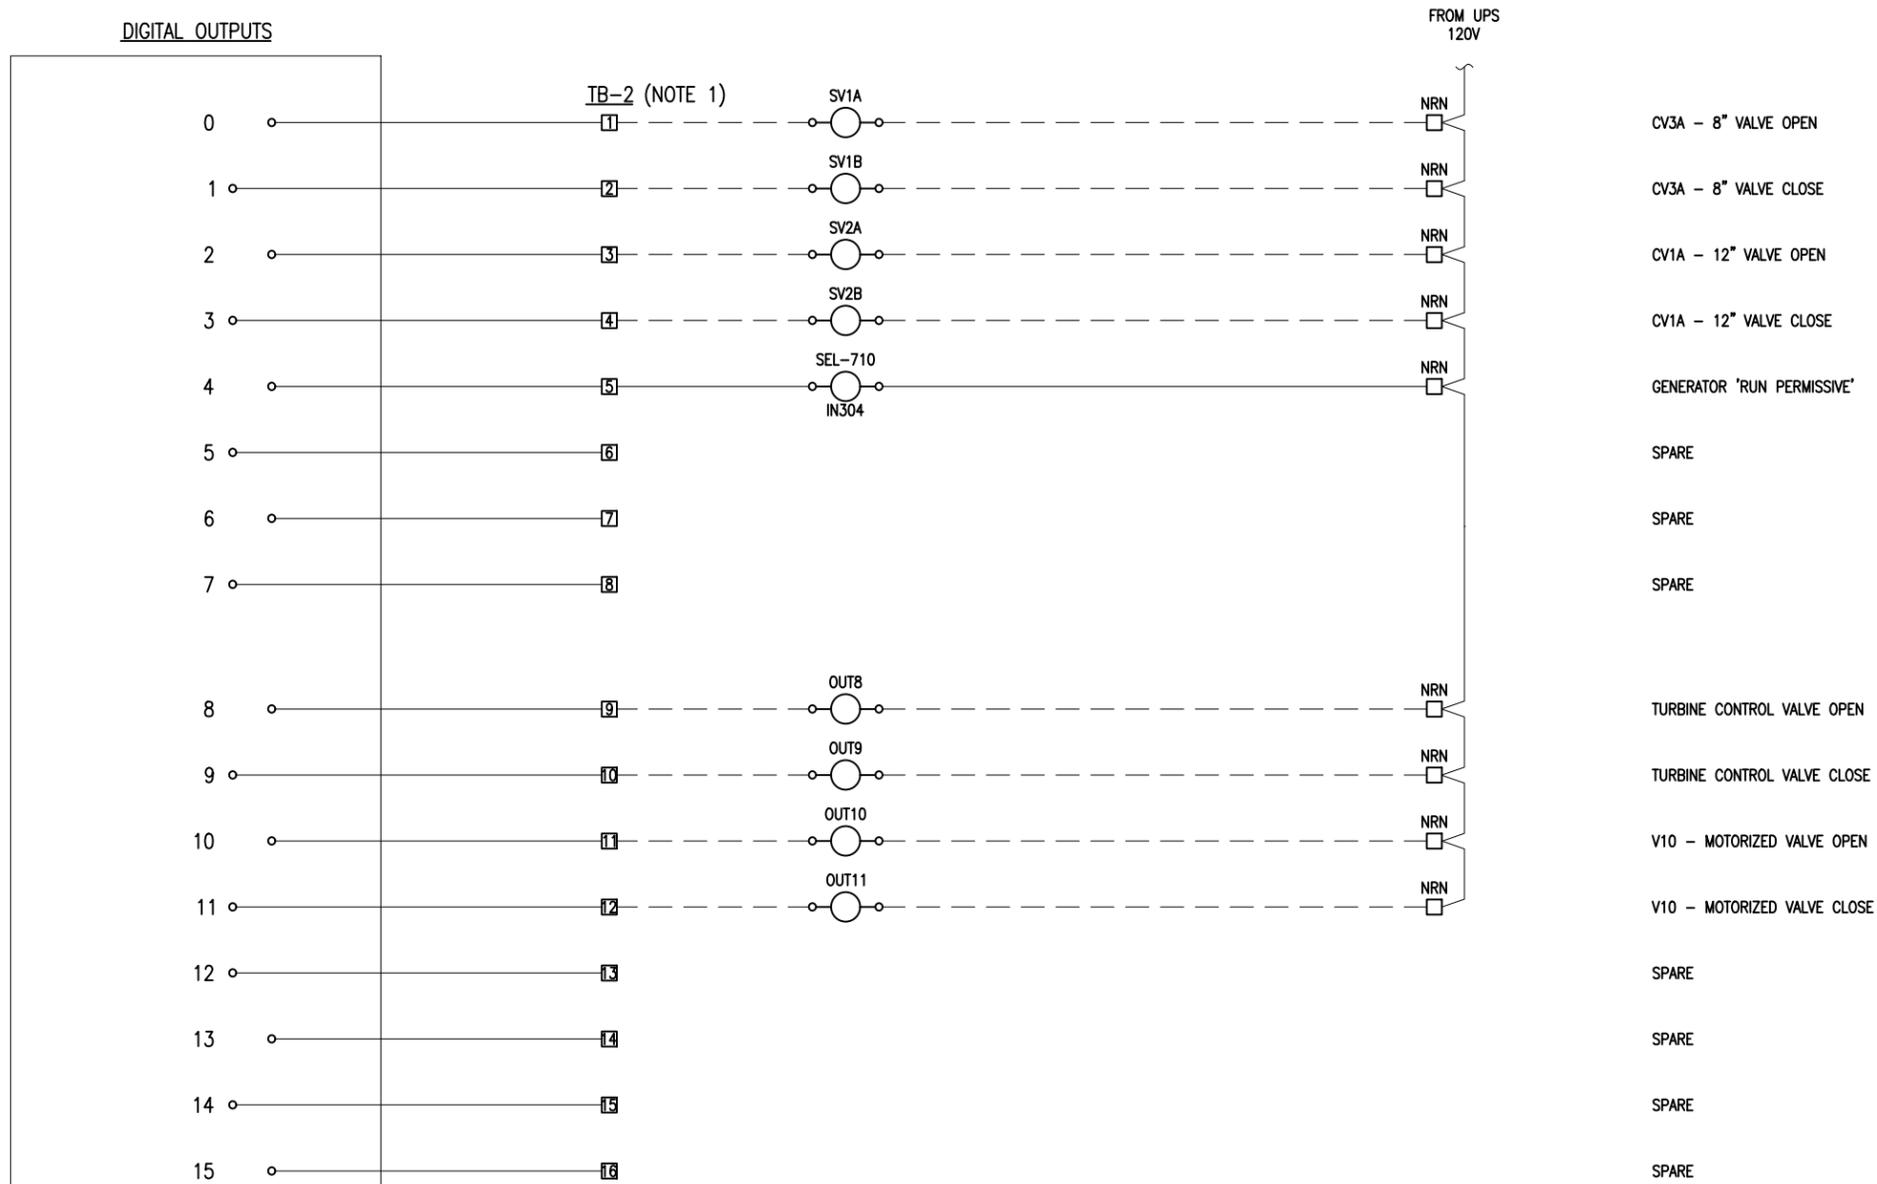

LEGEND:  
 □ - TERMINAL BLOCK

SCADARACK\_32  
 PBUP4B-102-01-1-1

PRELIMINARY  
 NOT FOR CONSTRUCTION



FISHERIES AND OCEANS CANADA  
 REAL PROPERTY AND TECHNICAL SUPPORT

PUNTLEDGE RIVER HATCHERY  
 WATER SUPPLY ENERGY RECOVERY  
 ELECTRICAL  
 AERATION BUILDING  
 CONTROL CABINET I/O-2


SCALE	N.T.S.
DATE	31-MAR-16
DRAWING NUMBER	E-006
REVISION	E

NO.	DATE	REVISIONS
E	16-NOV-2016	ADDED UPS
D	09-NOV-2016	REVISED FOR TENDER
C	05-MAY-2016	REVISED FOR TENDER
B	31-MAR-2016	ISSUED FOR TENDER
A	08-MAR-2016	ISSUED FOR REVIEW

1. SEE DWG E-003 TYPICAL TB-3 FOR LAYOUT IN PANEL

DWG. NO.	DRAWING REFERENCES	NOTES

CONFIGURABLE  
DIGITAL INPUTS/OUTPUTS

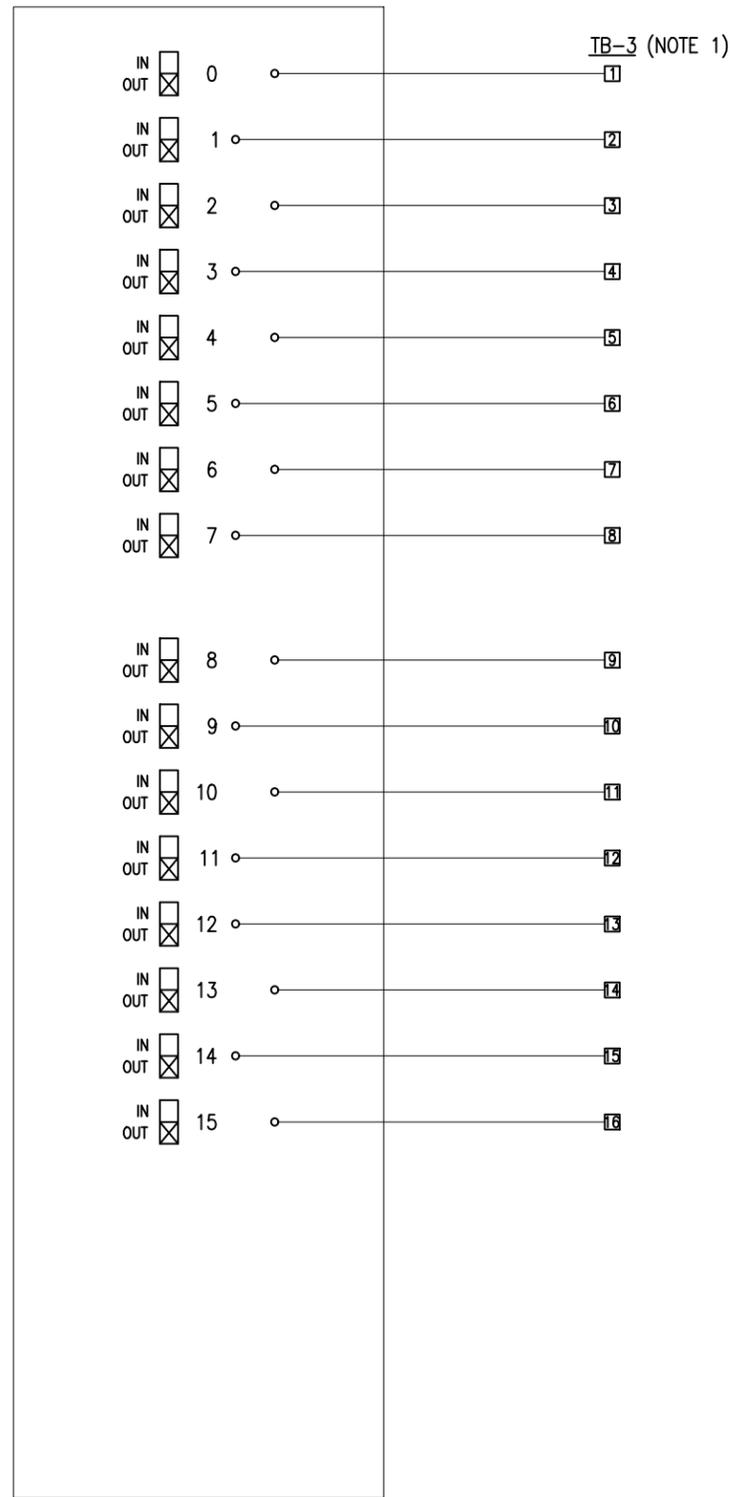

MODULE 5402

LEGEND:  
□ - TERMINAL BLOCK

SPARE  
SPARE


PRELIMINARY  
NOT FOR CONSTRUCTION

Plotted by: Billy Daulton, Plot date: 16-Mar-16 Path: \\msname01\c\Users\B\Documents\Projects\1608 Puntledge Energy Recovery Facility\08 Drawings\STS Drawings\161116 E-001 - E-008 Puntledge.dwg Size: 44444

DWG. NO.		DRAWING REFERENCES		NOTES		NO.		DATE		REVISIONS				 <b>FISHERIES AND OCEANS CANADA</b> REAL PROPERTY AND TECHNICAL SUPPORT		DESIGNED JRB DRAWN SK CHECKED JRB RECOMMENDED APPROVED APPROVED		SCALE N.T.S. DATE 31-MAR-16 DRAWING NUMBER E-007 REVISION B	
				1. SEE DWG E-003 TYPICAL TB-3 FOR LAYOUT IN PANEL		B		31-MAR-16		ISSUED FOR TENDER		PUNTLEDGE RIVER HATCHERY WATER SUPPLY ENERGY RECOVERY ELECTRICAL AERATION BUILDING CONTROL CABINET I/O-3							
						A		08-MAR-16		ISSUED FOR REVIEW									


CONTROL PANEL

DIFFERENTIAL ANALOG INPUTS


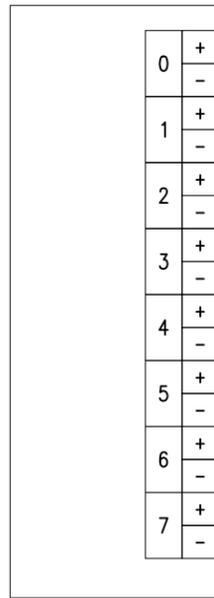


MODULE 5502

DIFFERENTIAL ANALOG INPUTS

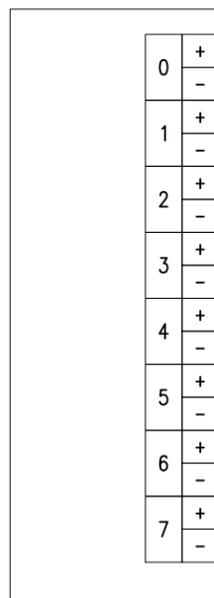


MODULE 5502

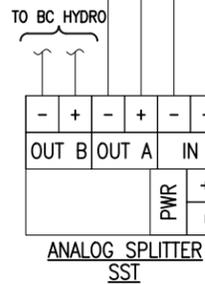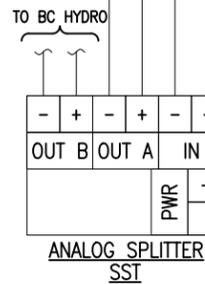

PS2 -24VDC +24VDC PS1 -24VDC +24VDC

TB-4 (NOTE 1)

FIELD

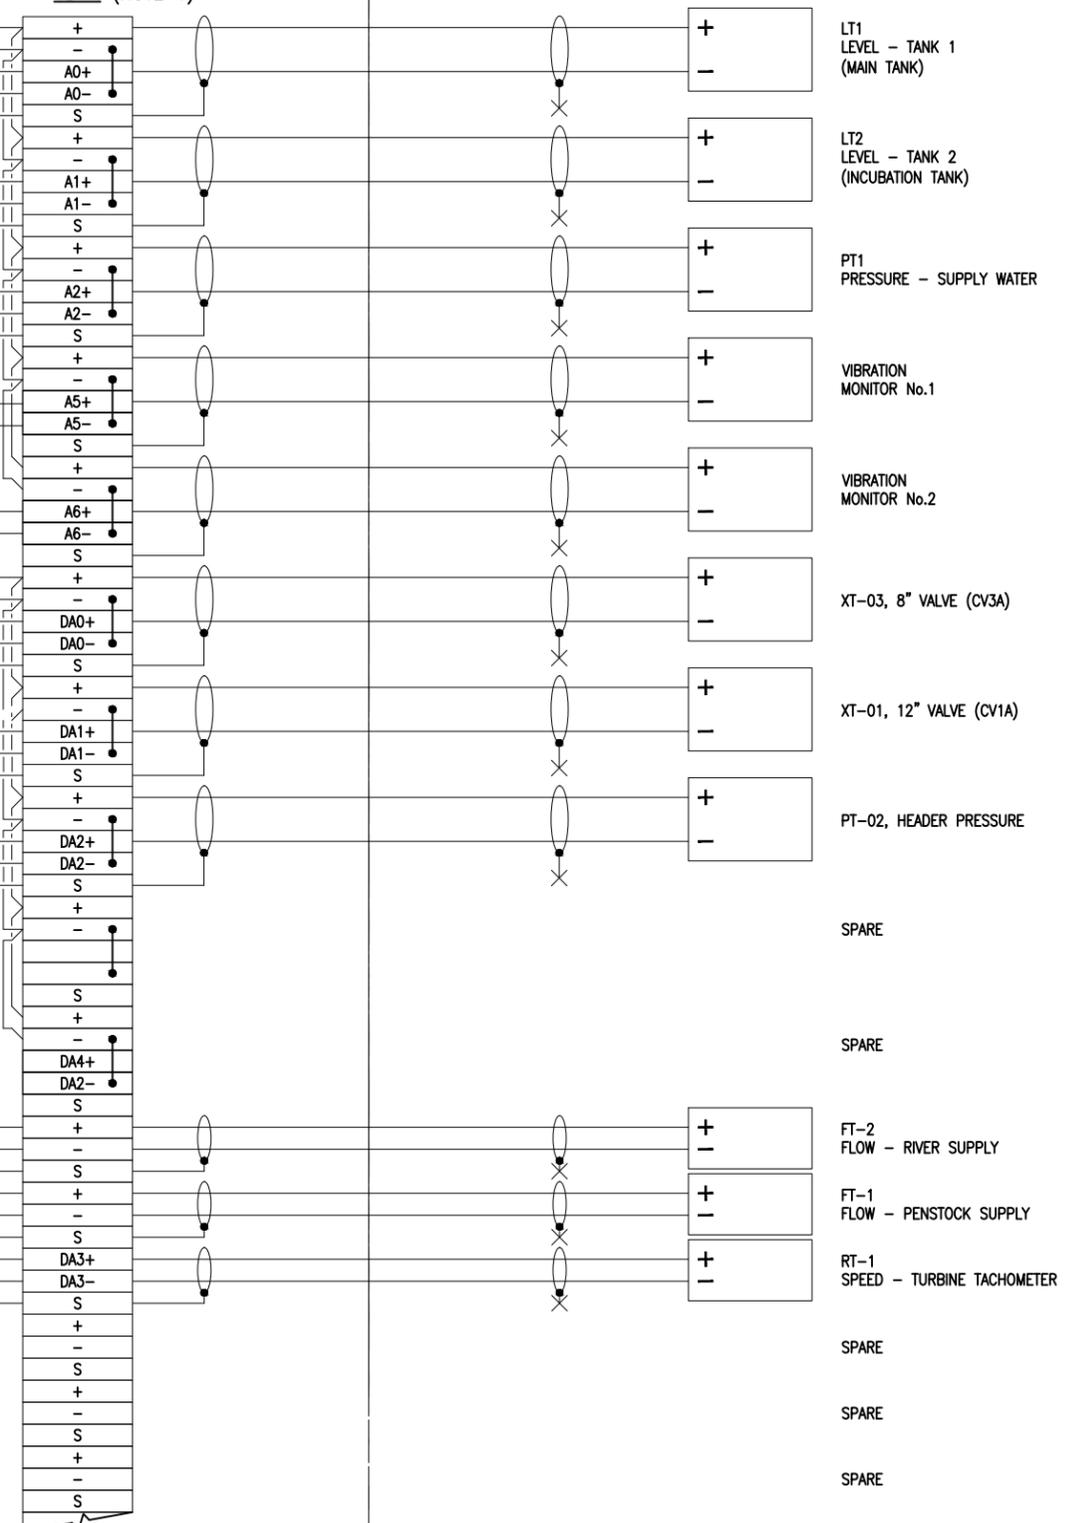

PRELIMINARY  
NOT FOR CONSTRUCTION



FISHERIES AND OCEANS CANADA  
REAL PROPERTY AND TECHNICAL SUPPORT

1. SEE DWG E-003 TYPICAL TB-1 FOR LAYOUT IN PANEL

D	09-NOV-2016	REVISED FOR TENDER
C	05-MAY-2016	ADDED VIBRATION MONITORS
B	31-MAR-2016	ISSUED FOR TENDER
A	08-MAR-2016	ISSUED FOR REVIEW

DESIGNED	JRB
DRAWN	SK
CHECKED	JRB
RECOMMENDED	
APPROVED	
APPROVED	


PUNTLEDGE RIVER HATCHERY  
WATER SUPPLY ENERGY RECOVERY  
ELECTRICAL  
AERATION BUILDING  
CONTROL CABINET I/O-4

SCALE	N.T.S.
DATE	31-MAR-16
DRAWING NUMBER	E-008
REVISION	D

Plotted by: Billy Daulton, Plot date: 16-Nov-16 Path: \\msname01\Users\B\Documents\Projects\1608\_Puntledge\_Energy\_Recovery\_Facility\08\_Drawing\STS\_Drawing\161116\_E001 - E008\_Puntledge\_Eng\_Sig.dwg

CONTROL PANEL

DIFFERENTIAL ANALOG INPUTS


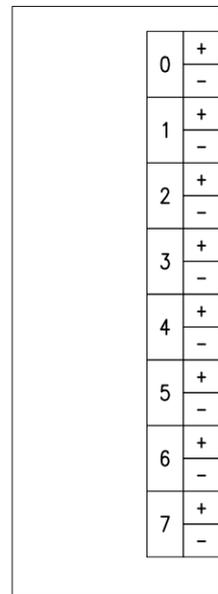


MODULE 5502

PS2 -24VDC +24VDC  
PS1 -24VDC +24VDC

TB-4

FIELD

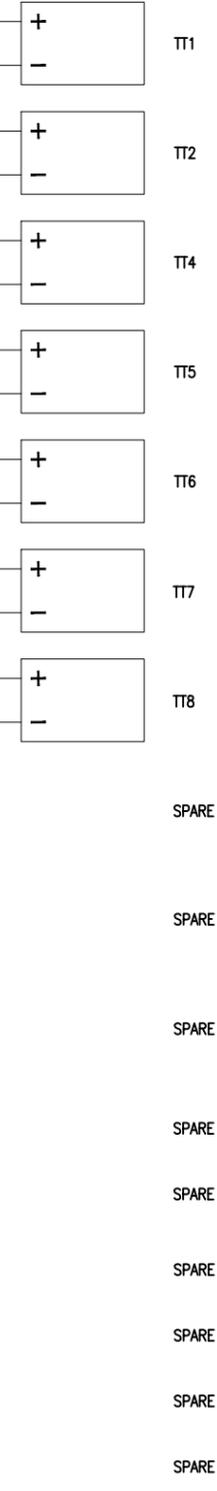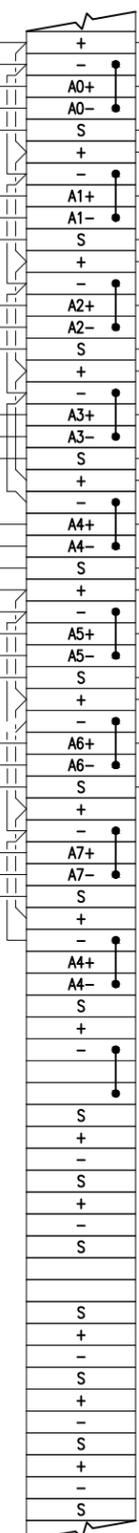

**PRELIMINARY**  
NOT FOR CONSTRUCTION



**FISHERIES AND OCEANS CANADA**  
REAL PROPERTY AND TECHNICAL SUPPORT





**PUNTLEDGE RIVER HATCHERY**  
**WATER SUPPLY ENERGY RECOVERY**  
**ELECTRICAL**  
**AERATION BUILDING**  
**CONTROL CABINET I/O-5**

SCALE	N.T.S.
DATE	31-MAR-16
DRAWING NUMBER	E-009
REVISION	C

NO.	DATE	REVISIONS
C	09-NOV-2016	REVISED FOR TENDER
B	31-MAR-2016	ISSUED FOR TENDER
A	18-MAR-2016	ISSUED FOR REVIEW

DWG. NO.	DRAWING REFERENCES	NOTES

Plotted by: Billy Daulton, Plot date: 18-Mar-16 Path: \\msname01\c\Users\B\Documents\Projects\1608 Puntledge Energy Recovery Facility\1608 Puntledge\161116 E001 - E009 Puntledge\161116 E001 - E009 Puntledge.dwg Size: 44444

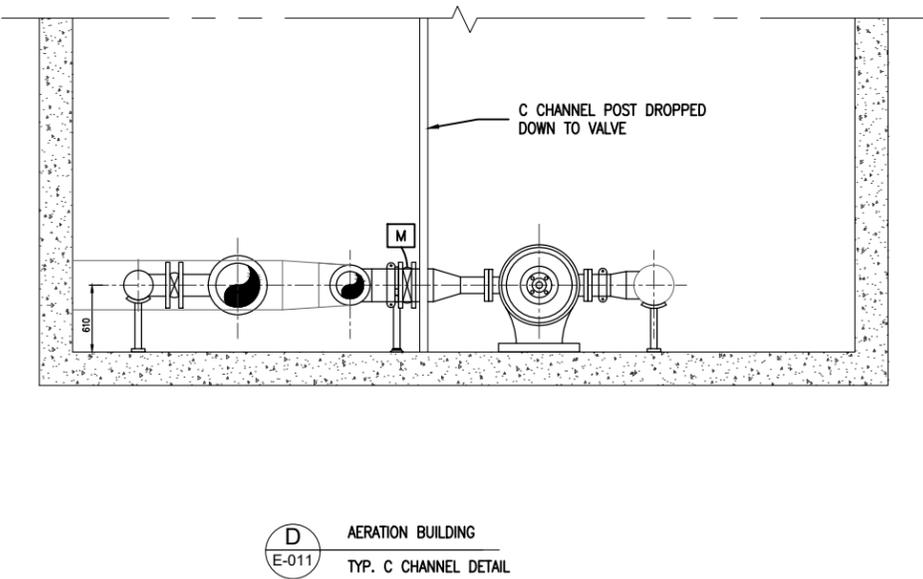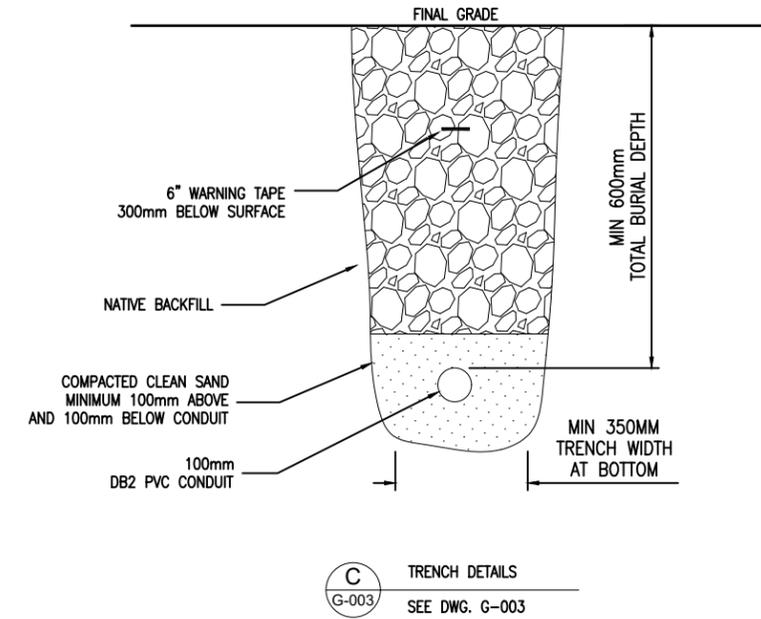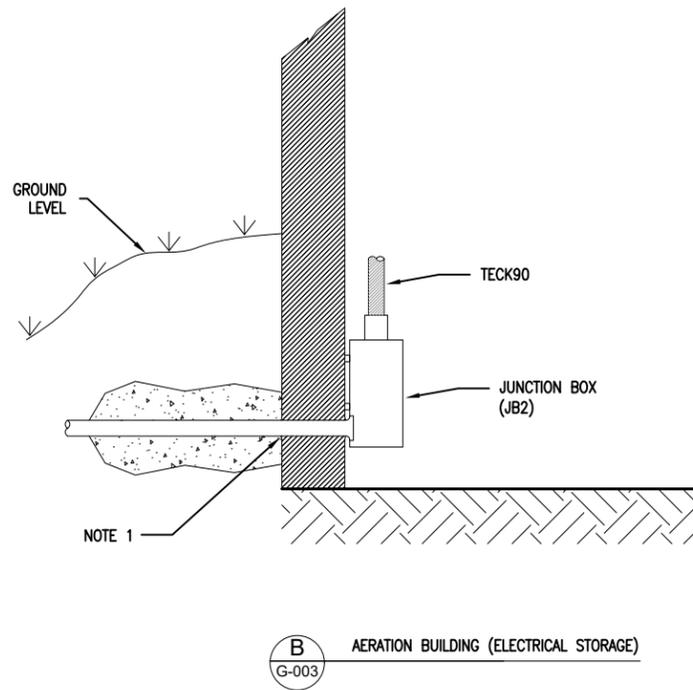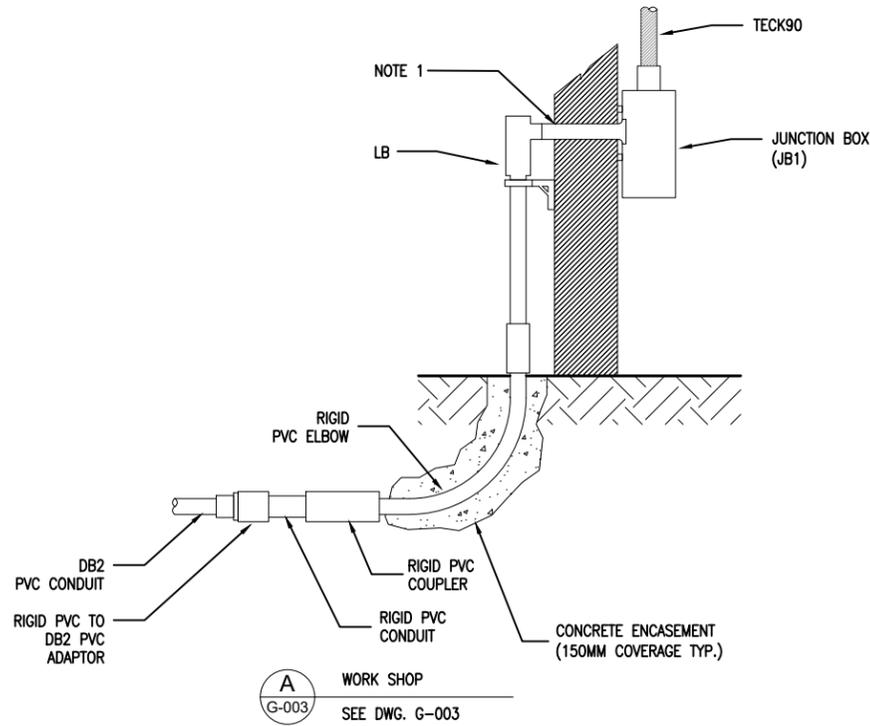

PRELIMINARY  
NOT FOR CONSTRUCTION

Plotted by: Billy Daulton Plot date: 18-Mar-2016 Path: \\msname01\Users\B.S. Valente\Projects\1808\_Puntledge\_Energy\_Recovery\_Facility\08\_Drawings\STS Drawings\18116 E-011 - E-011\_Puntledge.dwg Size: 44444

DWG. NO.	DRAWING REFERENCES

NO.	DATE	REVISIONS

1. CONDUIT ENTRANCE THROUGH BUILDING WALL MUST BE SEALED WATER TIGHT
2. INSTALLATION TO COMPLY WITH ALL REQUIREMENTS OF CEC-22.1-15

NO.	DATE	REVISIONS
B	31-MAR-2016	ISSUED FOR TENDER
A	18-MAR-2016	ISSUED FOR REVIEW



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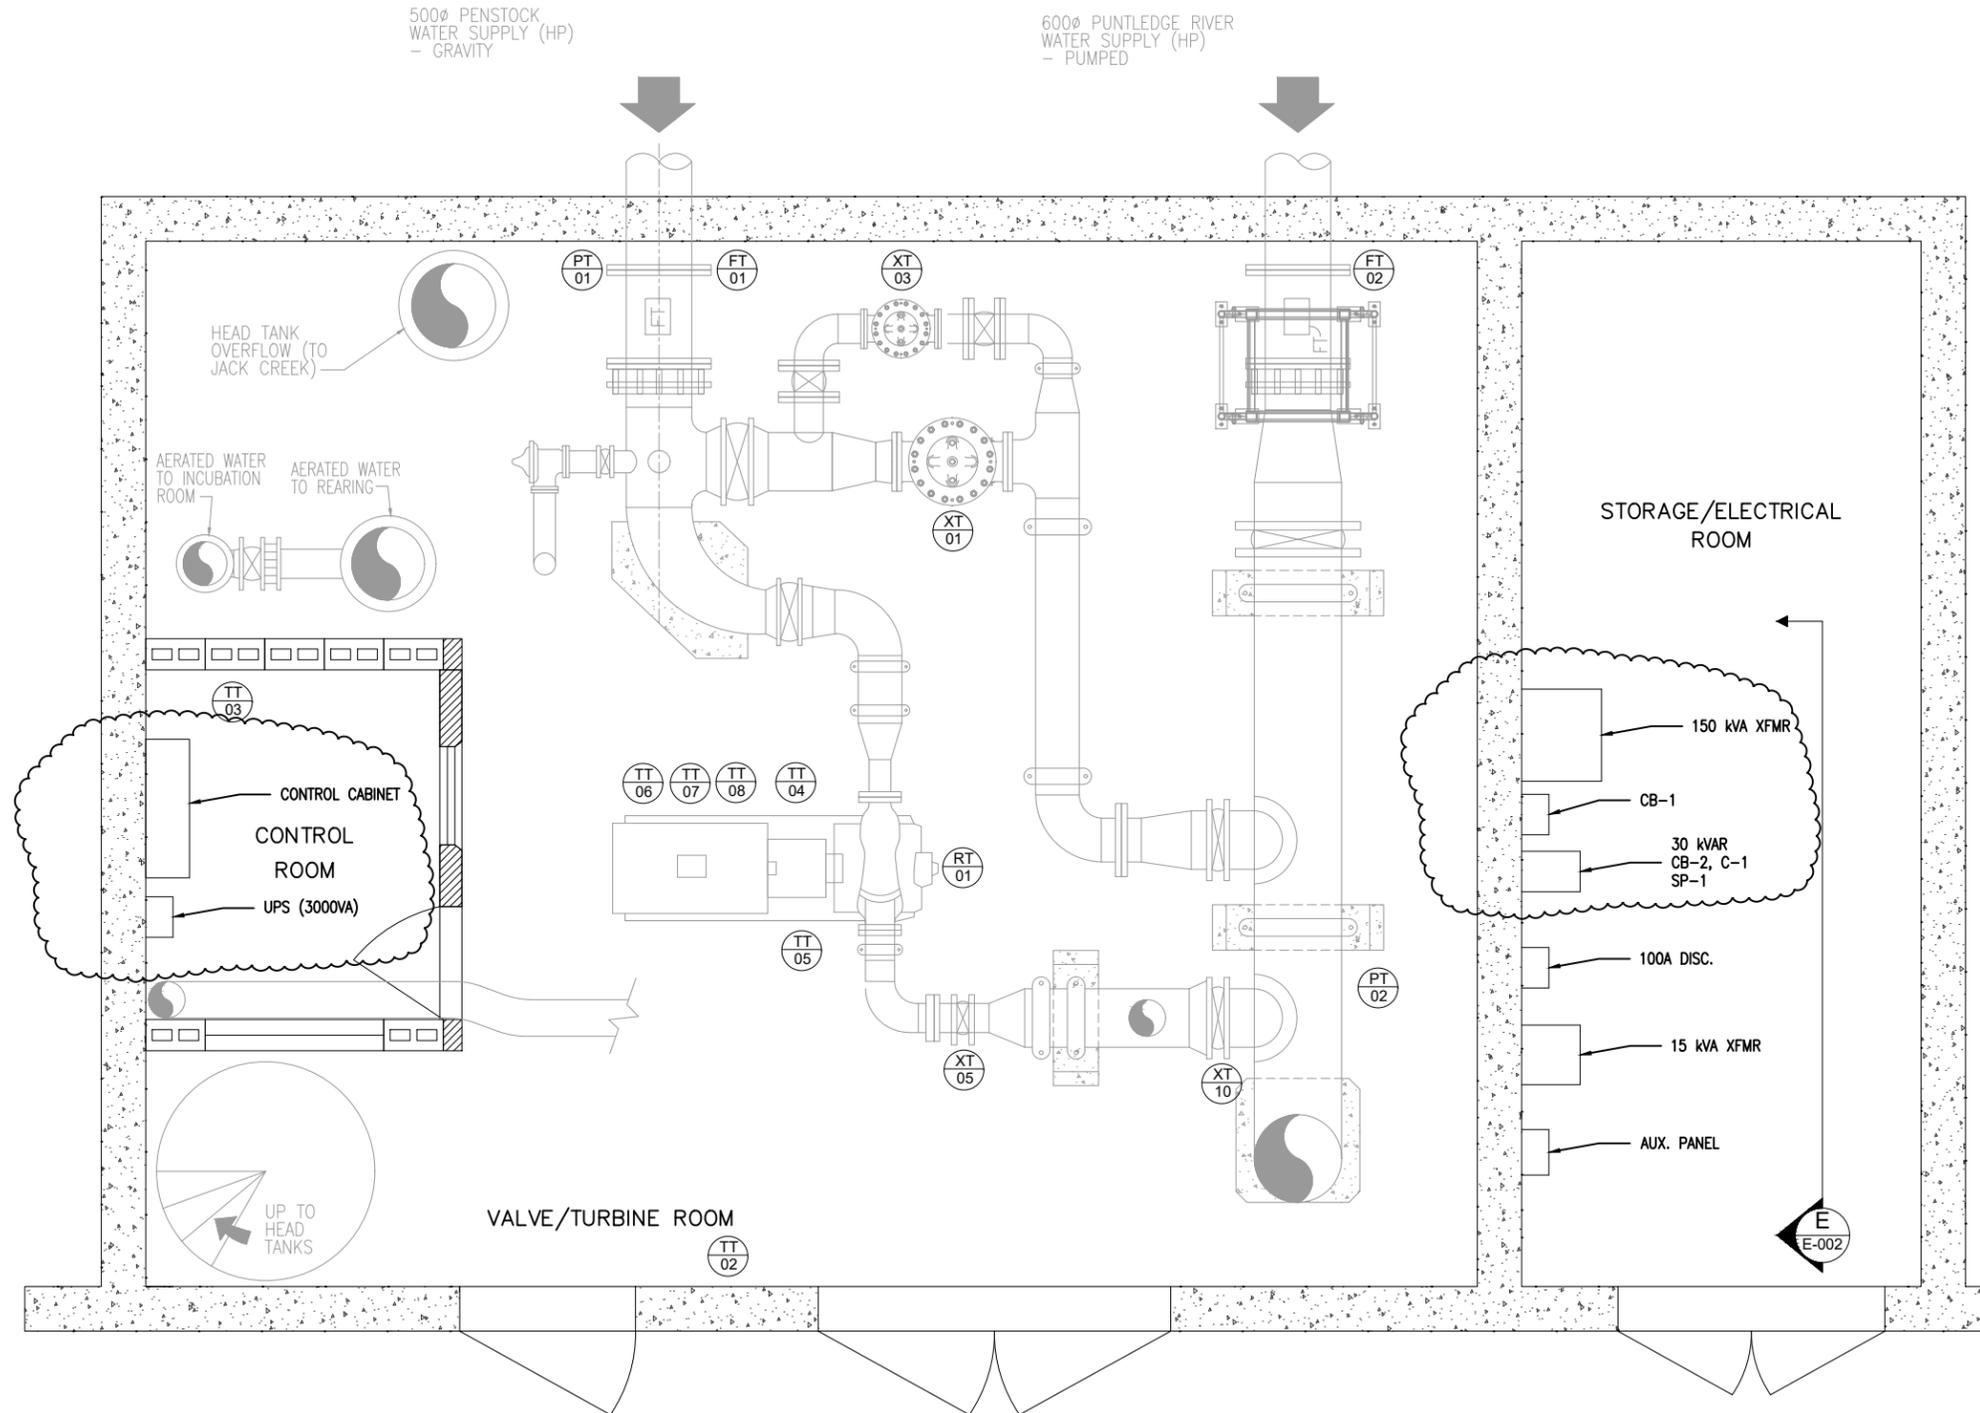
**FISHERIES AND OCEANS CANADA**  
REAL PROPERTY AND TECHNICAL SUPPORT

**PUNTLUDGE RIVER HATCHERY  
WATER SUPPLY ENERGY RECOVERY  
ELECTRICAL  
CONDUIT SECTION DETAILS**

SCALE N.T.S.	DATE 31-MAR-16
DRAWING NUMBER <b>E-010</b>	
REVISION	B

Plotted by: Billy Daulton, Plot date: 16-Nov-16 Path: \\resources.s:\clients\pfo\1608 Puntledge Energy Recovery Facility\1608 Puntledge Energy Recovery Facility\161116 E011 - E009 Puntledge.dwg Size: 444444

BILL OF MATERIAL		
ITEM	TAG	DESCRIPTION
1	FT-01	PENSTOCK FLOW METER
2	FT-02	RIVER SUPPLY FLOW METER
3	PT-01	PENSTOCK SUPPLY PRESSURE
4	PT-02	HEADER PRESSURE
5	RT-01	TURBINE ROTATING SPEED
6	TT-02	VALVE ROOM THERMOSTAT
7	TT-03	CONTROL ROOM THERMOSTAT
8	TT-04	TURBINE INSIDE BEARING RTD
9	TT-05	TURBINE BEARING RTD
10	TT-06	GENERATOR RTD - PHASE A
11	TT-07	GENERATOR RTD - PHASE B
12	TT-08	GENERATOR RTD - PHASE C
13	XT-01	CV1A VALVE POSITION
14	XT-03	CV3A VALVE POSITION
15	XT-05	TCV VALVE POSITION
16	XT-10	VALVE 10 POSITION



**PRELIMINARY**  
 NOT FOR CONSTRUCTION



**FISHERIES AND OCEANS CANADA**  
 REAL PROPERTY AND TECHNICAL SUPPORT


DWG. NO.	DRAWING REFERENCES	NOTES	NO.	DATE	REVISIONS
			D	16-NOV-2016	ADDED UPS
			C	09-NOV-2016	REVISED FOR TENDER
			B	30-MAY-2016	ADDED INSTRUMENTS
			A	31-MAR-2016	ISSUED FOR TENDER

DESIGNED	RD
DRAWN	RB
CHECKED	RD
RECOMMENDED	
APPROVED	
APPROVED	

**PUNTLEDGE RIVER HATCHERY**  
**WATER SUPPLY ENERGY RECOVERY**  
**AERATION BUILDING**  
**ELECTRICAL EQUIPMENT**  
**LAYOUT**

SCALE	N.T.S.
DATE	31-MAR-16
DRAWING NUMBER	E-011
REVISION	D

Plotted by: Billy Duffin, Plot date: 16-Nov-16 Path: \\resources\S\Victoria\GFD\1608\_Puntledge\_Energy\_Recovery\_Facility\08\_Drawings\STS Drawings\11116\_E012 - E012\_Puntledge\_Ind. Schematic.dwg Size: 4444H

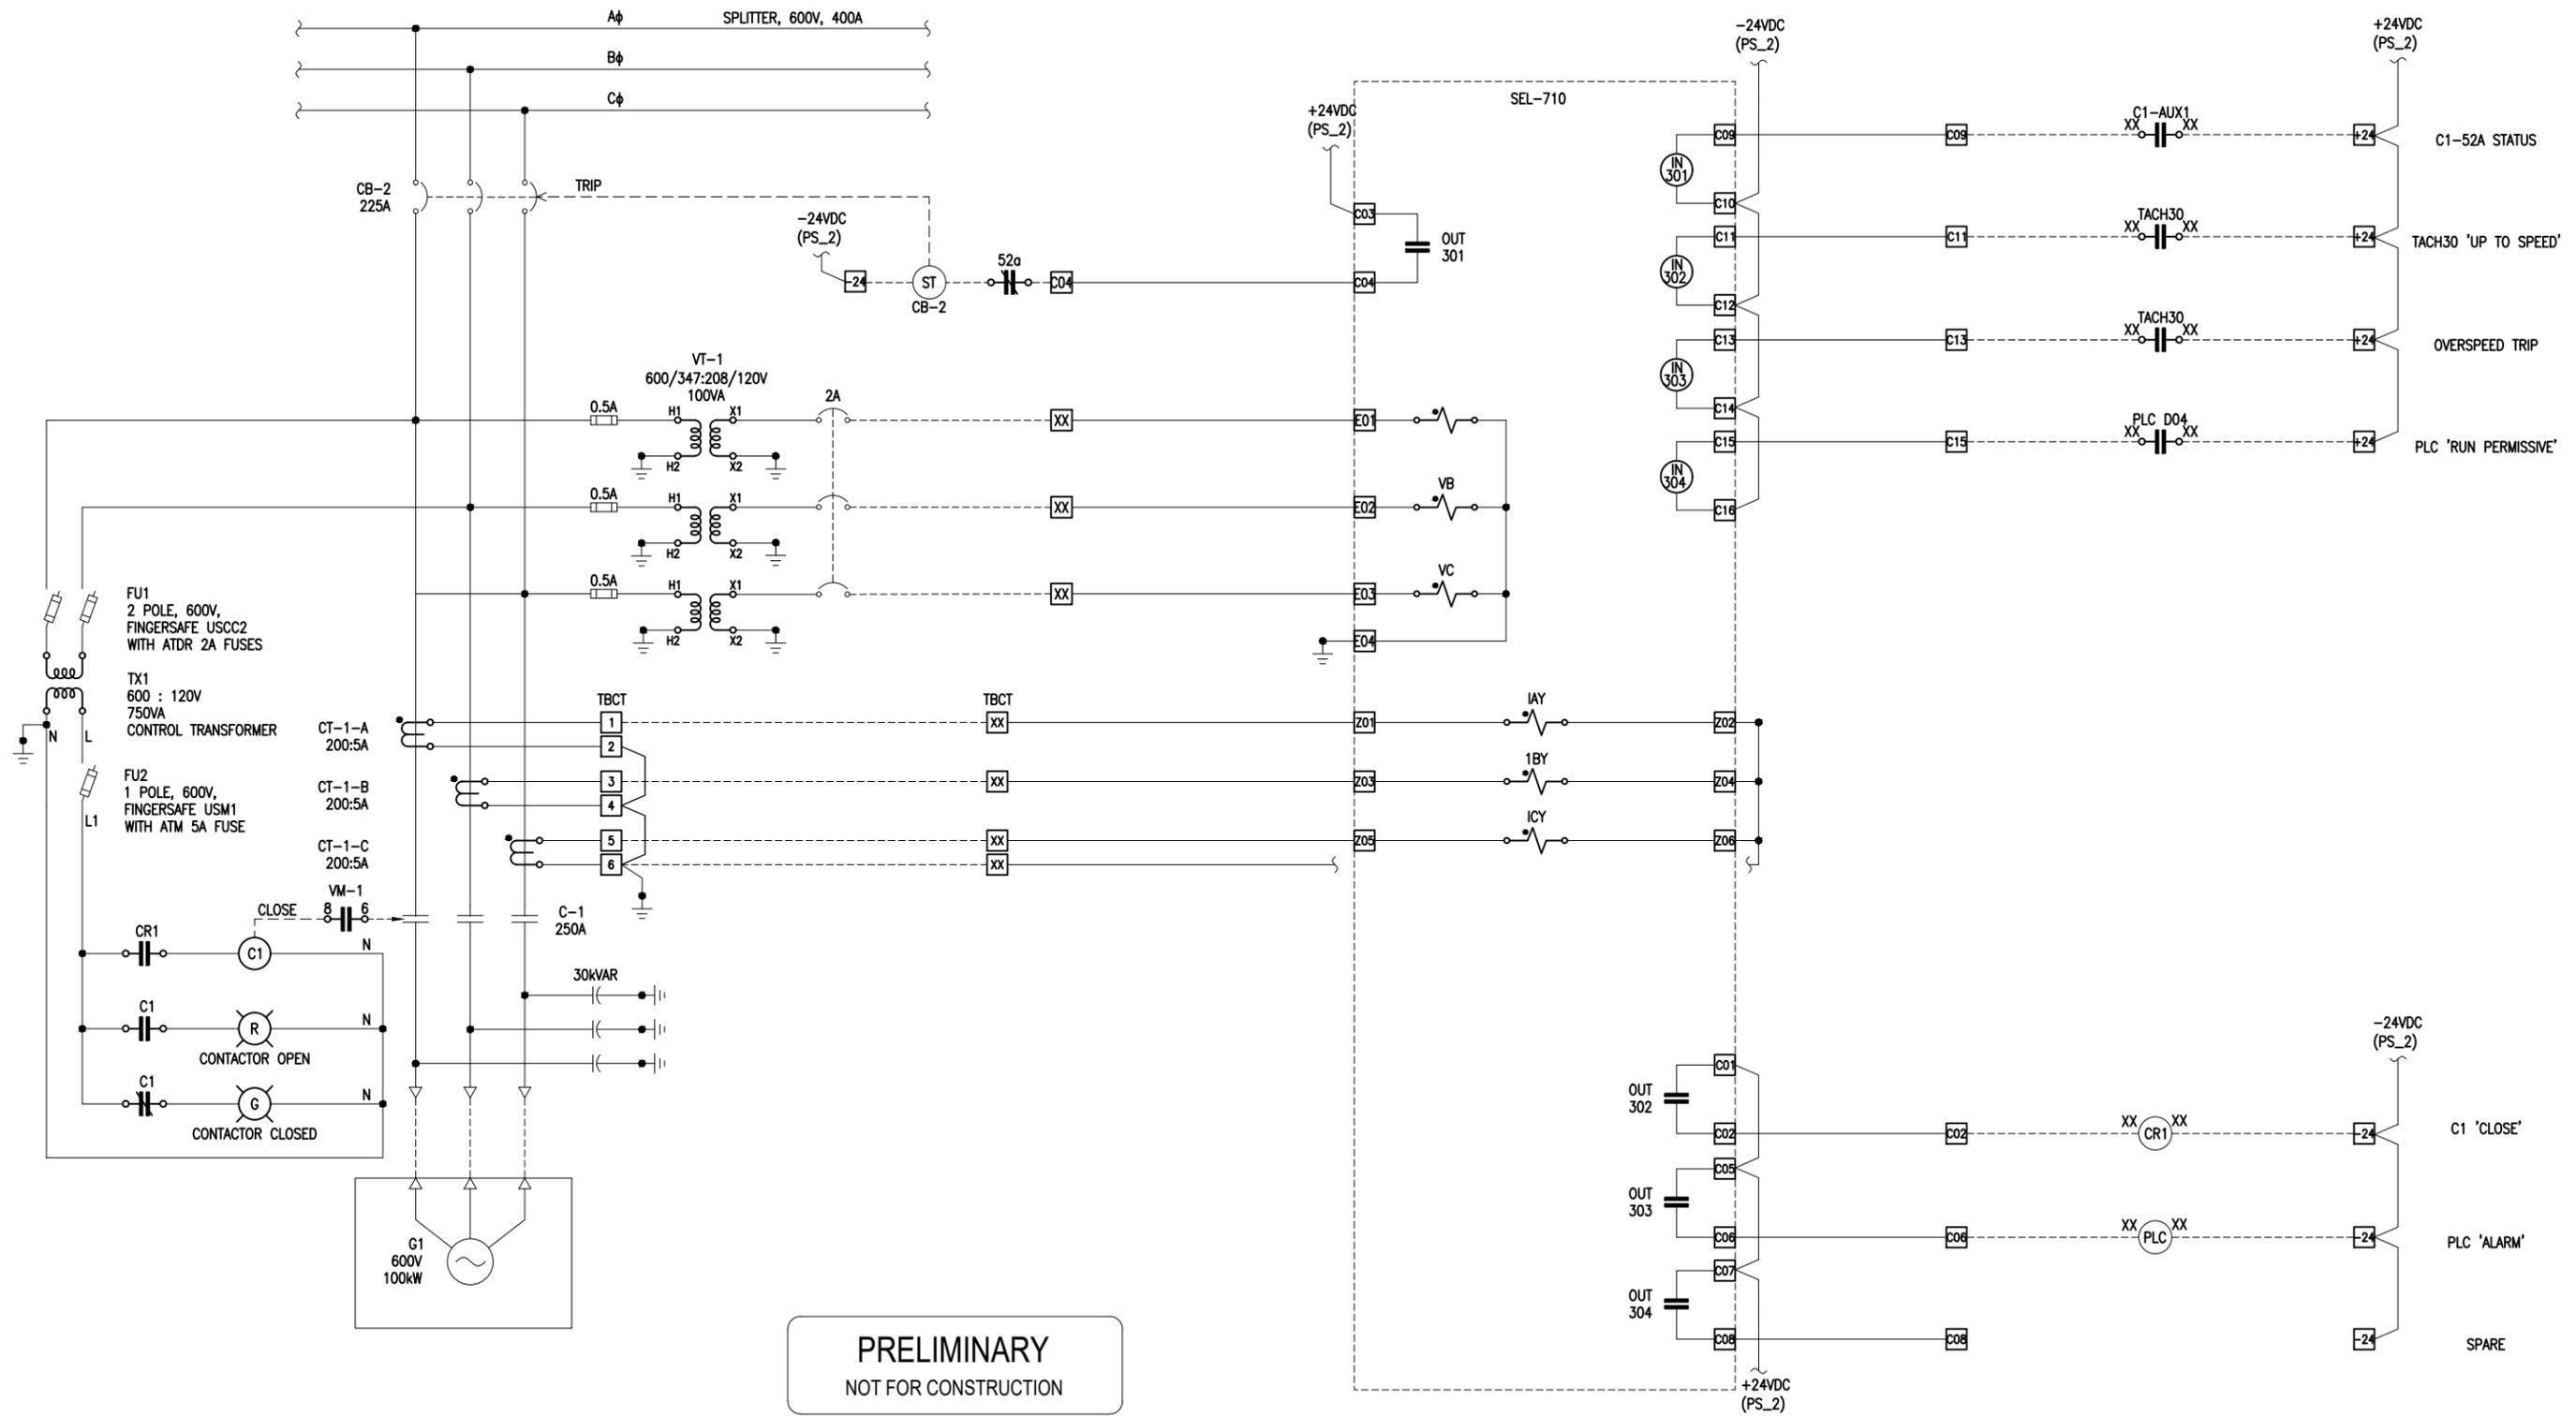

**PRELIMINARY**  
 NOT FOR CONSTRUCTION



**FISHERIES AND OCEANS CANADA**  
 REAL PROPERTY AND TECHNICAL SUPPORT

**PUNTLEDGE RIVER HATCHERY**  
**WATER SUPPLY ENERGY RECOVERY**  
**AERATION BUILDING**  
**INDUCTION GENERATOR**  
**PROTECTION & CONTROL SCHEMATIC**

SCALE	N.T.S.
DATE	31-MAR-16
DRAWING NUMBER	E-012
REVISION	B

DWG. NO.	DRAWING REFERENCES	NOTES	NO.	DATE	REVISIONS
			B	09-NOV-2016	REVISED FOR TENDER
			A	05-MAY-2016	ISSUED FOR TENDER

DESIGNED	RD
DRAWN	RB
CHECKED	RD
RECOMMENDED	
APPROVED	
APPROVED	

E-100 Rev B	Date : 16 NOV 2016	PUNLEDGE RIVER HATCHERY - CABLE SCHEDULE		ISSUED FOR TENDER
Drawing #	Cable Type & Size	From	To	Remarks
Location		Equipment	Equipment	
E-001	3c #4/0 TECK	Mechanical/Electrical Room - MDC Feeder Panel	Junction Box - JB1	
E-001	3c #4/0	Junction Box - JB1	Junction Box - JB2	Underground in Conduit
E-001	3c#4/0 TECK	Junction Box - JB2	Aeration Building - CB-1	
E-001	3c #4/0 TECK	Aeration Building - CB-1	Aeration Building - TFR (150kVA)	
E-001	3c #4/0 TECK	Aeration Building - TFR (150kVA)	Aeration Building - SP-1	
E-001	3c #2/0 TECK	Aeration Building - SP-1	Aeration Building - D2 (CB-2)	
E-001	3c #6 TECK	Aeration Building - Power Factor Correction Capacitor (PFCC)	Aeration Building - D2	
E-001	3c #2/0 TECK	Aeration Building - G1	Aeration Building - D2	
E-001	3c #4 TECK	Aeration Building - SP-1	Aeration Building - 100A Fused Disconnect	
E-004	2c #14 TECK	Aeration Building - Control Panel	Pumphouse (A3 Cable)	
E-004	2c #14 TECK	Aeration Building - Control Panel	Aeration Building - XT1 (Power)	
E-004	2c #14 TECK	Aeration Building - Control Panel	Aeration Building - XT3 (Power)	
E-004	2c #14 TECK	Aeration Building - Control Panel	Aeration Building - PT2 (Power)	
E-004	2c #14 TECK	Aeration Building - Control Panel	Aeration Building - XT5 (Power)	
E-004	2c #14 TECK	Aeration Building - Control Panel	Aeration Building - XT10 (Power)	
E-004	2c #14 TECK	Aeration Building - Control Panel	LT1 (Power)	
E-004	2c #14 TECK	Aeration Building - Control Panel	LT2 (Power)	
E-004	2c #14 TECK	Aeration Building - Control Panel	Aeration Building - PT1 (Power)	
E-004	2c #14 TECK	Aeration Building - Control Panel	Aeration Building - FT1 (Power)	
E-004	2c #14 TECK	Aeration Building - Control Panel	Aeration Building - FT2 (Power)	
E-004	2c #14 TECK	Aeration Building - Control Panel	Aeration Building - RT1 (Power)	
E-004	2c #14 TECK	Aeration Building - Control Panel	TT1 (Power)	
E-004	2c #14 TECK	Aeration Building - Control Panel	Aeration Building - TT2 (Power)	
E-004	2c #14 TECK	Aeration Building - Control Panel	Aeration Building - TT4 (Power)	
E-004	2c #14 TECK	Aeration Building - Control Panel	Aeration Building - TT5 (Power)	
E-004	2c #14 TECK	Aeration Building - Control Panel	Aeration Building - TT6 (Power)	
E-004	2c #14 TECK	Aeration Building - Control Panel	Aeration Building - TT7 (Power)	
E-004	2c #14 TECK	Aeration Building - Control Panel	Aeration Building - TT8 (Power)	
E-005	2c #14 TECK	Aeration Building - Control Panel (TB-1)	V10 (Valve Open Position)	
E-005	2c #14 TECK	Aeration Building - Control Panel (TB-1)	V10 (Valve Closed Position)	
E-005	2c #14 TECK	Aeration Building - Control Panel (TB-1)	Turbine Control Valve (Open Position)	
E-005	2c #14 TECK	Aeration Building - Control Panel (TB-1)	Turbine Control Valve (Closed Position)	
E-005	2c #14 TECK	Aeration Building - Control Panel (TB-1)	V8 (Valve Open Position)	
E-005	2c #14 TECK	Aeration Building - Control Panel (TB-1)	V8 (Valve Closed Position)	
E-006	2c #14 TECK	Aeration Building - Control Panel (TB-2)	CV3A (8" Valve Open)	
E-006	2c #14 TECK	Aeration Building - Control Panel (TB-2)	CB3A (8" Valve Close)	
E-006	2c #14 TECK	Aeration Building - Control Panel (TB-2)	CV1A (12" Valve Open)	
E-006	2c #14 TECK	Aeration Building - Control Panel (TB-2)	CV1A (12" Valve Close)	
E-006	2c #14 TECK	Aeration Building - Control Panel (TB-2)	Turbine (Control Valve Open)	
E-006	2c #14 TECK	Aeration Building - Control Panel (TB-2)	Turbine (Control Valve Close)	
E-006	2c #14 TECK	Aeration Building - Control Panel (TB-2)	V10 (Motorized Valve Open)	
E-006	2c #14 TECK	Aeration Building - Control Panel (TB-2)	V10 (Motorized Valve Close)	
E-008	1PR SHLD Teck	Aeration Building - Control Panel (TB-4)	LT1 (Level - Tank 1 (Main Tank))	
E-008	1PR SHLD Teck	Aeration Building - Control Panel (TB-4)	LT2 (Level - Tank 2 (Incubation Tank))	
E-008	1PR SHLD Teck	Aeration Building - Control Panel (TB-4)	PT1 (Pressure - Supply Water)	
E-008	1PR SHLD Teck	Aeration Building - Control Panel (TB-4)	Vibration Monitor No. 1	
E-008	1PR SHLD Teck	Aeration Building - Control Panel (TB-4)	Vibration Monitor No. 2	
E-008	1PR SHLD Teck	Aeration Building - Control Panel (TB-4)	XT-03, 8" Valve (CV3A)	
E-008	1PR SHLD Teck	Aeration Building - Control Panel (TB-4)	XT-01, 12" Valve (CV1A)	
E-008	1PR SHLD Teck	Aeration Building - Control Panel (TB-4)	PT-02 (Header Pressure)	
E-008	1PR SHLD Teck	Aeration Building - Control Panel (TB-4)	FT-2 (Flow - River Supply)	
E-008	1PR SHLD Teck	Aeration Building - Control Panel (TB-4)	FT-1 (Flow - Penstock Supply)	
E-008	1PR SHLD Teck	Aeration Building - Control Panel (TB-4)	RT-1 (Speed - Turbine Tachometer)	
E-009	1PR SHLD Teck	Aeration Building - Control Panel (TB-4)	TT1	
E-009	1PR SHLD Teck	Aeration Building - Control Panel (TB-4)	TT2	
E-009	1PR SHLD Teck	Aeration Building - Control Panel (TB-4)	TT4	
E-009	1PR SHLD Teck	Aeration Building - Control Panel (TB-4)	TT5	
E-009	1PR SHLD Teck	Aeration Building - Control Panel (TB-4)	TT6	
E-009	1PR SHLD Teck	Aeration Building - Control Panel (TB-4)	TT7	
E-009	1PR SHLD Teck	Aeration Building - Control Panel (TB-4)	TT8	
E-012	4c #10 Teck	Aeration Building - D2 (CT-1)	Aeration Building - Control Panel (SEL-710)	
E-012	4c #10 Teck	Aeration Building - D2 (VT-1)	Aeration Building - Control Panel (SEL-710)	
E-011	3C #12 Teck	125A Auxiliary Service Panel	UPS	