



Public Works and
Government Services
Canada

Travaux publics et
Services gouvernementaux
Canada



Indigenous and
Northern Affairs Canada

REAL PROPERTY SERVICES
Western Region

Canada

REMEDIATION PROJECT

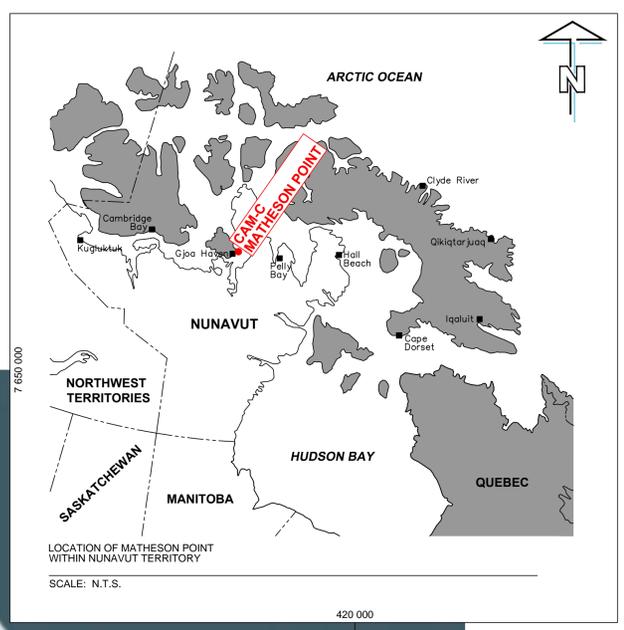
DRAWING INDEX			
SHEET NO.	TITLE	SHEET NO.	TITLE
CIVIL		STRUCTURAL	
R.064062-C00	COVER SHEET	R.064062-S01	STATION POL - DEMOLITION SITE PLAN
R.064062-C01	SITE LOCATION PLAN	R.064062-S02	BEACH POL - DEMOLITION SITE PLAN
R.064062-C02	SITE PLAN AND PROJECT LAYOUT	R.064062-S03	WAREHOUSE AND GARAGE - PLAN, ELEVATION, AND SECTION
R.064062-C03	DEBRIS AREA 10, CONTAMINATED SOIL AREA - SITE PLAN		
R.064062-C04	STATION POL - SITE PLAN - SHEET 1 OF 2		
R.064062-C05	STATION POL - SITE PLAN - SHEET 2 OF 2		
R.064062-C06	STATION WEST LANDFILL - SITE PLAN		
R.064062-C07	AIRSTRIP LANDFILL - SITE PLAN		
R.064062-C08	BEACH POL - SITE PLAN		
R.064062-C09	STATION WEST LANDFILL - CROSS SECTION		
R.064062-C10	AIRSTRIP LANDFILL CHANNEL - CROSS SECTION		



CAM-C, MATHESON POINT, NU ISSUED FOR TENDER

AECOM

NOVEMBER 23, 2016



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E	ISSUED FOR TENDER	16/11/23
D	DRAFT REVISION	16/09/23
C	ISSUED FOR TENDER	14/02/27
B	ISSUED FOR 75% DESIGN	14/01/03
A	ISSUED FOR 75% DESIGN	13/12/02
Revision/Revision	Description/Description	Date/Date

Client/client

PUBLIC WORKS AND GOVERNMENT SERVICES CANADA

Project title/Titre du projet

CAM-C MATHESON POINT REMEDIATION PROJECT

Approved by/Approuvé par

B. FEDORAK

Designed by/Concept par

K. SCOTT

Drawn by/Dessiné par

J. KNOTT

PWSSC Project Manager/Administrateur de Projets TPSGC

J. HOYT

PWSSC Architectural and Engineering Resources Manager/ Ressources Architectural et de Directeur d'ingénierie, TPSGC

Client/client

PUBLIC WORKS AND GOVERNMENT SERVICES CANADA

Drawing title/Titre du dessin

SITE LOCATION PLAN

Project No./No. du projet

R.064062

Sheet/Feuille

C01


OF 10

Revision no./ La Revision no.

E



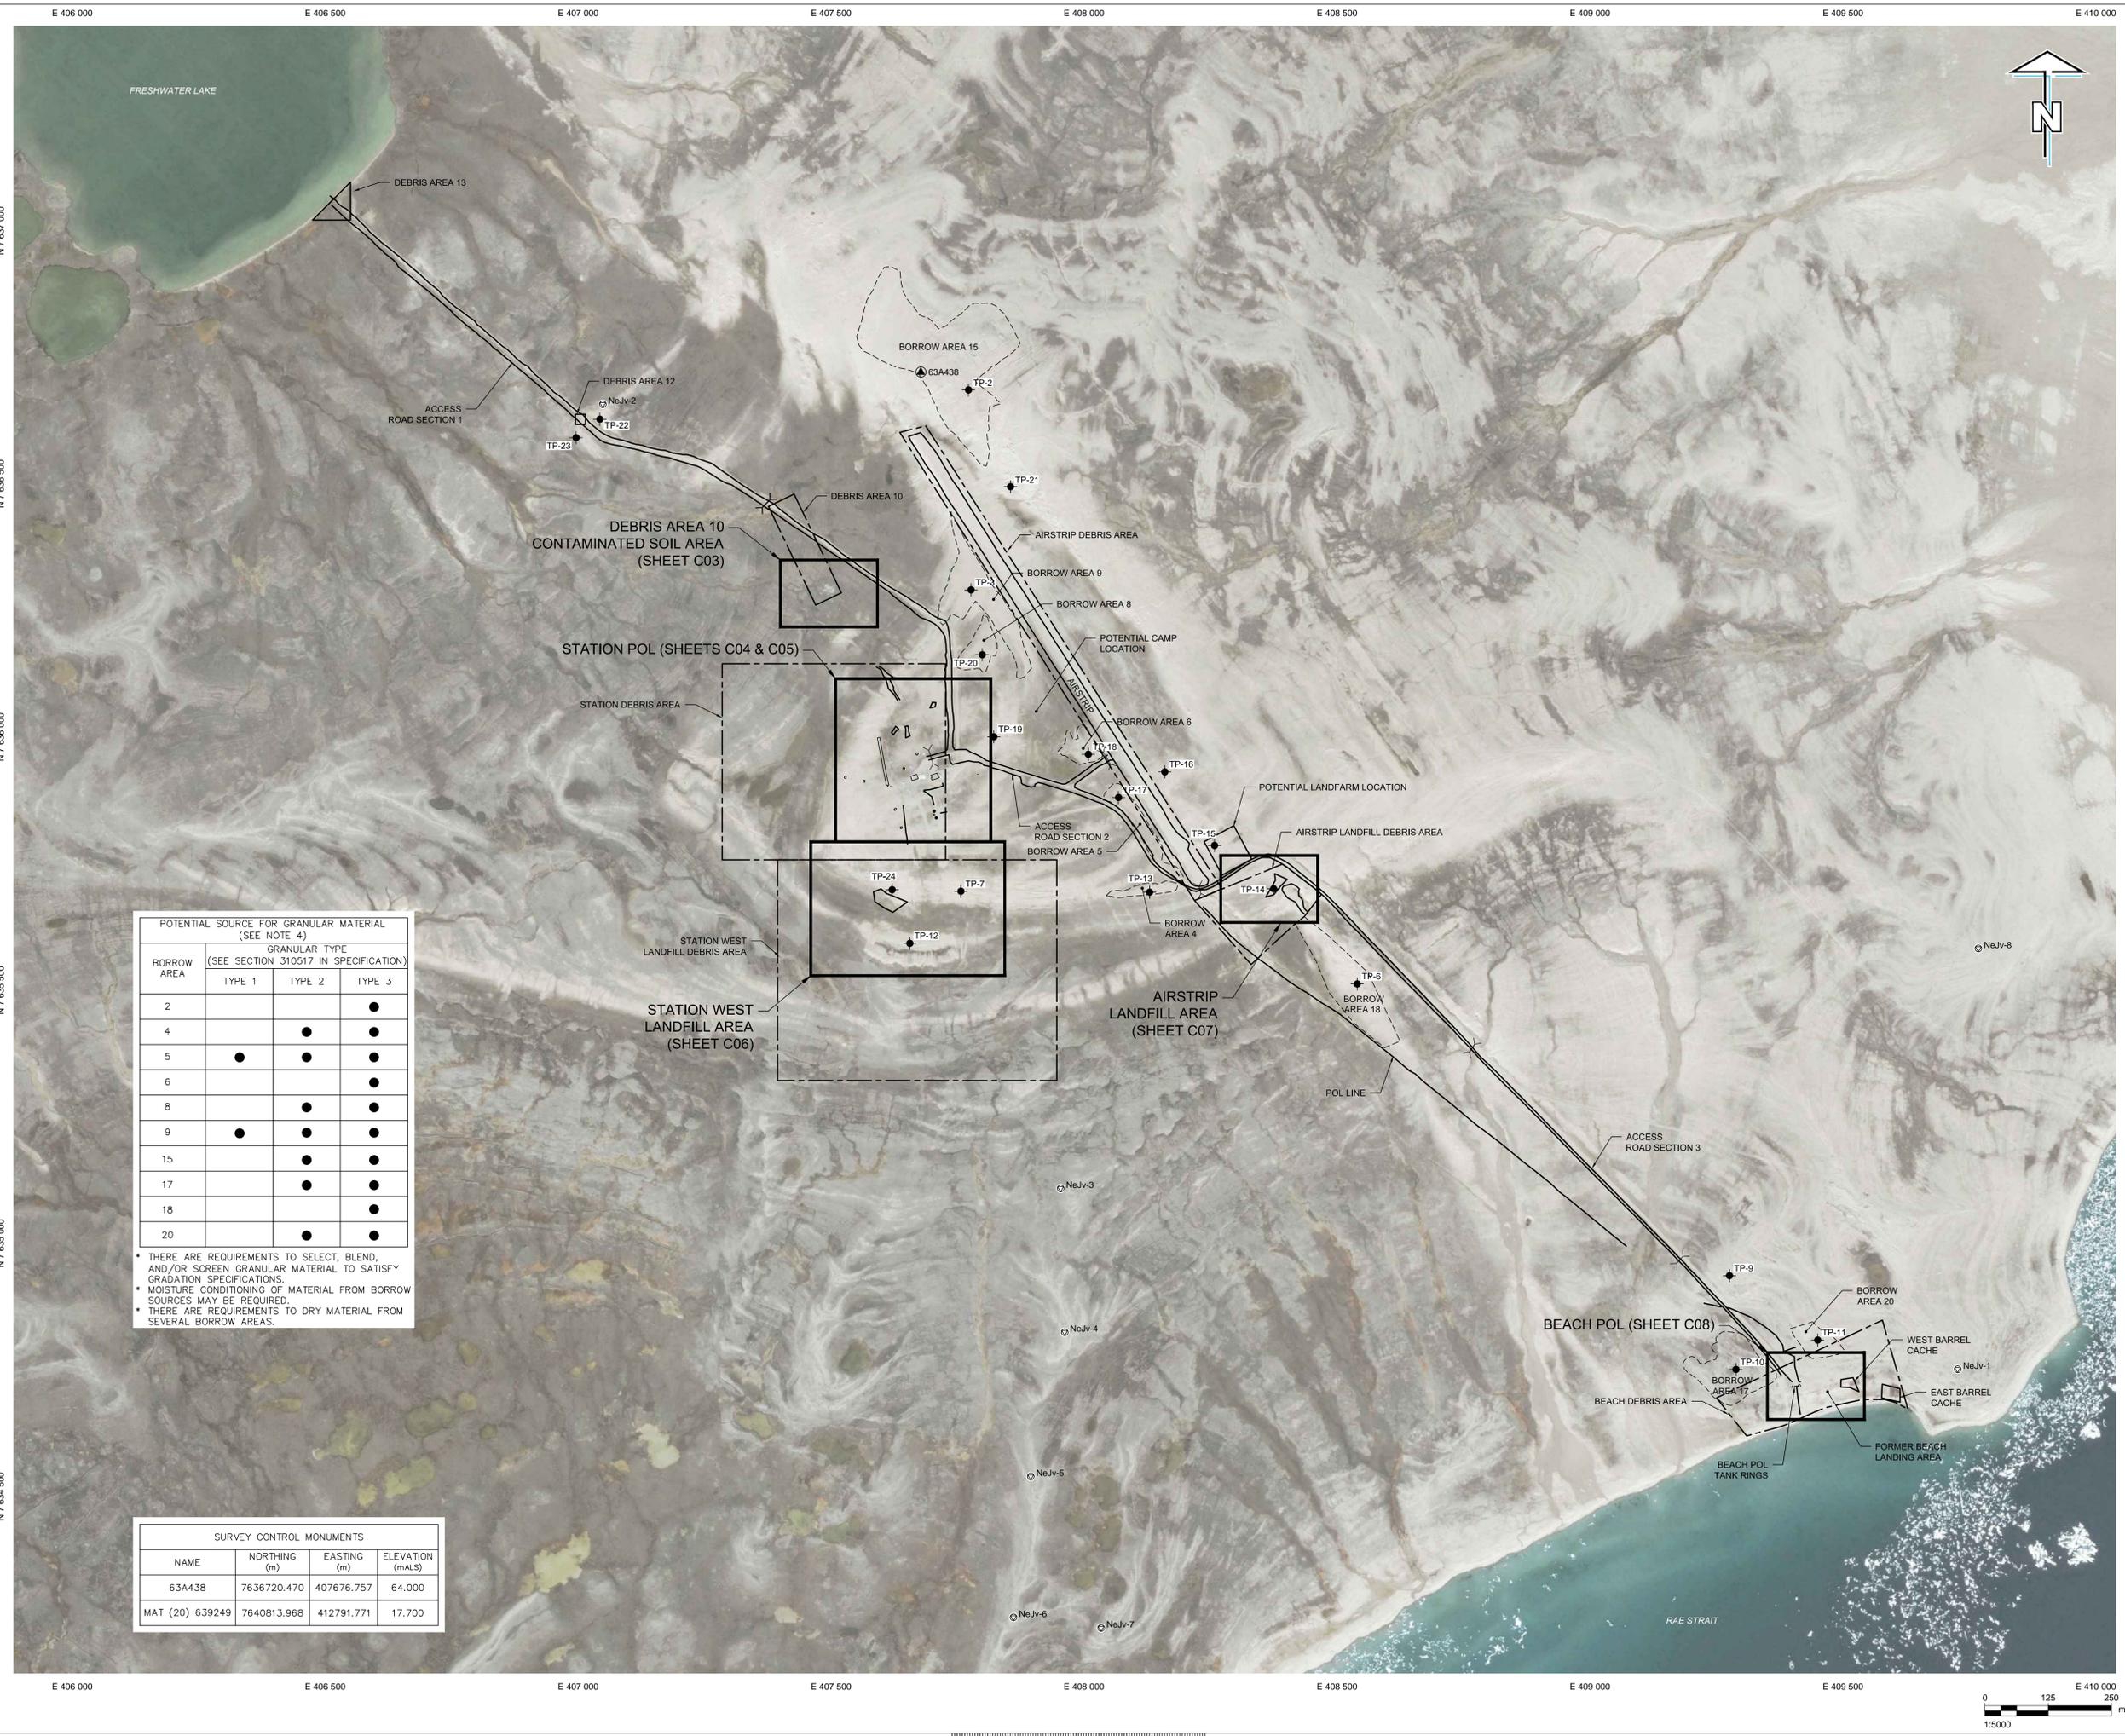AECOM FILE NO.: P:\60516763\900-CAD_GIS\910-CAD\20-SHEETS\C\18360516763-00-C-002-RX.DWG
 Saved by: Eros, Craig
 PLOT: Wednesday, November 23, 2016 11:45:31 AM
 Sheet Size: B1 (1000mm x 707mm)



BORROW AREA	GRANULAR TYPE (SEE SECTION 310517 IN SPECIFICATION)		
	TYPE 1	TYPE 2	TYPE 3
2			●
4		●	●
5	●	●	●
6			●
8		●	●
9	●	●	●
15		●	●
17		●	●
18			●
20		●	●

* THERE ARE REQUIREMENTS TO SELECT, BLEND, AND/OR SCREEN GRANULAR MATERIAL TO SATISFY GRADATION SPECIFICATIONS.
 * MOISTURE CONDITIONING OF MATERIAL FROM BORROW SOURCES MAY BE REQUIRED.
 * THERE ARE REQUIREMENTS TO DRY MATERIAL FROM SEVERAL BORROW AREAS.

SURVEY CONTROL MONUMENTS			
NAME	NORTHING (m)	EASTING (m)	ELEVATION (mALS)
63A438	7636720.470	407676.757	64.000
MAT (20) 639249	7640813.968	412791.771	17.700

Public Works and Government Services Canada

Travaux publics et Services gouvernementaux Canada

REAL PROPERTY SERVICES
Western Region
SERVICES IMMOBILIERS
Région de l'ouest

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N 7 637 000

N 7 636 500

N 7 636 000

N 7 635 500

N 7 635 000

N 7 634 500

N 7 634 000

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- ALL DIMENSIONS ARE IN METRES UNLESS NOTED OTHERWISE.
- CULVERTS TO BE REMOVED AND CULVERT AREA TO BE GRADED TO DRAIN PRIOR TO PROJECT COMPLETION.
- BORROW AREAS ARE IDENTIFIED. OTHER BORROW AREAS EXIST AND CAN BE CONSIDERED FOR USE IF REQUIRED.
- REFER TO APPENDICES IN SPECIFICATION FOR DESCRIPTION OF DEBRIS AREAS.

LEGEND:

- APPROXIMATE EXTENT OF BORROW AREA
- - - DEBRIS AREA
- EXISTING CULVERT
- ⊙ ARCHAEOLOGICAL SITE
- ▲ SURVEY CONTROL POINT
- ◆ GEOTECHNICAL TEST PIT

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E	ISSUED FOR TENDER	16/11/23
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Project title/Titre du projet

CAM-C MATHESON POINT REMEDIATION PROJECT

Approved by/Approuvé par
B. FEDORAK

Designed by/Conçue par
K. SCOTT

Drawn by/Dessiné par
J. KNOTT

PWSSC Project Manager/Administrateur de Projets TPSGC
J. HOYT

PWSSC Architectural and Engineering Resources Manager/Ressources Architectural et de Directeur d'ingénierie, TPSGC


Client/client
PUBLIC WORKS AND GOVERNMENT SERVICES CANADA


Drawing title/Titre du dessin

SITE PLAN AND PROJECT LAYOUT

Project No./No. du projet R.064062	Sheet/Feuille C02 OF 10	Revision no./La Révision no. E
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0 125 250
1:5000 m



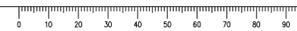

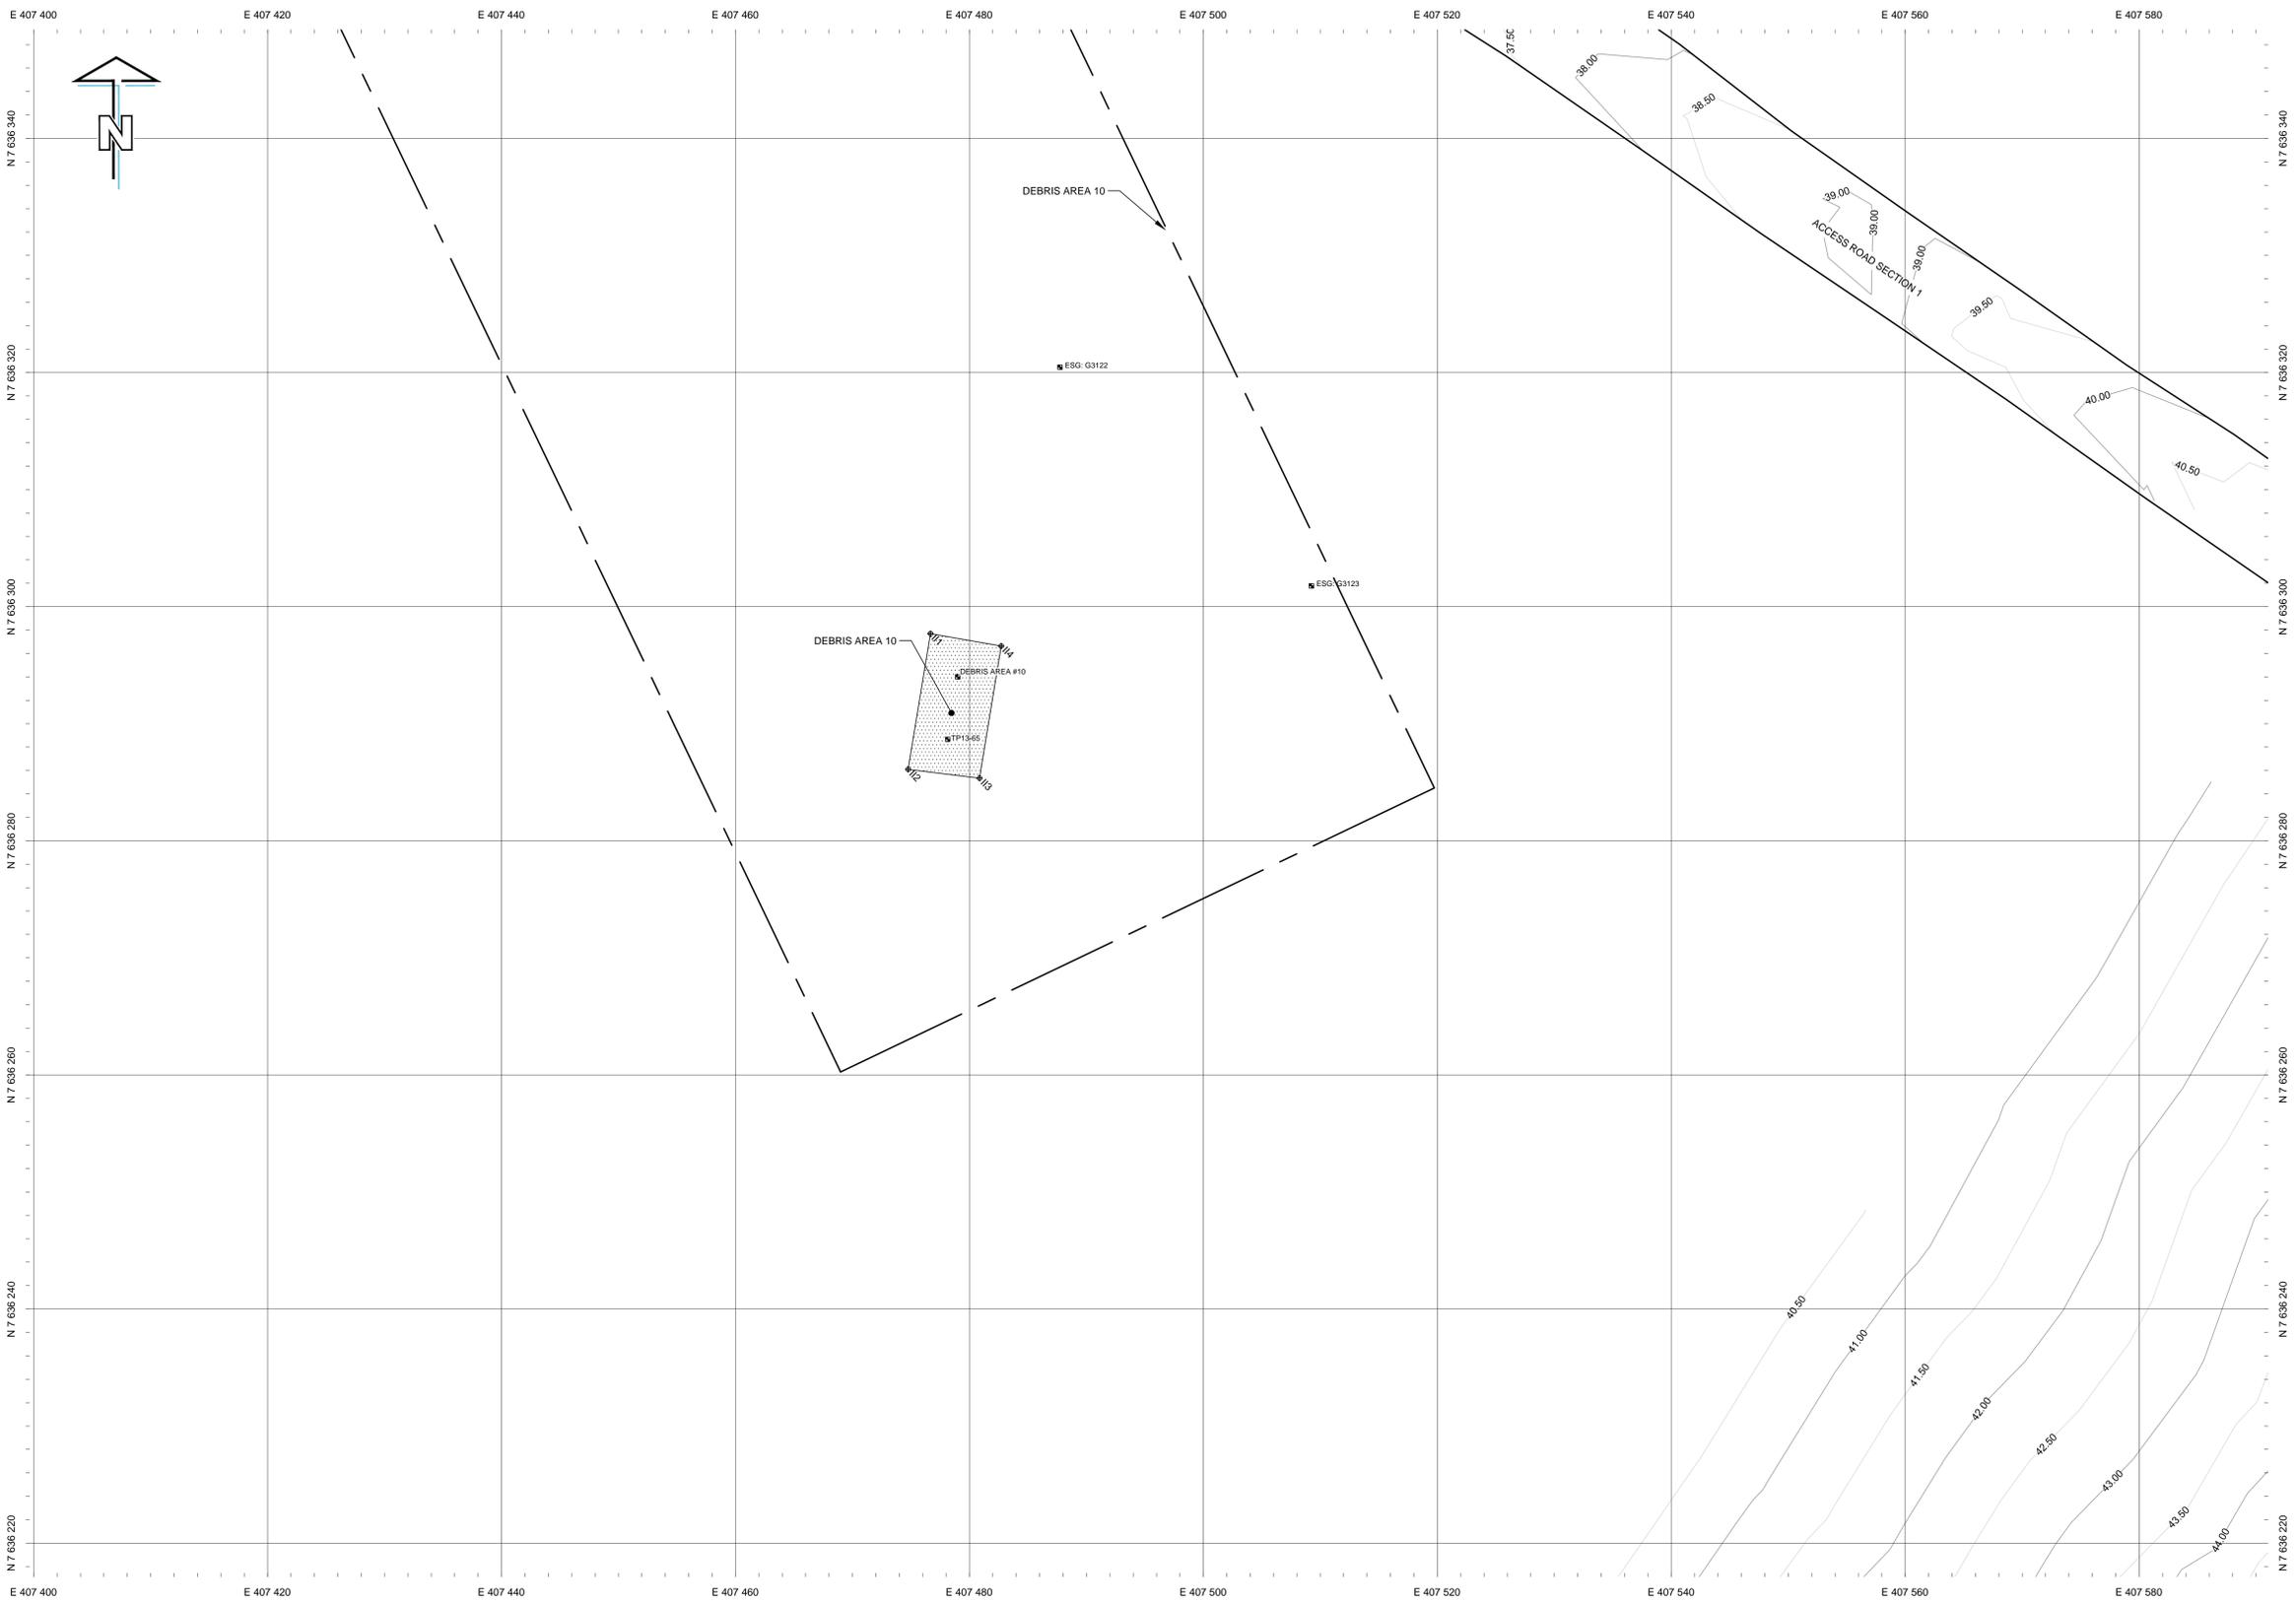CONTAMINATED SOIL TO BE EXCAVATED						REFERENCE POINTS	
AREA NAME	APPROX. AREA (m ²)	ESTIMATED DEPTH OF CONTAMINATION (m)	ESTIMATED VOLUME OF EXCAVATION (m ³)	CONTAMINATION CLASSIFICATION	COMMENTS	NORTHING	EASTING
DEBRIS AREA 10	71	0.3	22	TIER I	OFF SITE DISPOSAL	7 636 291.4	407 478.8

TIER I CONTAMINATED SOIL EXCAVATION DEBRIS AREA 10 COORDINATES		
NO.	NORTHING	EASTING
I11	7 636 297.7	407 476.7
I12	7 636 286.1	407 474.8
I13	7 636 285.3	407 480.9
I14	7 636 296.6	407 482.7

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- REFER TO DWG. C02 FOR ENTIRE DEBRIS AREA LIMITS

LEGEND:

- DEBRIS AREA
- [Pattern] TIER I CONTAMINATED SOIL

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E	ISSUED FOR TENDER	16/11/23
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Project title/Titre du projet

CAM-C MATHESON POINT REMEDIATION PROJECT

Approved by/Approuvé par

B. FEDORAK

Designed by/Concept par

K. SCOTT

Drawn by/Dessiné par

J. KNOTT

PM/SC Project Manager/Administrateur de Projets TPSGC

J. HOYT

PM/SC Architectural and Engineering Resources Manager / Ressources Architectural et de Directeur d'ingénierie, TPSGC

PUBLIC WORKS AND GOVERNMENT SERVICES CANADA

Drawing title/Titre du dessin

DEBRIS AREA 10 CONTAMINATED SOIL AREA SITE PLAN

Project No./No. du projet

R.064062



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C03

OF 10

Revision no./La Revision no.

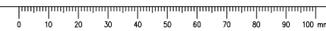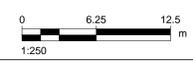E



Sheet Size: B1 (1000mm x 707mm)

PLOT: Wednesday, November 23, 2016 11:25:40 AM

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2. ALL DIMENSIONS ARE IN METRES UNLESS NOTED OTHERWISE.
3. ALL SURFACE DEBRIS IS TO BE REMOVED FROM ALL CONTAMINATED SOIL AREAS AND EXISTING BURIED DEBRIS AREAS PRIOR TO EXCAVATION OR FILL PLACEMENT TAKING PLACE.
4. REFER TO DWG. C02 FOR ENTIRE DEBRIS AREA LIMITS.
5. REGRADED SIDE SLOPES 6H:1V UNLESS NOTED OTHERWISE.

LEGEND:

- - - - - APPROXIMATE EXTENT OF BORROW AREA
--- DEBRIS AREA
--- EXISTING CULVERT
■ SAMPLE LOCATION
[Pattern] TIER I CONTAMINATED SOIL
[Pattern] TIER II CONTAMINATED SOIL
[Pattern] TYPE B PHC CONTAMINATED SOIL

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Table with 3 columns: Revision, Description/Description, Date/Date. Rows include E (ISSUED FOR TENDER), D (DRAFT REVISION), C, B, A, and Revision/Revision.

Client/client

PUBLIC WORKS AND GOVERNMENT SERVICES CANADA

Project title/Titre du projet

CAM-C MATHESON POINT REMEDIATION PROJECT

Approved by/Approve par

B. FEDORAK

Designed by/Concept par

K. SCOTT

Drawn by/Dessiné par

J. KNOTT

PWSSC Project Manager/Administrateur de Projets TPSGC

J. HOYT

PWSSC Architectural and Engineering Resources Manager/ Ressources Architecturale et de Directeur d'ingénierie, TPSGC

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PUBLIC WORKS AND GOVERNMENT SERVICES CANADA

Drawing title/Titre du dessin

STATION POL SITE PLAN SHEET 1 OF 2

Project No./No. du projet

R.064062



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C04

OF 10

Revision no./ La Revision no.

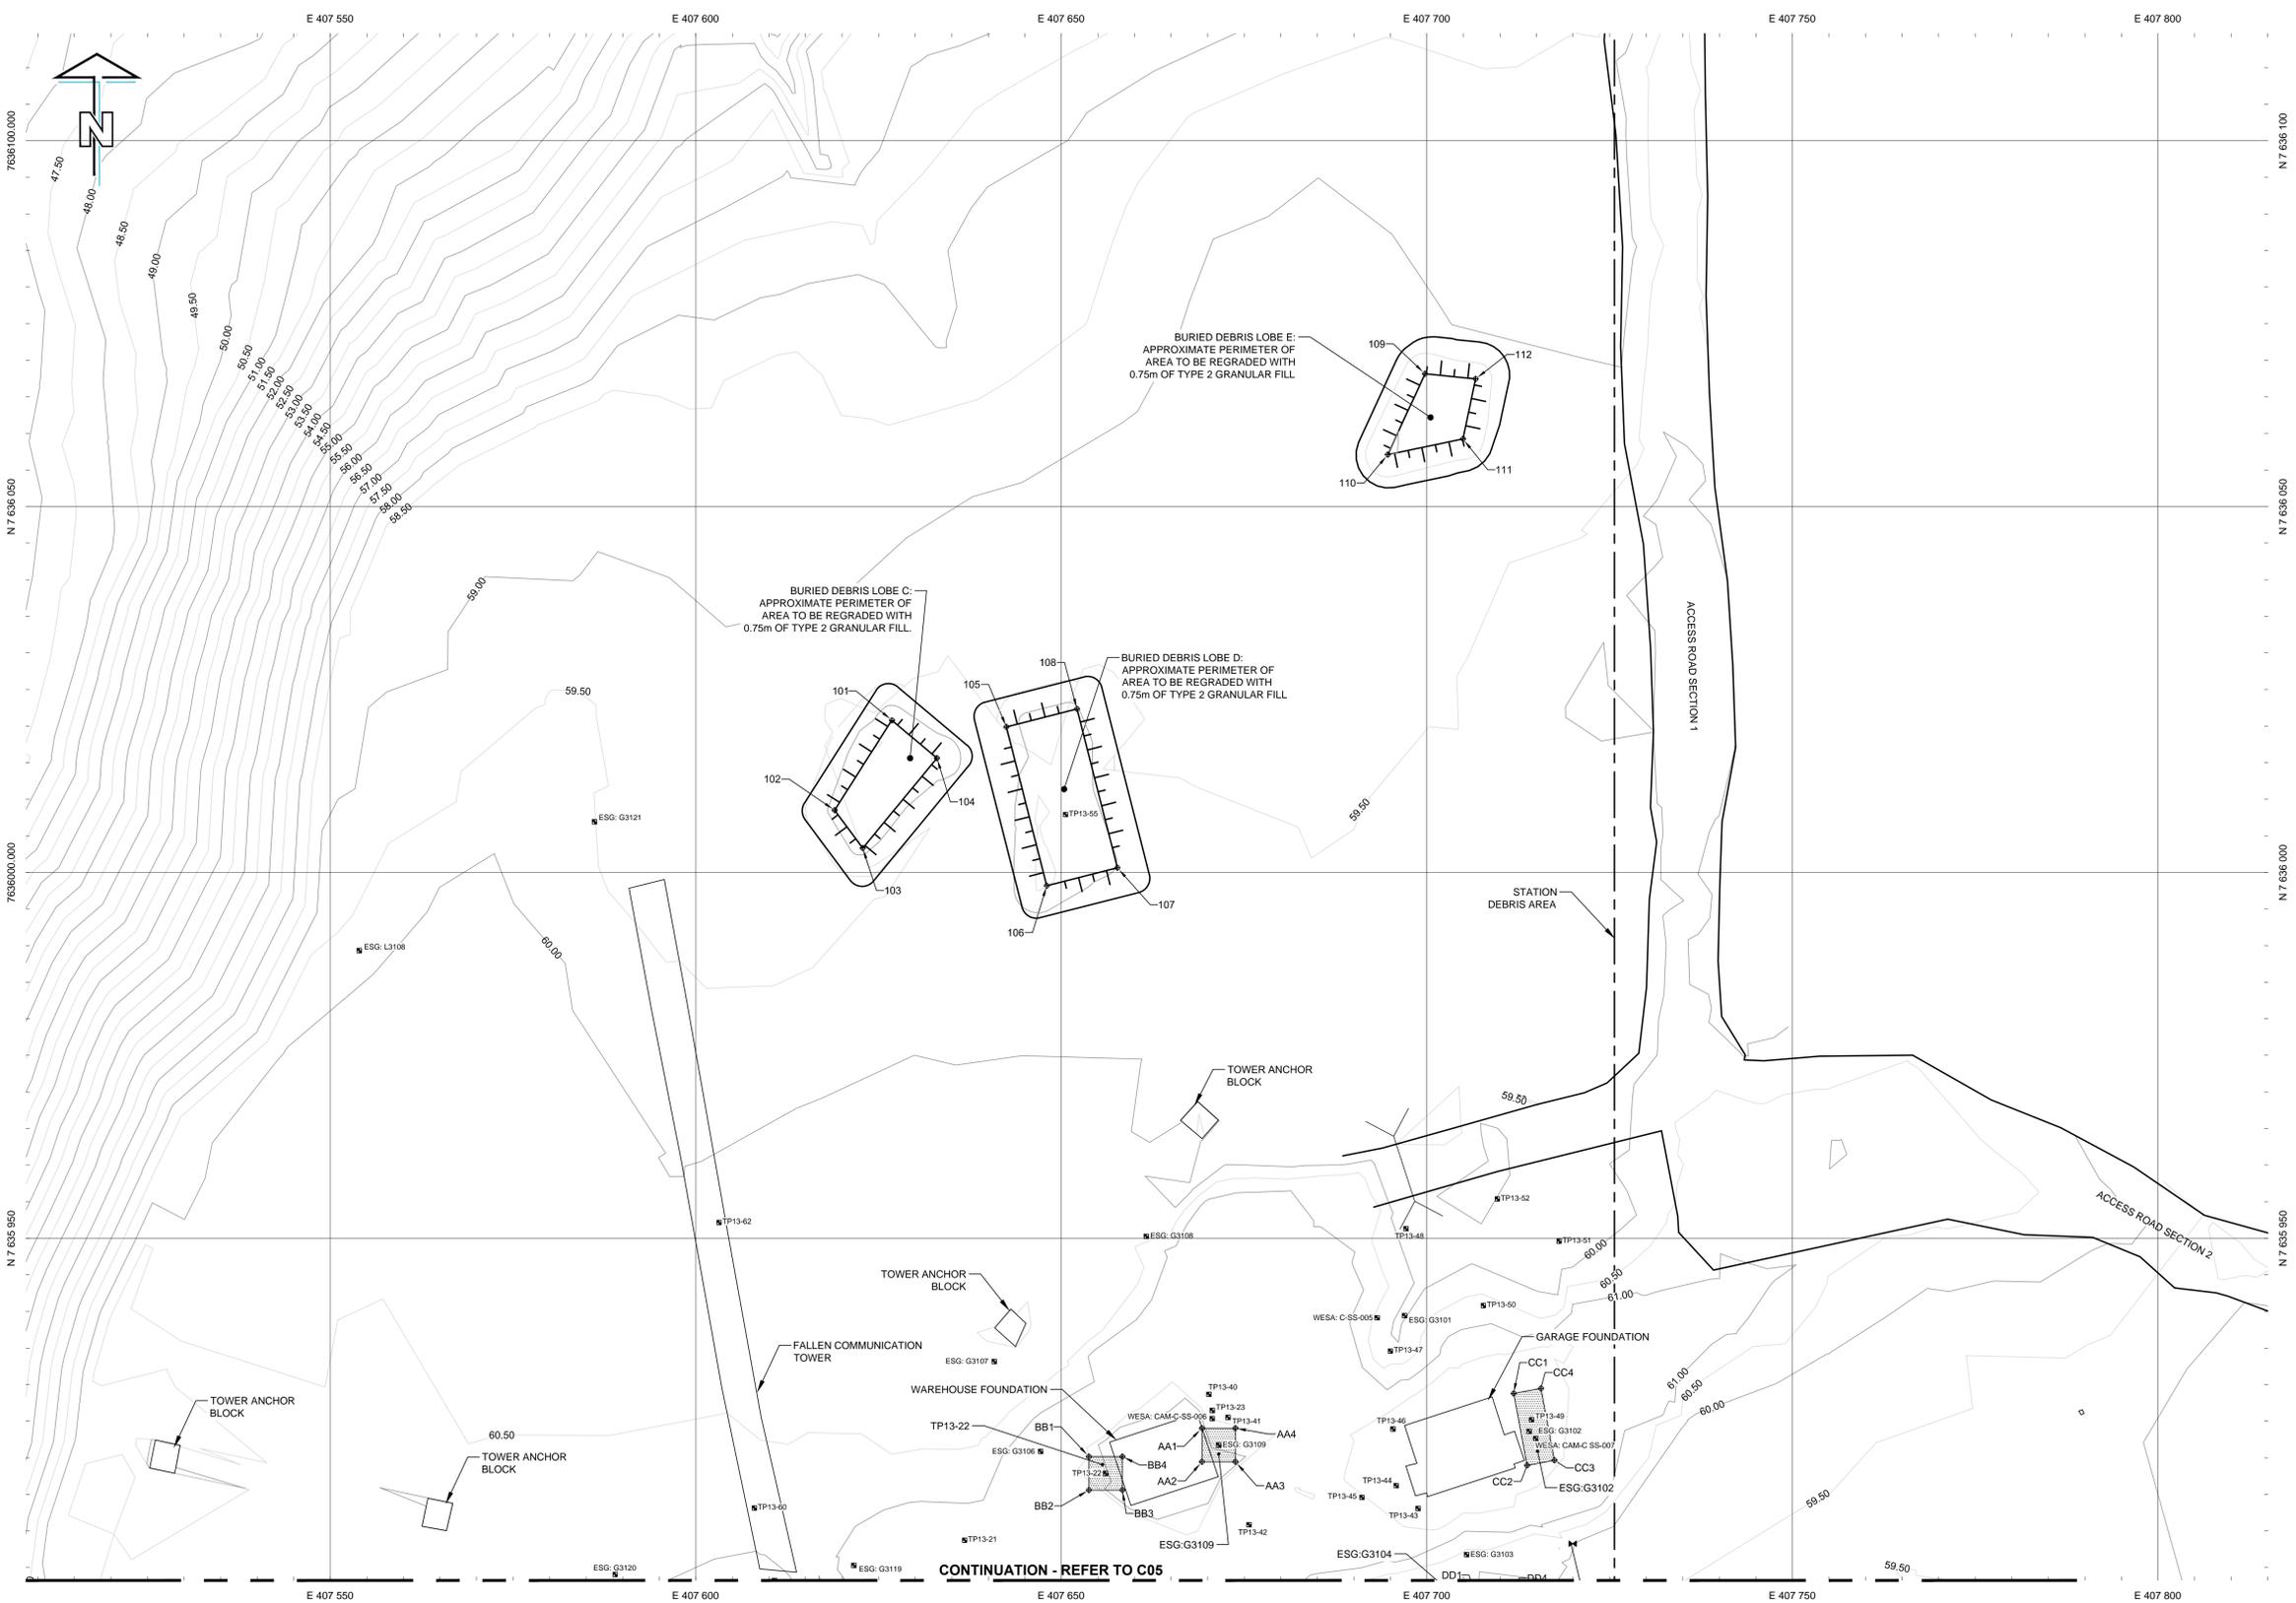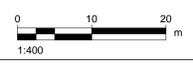E



CONTINUATION - REFER TO C05

Table with 3 columns: NO., COORDINATES (NORTHING, EASTING). Rows 101-104.

Table with 3 columns: NO., COORDINATES (NORTHING, EASTING). Rows 109-112.

Table with 3 columns: NO., COORDINATES (NORTHING, EASTING). Rows AA1-AA4.


Table with 3 columns: NO., COORDINATES (NORTHING, EASTING). Rows BB1-BB4.


Table with 3 columns: NO., COORDINATES (NORTHING, EASTING). Rows CC1-CC4.

Table with 3 columns: NO., COORDINATES (NORTHING, EASTING). Rows DD1-DD4.

Table with 3 columns: NO., COORDINATES (NORTHING, EASTING). Rows 105-108.

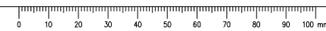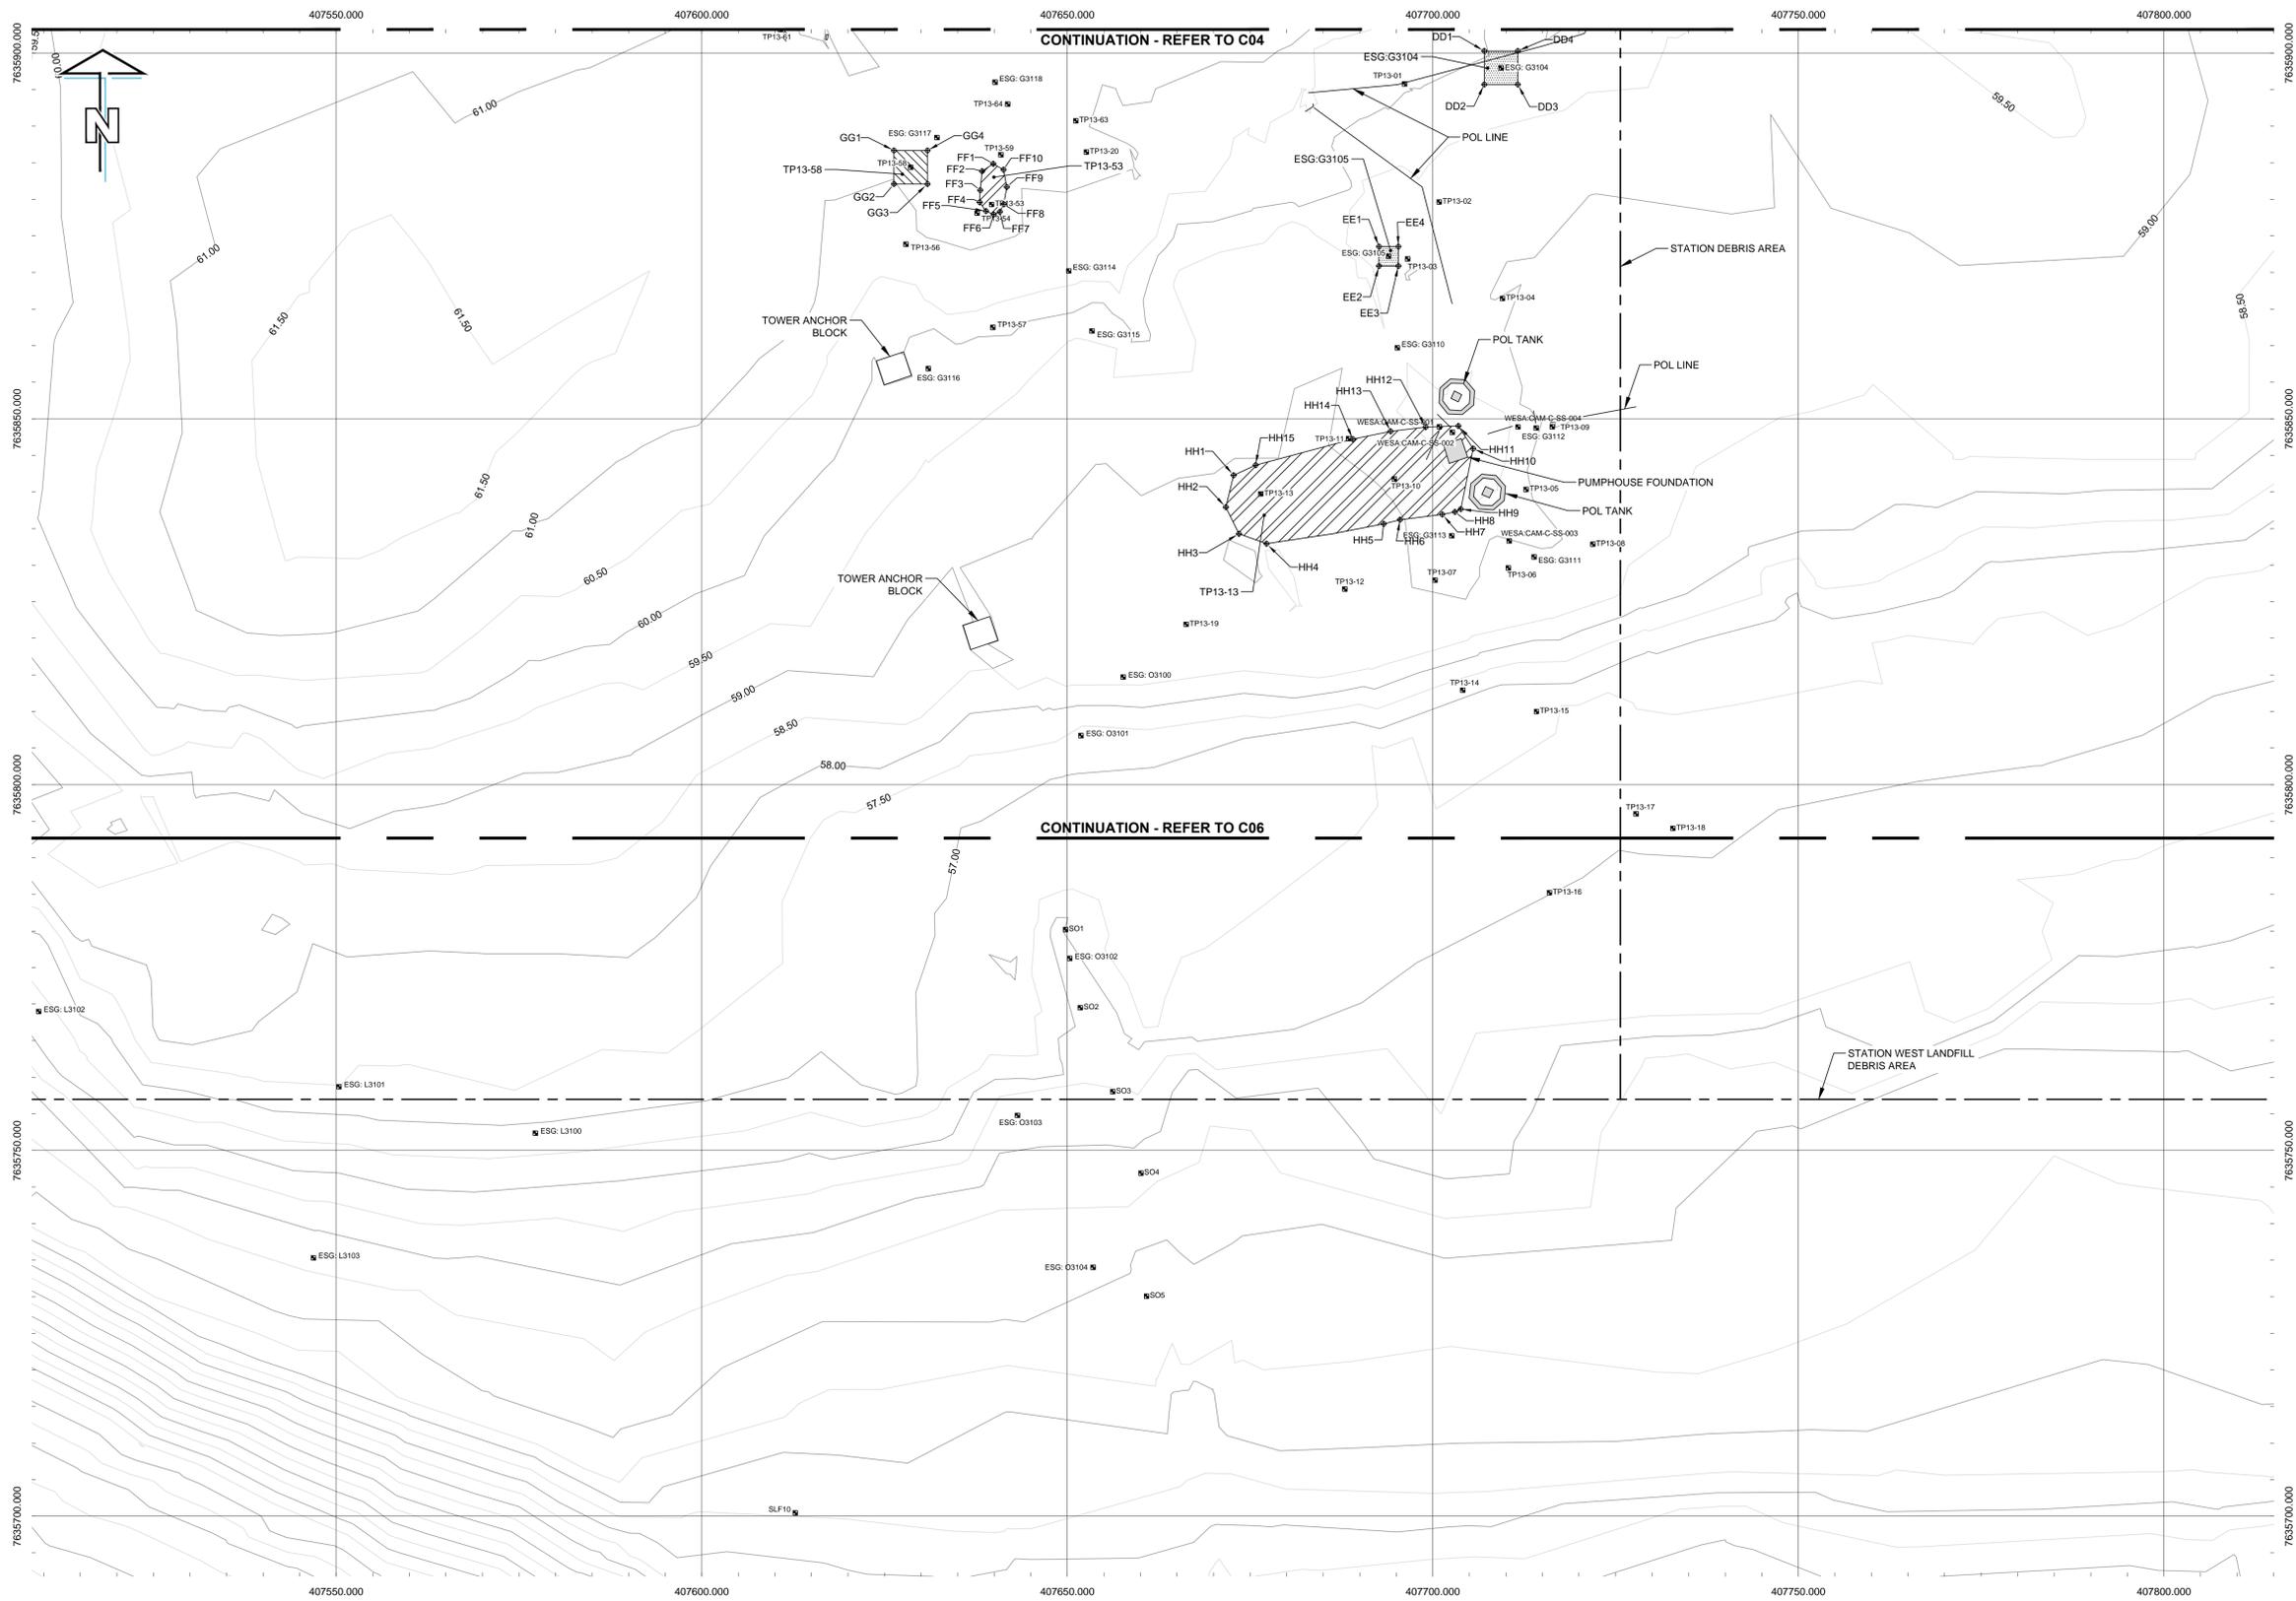Table with 7 columns: AREA NAME, APPROX. AREA (m²), ESTIMATED DEPTH OF CONTAMINATION (m), ESTIMATED VOLUME OF EXCAVATION (m³), CONTAMINATION CLASSIFICATION, COMMENTS, SAMPLE POINTS (NORTHING, EASTING). Rows ESG-G3109, TP13-22, ESG-G3102.





TIER I CONTAMINATED SOIL EXCAVATION ESG-G3104		
NO.	COORDINATES	
	NORTHING	EASTING
DD1	7 635 900.3	407 707.0
DD2	7 635 895.7	407 707.0
DD3	7 635 895.7	407 711.6
DD4	7 635 900.3	407 711.6

TIER I CONTAMINATED SOIL EXCAVATION ESG-G3105		
NO.	COORDINATES	
	NORTHING	EASTING
EE1	7 635 873.5	407 692.6
EE2	7 635 870.9	407 692.6
EE3	7 635 870.9	407 695.3
EE4	7 635 873.5	407 695.3

TYPE B PHC CONTAMINATED SOIL EXCAVATION TP13-53		
NO.	COORDINATES	
	NORTHING	EASTING
FF1	7 635 884.9	407 639.9
FF2	7 635 883.8	407 638.4
FF3	7 635 881.2	407 638.1
FF4	7 635 879.6	407 638.0
FF5	7 635 878.4	407 638.9
FF6	7 635 877.9	407 639.9
FF7	7 635 878.3	407 640.8
FF8	7 635 879.3	407 641.3
FF9	7 635 881.7	407 641.7
FF10	7 635 884.0	407 641.3

TIER II CONTAMINATED SOIL EXCAVATION TP13-59		
NO.	COORDINATES	
	NORTHING	EASTING
GG1	7 635 886.7	407 636.3
GG2	7 635 882.1	407 630.9
GG3	7 635 882.1	407 630.9
GG4	7 635 886.7	407 630.9

TYPE B PHC CONTAMINATED SOIL EXCAVATION TP13-13		
NO.	COORDINATES	
	NORTHING	EASTING
HH1	7 635 842.3	407 672.8
HH2	7 635 837.9	407 671.7
HH3	7 635 834.3	407 673.5
HH4	7 635 832.9	407 677.3
HH5	7 635 835.6	407 693.3
HH6	7 635 836.2	407 695.5
HH7	7 635 836.9	407 701.3
HH8	7 635 837.3	407 701.3
HH9	7 635 837.7	407 703.8
HH10	7 635 845.9	407 705.5
HH11	7 635 849.0	407 703.5
HH12	7 635 848.9	407 699.0
HH13	7 635 848.3	407 694.2
HH14	7 635 847.2	407 689.0
HH15	7 635 843.7	407 675.8

AREA NAME	APPROX. AREA (m ²)	ESTIMATED DEPTH OF CONTAMINATION (m)	ESTIMATED VOLUME OF EXCAVATION (m ³)	CONTAMINATION CLASSIFICATION	COMMENTS	SAMPLE POINTS	
						NORTHING	EASTING
ESG-G3104	21	0.3	8	TIER I	OFF SITE DISPOSAL	7 635 898.0	407 709.3
ESG-G3105	7	0.3	3	TIER I	OFF SITE DISPOSAL	7 635 872.2	407 694.0
TP13-53	20	0.5	12	TYPE B PHC	ON SITE TREATMENT	7 635 881.8	407 639.7
TP13-58	21	0.3	8	TIER II	OFF SITE DISPOSAL	7 635 884.4	407 628.6
TP13-13	375	1.0	417	TYPE B PHC	OFF SITE DISPOSAL	7 635 841.0	407 690.4

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- REFER TO DWG. C02 FOR ENTIRE DEBRIS AREA LIMITS.
- REGRADED SIDE SLOPES 6H:1V UNLESS NOTED OTHERWISE.

LEGEND:

- APPROXIMATE EXTENT OF BORROW AREA
- - - DEBRIS AREA
- EXISTING CULVERT
- SAMPLE LOCATION
- ▨ TIER I CONTAMINATED SOIL
- ▩ TIER II CONTAMINATED SOIL
- ▧ TYPE B PHC CONTAMINATED SOIL

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Client / Client

**PUBLIC WORKS AND
GOVERNMENT SERVICES
CANADA**

Project title / Titre du projet

**CAM-C MATHESON POINT
REMEDIATION PROJECT**

Approved by / Approuvé par

B. FEDORAK

Designed by / Conçu par

K. SCOTT

Drawn by / Dessiné par

J. KNOTT

PM/CSG Project Manager / Administrateur de Projets TPSGC

J. HOYT

PM/CSG Architectural and Engineering Resources Manager / Ressources Architectural et de Directeur d'ingénierie, TPSGC

Client / Client

PUBLIC WORKS AND GOVERNMENT SERVICES CANADA

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**STATION POL
SITE PLAN
SHEET 2 OF 2**

Project No. / No. du projet

R.064062


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OF 10

Revision no. / La Révision no.

E



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3. REFER TO DWG. C02 FOR ENTIRE DEBRIS AREA LIMITS.
4. ALL SURFACE DEBRIS IS TO BE REMOVED FROM LANDFILL PRIOR TO FILL PLACEMENT.

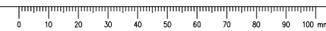LEGEND:

- - - - - APPROXIMATE EXTENT OF BORROW AREA
--- DEBRIS AREA
--- LANDFILL AREA
A-CROSS SECTION MARKER

Professional Seals / Sceaux

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Table with 3 columns: Revision, Description/Description, Date/Date. Includes revisions E, D, C, B, A and a final Revision/Description/Date row.

PUBLIC WORKS AND GOVERNMENT SERVICES CANADA

Project title/Titre du projet

CAM-C MATHESON POINT REMEDIATION PROJECT

Approved by/Approuvé par: B. FEDORAK

Designed by/Concept par: K. SCOTT

Drawn by/Dessiné par: J. KNOTT

PWSSC Project Manager/Administrateur de Projets TPSGC: J. HOYT


PWSSC Architectural and Engineering Resources Manager/Ressources Architectural et de Directeur d'ingénierie, TPSGC

Client/Client: PUBLIC WORKS AND GOVERNMENT SERVICES CANADA

Drawing title/Titre du dessin

STATION WEST LANDFILL SITE PLAN

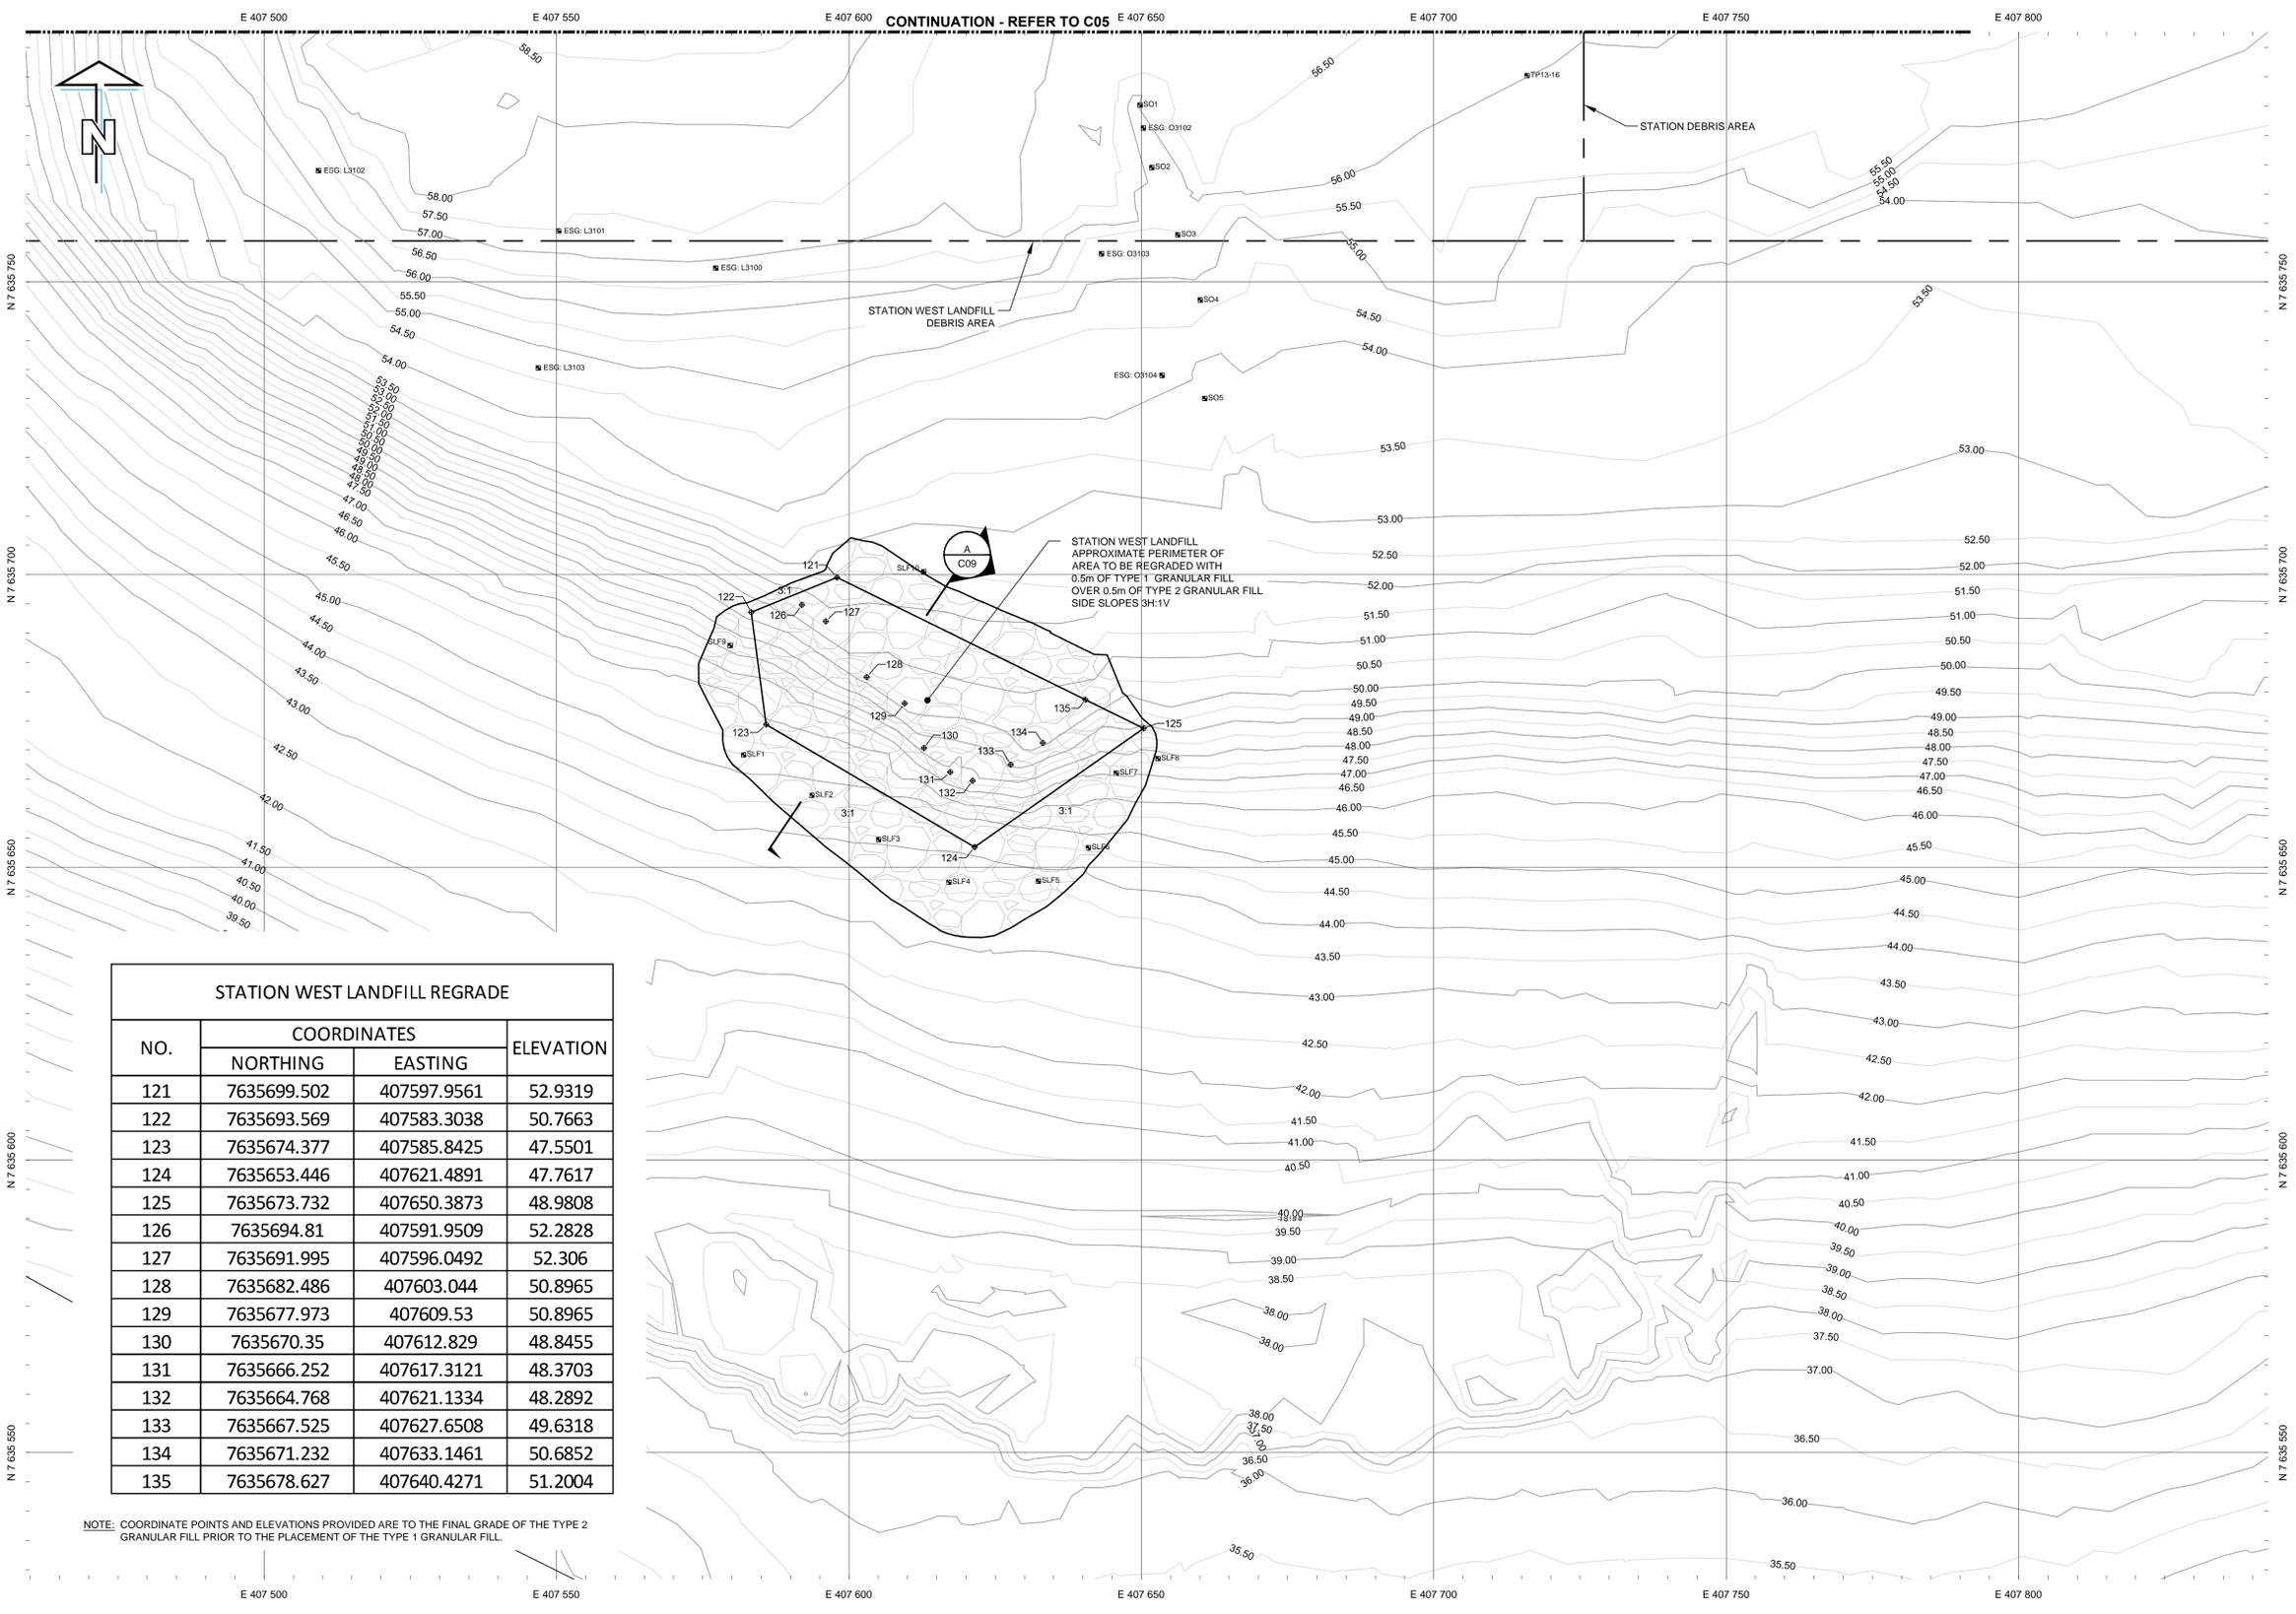Table with 3 columns: Project No./No. du projet (R.064062), Sheet/Feuille (C06 OF 10), Revision no./La Revision no. (E)



STATION WEST LANDFILL REGRADE table with columns: NO., COORDINATES (NORTHING, EASTING), and ELEVATION. Lists points 121 through 135.

NOTE: COORDINATE POINTS AND ELEVATIONS PROVIDED ARE TO THE FINAL GRADE OF THE TYPE 2 GRANULAR FILL PRIOR TO THE PLACEMENT OF THE TYPE 1 GRANULAR FILL.



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- REFER TO DWG. C02 FOR ENTIRE DEBRIS AREA LIMITS.
- REPLACE CLEAN BURIED DEBRIS EXCAVATION SOILS FROM THE EXCAVATION OF THE AIRSTRIP LANDFILL AS BACKFILL CAP AREAS WITH 0.3m OF TYPE 3 GRANULAR FILL OVER THE CLEAN BACKFILL.
- DEPTH TO LANDFILL EXCAVATION TO EXTEND TO BASE OF DEBRIS. LIMIT AND DEPTH OF EXCAVATION TO BE VERIFIED BY EXCAVATION OF TEST PITS.

LEGEND:

- DEBRIS AREA
- LANDFILL AREA
- CROSS SECTION MARKER
- BURIED DEBRIS EXCAVATION

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Revision/Revision	Description/Description	Date/Date

PUBLIC WORKS AND GOVERNMENT SERVICES CANADA

Project title/Titre du projet

CAM-C MATHESON POINT REMEDIATION PROJECT

Approved by/Approuvé par
B. FEDORAK

Designed by/Concept par
K. SCOTT

Drawn by/Dessiné par
J. KNOTT

PWSSC Project Manager/Administrateur de Projets TPSGC
J. HOYT


PWSSC Architectural and Engineering Resources Manager/ Ressources Architectural et de Directeur d'ingénierie, TPSGC

Client/Client
PUBLIC WORKS AND GOVERNMENT SERVICES CANADA


Drawing title/Titre du dessin

AIRSTRIP LANDFILL SITE PLAN

Project No./No. du projet R.064062	Sheet/Feuille C07 OF 10	Revision no./ La Revision no. E
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AIRSTRIP LANDFILL EXCAVATION		
NO.	COORDINATES	
	NORTHING	EASTING
KK1	7 635 683.5	408 358.7
KK2	7 635 716.5	408 377.5
KK3	7 635 729.7	408 376.4
KK4	7 635 718.3	408 400.8
KK5	7 635 687.9	408 374.2
KK6	7 635 689.5	408 353.7
KK7	7 635 676.9	408 354.0
KK8	7 635 686.6	408 376.5

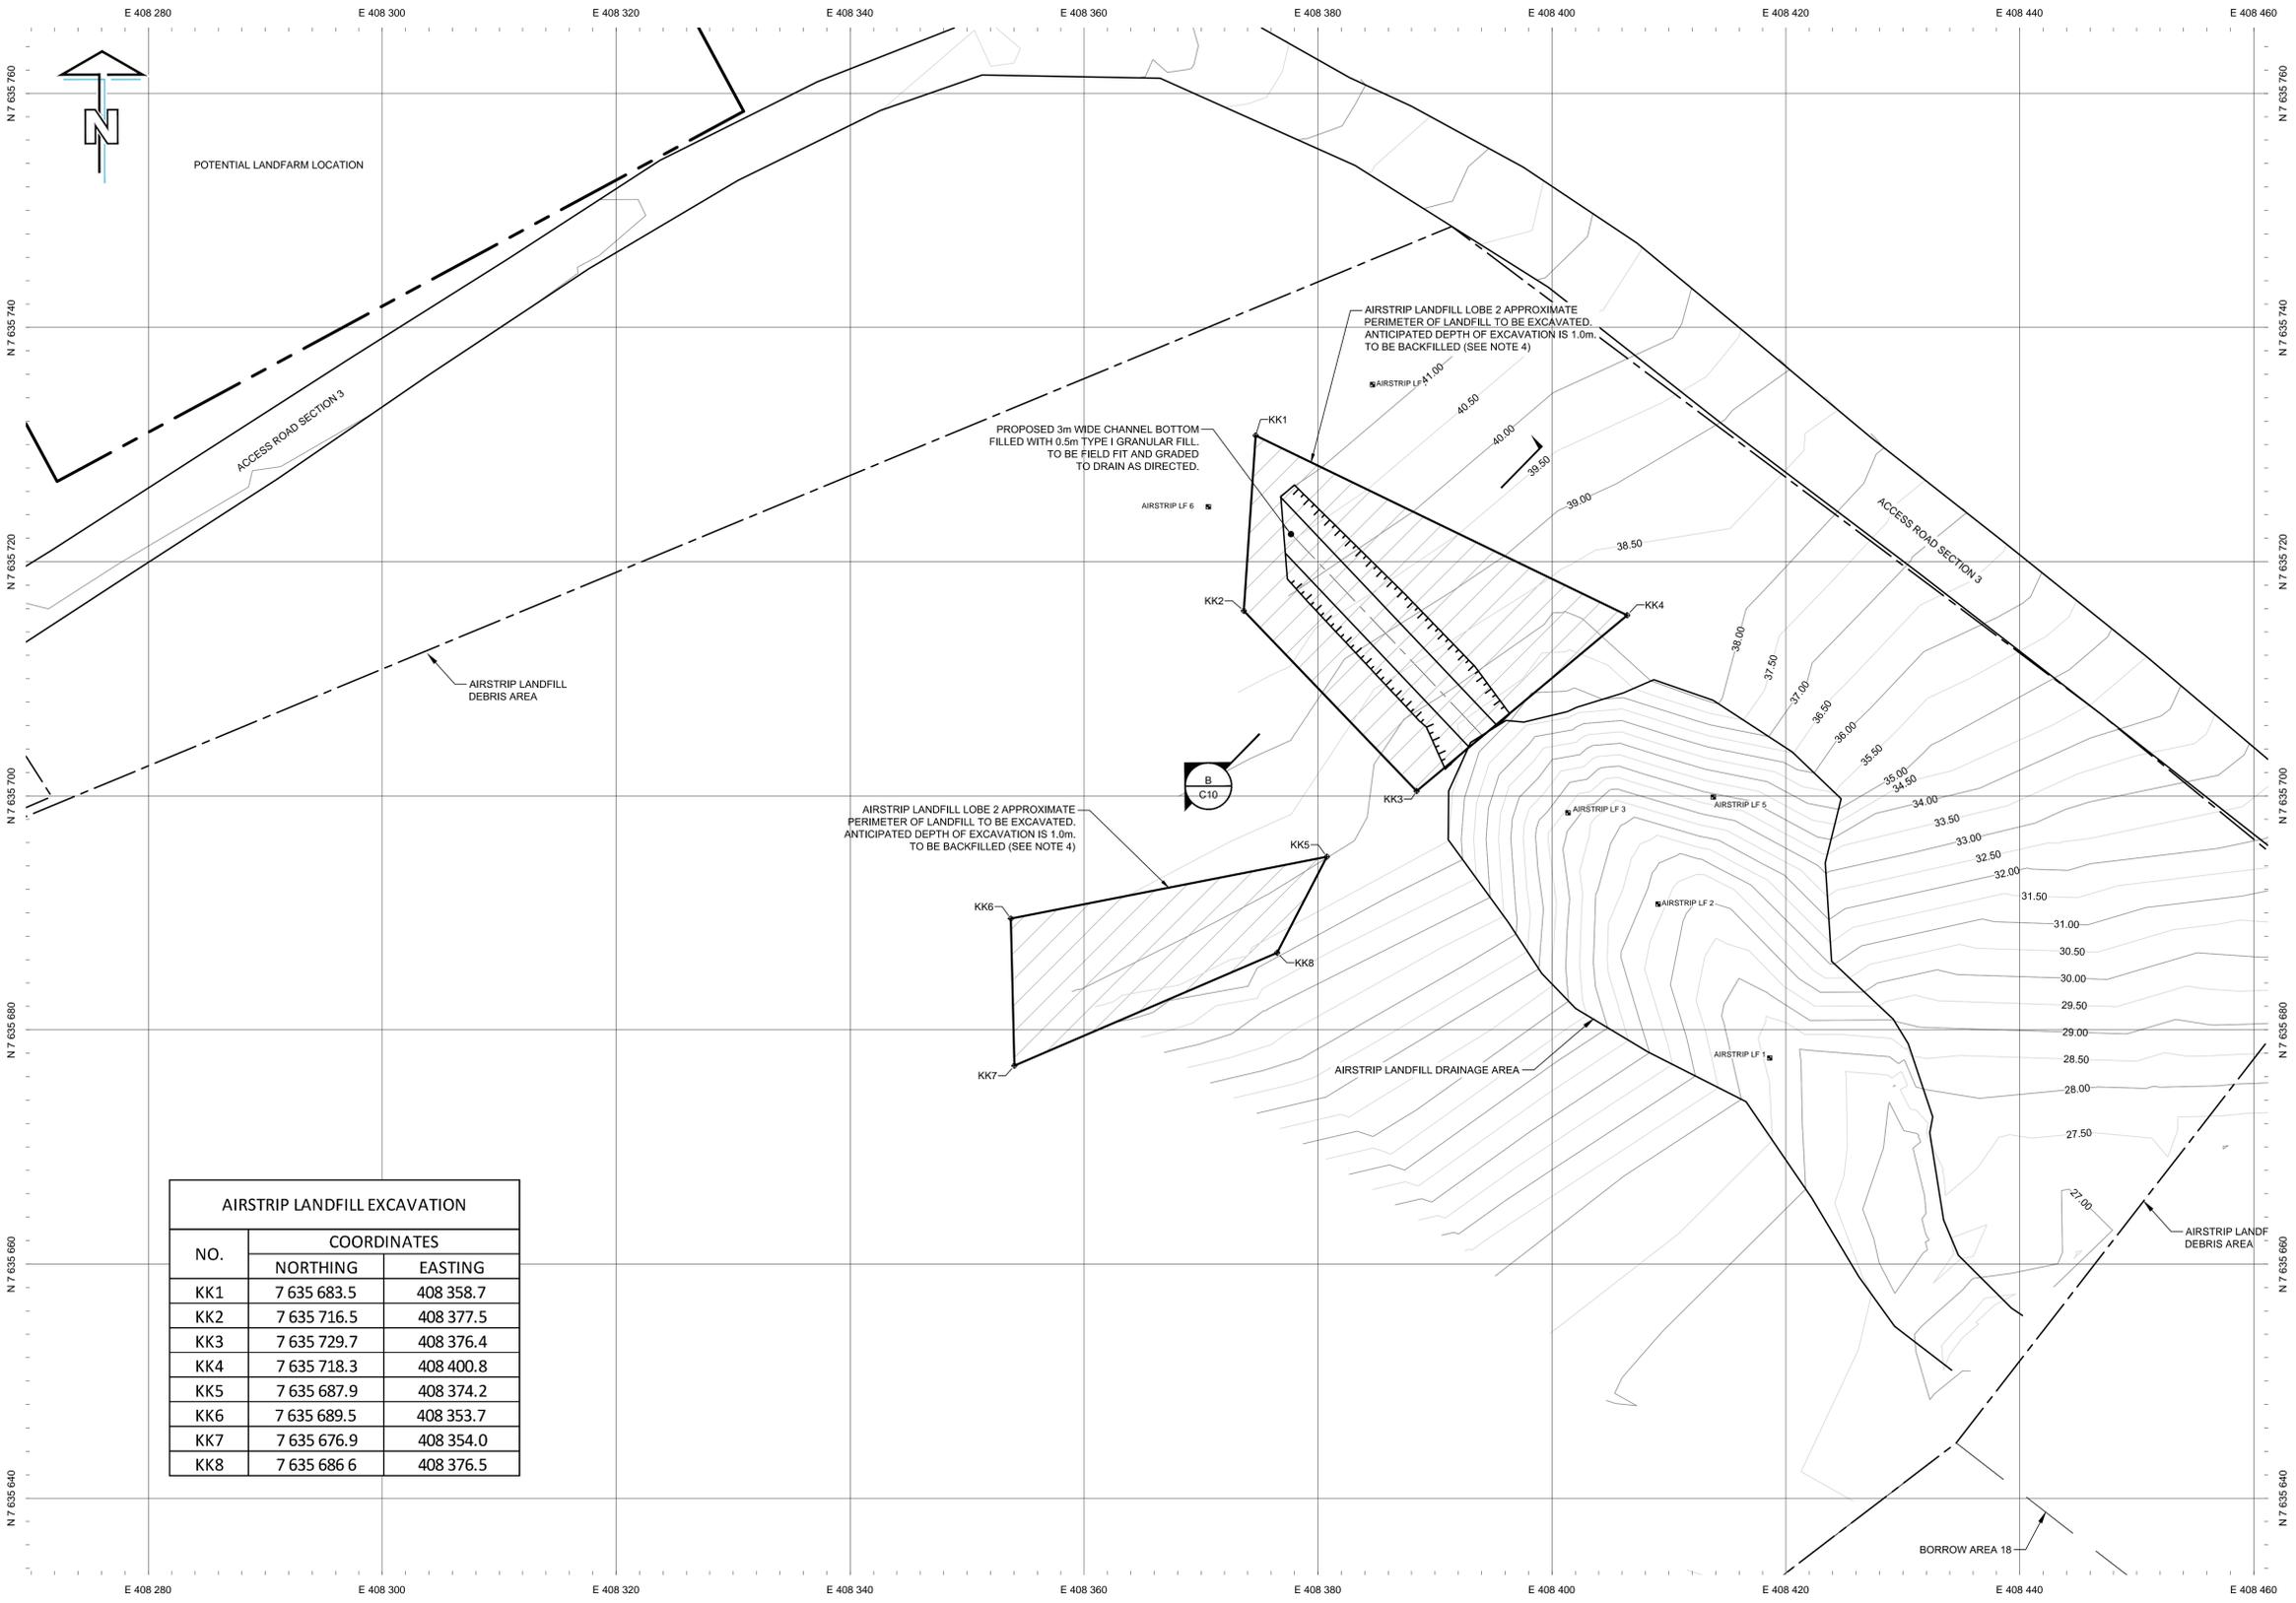

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NOT FOR CONSTRUCTION**
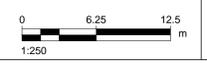
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- ALL DIMENSIONS ARE IN METRES UNLESS NOTED OTHERWISE.
- REFER TO DWG. C02 FOR ENTIRE DEBRIS AREA LIMITS.

LEGEND:

- APPROXIMATE EXTENT OF BORROW AREA
- - - DEBRIS AREA
- ▨ TYPE B CONTAMINATED SOIL

Professional Seals / Sceaux

DO NOT SCALE DRAWINGS

E	ISSUED FOR TENDER	16/11/23
D	DRAFT REVISION	16/09/23
C	ISSUED FOR TENDER	14/02/27
B	ISSUED FOR 75% DESIGN	14/01/03
A	ISSUED FOR 75% DESIGN	13/12/02
Revision / Revision	Description / Description	Date / Date

Client/Client

**PUBLIC WORKS AND
GOVERNMENT SERVICES
CANADA**

Project title/Titre du projet

**CAM-C MATHESON POINT
REMEDATION PROJECT**

Approved by/Approuvé par

B. FEDORAK

Designed by/Concept par

K. SCOTT

Drawn by/Dessiné par

J. KNOTT

PM/SC Project Manager/Administrateur de Projets TPSGC

J. HOYT

PM/SC Architectural and Engineering Resources Manager/
Ressources Architectural et de Directeur d'ingénierie, TPSGC

Client/Client

PUBLIC WORKS AND GOVERNMENT SERVICES CANADA

Drawing title/Titre du dessin

**BEACH POL
SITE PLAN**

Project No./No. du projet

R.064062


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C08

OF 10



Revision no./
La Revision no.

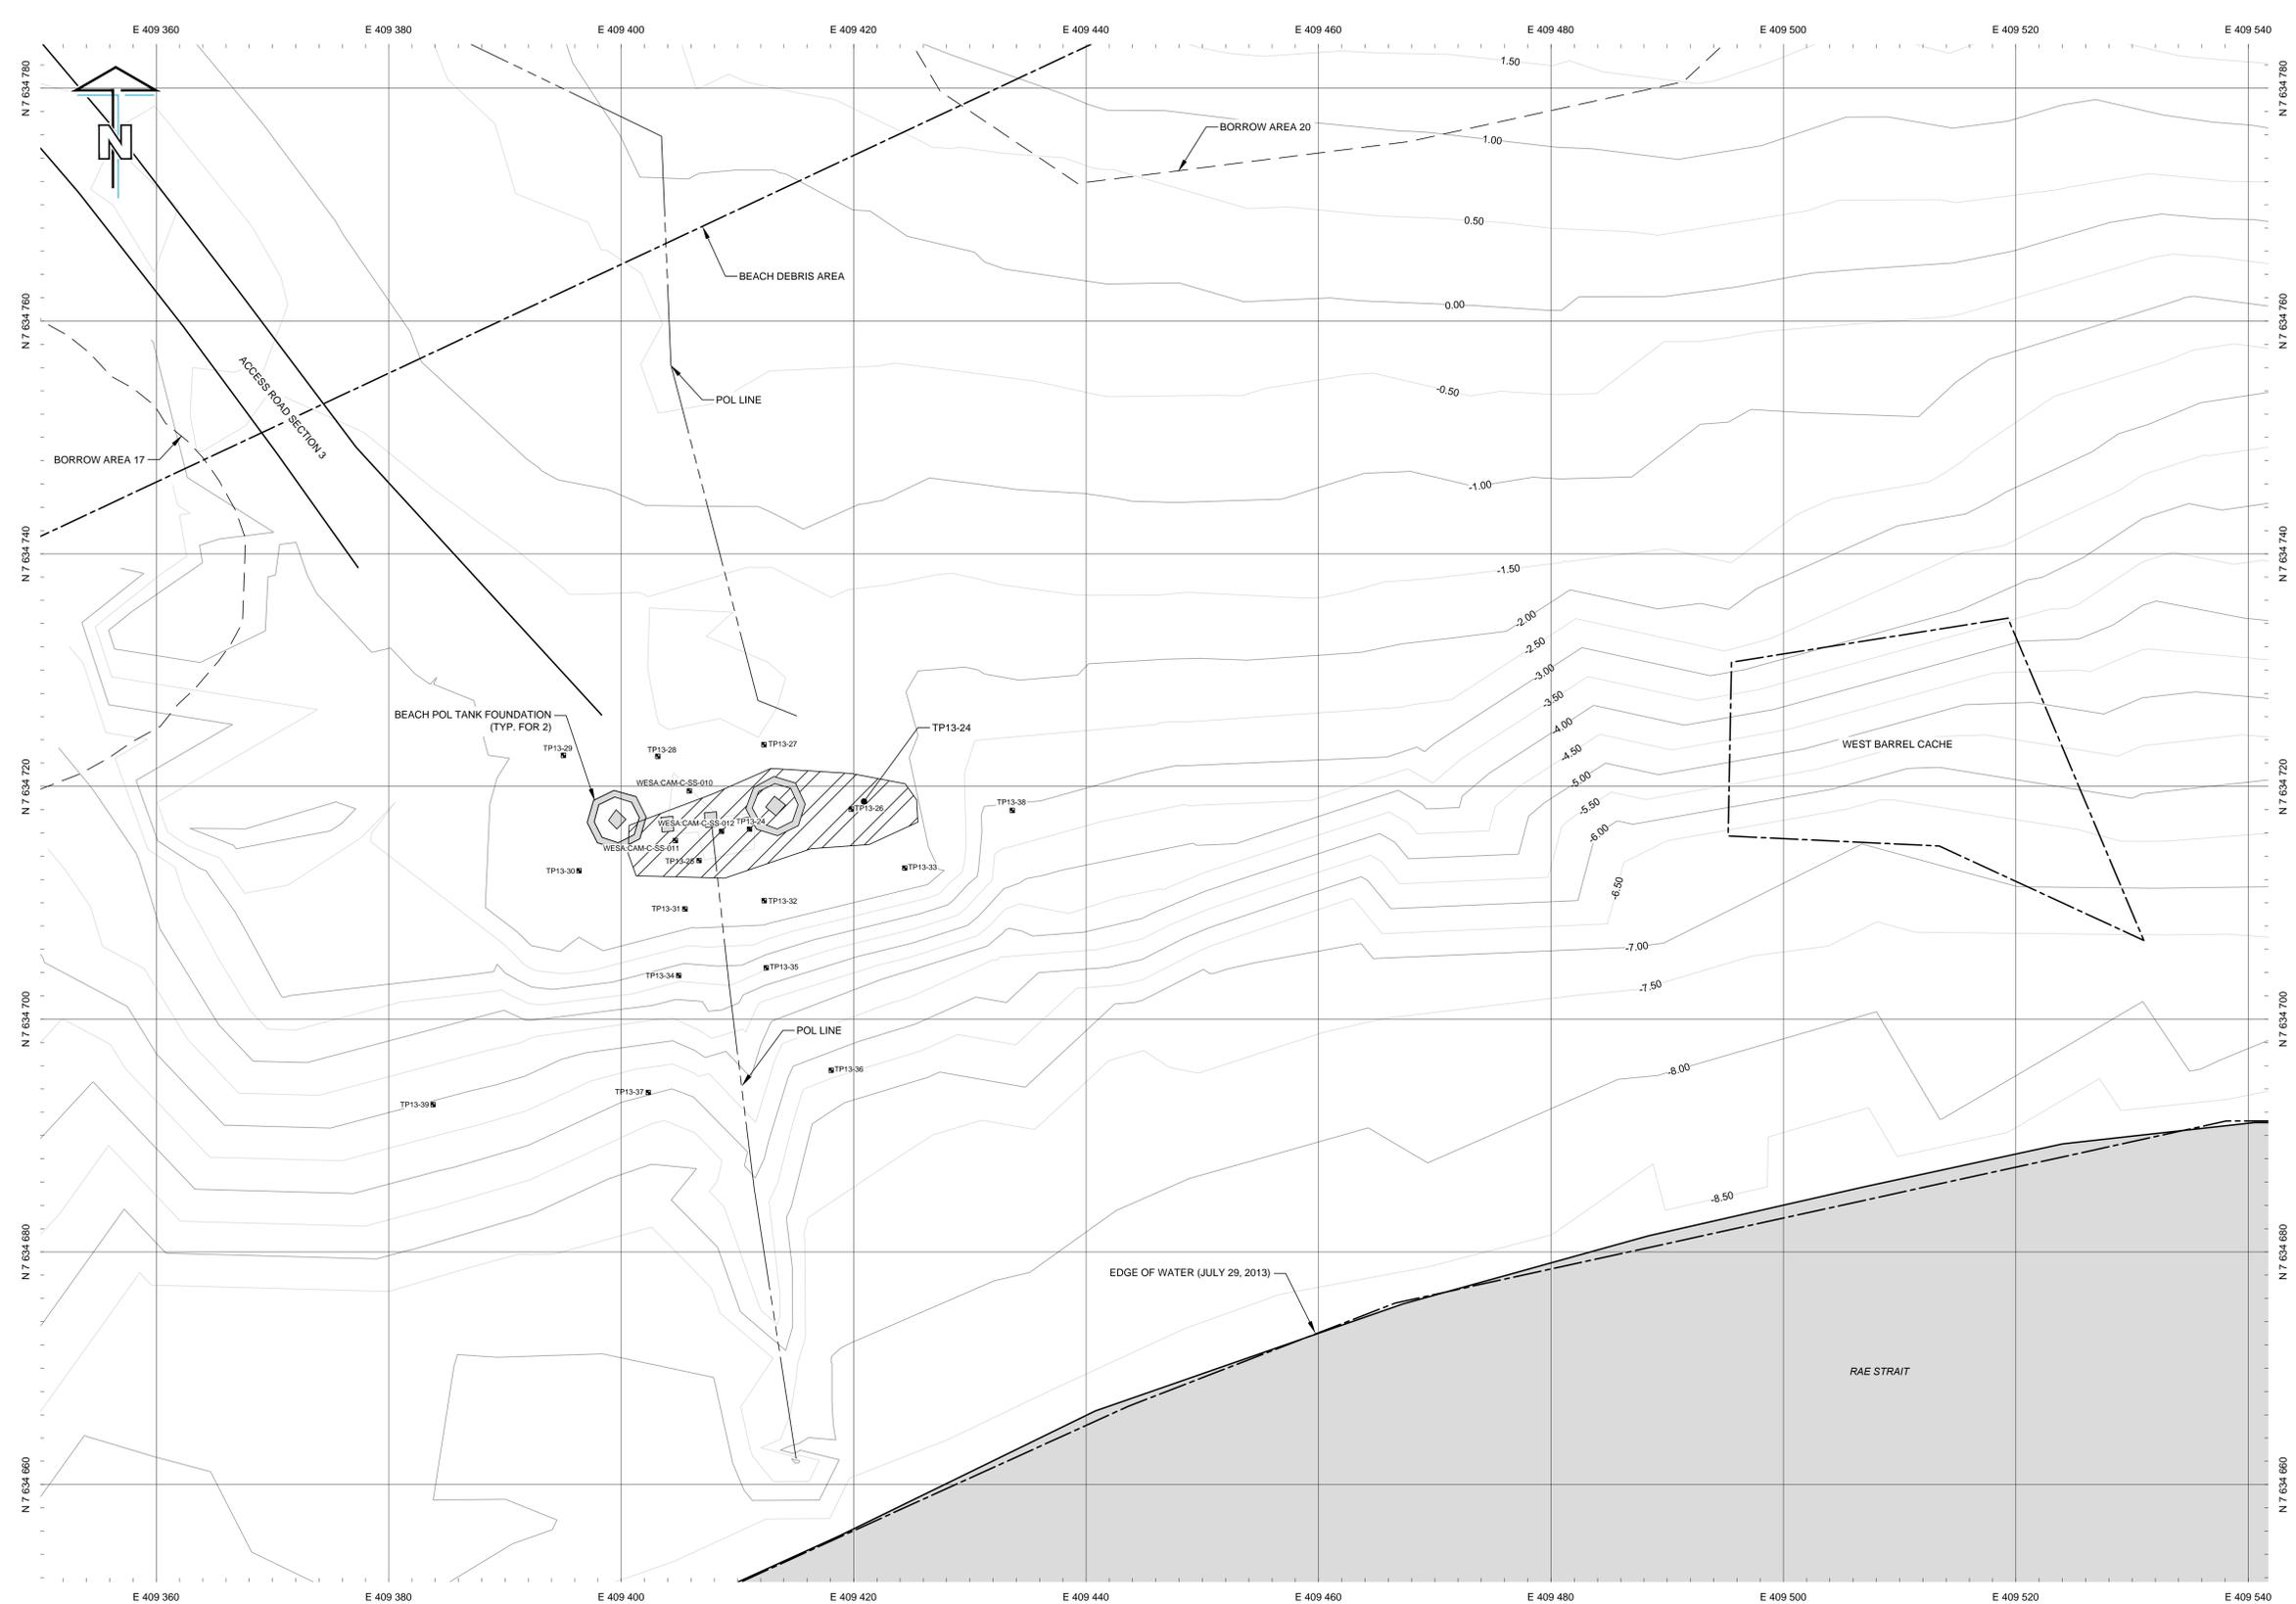E



TYPE B PHC CONTAMINATED SOIL EXCAVATION TP13-53		
NO.	COORDINATES	
	NORTHING	EASTING
JJ1	7 634 716.7	409 400.7
JJ2	7 634 714.2	409 400.6
JJ3	7 634 712.3	409 401.3
JJ4	7 634 712.1	409 408.9
JJ5	7 634 714.7	409 416.4
JJ6	7 634 715.0	409 421.3
JJ7	7 634 716.9	409 425.5
JJ8	7 634 718.8	409 425.4
JJ9	7 634 720.2	409 424.4
JJ10	7 634 721.1	409 419.8
JJ11	7 634 721.6	409 412.9
JJ12	7 634 719.4	409 407.9

CONTAMINATED SOIL TO BE EXCAVATED							
AREA NAME	APPROX. AREA (m ²)	ESTIMATED DEPTH OF CONTAMINATION (m)	ESTIMATED VOLUME OF EXCAVATION (m ³)	CONTAINMENT CLASSIFICATION	COMMENTS	REFERENCE POINTS	
						NORTHING	EASTING
TP13-24	155	1.2	115	TYPE B PHC	ON SITE TREATMENT	7 634 716.1	409 412.6

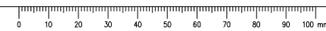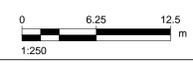



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Revision/Revision	Description/Description	Date/Date
E	ISSUED FOR TENDER	16/11/23
D	DRAFT REVISION	16/09/23
C	ISSUED FOR TENDER	14/02/27
B	ISSUED FOR 75% DESIGN	14/01/03
A	ISSUED FOR 75% DESIGN	13/12/02

**PUBLIC WORKS AND
GOVERNMENT SERVICES
CANADA**

Project title/Titre du projet

**CAM-C MATHESON POINT
REMEDIATION PROJECT**

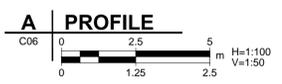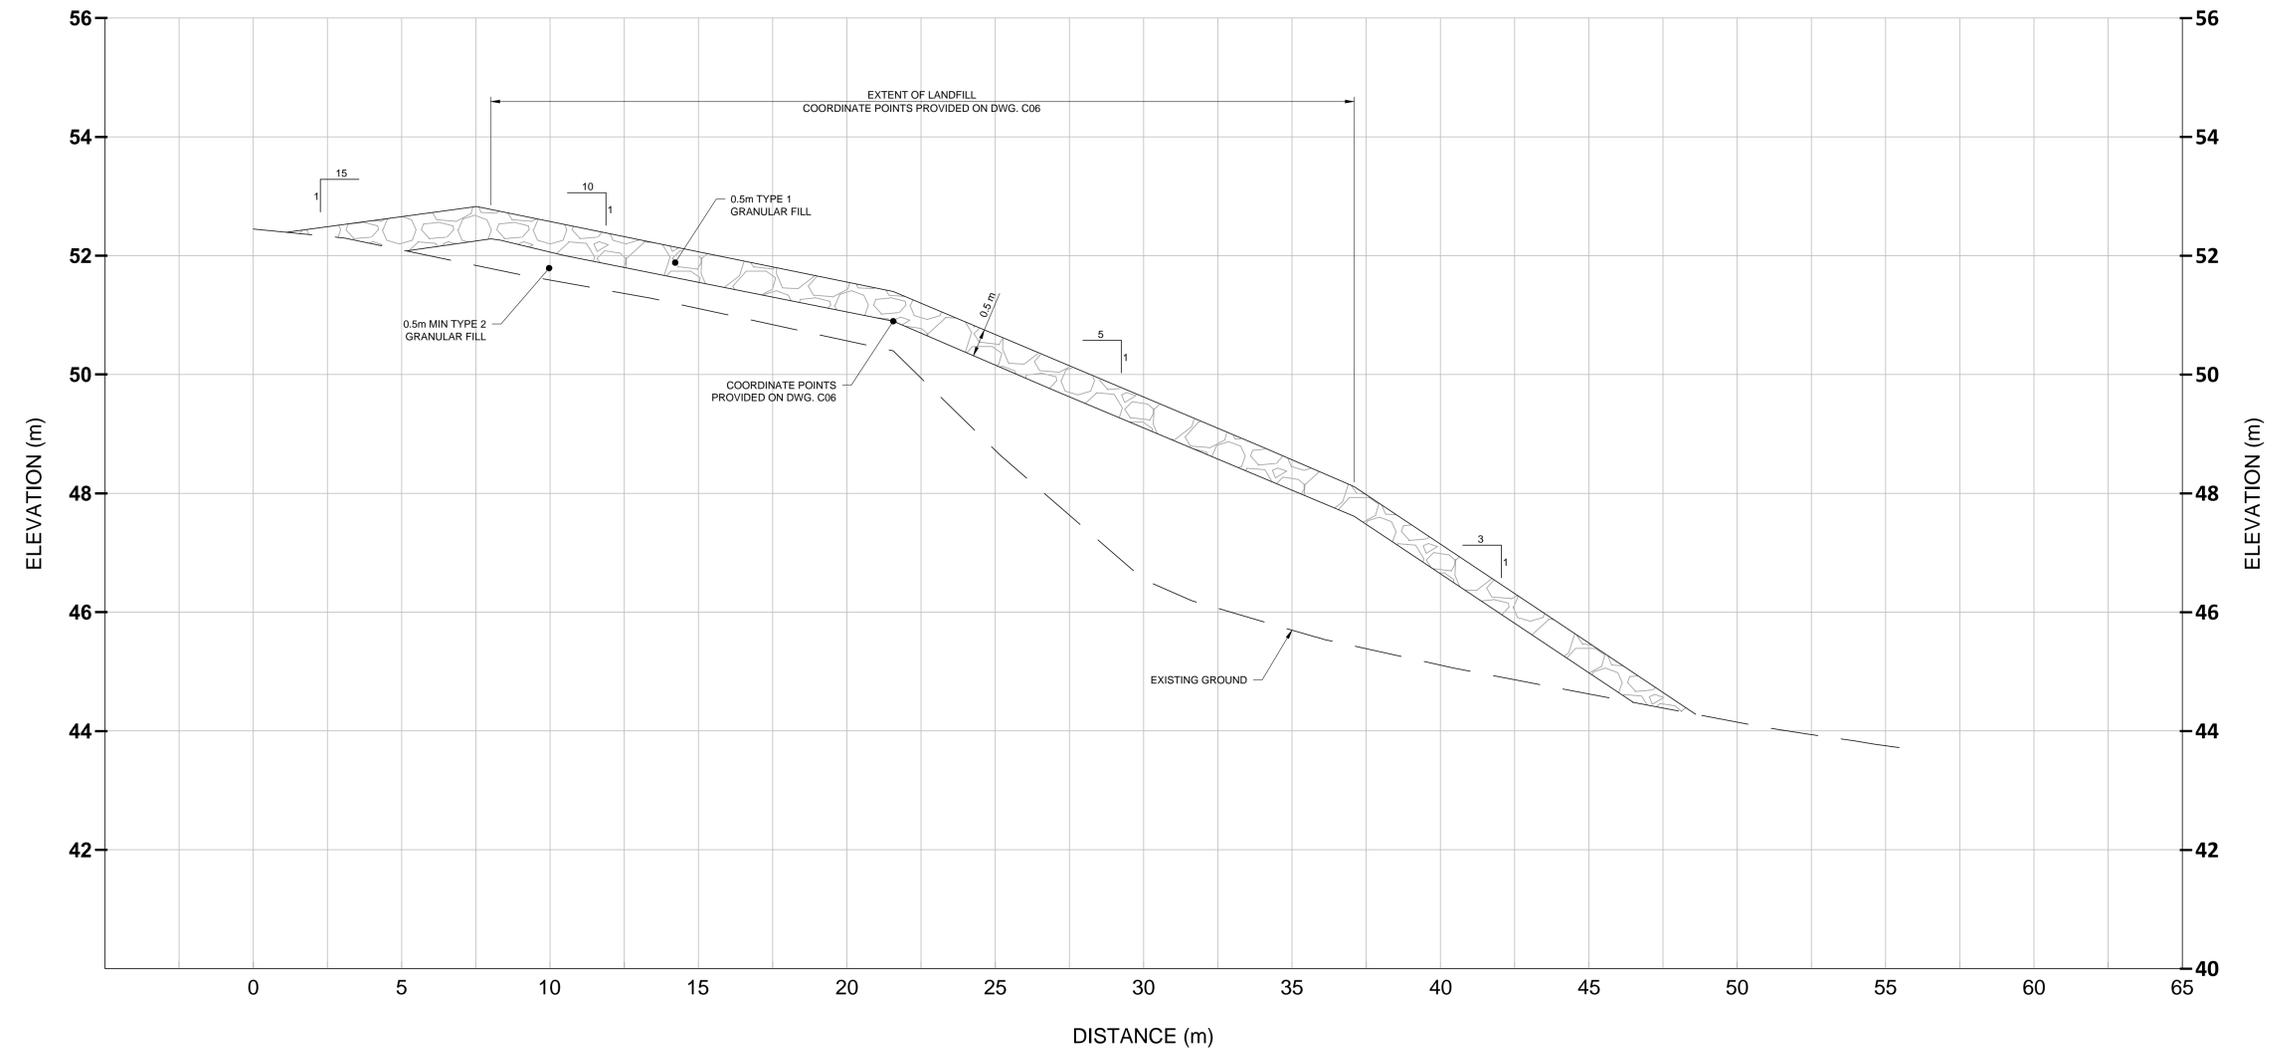Approved by/Approuvé par
B. FEDORAK

Designed by/Concept par
K. SCOTT

Drawn by/Dessiné par
J. KNOTT

PWSSC Project Manager/Administrateur de Projets TPSGC
J. HOYT

PWSSC Architectural and Engineering Resources Manager/
Ressources Architectural et de Directeur d'Ingénierie, TPSGC

Client/client
PUBLIC WORKS AND GOVERNMENT SERVICES CANADA

Drawing title/Titre du dessin

**STATION WEST LANDFILL
CROSS SECTION**

Project No./No. du projet R.064062	Sheet/Feuille C09 OF 10	Revision no./ La Revision no. E
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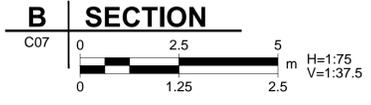
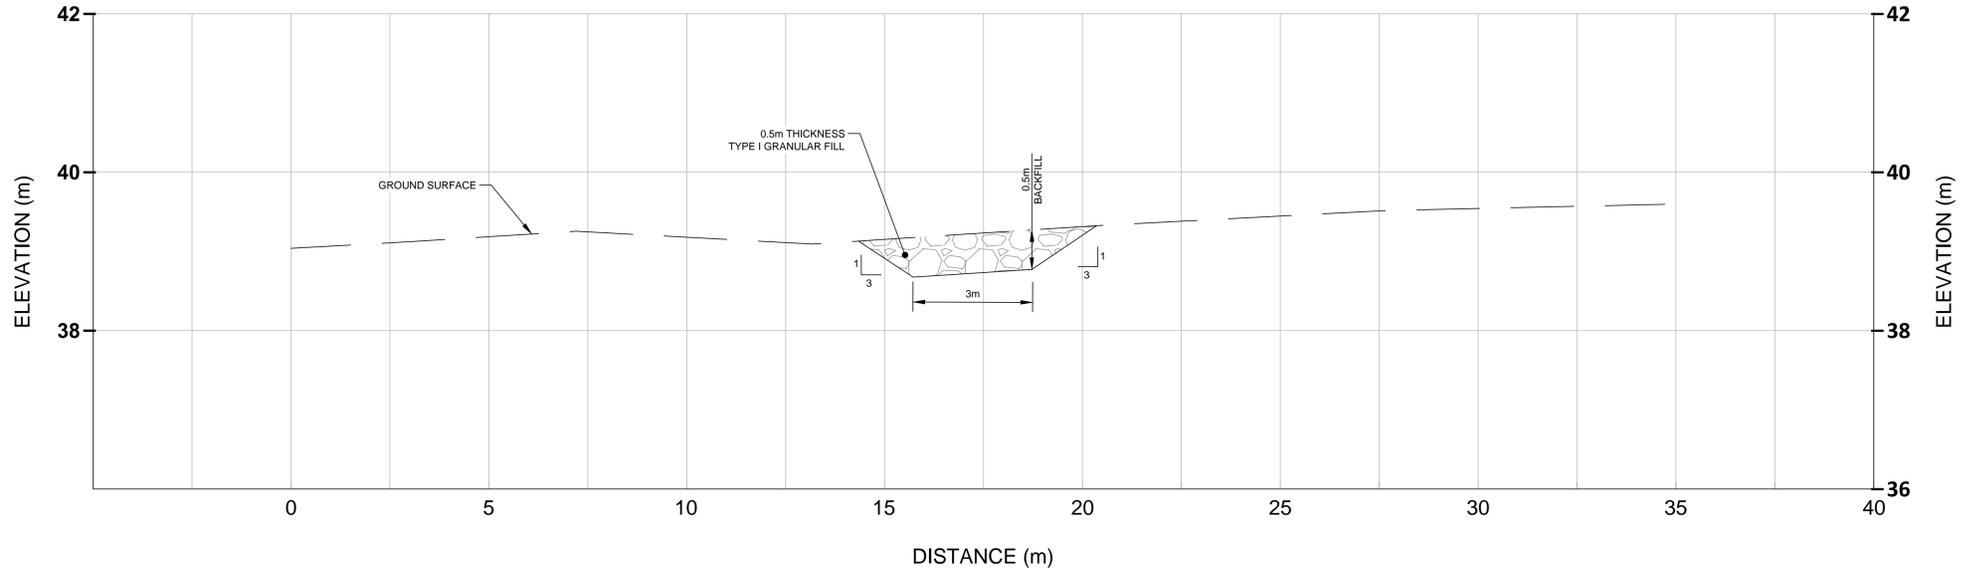
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2. ALL DIMENSIONS ARE IN METRES UNLESS NOTED OTHERWISE.
3. CHANNEL TO BE FIELD FIT AS DIRECTED DURING CONSTRUCTION.



Professional Seals / Sceaux

DO NOT SCALE DRAWINGS

Revision/Revision	Description/Description	Date/Date
E	ISSUED FOR TENDER	16/11/23
D	DRAFT REVISION	16/09/23
C	ISSUED FOR TENDER	14/02/27
A	ISSUED FOR 75% DESIGN	14/01/03
A	ISSUED FOR 75% DESIGN	13/12/02

**PUBLIC WORKS AND
GOVERNMENT SERVICES
CANADA**

Project title/Titre du projet

**CAM-C MATHESON POINT
REMEDATION PROJECT**

Approved by/Approuvé par
B. FEDORAK

Designed by/Concept par
K. SCOTT

Drawn by/Dessiné par
J. KNOTT

PWSSC Project Manager/Administrateur de Projets TPSGC
J. HOYT

PWSSC Architectural and Engineering Resources Manager/
Ressources Architectural et de Directeur d'ingénierie, TPSGC

Client/client
PUBLIC WORKS AND GOVERNMENT SERVICES CANADA

Drawing title/Titre du dessin

**AIRSTIP LANDFILL CHANNEL
CROSS SECTION**

Project No./No. du projet R.064062	Sheet/Feuille C10 OF 10	Revision no./ La Revision no. E
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2. ALL DIMENSIONS ARE IN METRES UNLESS NOTED OTHERWISE.
3. ALL SURFACE DEBRIS IS TO BE REMOVED FROM ALL CONTAMINATED SOIL AREAS AND EXISTING BURIED DEBRIS AREAS PRIOR TO EXCAVATION OR FILL PLACEMENT TAKING PLACE.
4. REFER TO DWG. C02 FOR ENTIRE DEBRIS AREA LIMITS.
5. POL LINES TO BE DEMOLISHED TO INCLUDE ALL ASSOCIATED PIPE SUPPORTS, MARKERS, VALVES AND ANCILLARY EQUIPMENT.
6. REFER TO SPECIFICATIONS DEMOLITION INVENTORY FOR DESCRIPTION OF MAJOR COMPONENTS.
7. CULVERTS TO BE REMOVED AND CULVERT AREA TO BE GRADED TO DRAIN PRIOR TO PROJECT COMPLETION.

LEGEND:

- - - - - APPROXIMATE EXTENT OF BORROW AREA
- - - - - DEBRIS AREA
- - - - - EXISTING CULVERT
XXXXXX STRUCTURE TO BE DEMOLISHED

Professional Seals / Sceaux

DO NOT SCALE DRAWINGS

Table with 3 columns: Revision, Description, Date. Rows include E (ISSUED FOR TENDER), D (DRAFT REVISION), C, B, A, and Revision/Revision/Description/Date/Date.

PUBLIC WORKS AND GOVERNMENT SERVICES CANADA

Project title/Titre du projet

CAM-C MATHESON POINT REMEDIATION PROJECT

Approved by/Approve par: B. FEDORAK

Designed by/Concept par: K. SCOTT

Drawn by/Dessiné par: J. KNOTT


PWSSC Project Manager/Administrateur de Projets TPSGC: J. HOYT

PWSSC Architectural and Engineering Resources Manager/Ressources Architectural et de Directeur d'ingénierie, TPSGC

Client/Client: PUBLIC WORKS AND GOVERNMENT SERVICES CANADA

Drawing title/Titre du dessin: STATION POL DEMOLITION SITE PLAN

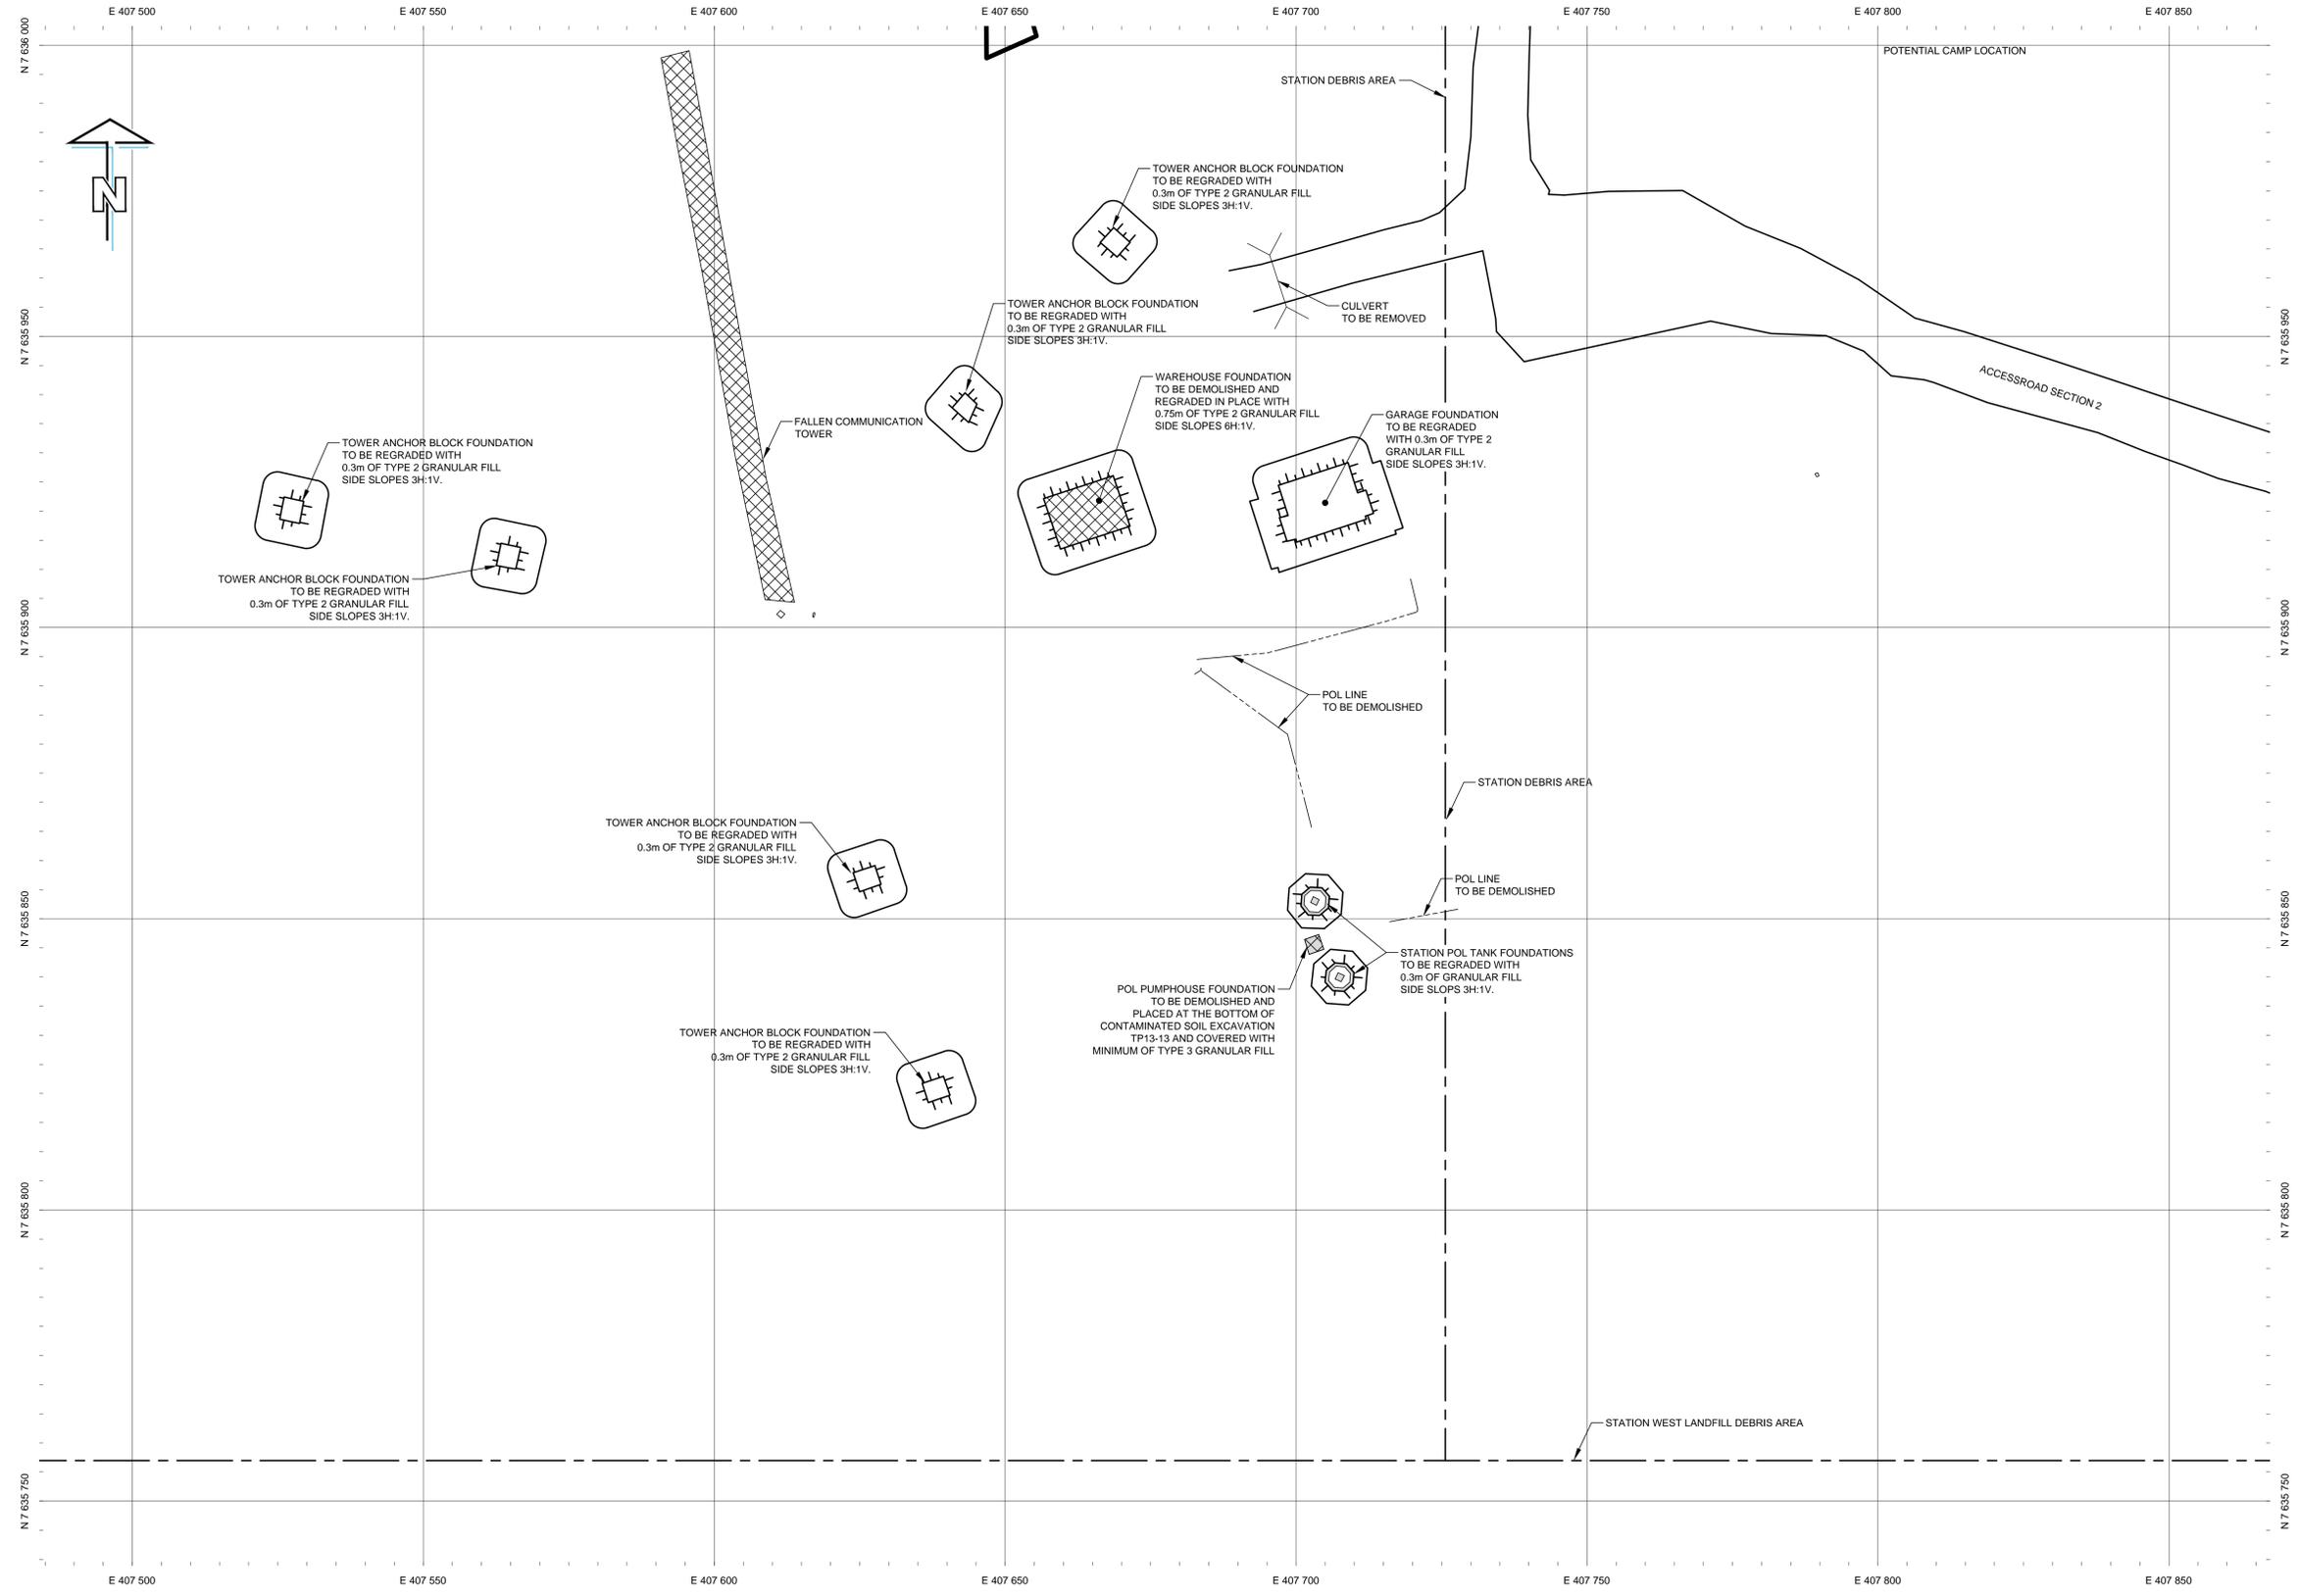Table with 3 columns: Project No./No. du projet, Sheet/Feuille, Revision no./La Revision no. Values: R.064062, S01 OF 3, E



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2. ALL DIMENSIONS ARE IN METRES UNLESS NOTED OTHERWISE.
3. ALL SURFACE DEBRIS IS TO BE REMOVED FROM ALL CONTAMINATED SOIL AREAS AND EXISTING BURIED DEBRIS AREAS PRIOR TO EXCAVATION OR FILL PLACEMENT TAKING PLACE.
4. REFER TO DWG. C02 FOR ENTIRE DEBRIS AREA LIMITS.
5. POL LINES TO BE DEMOLISHED TO INCLUDE ALL ASSOCIATED PIPE SUPPORTS, MARKERS, VALVES AND ANCILLARY EQUIPMENT.
6. REFER TO SPECIFICATIONS DEMOLITION INVENTORY FOR DESCRIPTION OF MAJOR COMPONENTS.

LEGEND:

- - - APPROXIMATE EXTENT OF BORROW AREA
- - - DEBRIS AREA
[Cross-hatched box] STRUCTURE TO BE DEMOLISHED

Professional Seals / Sceaux

DO NOT SCALE DRAWINGS

Table with 3 columns: Revision, Description, Date/Date. Includes revisions A through E with dates and descriptions like 'ISSUED FOR TENDER' and 'ISSUED FOR 75% DESIGN'.

PUBLIC WORKS AND GOVERNMENT SERVICES CANADA



CAM-C MATHESON POINT REMEDIATION PROJECT

Approved by/Approve par: B. FEDORAK
Designed by/Concept par: K. SCOTT
Drawn by/Dessiné par: J. KNOTT
PWSCC Project Manager/Administrateur de Projets TPSGC: J. HOYT

Client/Client: PUBLIC WORKS AND GOVERNMENT SERVICES CANADA

BEACH POL DEMOLITION SITE PLAN

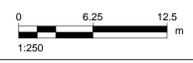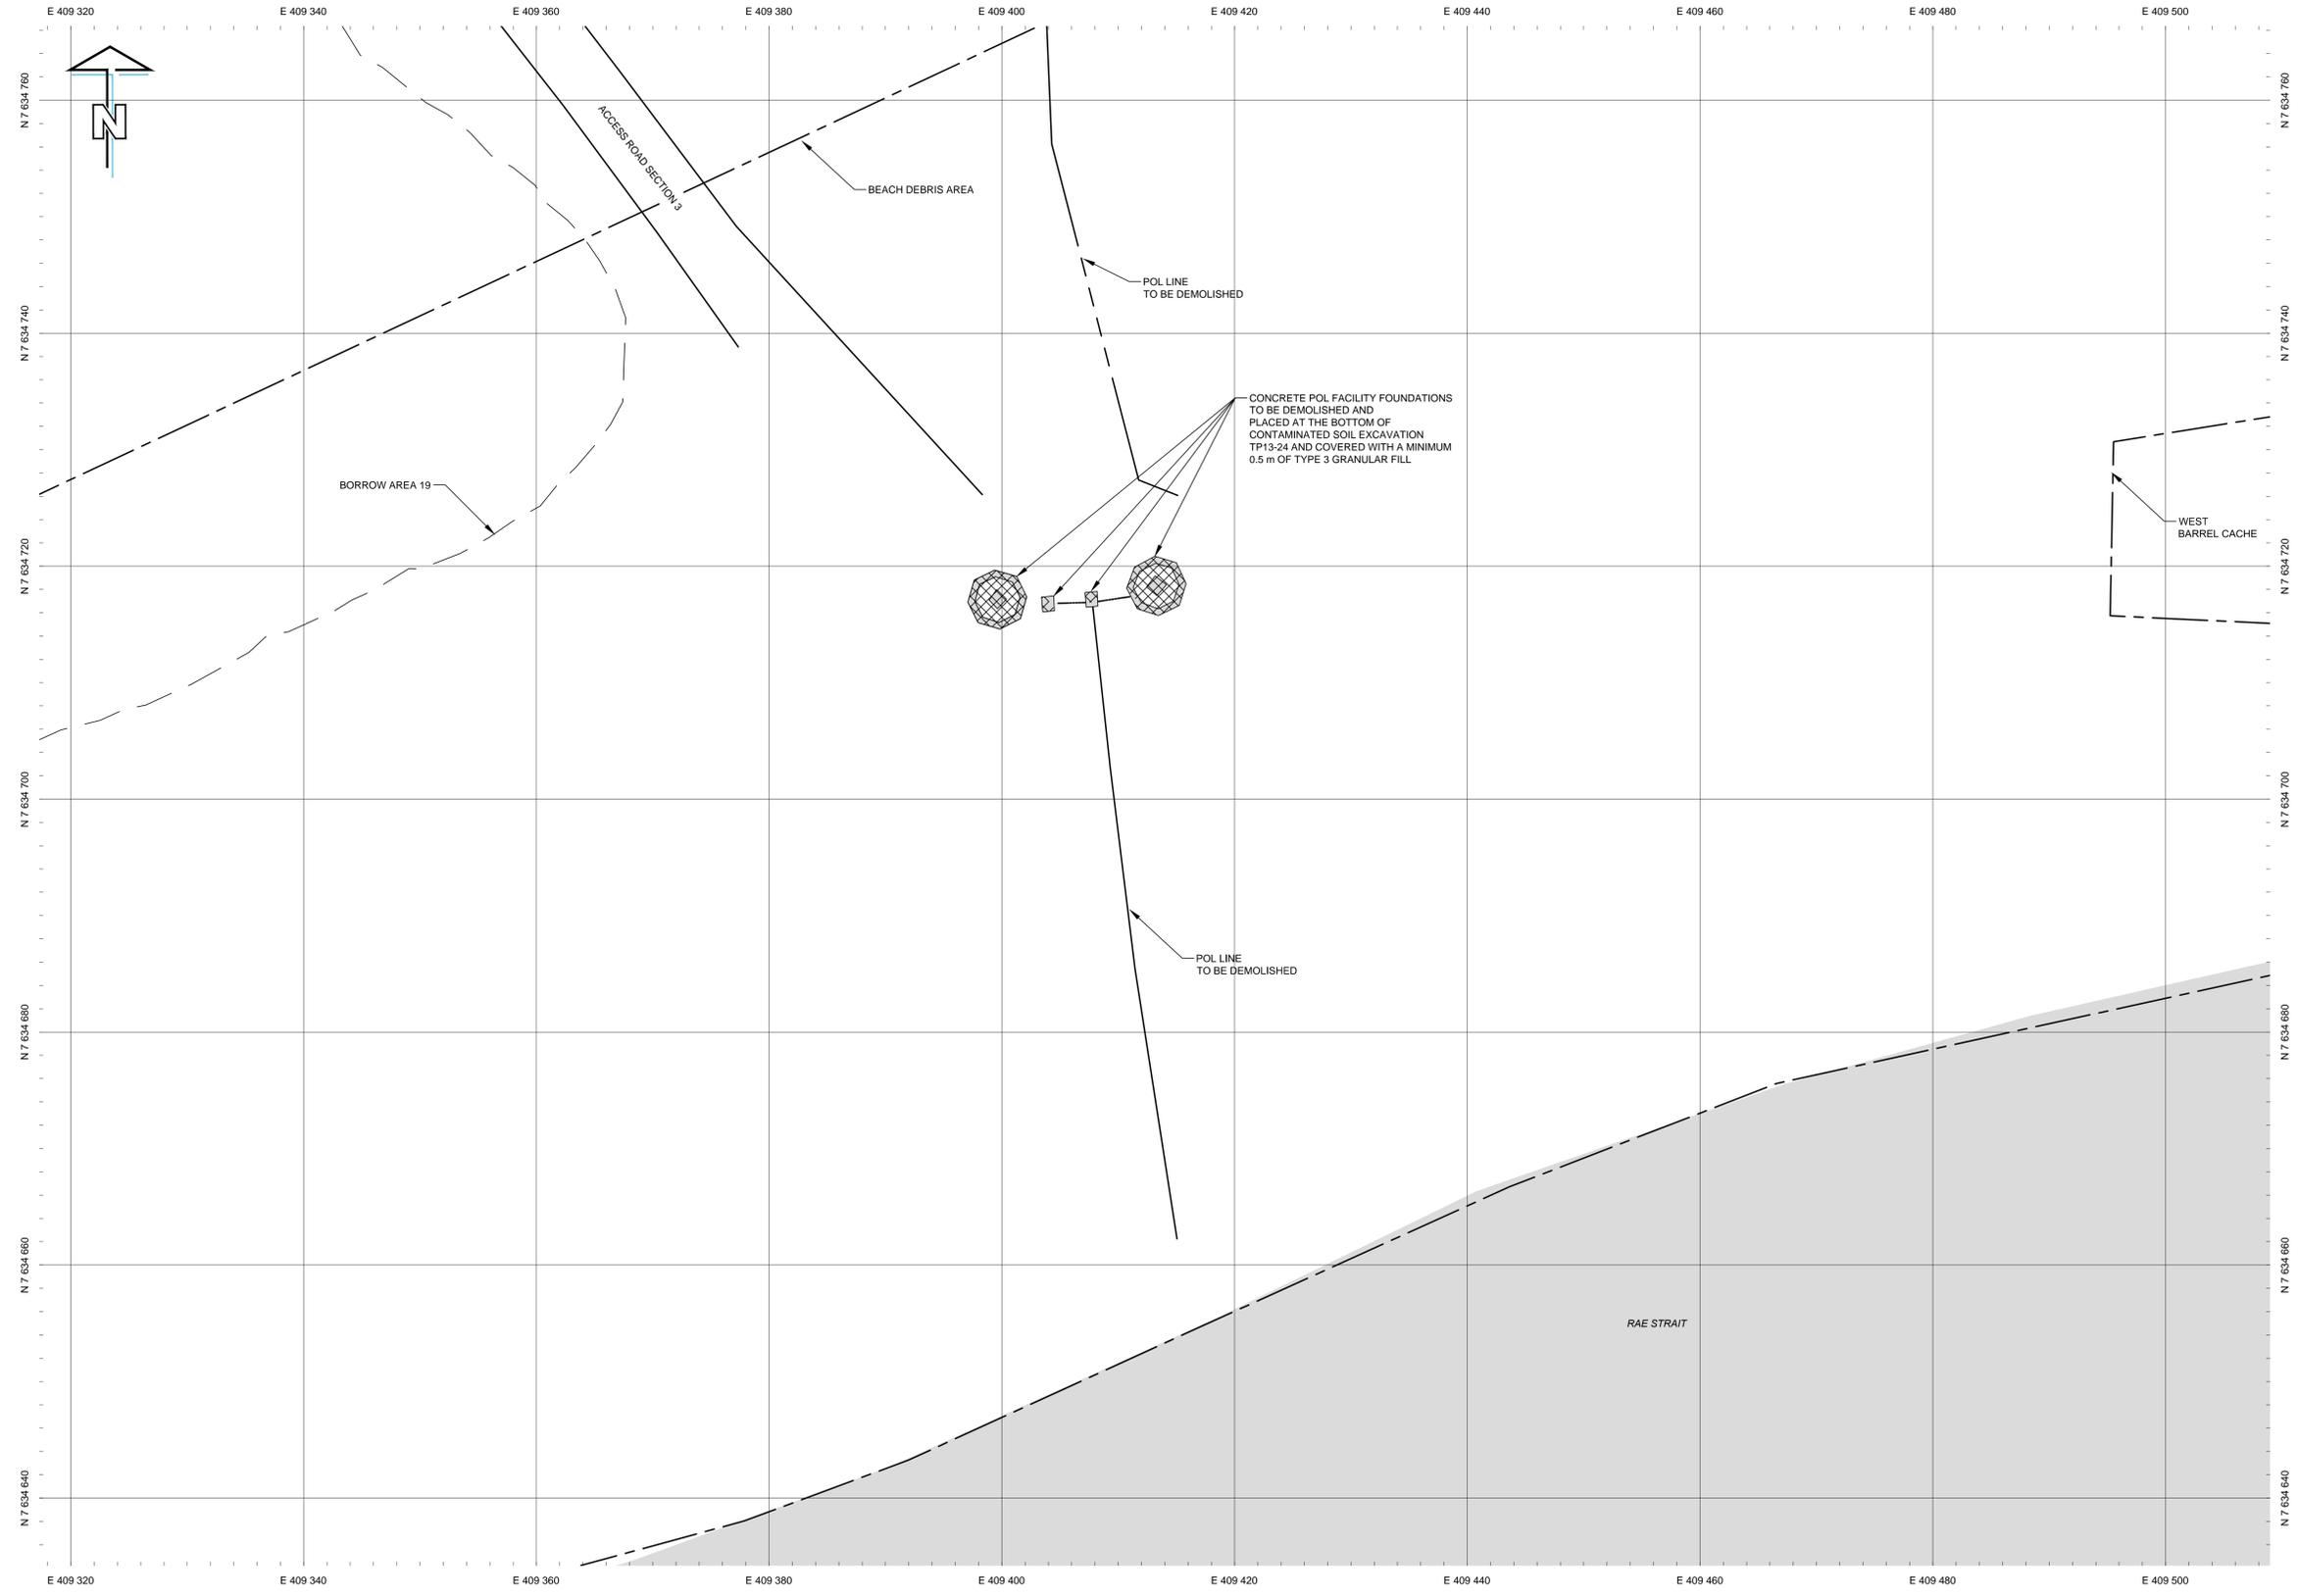Table with 3 columns: Project No./No. du projet (R.064062), Sheet/Feuille (S02 OF 3), Revision no./La Revision no. (E)




PRELIMINARY NOT FOR CONSTRUCTION



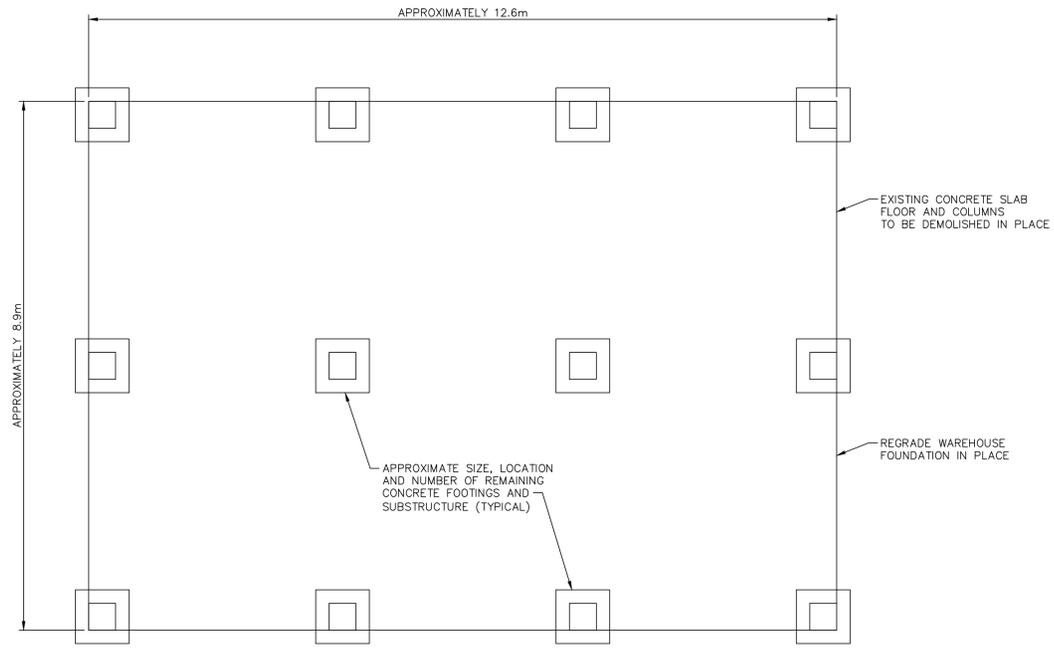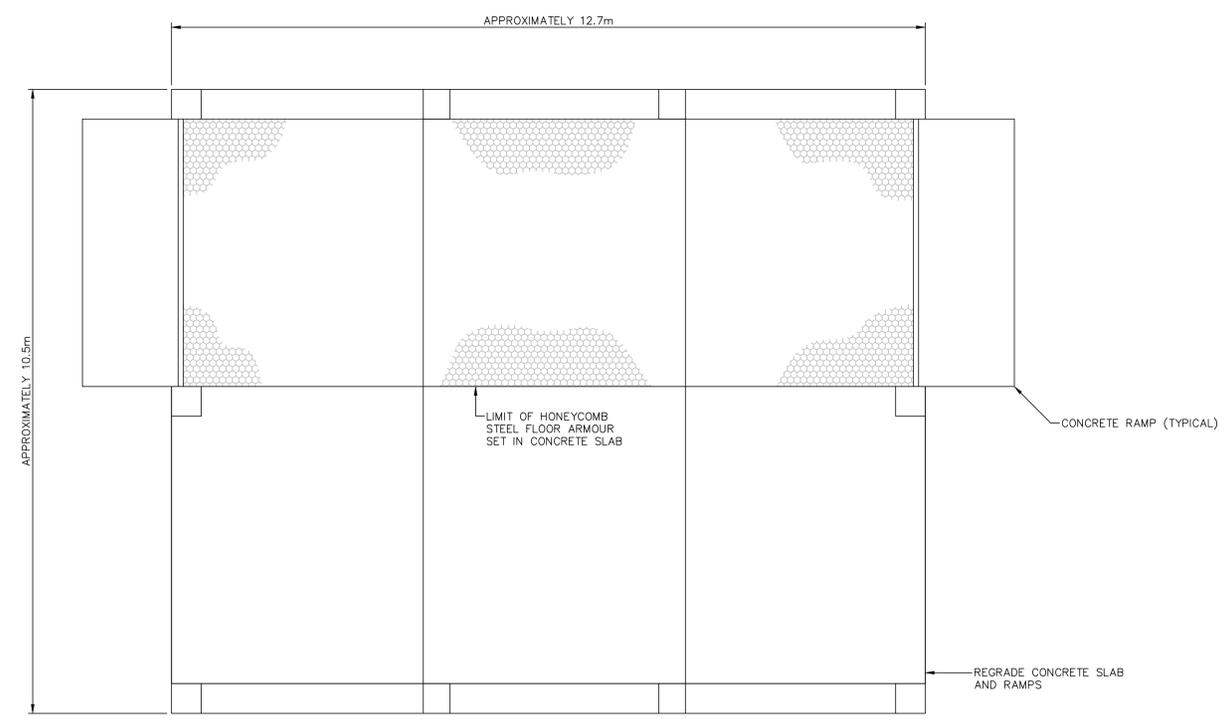
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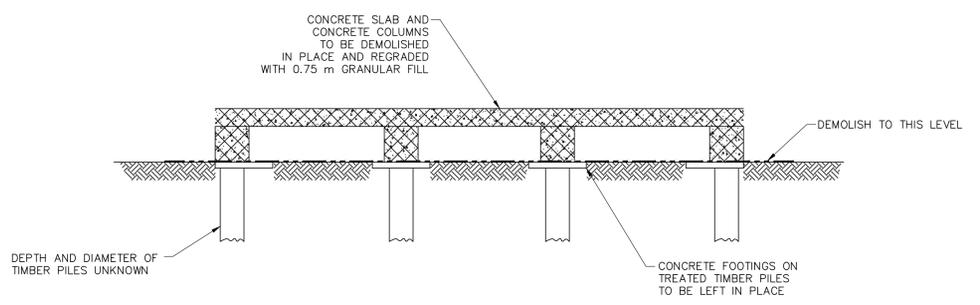
- GENERAL NOTES: 1. ALL DIMENSIONS ARE IN METRES UNLESS NOTED OTHERWISE. 2. REFER TO SPECIFICATION DEMOLITION INVENTORY FOR DESCRIPTIONS OF MAJOR COMPONENTS.




WAREHOUSE FOUNDATION PLAN SCALE 1:50



GARAGE FOUNDATION PLAN SCALE 1:50



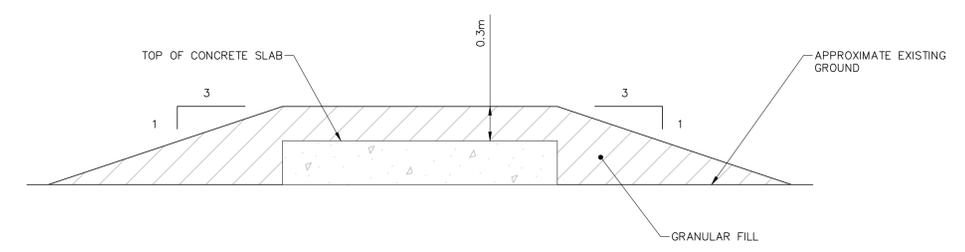WAREHOUSE FOUNDATION SECTION SCALE 1:50



TYPICAL FOUNDATION REGRADE DETAIL SCALE: N.T.S.

Professional Seals / Sceaux

DO NOT SCALE DRAWINGS

Revision table with columns: Revision, Description/Description, Date/Date. Includes revisions A through E.

PUBLIC WORKS AND GOVERNMENT SERVICES CANADA

Project title/Titre du projet

CAM-C MATHESON POINT REMEDIATION PROJECT

Approved by/Approuvé par

Designed by/Concept par

Drawn by/Dessiné par

PWGSC Project Manager/Administrateur de Projets TPSGC

PWGSC Architectural and Engineering Resources Manager/Ressources Architectural et de Directeur d'ingénierie, TPSGC

Client/client

PUBLIC WORKS AND GOVERNMENT SERVICES CANADA

Drawing title/Titre du dessin

WAREHOUSE AND GARAGE PLAN, ELEVATION, AND SECTION

Project No./No. du projet

Sheet/Feuille

Revision no./La Revision no.

R.064062

S03 OF 3

E