



P.O. Box 1073, Sydney, N.S., Canada
 ph: 902 539 8079 fax: 902 539 1336
 info@tritos-ns.ca www.tritos.ca

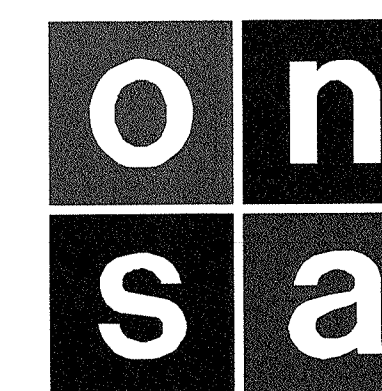


F.C. O'Neill, Scriven & Assoc's Limited
 Consulting Engineers
 5450 Cornwallis Street,
 Halifax, Nova Scotia, B3K 1A9
 p: (902) 429-0701
 f: (902) 429-9729
 341 Townsend Street,
 Sydney, Nova Scotia, B1P 5G1
 p: (902) 562-6090
 f: (902) 562-6621
 w: www.onsa.ca

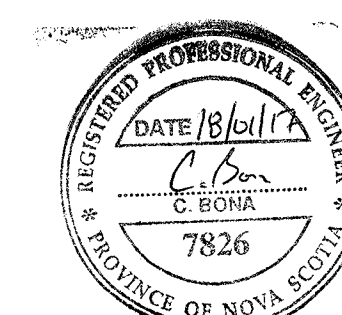

0 ISSUED FOR TENDER Jan 18, 2017
 revisions date
 project project
 POOL RENOVATION PROJECT
 CANADIAN COAST
 GUARD COLLEGE
 SYDNEY, NOVA SCOTIA

drawing dessin
 designed CLB conçu
 date JAN 18, 2017
 drawn KT dessin
 date JAN 18, 2017
 approved approved
 date
 Tender Submission
 PWGSC Project Manager Administrateur de projets TPSCG
 project number no. du projet
 R.065476.610
 drawing no. no. du dessin
 E1

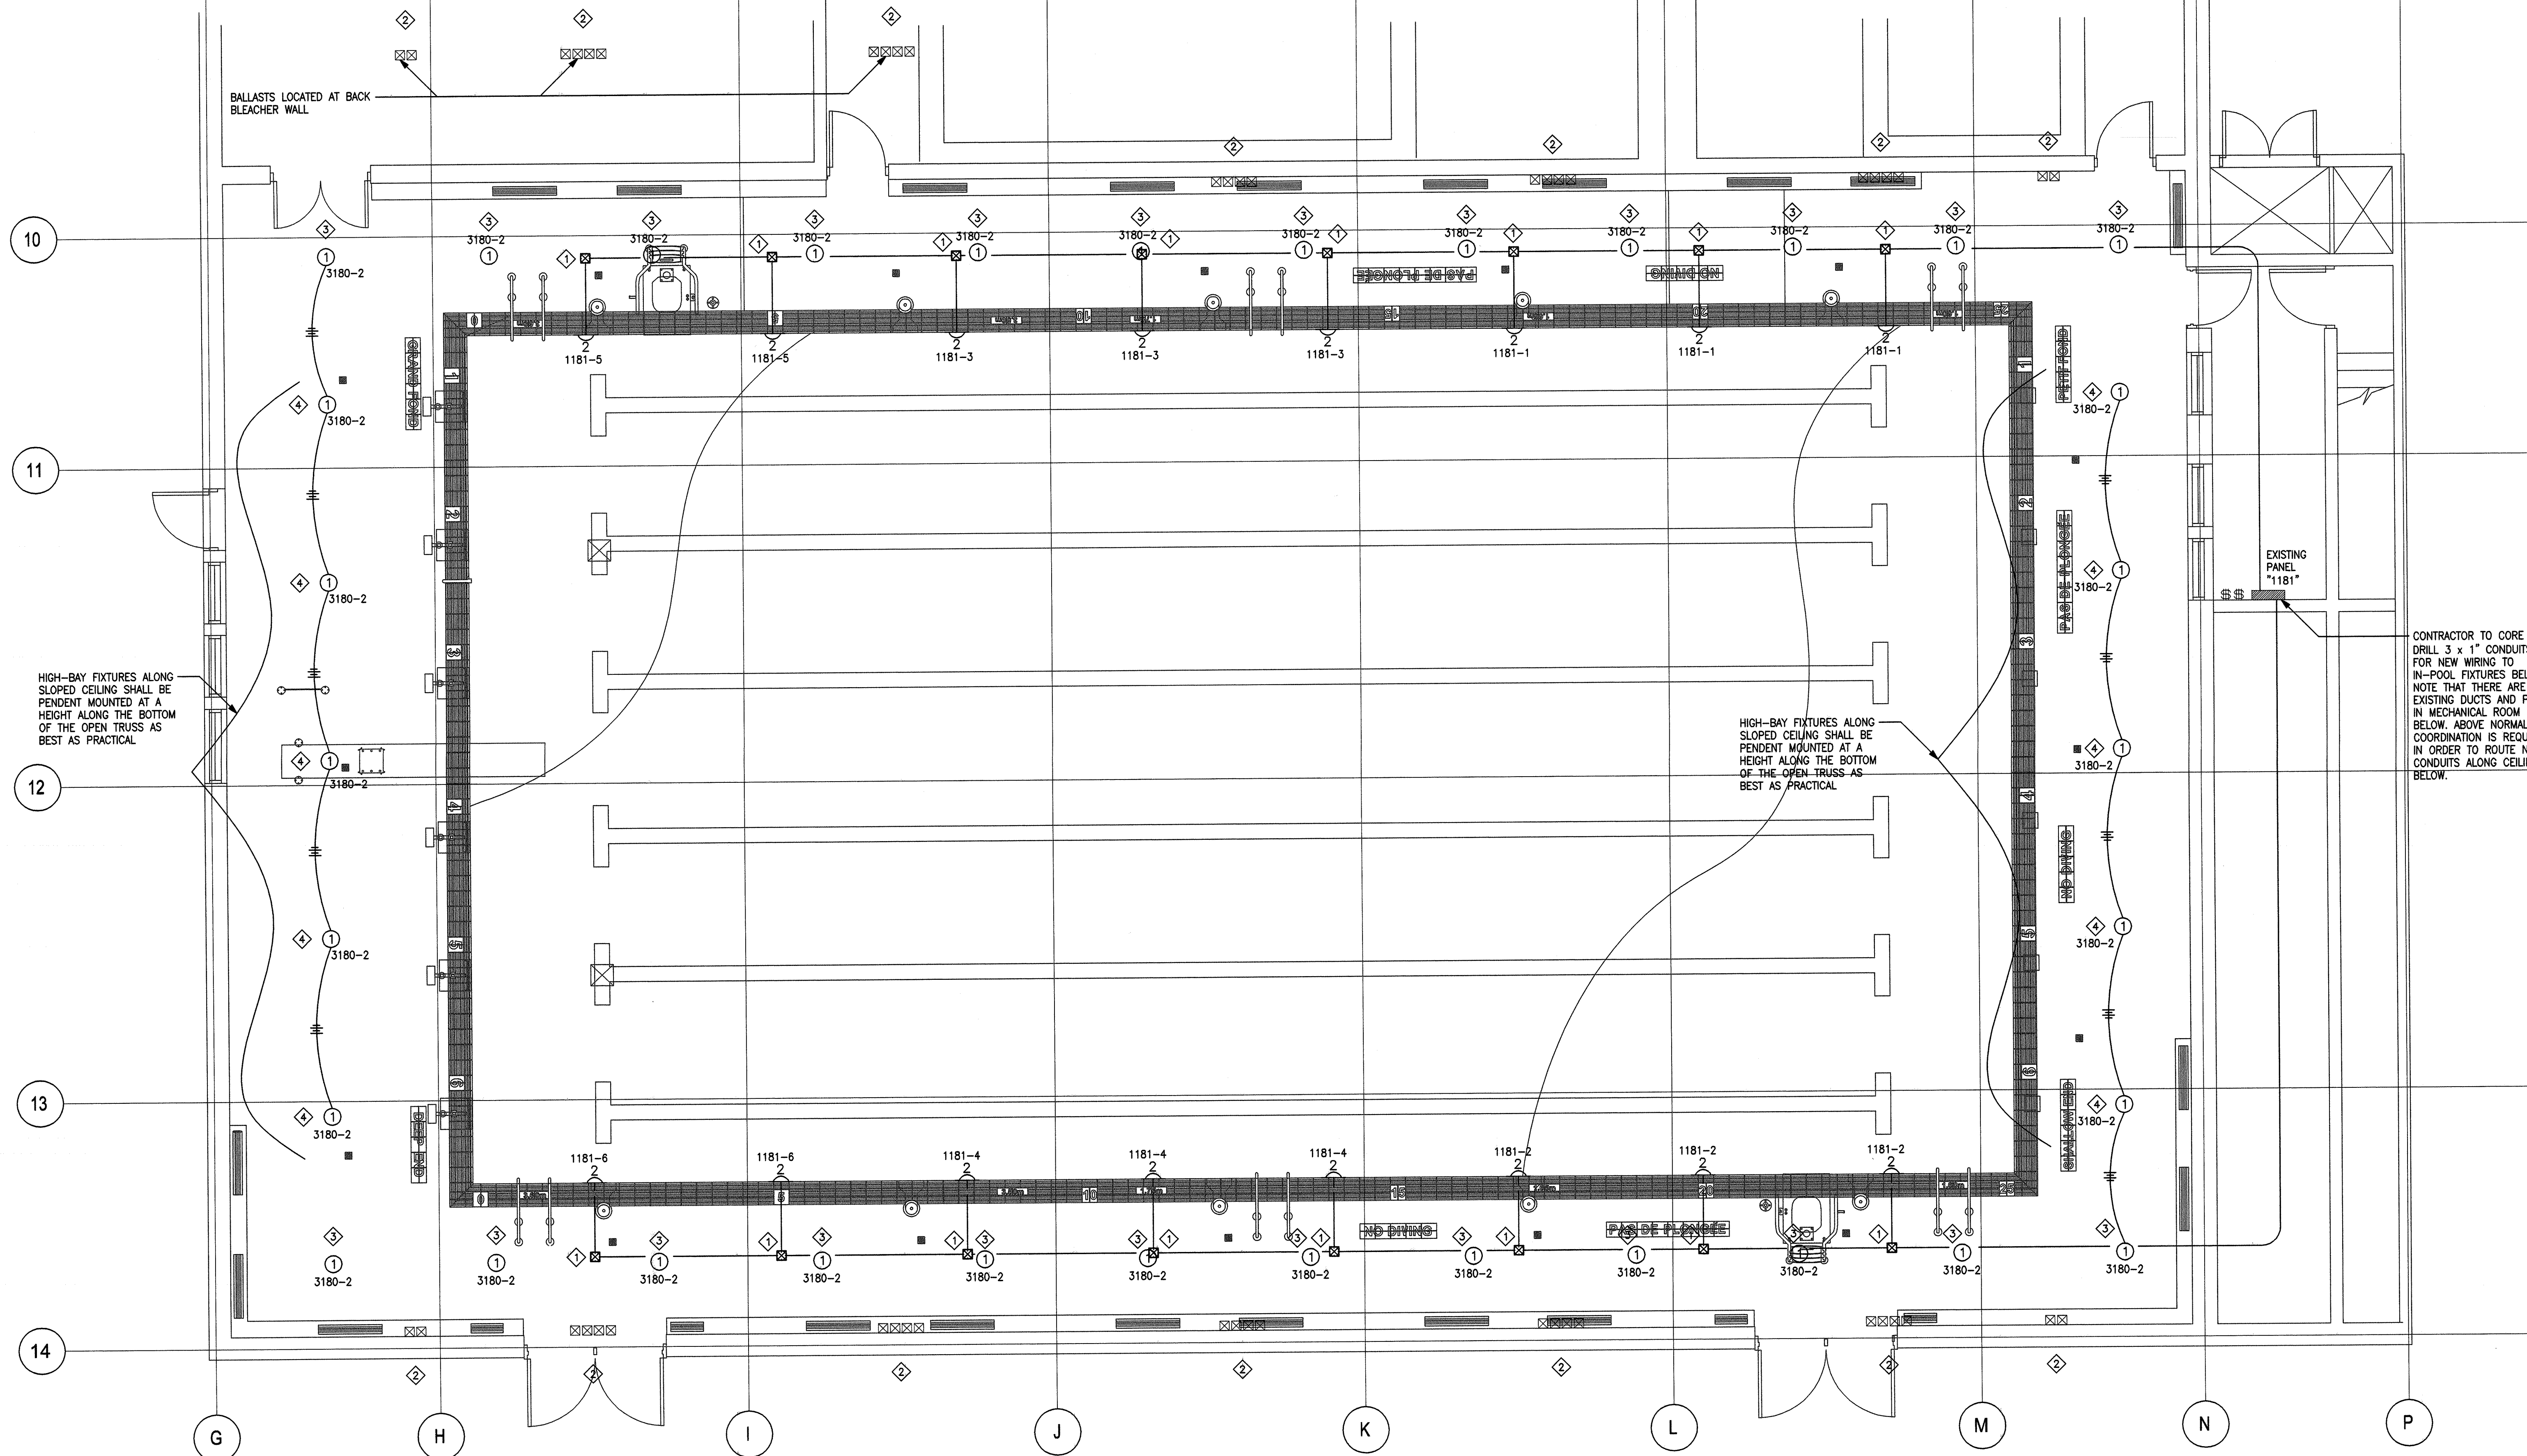


ELECTRICAL NOTES
 INDICATED BY THE \diamond SYMBOL ON THE DRAWINGS. (I.E. \diamond INDICATES NOTE 1)
 NOTE 1: LOCATION OF EXISTING JUNCTION BOX, TYPICAL FOR ALL SHOWN ON LAYOUT. REMOVE EXISTING WIRING ALONG EXISTING CONDUITS AND WITHIN EXISTING JUNCTION BOXES, BACK TO PANEL. PROVIDE AND INSTALL NEW WIRING, CONDUIT AND ASSOCIATED JUNCTION BOXES FOR NEW IN-POOL LIGHTING CIRCUIT AS PER "IN-POOL LIGHTING CIRCUITING" DETAIL. RUN NEW CONDUIT BACK TO EXISTING PANEL EXPOSED IN "POOL TUNNEL POOL" UNDERNEATH THE POOL WALKWAY.
 NOTE 1 (CONT'D): GENERAL CONTRACTOR TO FILL IN AREAS WHERE EXISTING JUNCTION BOXES ARE REMOVED AND INSTALL NEW FLOORING.
 NOTE 2: EXISTING HIGH BAY BALLASTS (WALL MOUNTED AT CEILING HEIGHT) TO BE REMOVED.
 NOTE 3: EXISTING HIGH BAY FIXTURE TO BE UPGRADED WITH NEW, EXISTING 347V CIRCUIT TO REMAIN. REFER TO LUMINAIRE SCHEDULE.
 NOTE 4: THE NEW HIGH BAY FIXTURE TO EXISTING 347V CIRCUIT. REFER TO LUMINAIRE SCHEDULE.

LIGHTING LAYOUT
 SCALE: 1:50
 0m 1m 2m 3m 4m 5m

LUMINAIRE LEGEND

TYPE	DESCRIPTION	MANUFACTURER'S CATALOGUE NO.	LAMP(S)	REMARKS
1	LED HIGH-BAY FIXTURE PENDENT MOUNTED ALONG BOTTOM OF OPEN TRUSS	KENALL #HBM026-4-DTA-LG-300L35K-347V	LED/3500K 23,500 Lumens	UNIT C/W TYPE IV LIGHT DISTRIBUTION TYPE, LIGHT GREY FINISH, AND DROP CLEAR TEXTURED ACRYLIC LENS
2	IN-POOL LED FIXTURES TO BE SUBMERGED IN POOL WATER, WALL MOUNTED	INTELLIBRIGHT 56 WHITE POOL LIGHT #601300, 120V	LED	UNIT C/W STAINLESS STEEL NICHE HOUSING, WATER-TIGHT PLUG, AND 50 FOOT CORD TO BE FED TO NEW JUNCTION BOX

NOTES:
 1. CO-ORDINATE ALL FIXTURE LOCATIONS WITH THE ARCHITECTURAL REFLECTED CEILING PLANS.
 2. ALTERNATES ACCEPTED UPON REVIEW: PHILIPS, COOPER, LITHONIA, STANPRO.

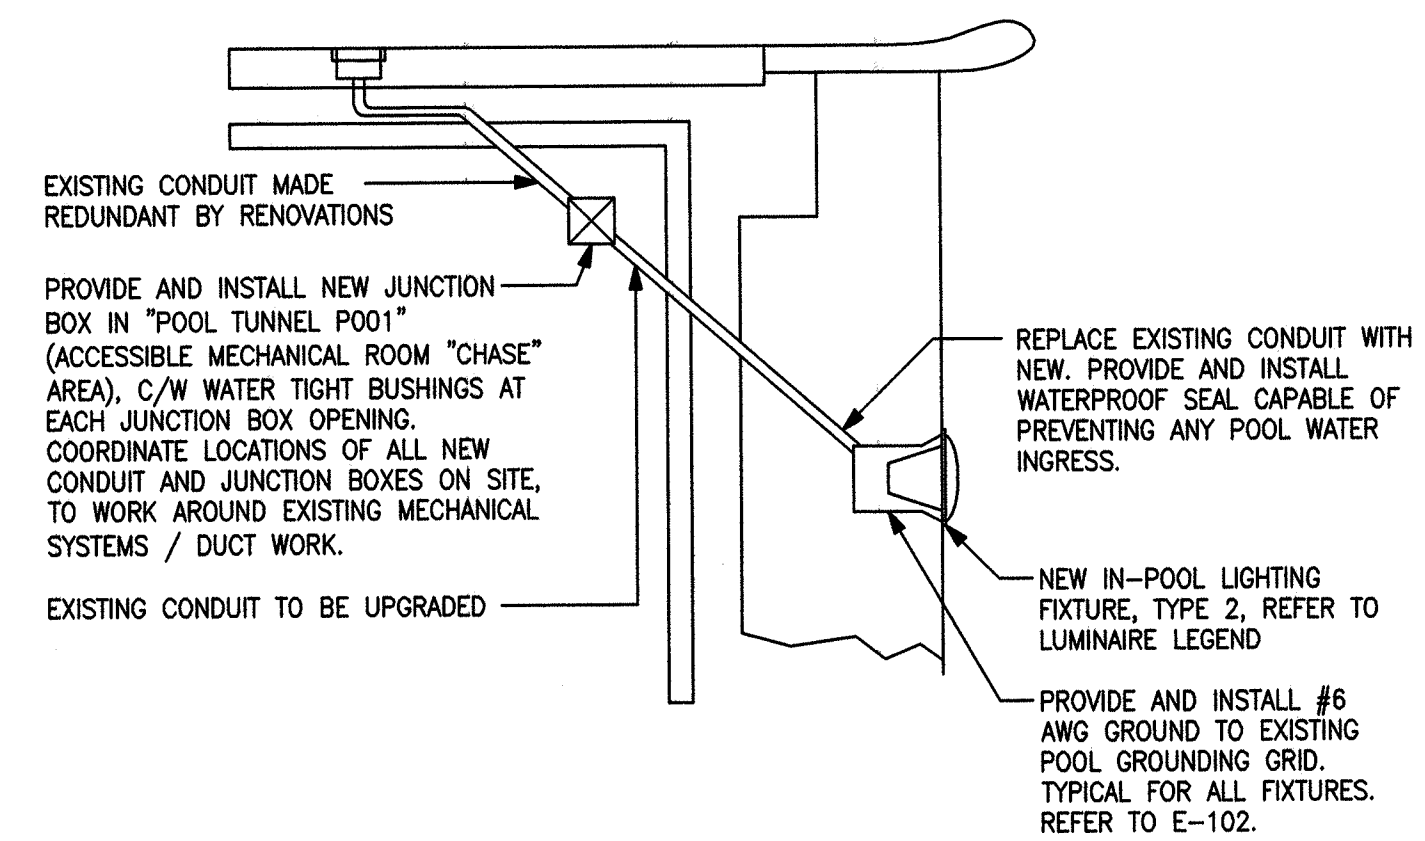

IN-POOL LIGHTING CIRCUITING
 SCALE: N.T.S.