

Public Works Government Services Canada

Architectural and Engineering Services

Ontario Region

Travaux publics Services gouvernementaux Canada

Services d'architecture et de génie

Région de l'Ontario

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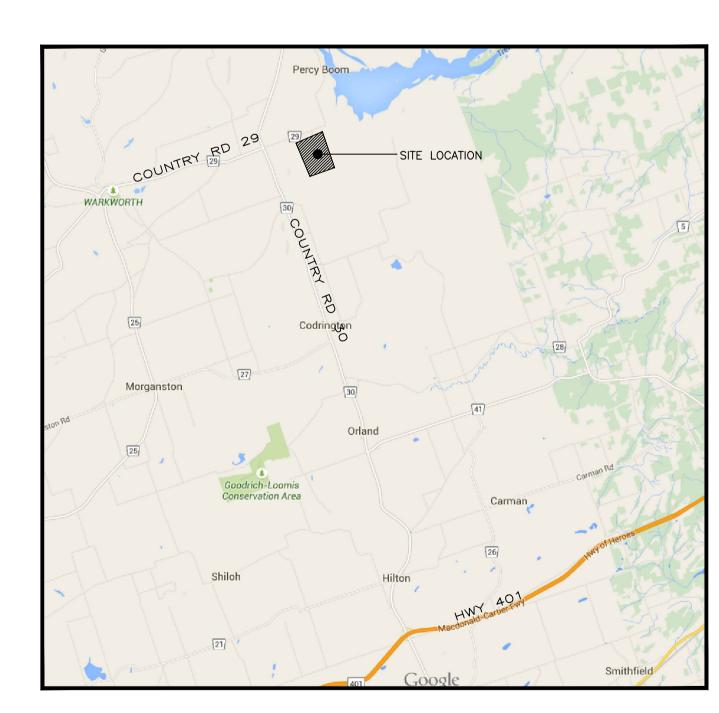
ELECTRICAL


E2-01 PARTIAL ELECTRICAL PLANS WW05 & WW06

SECURITY RETROFIT BLDGS WW05,06,08,09,10,11


WARKWORTH INSTITUTION
15847 COUNTY ROAD 29
CAMPBELLFORD, ON, KOL 1L0

PWGSC Proj. No.: R.078483.001



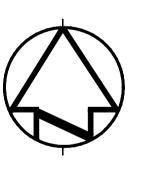



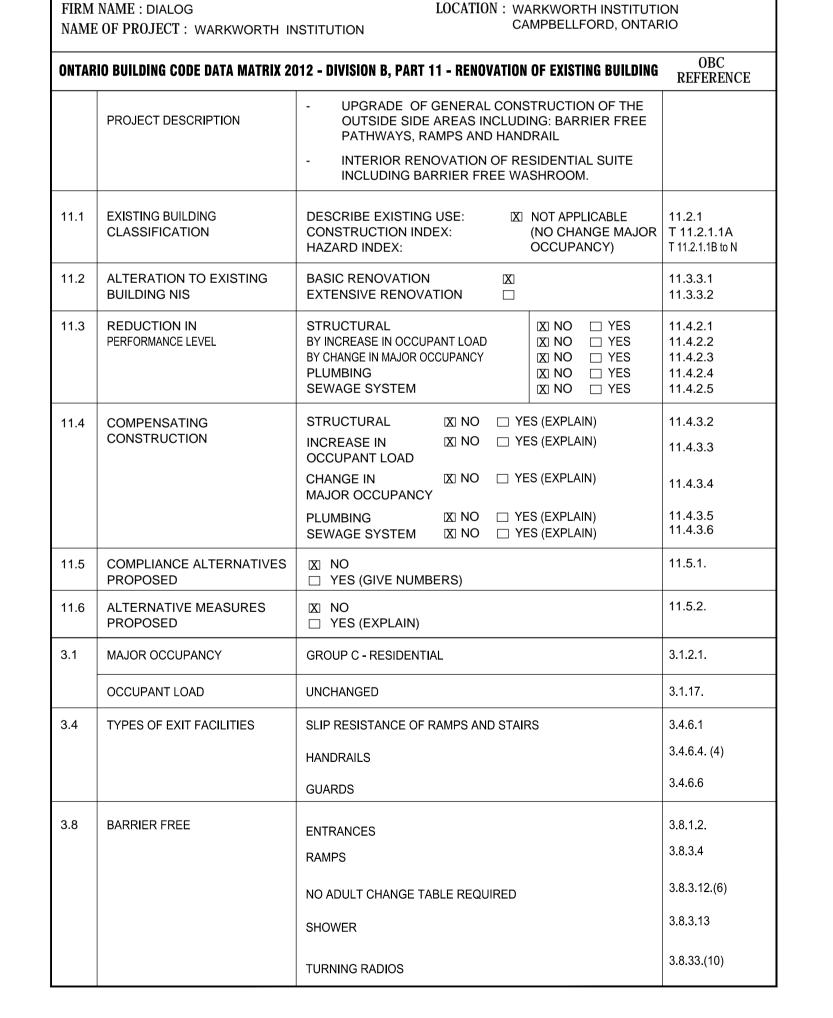





Public Works and Government Services Canada Architectural and Engineering Services Ontario Region

Travaux publics et Services gouvernementaux Canada Services d'architecture et de génie Région de l'Ontario





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1 ISSUED FOR BID 2016-12-02

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No. du détail

B drawing no. — where detail required dessin no. — où détail exigé

C drawing no. — where detailed dessin no. — où détaillé

titre du proje

SECURITY RETROFIT BLDGS WW05, 06, 08, 09, 10, 11

WARKWORTH INSTITUTION

15847 COUNTY ROAD 29, CAMPBELLFORD, ON, KOL 1LO

drawing title itre du dessin

SITE MAP, DRAWING LIST, AND OBC BUILDING MATRIX

R. NORTHCOTT

rawn by
essine par
S. ASHTON

esigned by

.....

R. NORTHCOTT

project mana re administrat K. HAQUE de proj

project date date du projet


2016-04-25

no. du projet R.078483.001

A-00

GSC-A1 DATE PLOTTED: PLOT SCALE: CAD F

Canadä

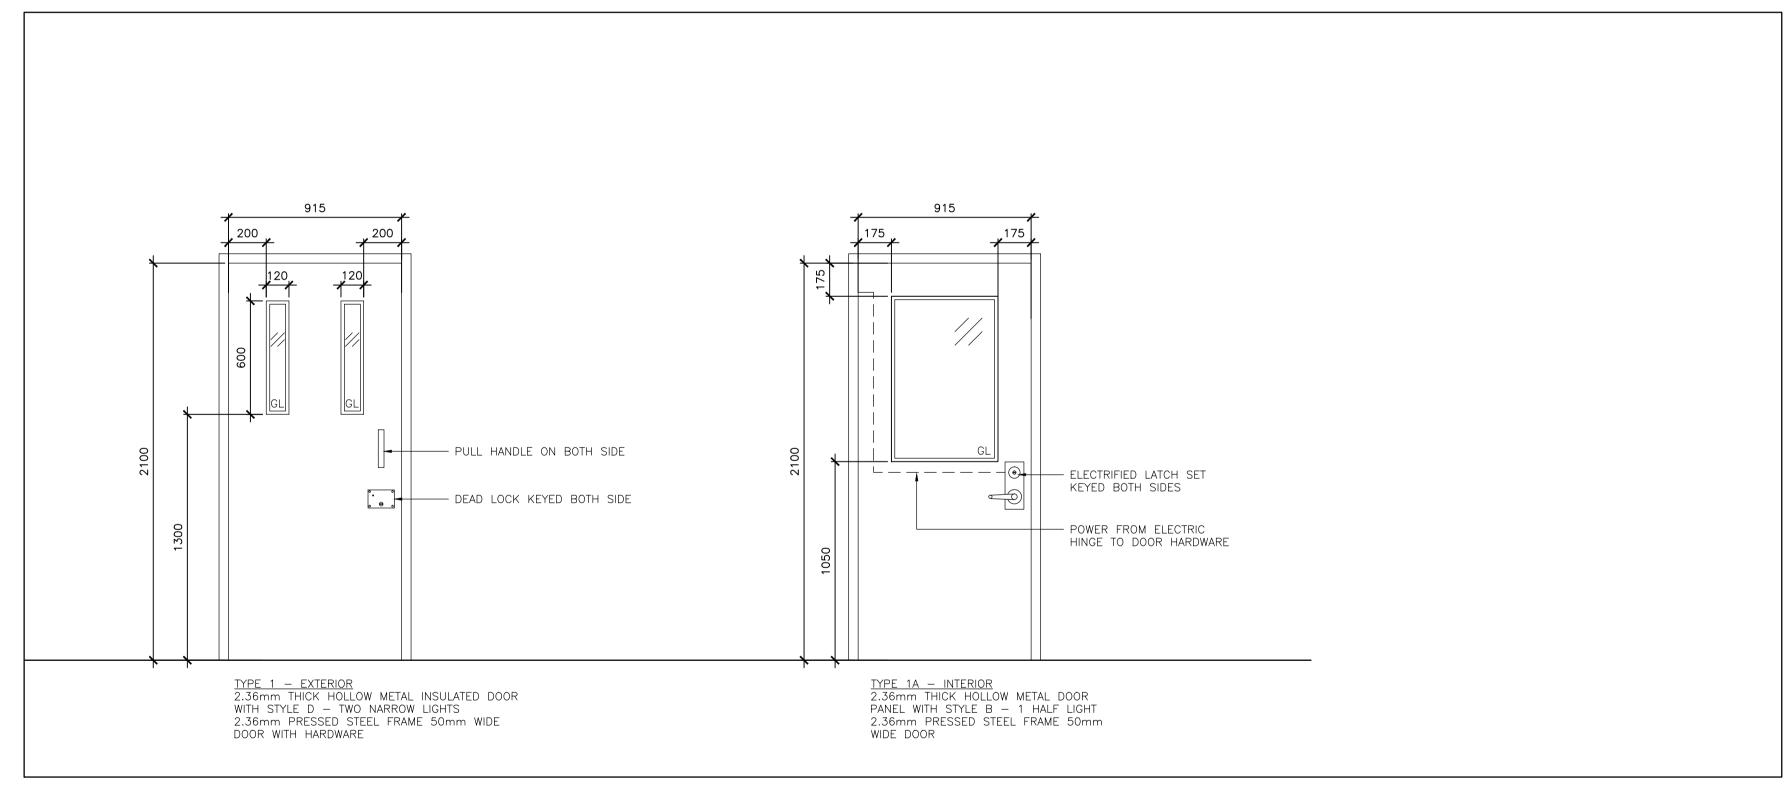

LEGEND	
CL	CHAIN LINK
НМ	HOLLOW METAL
GL	TEMPERED GLASS ON ATTACK SIDE OF FRAME, WITH AIR SPACE AND POLYCARBONATE. GLAZING STOP ON ATTACK SIDE
DD1	DETENTION DOORS SWING
DD2	DETENTION DOORS MAXIMUM SWING
MANUAL	OPERATION INDICATES THAT THE OPENING OR CLOSING OF A DOOR IS MANUALLY EXECUTED BY STAFF OR INMATES
ELECTRIC	REMOTE CONTROLLED LOCK OPERATES ELECTROMECHANICALLY OR PNEUMATICALLY FROM A CONTROL POST. LOCKS ARE ALSO MECHANICALLY KEYED AT THE DOOR AND MAY BE EQUIPPED WITH A LOCAL ELECTRIC UNLOCK WHEN ACTIVATED AT THE CONTROL POST CONSOLE.

DOOR TYPES \A-00A / SCALE: 1:20

DOOR DESCRIPTION AND LOCATION				DOORS						FRAMES			HARDWARE		GENERAL		
DOOR NUMBER	ROOM NUMBER	LOCATION	WIDTH	HEIGHT	CONDITION	TYPE	MATERIAL	FINISH	GLASS	CONDITION	TYPE	MATERIAL	FINISH	LOCKING	OPERATION	FIRE RATING	COMMENTS
D102A	102	WW05 CONTROL AND OFFICE TO EXERCISE YARD	915	2100	NEW	1	НМ	PT	_	NEW	1	STEEL	PT	MANUAL	MANUAL	_	DD1
D102B	102	WW05 CONTROL AND OFFICE	915	2100	NEW	1A	НМ	PT	_	NEW	1	STEEL	PT	ELECTRIC	MANUAL	_	DD2
D102C	_	EXERCISE YARD TO EXTERIOR	915	2100	NEW	2	CL	_	-	NEW	2	STEEL	_		MANUAL	_	
D102A	102	WW06 CONTROL AND OFFICE	915	2100	NEW	1A	НМ	PT	_	NEW	1	STEEL	PT	ELECTRIC	MANUAL	_	DD2
D102B	102	WW06 CONTROL AND OFFICE TO FRONT OF BUILDING	915	2100	NEW	1	НМ	PT	_	NEW	1	STEEL	PT	MANUAL	MANUAL	_	DD1

2 DOOR AND HARDWARE SCHEDULE A-00A SCALE: 1:1

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project title titre du projet

SECURITY RETROFIT BLDGS WW05, 06, 08, 09, 10, 11

WARKWORTH INSTITUTION

15847 COUNTY ROAD 29, CAMPBELLFORD, ON, KOL 1LO

drawing title titre du dessin SCHEDULE

DOOR AND HARDWARE

rawn by		
essine po	r S.	ASHTON

approuve par R. NORTHCOTT

R. NORTHCOTT

project managei administrateui K. HAQUE

project date date date du projet 2016-04-25

project no. no. du projet R.078483.001

drawing no. dessine no.

A - OOA

GSC-A1 DATE PLOTTED:

PLOT SCALE:

2 FLOOR PLAN - WW06

PLOT SCALE:

CAD FILE:

A-02 / SCALE: 1:100

DATE PLOTTED:

Government Services Canada Architectural and Engineering Services

Services gouvernementaux Canada Services d'architecture et de génie

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2016-12-02

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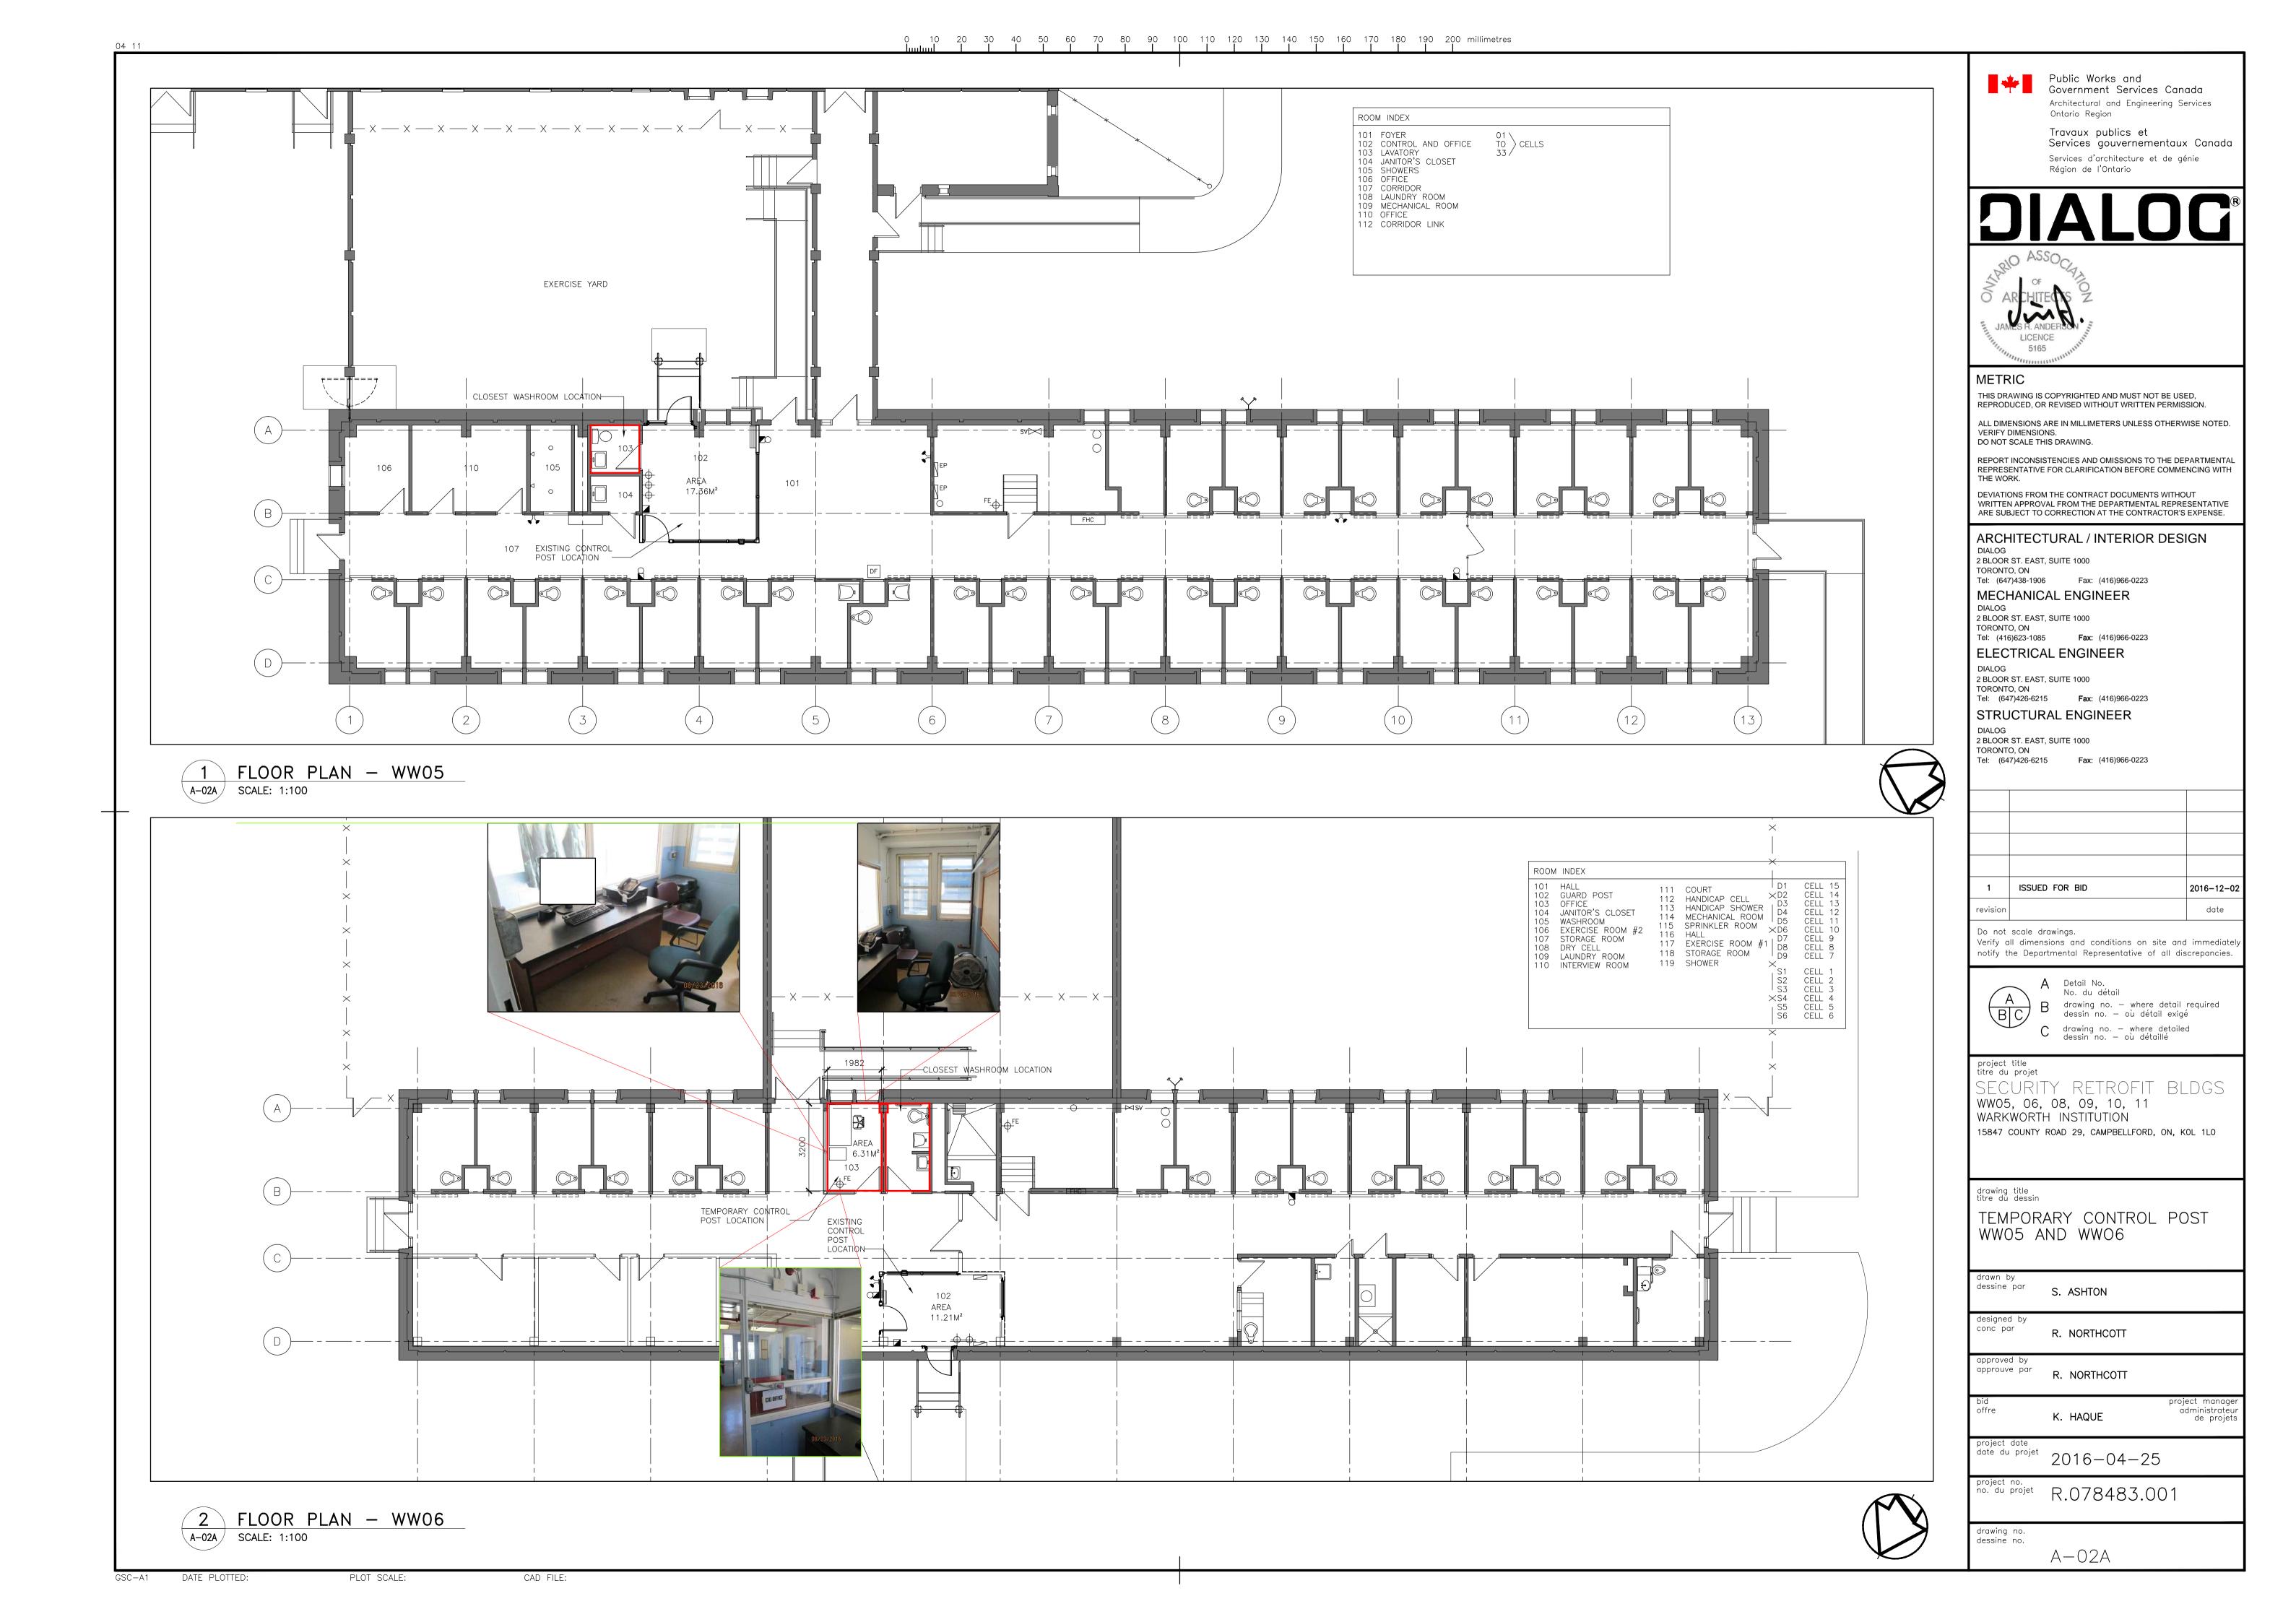
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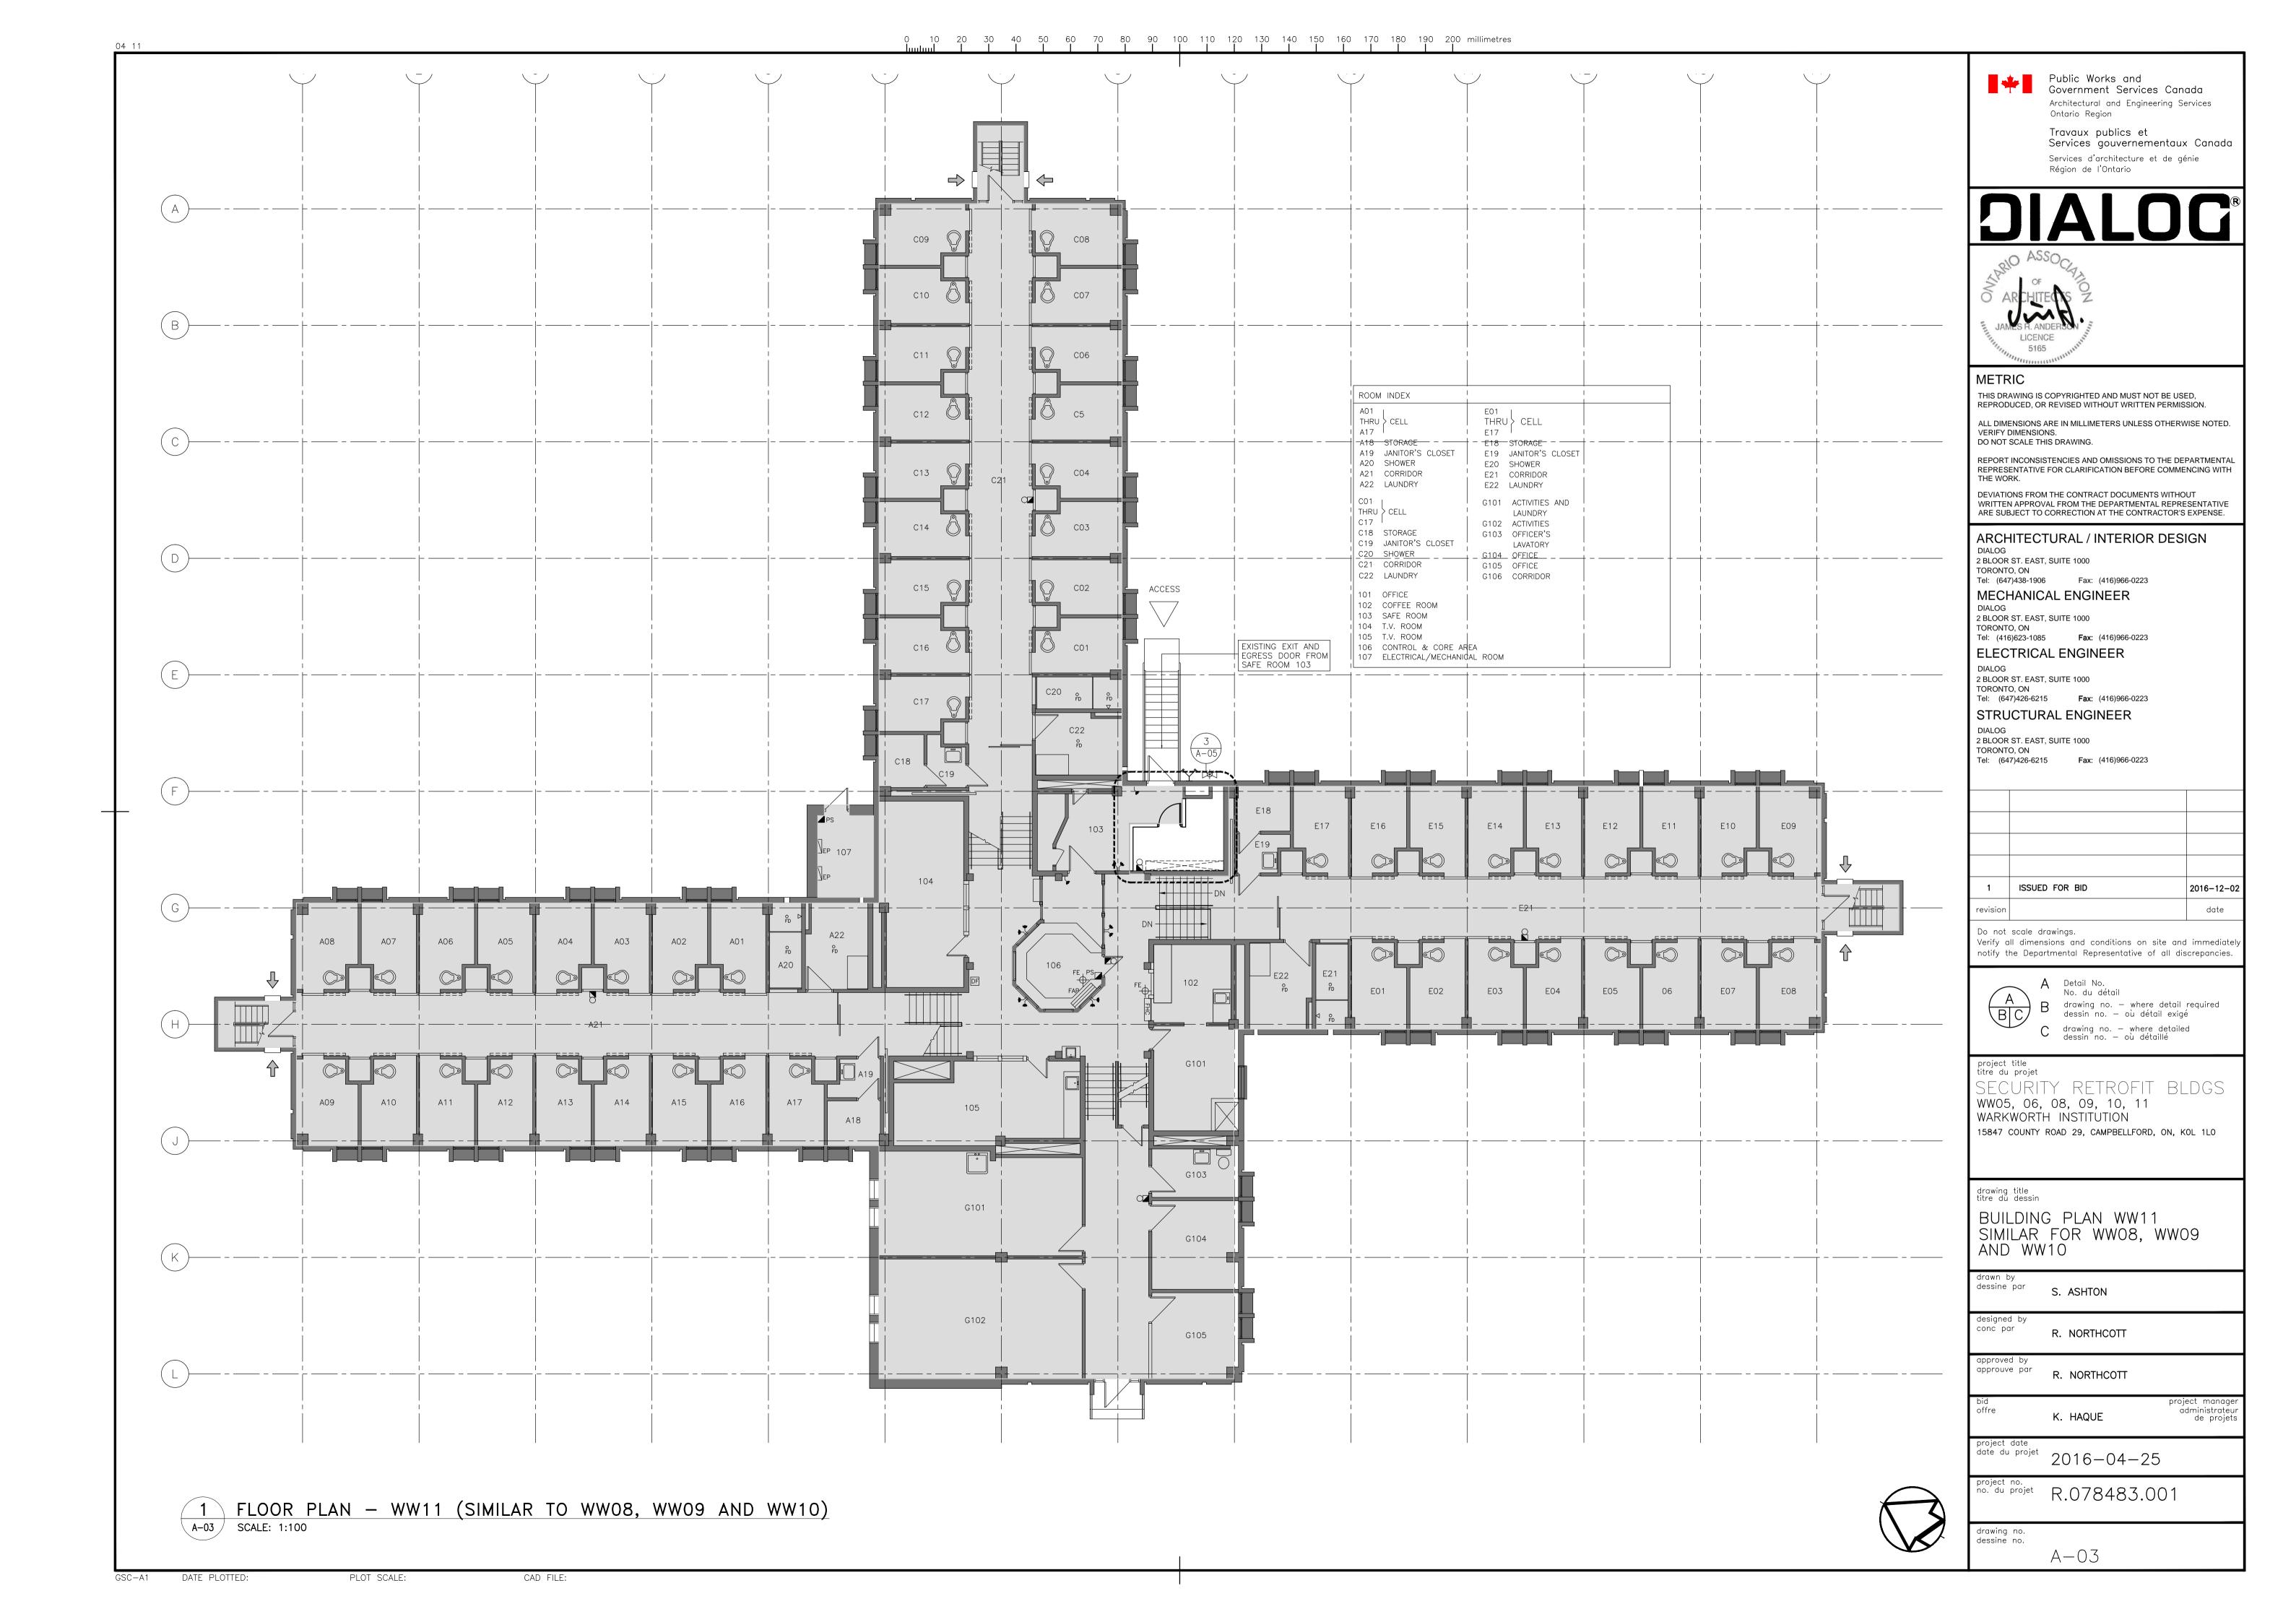
project manage administrateur


project no. R.078483.001


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A-02








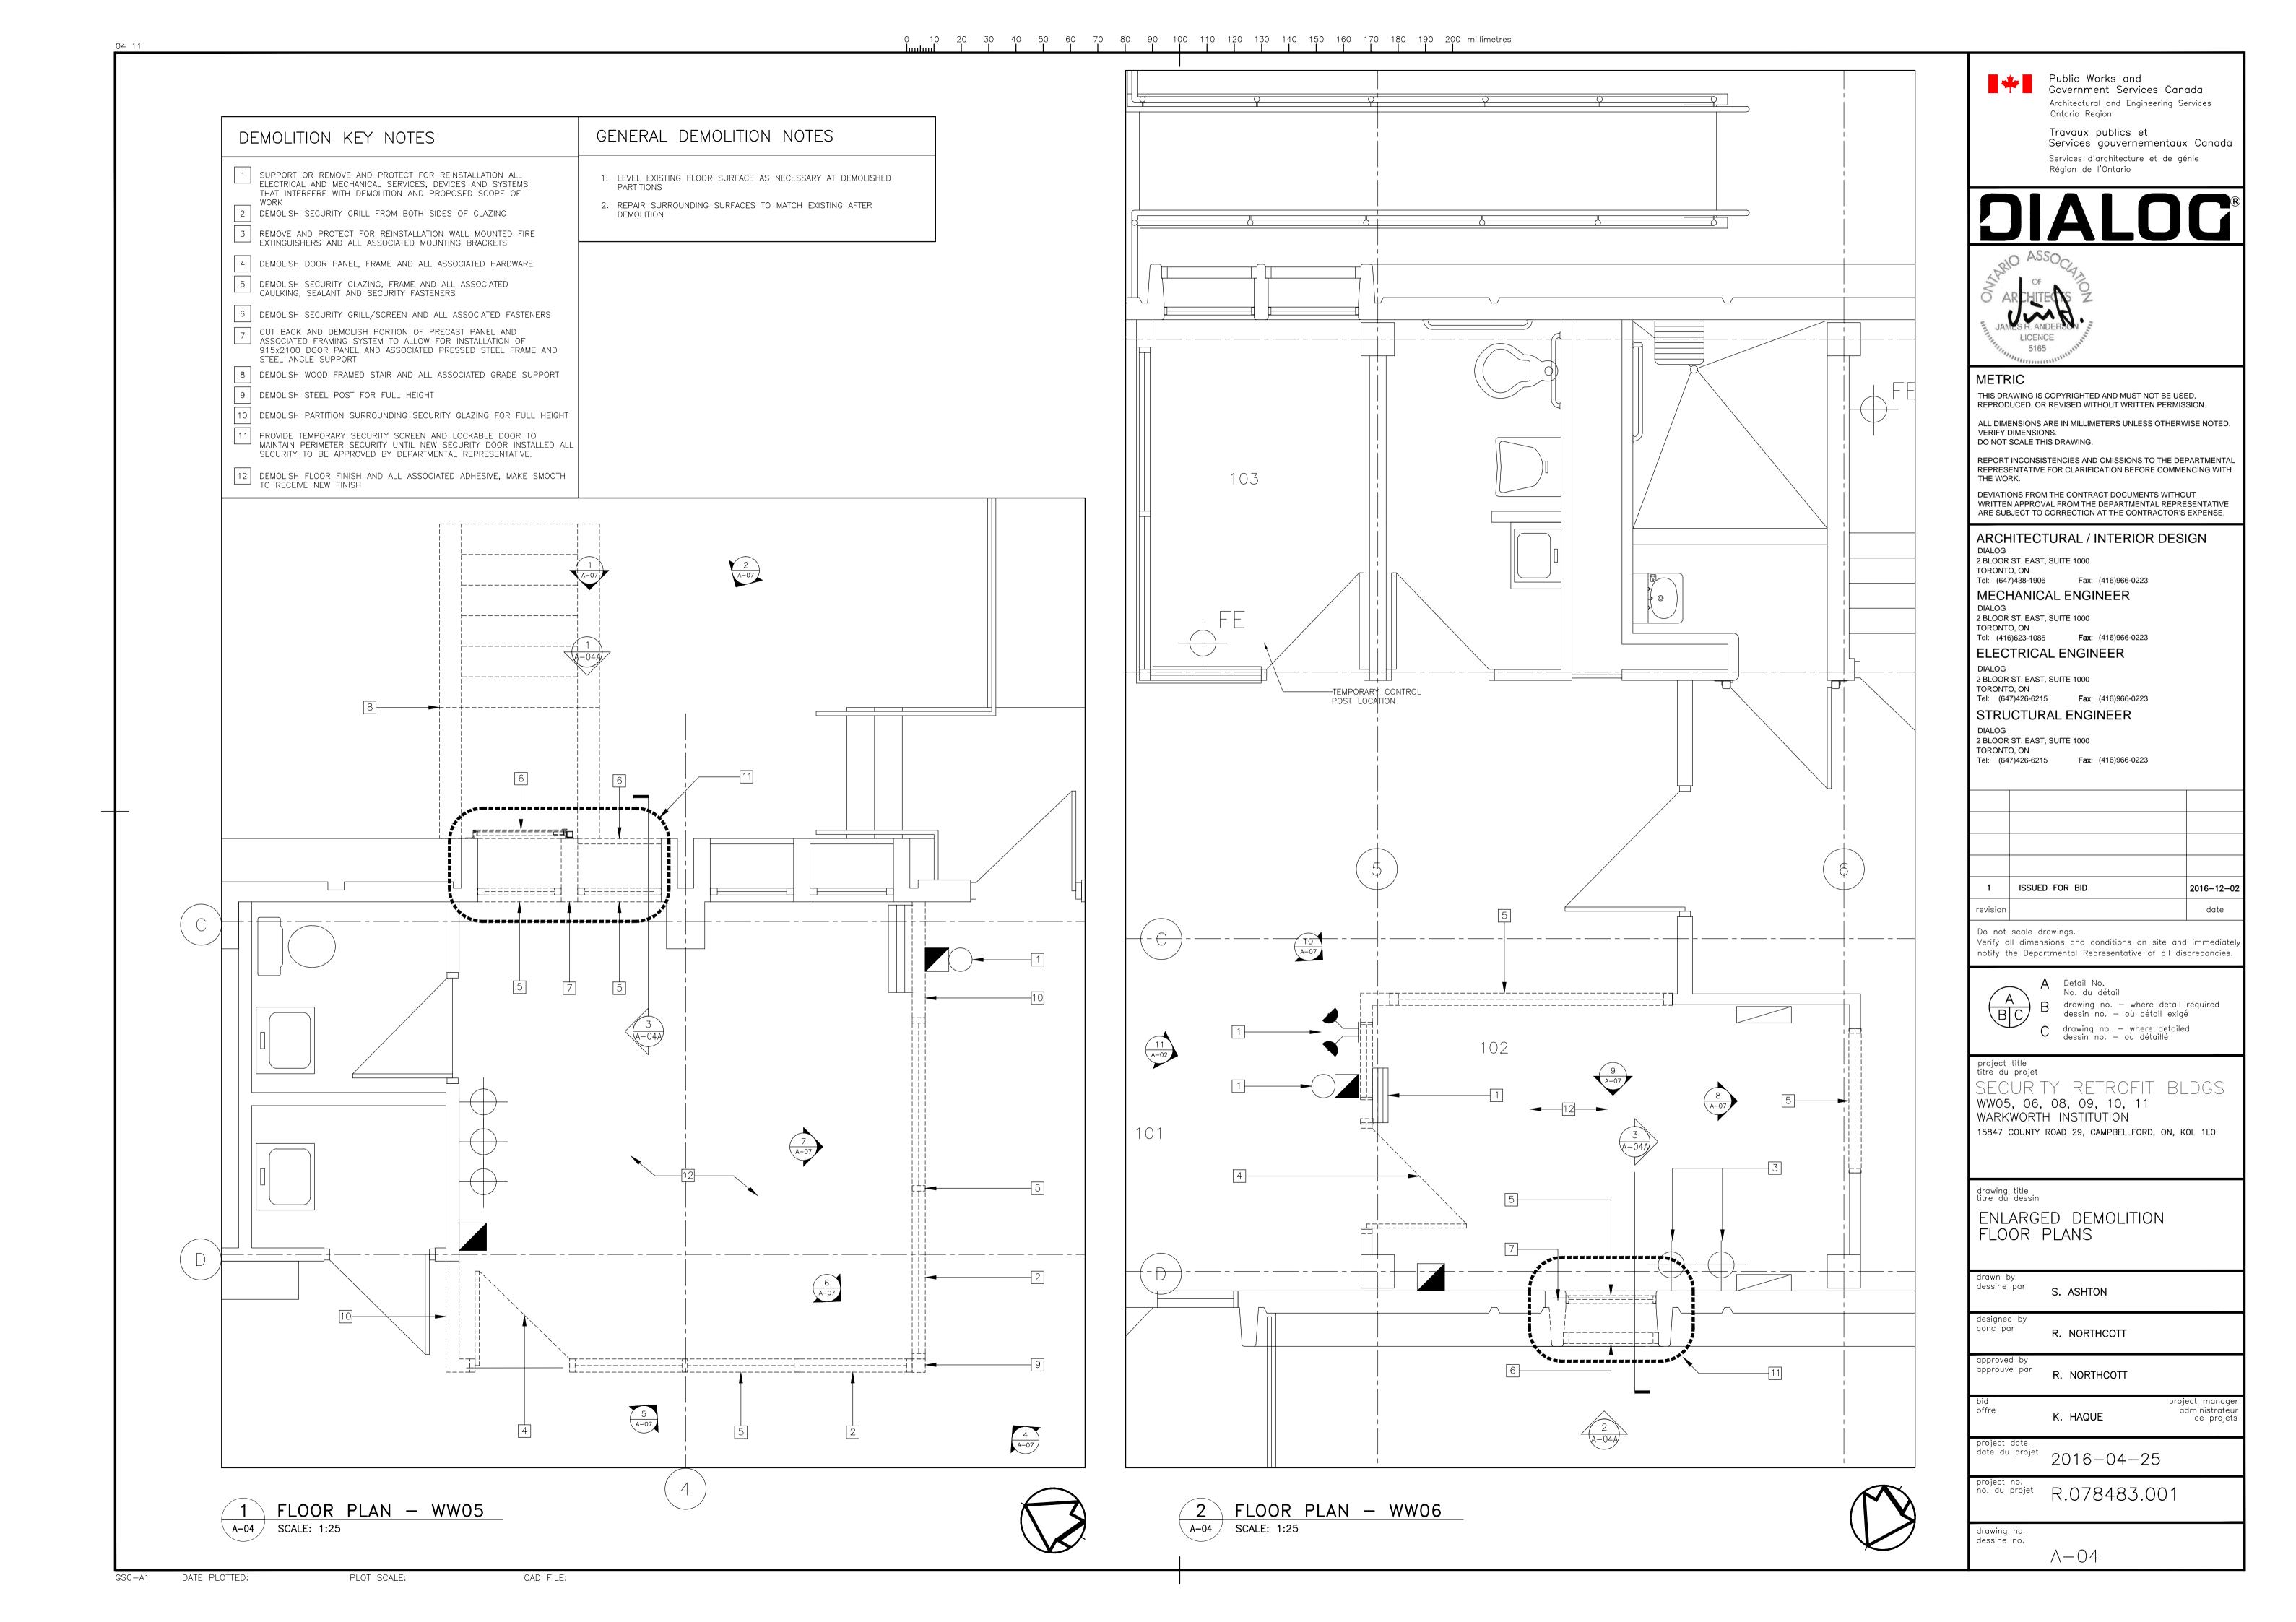

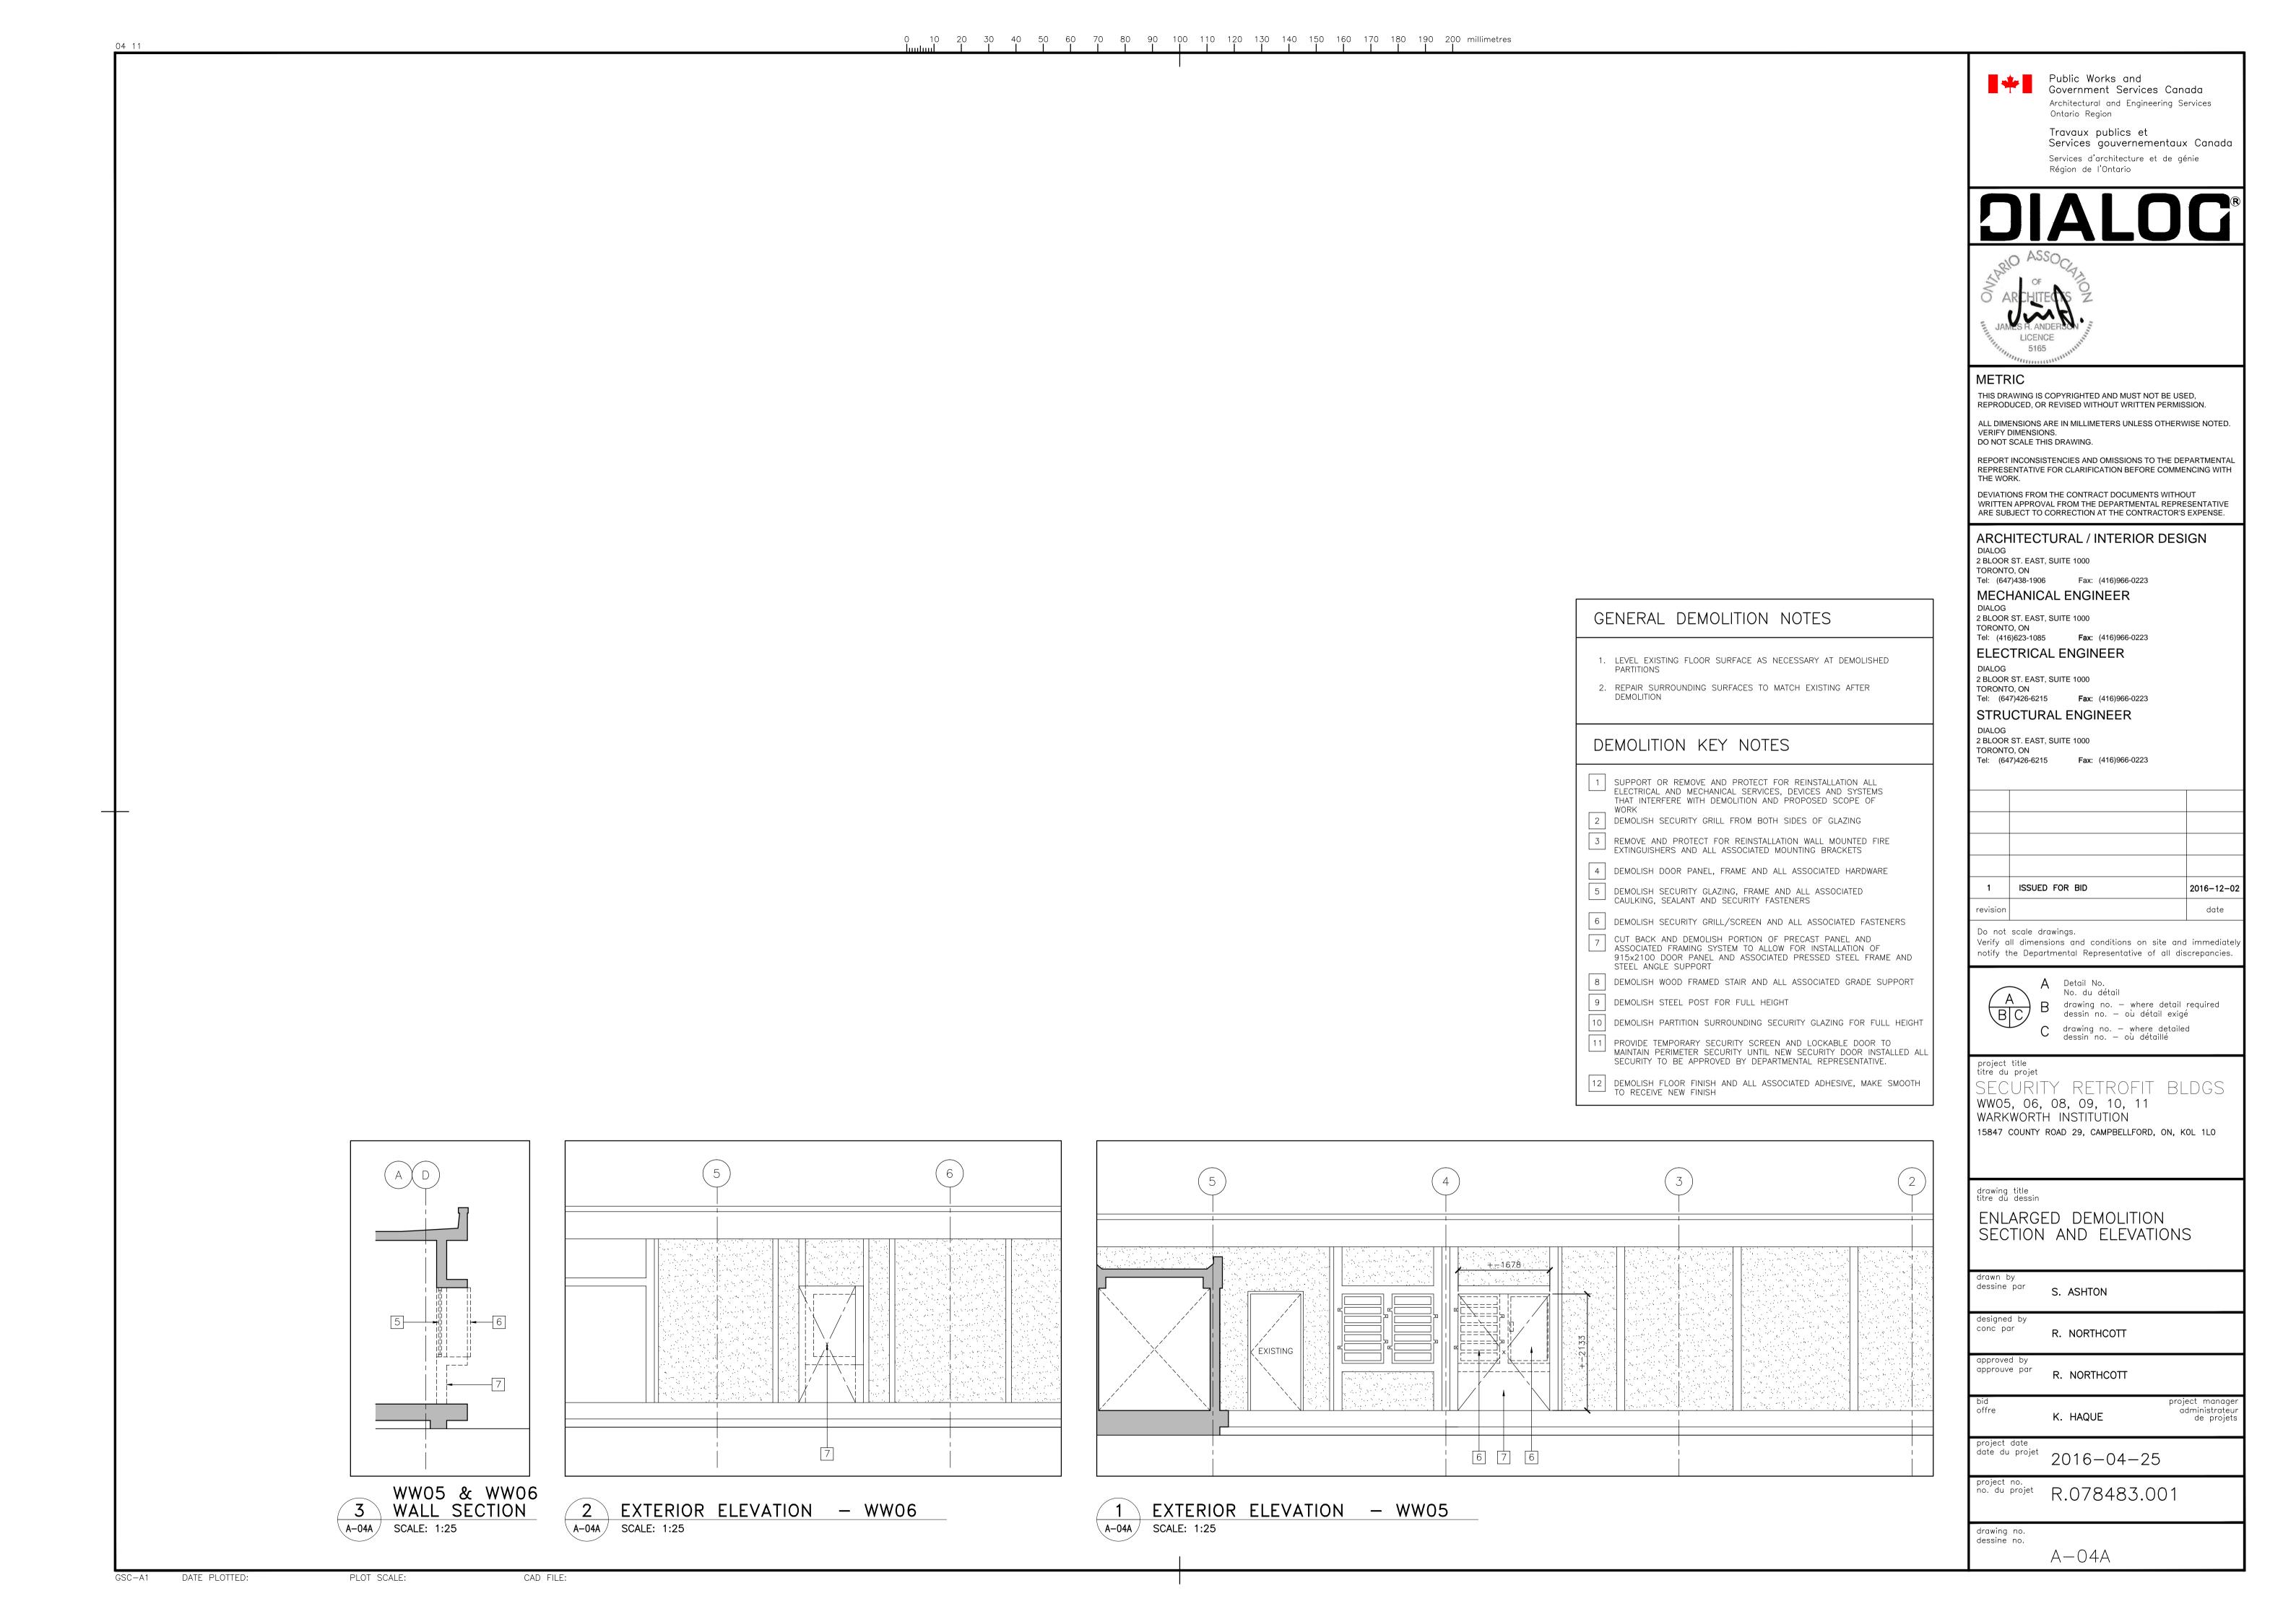
GSC-A1 DATE PLOTTED:

PLOT SCALE:

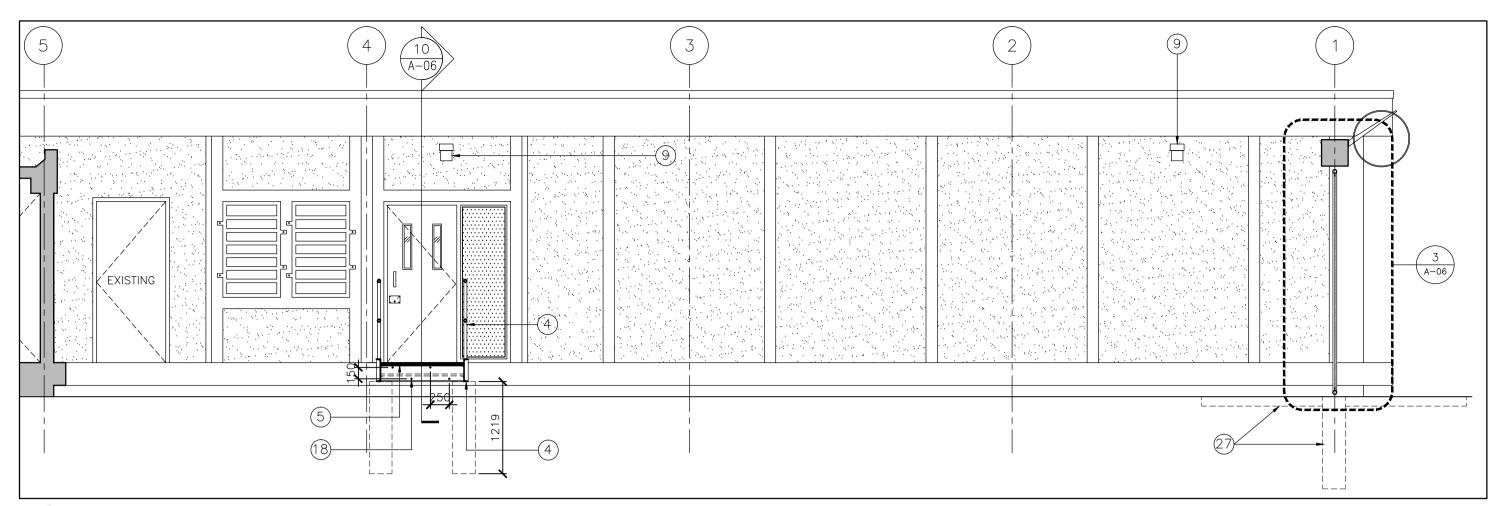

 $\begin{pmatrix} 10 \\ A-06 \end{pmatrix}$

EXTERIOR ELEVATION — WW06 A-06 / SCALE: 1:50

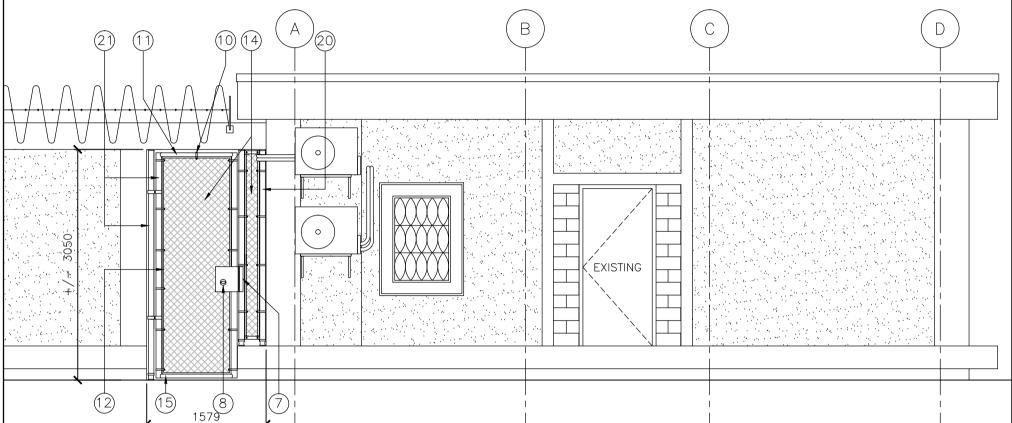

1000

WW05 INTERIOR ELEVATIONS 5 EAST WALL A-06 / SCALE: 1:50



INTERIOR ELEV-NORTH WALL


10 A-06A

WW06 ROOM 102


SCALE: 1:50

WW05 INTERIOR ELEVATIONS 4 SOUTH WALL

A-06 / SCALE: 1:50

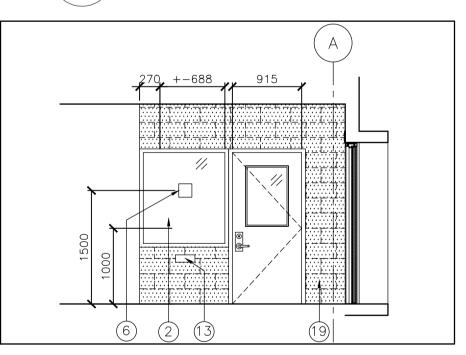

WW06 ROOM 102 8 INTERIOR ELEV—EAST WALL \ A−06 / SCALE: 1:50

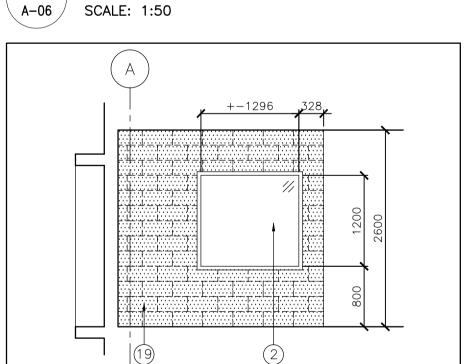


3 EXTERIOR ELEVATION - WW05

EXTERIOR SECTION - WW05

A−06 / SCALE: 1:50

WW06 ROOM 102 INTERIOR ELEV-WEST WALL 6 \ A-06 / SCALE: 1:50

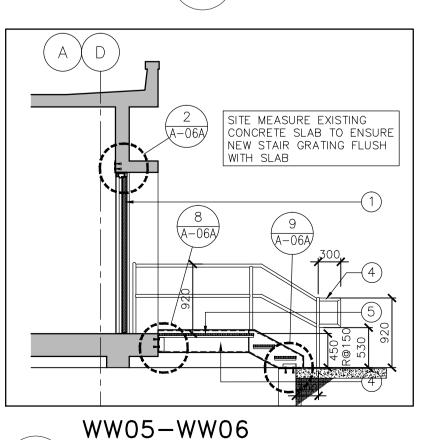


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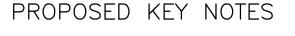
(10) STAIR SECTION

A-06 / SCALE: 1:50

、A−06 /

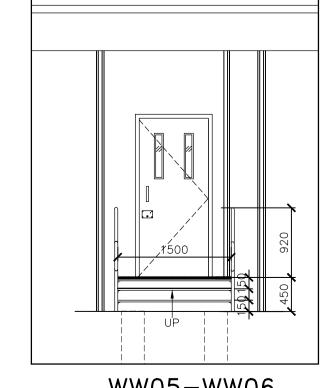

WW05-WW06 STAIR ELEVATION A-06 / SCALE: 1:50



- (1) 915x2100 2.36mm THICK HOLLOW METAL INSULATED DOOR PANEL WITH STYLE D - 2 NARROW LITES 2.36mm PRESSED STEEL FRAME 50mm WIDE (DD1) WITH POWERED HARDWARE, REFER TO ELECTRICAL DRAWINGS FOR WIRING LOCATIONS AND SPECIFICATIONS FOR HARDWARE TYPES
- (1A) 915x2100 2.36mm THICK HOLLOW METAL DOOR PANEL WITH STYLE B - 1 HALF LITE 2.36mm PRESSED STEEL FRAME 50mm WIDE (DD1), REFER TO SPECIFICATIONS FOR HARDWARE TYPE 2.36mm PRESSED STEEL FRAME 50mm WIDE (DD1) SIDE LIGHT WITH 6mm SHEET STEEL INSERT 25mm WIDE INSERT STOP ON ATTACK SIDE 9.6mm SECURITY SCREWS @200 O.C.
- (2) 2.36mm PRESSED STEEL FRAME 50mm WIDE (DD1) WRAP AROUND AT BLOCK, FLUSH AT SHEET STEEL WITH 6mm TEMPERED GLASS ON ATTACK SIDE OF FRAME 12.7mm POLYCARBONATE 25mm GLAZING STOP ON ATTACK SIDE 9.6 mm SECURITY SCREWS @200 O.C.
- (3) DEMOLISH PORTION OF GYPSUM BOARD SUSPENDED CEILING FOR ACCESS TO SCOPE OF WORK AREA, PATCH AND REPAIR TO MAKE GOOD AFTER SCOPE OF WORK COMPLETED AND INSPECTED
- (3A) SINGLE STEEL SHEET 4.24mm FACING WITH SECURITY FASTENERS CONTINUE FROM EXISTING STEEL TO UNDERSIDE OF CONCRETE SLAB CEILING FOR FULL WIDTH OF EXPOSED CONCRETE BLOCK
- (4) GALVANIZED 300mm STEEL CHANNEL AND 40mm PIPE RAIL STEEL
- (5) GALVANIZED TRU-WELD BAR GRATING TREADS, 38X4.8 SERRATED GRATING, CHECKER PLATE NOSING AND LANDING ON STEEL CHANNELS
- (6) SPEAKER PORT ATTACK LEVEL B, SEE 7/A-06A
- 7) FOLGER ADAMS 80-4H FENCE GATE LOCK KEEPER CONTINUOUSLY WELDED TO GATE POST, PROVIDE HOLE FOR LOCK LATCH AS REQUIRED
- (8) MOUNTING PLATE CONTINUOUSLY WELDED TO GATE DOOR POST FOR FOLGER ADAMS FGM-80 LOCK MECHANISM KEYED BOTH SIDES.
- MAX 8mm CLEARANCE. (9) SURFACE MOUNT WALL LIGHTING
- (10) TIE WIRES 300mm O.C. MAXIMUM
- (11) 114.3mmø TOP RAIL
- (12) 5x20mm TENSION BARS
- (13) KEY PASS THROUGH, SEE 7/A-06A
- (14) 50.8mm, 9 GAUGE CHAIN LINK
- (15) 42.2mmø BOTTOM RAIL
- (16) POURED CONCRETE PIER, REFER TO STRUCTURAL DRAWINGS
- (17) PROVIDE TEMPORARY SECURITY SCREEN AND LOCKABLE DOOR TO MAINTAIN PERIMETER SECURITY OF WORK AREA, TO BE APPROVED BY
- (18) DRILL AND INSTALL 12mmø WEDGE CONCRETE ANCHOR WITH 110mm EMBEDMENT IN EXISTING CONCRETE. DESIGN FOR 10kN TENSION AND SHEAR CAPACITIES. ALL ANCHORS SHALL BE INSTALLED AS PER MANUFACTURERS RECOMMENDATIONS. ALL HOLES TO BE PROPERLY DRILLED AND CLEANED
- SINGLE STEEL SHEET 4.24mm FACING WITH SECURITY FASTENERS FROM FLOOR SLAB TO UNDERSIDE OF EXPOSED STRUCTURE FOR FULL WIDTH OF EXPOSED CONCRETE BLOCK OF CONTROL POST PERIMETER
- 20) 73mmø LINE POST
- (21) GATE DOOR POSTS, HINGE POST AND SIDE POSTS ALL 73mmø
- 22 2.36mm PRESSED STEEL FRAME 50mm WIDE (DD1) WELD TO SHEET STEEL FLUSH TO ATTACK SIDE 6mm TEMPERED GLASS ON ATTACK SIDE OF FRAME 12.7mm POLYCARBONATE 25mm GLAZING STOP ON ATTACK SIDE 9.6 mm SECURITY SCREWS @200 O.C.
- 100×100 HSS POST SECURED TO CONCRETE SLAB FLOOR AND U/S OF EXPOSED STRUCTURE
- (24) STEEL SECURITY PARTITION 6mm SHEET STEEL 50x100 HSS STUD @600 O.C. MAXIMUM 6mm SHEET STEEL
- (25) 50×100 STEEL CHANNEL ANCHORED TO EXISTING CONCRETE BLOCK WALL
- 26 2000mmx1200mmx125mm DEEP CONCRETE LANDING AT STAIR ON GRANULAR FILL
- (27) EXISTING ANTI BURROWING WALL BELOW GRADE TO REMAIN. PROVIDE NEW 1600mmX1600mmX125mm CONCRETE LANDING EACH SIDE

OTHER THAN THE STAINLESS STEEL TIE WIRES AT THE SECURE SIDE. AT THE CONCERTINA ALL ELEMENTS OF THE SECURITY FENCE TO BE GALVANIZED STEEL

SITE TO VERIFY ALL DIMENSIONS PRIOR TO FABRICATION

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project title titre du projet

SECURITY RETROFIT BLDGS WW05, 06, 08, 09, 10, 11 WARKWORTH INSTITUTION

15847 COUNTY ROAD 29, CAMPBELLFORD, ON, KOL 1LO

drawing title titre du dessin

drawing no. dessine no.

EXTERIOR AND INTERIOR ELEVATIONS AND SECTIONS

dessine par S. ASHTON

R. NORTHCOTT

approuve par R. NORTHCOTT

administrateu K. HAQUE

date du projet 2016-04-25

no. du projet R.078483.001

A - 06


GSC-A1 DATE PLOTTED: PLOT SCALE:

WW05-WW06


STAIR PLAN

9


A-06 / SCALE: 1:50

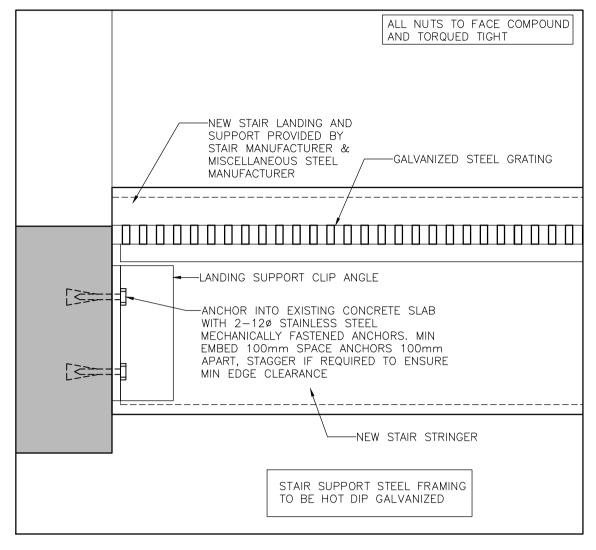


STAIR LANDING \A-06A / SCALE: 1:5

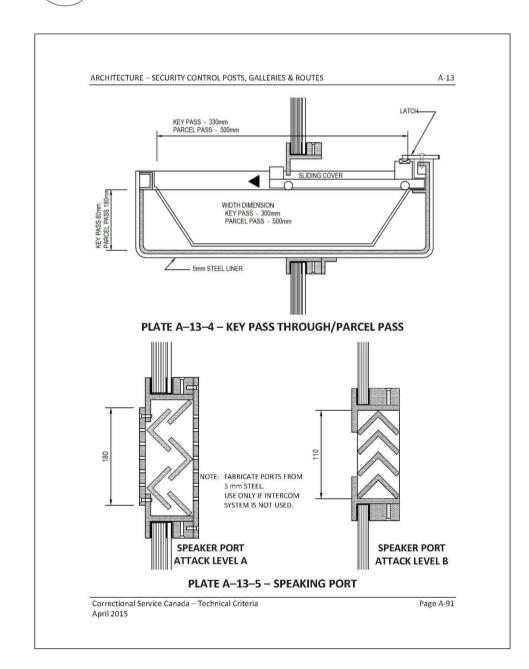


SECTION DETAIL - WW05 & WW06 SCALE: NOT TO SCALE \ A−06A /

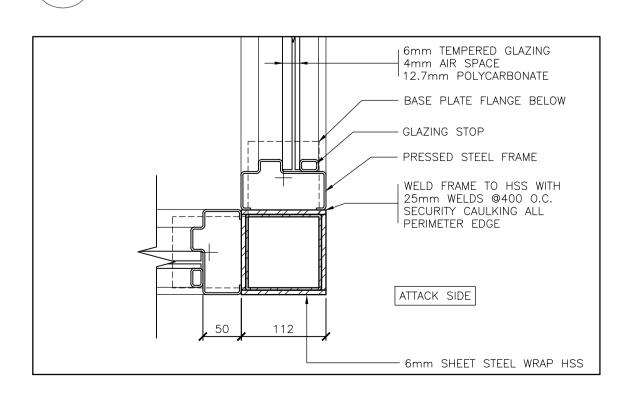


PLAN DETAIL - WW05 ∖ A-06A / SCALE: 1:5

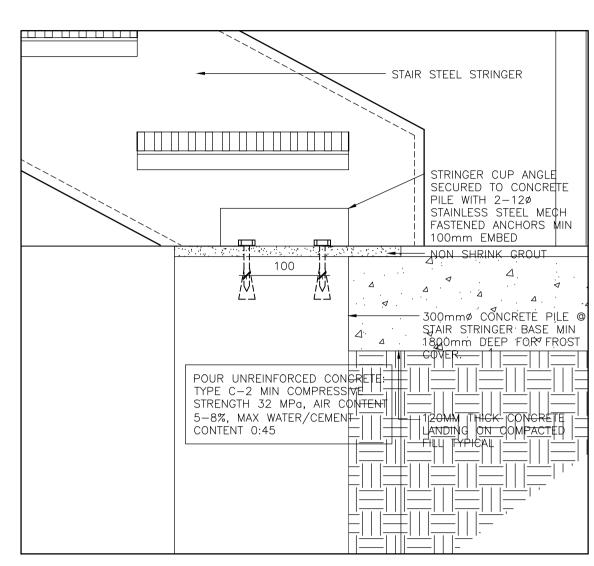


STAIR DETAIL AT BASE SCALE: 1:5 **∖ A−06A** /

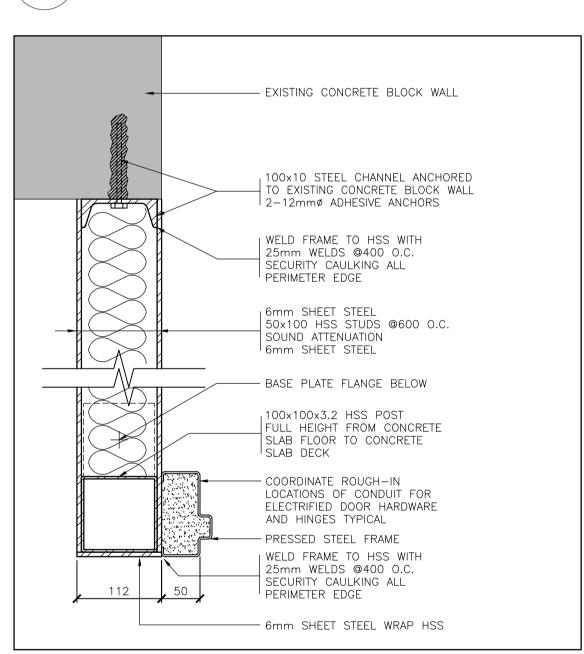


PLAN DETAIL - WW05 \ A-06A / SCALE: 1:5

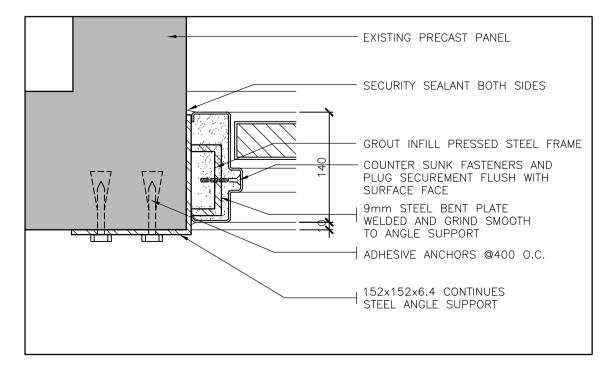


PLAN DETAIL - TYPICAL \ A−06A / SCALE: 1:5

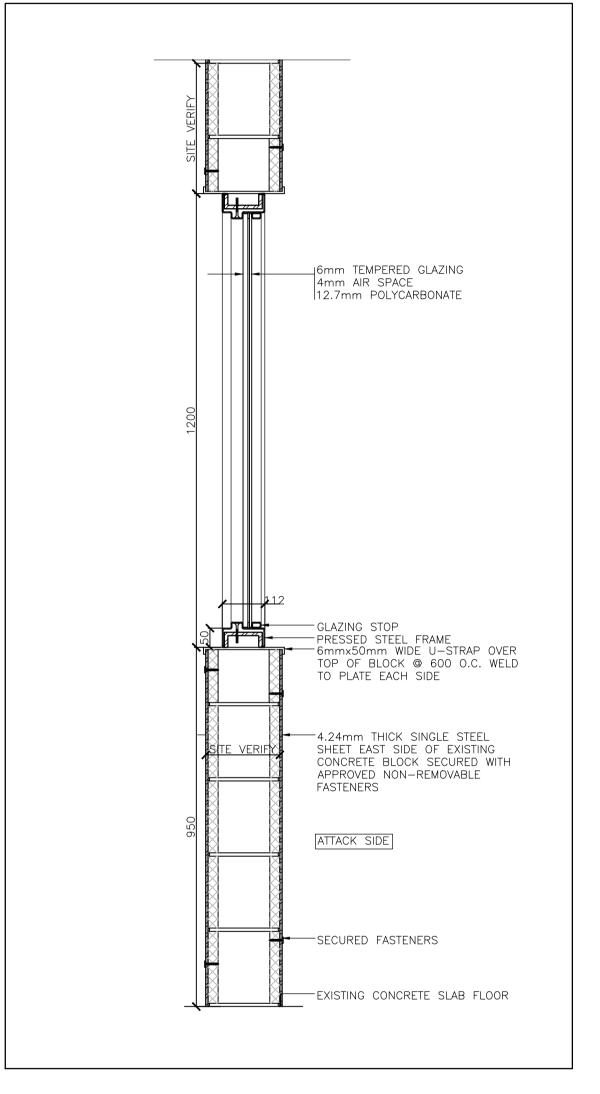


10 SECTION DETAIL - WW06 SCALE: 1:5 ∖ A-06A /

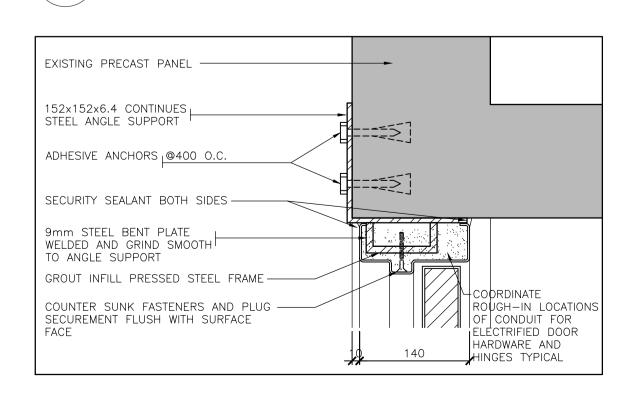

SECTION DETAIL - TYPICAL \ A-06A / SCALE: 1:5

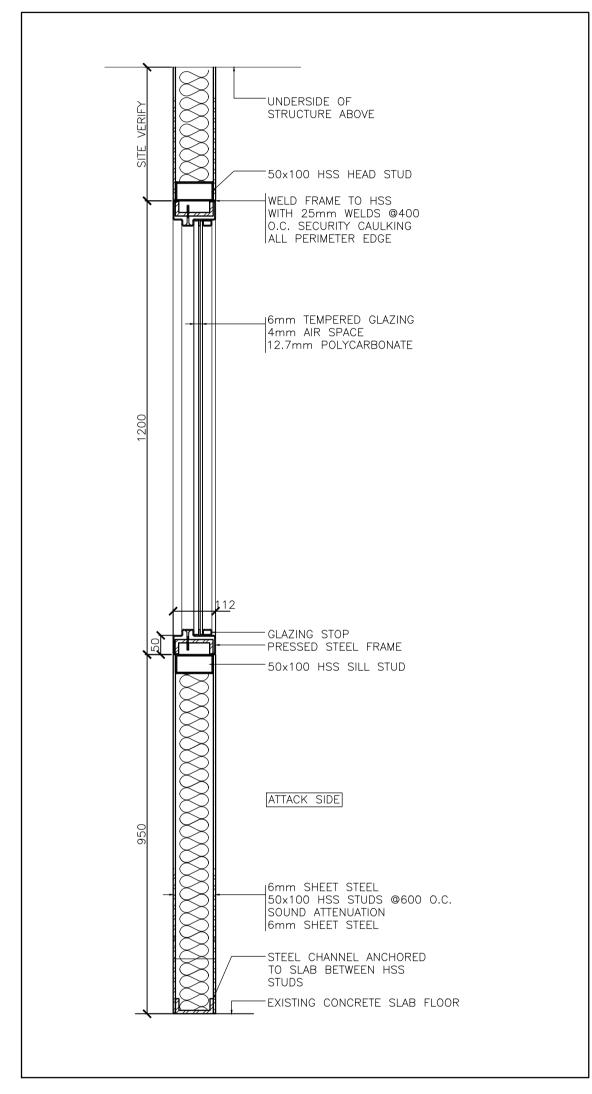

SECTION DETAIL - WW05 ∖ A-06A / SCALE: 1:5

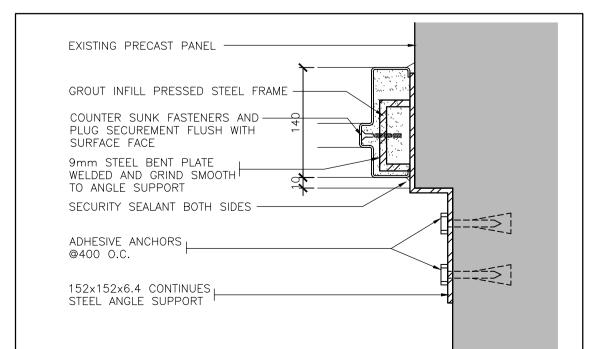

PLAN DETAIL - WW05 \ A-06A / SCALE: 1:5

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dessin no. — où détaillé

project title titre du projet

SECURITY RETROFIT BLDGS

WW05, 06, 08, 09, 10, 11 WARKWORTH INSTITUTION 15847 COUNTY ROAD 29, CAMPBELLFORD, ON, KOL 1LO

drawing title titre du dessin DETAILS

dessine par S. ASHTON

conc par R. NORTHCOTT

approuve par R. NORTHCOTT

offre ádministratěu K. HAQUE

date du projet 2016-04-25

no. du projet R.078483.001

drawing no. dessine no. A-06A

DATE PLOTTED: PLOT SCALE:



EXISTING CONCRETE WALL TO BE REINFORCED WITH SINGLE STEEL SHEET FROM FLOOR SLAB TO UNDERSIDE OF CONCRETE SLAB CEILING - EXISTING GLAZING TO BE DEMOLISHED AND NEW GLAZING WITH WILL BE INSTALLED WITH KEY PASS THROUGH AND SPEAKER PORT - EXISTING DOOR TO BE REPLACED WITH NEW HM
DOOR WITH SIDELIGHT

WW06 - CORRIDOR VIEW OF RM 102



APPROXIMATE LOCATION OF CEILING TO BE REMOVED TO ACCESS UPPER WALL AREA. REINSTALL AFTER COMPLETED


12 TYP. WW08, WW09 AND WW10 SAFE RM 103



6 WW05 - CONTROL & OFFICE RM 102 SOUTH WALL A-07 SCALE: 1:50



EXERCISE YARD - SOUTH WEST CORNER - EXTERIOR

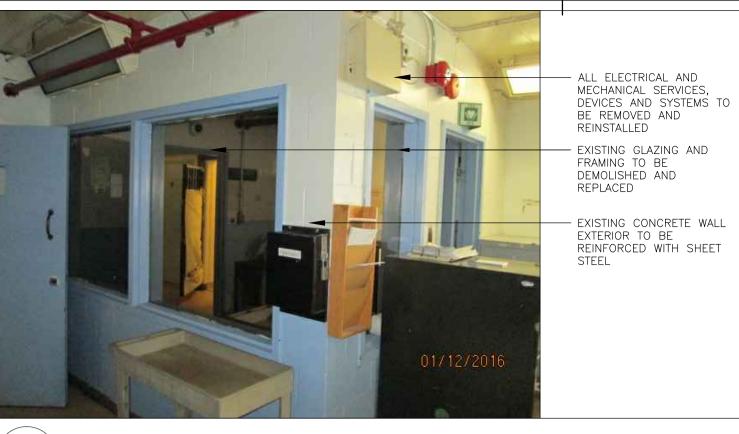

10 WW06 - CORRIDOR VIEW OF RM 102 A-07 SCALE: 1:50



- SUPPORT OR REMOVE AND PROTECT FOR REINSTALLATION ALL ELECTRICAL AND MECHANICAL SERVICES, DEVICES AND SYSTEMS THAT INTERFERE WITH DEMOLITION AND PROPOSED SCOPE OF WORK

- EXISTING GLAZING AND

DEMOLISHED AND REPLACED

FRAMING TO BE

WW06 - CONTROL & OFFICE RM 102 EAST-WALL




5 \ WW05 - CONTROL & OFFICE RM 102 SOUTH WALL A-07 SCALE: 1:50



EXERCISE YARD SOUTH WEST CORNER



9 \ WW06 - CONTROL & OFFICE RM 102 SOUTH WALL \ A-07

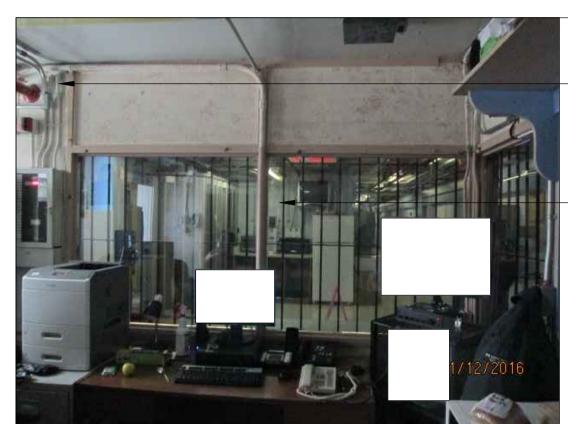

- ALL ELECTRICAL AND MECHANICAL SERVICES, DEVICES AND SYSTEMS TO BE REMOVED AND REINSTALLED - ALL EXISTING GLAZING AND

GRILLS TO BE DEMOLISHED. NEW SECURITY GLAZING AND PARTITION TO BE

WW05 - CONTROL & OFFICE RM 102 EAST WALL



WW05 - CONTROL & OFFICE RM 102 EAST WALL A-07 SCALE: 1:50



EXERCISE YARD SOUTH FACING RM 102



Public Works and Government Services Canada Architectural and Engineering Services Ontario Region

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ARCHITECTURAL / INTERIOR DESIGN

DIALOG 2 BLOOR ST. EAST, SUITE 1000 TORONTO, ON

Tel: (647)438-1906 Fax: (416)966-0223 MECHANICAL ENGINEER

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STRUCTURAL ENGINEER

2 BLOOR ST. EAST, SUITE 1000

TORONTO, ON

ISSUED FOR BID 2016-12-02 date

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Detail No. No. du détail drawing no. — where detail required dessin no. — où détail exigé drawing no. — where detailed

project title titre du projet

SECURITY RETROFIT BLDGS

WW05, 06, 08, 09, 10, 11 WARKWORTH INSTITUTION

15847 COUNTY ROAD 29, CAMPBELLFORD, ON, KOL 1LO

SCOPE OF WORK PHOTOS

dessine par A. TO

R. NORTHCOTT

approuve par R. NORTHCOTT

ádministratěu K. HAQUE


2016-04-25

no. du projet R.078483.001

drawing no. dessine no.

A - 07

DATE PLOTTED: PLOT SCALE:

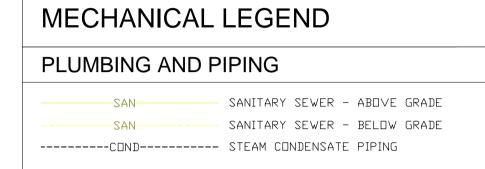

-----RL----- REFRIGERANT LIQUID PIPING

SPECIAL PIPING AND SYSTEMS

CONTROLS AND INSTRUMENTATION								
Ţ	THERMOSTAT							
AIR DISTRIBUTION								
S-1 300ø	AIR DUTLET TAG TYPE SUPPLY TYPE S SIZE RETURN TYPE R FLOW (L/S) EXHAUST TYPE E							
RTU-1	EQUIPMENT TAG							
—— U/C —— 1	DOOR UNDERCUT							
	DOOR GRILLE (SIZE NOTED)							
─/ ─	DIRECTION OF AIR FLOW							
	<u>DUCT DIMENSIONING</u> (CLEAR INSIDE DUCT DIMENSION)							
	ROUND DUCT							
	DVAL DUCT (where 300 is the visible dim.)							
	RECTANGULAR DUCT (WHERE 300 IS THE VISIBLE DIM.)							

→ 300X200 → SINGLE LINE DUCT REPRESENTATION

DRAWING LIST

M0.01 MECHANICAL LEGEND, SCHEDULES & DETAILS
M2.01 ENLARGED PROPOSED MECHANICAL HVAC UPGRADE PLAN


AIR CONDITIONING UNIT SCHEDULE

AIK	AIR CONDITIONING UNIT SCHEDULE												
TAG SERV		LOCATION	REFRIGERANT FL	AIR		ELECTRICAL CHARACTERISTICS			LIQUID		TOTAL	TOTAL	
	SERVICE			FLOW (L/S)	WEIGHT (KG)	VOLTAGE (V/PH/Hz)	M□P (AMPS)	MCA (AMPS)	PIPE SIZE (MM)	EMERGENCY POWER	CODLING HEATING CAPACITY (KW) (KW)	NOTES	
AC-1	OFFICE	ROOM 102, WW05 & WW06	R410A	266.6	21	208/1/60	30	18.1	10	_	5.8	6.4	1
CU-1	OFFICE	ROOM 102, WW05 & WW06	R410A	966.5	60	208/1/60	30	18.1	10	_	5.8	6.4	1

NOTES

1. INDOOR UNIT AC-1 TO BE POWERED BY OUTDOOR UNIT CU-1. COORDINATE WITH MANUFACTURER AND ELECTRICAL CONTRACTOR.

2. UNITS TO BE C/W FULL ENCLOSURE AND TO BE SURFACE MOUNTED.

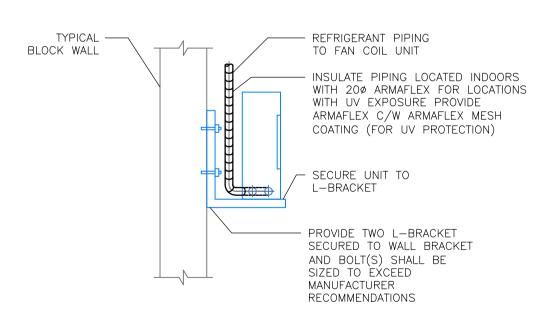

NOTE:

1. CONDENSER UNIT TO BE INSTALLED ACCORDING TO ALL APPLICABLE NATIONAL AND LOCAL ELECTRICAL, MECHANICAL AND BUILDING CODES.

REFER TO MANUFACTURER FOR MINIMUM INSTALLATION CLEARANCES.
 INSTALL EQUIPMENT PER MANUFACTURER RECOMMENDATIONS.





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DIALOG 2 BLOOR ST. EAST, SUITE 1000 TORONTO, ON

STRUCTURAL ENGINEER
DIALOG

ISSUED FOR BID 2016-12-0 date

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project title titre du projet

SECURITY RETROFIT BLDGS wwo5, 06, 08, 09, 10, 11 warkworth institution

15847 COUNTY ROAD 29, CAMPBELLFORD, ON, KOL 1LO

drawing title titre du dessin

MECHANICAL LEGEND, SCHEDULES & DETAILS

drawn by dessine par

designed by conc par

approuve par H

project manager administrateur de projets

project date date du projet

offre


project no. no. du projet R.078483.001

11.07040

drawing no. dessine no.

M0.01

GSC-A1 DATE PLOTTED: PLOT SCALE: CAD FILE:

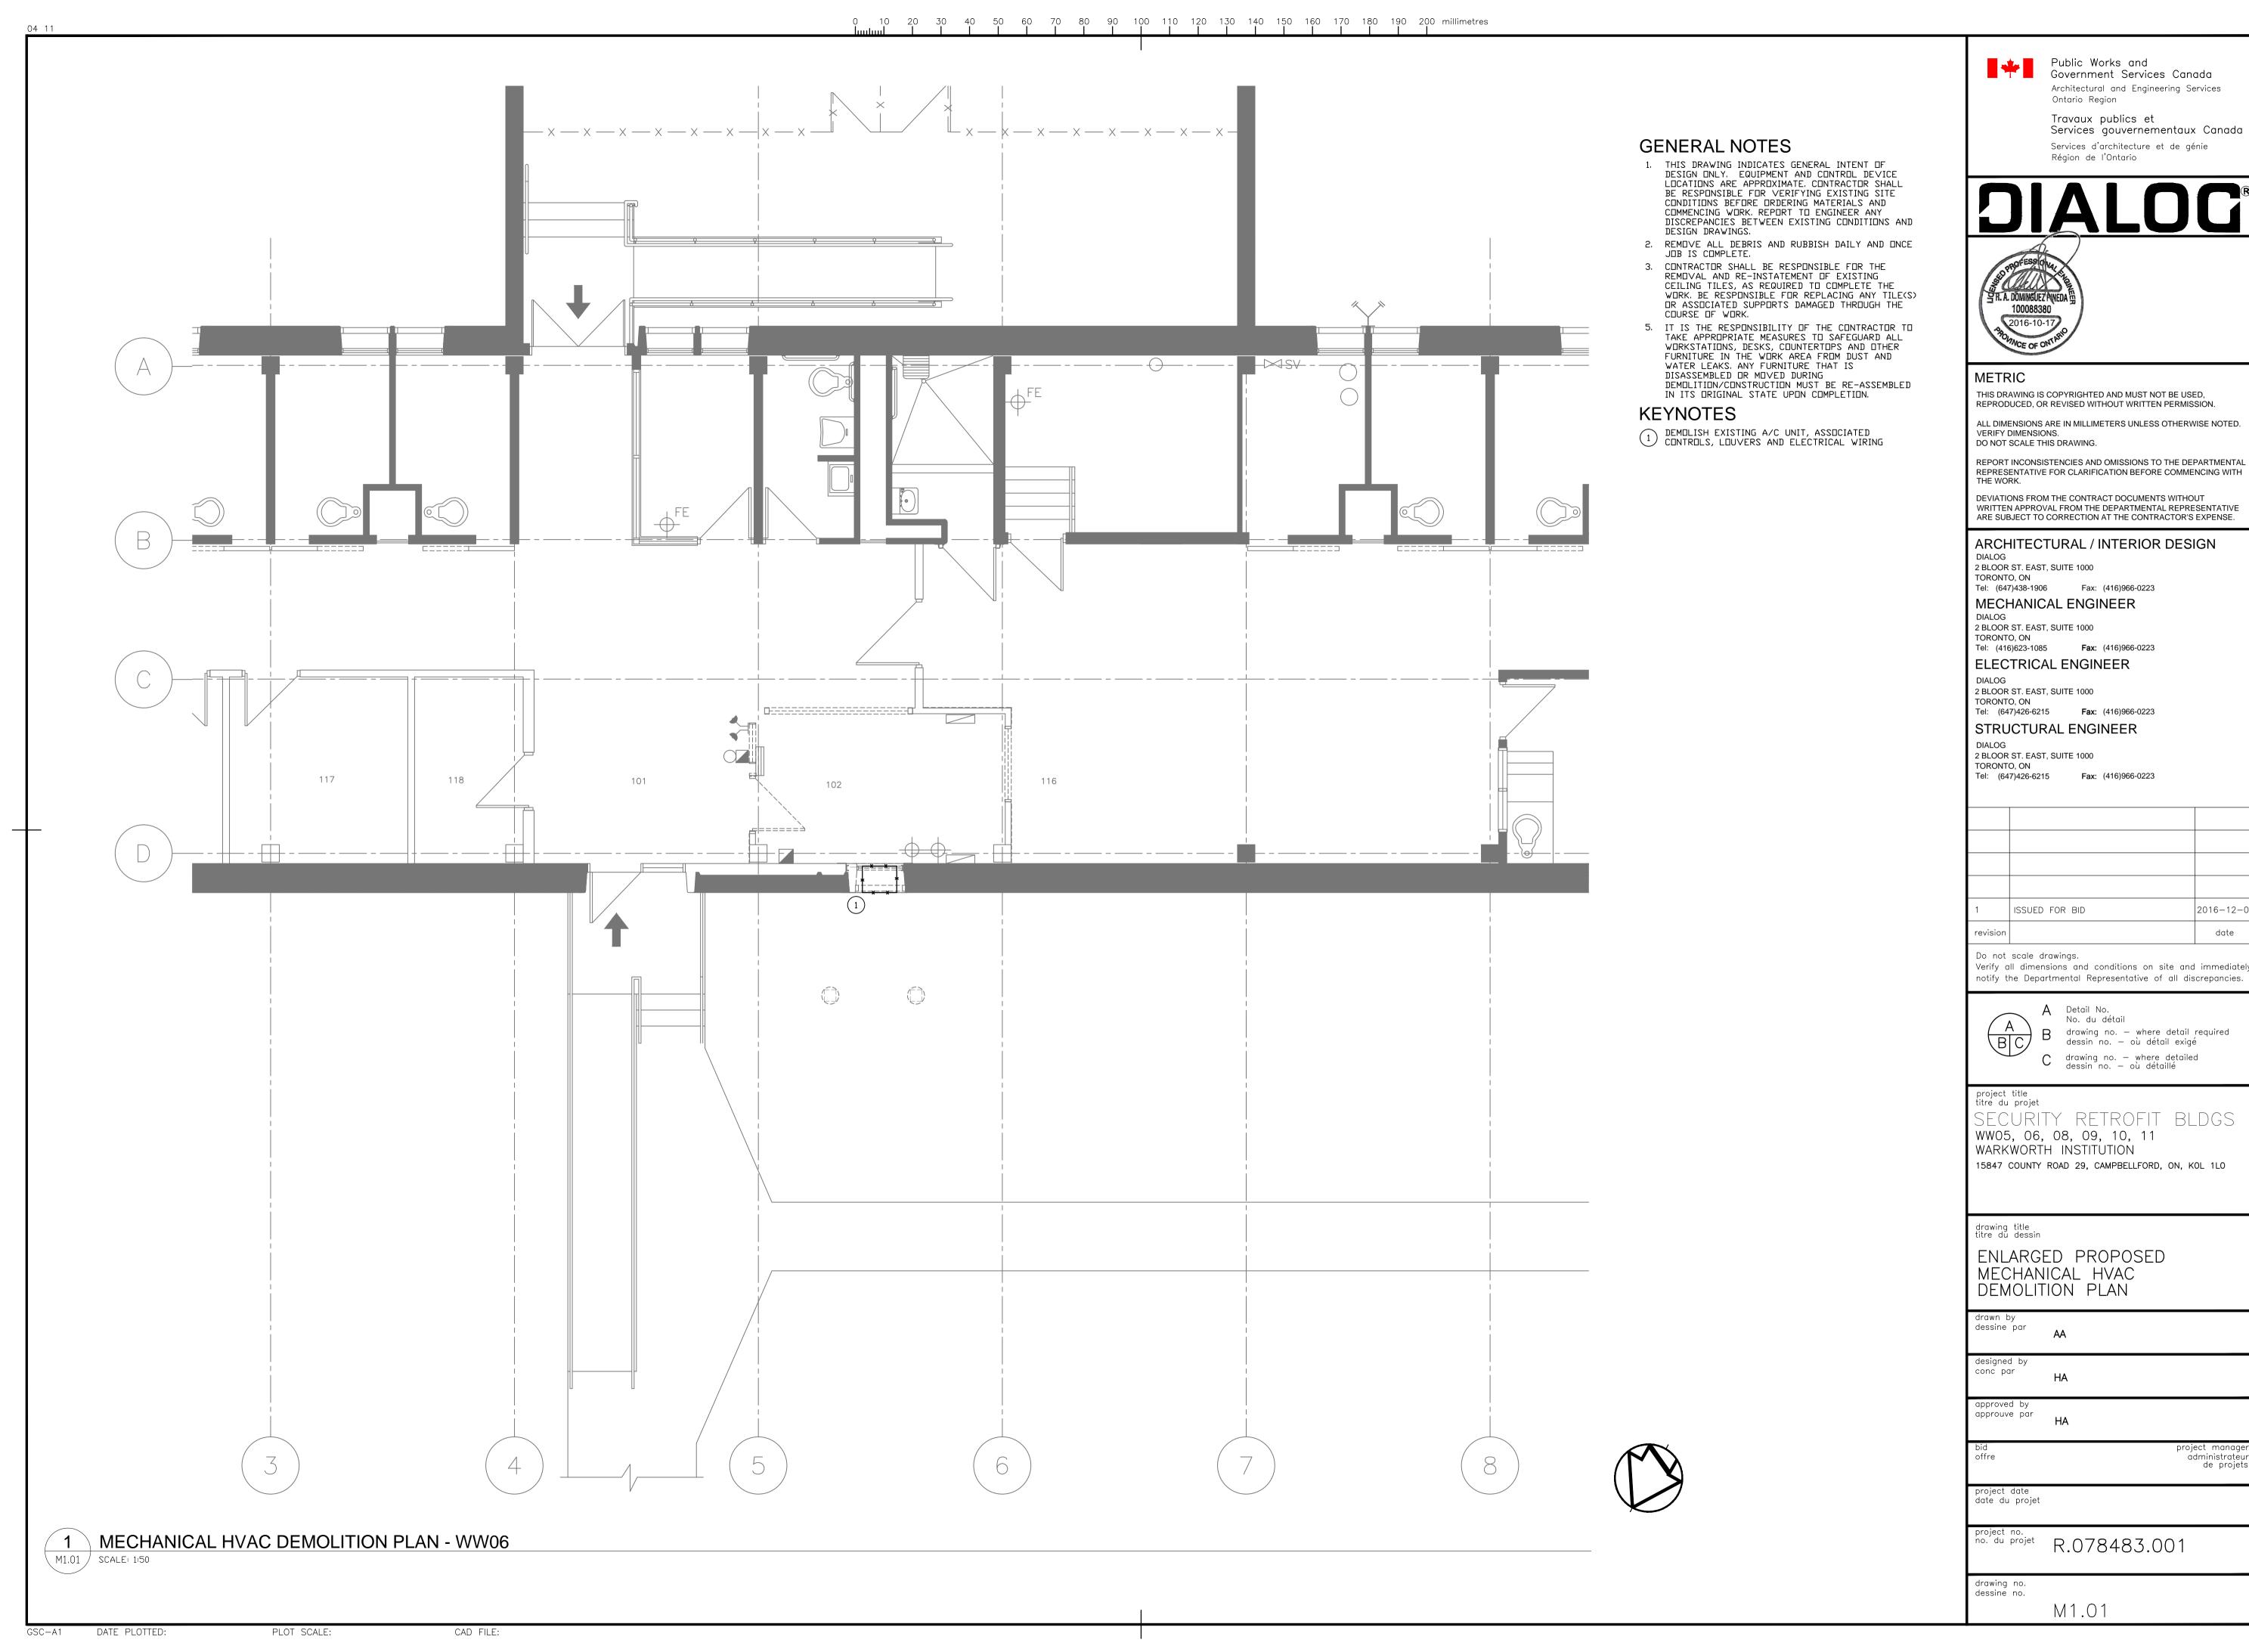



2016-12-0

GSC-A1 DATE PLOTTED:

PLOT SCALE:


CAD FILE:



2016-12-0


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M1.02



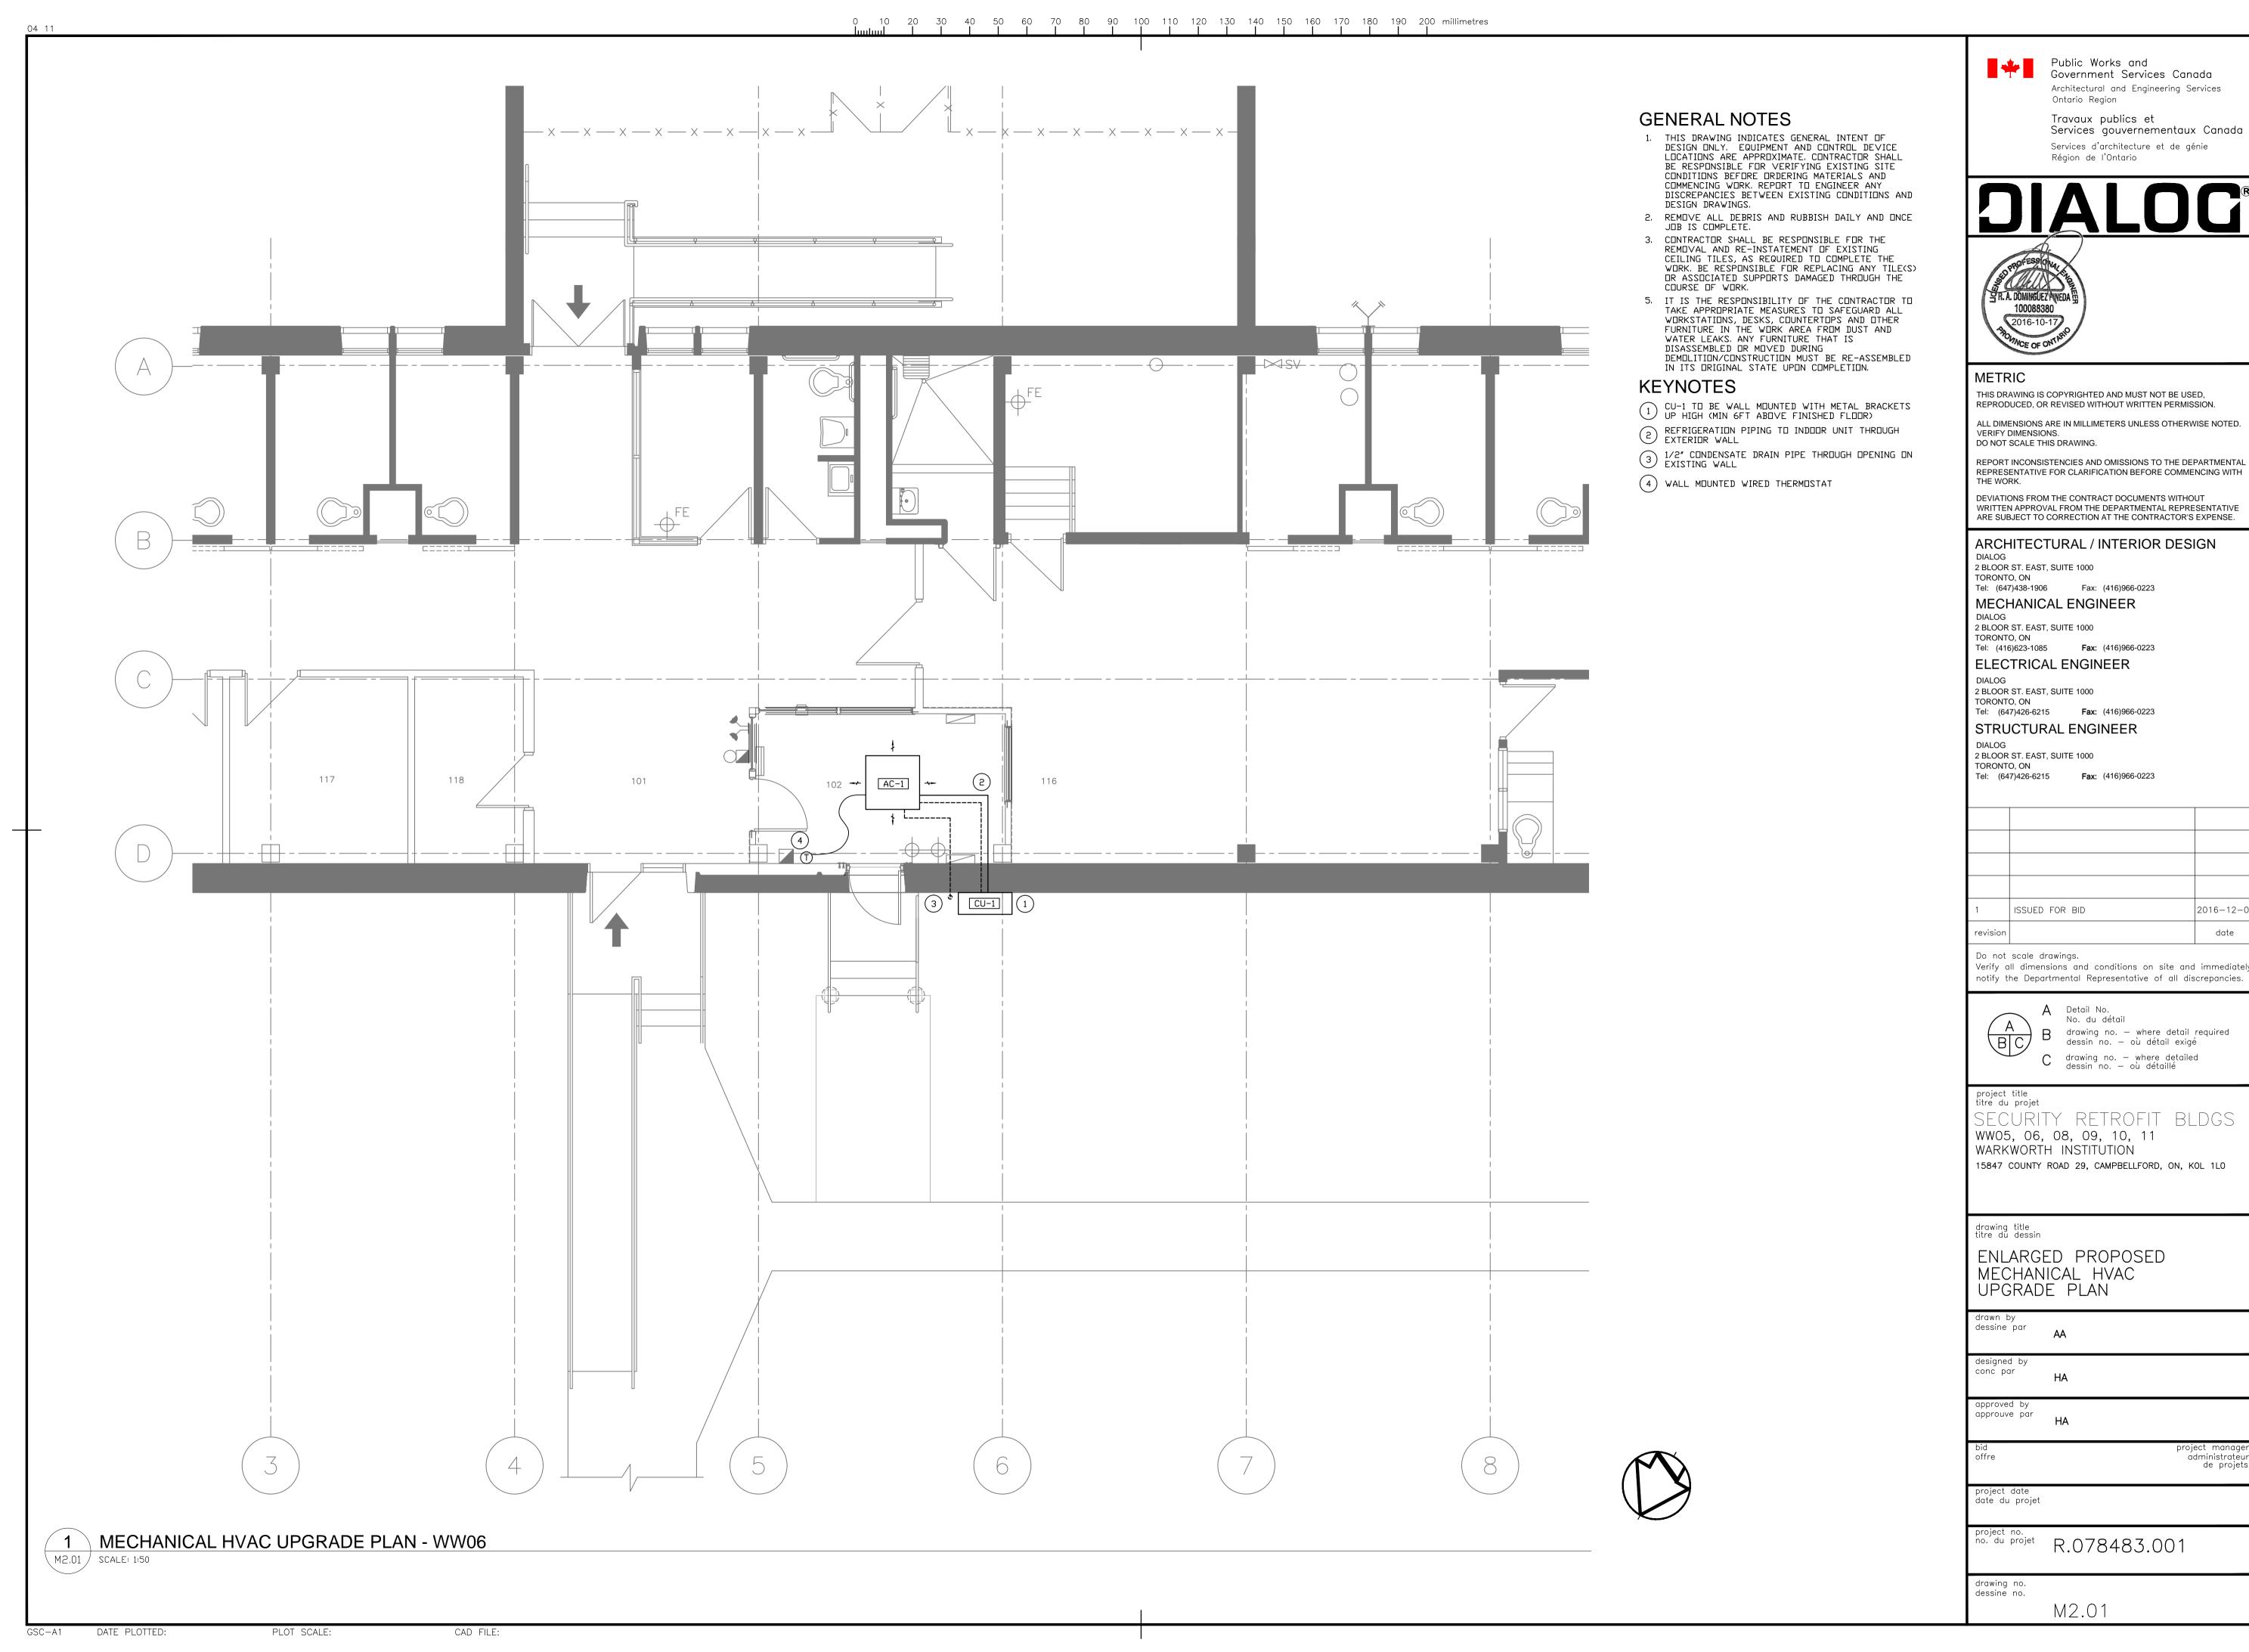

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LUMINAIRE SCHEDULE										
TYPE	MANUFACTURER/DISTRIBUTOR	CATALOGUE #	LAMPS	REMARKS						
W1	LSI INDUSTRIES	XPWS3-FT-LED-48-450-NW-UE-PLP	LED (48 LEDs), 120/277V, 4000K (NEUTRAL WHITE)	LED PATRIOT WALL SCONCE						

KEYNOTES:

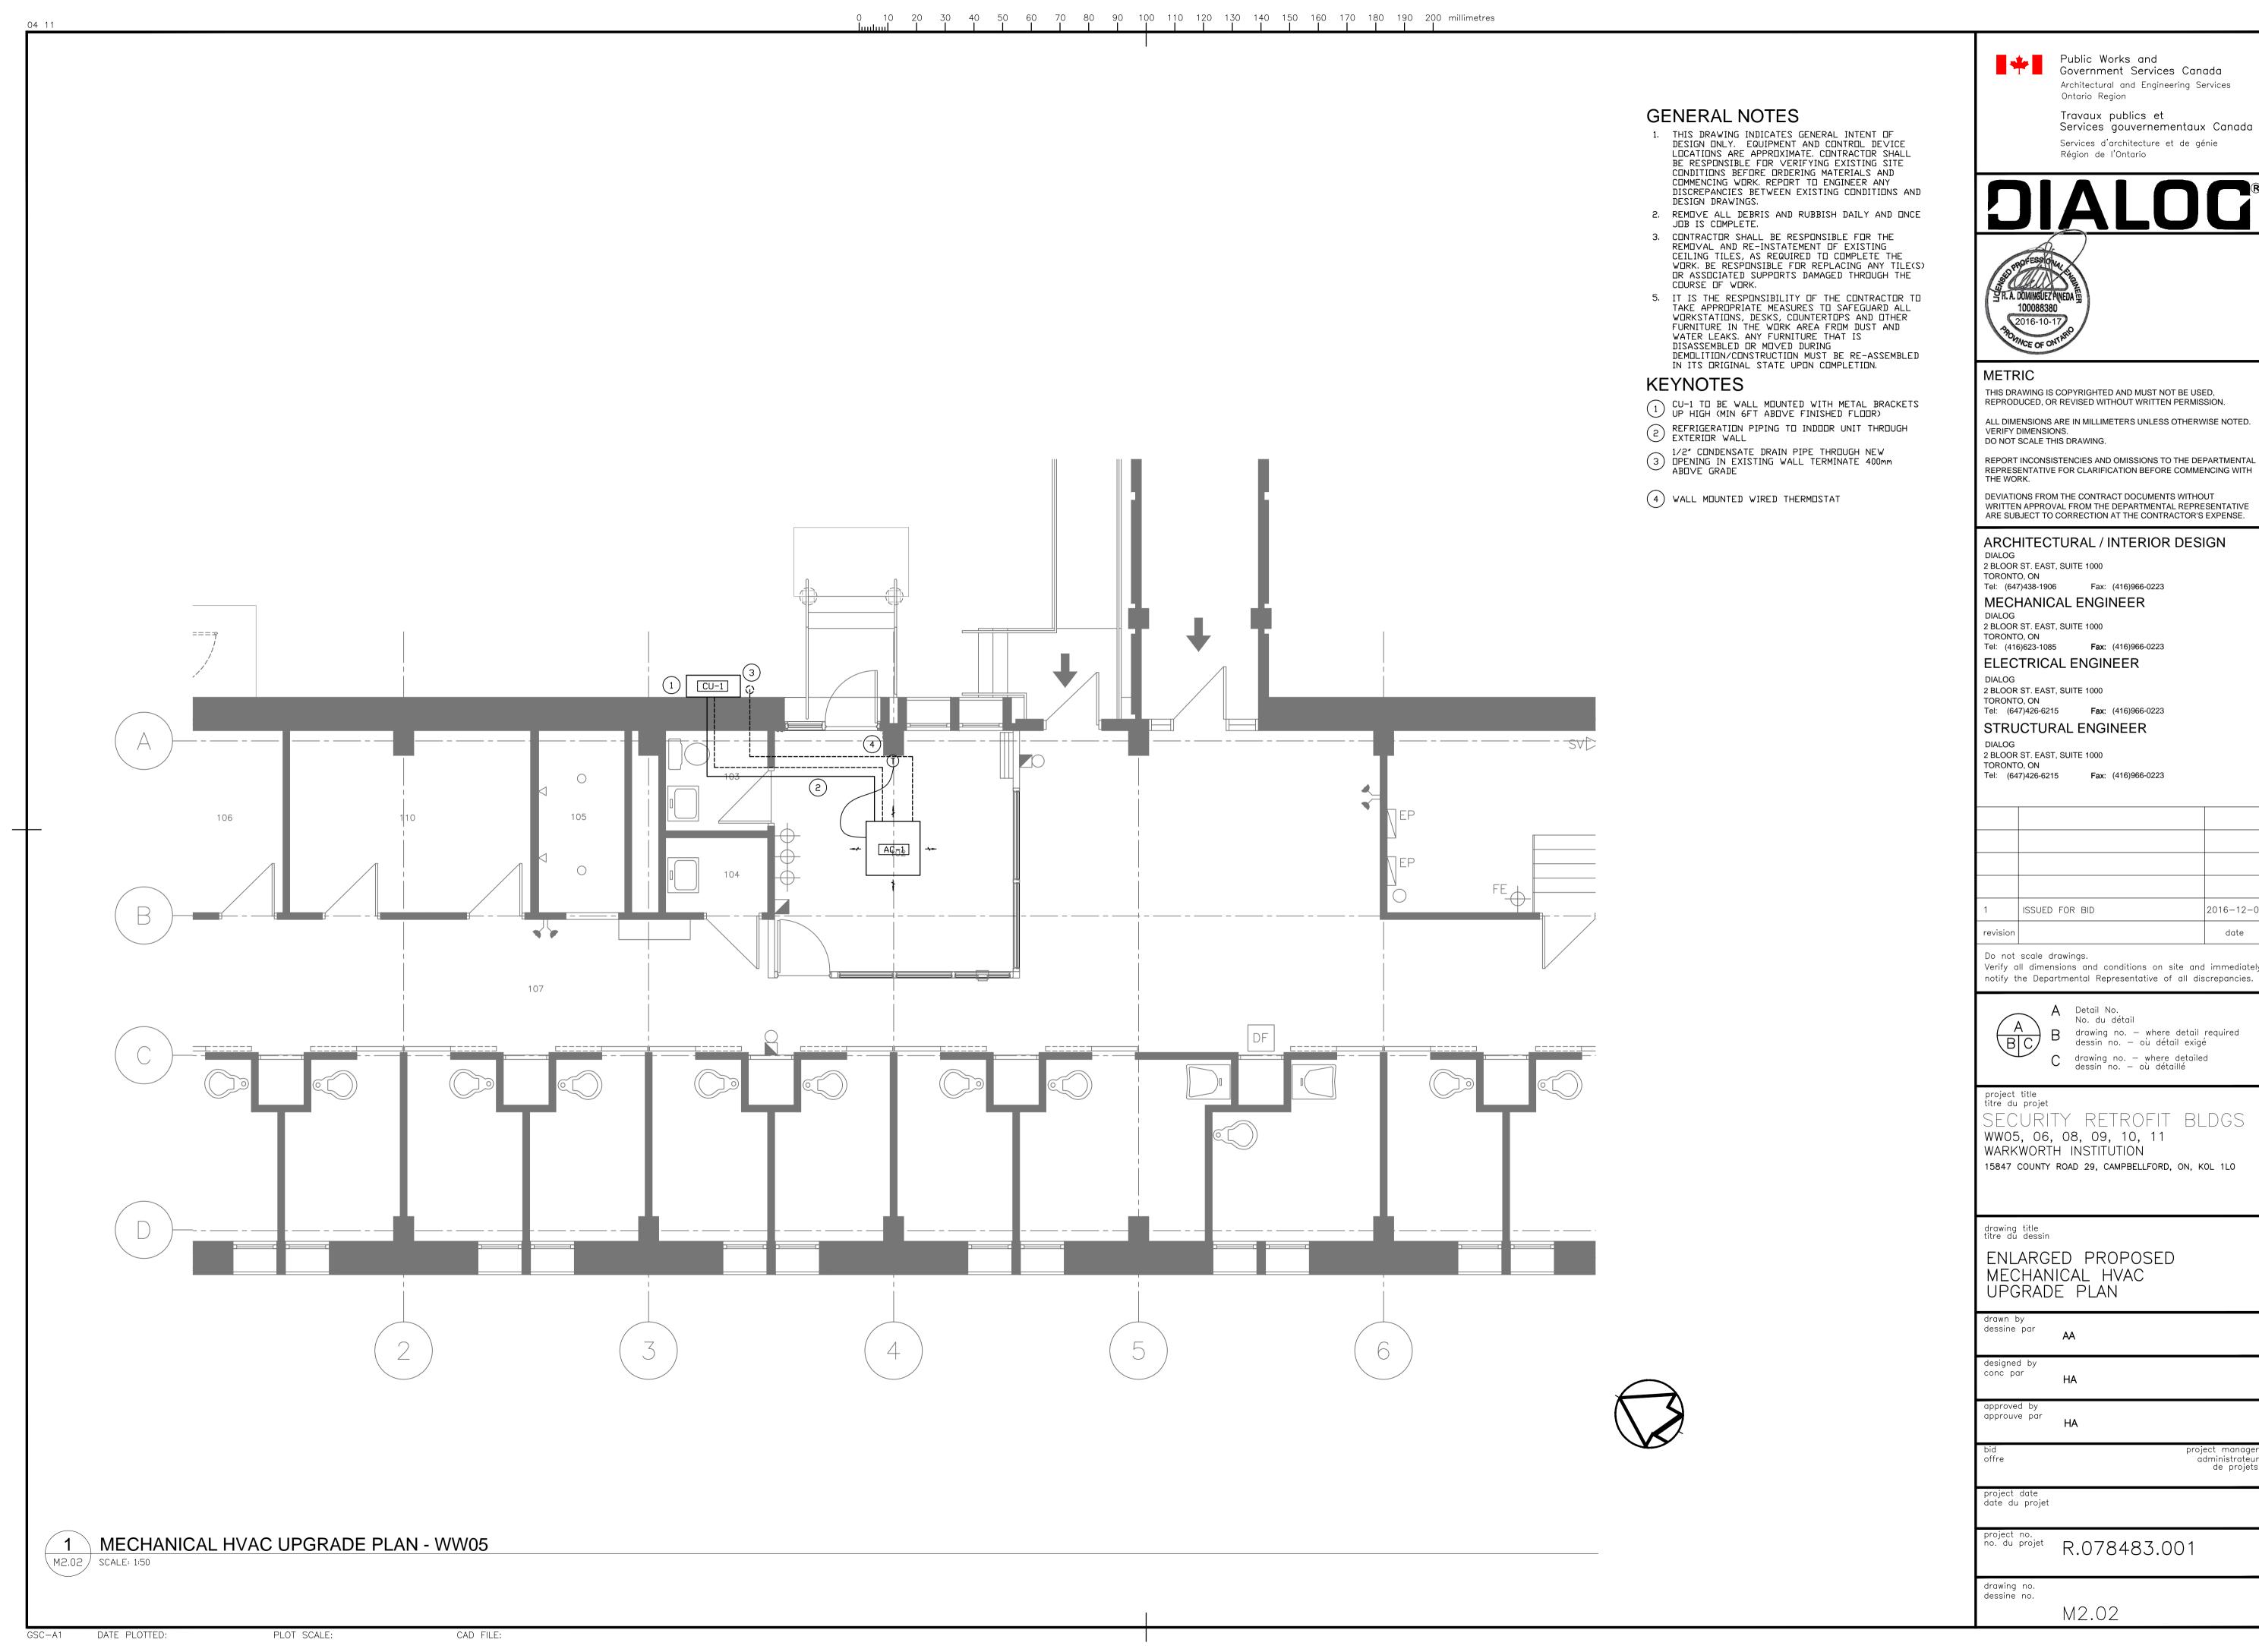- DEMOLISH THE EXISTING EXTERIOR LIGHT FIXTURE AND PROVIDE NEW LUMINAIRES AS INDICATED ON DRAWING PLAN. REFER TO LUMINAIRE SCHEDULE FOR THE NEW FIXTURE TYPE. RE—USE EXITING LIGHTING CIRCUIT, WIRING AND CONTROL FOR NEW EXTERIOR LUMINAIRES. EXTEND AND/OR MODIFY EXISTING WIRING AS REQUIRED. VERIFY LOAD CONDITION OF THIS CIRCUIT AND REPORT TO CONSULTANT ENGINEER IF THE CIRCUIT WAS OVERLOAD AFTER NEW INSTALLATION.
- PROVIDE 30A, 2P CIRCUIT BREAKER IN EXISTING 120/208V PANEL AS INDICATED. PROVIDE 2#10AWG+GRD IN 3/4"C TO FEED EQUIPMENT.
- 3 AC INDOOR UNIT IS FED FROM OUTDOOR UNIT, PROVIDE 3#12AWG+GRD IN 3/4"C.
- ELECTRICAL CONTRACTOR TO VISIT THE SITE AND COORDINATE WITH MECHANICAL CONTRACTOR FOR INSTALLATION OF THE AC INDOOR UNIT. RELOCATE ELECTRICAL LIGHTING FIXTURES, FIRE ALARM DEVICES, ETC AS REQUIRED. THESE RELOCATION WORK SHOULD BE FULLY INCLUDED AS PART OF THE SCOPE OF THIS PROJECT.
- EXTEND EXISTING RECEPTACLE CIRCUITS FROM THE RECEPTACLES IN THE EXISTING CONTROL POST TO BE RETROFITTED IN WWO6 BUILDING. CONTRACTOR TO VERIFY ON SITE AND CONFIRM THAT THESE RECEPTACLE CIRCUITS ARE NOT OVERLOAD.
- CONTRACTOR TO PROVIDE 25MM E.M.T. CONDUIT BETWEEN THE EXISTING CONTROL POST TO THE TEMPORARY CONTROL POST IN WW06 BUILDING, WITH MINIMUM OF TWO CAT. 6 (GREEN) CABLES FOR THE TEMPORARY ELECTRONIC EQUIPMENT AS REQUIRED BY CSC. EXTEND THE CONDUIT AND CABLES TO LOCATIONS WHERE THE EQUIPMENT INSTALLED. COORDINATE WITH CSC REPRESENTATIVE ON SITE FOR THE EXACT LOCATIONS OF THE EQUIPMENT.

GENERAL NOTES

- CONTRACTOR SHALL VISIT THE SITE TO VERIFY EXISTING SERVICES AND ALL SITE CONDITIONS PRIOR TO SUBMITTING ANY QUOTATION. NO ALLOWANCE SHALL BE MADE DUE TO FAILURE TO DO SO.
- 2. ANY DISCREPANCIES BETWEEN DRAWINGS AND SPECIFICATIONS AND/OR EXISTING CONDITIONS SHALL BE REPORTED DEPARTMENT REPRESENTATIVE BEFORE ANY WORK IS BEGUN.

3. KEEP CONSISTENCE WITH EXISTING INSTALLATION SUCH AS USING SAME BOX TYPES AND CONDUCTOR PROTECTION.


DEVICE LIGHTING FIXTURE, WALL MOUNTED 347/600V PANEL SURFACE MOUNTED 120/208V PANEL, SURFACE MOUNTED TELEPHONE OUTLET VOICE/DATA OUTLET DATA OUTLET DIRECT CONNECTION 15A 120V DUPLEX RECEPTACLE MOTOR WITH NON-FUSIBLE DISCONNECT ED EXISTING TO BE DELETED EX EXISTING TO REMAIN KEY NOTE TAG



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project title

titre du projet SECURITY RETROFIT BLDGS

WW05, 06, 08, 09, 10, 11 WARKWORTH INSTITUTION

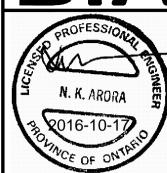15847 COUNTY ROAD 29, CAMPBELLFORD, ON, KOL 1LO

drawing title titre du dessin

PARTIAL ELECTRICAL PLANS WW05 & WW06

drawn by dessine par

designed by conc par


approuve par

project manager administrateur de projets

project date date date du projet 2016-04-25

project no. no. du projet 09711T0400

drawing no. dessine no.

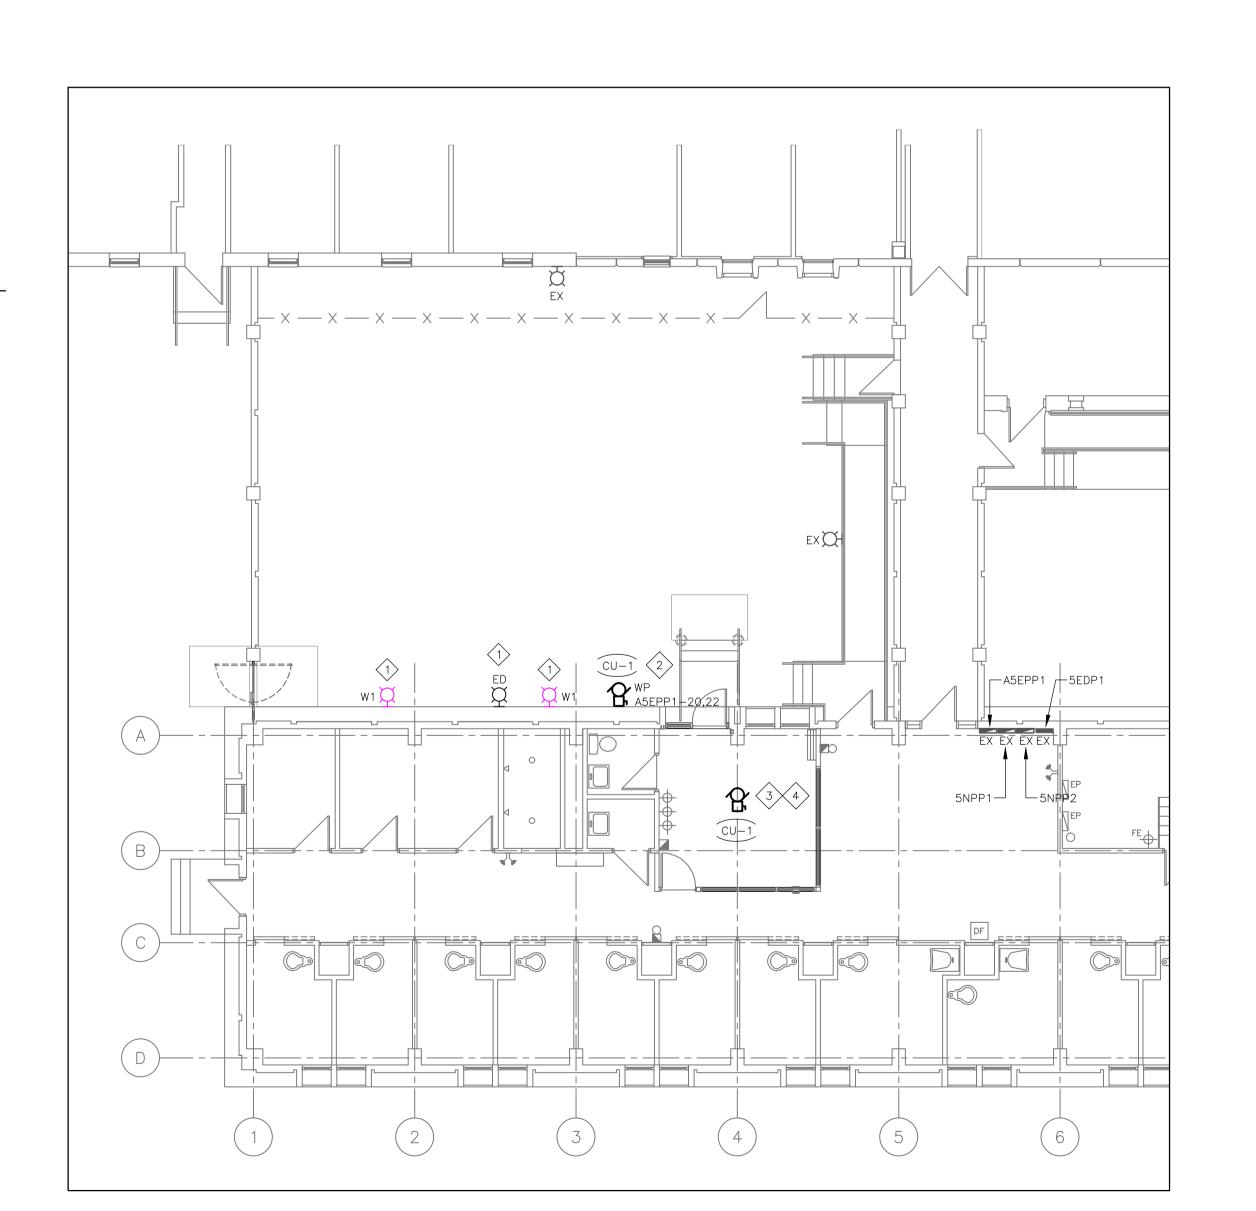







-LPXA1 (EM. POWER)

-XX (NORMAL POWER)

1 WP XX-22,24