

NEW 4,546L ABOVEGROUND DOUBLE-WALLED STEEL FUEL OIL STORAGE TANK (1.2/300)


NEW SNOW AND ICE CANOPY BASE PLATE (typ.) (3/400)

**NEW TANK SNOW AND ICE CANOPY PLAN** (1/400)

SCALE: 1:30  
0mm 500mm 1000mm 1500mm 2000mm 2500mm 3000mm

- STEEL NOTES:**
1. ALL WORK SHALL COMPLY IN ALL RESPECT WITH CSA S16 "DESIGN OF STEEL STRUCTURES" AS AMENDED TO DATE.
  2. PLATES, RODS, ANGLES AND CHANNEL SHAPES SHALL CONFIRM TO THE REQUIREMENTS OF CSA G40.21, GRADE 300W.
  3. HOLLOW STRUCTURAL SECTIONS SHALL CONFIRM TO THE REQUIREMENTS OF CSA G40.21 GRADE 350W, CLASS C OR ASTM A500 GRADE C.
  4. ALL WELDED CONSTRUCTION. CONTRACTOR TO VERIFY DIMENSIONS AND SHOP CUT ANGLES PRIOR TO ERECTION.
  5. ALL WELDING SHALL BE IN ACCORDANCE WITH CSA W59 AND SHALL BE PERFORMED BY COMPANIES CERTIFIED TO DIVISION 1 OR DIVISION 2.1 OF CSA W47.1
  6. WELDING ELECTRODES SHALL BE CARBON STEEL ELECTRODES: E49XX.
  7. ALL STRUCTURAL STEEL AND MISCELLANEOUS METALS TO RECEIVE A COAT SHOP PRIMER AND TOP COAT SUITABLE FOR EXTERIOR EXPOSURE. ALL STRUCTURAL STEEL AND MISCELLANEOUS METALS TO BE PAINTED BLACK.

**NOTE:**  
CONTRACTOR TO ENSURE THAT THERE IS SUFFICIENT SPACE AND CLEARANCE BENEATH THE SNOW AND ICE CANOPY TO ACCOMMODATE AND PROTECT THE FUEL DELIVERY PERSONNEL DURING PRODUCT TRANSFER OPERATIONS.  
CONTRACTOR TO ENSURE THAT THERE IS SUFFICIENT CLEARANCE BENEATH THE SNOW AND ICE CANOPY TO ALLOW MANUAL DIPPING OF THE STORAGE TANK.

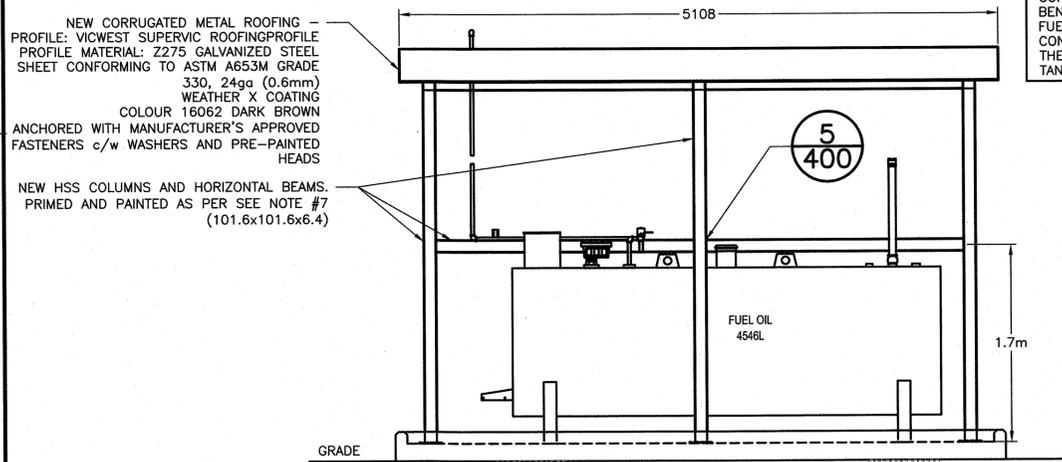


NEW CORRUGATED METAL ROOFING - PROFILE: VICWEST SUPERVIC ROOFING PROFILE  
PROFILE MATERIAL: Z275 GALVANIZED STEEL SHEET CONFORMING TO ASTM A653M GRADE 330, 24ga (0.6mm) WEATHER X COATING COLOUR 16062 DARK BROWN ANCHORED WITH MANUFACTURER'S APPROVED FASTENERS c/w WASHERS AND PRE-PAINTED HEADS

NEW HSS COLUMNS AND HORIZONTAL BEAMS. PRIMED AND PAINTED AS PER SEE NOTE #7 (101.6x101.6x6.4)


**NEW TANK SNOW AND ICE CANOPY FRONT ELEVATION** (2/400)

SCALE: 1:30  
0mm 500mm 1000mm 1500mm 2000mm 2500mm 3000mm

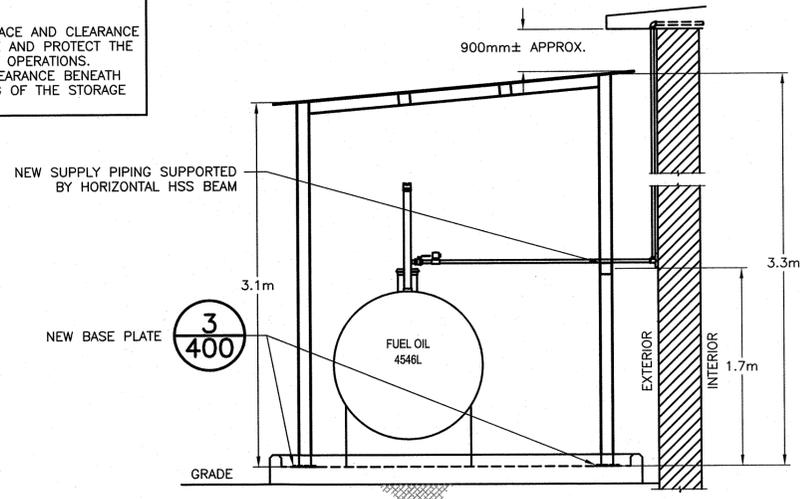


**NEW TANK SNOW AND ICE CANOPY SIDE ELEVATION** (4/400)

SCALE: 1:30  
0mm 500mm 1000mm 1500mm 2000mm 2500mm 3000mm

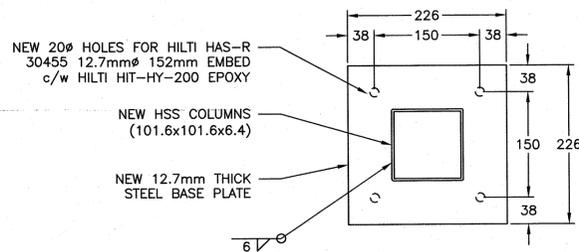

**TYPICAL BASE PLATE** (3/400)

SCALE: 1:5  
0mm 100mm 200mm 300mm 400mm 500mm

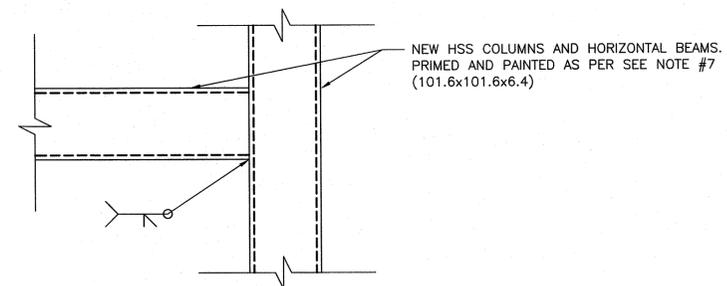

**TYPICAL TUBE/TUBE CONNECTION** (5/400)

SCALE: 1:5  
0mm 100mm 200mm 300mm 400mm 500mm



B	ISSUED FOR TENDER	01/24 2017
A	ISSUED FOR 99% REVIEW	01/12 2017
revisions		date
project		projet

**FUEL OIL SYSTEM REPLACEMENT WORKS COMPOUND MAINTENANCE BUILDING KOUCHIBOUGUAC NATIONAL PARK, NB**

**NEW FUEL OIL TANK SNOW AND ICE CANOPY PLANS, SECTIONS AND DETAILS**

designed	J. BURRY	conçu
date	2017-01-03	
drawn	M. CLARK	dessiné
date	2017-01-03	
approved	E. FINNAMORE	approuvé
date	2017-01-03	
Tender	<i>McConnell</i> 2017-02-02	Soumission
PWOSC Project Manager	Administrateur de projets TPSGC	
project number		no. du projet
	<b>R.080258.005</b>	
drawing no.		no. du dessin
	<b>400</b>	