

Canada

Newfoundland Region St. John's, NL.

# WHARF (#404) RECONSTRUCTION

# Codroy, NL

LONG RANGE MOUNTAINS DISTRICT, NEWFOUNDLAND AND LABRADOR

# **PROJECT NO. 704074**

## Fisheries and Oceans Pêches et Océans Canada

## Small Craft Harbours Ports Pour Petits Bateaux



## DRAWING LIST

DRAWING NO. COVER 1 OF 7 2 OF 7 3 OF 7 4 OF 7

5 OF 7 MISC. DETAILS 6 OF 7 MISC. DETAILS 7 OF 7 E1 OF 5 E2 OF 5 NEW SITE PLAN E3 OF 5 E4 OF 5

E5 OF 5



### TITLE

SITE LOCATION MAP, EXISTING SITE PLAN, DEMOLITION PLAN AND SECTION NEW SITE PLAN, WHARF PLAN NEW WHARF SECTIONS

WHARF CRIB PLAN, WHARF ELEVATIONS AND DETAILS

ELECTRICAL BUILDING PLAN, SECTION AND DETAILS

DEMOLITION SITE PLAN AND LEGEND


NEW WHARF & PEDESTAL DETAILS

ELECTRICAL DETAILS

PANEL SCHEDULES & DETAILS



E-DRM/GDD-E:

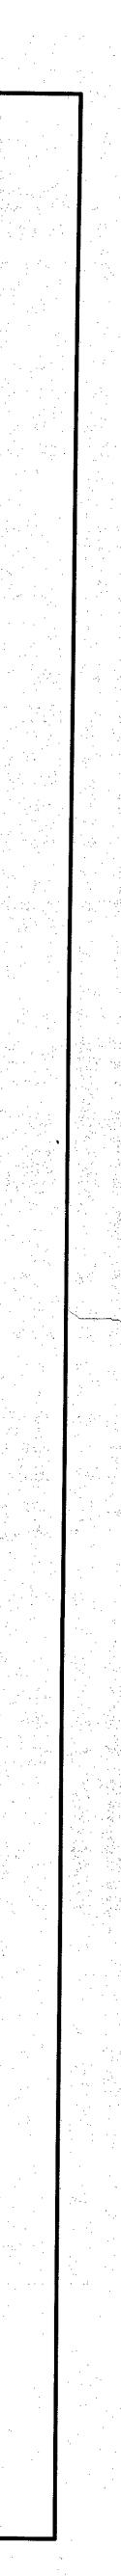

#### SURVEY NOTES

SURVEY PARTY CHIEF EDDIE BEARNS SURVEY VESSEL ALUMINUM BOAT SURVEY DATE(S) FEB.03,2012 & MAR. 01,2012 SOUNDER TYPE: SINGLE TRANSDUCER SOUNDER SETTING MIN/INST VEL. OF SOUND 1520 m/s DEPTH GATE USED N/A FRE. OF TRANS. 210 KHZ POSITIONING SYSTEM USED DGPS (WITH OTF) LAND SURVEY POSITION BY DGPS (WITH OTF) DATA TAPE/DISC(S) USED CAD DRAWING FILE(S): TIDAL REDUCTION SCHEME

OFFICE PROCESSOR EDDIE BEARNS DATE OF PROCESSING MARCH 2012 MODE OF PLOTTING AVERAGE DEPTHS MATRIX CELL WIDTH X LENGTH REDUCTION OF MATRIX CELLS

CONTROL POINTS: Pt. NAME EASTING 84G4168 320790.322 5306664.098 84G4169 321353.007 5305545.412 PWC BM 1-87

NORTHING CD ELEV DESCRIPTION

PROVINCIAL BRASS PLAQUE IN ROCK PROVINCIAL BRASS PLAQUE IN ROCK +2.909 m X-CUT IN BOLT OF FISHERIES SIGH. PWC 2-87 320746.807 5305719.448 +3.072 m BOLT CEMENTED IN CONCRETE DECK OF WHARF

ALL SOUNDINGS & ELEVATIONS IN METRES. ALL SOUNDINGS & ELEVATIONS REFERRED TO PWC 2-87 ELEV.+3.072 WHICH WAS ESTABLISHED BY LEVELING FROM THE CHS BENCH MARK.

SOUNDINGS TAKEN USING NAVISOUND 210 ECHO SOUNDER AND POSITIONED BY TRIMBLE DIFFERENTIAL GPS POSITIONING SYSTEM ON JAN.10,2012 THRU MAR.01,2012 BY PWGSC SURVEY CREW.

COORDINATES FOR HORIZONTAL CONTROL ARE GIVEN ON THE U.T.M. MAPPING PLANE, ZONE 21, USING THE NORTH AMERICAN DATUM OF 1983(NAD83). SOUNDINGS WERE REDUCED BY DIGITRACE & RE-CHECKED FROM SOUNDING CHARTS BEFORE BEING CORRECTED FOR TIDE & BAR CHECK CORRECTION. SOUNDINGS WERE REDUCED USING HYPACK MAX VER.02.12. SPEED OF SOUND WAS OBTAINED USIND A DIGIBAR-PRO VELOCIMETER. ALL FIELD NOTES ARE IN CODROY BOOK #40 "A" & #40 "B".

0	EXISTING LIFE RING
e PP	EXISTING HYDRO POLE
	HORIZONTAL /VERTICAL CONTROL
00	EXISTING GRADE ELEVATION
Õ	EXISTING B1 CLEAT
>	EXISTING TYPE "A" CLEAT & BLOCK
	EXISTING CULVERT
X.●	EXISTING POLE WITH LIGHT FIXTURE
$\square$	EXISTING ELECTRICAL PEDESTAL
	EXISTING LADDER
$\bowtie$	EXISTING WATER CONNECTION
	EXISTING JIB CRANE BASE
$\square_{i}$	
	INDICATES EXISTING WHARF TO BE DEMOLISHED AND REMOVED
	INDICATES EXISTING ASPHALT TO BE REMOVED
BH#	INDICATES BORE HOLE LOCATIONS. BORE HOLE INFORMATION CAN BE FOUND IN APPENDIX A OF THE TECHNICAL SPECIFICATIONS.

GENERAL NOTES:

LEGEND

1. ALL DIMENSIONS IN MILLIMETERS. 2. ALL SOUNDINGS & ELEVATIONS IN METERS.

3. CONTRACTOR TO VERIFY ALL DIMENSIONS

AND ALL EXISTING SITE CONDITIONS IN THE FIELD. ALL ERRORS AND UNSATISFACTORY CONDITIONS TO BE REPORTED TO THE DEPARTMENTAL REPRESENTATIVE.

4. THE CONTRACTOR SHALL VISIT THE SITE AND BECOME FAMILIAR WITH THE EXISTING CONDITIONS PRIOR TO BIDDING THIS. PROJECT. IT IS THE RESPONSIBILITY OF THE CONTRACTOR TO INFORM THE


DEPARTMENTAL REPRESENTATIVE IN WRITING OF ANY DISCREPANCIES BETWEEN EXISTING CONDITIONS AND THE PROJECT


DRAWINGS.





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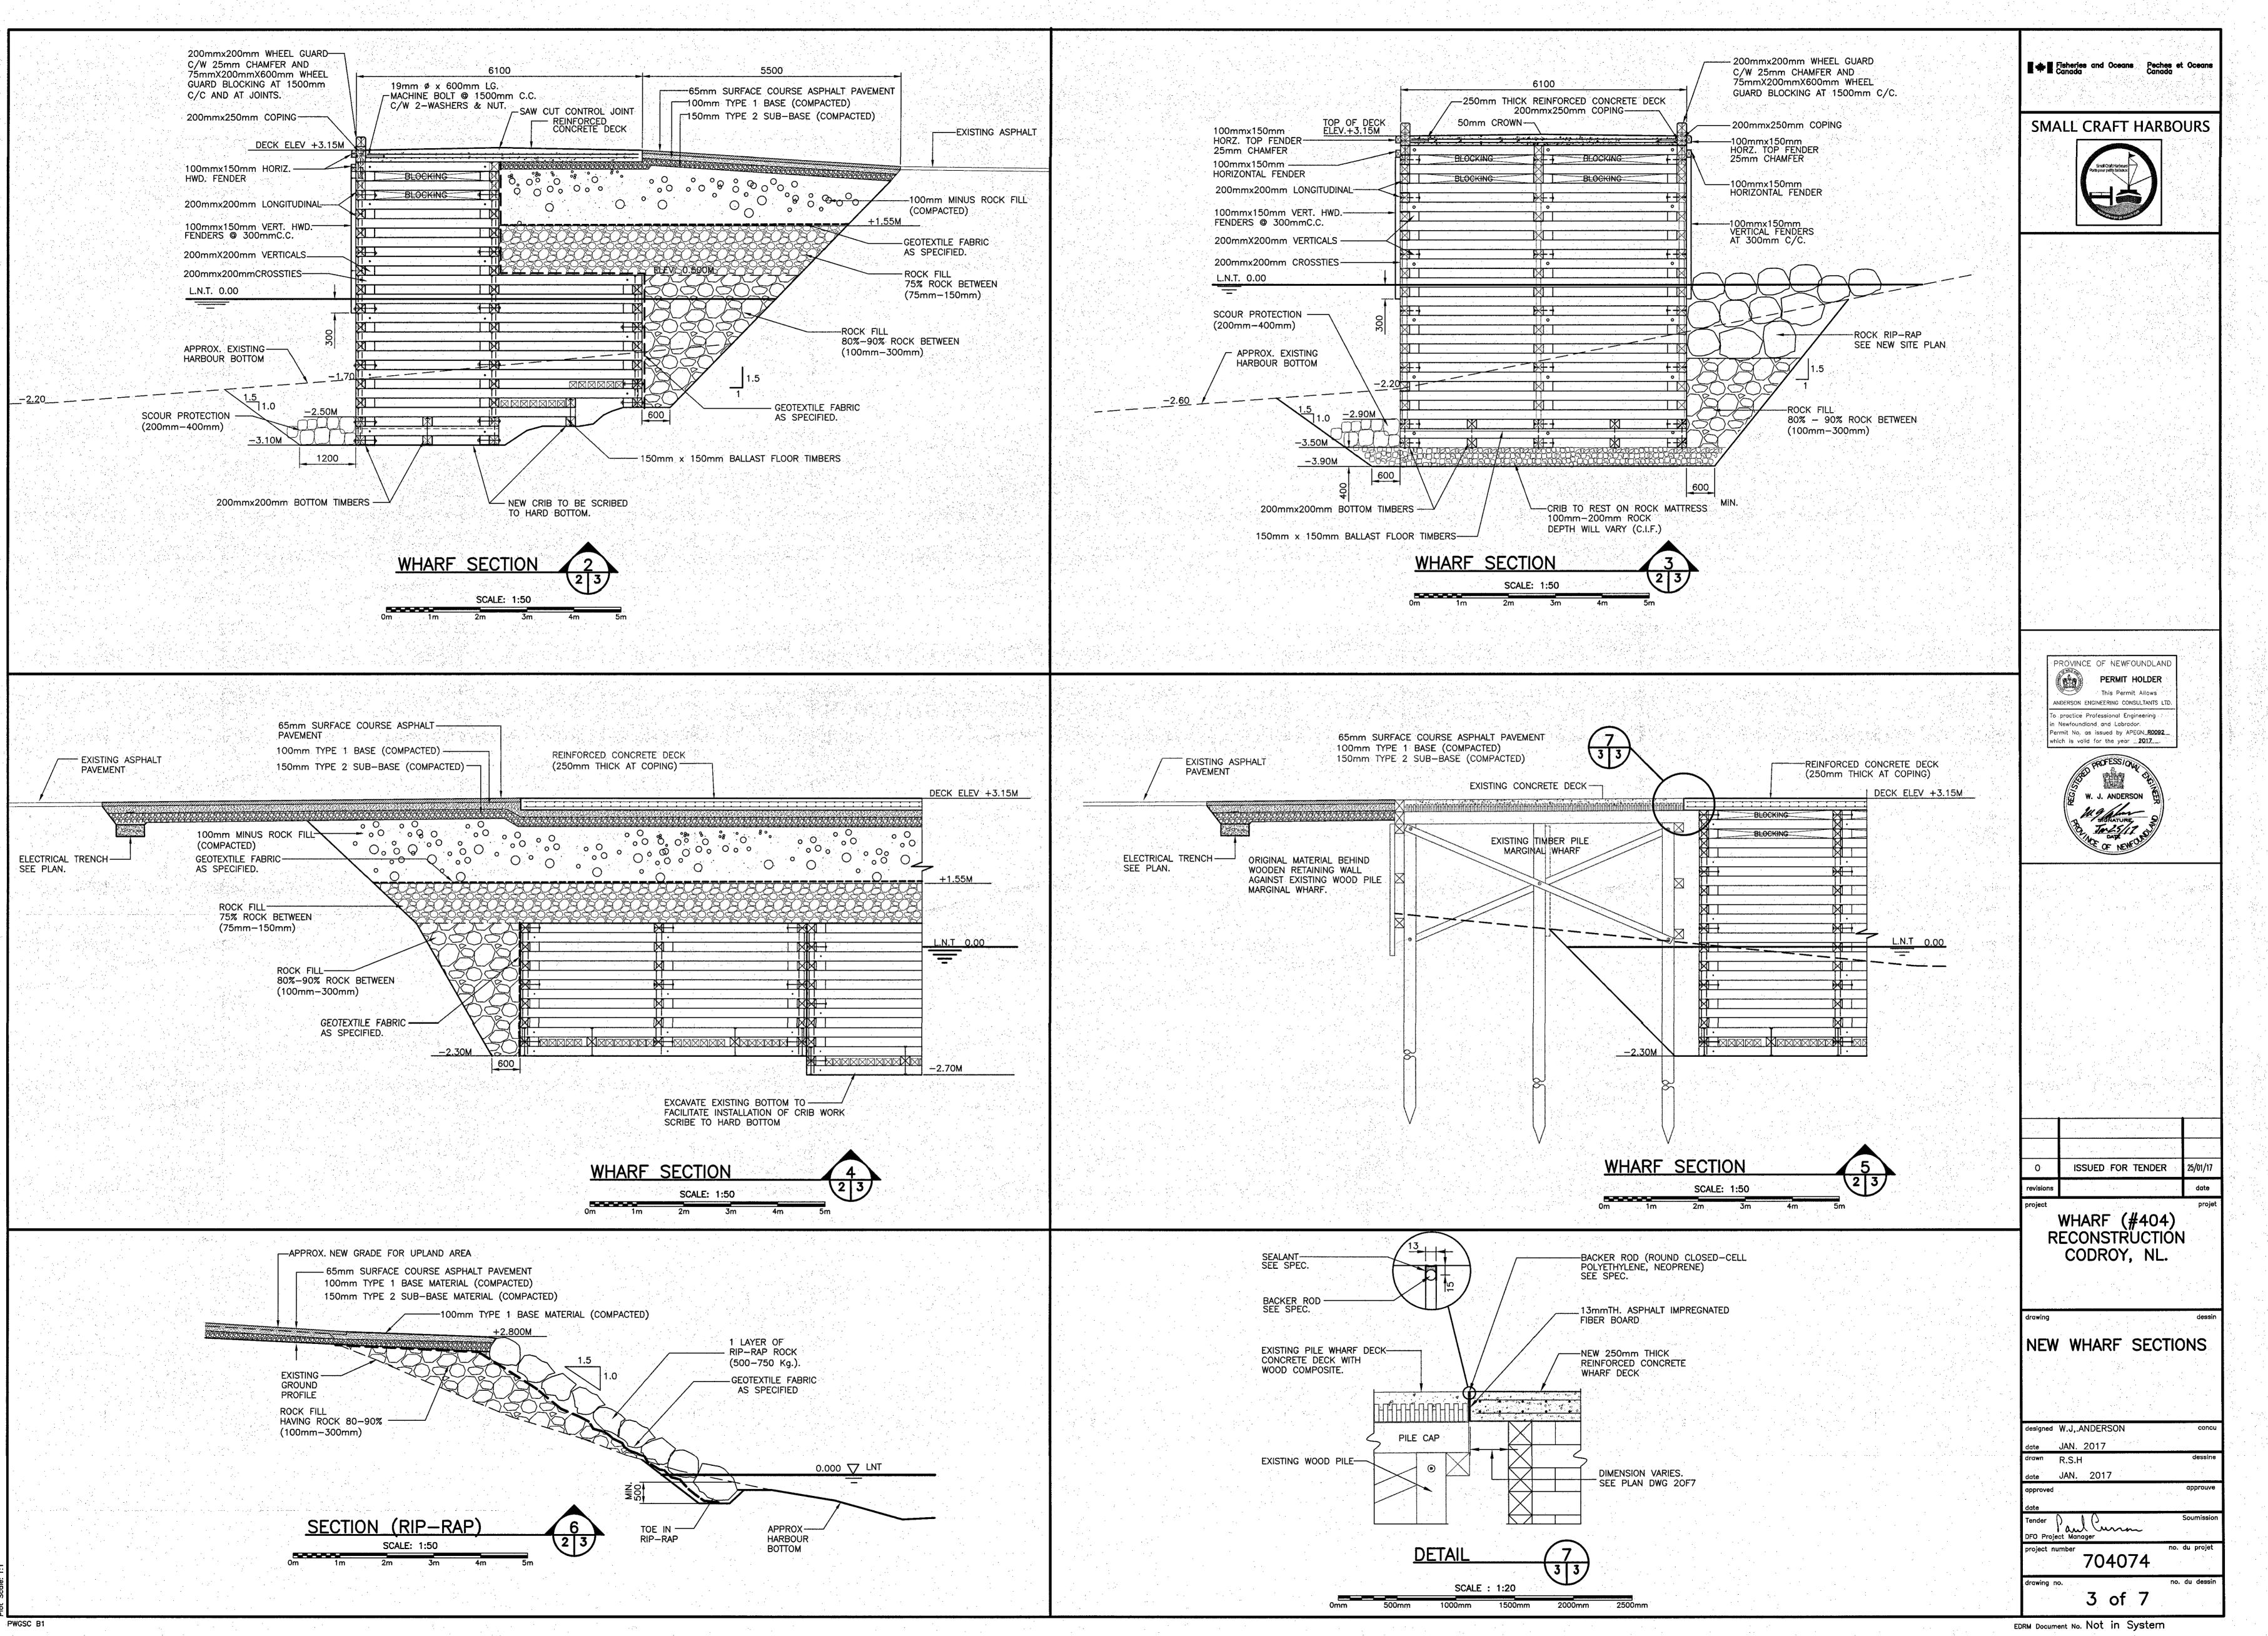


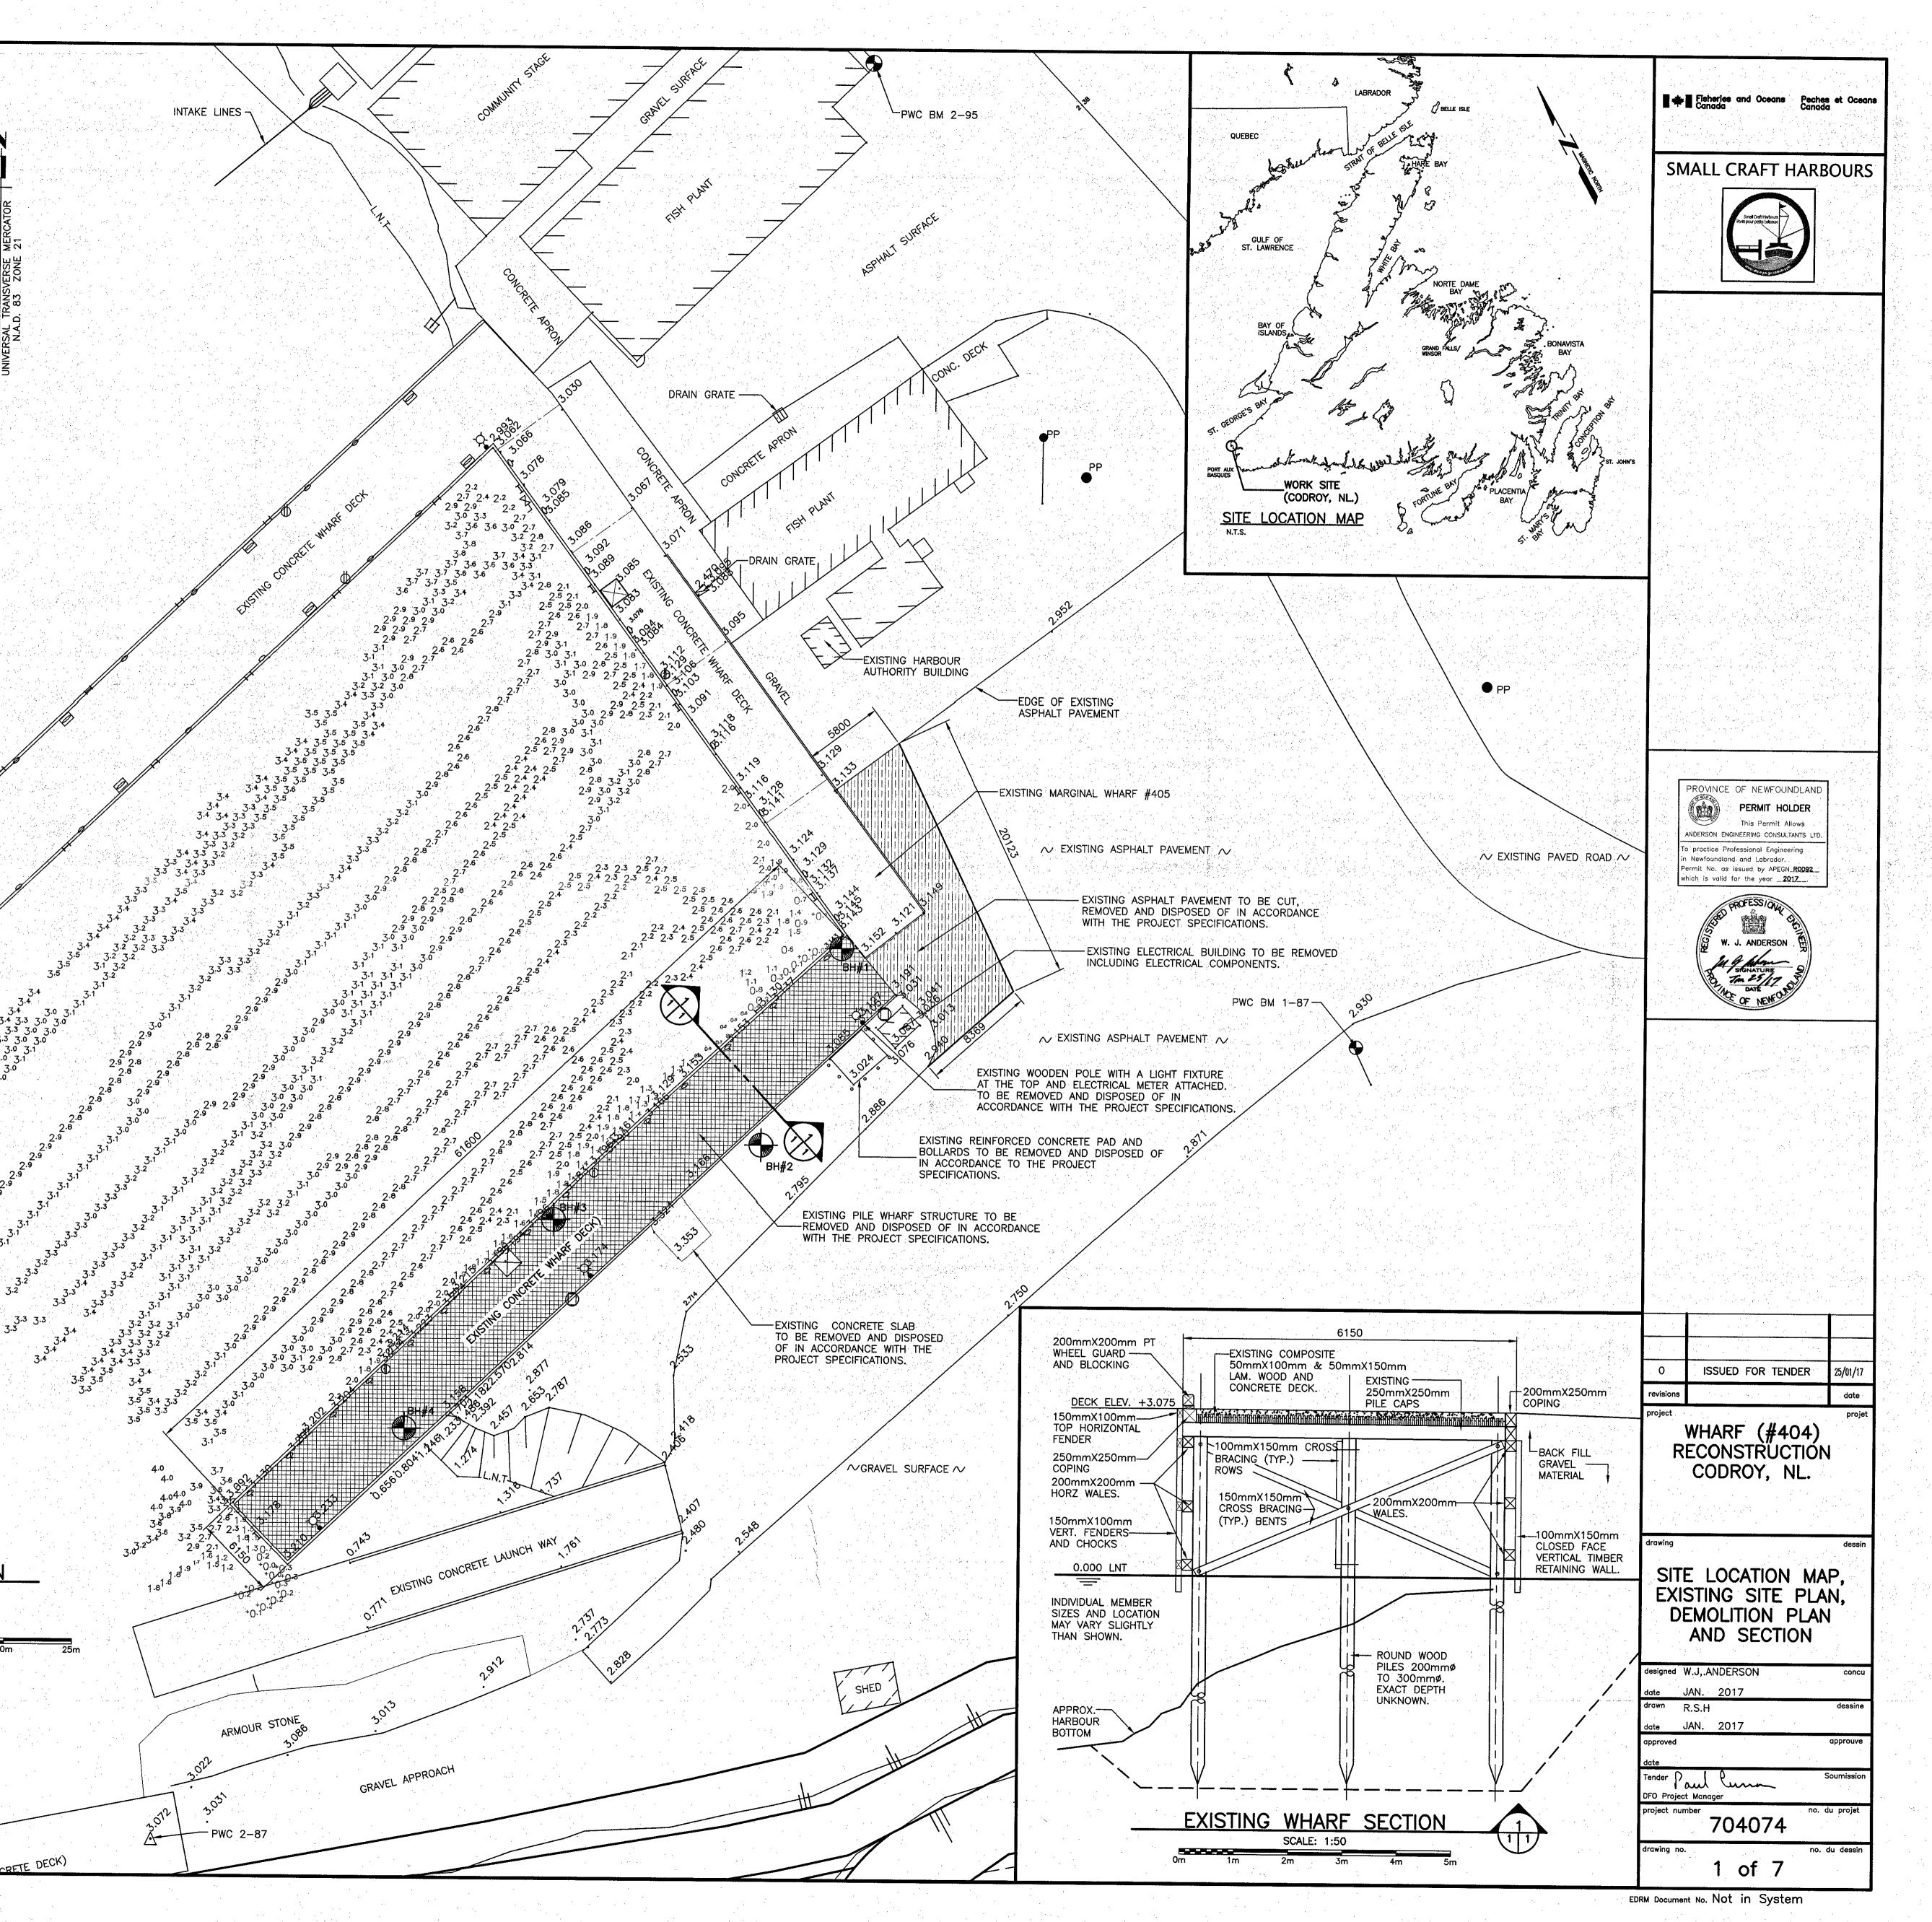
<u></u>	HORIZONTAL CONTROL	POINTS
MARK	EASTING	NORTHING
PWC 2-87	320746.807	5305719.448
$\langle A \rangle$	320761.760	5305752.838
B	320765.940	5305748.395
	320797.300	5305786.280
	320801.479	5305781.838

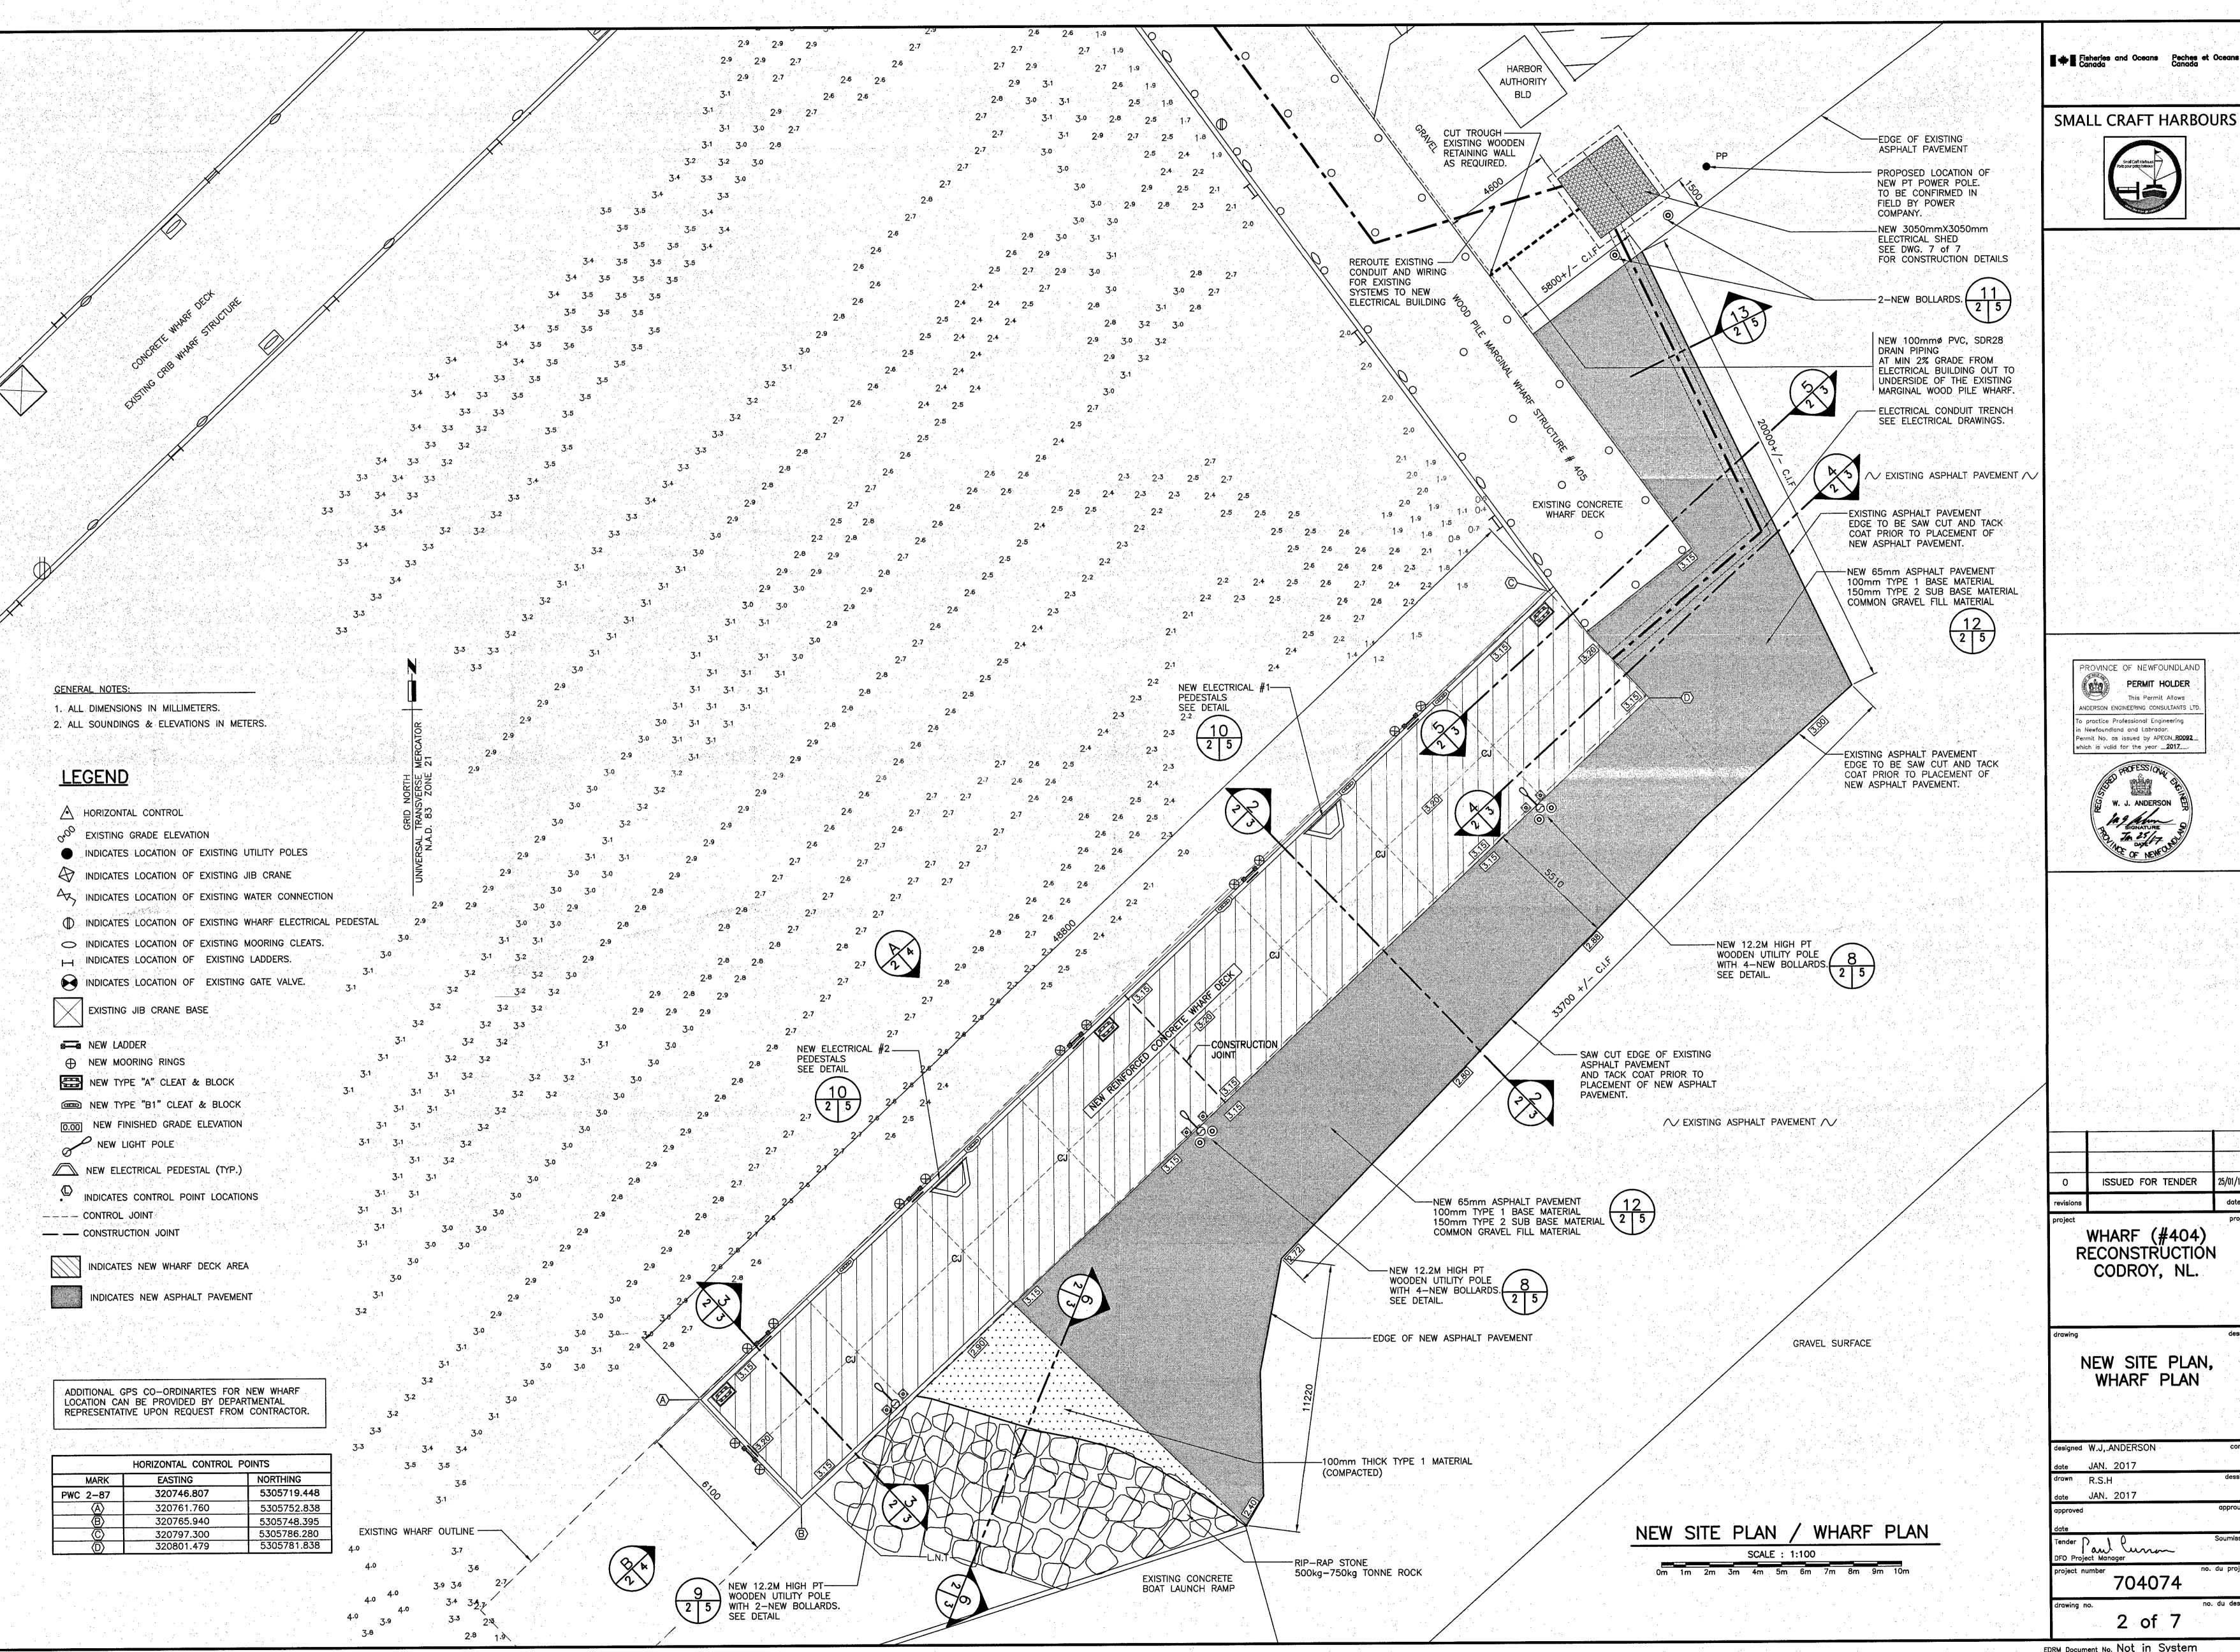
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RUNGS @ <\*== 300mmC.C. -19mmø LAG SCREWS BOLTS AS SPECIFIED 15 4 4

150mmx200mm -LADDER UPRIGHT FOR FUTURE UTILITIES. • 65 TREAT NOTCHES AS SPECI - 68 - 25mmø GALV. STEEL

-25mmø GALV. STEEL

- 200mmX200mm WHEEL GUARD BEVELED AS SHOW

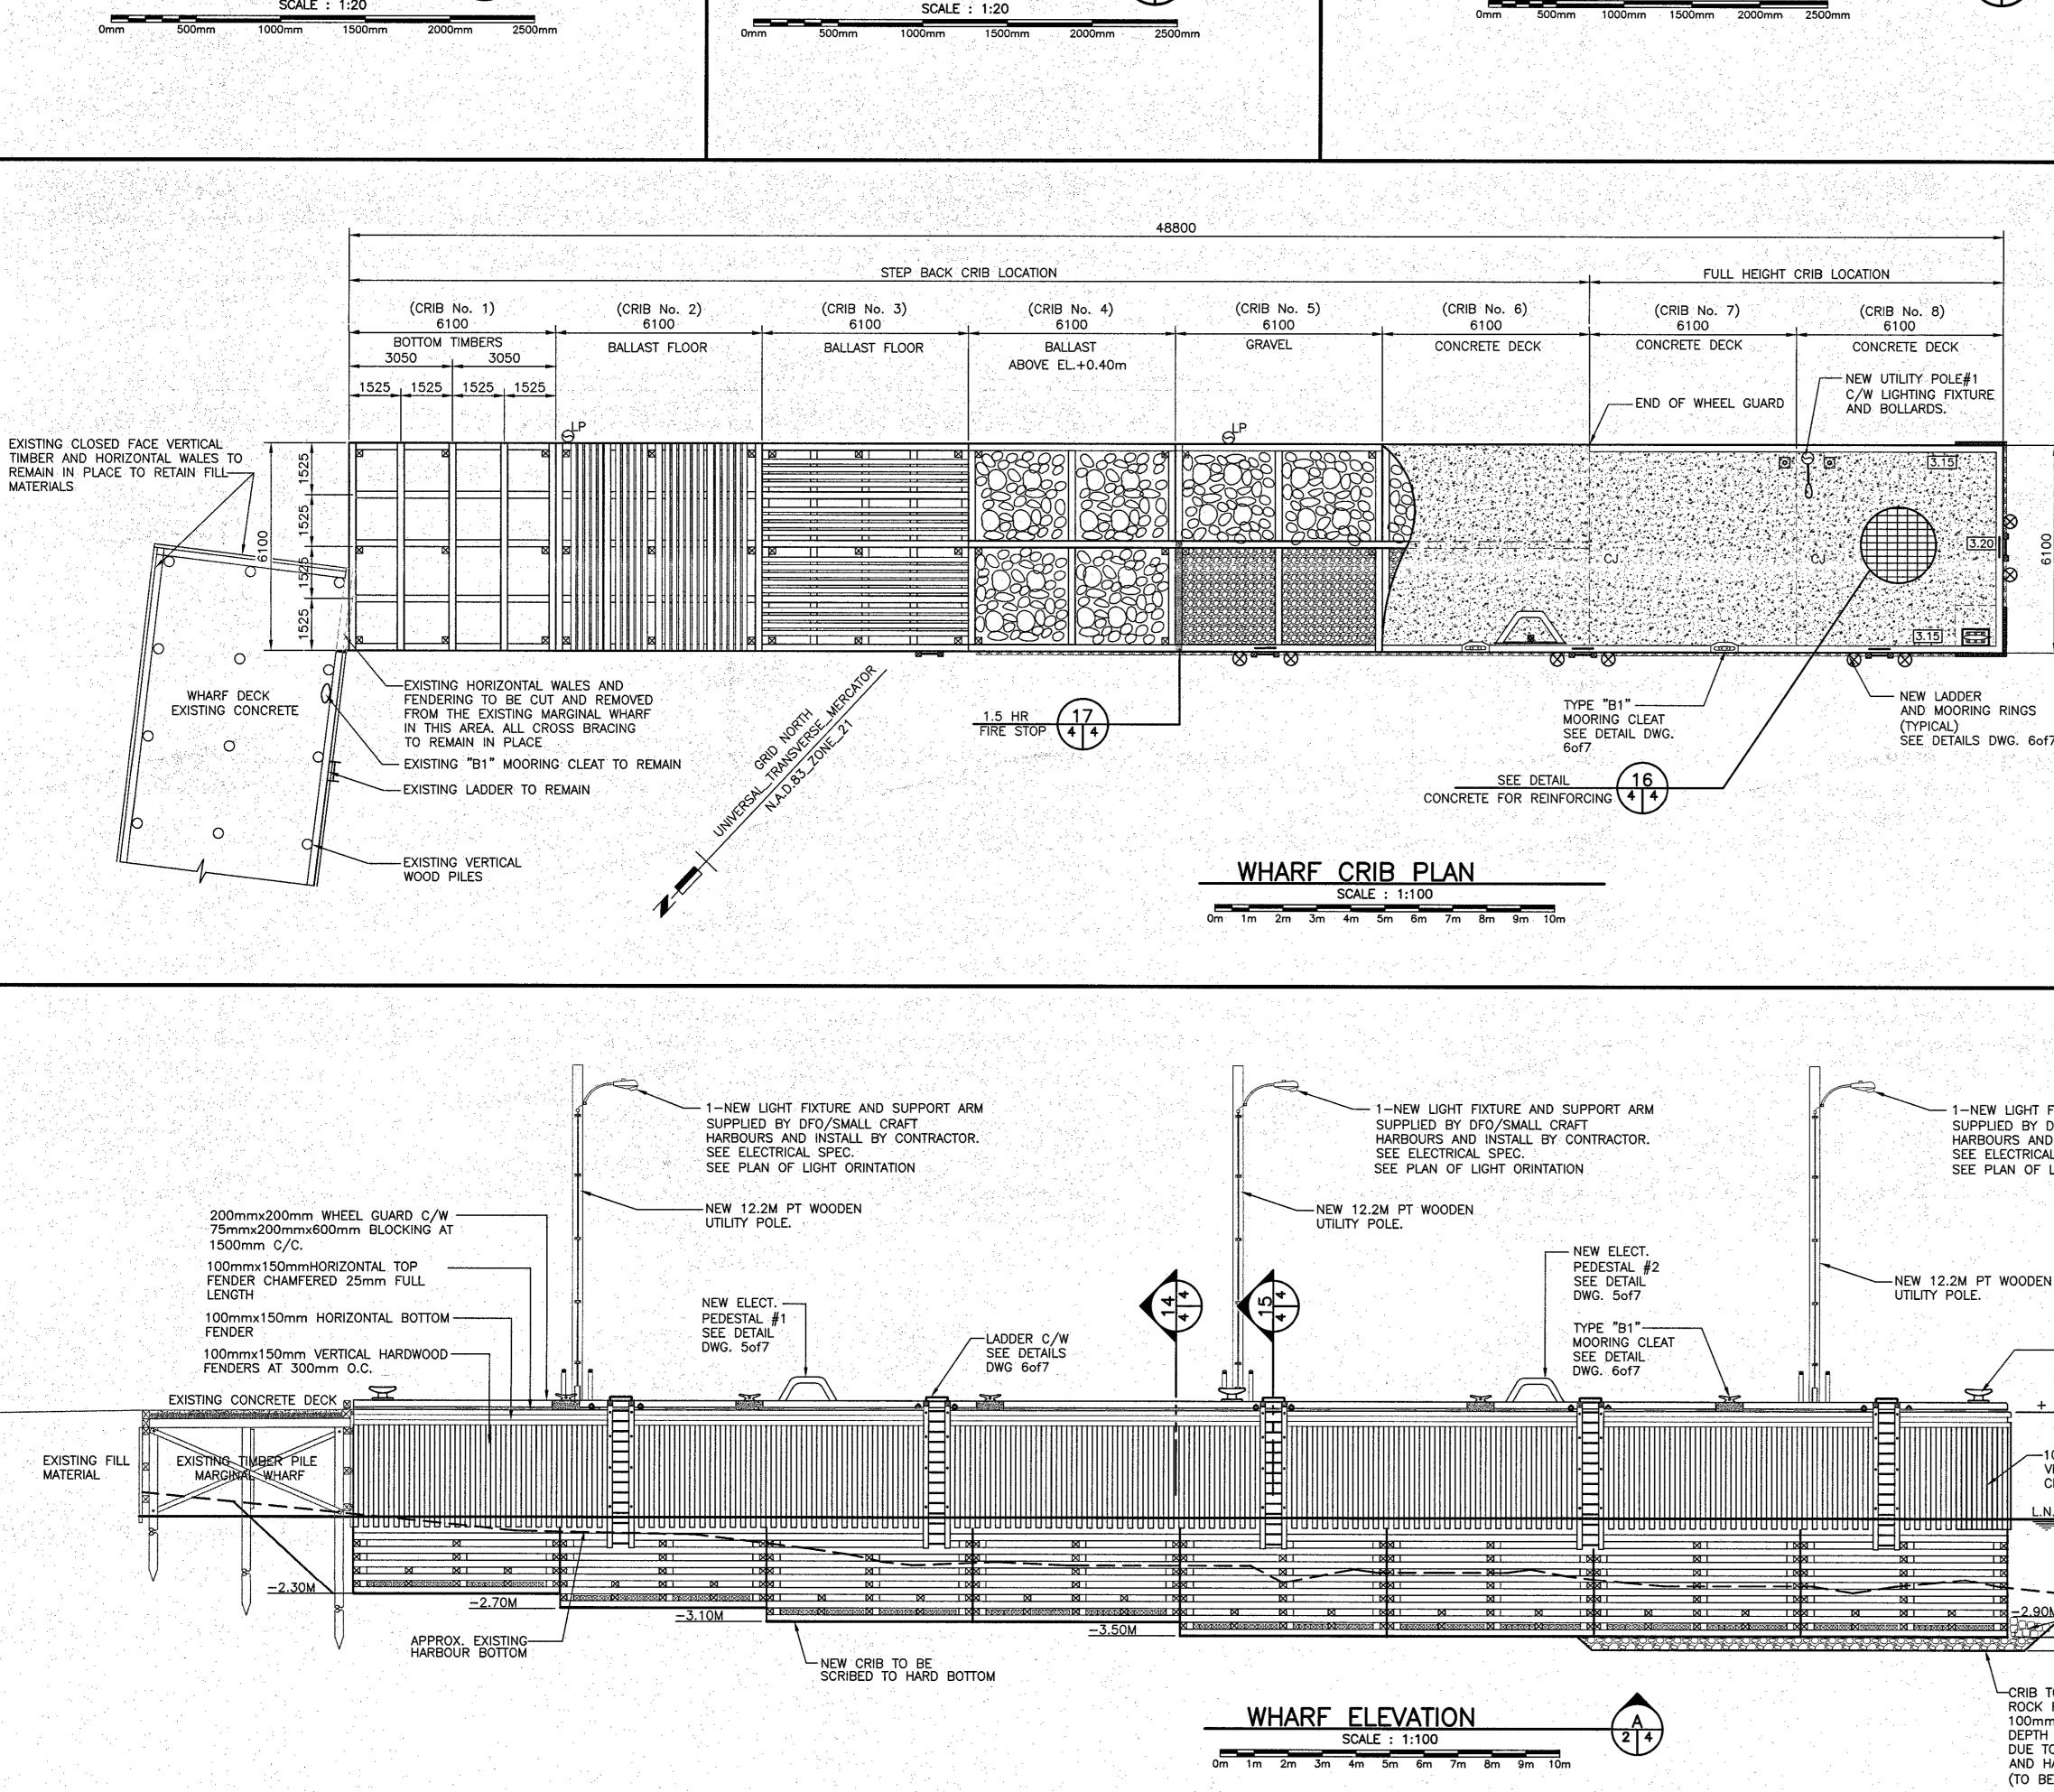HAND GRIP

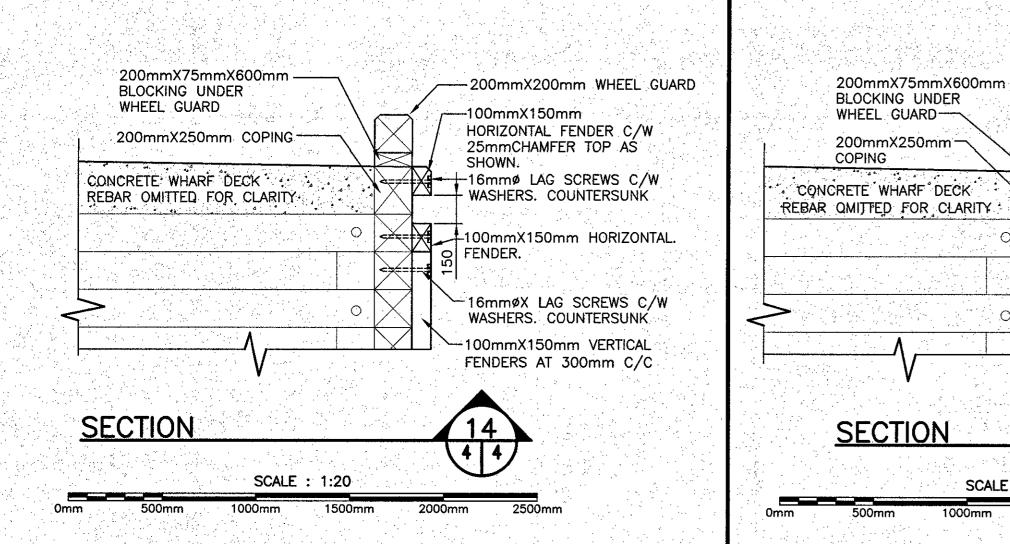45

-15M BARS AT 200mm C/C TRANSVERSE (PERPENDICULAR TO WHARF FACE) -20M BARS AT 150mm C/C LONGITUDINAL (PARALLEL TO WHARF FACE) 65mm CLEAR-----COVER 150mm TYPE MATERIAL (COMPACTED) —20M BARS AT 150mm C/C LONGITUDINAL (PARALLEL TO WHARF FACE) -15M BARS AT 200mm C/C TRANSVERSE (PERPENDICULAR TO WHARF FACE) CONCRETE WHARF DECK REINFORCING DETAIL

SCALE: 1:25


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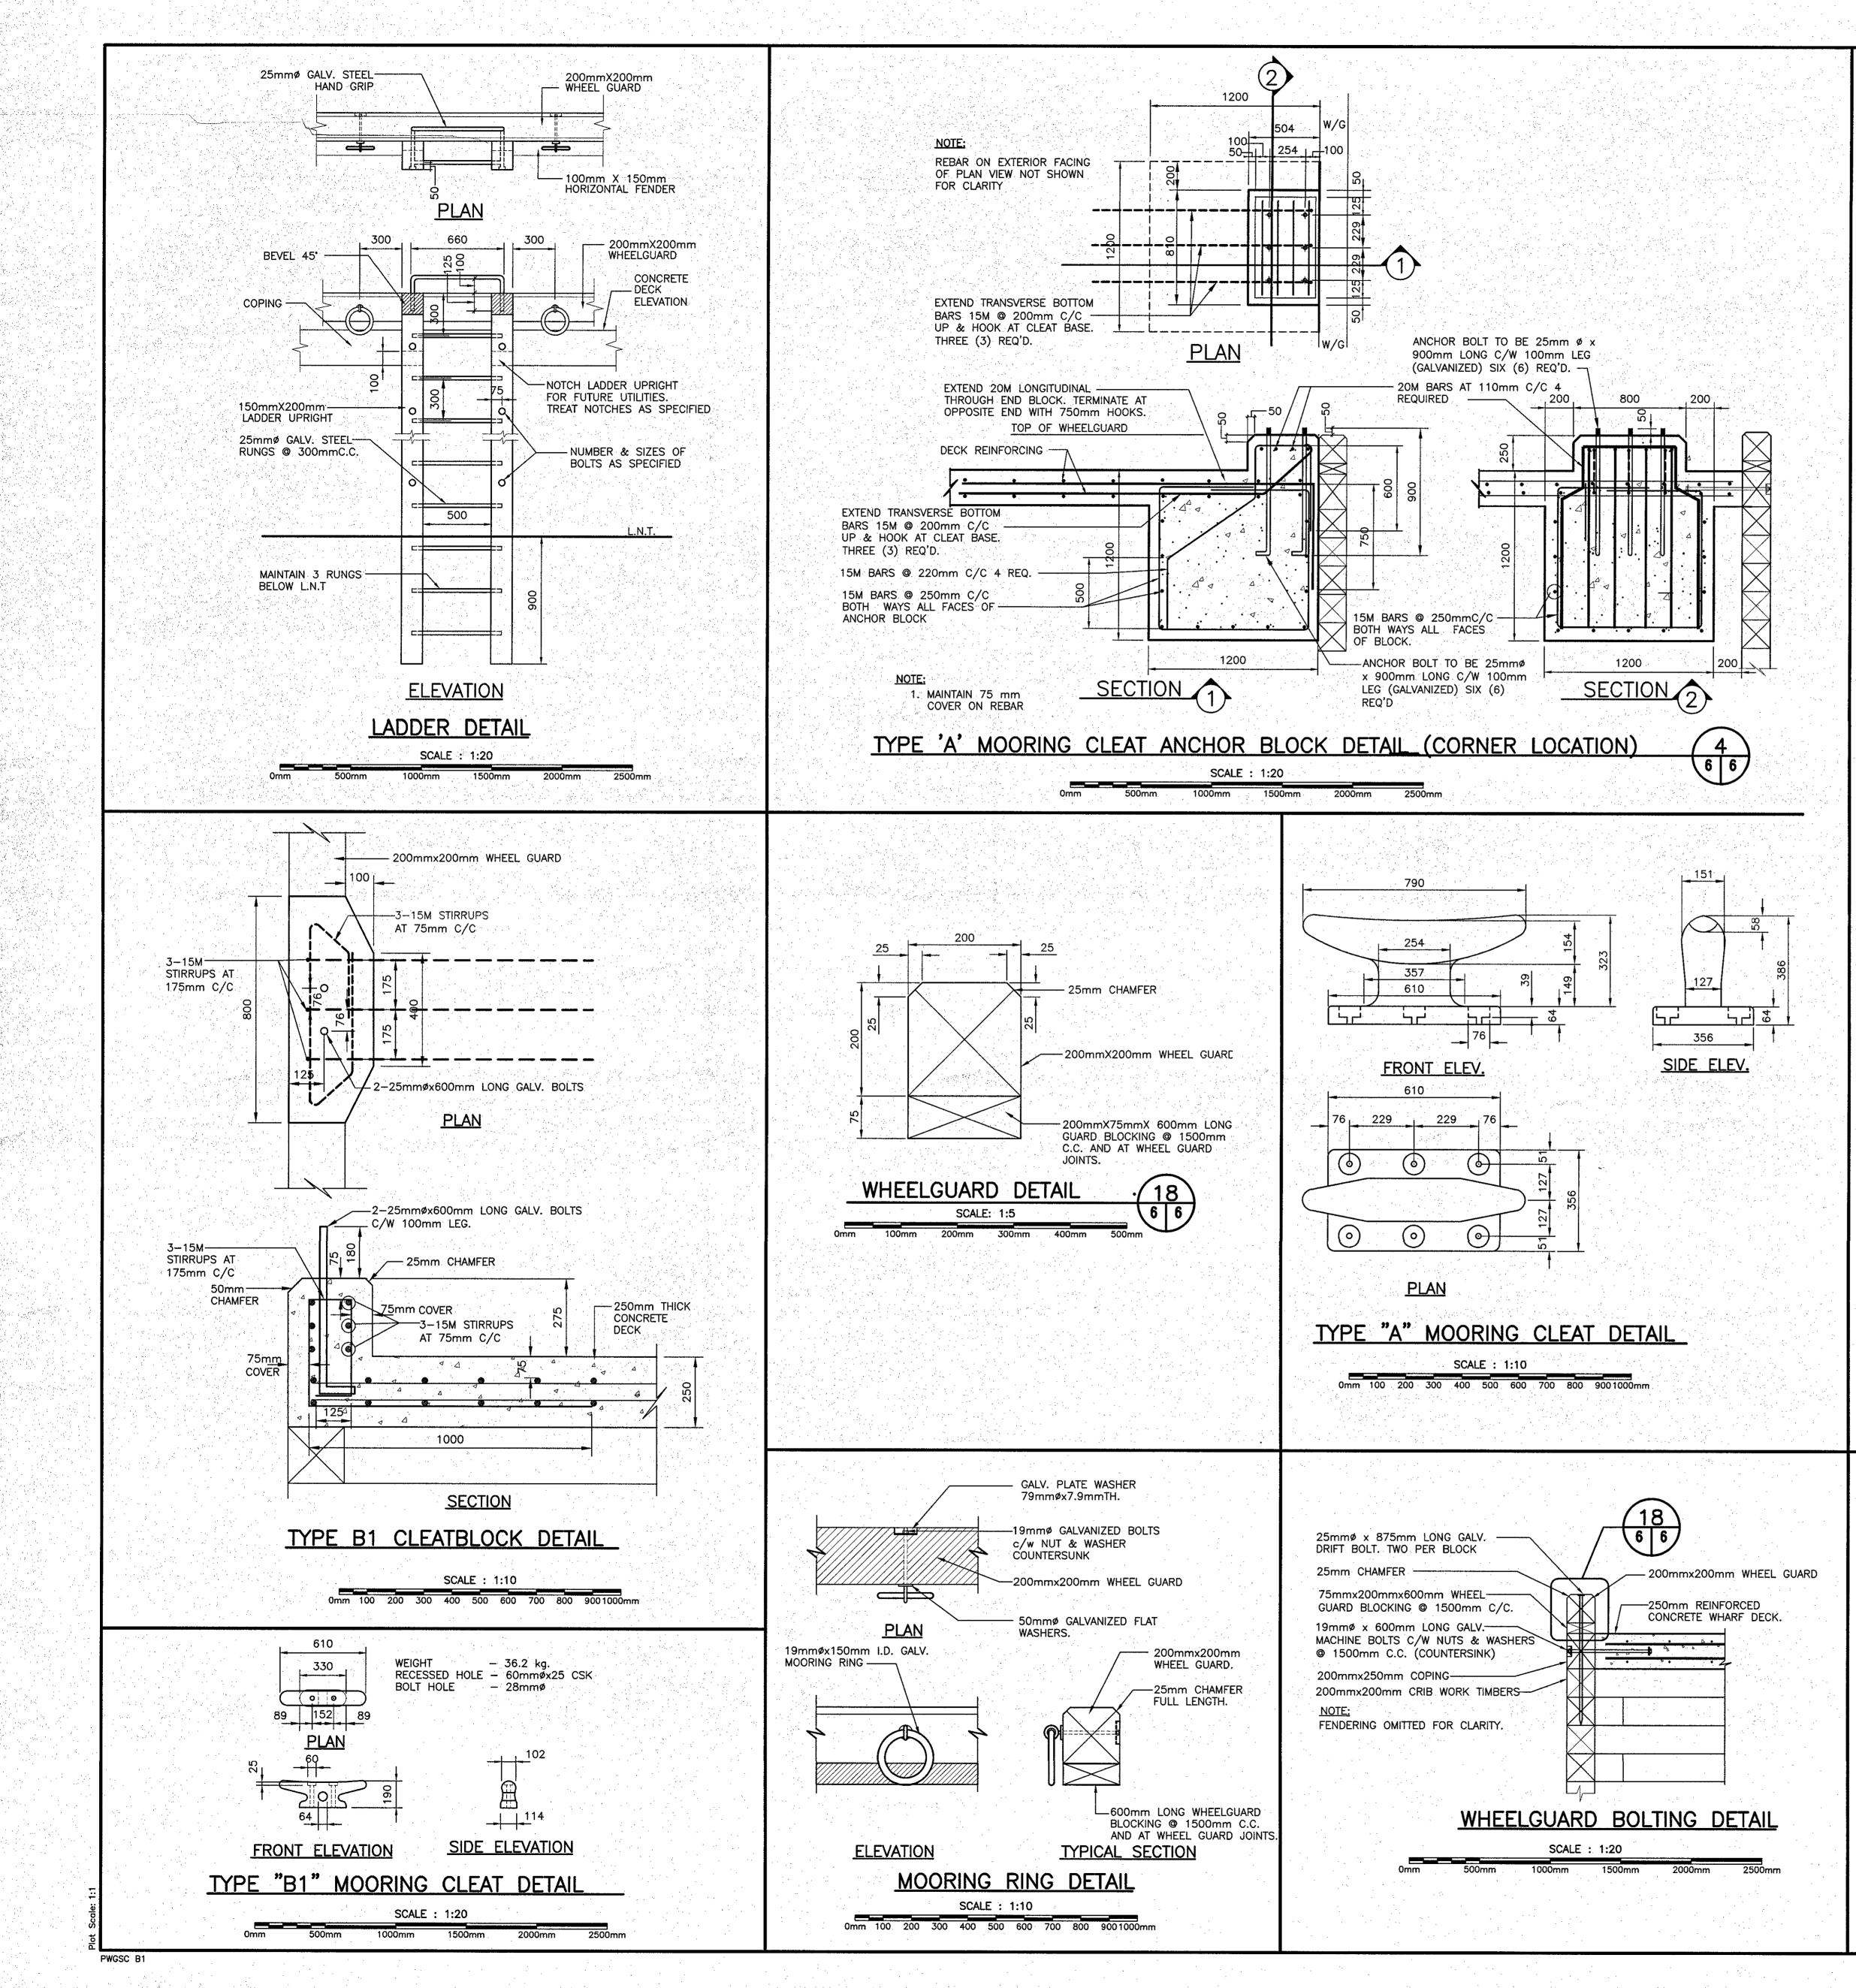
\4|4


이 가지 않는 것이 있는 것이 있다. 것이 있는 것이 있는 같은 것이 같은 것이 있는 것이 있는 것이 있는 것이 있는 것이 있는 것이 있는 것이 같은 것이 같은 것이 있는 것 같은 것이 같은 것이 같은 것이 있는 것이 같은 것이 있는 것이 같은 것이 있는 것이 같은 것이 있다.	
<ul> <li>NOTES:</li> <li>1. ALL DIMENSIONS IN MILLIMETERS.</li> <li>2. MINIMUM CONCRETE STRENGTH 35 MPG @28 DAYS.</li> <li>3. REINFORCING STEEL YIELD STRENGTH 400 MPa</li> <li>4. REINFORCING STEEL SPLICES SHALL CONFORM TO A 23.3, LATEST EDITION. REINFORCING STEEL ID BE LAPPED 900mm FOR LONGTUDINAL BARS REINFORCING STEEL TO BE LAPPED 900mm FOR TRANSVERSE BARS</li> <li>5. ALL REBAR TO HAVE MIN. COVER OF 65mm.</li> <li>6. ALL MACHINE BOLTS 19mm# (GALVANIZED)</li> <li>7. ALL DRIFT BOLTS TO BE 19mm# (GALVANIZED)</li> <li>8. ALL ARGAR TO HAVE MIN. COVER OF 65mm.</li> <li>9. CONTRACTOR TO VERIFY ALL FIELD MEASUREMENTS FOR REQUIRED CRIB TIMBER PRIOR TO ORDERING MATERIALS.</li> <li>10. ALL TIMBER TO BE PRESSURE TREATED.</li> <li>11. DECK DESIGN LOAD: CL-625 FOR NEW WHARF DECK STRUCTURE.</li> <li>12. NEW CRIB WORK TO BE SCRIBED TO HARD BOTTOM OR ROCK MATTRESS AS INDICATED ON DRAWINGS.</li> <li>13. CONTRACTOR TO VERIFY ALL FIELD MEASUREMENTS FOR REQUIRED CONDITIONS IN THE FIELD ALL ERRORS AND MALEXISTING SITE CONDITIONS IN THE FIELD ALL ERRORS AND UNSITISFACTORY CONDITIONS TO BE REPORTED TO THE DEPARTMENTAL REPRESENTATIVE.</li> <li>14. THE CONTRACTOR SHALL VISIT THE SITE AND BECOME FAMILIAR WITH THE EXISTING CONDITIONS IN THE FIELD ALL ERRORS AND UNSITISFACTORY CONDITIONS TO BE REPORTED TO THE DEPARTMENTAL REPRESENTATIVE.</li> <li>14. THE CONTRACTOR SHALL VISIT THE SITE AND BECOME FAMILIAR WITH THE EXISTING CONDITIONS IN THE FIELD ALL ERRORS AND UNSITISFACTORY CONDITIONS TO BE REPORTED TO THE DEPARTMENTAL REPRESENTATIVE.</li> <li>14. THE CONTRACTOR SHALL VISIT THE SITE AND BECOME FAMILIAR WITH THE EXISTING CONDITIONS PRIOR TO BIDDING THIS PROJECT. IT IS THE RESPONSIBILITY OT THE CONTRACTOR TO INFORM THE DEPARTMENTAL REPRESENTATIVE IN WRITING OF ANY DISCREPANCIES BETWEEN EXISTING CONDITIONS PRIOR TO BIDDING THIS PROJECT. THIS THE RESPONSIBILITY OF THE PROJECT THE SITE AND AND THE PROJECT DRAWINGS.</li> </ul>	<b>SMALL CRAFT HARB</b>
7	PROVINCE OF NEWFOUNDLAND PERMIT HOLDER This Permit Allows ANDERSON ENGINEERING CONSULTANTS LTD. To practice Professional Engineering in Newfoundland and Labrador. Permit No. as issued by APEGN.R0092. which is volid for the year2017
N -TYPE "A" MOORING CLEAT <u>3.15M</u> DECK ELEV. + 3.15M DECK ELEV	0 ISSUED FOR TENDER revisions project WHARF (#404) RECONSTRUCTIO CODROY, NL. drawing WHARF CRIB PLA WHARF ELEVATION AND DETAILS designed W.J.ANDERSON date JAN. 2017 trawn R.S.H date JAN. 2017 trawn R.S.H date JAN. 2017
TO REST ON ROCK MATTRESS FILL TO BE BETWEEN m-200mm t WILL VARY B	DFO Project Manager project number 704074
IO FIELD CONDITIONS	Irawing no. no. <b>1</b>


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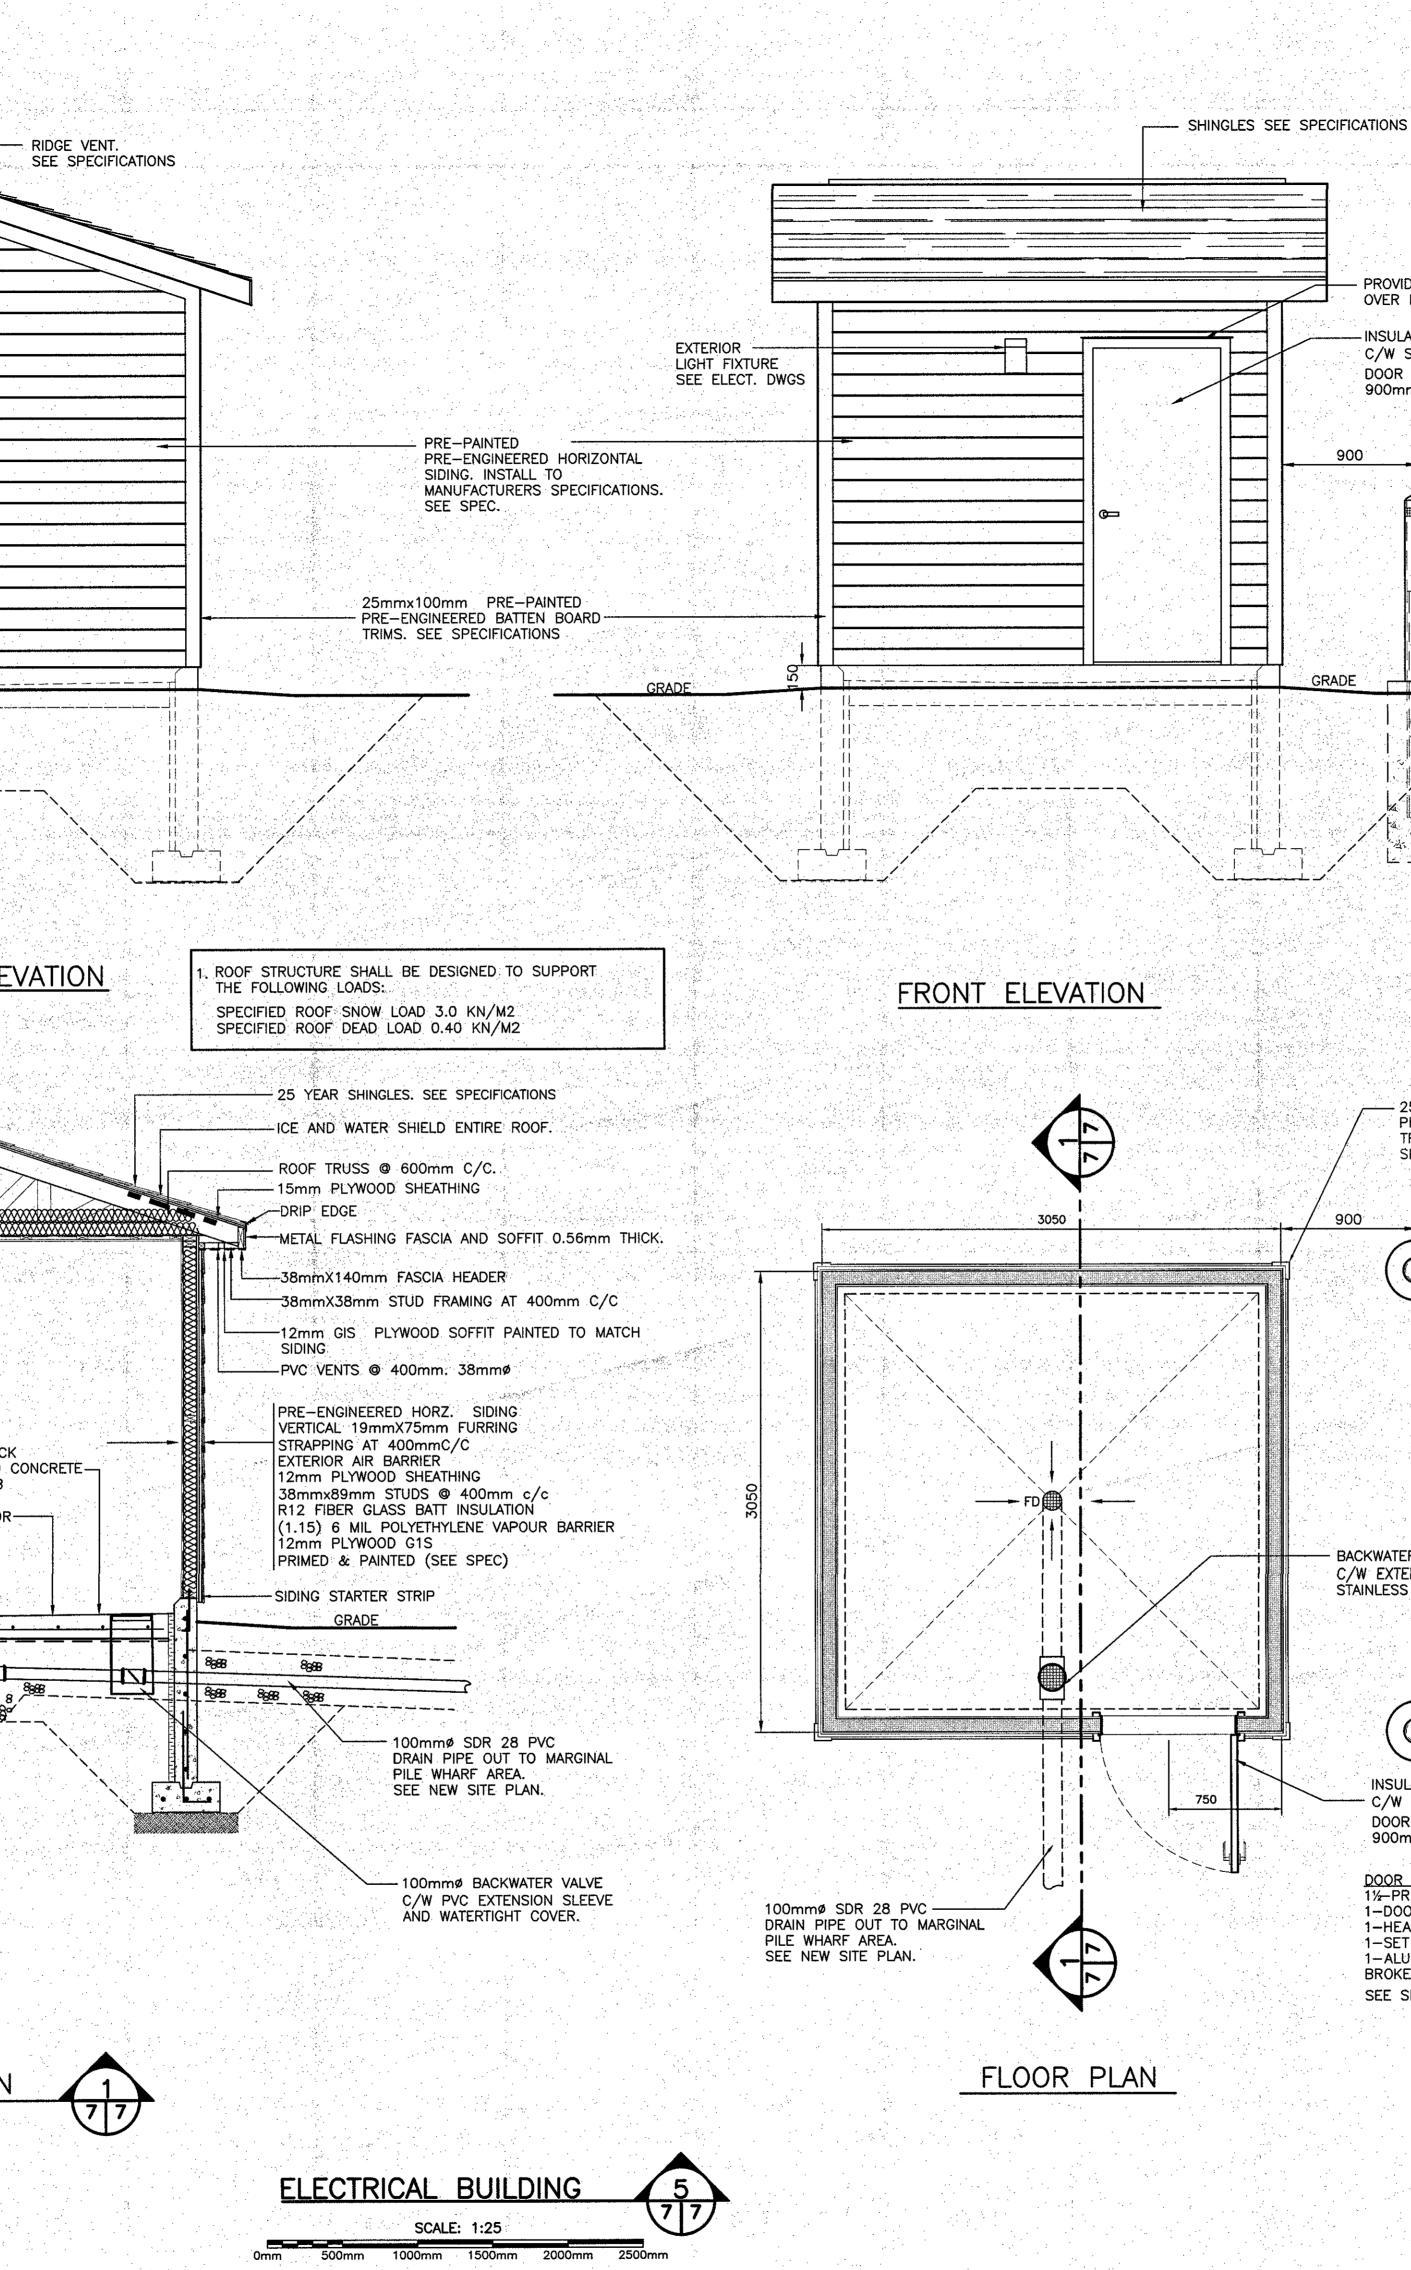


SIDE ELEVATION

	RIDGE VENT
STYROFOAM THRU VENTS - BETWEEN ALL TRUSS	
12mm PLYWOOD G.1.S. 19mmx75mm STRAPPING AT 400mmC/C 6 MIL (0.15) POLY VAPOUR BARRIER R20 BATT INSULATION PRE-ENG ROOF TRUSS AT 600mm C/C	
SILL GASKET 15mm X 300mm LG ANCHOR BOLTS AT 1200mm C/C GRADE	150mm THICK REINFORCED CONCRETE FLOOR SLAB
38mm THICK SM INSULATION PERIMETER FOUNDATION WALL BACKFILL USING EXISTING EXCAVATED MATERIAL 10M AT 600mm C/C, B/W	
10M TIES AT 500mm C/C. 3-15M REBAR, CONTINUOUS	
FOOTING TO REST ON UNDISTURBED MATERIAL 10M REBAR AT	450 300mm C/C, B/W
200mm TYPE 2	MATERIAL COMPACTED
6 MIL.	POLY SHEET UNDER SLAB

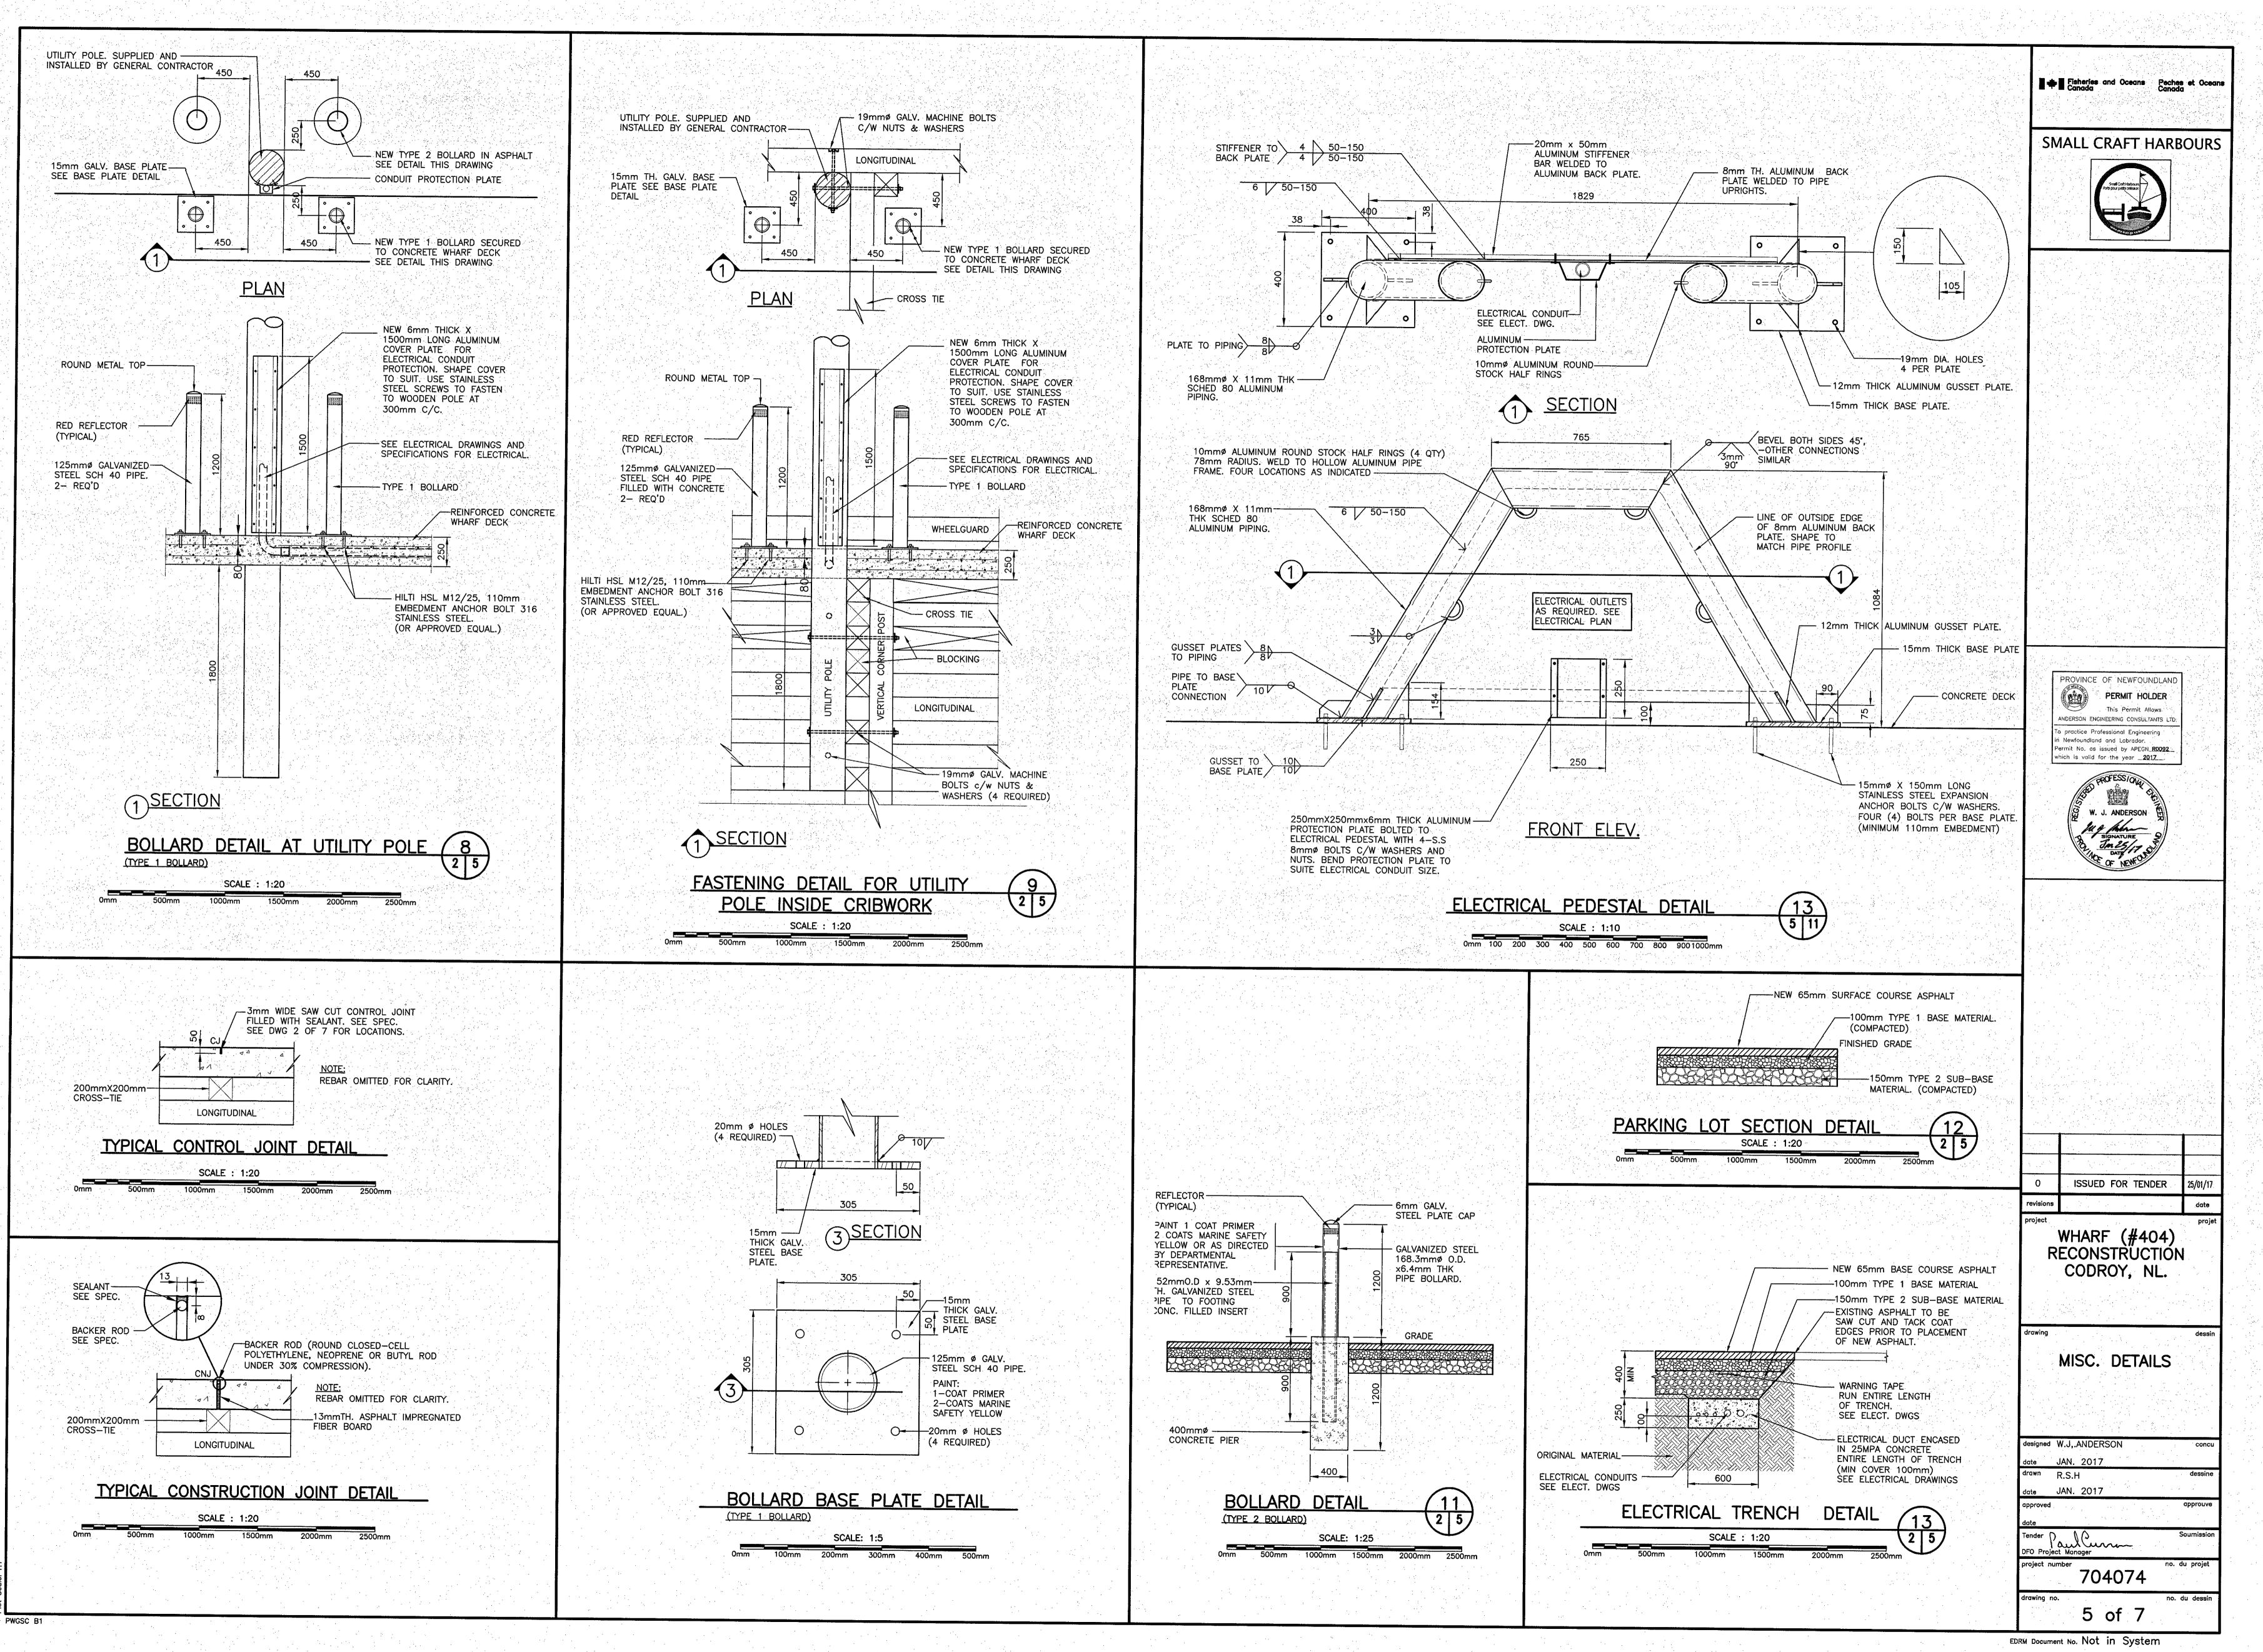SECTION
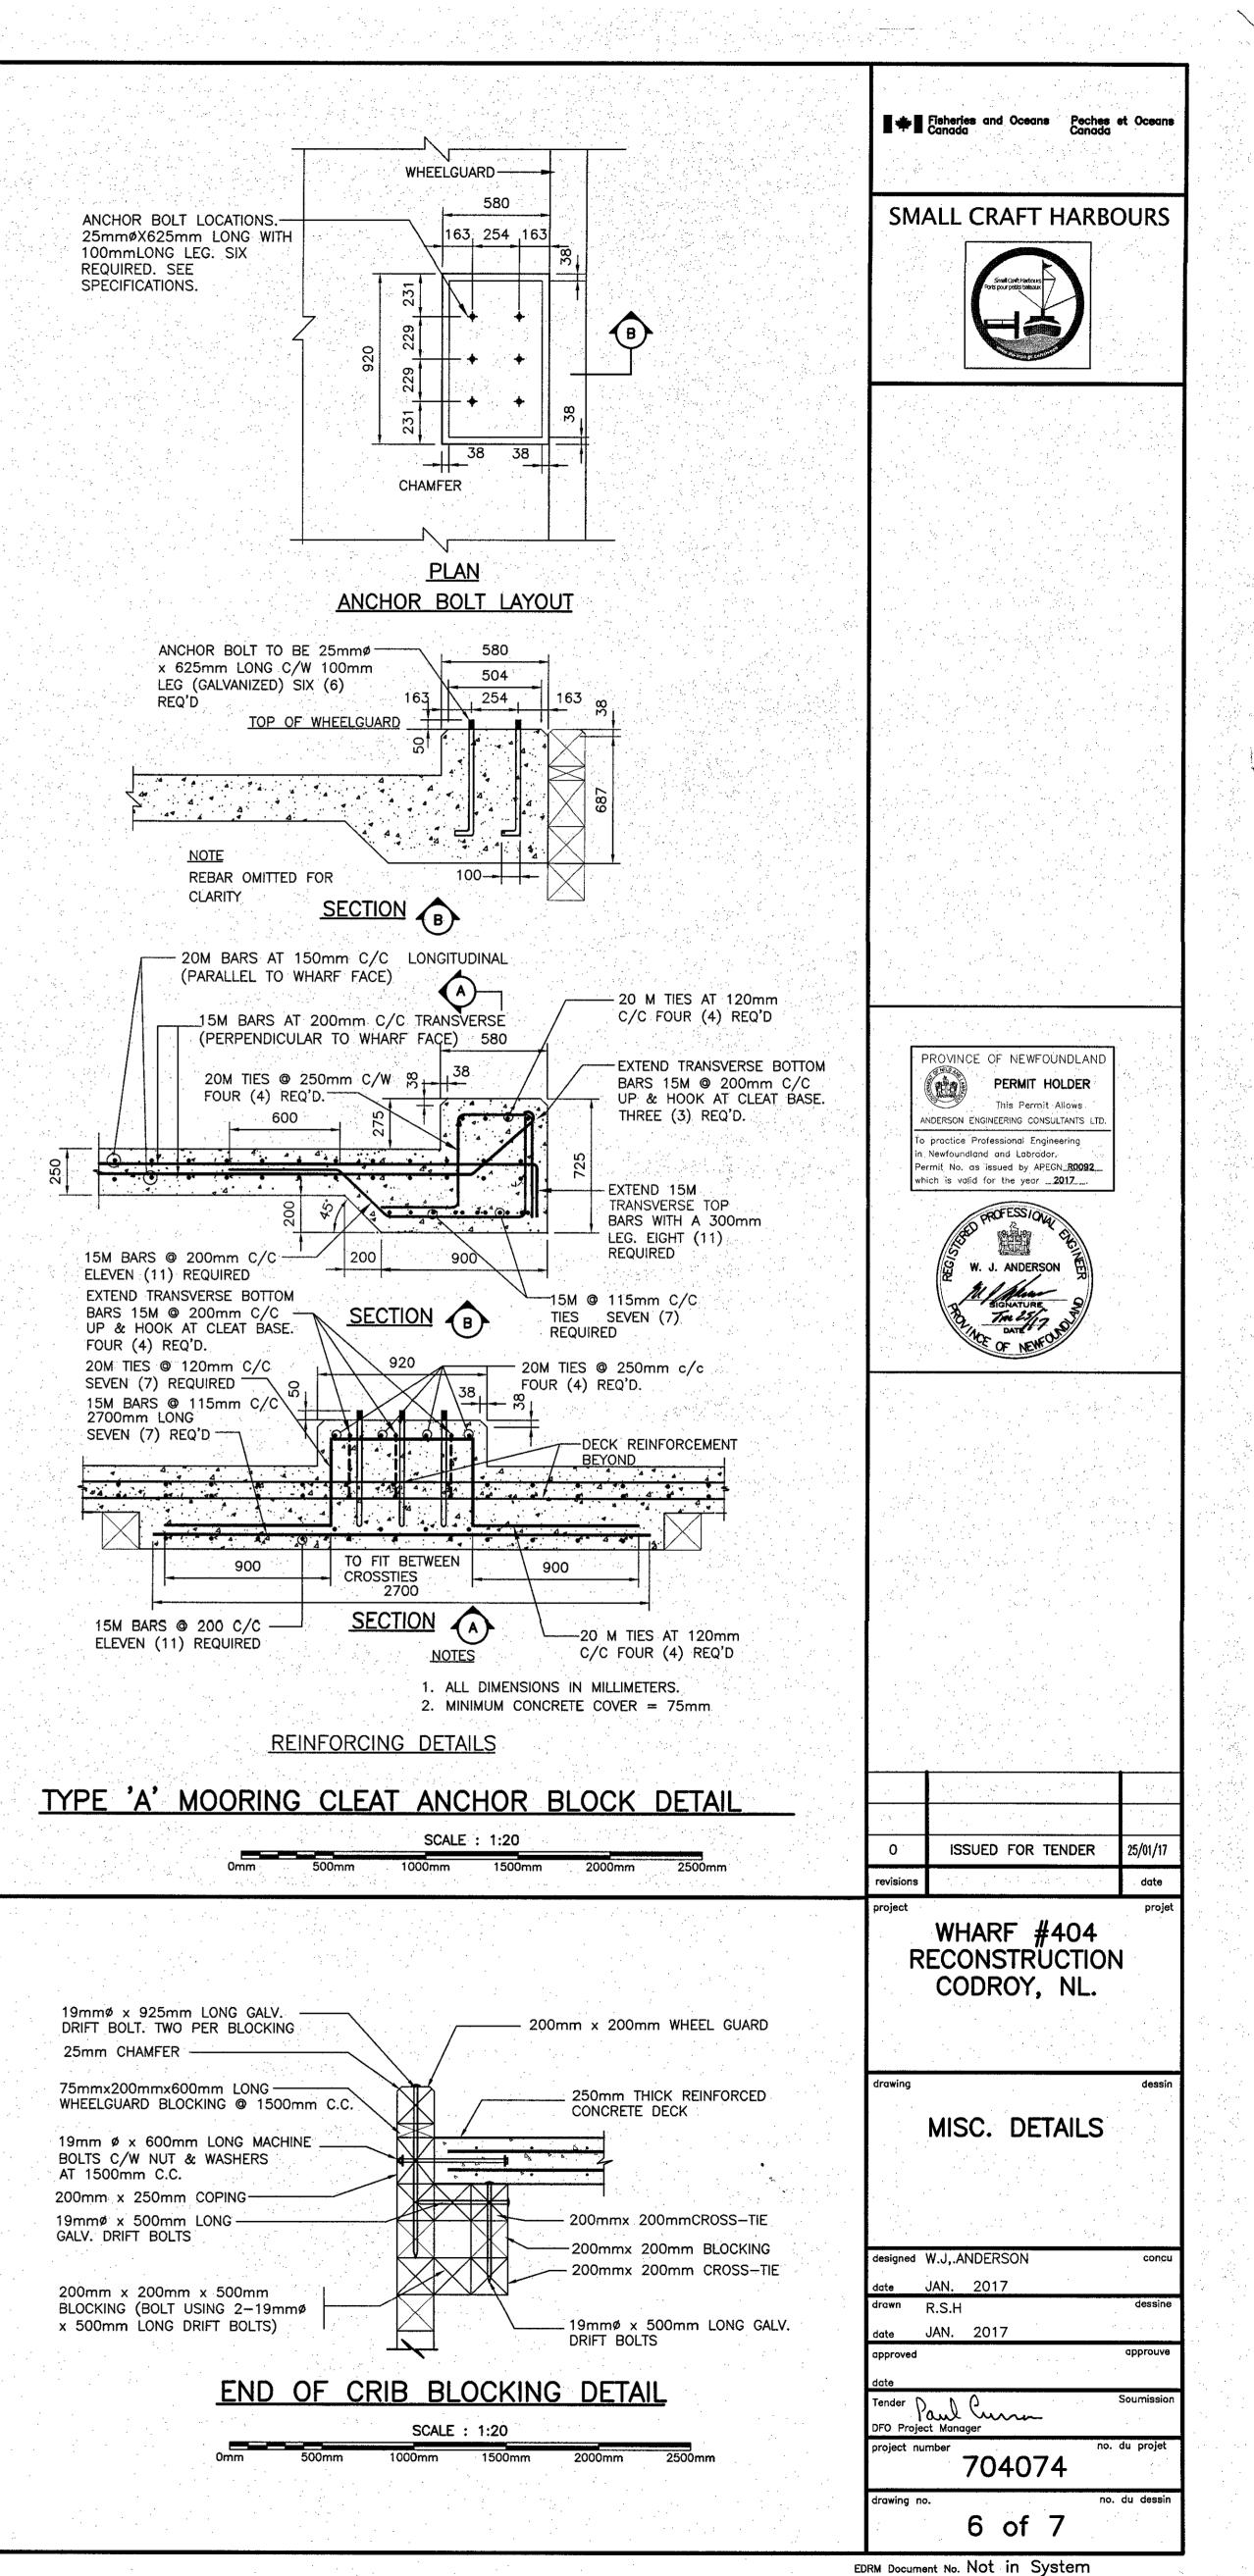
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900

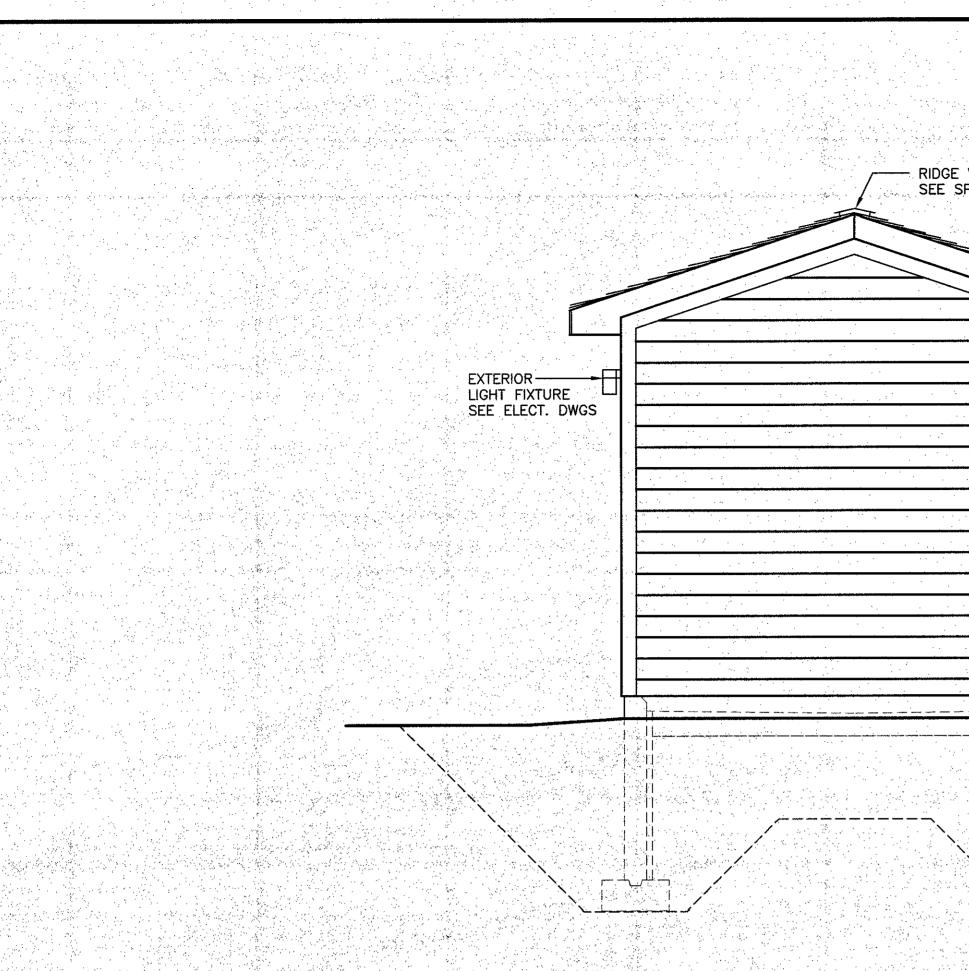900

 $(\mathfrak{G})$ 

## - PROVIDE FLASHING OVER DOOR

-INSULATED GALV. STEEL DOOR C/W STEEL FRAME. SEE SPEC. DOOR SIZE: 900mm WIDE X2133mm HIGH

NEW BOLLARD. SEE DETAILS DRAWING 5 OF 7 EXISTING ASPHALT

- NEW BOLLARD. SEE DETAILS DRAWING 5 OF 7

1.500 200

25mmX100mm PRE-PAINTED

TRIM BY SIDING SUPPLIER. SEE SPECIFICATIONS.

PRE-ENGINEERED BATTEN BOARD

drawing JAN. 2017 drawn R.S.H date JAN. 2017


C/W EXTENSION AND STAINLESS STEEL COVER




BACKWATER VALVE

INSULATED GALV. STEEL DOOR - C/W STEEL FRAME. SEE SPEC. DOOR SIZE: 900mm WIDE X2133mm HIGH

DOOR HARDWARE 11/2-PR. HEAVY DUTY BUTT HINGES 1-DOOR CLOSER 1-HEAVY DUTY MORTISED LEVER LOCKSET 1-SET WEATHER STRIPPING TO SUIT DOOR SIZE 1-ALUMINUM HEAVY DUTY THRESHOLD THERMALLY BROKEN SEE SPECIFICATIONS

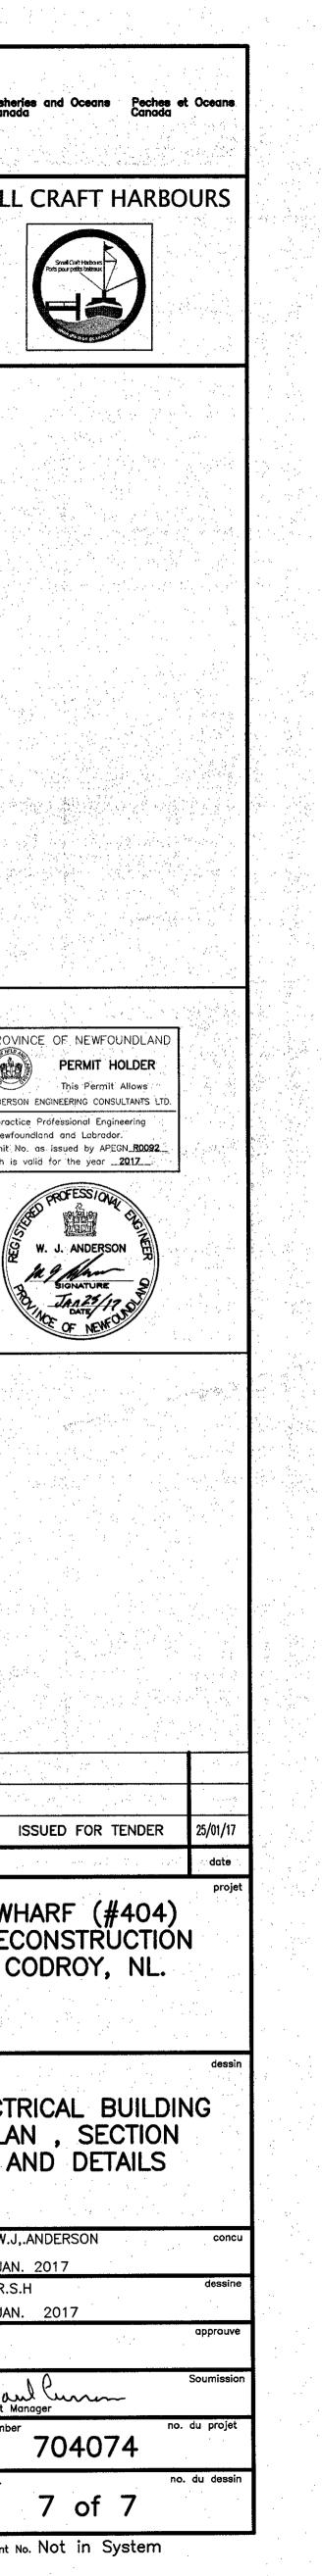


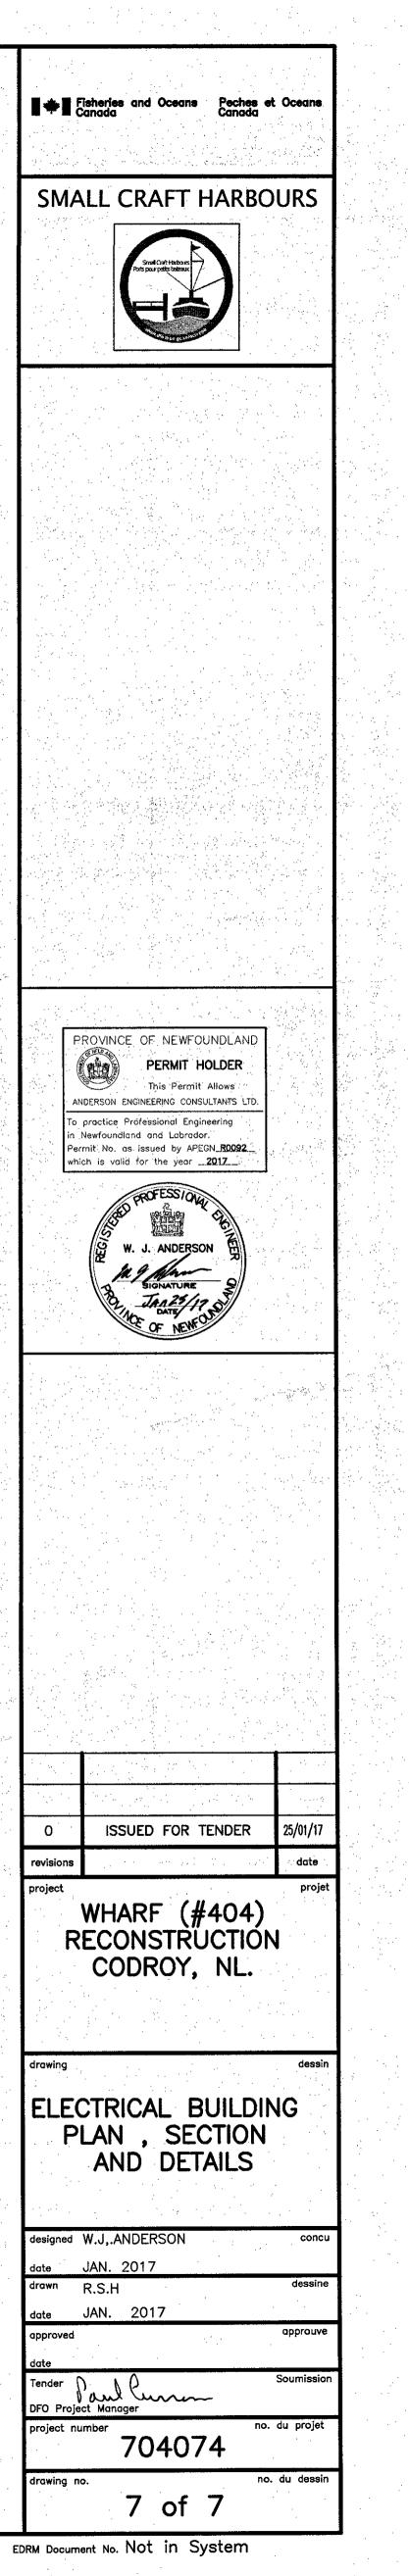




BH	LED LIGHTING FIXTURE. TO BE PHILIPS #313LED16704K120 OR APPROVED EQUAL. SEE SPEC.		
	LED LIGHTING FIXTURE. TO BE PHILIPS #DWAE43L940-4		
\$	C/W ACRYLIC LENS OR APPROVED EQUAL. SEE SPEC. SINGLE POLE TOGGLE SWITCH. 15 AMP, 120 VOLT, YELLOW,		
	MARINE GRADE C/W PVC MARINE GRADE COVERPLATE. SEE SPEC. FOR MORE INFORMATION. MOUNT 1200mm ABOVE FINISHED FLOOR.		
(T)	LINE VOLTAGE THERMOSTAT RATED 240 VOLT, 4500 WATTS, DPST, WHITE. MOUNT 1200mm AFF.		• • • •
0	SURFACE MOUNTED PANELBOARD		· · · ·
	LIGHT POLE AND FIXTURES. SEE DETAIL ON DRAWING E4.		
	ELECTRICAL PEDESTAL. SEE DETAILS ON DRAWING E3. DUPLEX U-GROUND RECEPTACLE. 120 VOLT, 15 AMP, MARINE GRADE. YELLOW		
vp (L)	& C/W PVC MARINE GRADE COVERPLATE. WALL MOUNT 400mm ABOVE FINISHED FLOOR. "WP" INDICATES WEATHERPROOF GASKET AND COVERPLATE.		
TYPE CIRCUIT			
			· , ·
	JIB CRANE.		
GEN	IERAL NOTES:		
1.	CONTRACTOR MUST VERIFY ALL DIMENSIONS AND CONDITIONS ON SITE BEFORE PROCEEDING WITH ANY PORTION OF THIS WORK. DO NOT SCALE		
	FROM DRAWINGS. CONTRACTOR TO ASSESS WORK AREA IN ADVANCE WITH OWNER REPRESENTATIVE FOR COORDINATION OF RELATED DAILY		
	WORK SCHEDULES, PARKING, BUILDING ACCESS, AND STORAGE OF EQUIPMENT.		
2.	ALL WORK TO BE IN ACCORDANCE WITH THE LATEST REQUIREMENTS OF: THE NATIONAL BUILDING CODE OF CANADA, LATEST EDITION; CANADIAN		
	ELECTRICAL CODE, CURRENT EDITION; ANY OTHER AUTHORITIES HAVING JURISDICTION.		
3.	WORK SHALL BE SCHEDULED DURING NORMAL WORKING HOURS CONTRACTOR MAY WORK AFTER NORMAL WORKING HOURS AS		
	COORDINATED BY OWNER REPRESENTATIVE. BUILDING TO REMAIN OPERATIONAL DURING CONSTRUCTION.		
4.	CONTRACTOR SHALL BE RESPONSIBLE FOR CLEAN UP AND DISPOSALS OF WORK AREA ON A DAILY BASIS. AFTER EACH WORKING SHIFT		
	BUILDING TO BE CLEANED AND FREE OF DEBRIS. BUILDING GARBAGE BINS ARE NOT TO BE USED.		
5.	ANY ELECTRICAL SYSTEM SHUTDOWN TO BE SCHEDULED AFTER NORMAL BUSINESS HOURS AND SHALL BE COORDINATED WITH OWNER		
	REPRESENTATIVE. SUFFICIENT NOTICE SHALL BE GIVEN. 5 WORKING DAYS NOTICE IS REQUIRED FOR ANY DISRUPTION.		
6.	WORK TO BE CARRIED OUT IN CONSIDERATION OF CLIENT COMFORT AND OPERATIONS.		
<b></b>	ALL WIRING TO BE INSTALLED IN CONDUIT AS INDICATED.		
8.	ACCESS TO FACILITY TO BE COORDINATED WITH OWNER REPRESENTATIVE.		
9.	PROVIDE TYPED REVISED PANELBOARD DIRECTORIES FOR ALL PANELBOARDS WHERE BRANCH CIRCUITS WERE REMOVED, ADDED OR		
10.	MODIFIED.		
	STANDARDS.		
	ALL EXISTING ELECTRICAL EQUIPMENT REMOVED TO BE TURNED OVER TO OWNER. IF OWNER REFUSES THEN CONTRACTOR TO REMOVE FROM SITE AND DISPOSE.	EXISTING PEDESTAL	

PWGSC B1

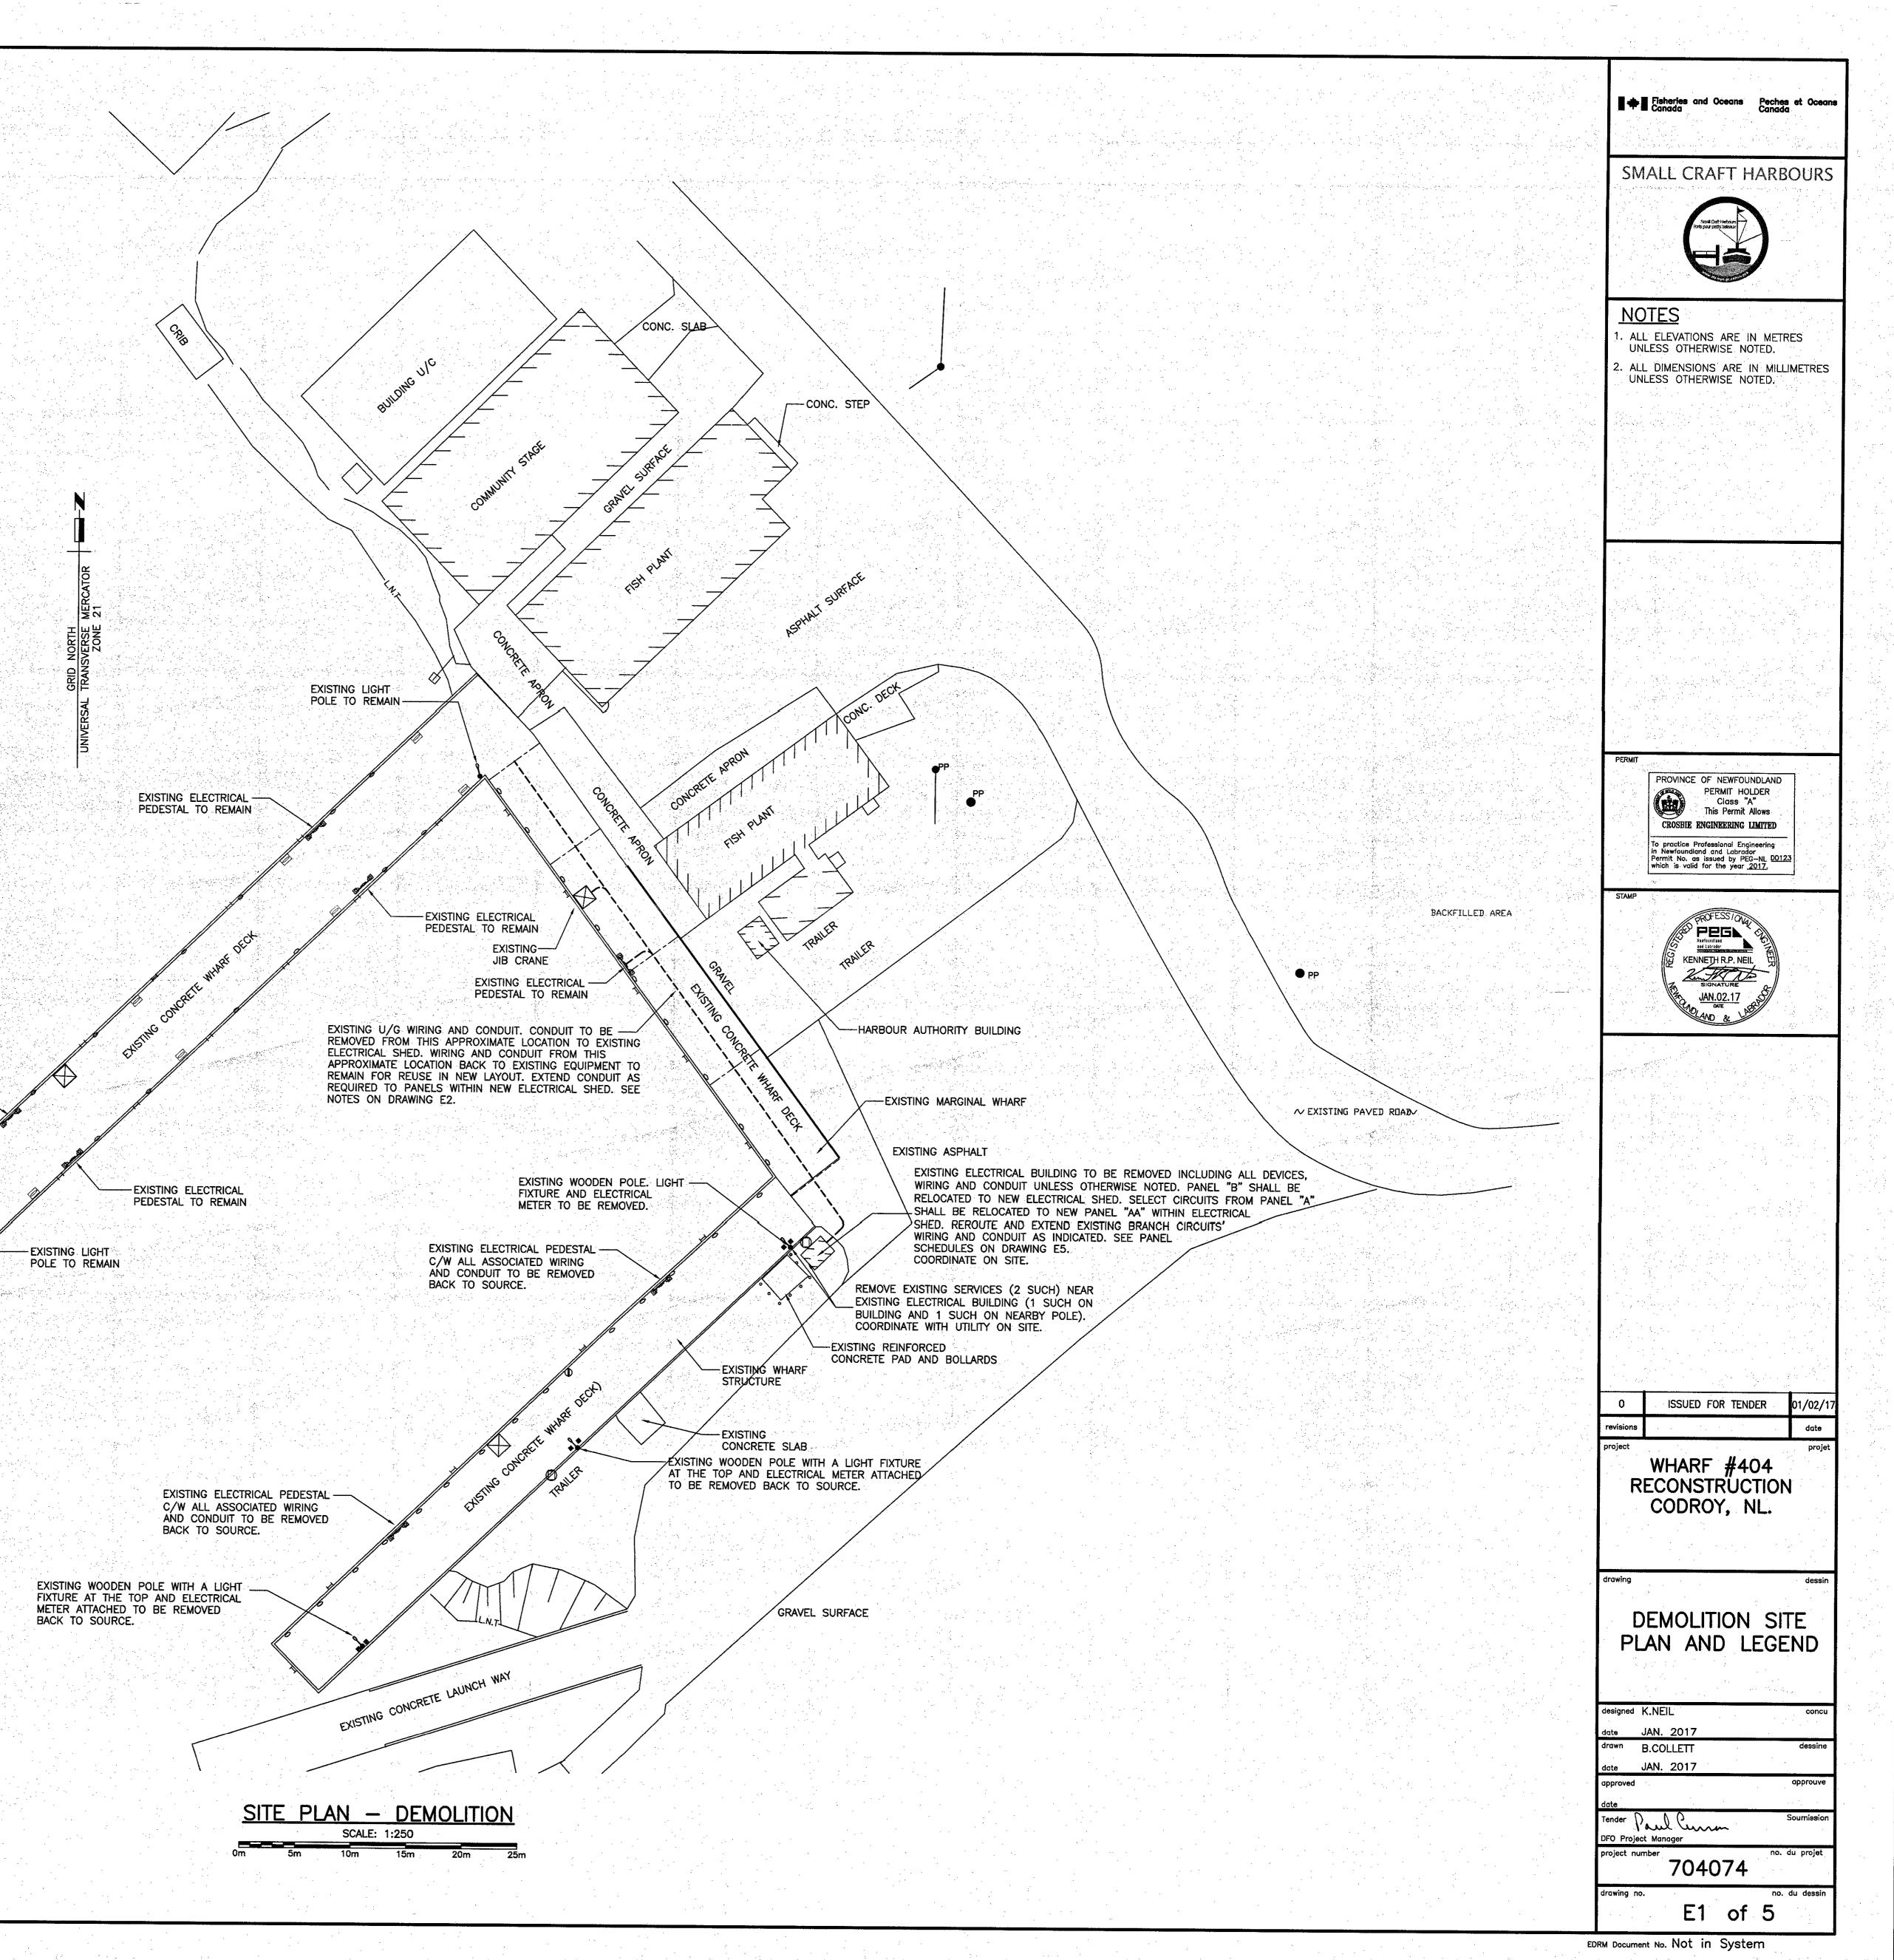

0	ISSUED FOR TENDER
revisions	
roject	
R	WHARF #404 ECONSTRUCTIO CODROY, NL
rawing	· · · · · · · · · · · · · · · · · · ·
D	EMOLITION

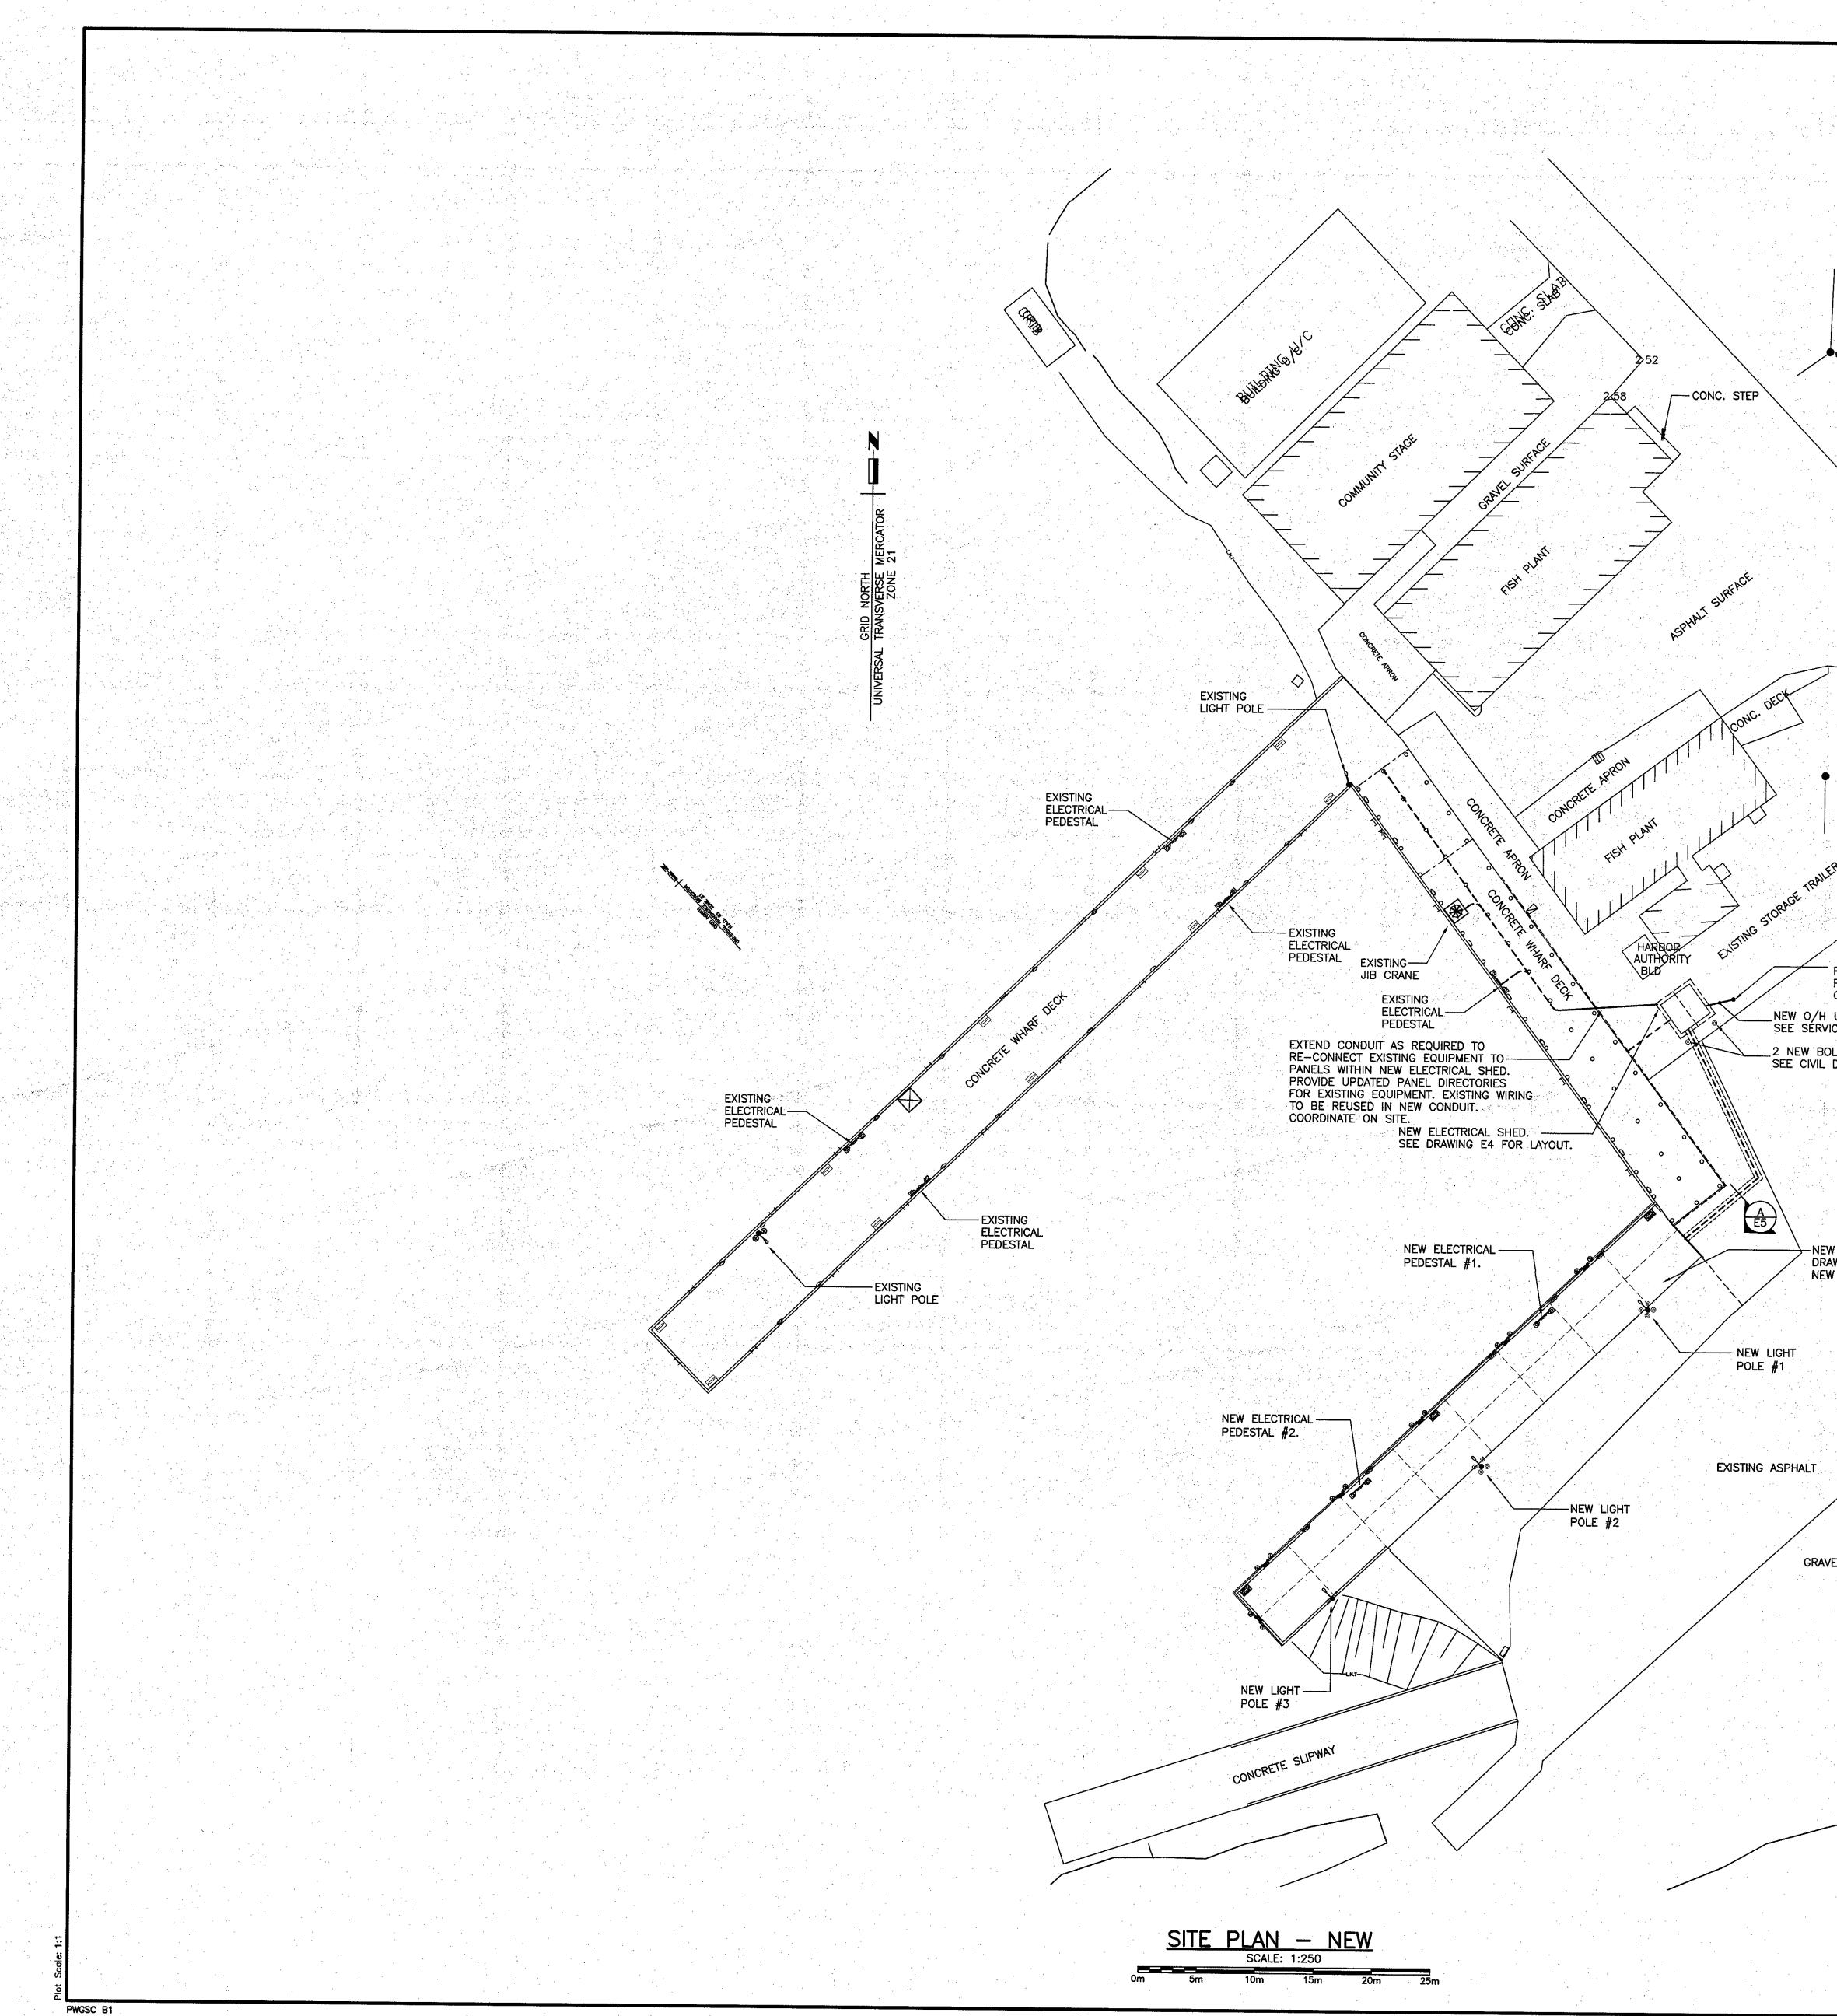

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1. Jan 1. M.

<u>NOTES</u> ALL ELEVATIONS ARE IN METRES UNLESS OTHERWISE NOTED. 2. ALL DIMENSIONS ARE IN MILLIMETRES UNLESS OTHERWISE NOTED. PERMIT PROVINCE OF NEWFOUNDLAND CROSBIE ENGINEERING LIMITED To practice Professional Engineering in Newfoundland and Labrador Permit No. as issued by PEG-NL D0123 which is valid for the year <u>2017</u>. STAMP

Fisheries and Oceans

PERMIT HOLDER Class "A"

This Permit Allows

GROFE KENNETH R.P. NEIL AN.02.17

ISSUED FOR TENDER revision WHARF #404 RECONSTRUCTION CODROY, NL. drawing

designed K.NEIL date JAN. 2017 drawn B.COLLETT date JAN. 2017 Tender Paul Current DFO Project Manager project number 704074 drawing no. E2 of 5

EDRM Document No. Not in System

### EXISTING ASPHALT

-EDGE OF


 PROPOSED LOCATION OF NEW UTILITY
 POLE BY UTILITY COMPANY.
 COORDINATE EXACT LOCATION ON SITE. \_\_NEW O/H UTILITY LINE BY UTILITY COMPANY. SEE SERVICE ELEVATION DETAIL ON DRAWING E4. \_2 NEW BOLLARDS. SEE CIVIL DRAWINGS FOR DETAILS.


NEW WHARF. SEE DRAWING E3 FOR NEW WHARF LAYOUT.

GRAVEL SURFACE

approved

NEW SITE PLAN

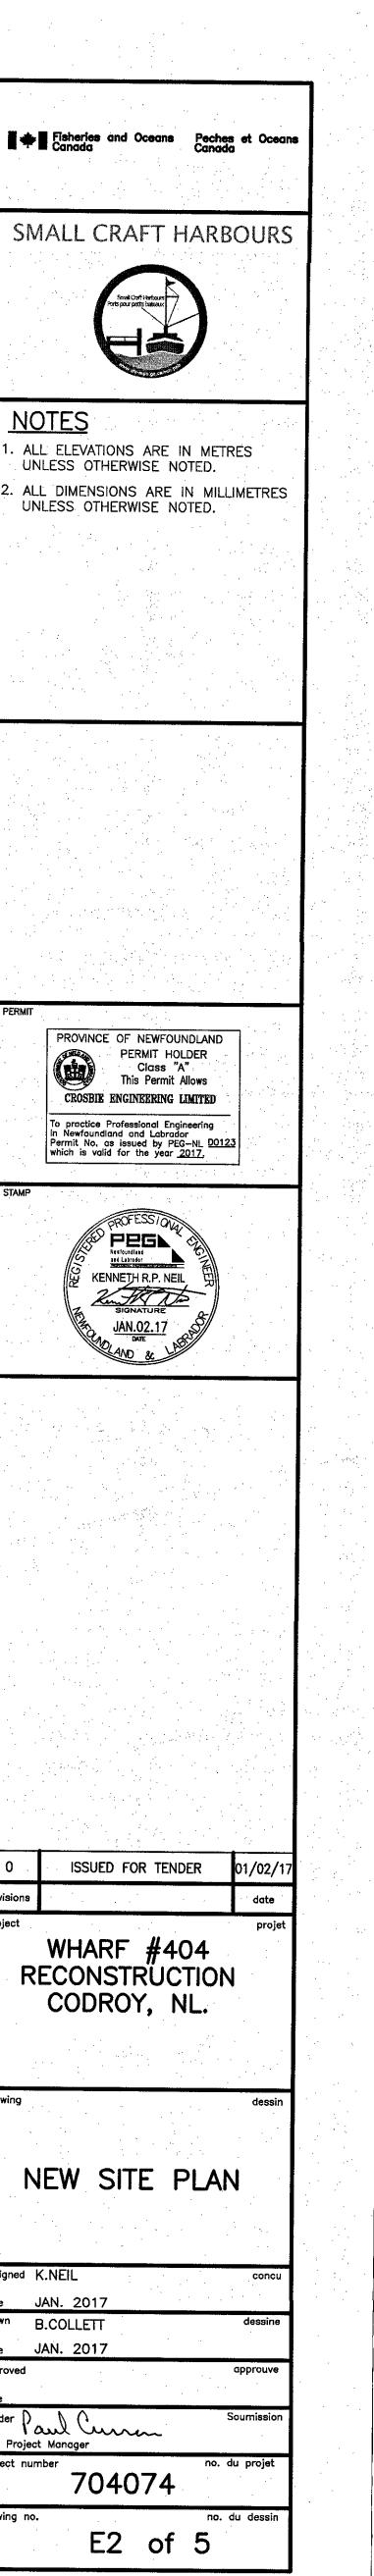

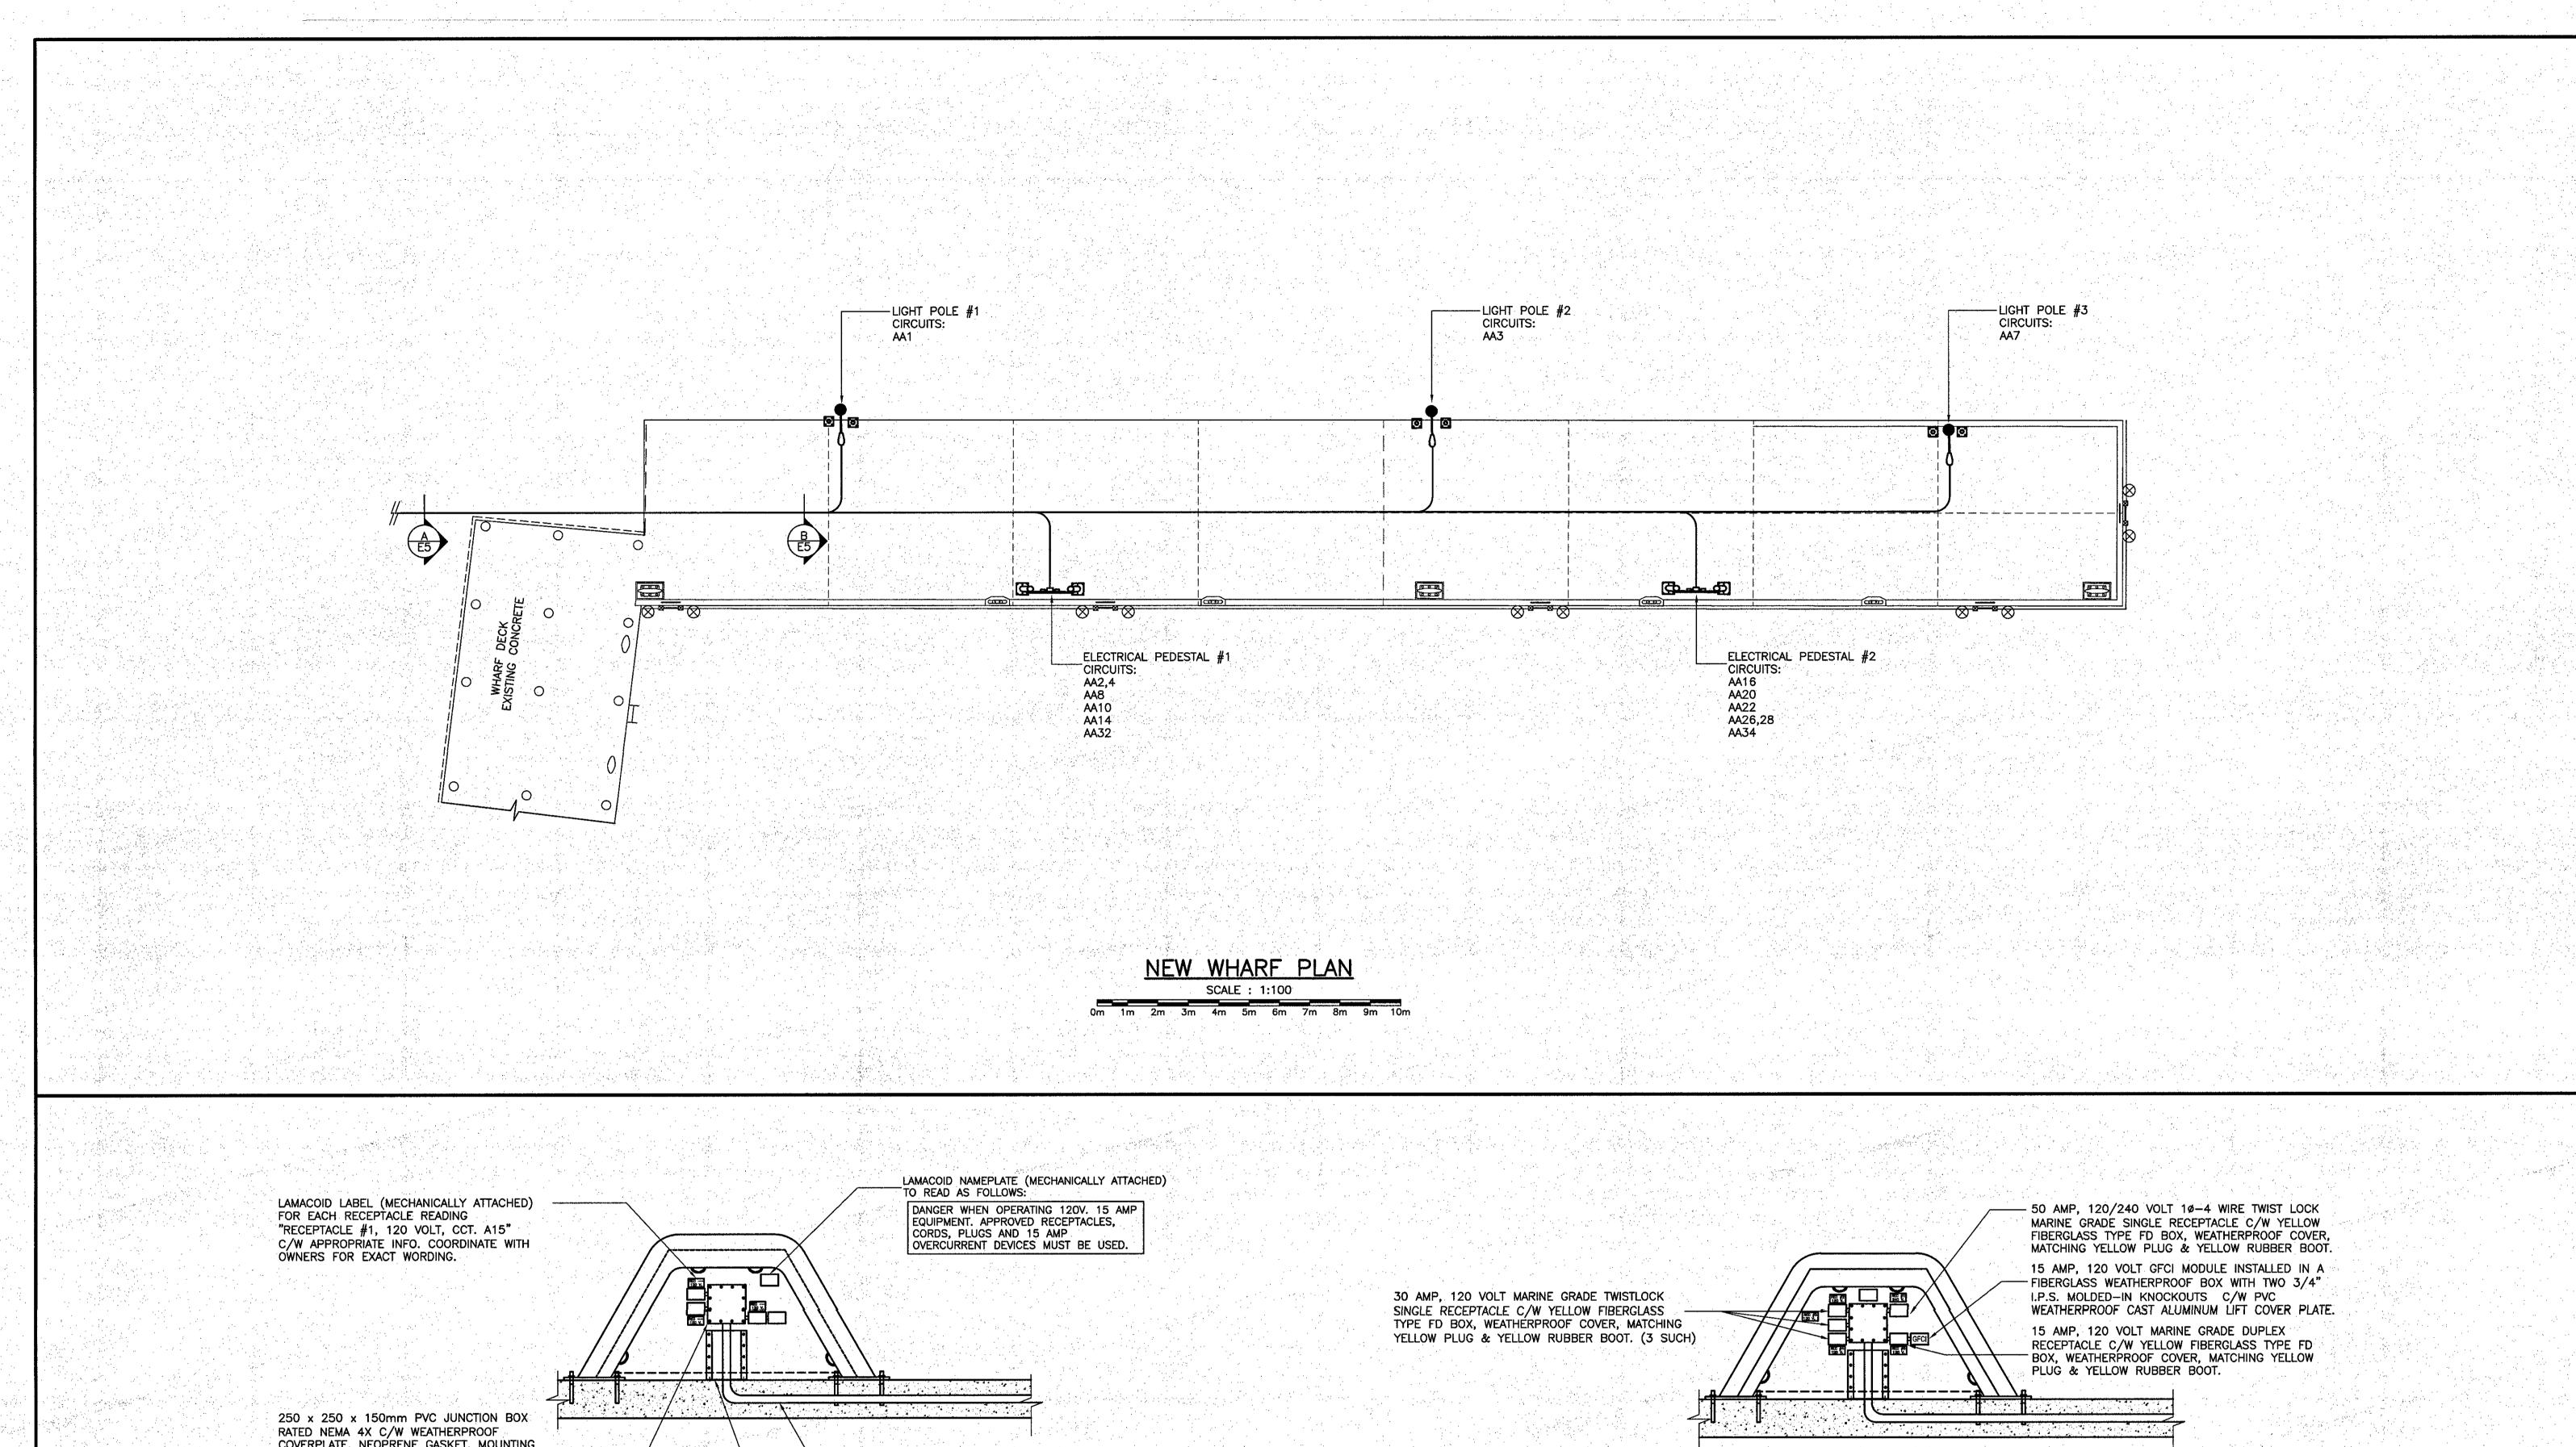

COVERPLATE, NEOPRENE GASKET, MOUNTING STRAPS & WEATHERPROOF FITTINGS. "SCEPTER" OR APPROVED EQUAL. RUN A DEDICATED. NEUTRAL CONDUCTOR FOR EACH CIRCUIT. SIZE BOND WIRES TO SECTION 10 OF C.E.C. C22.1-12. ALL CABLE CONNECTORS TO BE MARINE GRADE C/W "O" RINGS. BOX TO BE C/W DIN RAIL MOUNTED TERMINAL BLOCKS EQUAL TO "PHOENIX" CONTACT UK16 SERIES. DO NOT SPLICE CONDUCTORS.

**ELEVATION** 

ELECTRICAL CONTRACTOR.

NOTE:

TYPICAL ELECTRICAL PEDESTAL DETAIL SCALE : 1:20 1500mm 1000mm 0mm 2000mm 500mm

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-RIGID PVC CONDUIT C/W FACTORY BENDS. -6mm THICK ALUMINUM PIPE GUARD ANCHORED TO DECK & PEDESTAL BACK PLATE USING STAINLESS STEEL SCREWS, SHAPE GUARD TO FIT APPLICATION.

1. ELECTRICAL PEDESTAL SUPPLIED AND INSTALLED BY GENERAL CONTRACTOR. ELECTRICAL DEVICES SUPPLIED AND INSTALLED BY

2. MOUNT RECEPTACLES IN PVC FD TYPE OUTLET BOX, COVER, GASKET & MOUNTING LUGS. HUBS, WEATHER PROOF FITTINGS, CAST "CROUSE HINDS" OR EQUAL, C/W 20mm. 3. UTILIZE RIGID PVC CONDUIT C/W MARINE GRADE FITTINGS. SECURE TO PEDESTAL USING 2 HOLE STRAPS & S.S. SCREWS. TYPICAL.

30 AMP, 120 VOLT MARINE GRADE TWISTLOCK SINGLE RECEPTACLE C/W YELLOW FIBERGLASS - TYPE FD BOX, WEATHERPROOF COVER, MATCHING YELLOW PLUG & YELLOW RUBBER BOOT. (3 SUCH)

- 30 AMP, 120/240 VOLT  $1\phi-4$  WIRE TWIST LOCK MARINE GRADE SINGLE RECEPTACLE C/W YELLOW FIBERGLASS TYPE FD BOX, WEATHERPROOF COVER, MATCHING YELLOW PLUG & YELLOW RUBBER BOOT. 15 AMP, 120 VOLT GFCI MODULE INSTALLED IN A - FIBERGLASS WEATHERPROOF BOX WITH TWO 3/4" I.P.S. MOLDED-IN KNOCKOUTS C/W PVC WEATHERPROOF CAST ALUMINUM LIFT COVER PLATE. 15 AMP, 120 VOLT MARINE GRADE DUPLEX GFCI RECEPTACLE C/W YELLOW FIBERGLASS TYPE FD BOX, WEATHERPROOF COVER, MATCHING YELLOW PLUG & YELLOW RUBBER BOOT. 

1000mm

.

### ELECTRICAL PEDESTAL #1 SCALE : 1:20

1500mm

1000mm

500mm

0mm

ELECTRICAL PEDESTAL #2 SCALE : 1:20


revisions project WHARF #404 RECONSTRUCTION CODROY, NL. drawing NEW WHARF & PEDESTAL DETAILS designed K.NEIL JAN. 2017 drawn B.COLLETT ate JAN. 2017 approved Tender Paul Curron DFO Project Manager

Fisheries and Oceans

<u>NOTES</u>

project number 704074 drawing no.

EDRM Document No. Not in System

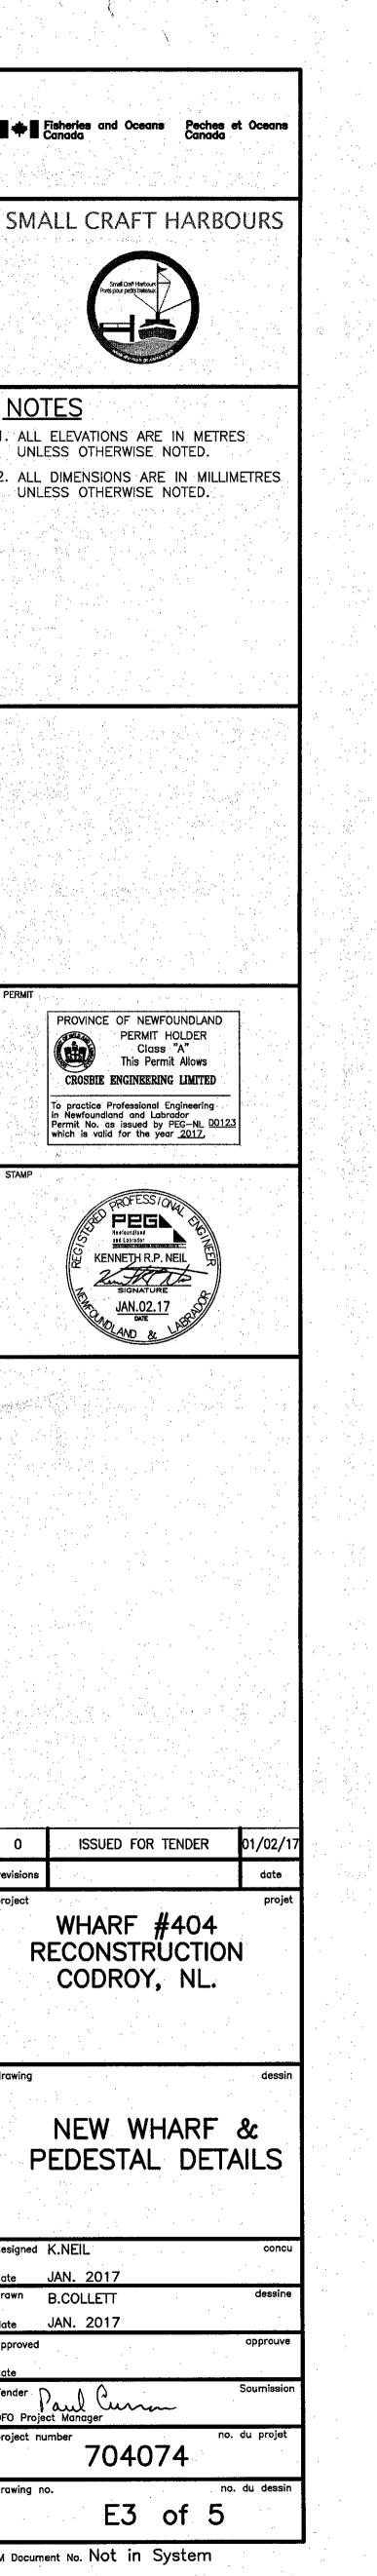

Class "A"

DROFE!


PEGN Neefourdisad and Labrador

KENNETH R.P. NEIL

JAN.02.17 MOLAND &

STAMP

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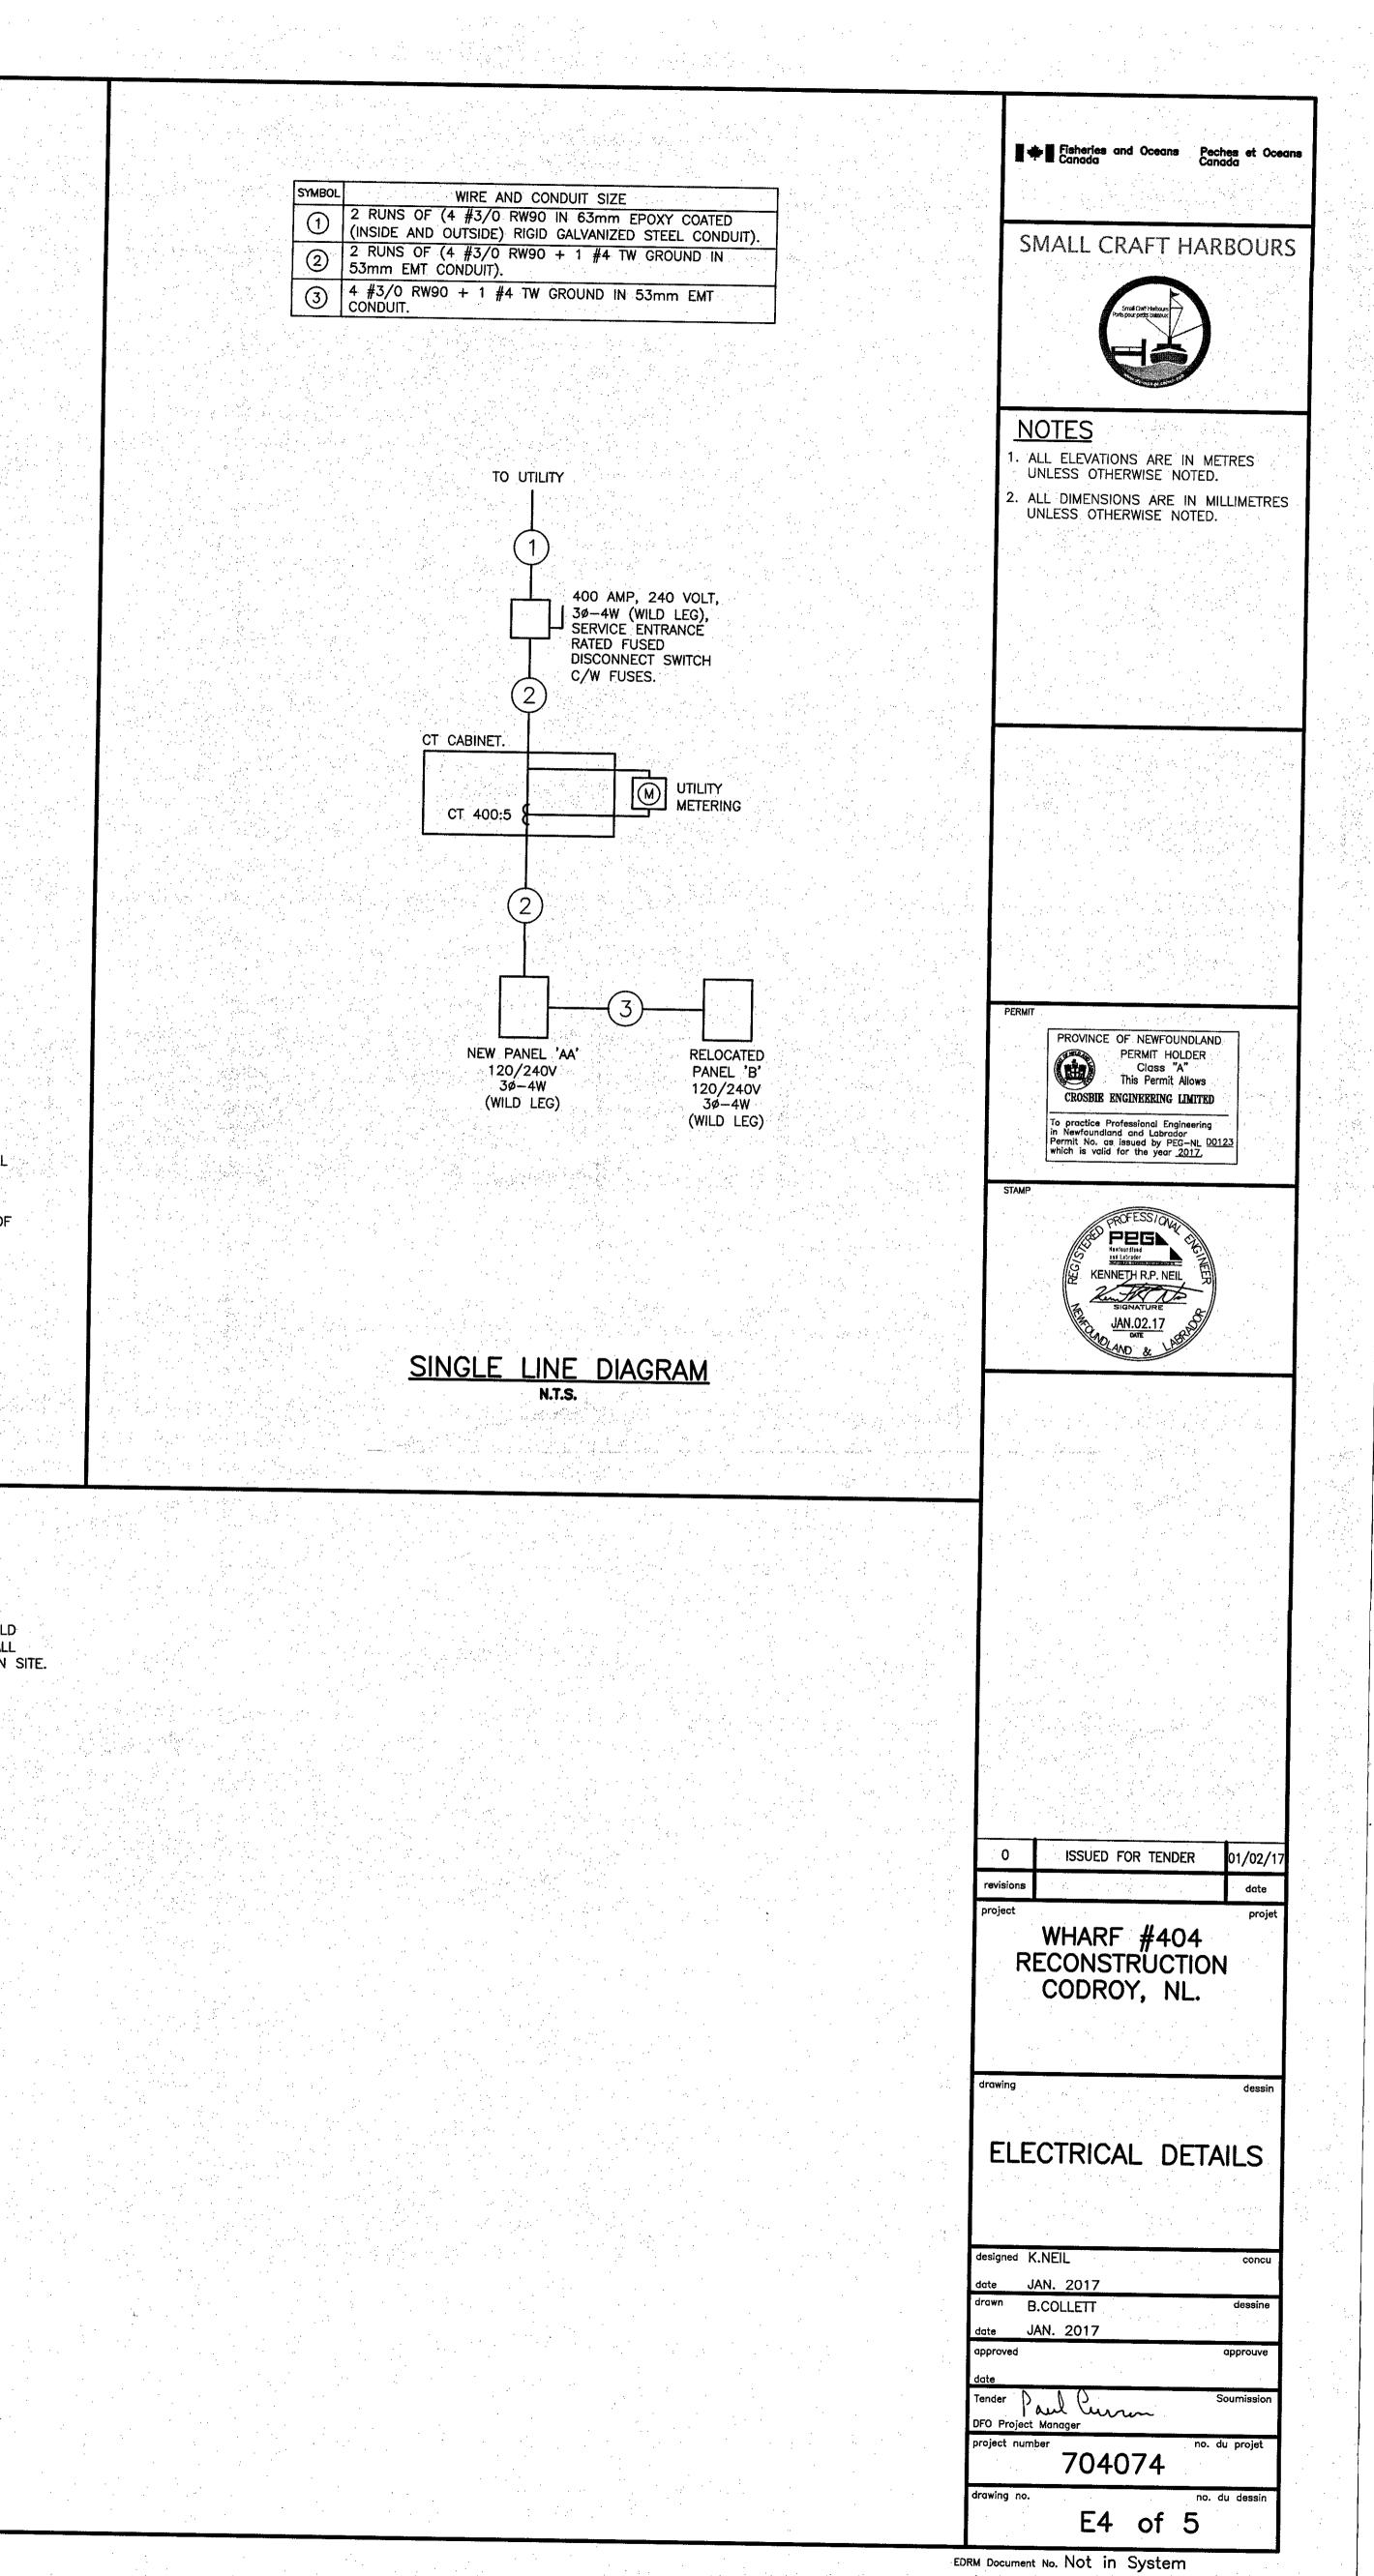
		CONTRACTOR TO COORDINATE WITH
		UITILITY COMPANY NEW SERVICE REQUIREMENTS. ACTUAL MOUNTING
		HEIGHT OF SERVICE MAST TO BE COORDINATED WITH UTILITY COMPANY.
		ADJUST CONDUCTOR AND CONDUIT
		LENGTHS ON THIS DETAIL AS REQUIRED.
		그는 것이 📿 지금은 일상은 문화가 같은 것이 같은 것이 있는 것이 있는 것이 있는 것이 있는 것이 같이 있는 것이 같이 있는 것이 없다.
		63mm WEATHERHOODS (2 SUCH).
		2 RUNS OF 4-#3/0 RW90 EXTEND 900mm BEYOND WEATHERHOOD FOR
		UTILITY CONNECTION.
		SERVICE ATTACHMENT SPOOL. MINIMUM
		OF 5.5 METRES ABOVE FINISHED GRADE. NUMBER OF SPOOLS AS REQUIRED.
S.		GALVANIZED
		STEEL GUYS
		에 남 님은 말을 물을 줄을 잡았는 것 같은 것을 물러 것을 들어야 한다.
		FLASH AND SEAL WEATHERTIGHT WHERE MAST PENETRATES EAVE.
		2-HOLE STRAPS REQUIRED EVERY 900mm.
	친구, 그는 김 소리는 것은 것이라. 그는 것이다.	2 RUNS OF 4-#3/0 RW90 IN 63mm
		EPOXY COATED (INSIDE AND OUTSIDE) RIGID GALVANIZED STEEL CONDUIT.
	400 AMP, 120/240V,	이 [Hen ] [Hense States : 2012] 2022 - 2023 - 2023 - 2023 - 2023 - 2023 - 2023 - 2023 - 2023 - 2023 - 2023 - 202
	3ø, 4 WIRE (WILD LEG)	L.B. DRILL 6mm HOLE IN BOTTOM FOR DRAINAGE.
	PANEL "AA"	
	이에는 동안에 있는데, 이상은 유민이가는 것 해당한 것이 있다. 그는 아이는 것은 것은 것은 것이 같은 것은 것 같은 것을 하는 것을 하는 것을 수 있다.	이 것 물건집 동안 모양을 제공을 것을 것을 수 있는 것을 수 있는 것을 수 있는 것을 했다.
	GROUND BUS	<ul> <li>In the second s second second sec</li></ul>
	IN MAIN PANEL	▋ 수집 사람은 것 같은 것
<b>:К.</b>		
	FLOOR LEVEL	-1 #6 TW GROUND
		FINISHED GRADE
	는 가지 사람이 있는 것이 가지 않는 것이다. 가지 않는 것이 있는 것이 있는 것이다. 같은 것이 있는 것이 가지 않는 것이 있는 것이 있는 것이 있는 것이 같이 있는 것이 같은 것이다.	
	가지가 한다. 이것이 다 가격 가지 가장에 가격하려는 지않고 가능하는 것 	
		1 #6 BARE GROUND WIRE TO RUN IN 27mm RIGID PVC CONDUIT TO A POINT 2.0M BELOW THE NORMAL
	en e	TO 600 X 600 X 10mm STEEL PLATE FLECTRODE
		BT INERMII WELD CONNECTION AND FOUNDED ON
		THE HARBOR BOTTOM APPROX. 2.0 M FROM SIDE OF WHARF. SEE CEC SECTION 78 FOR GROUNDING
		DETAIL.
	in an an an an an an an Arran State an	ERVICE ELEVATION DETAIL

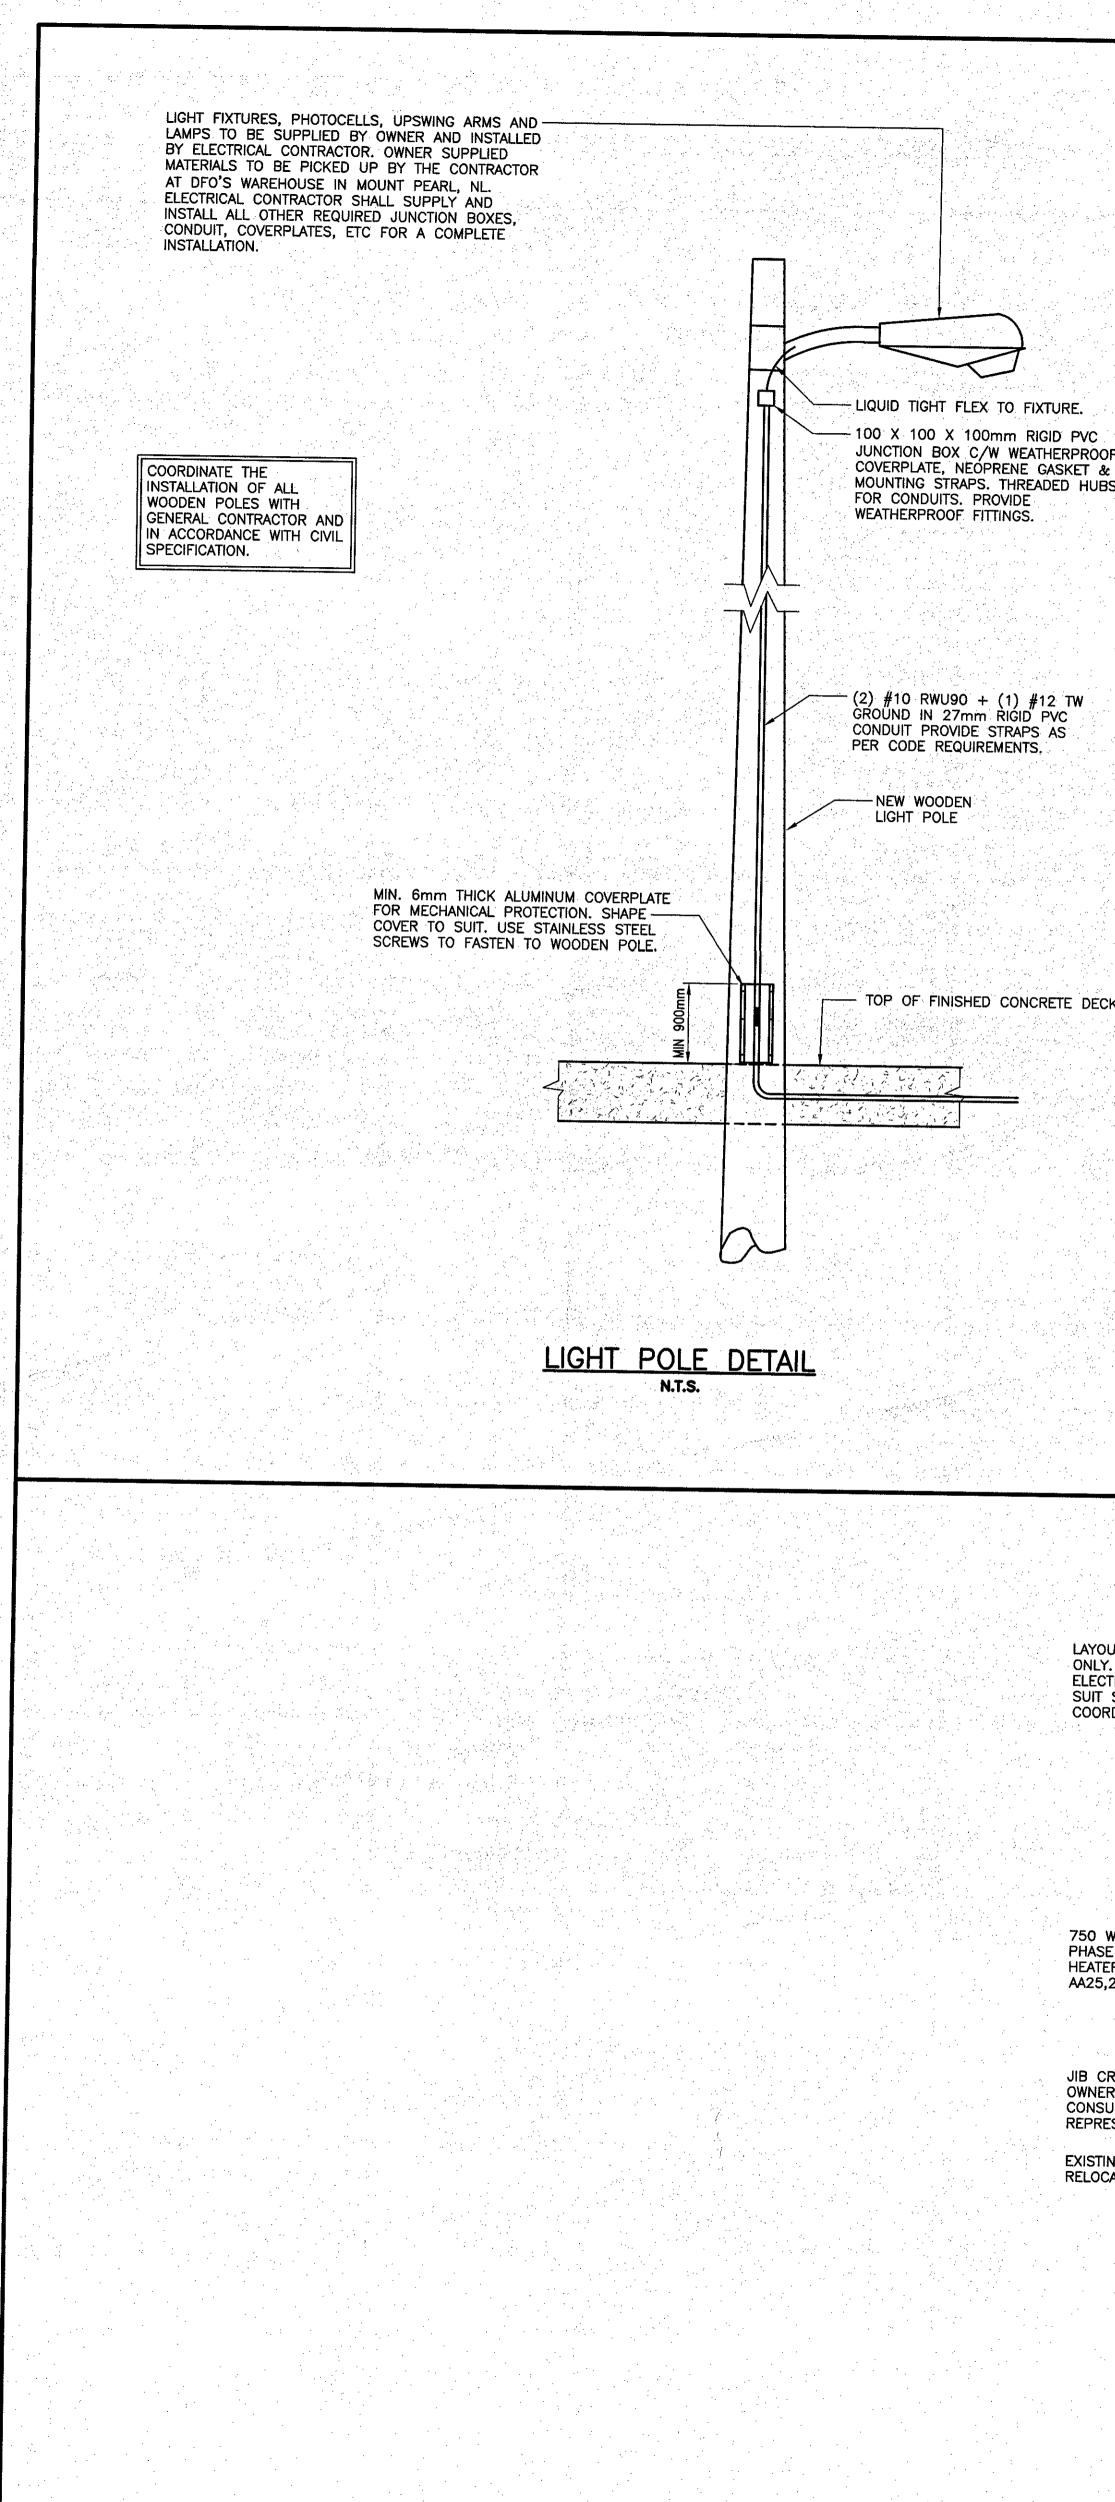OUT INDICATED IS APPROXIMATE Y. CONTRACTOR TO RELOCATE CTRICAL DEVICES IN SHED TO T SITE CONDITIONS. TO BE DRDINATED ON SITE.			LEG). REROUI	0/240 VOLT,
WATT, 240 VOLT, SINGLE SE ELECTRIC BASEBOARD TER. CONNECT TO CIRCUIT 5,27. CRANE CONTROLLER SUPPLIED BY ER, INSTALLED BY CONTRACTOR SULT WITH ON-SITE DEPARTMENTAL RESENTATIVE. TING LIGHTING CONTROL PANEL OCATED FROM EXISTING SHED.	A31   Dss   A31   A31   Dss   A337   A337   A37   A3	AA33		UTILITY METER CT CABINET METER ELECTRICAL SERVICE CONDUIT. SEE DETAIL ABOVE. 400 AMP, 120/240 VOLT, 3Ø-4W (WILD LEG), SERVICE ENTRANCE RATED MAIN FUSED DISCONNECT SWITCH C/W FUSES

 ELECTRICAL SHED PLAN

 SCALE : 1:20

 500mm
 1000mm
 1500mm
 2000mm
 21



VOLTS 120/240 (WILD LEG)	PANEL	NAME		·· "/	AA"				<u> </u>			M	AINS
PHASE 3	LOCAT	ION	EL	ECTR	ICAL	SHE	D -	Ad et	n Starten				OUNTI
												a de la composición d	NTER
DESIGNATION	WAT	TAGE						<u> </u>			T	WAT	TAGE
	ØA	ØB	WIRE	BKR	ССТ	A:	B	C	ICC1	BKR	WIRE	ØA	ØΒ
LIGHT POLE #1	200		10	15	1	+		+	2	50/	4	4200	``
LIGHT POLE #2		200	10	15	.3 .	] +		+	4	$\sqrt{2}$	4		4200
SPACE	<u> </u>	·	•	·	5	╏╺╋╴		+	6				
LIGHT POLE #3		200	10	15	7	<b>!</b> -+-		┿	8	30	6		2520
SPARE		ŀ	ļ	15	9	╏╺┼╴	-+-	+	10	30	6	2520	N. C.
SPACE	ļ	<u> </u>	L		11			+	12			•	
	ļ		ļ	30/	13	┿	+-	+	14	30	6	2520	
SPARE				1/	15	+	+	+-	16	30	4		2520
IP CRANE LICUTE (ADD)				$\sqrt{3}$	17	+		+	18				
JIB CRANE LIGHTS (A20) SPARE	<u> </u>	300	12	15	19			+	20	30	4	·	2520
SPACE				15	21		+	+-	22	30	4	2520	
			. 	457	23	! +		1	24		<u> </u>		
HEAT - SHED REACTION SERVICES THE SERVICE	375	775	12	15/	25 27			$\top$	26	30/	6	2520	
SPACE	· · ·	375		<u>72</u>	27		-	T	28	$\sqrt{2}$			2520
RECEPT - SHED	360		12	15	31			T	30	15	8	1000	
LIGHTING - SHED	300	150	12	15	33			Τ	32	15 15	6	1260	1000
SPACE		100	. 12		35			T	<u>34</u> 36	15	<u> </u>		1260
lighting — Shed	150		12	15	37			L	38	15	12	100	
EXTERIOR RECEPT		120	12	15	39	ŀ			40	15	12	100	
SPACE					41		Ŀ	<b>.</b>	42				
EXISTING CIRCUIT - POLE (A1)	300		1. 1. 2	15	43			T.	44	15	·*•	120	
EXISTING CIRCUIT - EXT. LIGHTING & RECEPT (A3)		300		20	45		+	<u> </u>		20		120	300
SPACE			· • • · · · ·		47	·			48				
EXISTING CIRCUIT - EXTERIOR LIGHTING (A5)	300			20	49	+	_	+-	50	20		300	
EXISTING CIRCUIT - POLE (A7)		300		15	51	+		+-	52	15			•
SPACE					53		_	┢	54				
EXISTING CIRCUIT - POLE (A4)	300			20	55	-	-	+		200/			
EXISTING CIRCUIT - POLE (A6)		300		20	57	+	- <b>(</b>	<b>_</b>	58		3/0	· . ·	
SPACE	-				59			<b>.</b>	60	/ 3			

PWGSC B1

TOTAL LOAD \_\_\_\_\_\_\_ KW \_\_\_\_\_\_ AMP DEPARTMENTAL REPRESENTATIVE.

	EXISTING PANEL RELOCATED TO NEW SHED		kan dir Vitif										C O	ONTRACTOR TO CLEARLY INDICATE WITH LAMICOID LABE
	PHASE		ON _	ÉLÉC	TRÌC	ALÌ						M	OUNTIN	RATED_200_ AMPS NG <u>SURFACE</u> ATCIRCUITS_42
	DESIGNATION	WAT Ø A	TAGE Ø B	WIREBK	R C	ст	AI	BC	cc	BKR	WIRE	WAT	TAGE Ø B	DESIGNATION
**   **	PEDESTAL #1 PEDESTAL #2	1260	1260		5	1 3	1	H	- <u>2</u> - 4			1400		
· ·[	SPACE	· ·	1200			5 5	-	F	- 6	/3			1400	WINCH
-	PEDESTAL #3 PEDESTAL #4	1260	1260	1		7 9			- <u>8</u> - 10	<u>30</u> 30		2520		PEDESTAL #5 PEDESTAL #5
	SPACE					11	_	$\square$	- 12			<u> </u>	2020	SPACE
<b>k</b> ∦[	PEDESTAL #1	2520		3	0 1		_	L	- 14			1260		PEDESTAL #5
≪{[	PEDESTAL #1		2520						- 16		<u> </u>	1200		SPARE
Ī	SPACE					7	_		- 18					SPACE
≪[	PEDESTAL #1	2520		3				Ш	- 20		1 .			SPARE
≪[	PEDESTAL #2		2520			21			- 22		<u> </u>			SPARE
. [	SPACE	·				23		i d	- 24					SPACE
*[	PEDESTAL #2	2520		30		25	-	Ŀ	- 26	_	<u> </u>	<u> </u>		SPARE
∺*[	PEDESTAL #2	-	2520	30	0 2	_		┝──┼	- 28	30	<u> </u>	<u> </u>	· · · · ·	SPARE
Ĺ	SPACE					29		┝──╋	- 30				· · ·	SPACE
*[	PEDESTAL #3	2520		30	5 3	31	-	<u> </u>	- 32	30	†		· · · · · ·	SPARE
*[	PEDESTAL #3		2520	30			+	┝──┼	- 34			1	2520	PEDESTAL #4
· . [	SPACE					5	+	·	- 36		· ·			SPACE
	PEDESTAL #3	2520		.30				-+	- 38	30		2520		PEDESTAL #4
*[	WINCH RECEPTACLE		120	15		9	+-	┝──┼	- 40	_			2520	PEDESTAL #4
ť [	SPACE					11			- 42			×.		SPACE
						RE	MOVE CK T	D A TO S	E ON AND R SOURC	EPLACE. CIF	CED. RCUIT	REMOV BREA	E WIRI KERS I	TO BE REMOVED FROM THE ELECTRICAL PEDESTALS NG AND CONDUIT AS REQUIRED FOR THESE CIRCUITS FOR THESE CIRCUITS TO REMAIN AS SPARES.
· [·	TOTAL LOAD <u>40.46</u> KW <u>98</u> AM	<b>P</b>				, :	**		REROL	ATES JTE A	EXIST ND E	ING CI XTEND	RCUIT WIRIN	REROUTED & RELOCATED FROM EXISTING SHED. G AND CONDUIT AS REQUIRED. COORDINATE ON SITE.

### CONTRACTOR TO CLEARLY INDICATE WITH LAMICOID LABEL ON FRONT OF PANEL THAT THIS PANEL HAS A WILD LEG.

T OF PANEL THAT THIS PANEL HAS A WILD LEG.	1. 
00 AMPS FACE CIRCUITS 60	
DESIGNATION	
TAL #1 (RECEPT. #1)	
TAL #1 (RECEPT. #2) TAL #1 (RECEPT. #3)	
TAL #1 (RECEPT. #4) TAL #2 (RECEPT. #1)	· · · ·
TAL #2 (RECEPT. #2) TAL #2 (RECEPT. #3)	
TAL #2 (RECEPT. #4)	
TAL #1 (RECEPT. #5) TAL #2 (RECEPT. #5)	
OR LIGHTING CONTROL PANEL	
	<b>k</b> >
IG CIRCUIT – POLE (A22) IG CIRCUIT – POLE (A24)	k≯ k≯
	1 <b>1</b>
ATED PANEL "B"	

\*\* - INDICATES EXISTING CIRCUIT RELOCATED FROM EXISTING PANEL 'A'. REROUTE AND EXTEND WIRING AND CONDUIT AS REQUIRED. COORDINATE ON SITE. COORDINATE ON SITE EXACT CIRCUITS TO BE RELOCATED WITH


가는 영국 소문을 통

1975 - C. 2005 A


\*\* \*\* |\*\* i **\*\*** 

\*\*


TRENCHING NOTES:

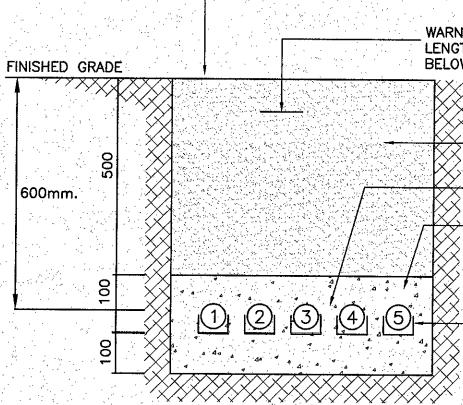


SYMBOL	
	2 #10 RWU90 + CONDUIT (LIGHT P
2	2 #10 RWU90 + CONDUIT (LIGHT P
3	2 #10 RWU90 + CONDUIT (LIGHT P
4	5 #6 RW90 + 6 PVC CONDUIT (PED
5	2 #8 RW90 + 6 IN 53mm RIGID PV

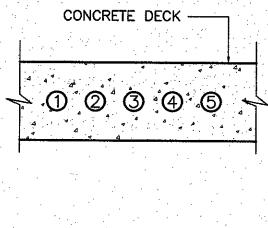

		CLARIT. SE
-  		
	SYMBOL	UNDERGROUND WIRE AND CONDUIT SIZE
	1	2 #10 RWU90 + 1 #12 TW GROUND IN 27mm RIGID PVC CONDUIT (LIGHT POLE #1)
	2	2 #10 RWU90 + 1 #12 TW GROUND IN 27mm RIGID PVC CONDUIT (LIGHT POLE #2)
	3	2 #10 RWU90 + 1 #12 TW GROUND IN 27mm RIGID PVC CONDUIT (LIGHT POLE #3)
	4	5 #6 RW90 + 6 #4 RW90 + 1 #4 TW GROUND IN 53mm PVC CONDUIT (PEDESTAL #2)
	5	2 #8 RW90 + 6 #6 RW90 + 3 #4 RW90 + 1 #4 TW GRO IN 53mm RIGID PVC CONDUIT (PEDESTAL #1)

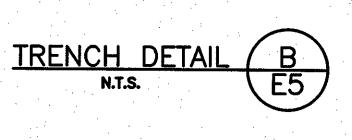

\_\_\_\_\_ RIGID ROUND

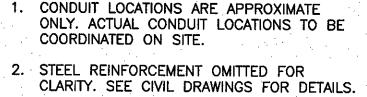

NOTES: 1. CONDUIT LOCATIONS ARE APPROXIMATE ONLY. ACTUAL CONDUIT LOCATIONS TO BE COORDINATED ON SITE.



RGROUND WIRE AND CONDUIT SIZE
#12 TW GROUND IN 27mm RIGID PVC LE #1)
#12 TW GROUND IN 27mm RIGID PVC LE #2)
#12 TW GROUND IN 27mm RIGID PVC _E #3)
4 RW90 + 1 #4 TW GROUND IN 53mm RIGID STAL #2)
6 RW90 + 3 #4 RW90 + 1 #4 TW GROUND CONDUIT (PEDESTAL #1)

LENGTH OF TRENCH 200mm BELOW SURFACE. XX------ UNDISTURBED SOIL

SELECTED BACKFILL

PROVIDE 100mm

CONCRETE COVERAGE ALL AROUND CONDUITS.

PROVIDE MONOBLOCK DUCT

SPACERS AS REQUIRED.

-53mm SPACING BETWEEN CONDUITS.

FOR DETAILS. WARNING TAPE, RUN ENTIRE

FINISHED GRADE TO MATCH EXISTING. SEE CIVIL DRAWINGS

5. ALL DUCTS AND FITTINGS MUST BE CSA APPROVED. 6. ALL DUCTS ARE TO BE SECURELY CAPPED AT BOTH ENDS. 7. ALL FITTINGS, COUPLINGS AND ADAPTERS ARE TO BE SOLVENT WELD.

2. THE DUCTS SHALL BE SUPPORTED BY APPROVED SPACERS. NO WIRE OR METAL TIES TO BE USED. 3. COPPER FISH WIRE MINIMUM #8 MUST BE INSTALLED IN ALL DUCTS. 4. ELECTRICAL DUCT MUST BE RIGID PVC OR APPROVED EQUIVALENT.

1. ALL TRENCHES SHALL BE BACKFILLED WITH SELECTED BACKFILL AND TAMPED IN 300mm LAYERS. EXCEPT AT ROAD CROSSINGS WHERE THE BACKFILL SHALL BE THE SAME MATERIAL AS THE ROAD BED AND TAMPED IN 150mm LAYERS. EXCESS FILL SHALL BE PLACED ON TOP TO ALLOW FOR SETTLING.

Fisheries and Oceans Peches et Oceans Canada SMALL CRAFT HARBOURS

NOTES

ISSUED FOR TENDER 0 evisions WHARF #404 RECONSTRUCTION CODROY, NL. drawing PANEL SCHEDULES & DETAILS designed K.NEIL JAN. 2017 drawn B.COLLETT date JAN. 2017 approved Tender Paul Curron DFO Project Manager

project number

drawing no.

704074

