
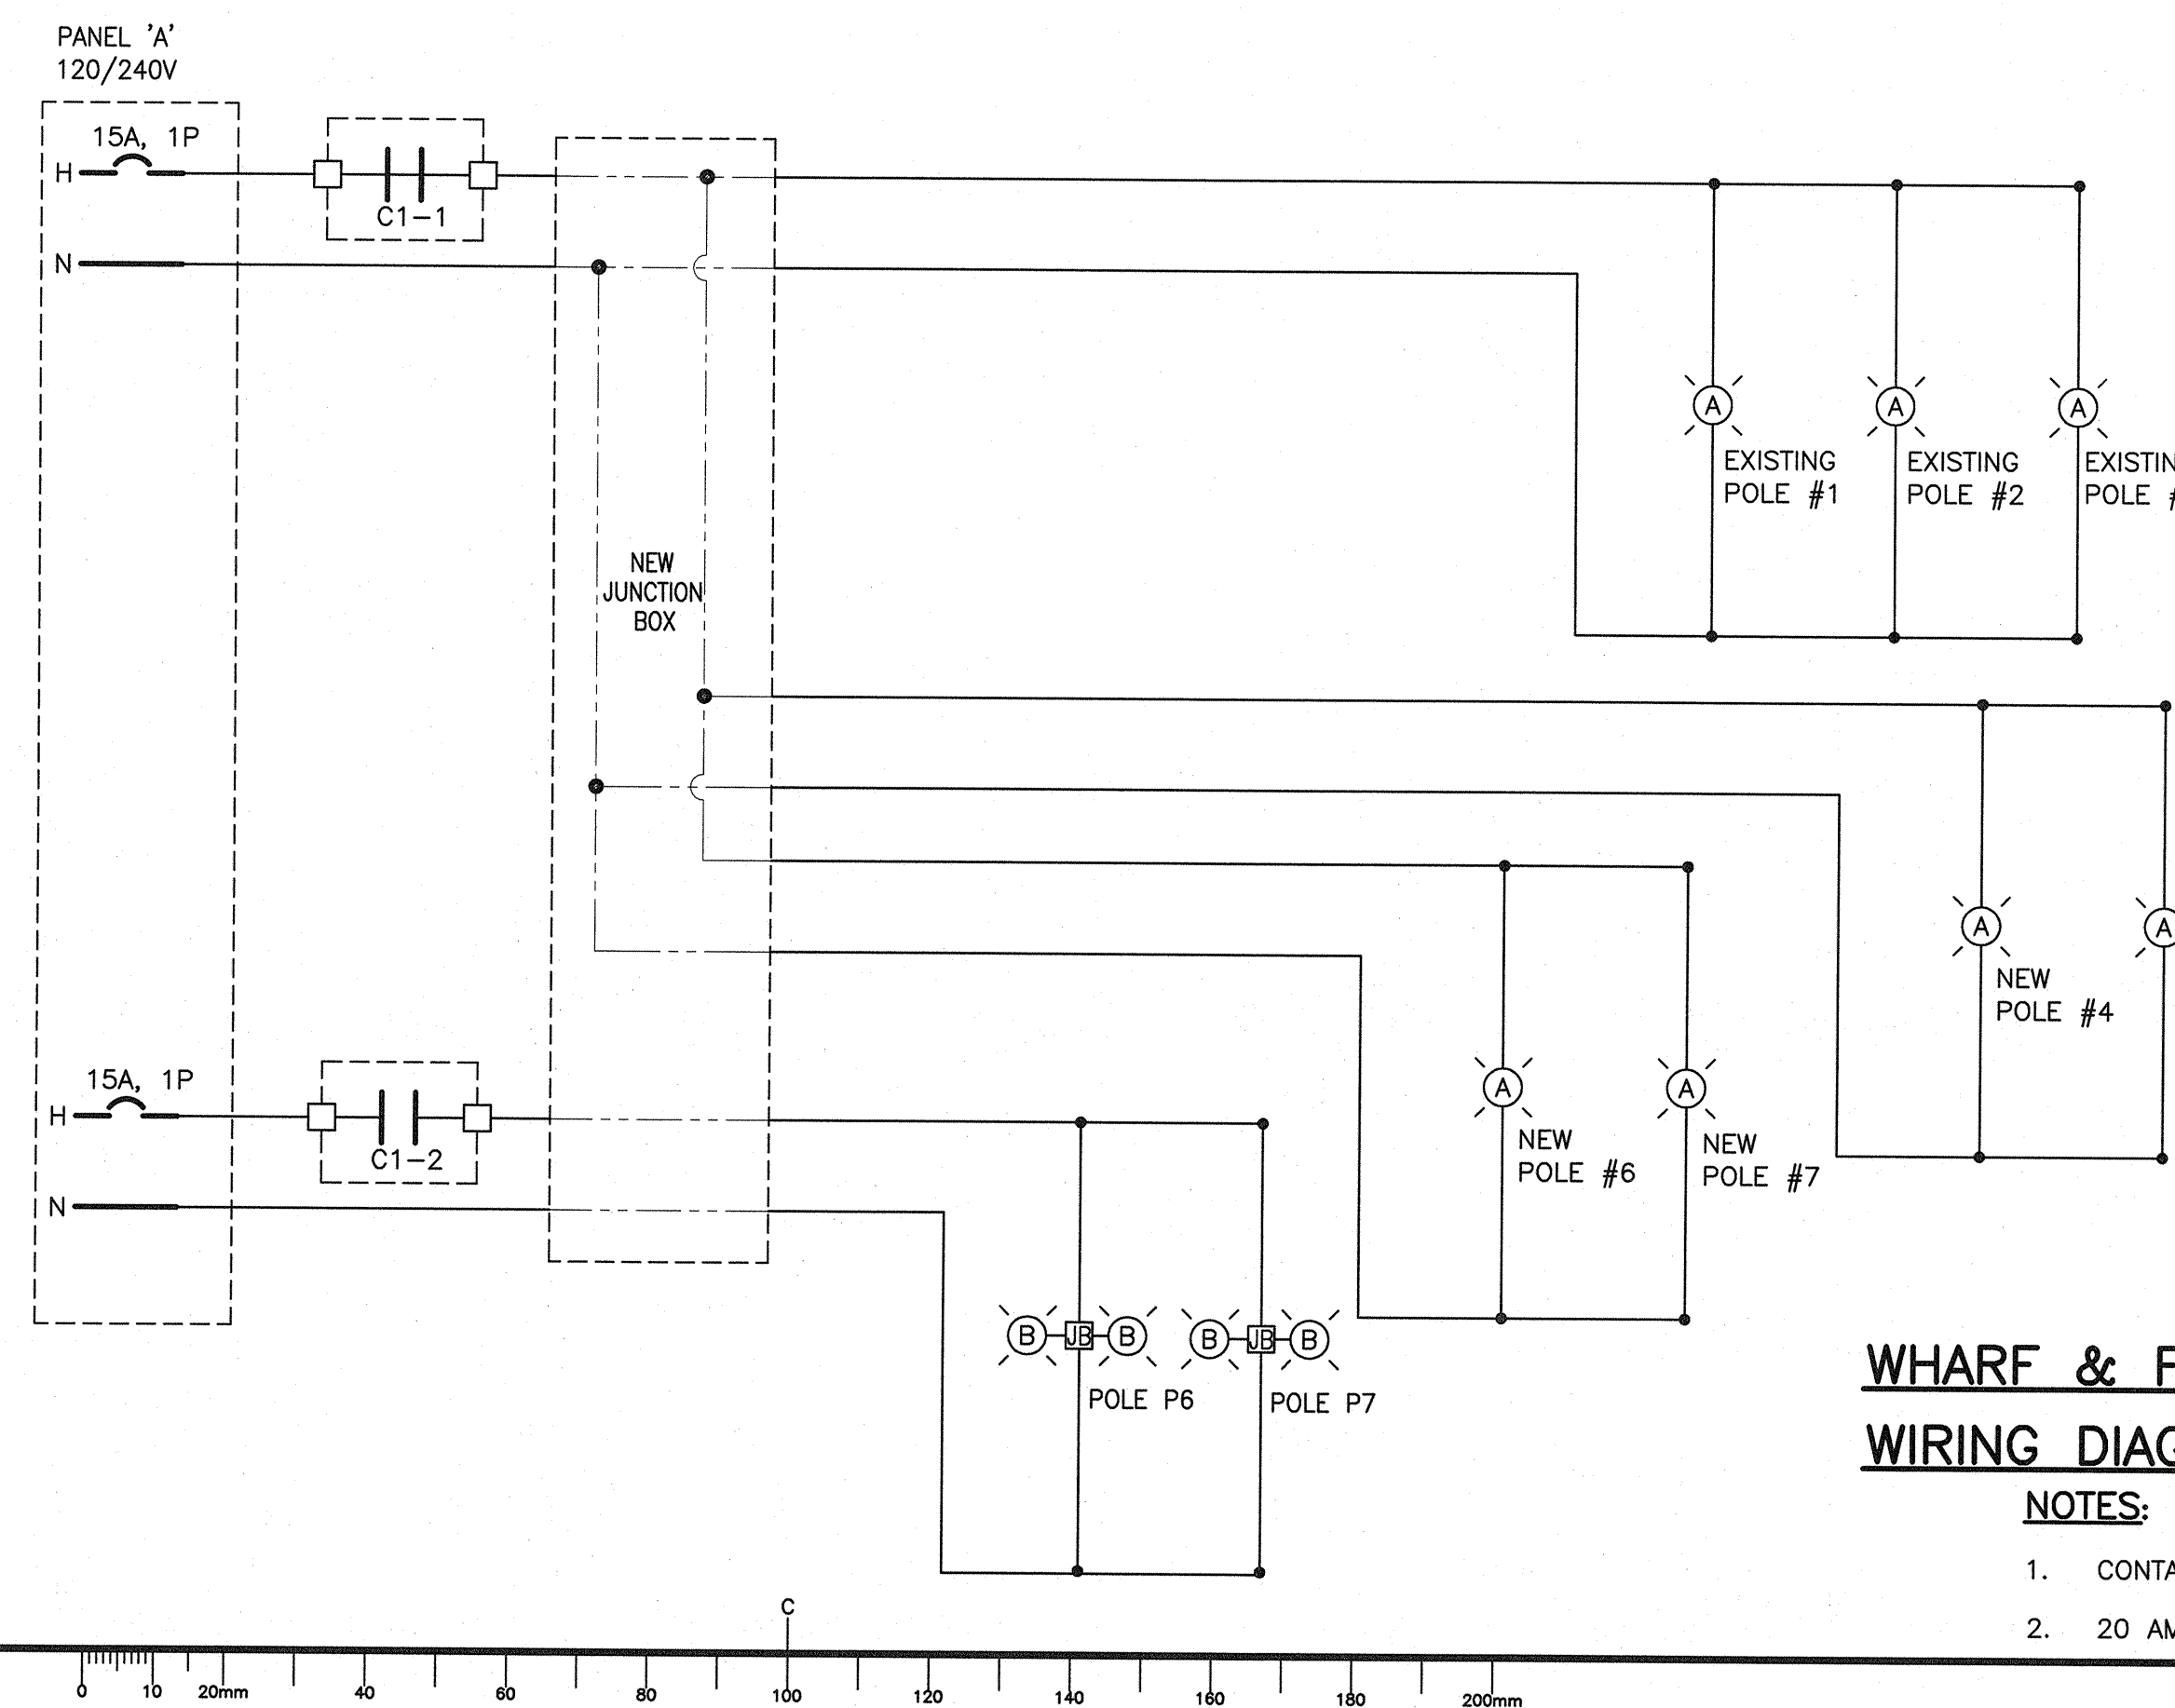


POLE & FIXTURE INSTALLATION DETAIL #1
SCALE: 1:25
0mm 500mm 1000mm 1500mm 2000mm 2500mm

- NOTE:**
1. TYPICAL FOR NEW POLES P4 AND P5.
 2. ALL DIMENSIONS ARE IN MILLIMETERS.


POLE & FIXTURE INSTALLATION DETAIL #2
SCALE: 1:25
0mm 500mm 1000mm 1500mm 2000mm 2500mm

- NOTE:**
1. TYPICAL FOR NEW POLES P6 AND P7.
 2. ALL DIMENSIONS ARE IN MILLIMETERS.
 3. FOR CLARITY PURPOSES ONLY 1 LED FLOOD LIGHT IS SHOWN.

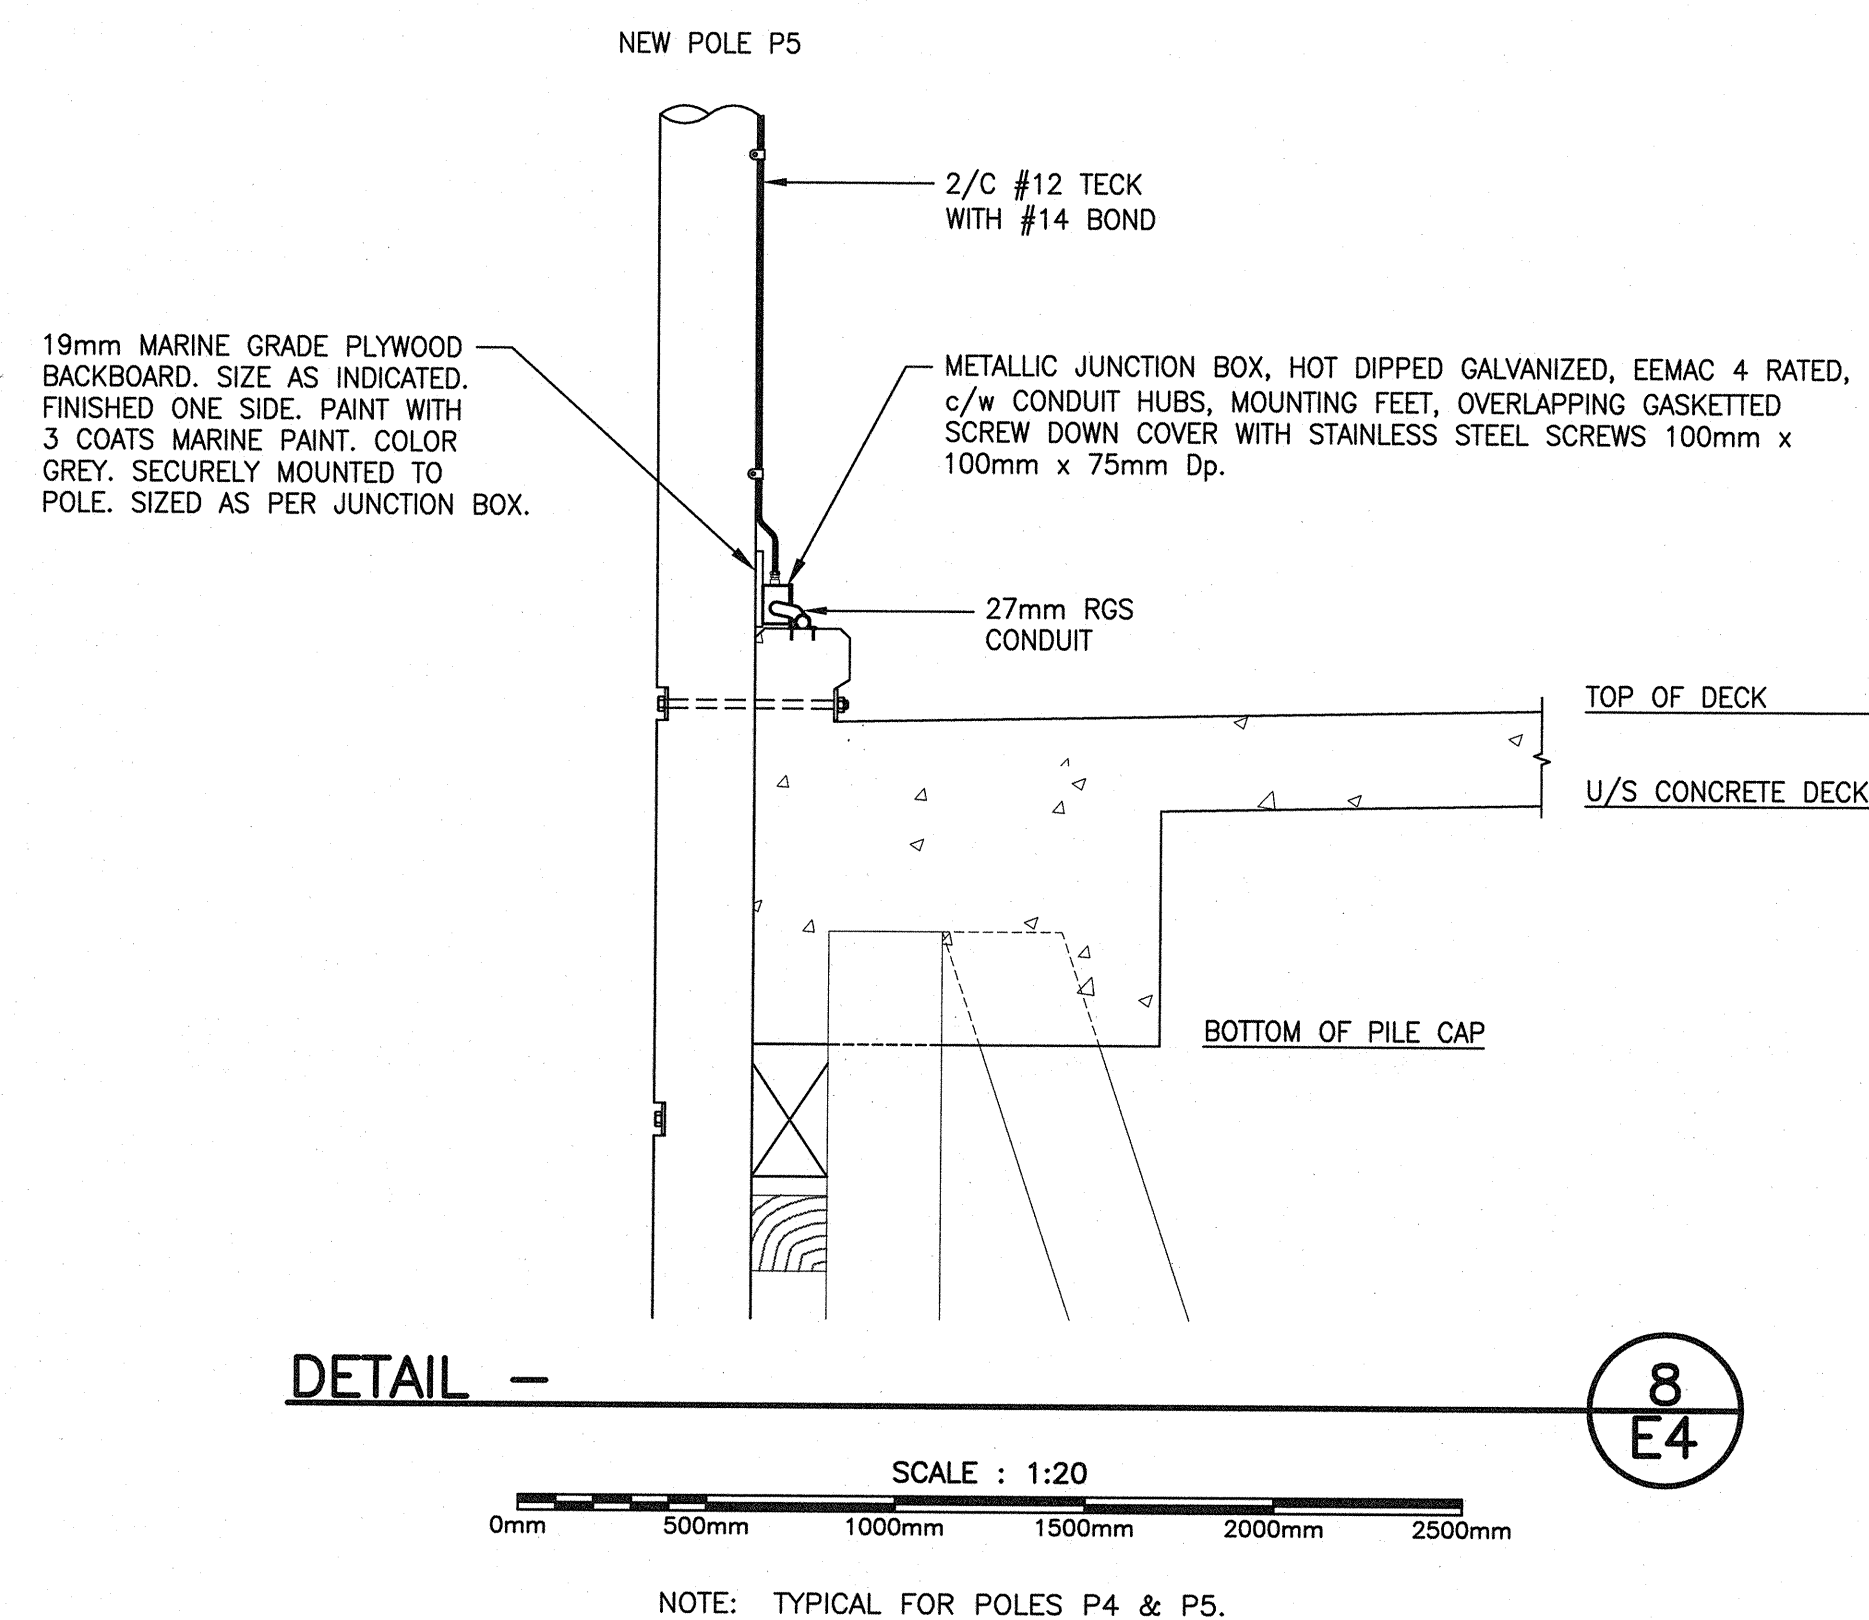


WHARF & FLOATING DOCK LIGHTING WIRING DIAGRAM & CONTROL SCHEMATIC
SCALE: N.T.S.

- NOTES:**
1. CONTACTS RATED FOR 15 AMP, 120V
 2. 20 AMP COIL

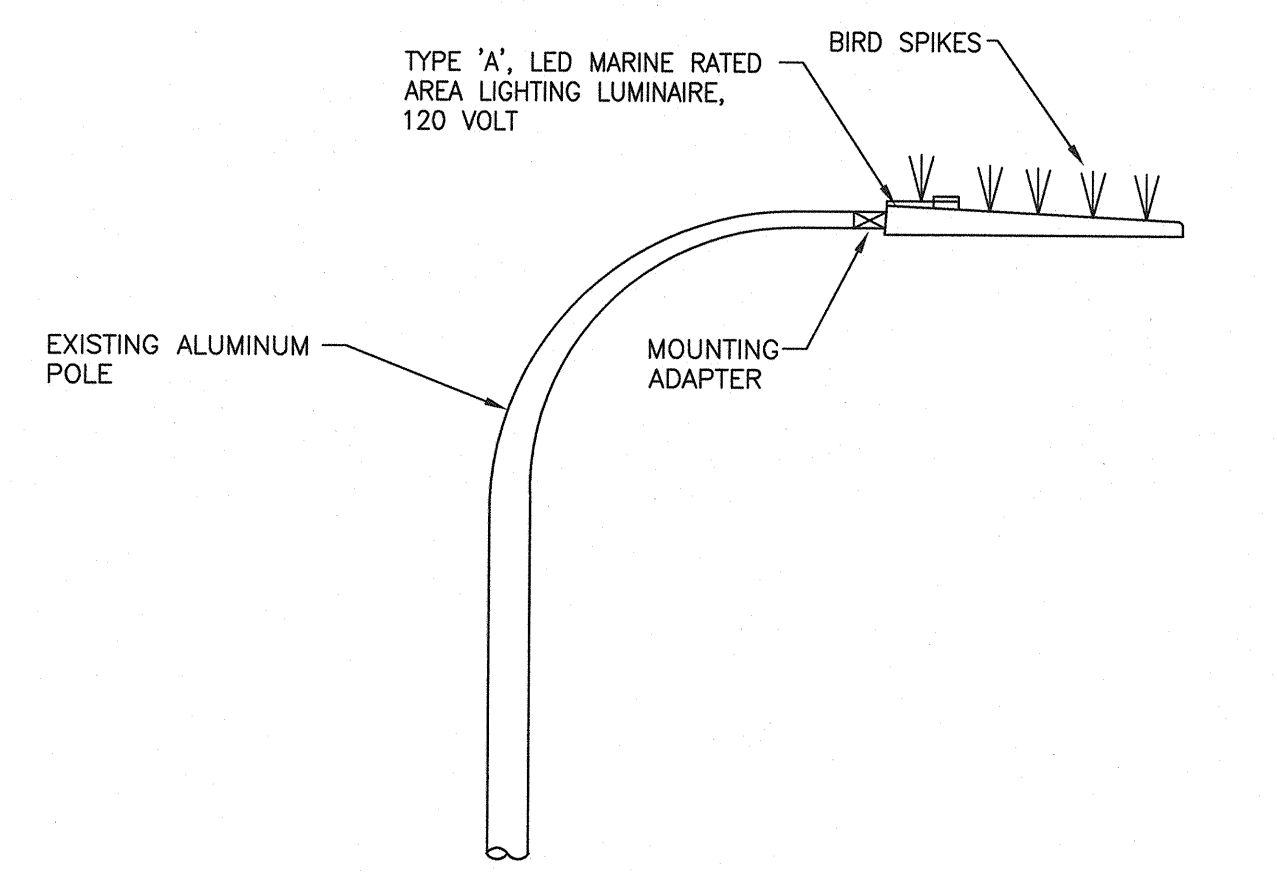


FIXTURE INSTALLATION DETAIL #3
SCALE: 1:20
0mm 500mm 1000mm 1500mm 2000mm 2500mm


- NOTE:**
1. TYPICAL FOR EXISTING POLES P1, P2 AND P3.

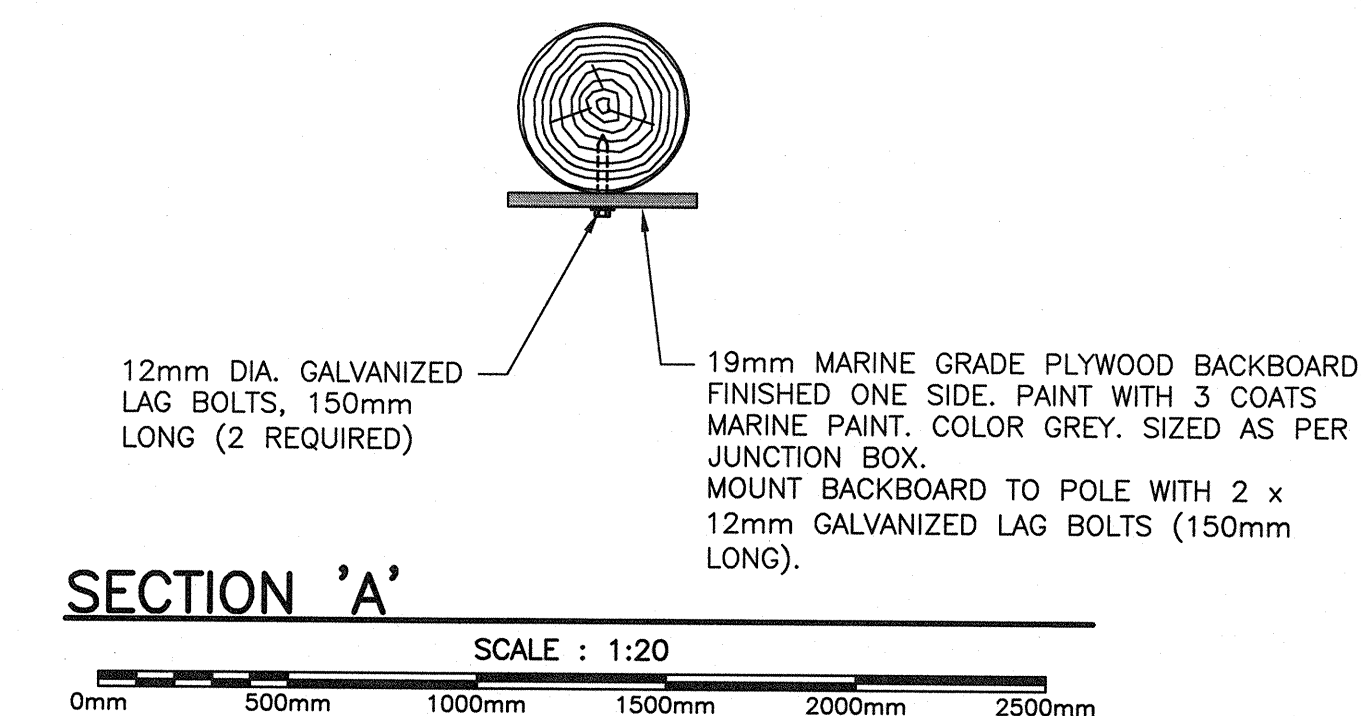


SECTION 'A'
SCALE: 1:20
0mm 500mm 1000mm 1500mm 2000mm 2500mm

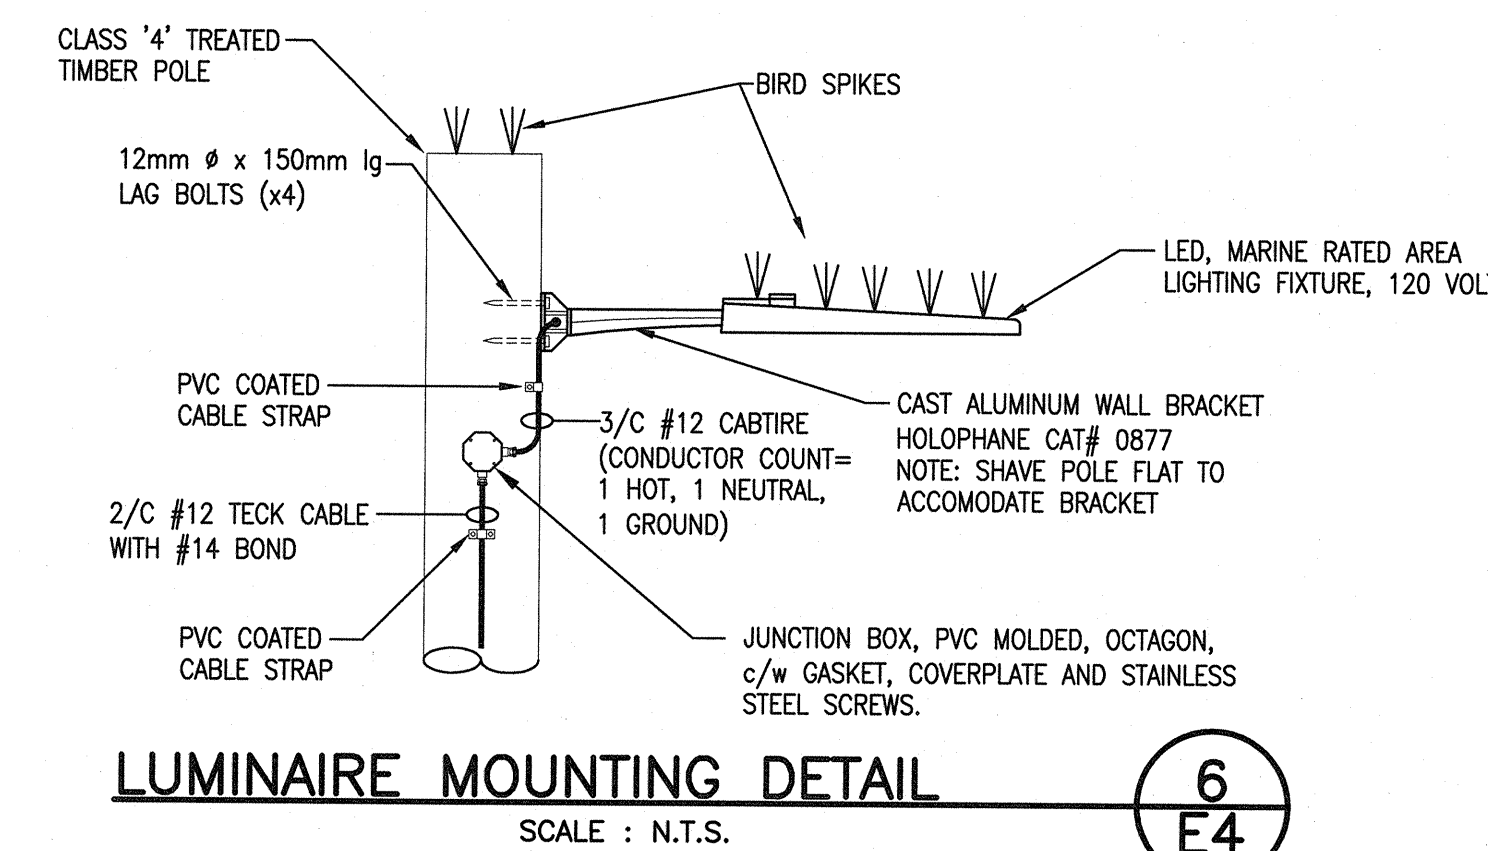


LUMINAIRE MOUNTING DETAIL
SCALE: N.T.S.

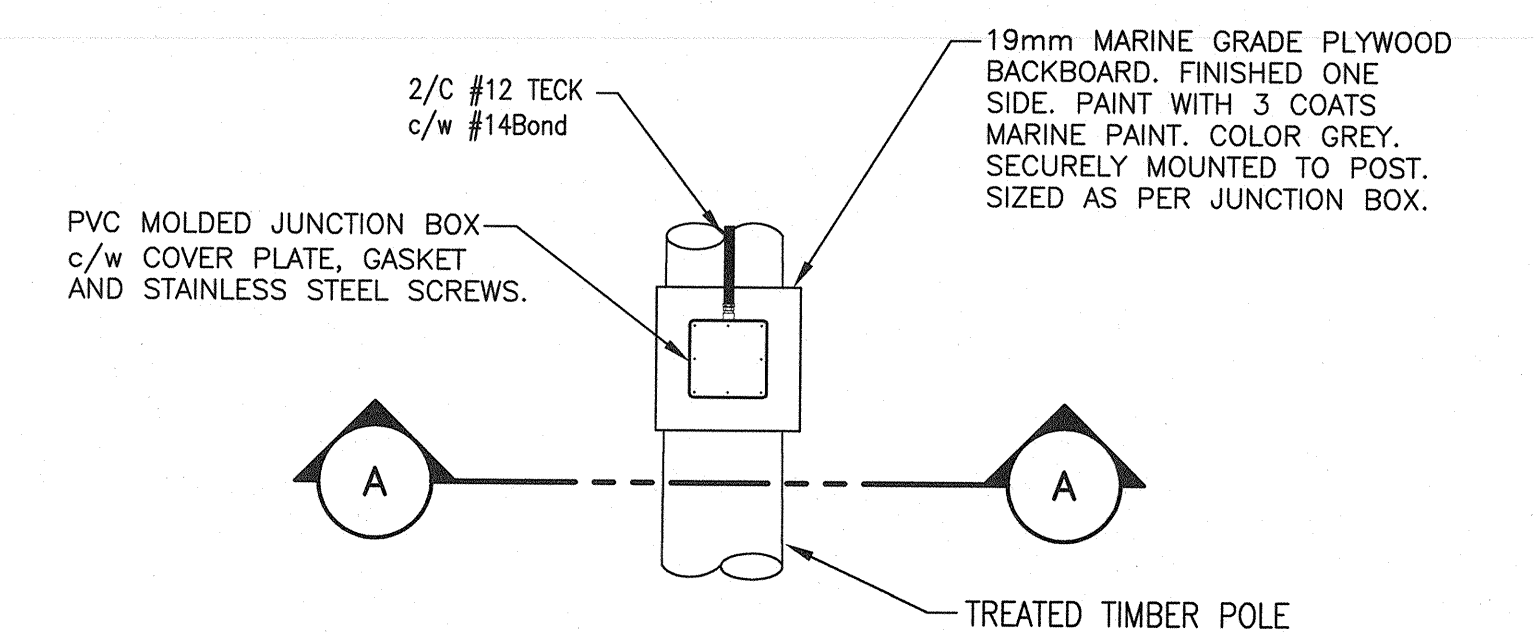

ELEVATION - POLE MOUNTED JUNCTION BOX
SCALE: 1:20
0mm 500mm 1000mm 1500mm 2000mm 2500mm
NOTE: TYPICAL FOR POLES P6 & P7.

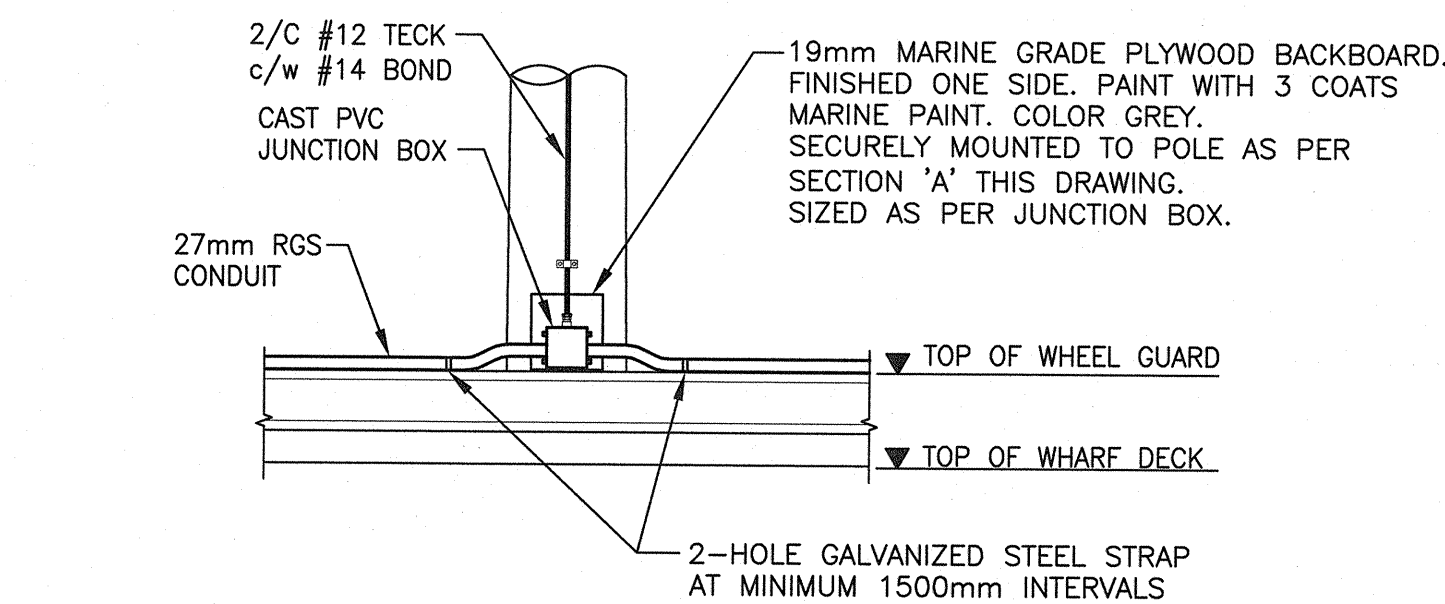

ELEVATION - POLE MOUNTED JUNCTION BOX
SCALE: 1:20
0mm 500mm 1000mm 1500mm 2000mm 2500mm
NOTE: TYPICAL FOR POLES P4 & P5.

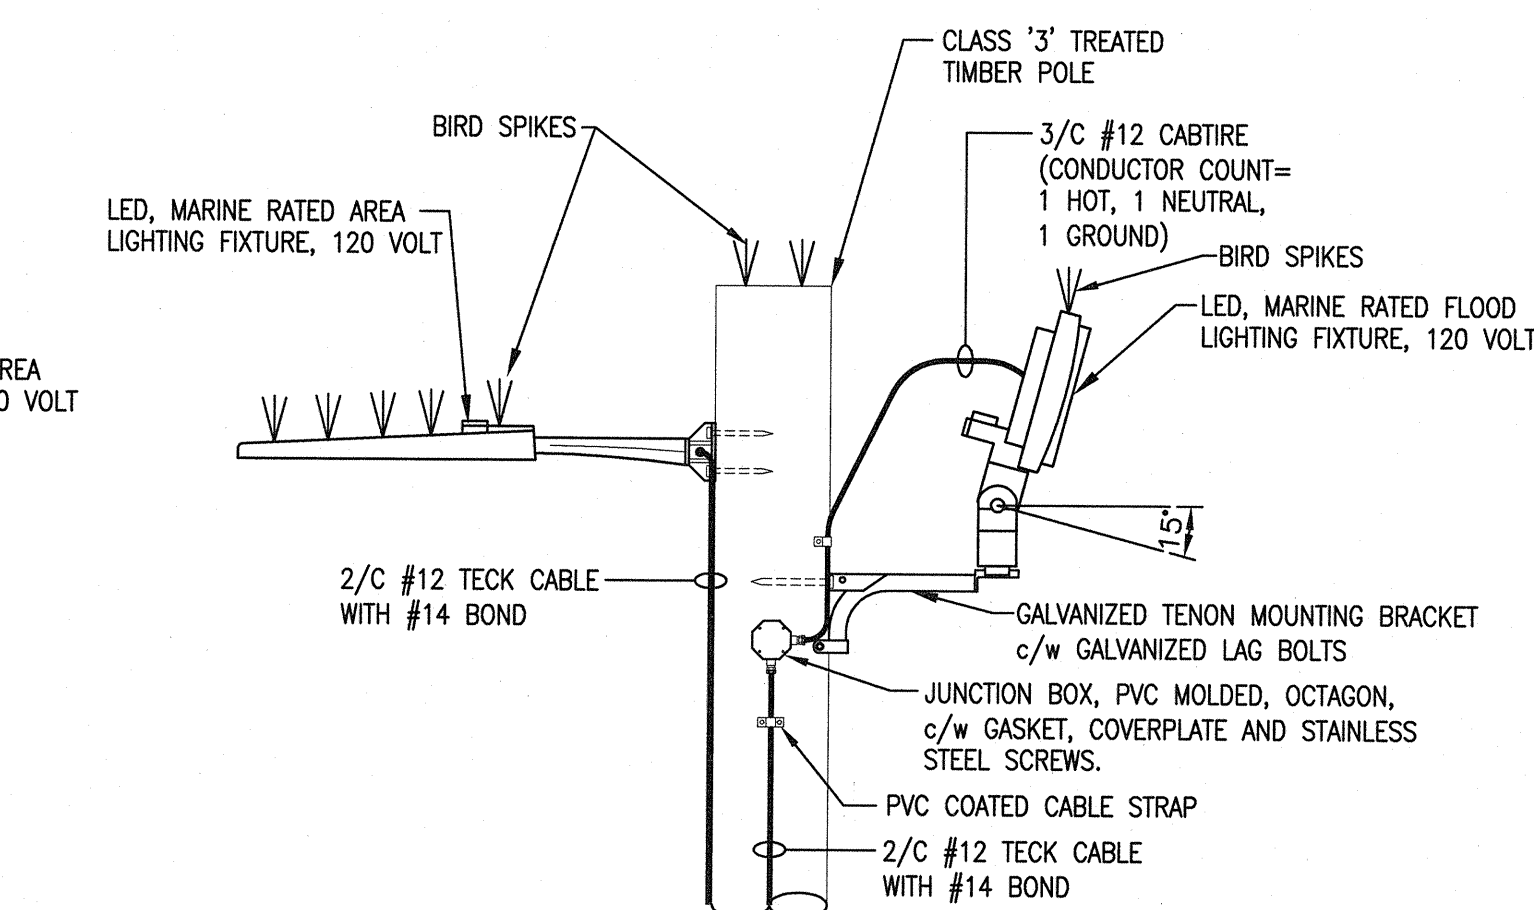


LUMINAIRE MOUNTING DETAIL
SCALE: N.T.S.

- NOTE:** FOR CLARITY PURPOSES ONLY 1 LED FLOOD LIGHT IS SHOWN.

MOUNTING NOTES:

1. ALL TECK CABLE OR METALLIC CONDUIT TERMINATED ON FIBREGLASS OR PVC BOXES SHALL UTILIZE BONDING LOCKNUTS. ALL BONDING LOCKNUTS SHALL BE CONNECTED TO GROUND USING A #14 AWG GREEN INSULATED CONDUCTOR.
2. CONTRACTOR TO SUPPLY AND INSTALL PVC COATED CABLE GLAND FOR ALL CABLE CONNECTIONS.
3. CONTRACTOR TO SUPPLY AND INSTALL PVC COATED TECK CONNECTORS FOR ALL TECK CABLE CONNECTIONS.
4. CONTRACTOR TO SUPPLY AND INSTALL BIRD DETERRENTS (SPIKES) ON ALL POLES AND LIGHT FIXTURES.

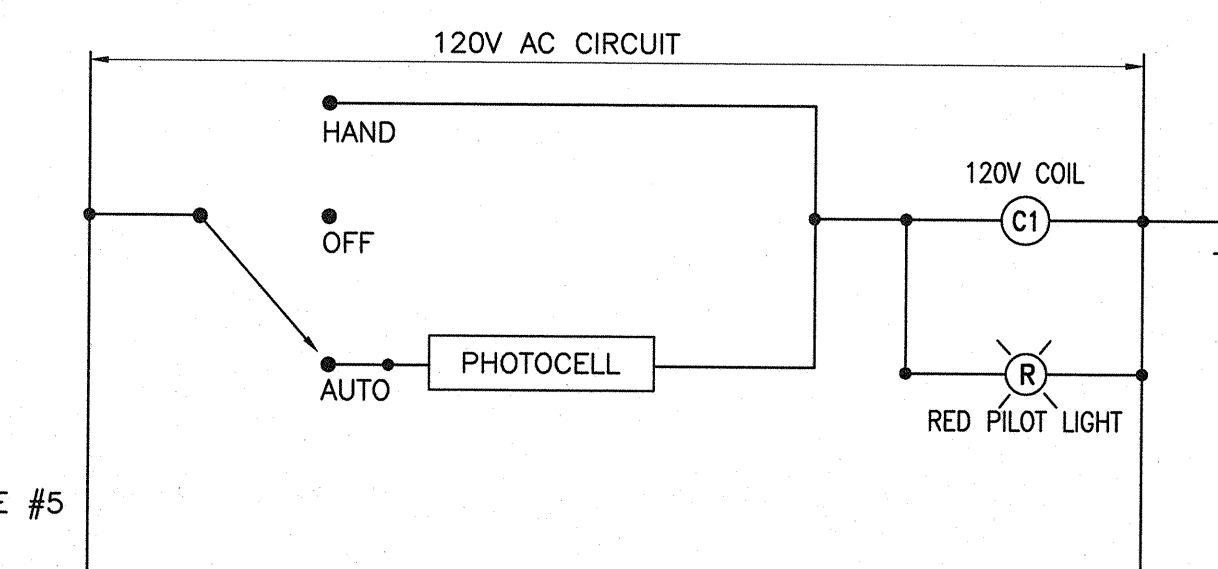

**WHARF EXTENSION
EASTERN PASSAGE
HALIFAX COUNTY
NOVA SCOTIA**

LIGHTING DETAILS

designed	G. BOWSER	conçu
date	MARCH 2017	
drawn	K. WOLFE	dessiné
date	MARCH 2017	
approved		approuvé
date		
Tender		Soumission
PWSC Project Manager	Administrateur de projets TPSCC	
project number	R.082417.001	no. du projet
drawing no.	E4	no. du dessin