




PLAN  
SCALE: 1/4" = 1'-0"

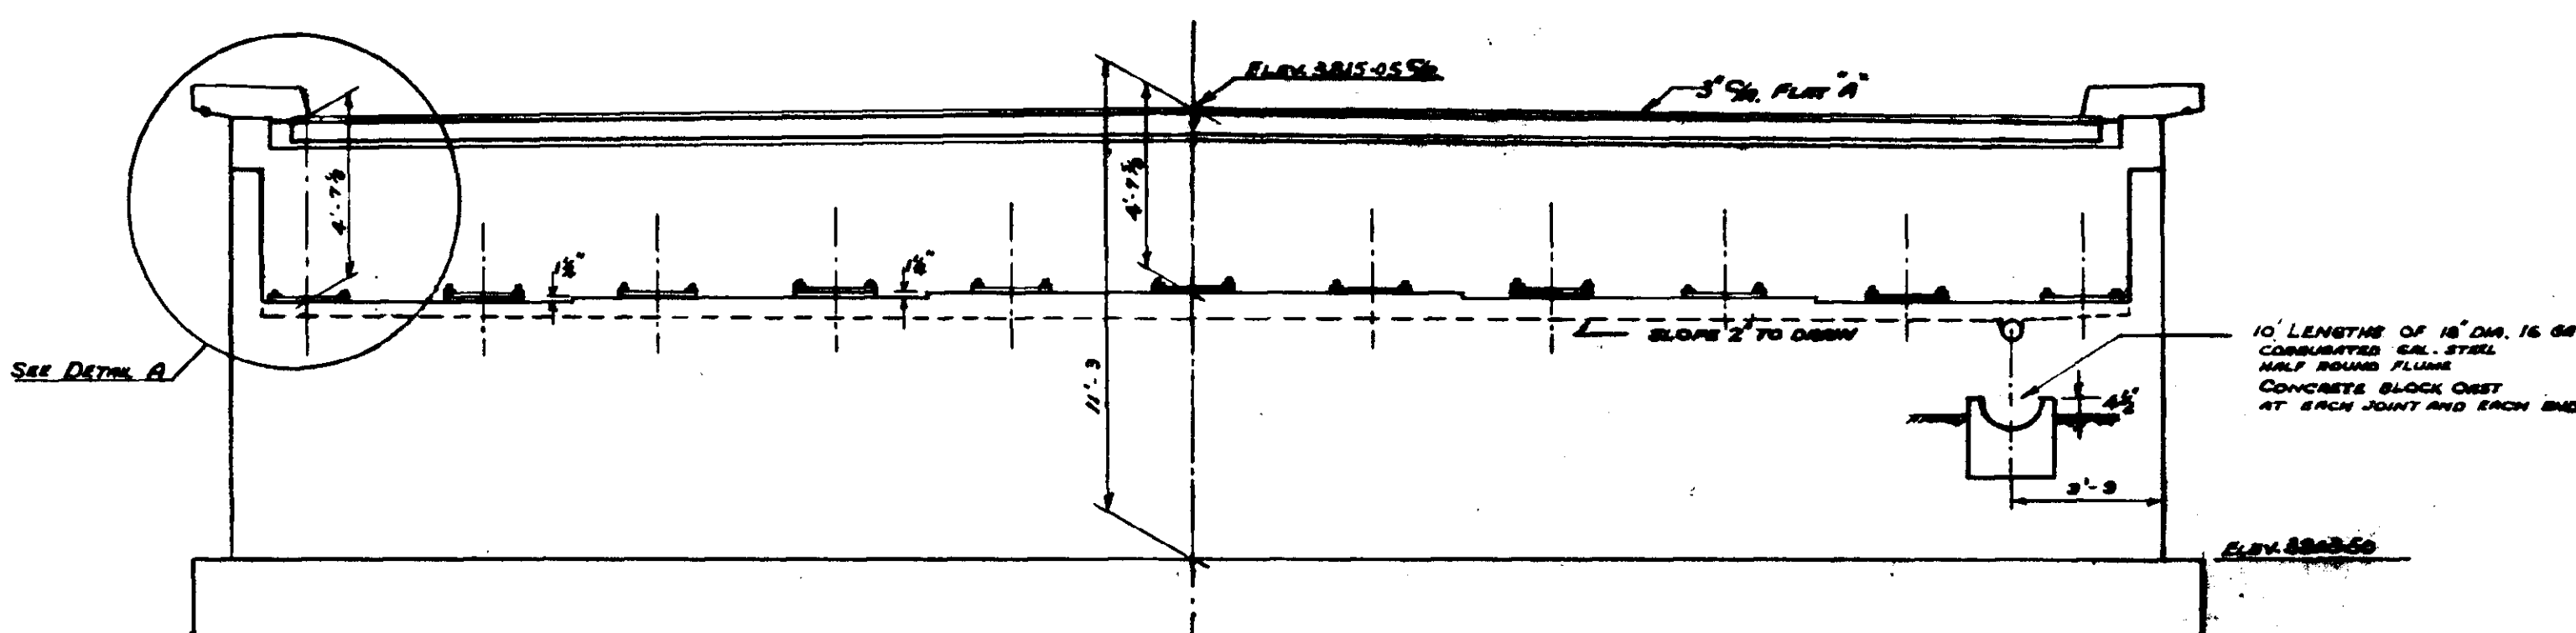


FRONT ELEVATION  
SCALE: 1/4" = 1'-0"

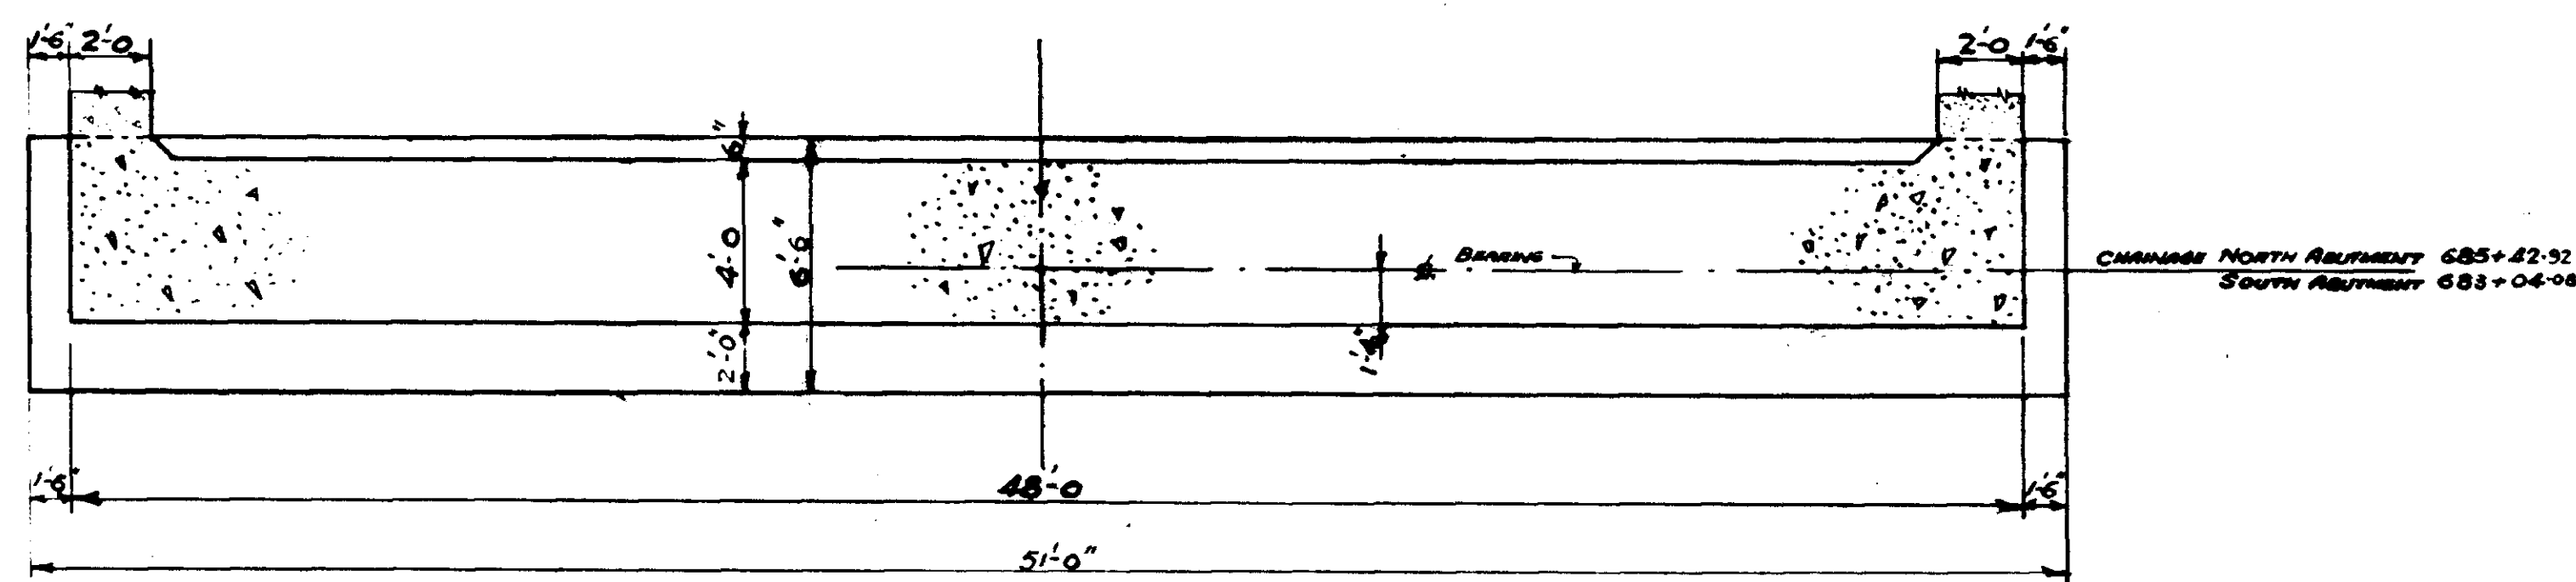


FOUNDATION PLAN  
SCALE: 1/4" = 1'-0"

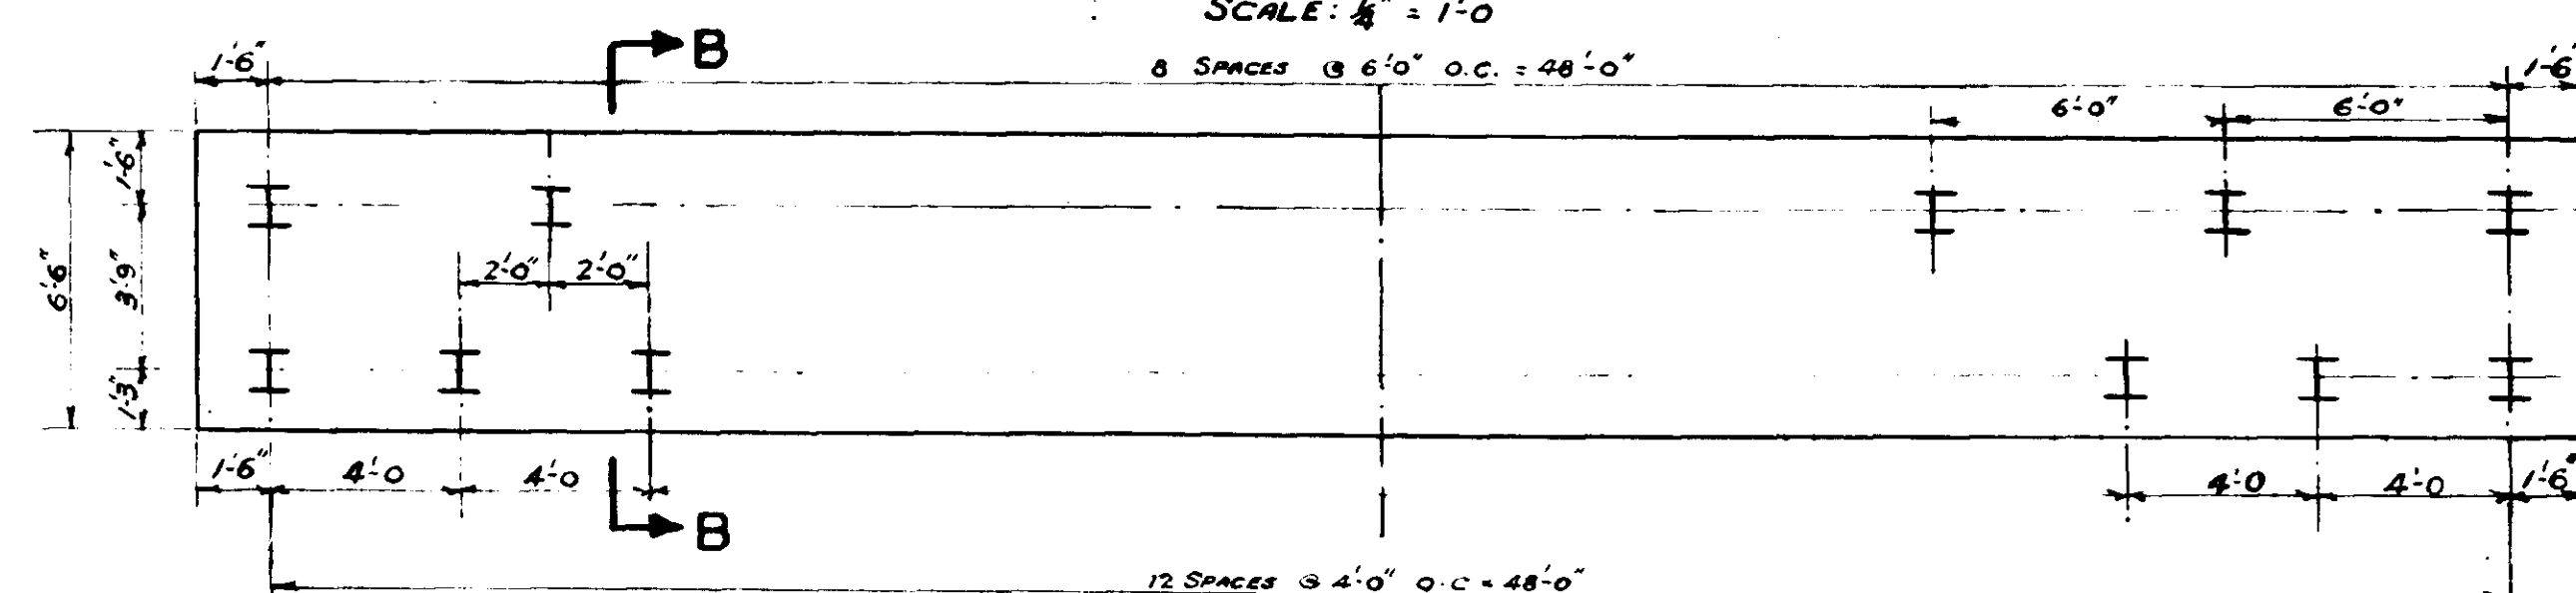


PILES FOUNDATION  
SCALE: 1/4" = 1'-0"

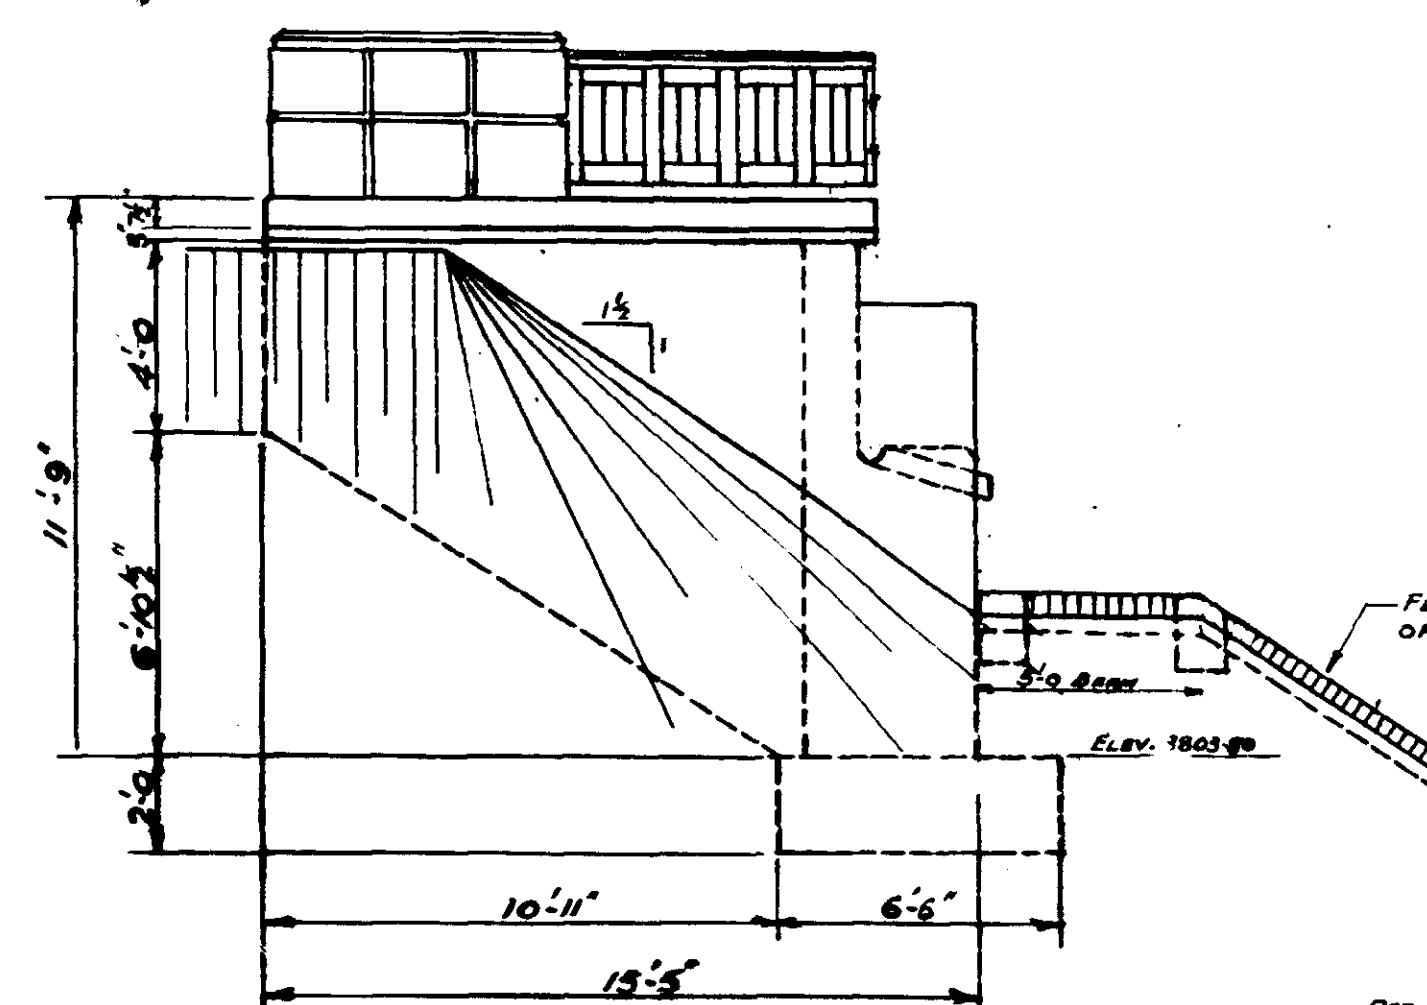


SIDE ELEVATION  
SCALE: 1/4" = 1'-0"

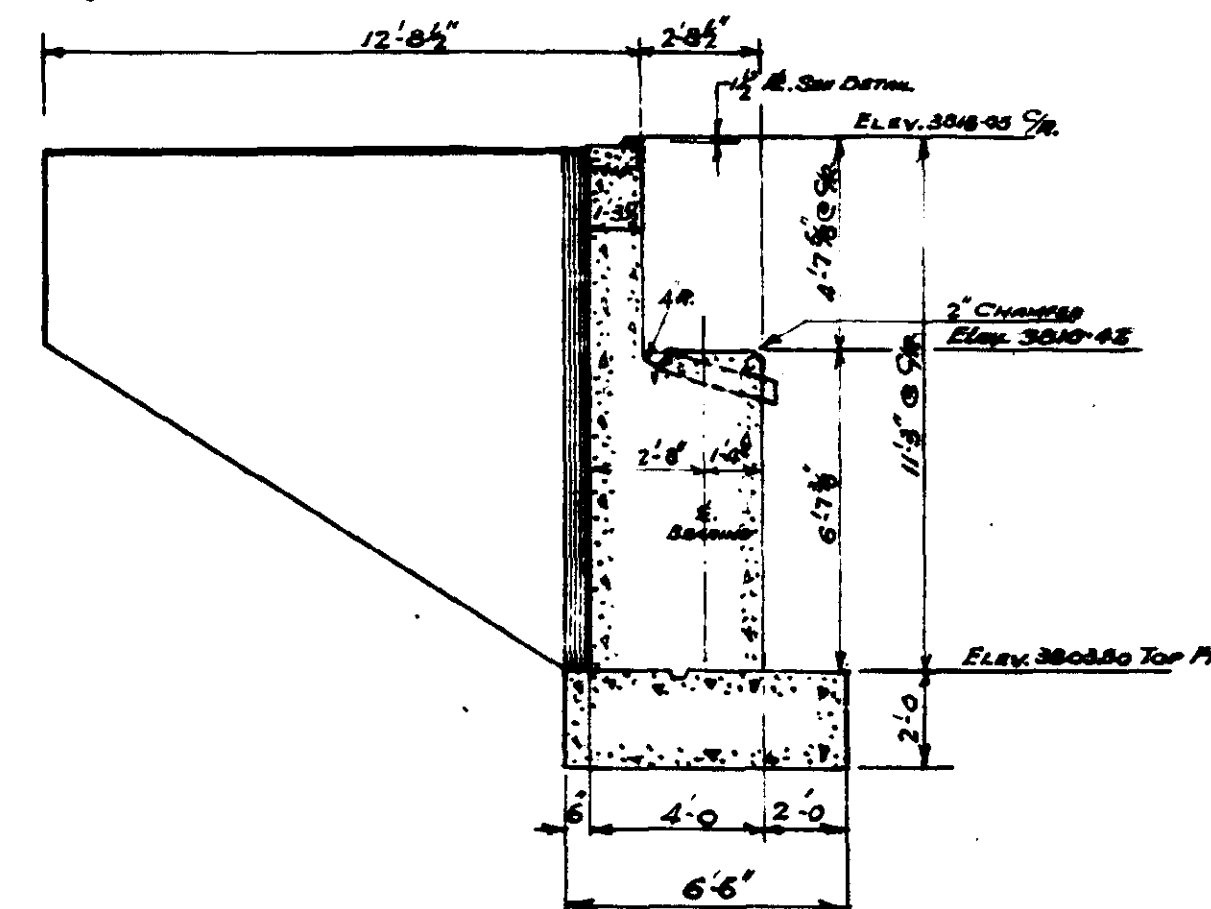


SECTION A-A  
SCALE: 1/4" = 1'-0"

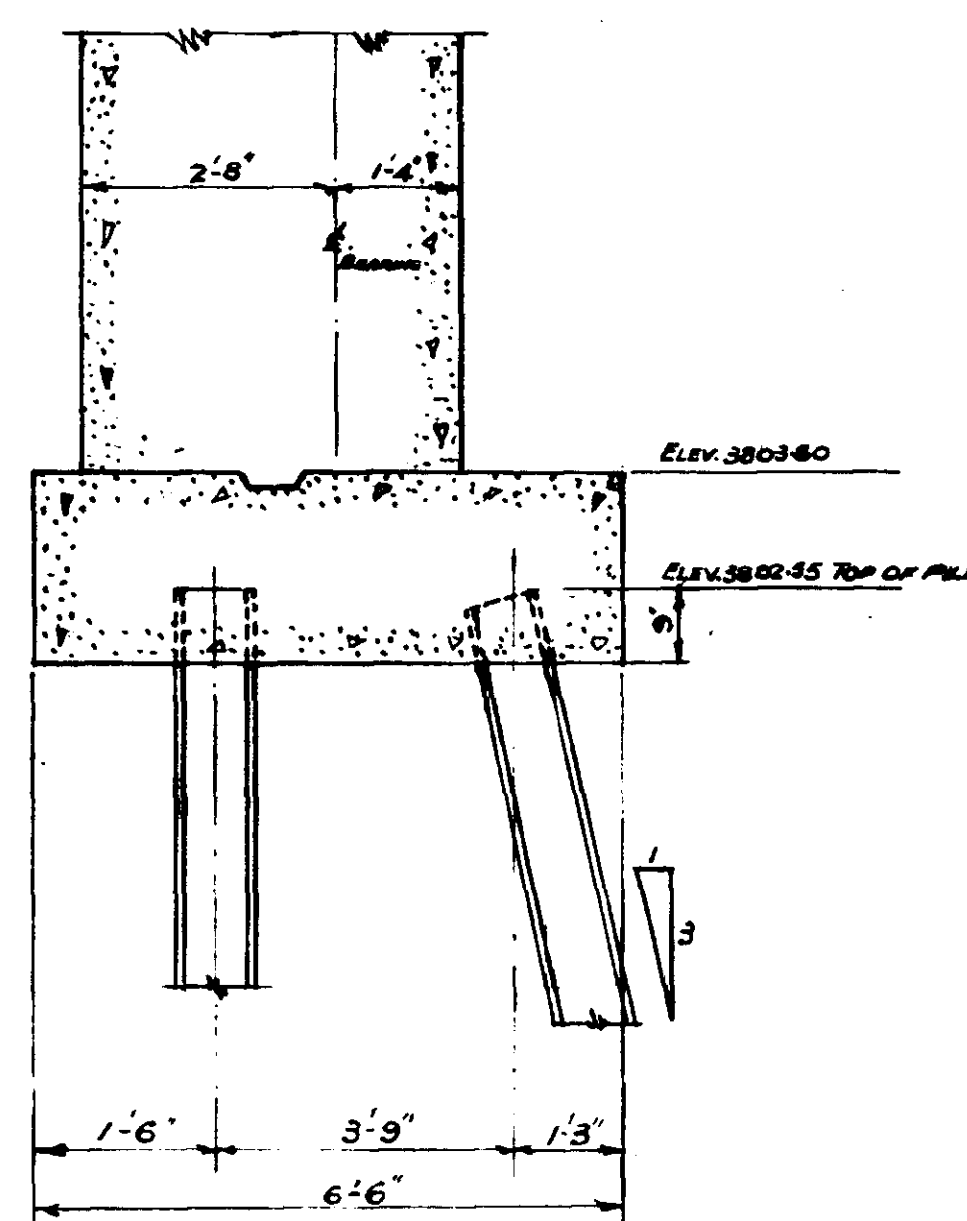

SECTION B-B  
SCALE: 1/4" = 1'-0"

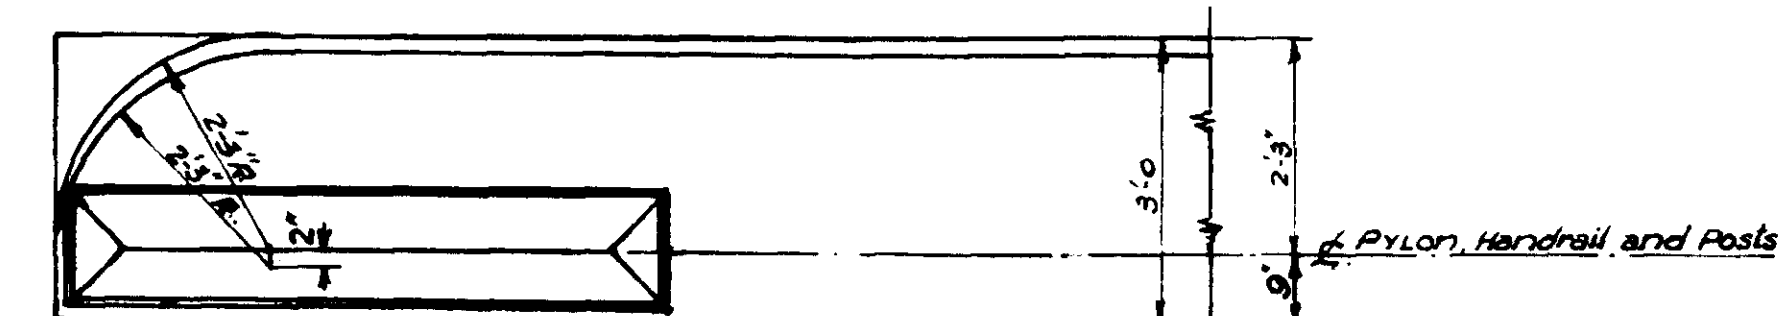


PLAN  
SCALE: 1/2" = 1'-0"

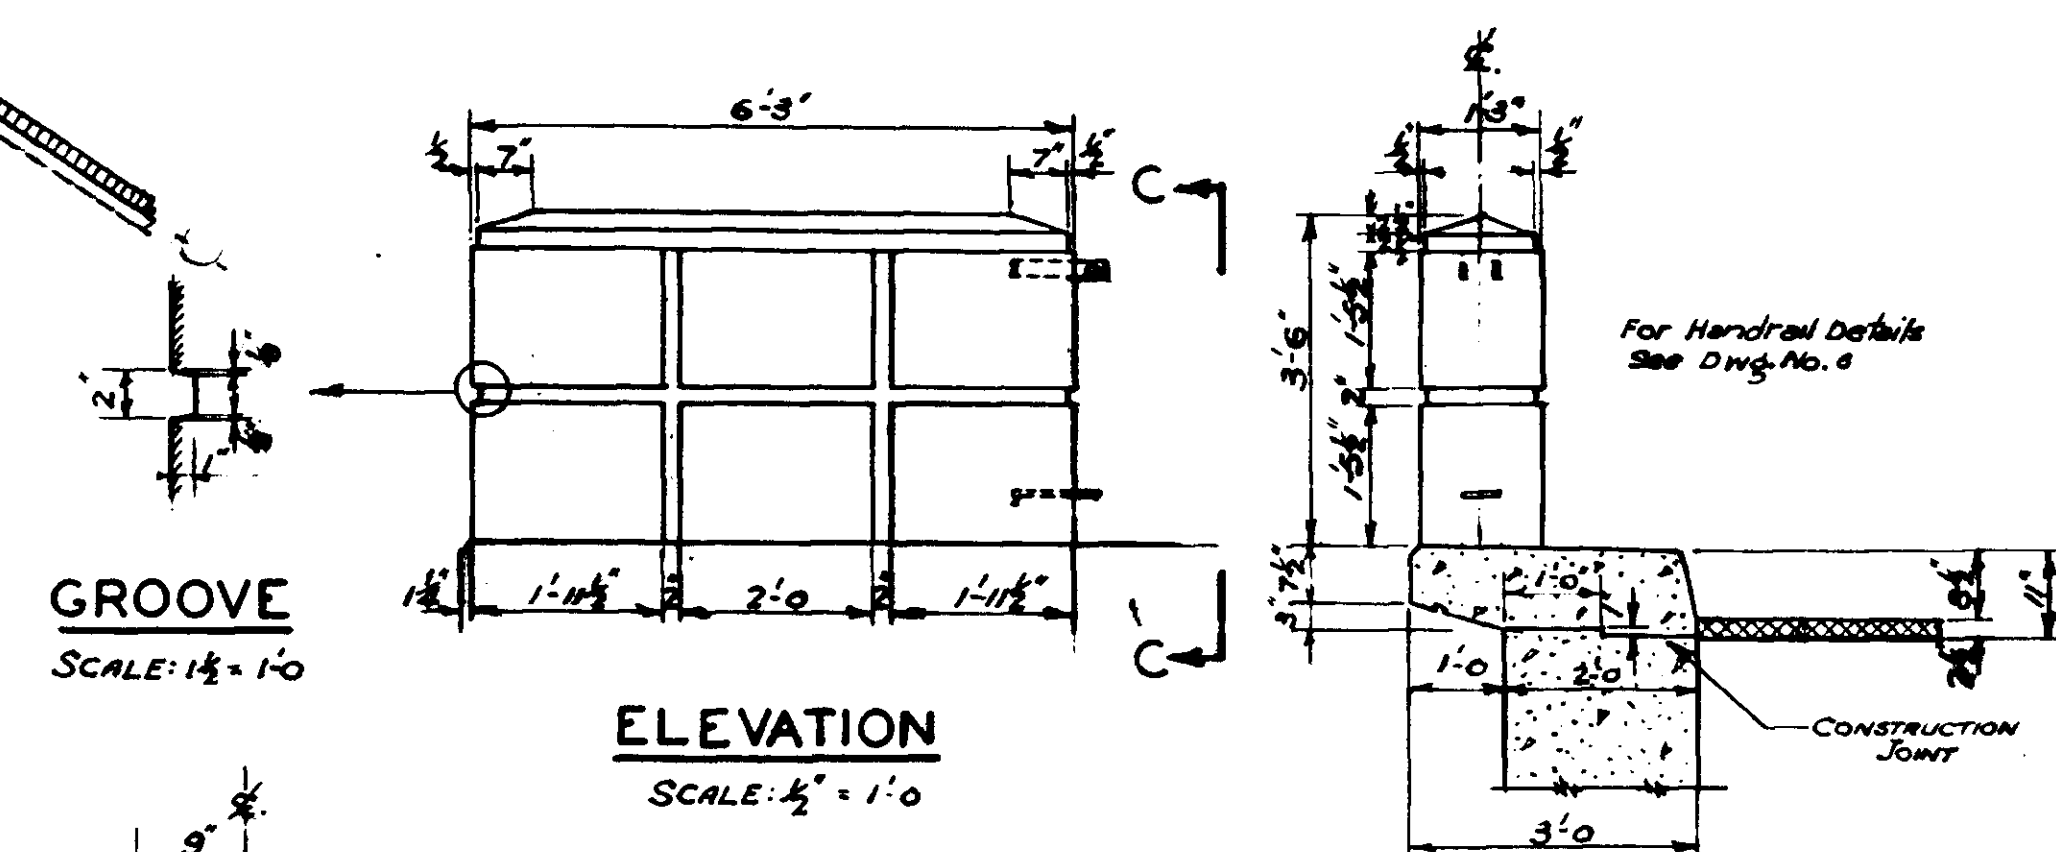

ELEVATION  
SCALE: 1/2" = 1'-0"

GROOVE  
SCALE: 1/2" = 1'-0"

SECTION C-C  
CURB & PYLON  
SCALE: 1/2" = 1'-0"

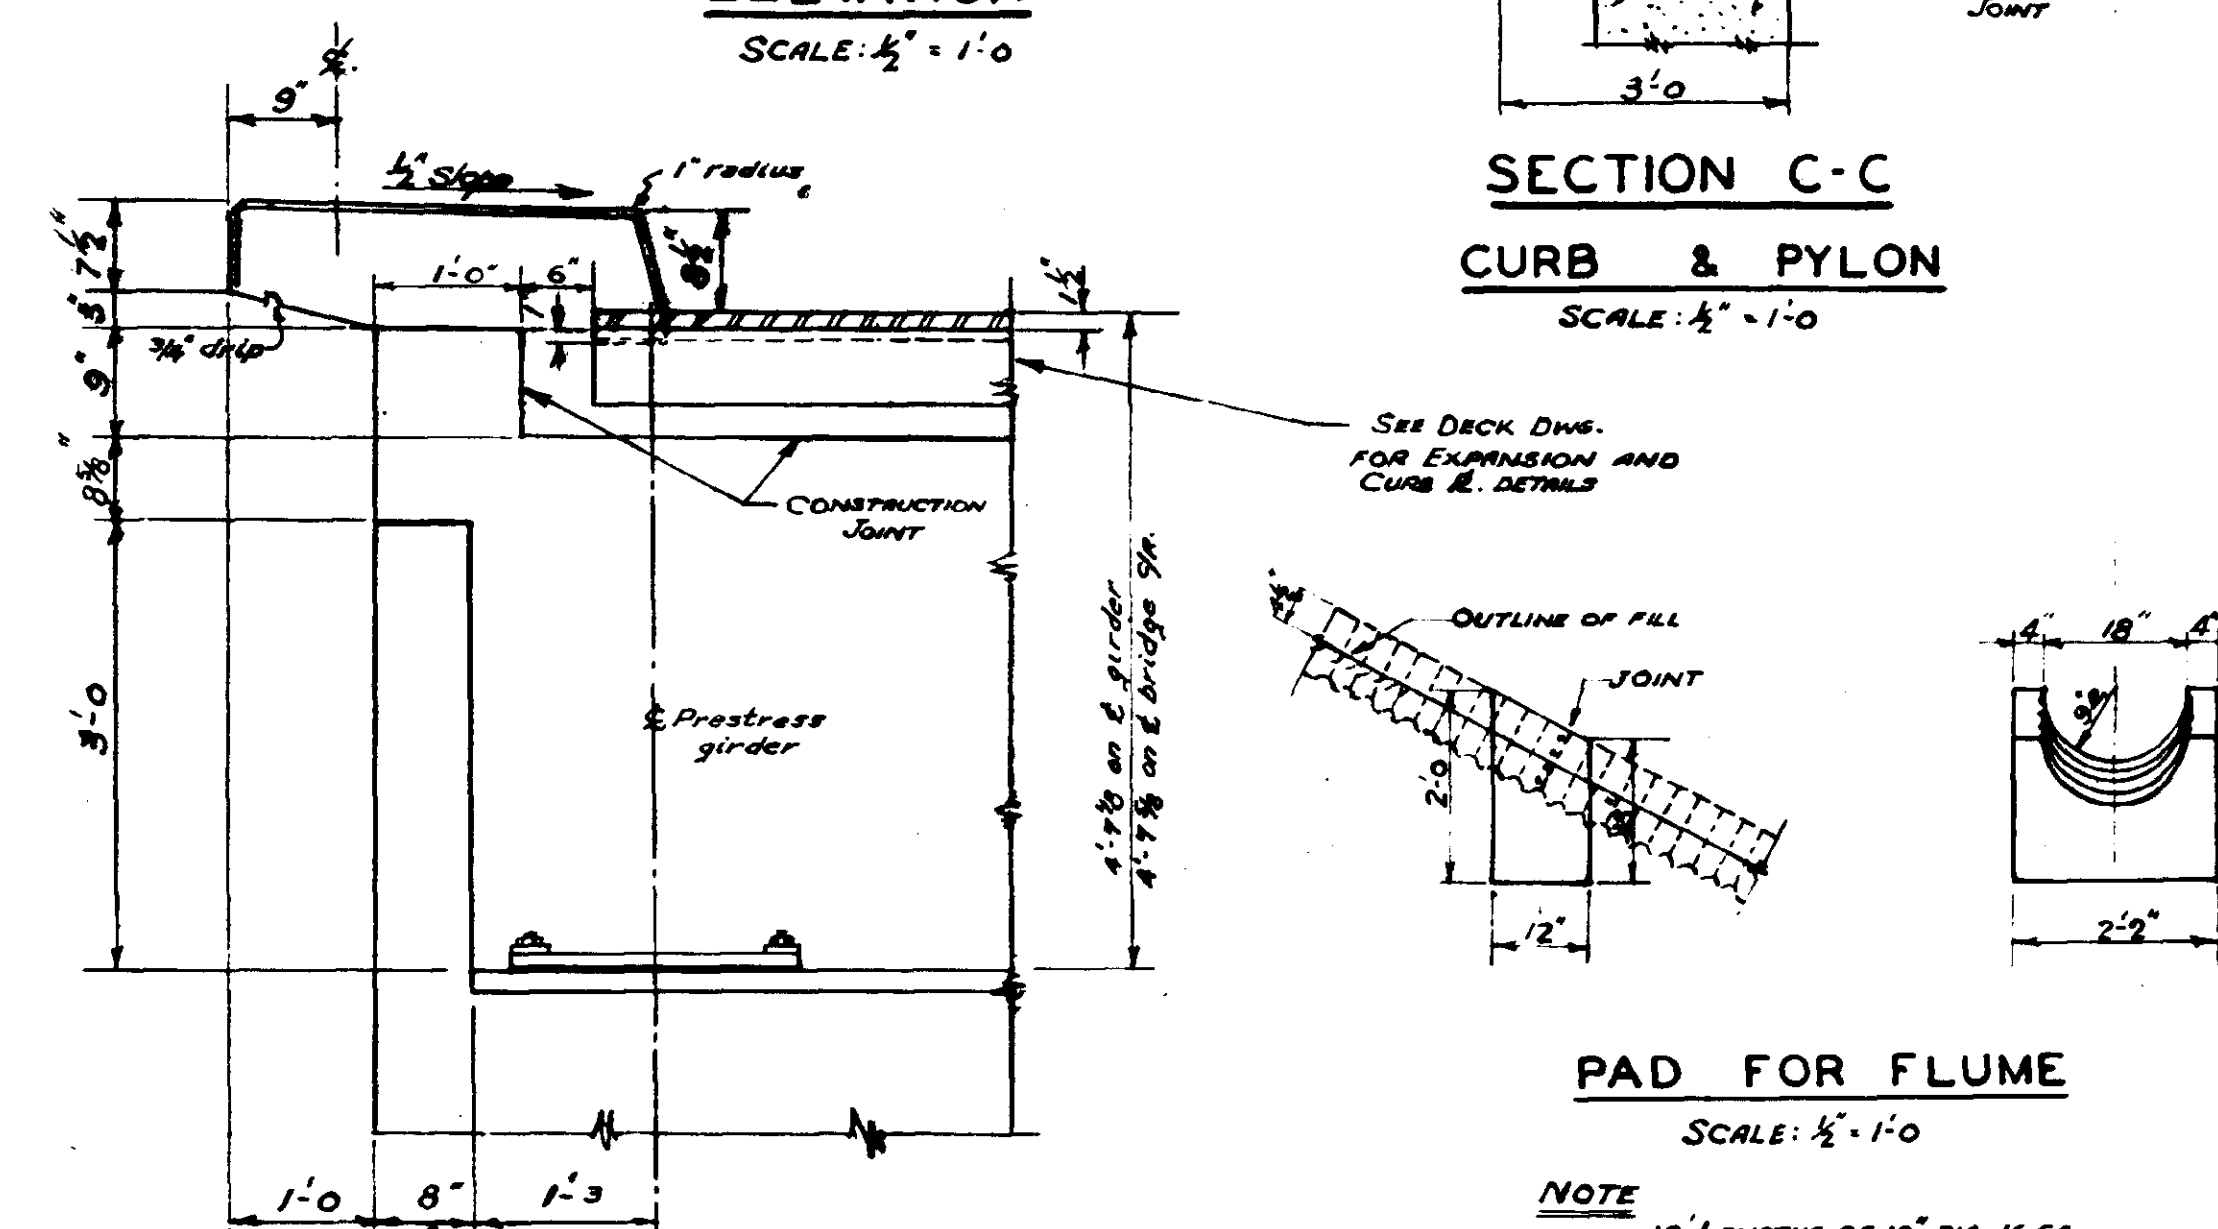

DETAIL A  
SCALE: 3/8" = 1'-0"

- NOTES:
- USE 10x10 @ 42 LBS. H BEARING PILES  
22 PILES ON PRESTRESS DESIGN  
22 PILES ON COMPOSITE DESIGN.
  - MAXIMUM LOAD ON PILE 40 TONS

NOTE - Elevations and details of bridge seat etc. are shown for the Prestress design only. When alternative to be used for construction has been established, revised drawings to conform herewith shall be supplied by the contractor for approval by the engineer.

Revised to conform with drawing No. 5C		Jun 25/57
Abutment shoulder wall reduced to 8' width		Oct 18/56
REVISIONS		DATE
DEPARTMENT OF PUBLIC WORKS CANADA DEVELOPMENT ENGINEERING BRANCH STRUCTURES DIVISION		
OTTERTAIL RIVER BRIDGE YOHO NATIONAL PARK B.C. M.12.9		
ABUTMENTS NORTH & SOUTH		
JOB SUPERVISOR J. C. BEAUCHAMP	DESIGN G. LANGLOIS	
APPROVED DATE 27/8/56	DRAWN W. L.	
CHECKED J. C. B.	PROJECT NO.	NP 10-21-34
CHIEF STRUCTURES DIVISION	DATE 27-8-56	
APPROVED		
CHIEF ENGINEER		
SHEET		2 OF 6