




revisions: _____ date: _____
project: **ARDGOWAN NATIONAL HISTORIC SITE HVAC UPGRADE QUEENS CO., PE**

drawing: **SECOND FLOOR PLAN**
design: _____

designed	RLS	date	MARCH 29 2017
drawn	JH	checked	
date	MARCH 29 2017	approved	
date	MARCH 29 2017	approved	
Tender	Submission of <i>Ray M. M. M. M.</i> PWSSC Project Manager / Administrateur de projets TPSSC project number R.080258.002 no. du projet drawing no. E2 OF 3 no. du dessin		

- EXISTING AIR HANDLING UNIT AHU-1 WILL BE REMOVED BY THE MECHANICAL CONTRACTOR, THIS CONTRACTOR SHALL REMOVE ALL ELECTRICAL CONNECTION AND WIRING BACK TO THE SOURCE. EXISTING CIRCUIT BREAKERS SHALL BE RE-LABELLED AS SPARE.
- EXISTING AIR HANDLING UNIT AHU-2 WILL BE REMOVED BY THE MECHANICAL CONTRACTOR, THIS CONTRACTOR SHALL REMOVE ALL ELECTRICAL CONNECTION AND WIRING BACK TO THE SOURCE. EXISTING CIRCUIT BREAKERS SHALL BE RE-LABELLED AS SPARE.
- EXISTING AIR HANDLING UNIT AHU-3 WILL BE REMOVED BY THE MECHANICAL CONTRACTOR, THIS CONTRACTOR SHALL REMOVE ALL ELECTRICAL CONNECTION AND WIRING BACK TO THE SOURCE. EXISTING CIRCUIT BREAKERS SHALL BE RE-LABELLED AS SPARE.
- EXACT LOCATIONS OF ALL NEW MECHANICAL EQUIPMENT AND ELECTRICAL CONNECTION POINTS TO BE COORDINATED WITH THE MECHANICAL CONTRACTOR PRIOR TO ROUGH-IN OF ELECTRICAL WIRING.
- ALL CONTROL WIRING FOR MECHANICAL EQUIPMENT IS THE RESPONSIBILITY OF THE MECHANICAL CONTRACTOR.

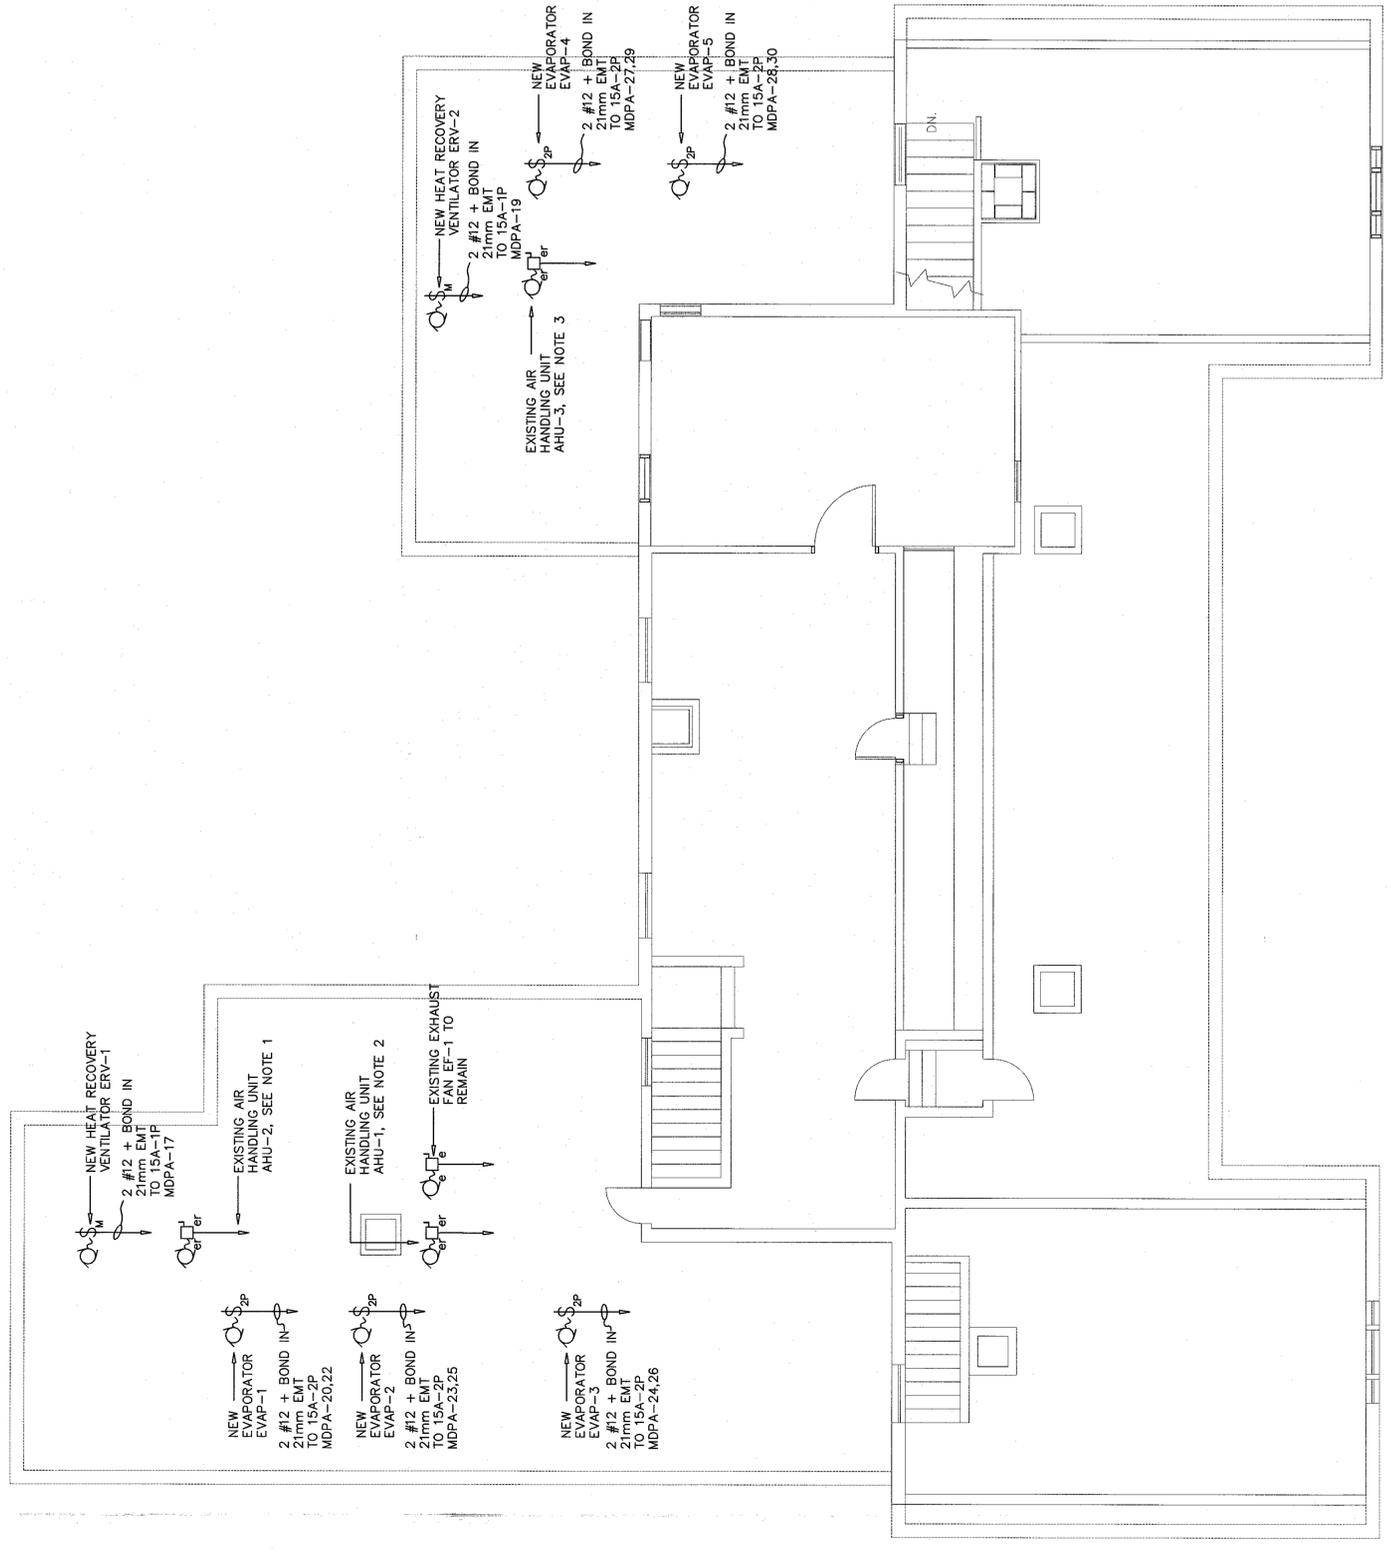

SECOND FLOOR ELECTRICAL PLAN
SCALE: 1:50
0m 1m 2m 3m 4m 5m

