


TYPICAL CONDUIT INSTALLATION IN NEW CRIBWORK 1
E7

SCALE: 1:25
0mm 500mm 1000mm 1500mm 2000mm 2500mm


NOTE:

1. ALL DIMENSIONS ARE IN MILLIMETERS AND REPRESENT MINIMUM VALUES.
2. SIZE, QUANTITY AND ELEVATION MAY VARY. REFERENCE SITE PLAN AND PILE CAP CONDUIT SECTION.

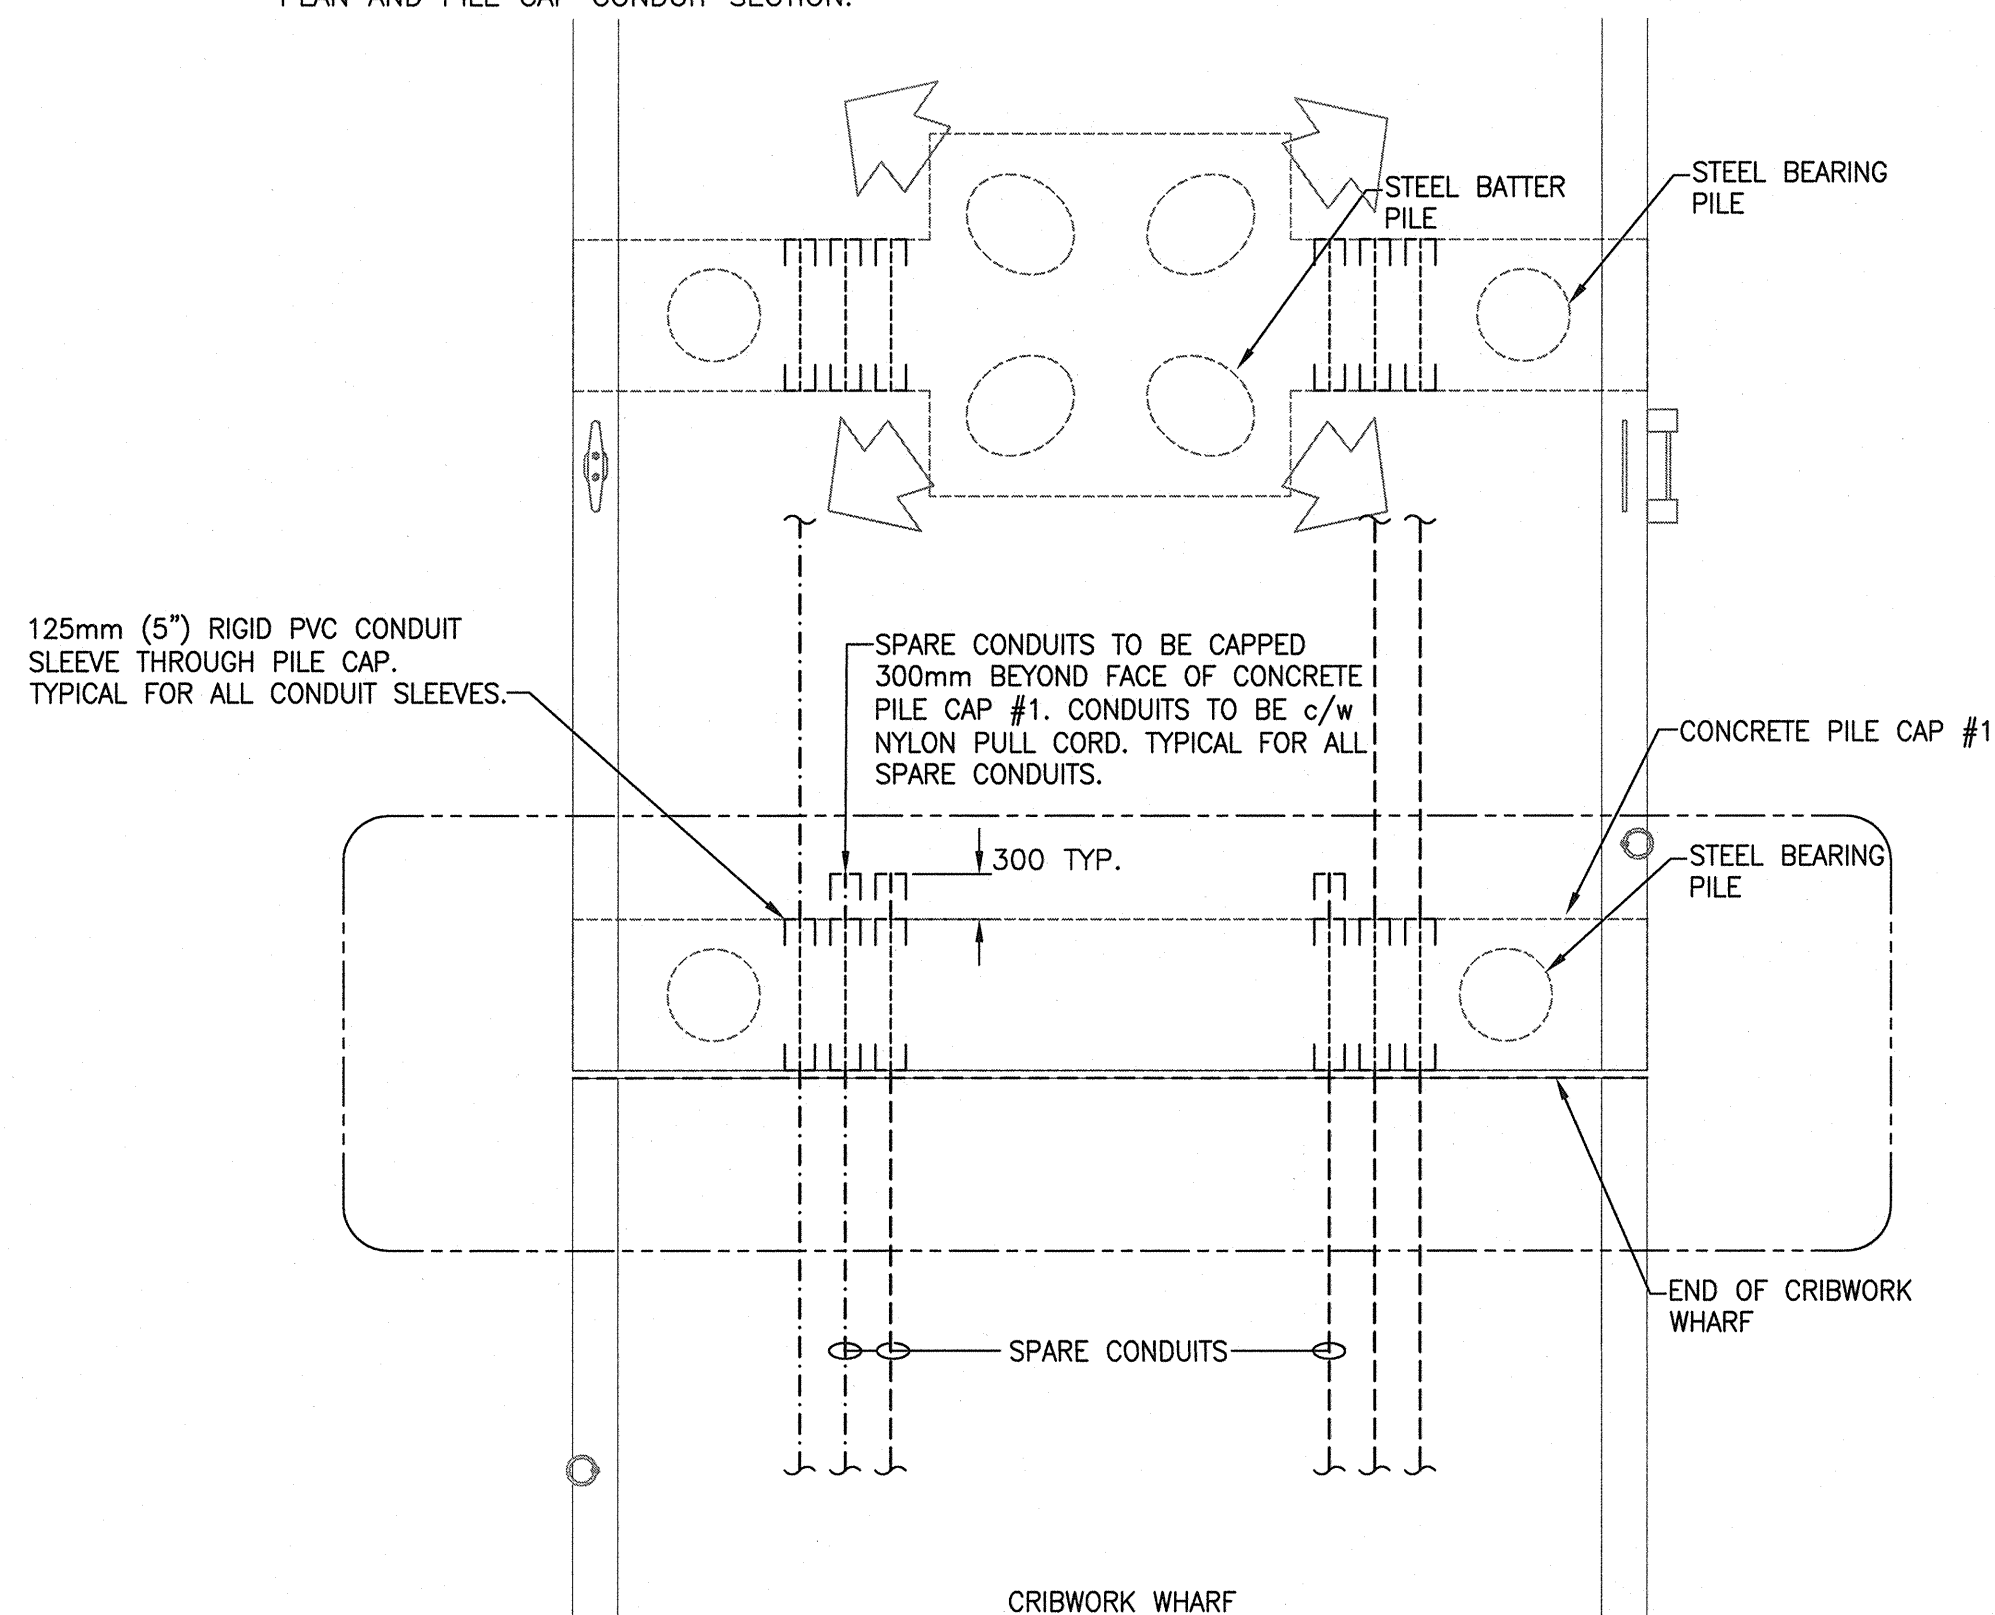

CONDUIT DETAIL AT WHARF TRANSITION 3
E1 E7


SCALE: 1:50
0m 1m 2m 3m 4m 5m

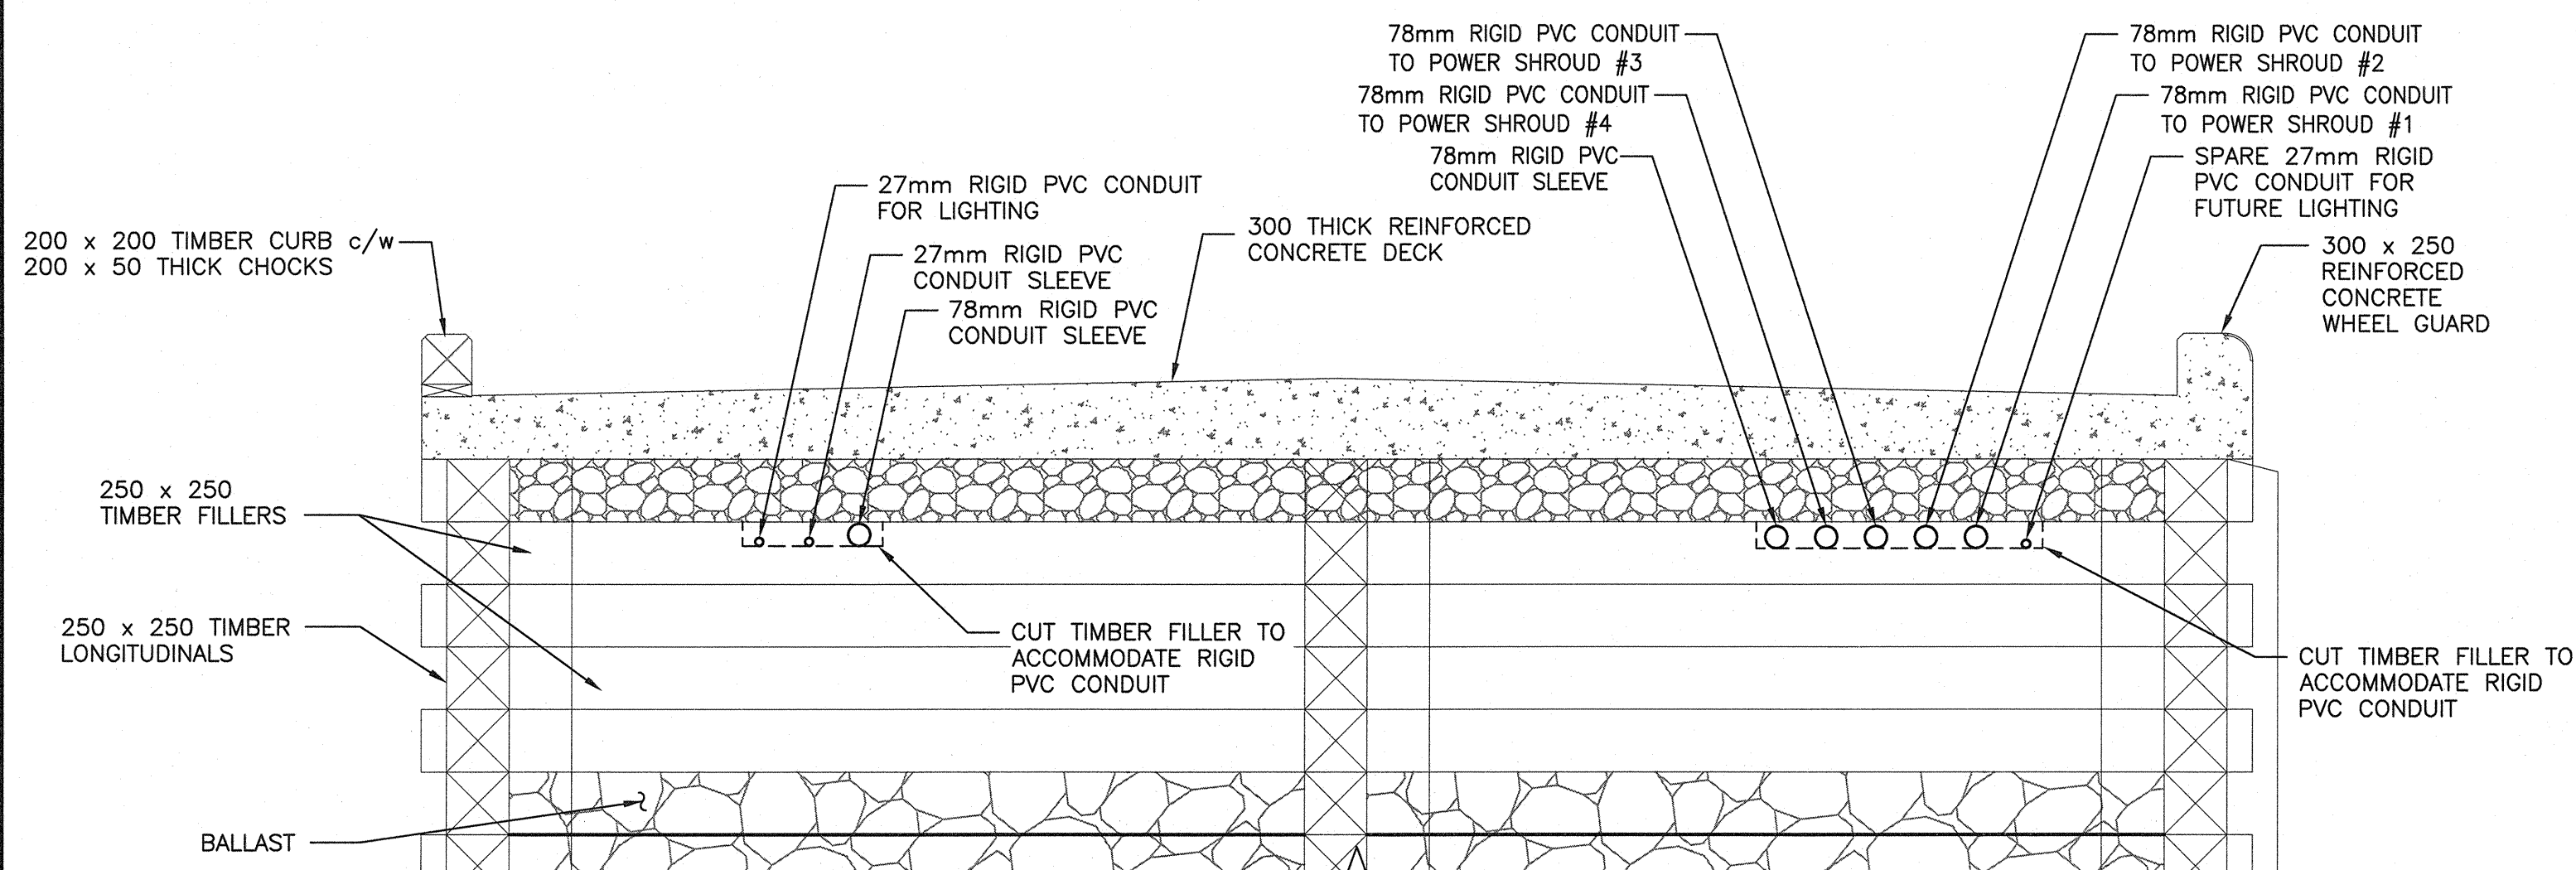

SECTION - CONDUIT INSTALLATION IN TIMBER CRIB WHARF D
E1 E7

SCALE: 1:25
0mm 500mm 1000mm 1500mm 2000mm 2500mm


NOTE:
ALL DIMENSIONS ARE IN MILLIMETERS AND REPRESENT MINIMUM VALUES.

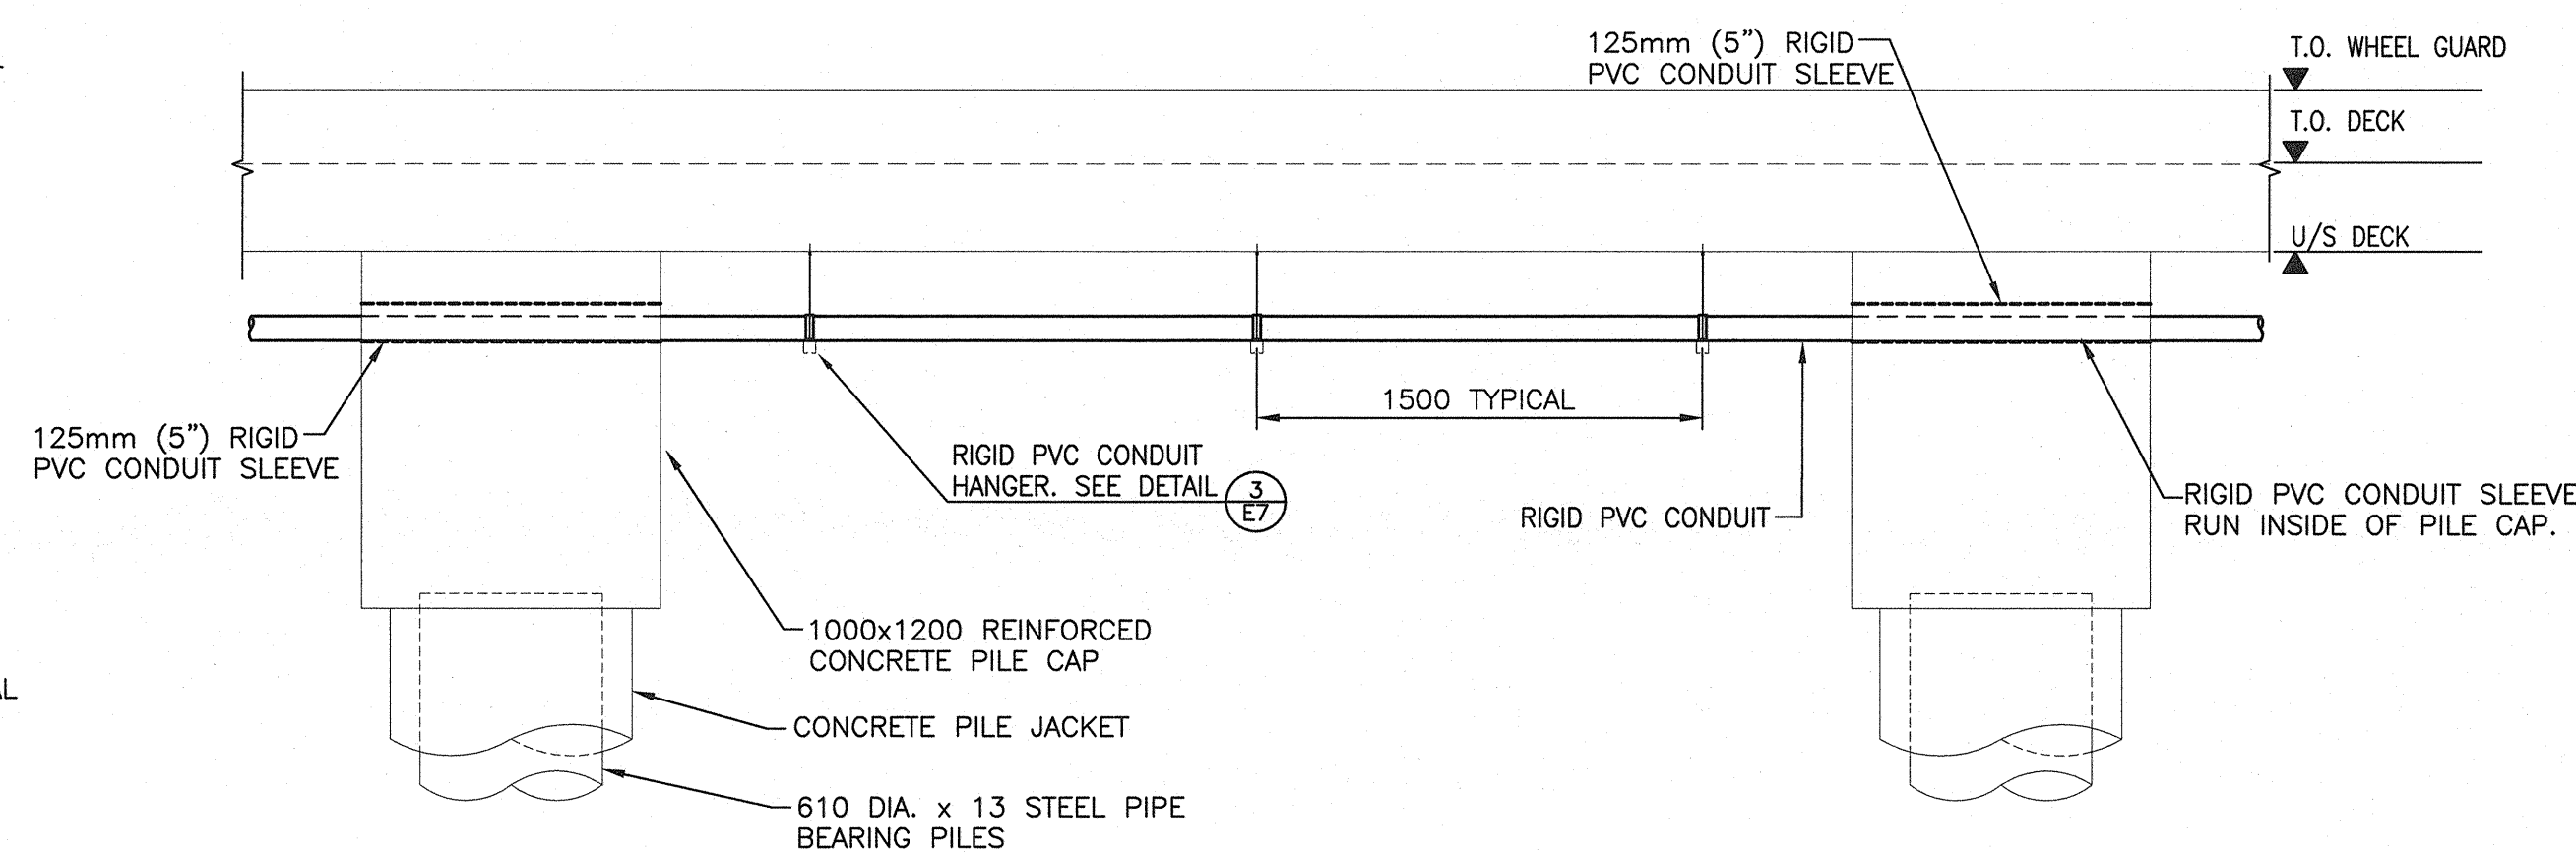

ELEVATION - CONDUIT INSTALLATION UNDER CONCRETE PILE CAP WHARF 2
E7

SCALE: 1:25
0mm 500mm 1000mm 1500mm 2000mm 2500mm


NOTE:
ALL DIMENSIONS ARE IN MILLIMETERS AND REPRESENT MINIMUM VALUES.

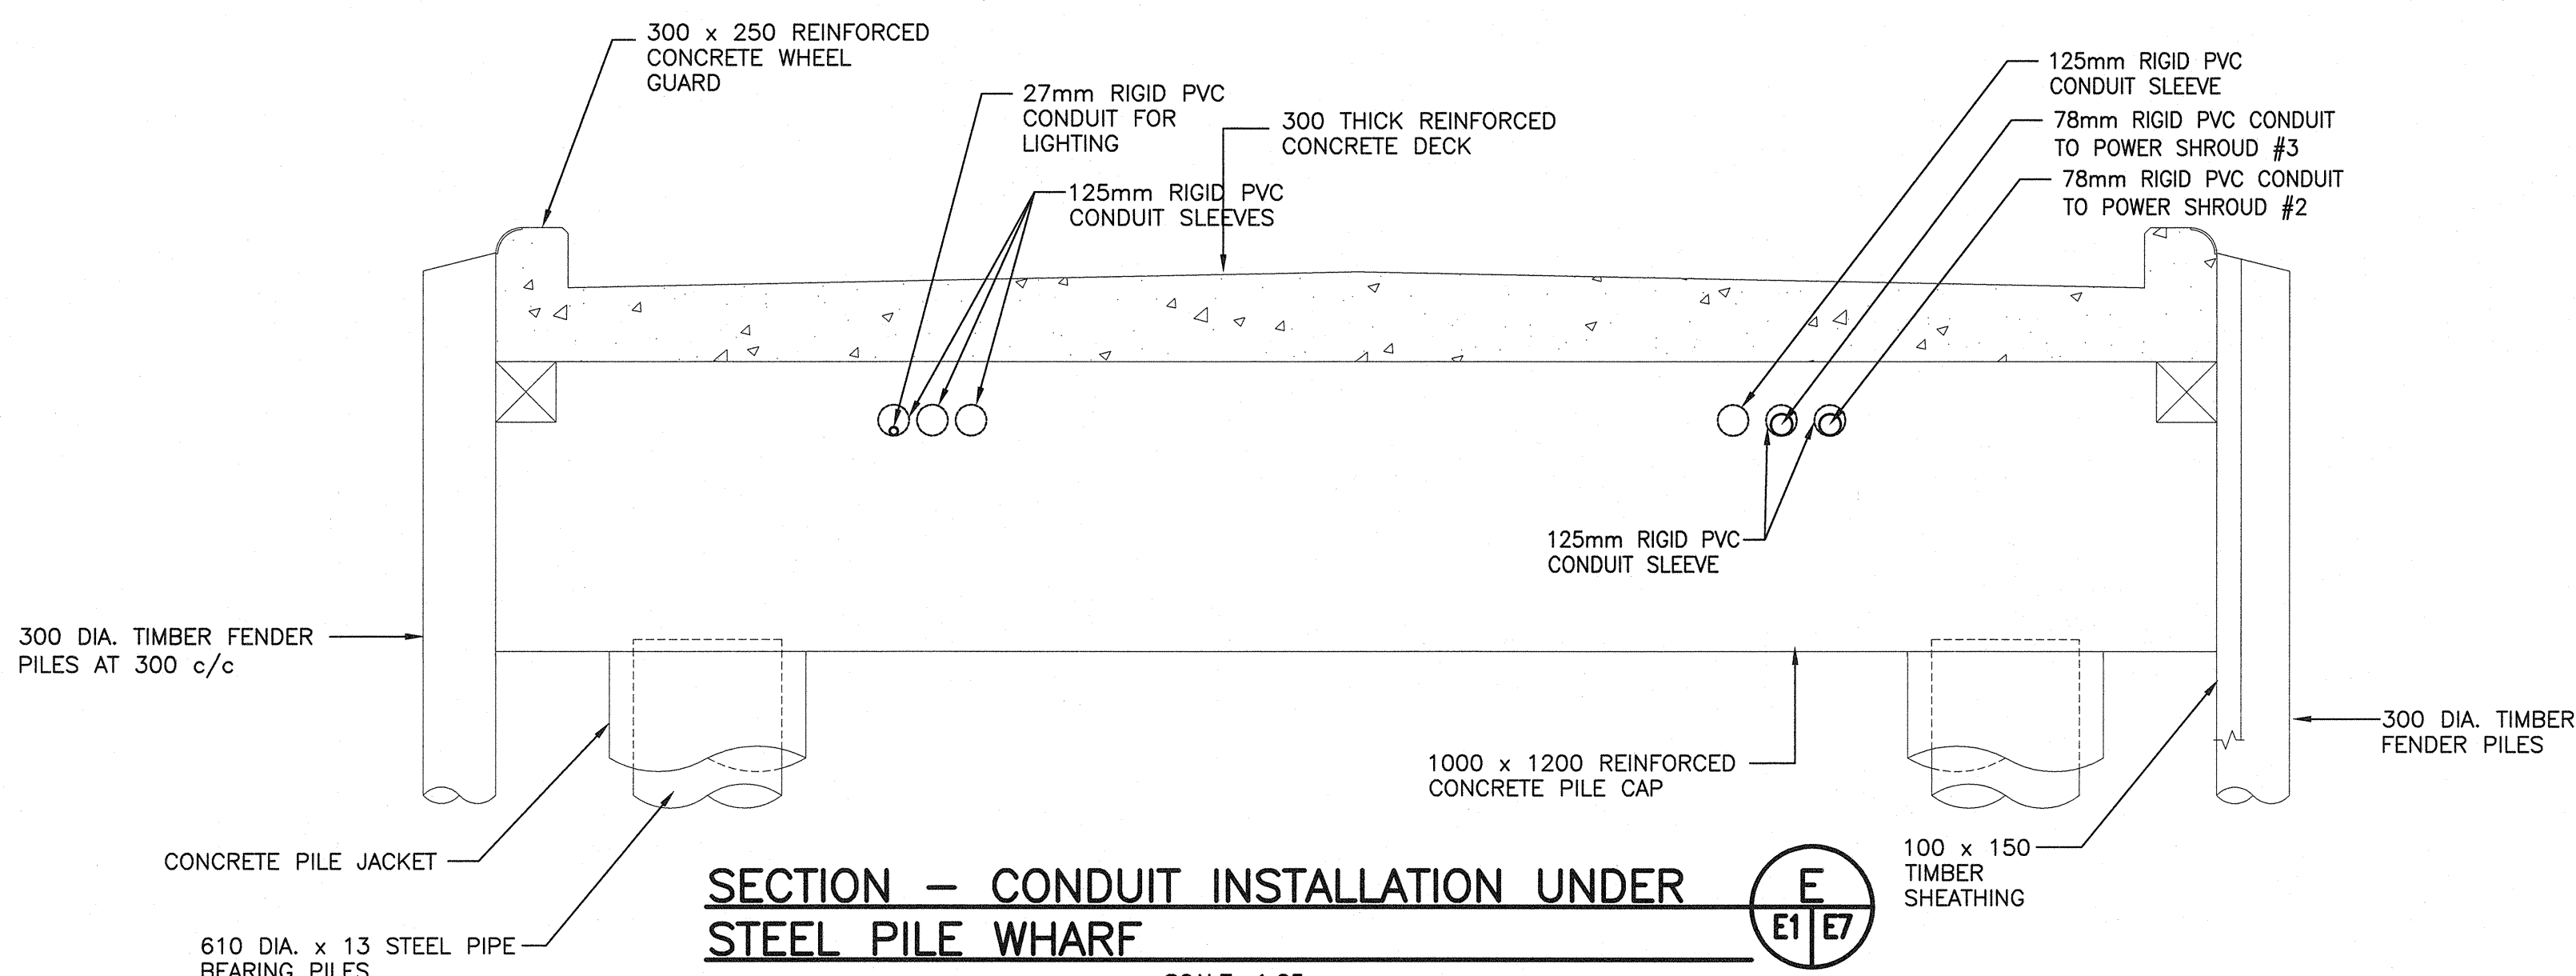

SECTION - CONDUIT INSTALLATION UNDER STEEL PILE WHARF E
E1 E7

SCALE: 1:25
0mm 500mm 1000mm 1500mm 2000mm 2500mm


NOTE:
ALL DIMENSIONS ARE IN MILLIMETERS AND REPRESENT MINIMUM VALUES.

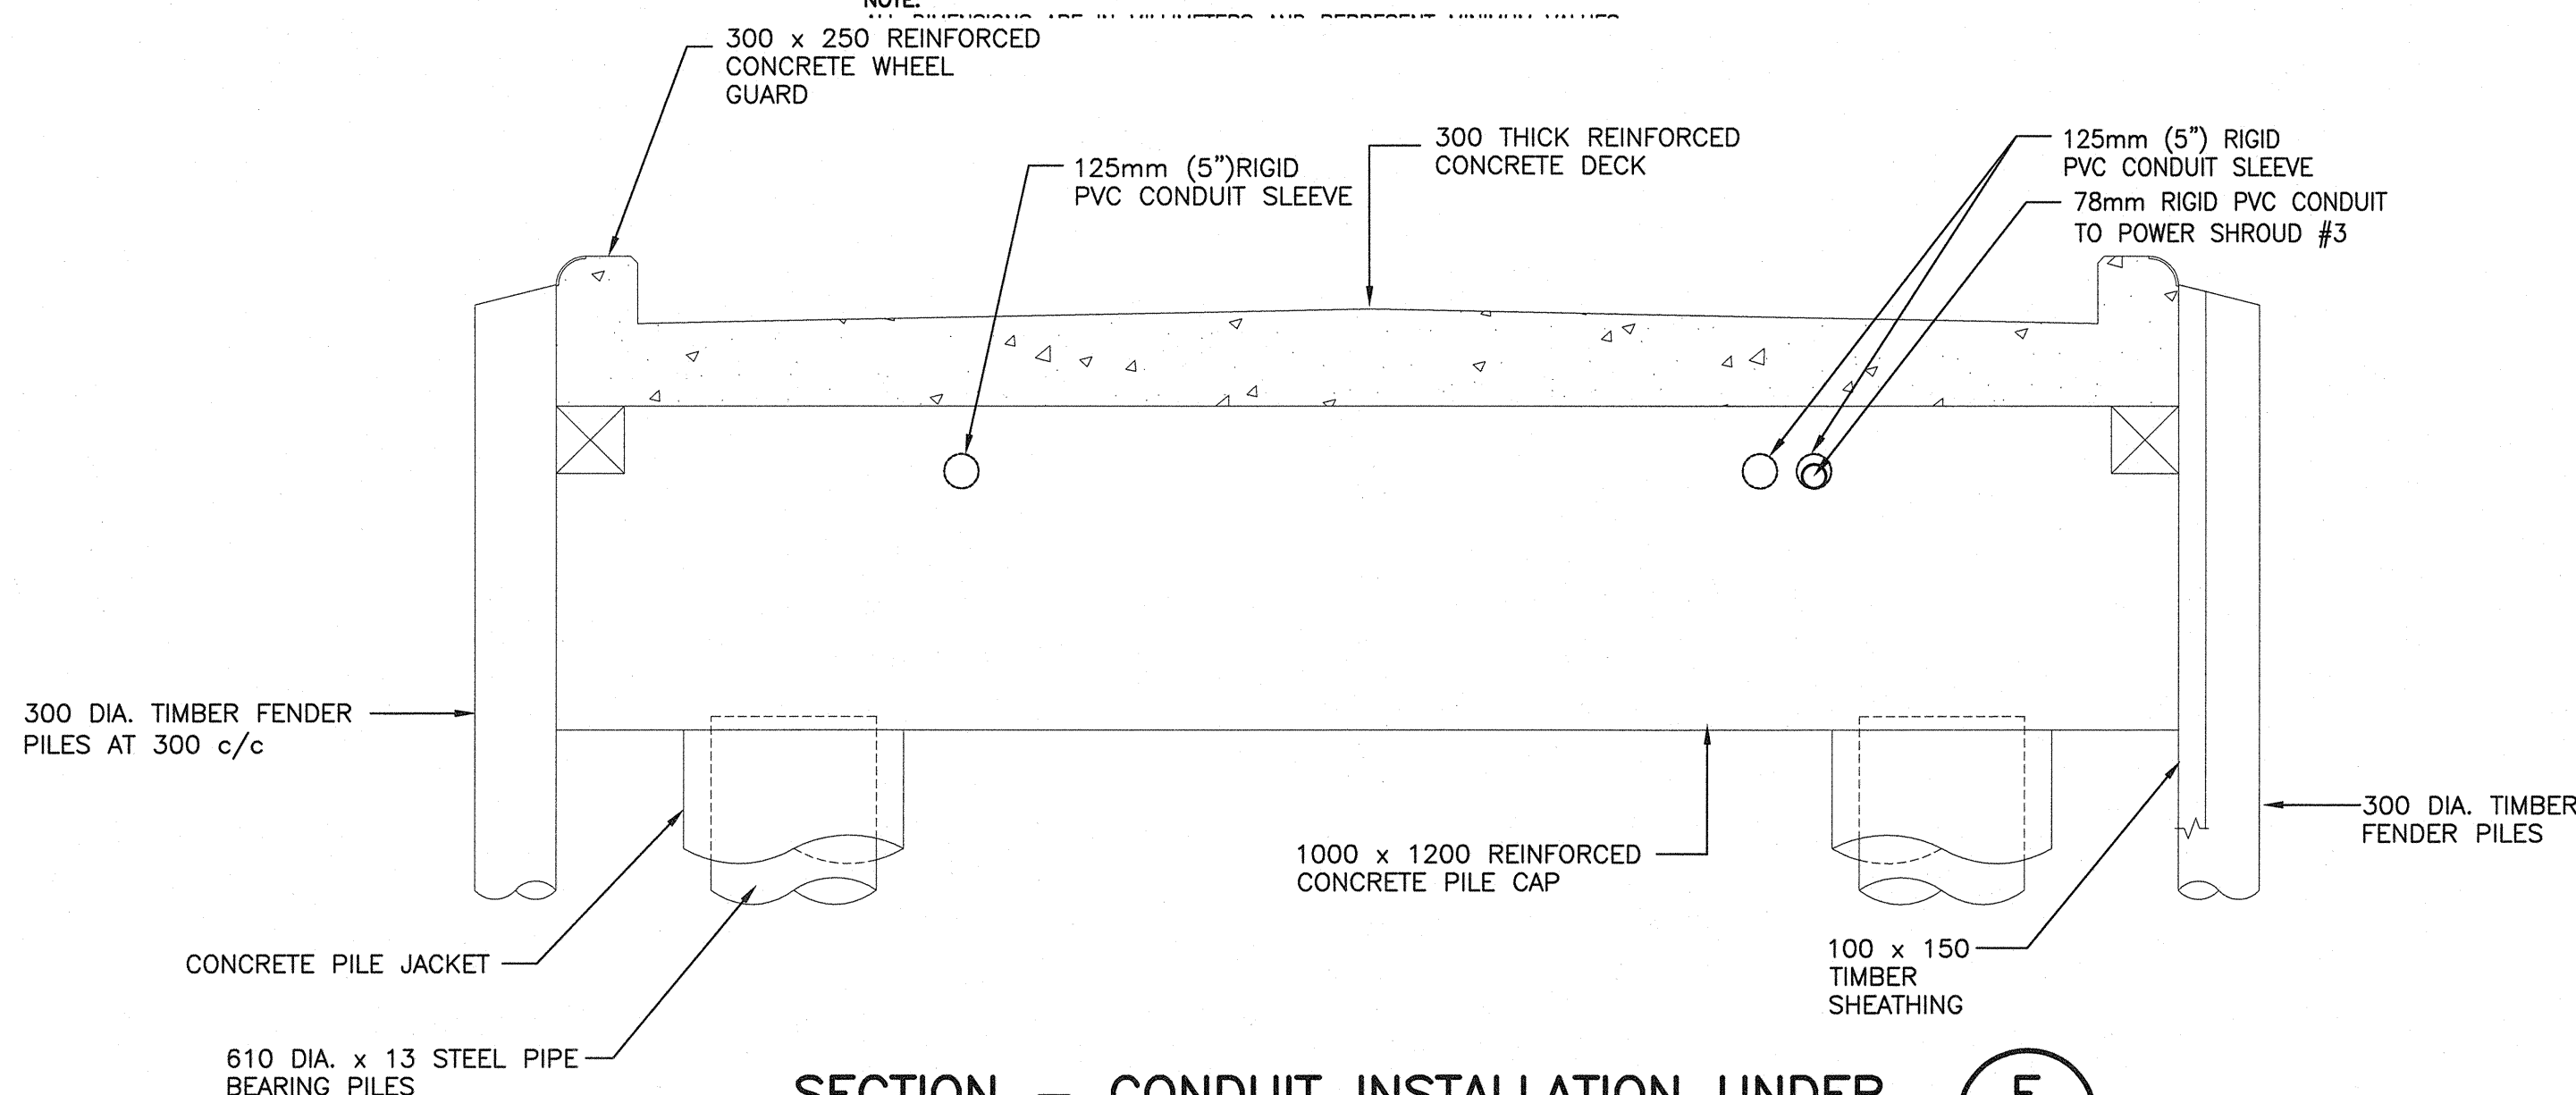

SECTION - CONDUIT INSTALLATION UNDER STEEL PILE WHARF F
E1 E7


SCALE: 1:25
0mm 500mm 1000mm 1500mm 2000mm 2500mm

NOTE:
ALL DIMENSIONS ARE IN MILLIMETERS AND REPRESENT MINIMUM VALUES.

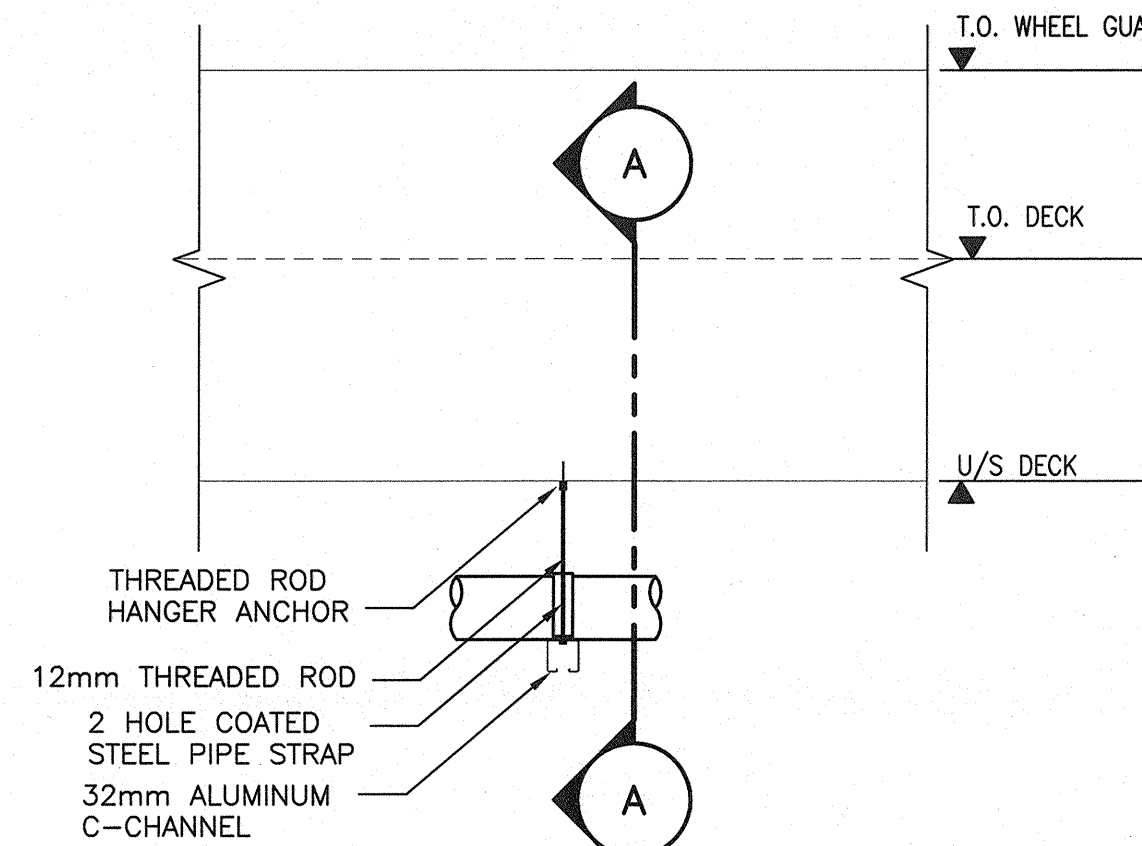

HANGER DETAIL 3
E7

SCALE: 1:10
0mm 100 200 300 400 500 600 700 800 900 1000mm

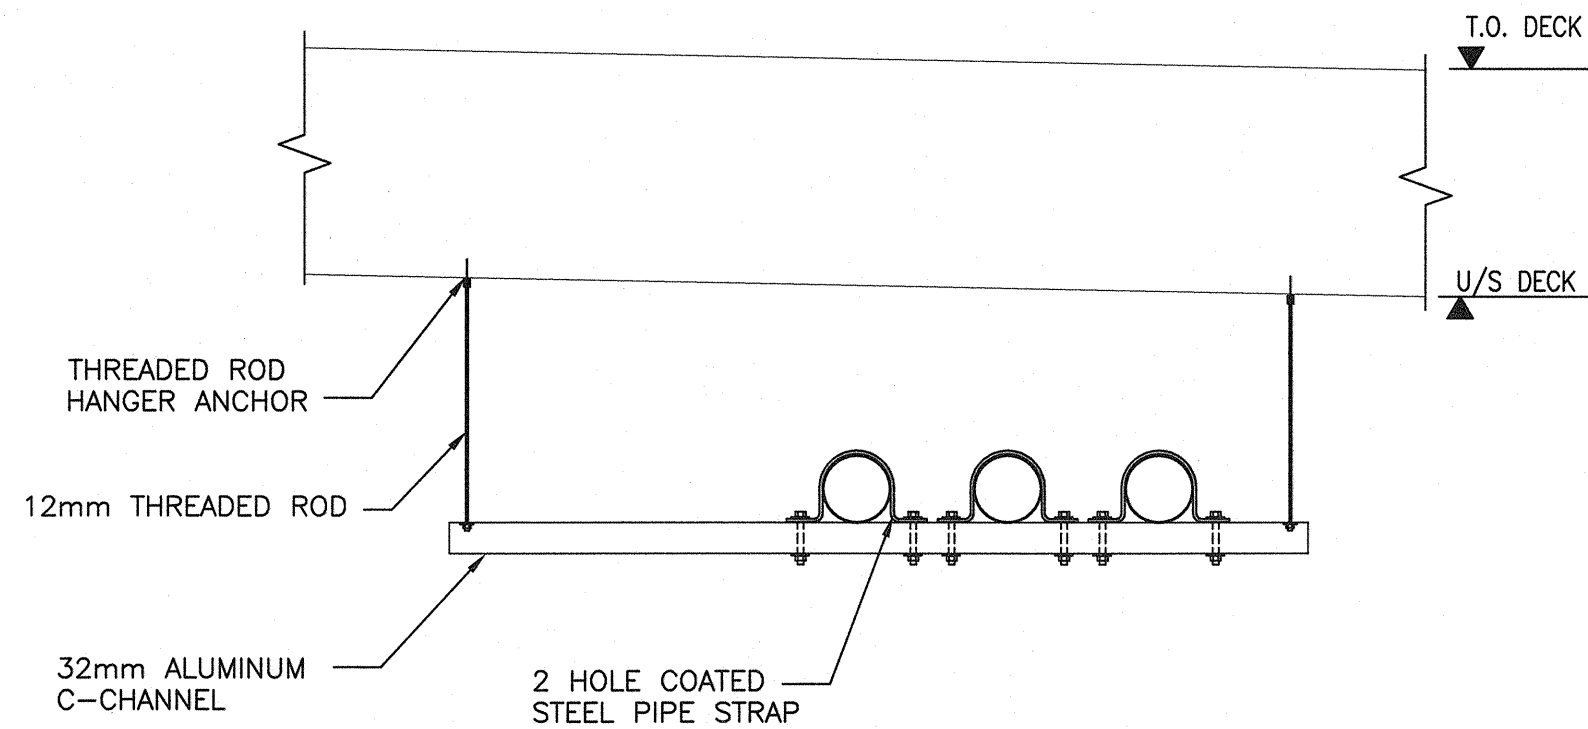

SECTION 'A'

SCALE: 1:10
0mm 100 200 300 400 500 600 700 800 900 1000mm

NOTE:

1. ALL DIMENSIONS ARE IN MILLIMETERS.
2. CONSTRUCT HANGER TO ACCOMMODATE FUTURE CONDUITS.

0	ISSUED FOR TENDER	MAY 2017
revisions		date

project
**WHARF CONSTRUCTION
NEW HARBOUR**
GUYSBOROUGH COUNTY
NOVA SCOTIA

drawing
**SITE DETAILS, SECTIONS
AND ELEVATIONS**

designed G. BOWSER
date MAY 2017
drawn K. WOLFE
date MAY 2017
approved
date
Tender
PWSG Project Manager
project number
R.082348.001
drawing no.
E7