

#### WALL TYPE GENERAL NOTES

1. REFER TO DEMOLITION PLAN FOR EXTENT OF DEMOLITION THROUGHOUT THE AREA OF WORK. COORDINATE ALL MECHANICAL AND ELECTRICAL DEVICES AND OTHER RELATED EQUIPMENT TO REMAIN TO ENSURE A FULLY FINISHED APPEARANCE.
2. FIRE RATED WALL TYPE SYMBOLS ARE DESIGNATED WITH AN "R". REFER TO REFLECTED CEILING PLAN FOR LOCATION AND RATING OF FIRE RATED WALLS. FIRE RESISTANCE RATINGS (FRR) AND SOUND TRANSMISSION CLASSES (STC) ARE SHOWN FOR REFERENCE ONLY.
3. REFER TO FINISHES SCHEDULE AND INTERIOR ELEVATIONS FOR WALL AND FLOOR FINISHES.
4. ALL ACOUSTICALLY INSULATED WALLS BETWEEN DIFFERENT SPACES TO EXTEND TO UNDERSIDE OF ACOUSTIC CEILING OR STRUCTURE ABOVE AS INDICATED IN WALL TYPES. SEAL WITH ACOUSTIC CAULKING AT PERIMETER AND ALL PENETRATIONS. REFER TO DETAILS AND CEILING PLAN.
5. CONSTRUCT FIRE RATED WALLS TO UNDERSIDE OF STRUCTURE ABOVE.
6. ACOUSTIC INSULATION IN FIRE RATED WALLS TO BE MINERAL FIBRE PROCESSED FROM ROCK OR SLAG WITH A MASS OF AT LEAST 2.8 kg/m<sup>2</sup> FOR 92MM THICKNESS. REFER TO SPEC.
7. ACOUSTICALLY SEPARATE BACK TO BACK ELECTRICAL BOXES WHICH CANNOT BE SEPARATED BY MIN. 400MM (1 FULL STUD SPACE). ATTACH DOUBLE LAYER 16MM GWB TO SIDE OF STUD FROM FLOOR TO 1200MM HIGH. SEAL WITH ACOUSTIC CAULK ON BOTTOM AND SIDES.
8. ALL INTERIOR WALL DIMENSIONS TO OUTSIDE FACE OF GYPSUM BOARD. COORDINATE STUDS TO SUIT.
9. PROVIDE SLIP-JOINT FOR ALL FULL HEIGHT PARTITIONS. MAINTAIN FIRE RESISTANCE RATING AS REQUIRED.
10. PROVIDE MINIMUM 19MM PLYWOOD BLOCKING FOR WALL HUNG EQUIPMENT, MILLWORK, FURNITURE, AND LOCATIONS INDICATED ON DRAWINGS. COORDINATE LOCATION WITH INSTALLERS AND/OR DEPARTMENTAL REPRESENTATIVE.
11. FIRESTOP ALL EXISTING AND NEW PENETRATIONS IN FIRE SEPARATIONS WITHIN THE AREA OF WORK. REFER TO THE REFLECTED CEILING PLAN FOR LOCATIONS AND SPECIFICATION.
12. OFFSET DOOR FRAMES 100MM FROM FACE OF WALL UNLESS OTHERWISE NOTED.

#### INTERIOR WALL TYPES:

- A1 (NBC WALL TYPE S4B) TH - 124 mm  
STC - 47, FRR - 1 HR. WHEN DESIGNATED
- FINISH - REFER TO FINISH SCHEDULE
  - 16 TYPE X GYPSUM BOARD
  - 92 STEEL STUDS @ 400 O.C. TO U/S FIN. CEILING UNLESS SHOWN OTHERWISE IN DETAILS
  - 89 THICK INSULATION - REFER TO SPEC.
  - 16 TYPE X GYPSUM BOARD
  - FINISH - REFER TO FINISH SCHEDULE

#### GENERAL RENOVATION NOTES

1. ALL NEW WALLS TO GO TO UNDERSIDE OF ACOUSTIC CEILING OR STRUCTURE ABOVE AS INDICATED IN WALL TYPES. COORDINATE WORK WITH REMOVAL AND RECONSTRUCTION OF A.C.T AND GRID.
2. CONTRACTOR TO REVISE SPRINKLER LINES TO SUIT NEW LAYOUT. REFER TO MECH.
3. CONTRACTOR TO PATCH AND REPAIR ALL EXISTING GWB AND PLASTER ON EXISTING WALLS, COLUMNS, BULKHEADS ETC. AND MAKE GOOD PRIOR TO PAINTING.
4. REFER TO INTERIORS DRAWINGS FOR ALL FURNITURE AND WORKSTATION LAYOUTS. FURNITURE IS N.I.C. GENERAL CONTRACTOR TO COORDINATE FURNITURE INSTALL, MOVING, AND RELOCATION WITH DEPARTMENTAL REPRESENTATIVE.
5. CONTRACTOR TO PROVIDE FIRESTOPPING IN ALL NEW AND EXISTING PENETRATIONS IN FIRE RATED WALLS. FIRE RATED WALL INDICATED ON REFLECTED CEILING PLAN
6. REFER TO DOOR SCHEDULE FOR ALL DOOR HARDWARE REQUIREMENTS ON NEW AND EXISTING DOORS WITHIN THE AREA OF WORK.
7. REFER TO FINISHES SCHEDULE AND INTERIOR ELEVATIONS FOR WALL AND FLOOR FINISHES.

#### LEGEND

- NEW WALL
- EXISTING WALL TO REMAIN
- NEW DOOR
- EXISTING DOOR TO REMAIN. REFER TO DOOR SCHEDULE FOR MODIFICATIONS TO EXISTING DOOR, FRAME AND/OR DOOR HARDWARE
- CG - STAINLESS STEEL CORNER GUARDS - REFER TO SPECIFICATION

#### RENOVATION KEYNOTES

1. PROVIDE 19mm X 140mm HT PLYWOOD BLOCKING. CONFIRM MOUNTING HT WITH DEPARTMENTAL REPRESENTATIVE. REFER TO INT. ELEVATIONS
2. ALIGN
3. EXISTING FLOORING TRANSITION STRIP TO REMAIN
4. NEW RUBBER BASE - REFER TO ROOM FINISH SCHEDULE AND SPEC.
5. NEW CARPET TILE - REFER TO ROOM FINISH SCHEDULE AND SPEC.
6. NEW THERMOSTAT - REFER TO MECH.
7. NEW FLOORING TRANSITION STRIP TO MATCH EXISTING - RUN FULL LENGTH WITH ONE CONTINUOUS PIECE. - REFER TO SPEC.

#### GENERAL NOTES


1. 1. REFER TO MECHANICAL FOR SPRINKLER AND FIRE PROTECTION DESIGN. CONTRACTOR TO REVISE SPRINKLER HEAD LOCATIONS TO ACCOMMODATE NEW CEILING LAYOUT. PROVIDE SPRINKLER DESIGN FOR REVIEW. COORDINATION AND APPROVAL.
2. CONTRACTOR TO PROVIDE FIRESTOPPING IN ALL NEW AND EXISTING PENETRATIONS IN FIRE RATED WALLS AND FLOOR ASSEMBLIES

#### LEGEND


- N NEW LIGHTS. REFER TO ELEC.
- EXISTING LIGHTS TO REMAIN. REFER TO ELEC.
- NEW ACOUSTIC CEILING TILE AND GRID - REFER TO SPEC.
- EXISTING CEILING SYSTEM TO REMAIN.
- EXISTING LINEAR METAL CEILING (LMC) TO REMAIN. MODIFY AS REQUIRED FOR NEW CONSTRUCTION.
- EXISTING MECHANICAL LINEAR RE-LOCATED GRILL/LOUVER. REFER TO MECH.
- 1 HR FIRE RESISTANCE RATING
- EXISTING 1 HR FIRE RESISTANCE RATING
- CEILING HEIGHT
- ACOUSTIC CEILING TILE WITH SOUND BARRIER - REFER TO SPEC.
- STANDARD ACOUSTIC CEILING TILE - REFER TO SPEC.

#### KEYNOTES


1. NOT USED
2. NOT USED
3. EXISTING GWB BULKHEAD TO REMAIN. PATCH AND MAKE GOOD. PAINT.
4. SALVAGED EXISTING EXIT SIGN TO BE INSTALLED IN INDICATED LOCATION - REFER TO ELECTRICAL
5. NEW WALL TO ALIGN WITH FACE OF EXISTING GWB FASCIA. REFER TO DETAIL 1/A5.1
6. SALVAGED EXISTING SLOT DIFFUSER TO BE INSTALLED IN INDICATED LOCATION - REFER TO MECH. REFER TO DETAIL 2/A5.1
7. RELOCATED EXISTING SPEAKER - REFER TO ELEC.
8. CEILING MOUNTED PROJECTOR LOCATION - REFER TO ELEC.

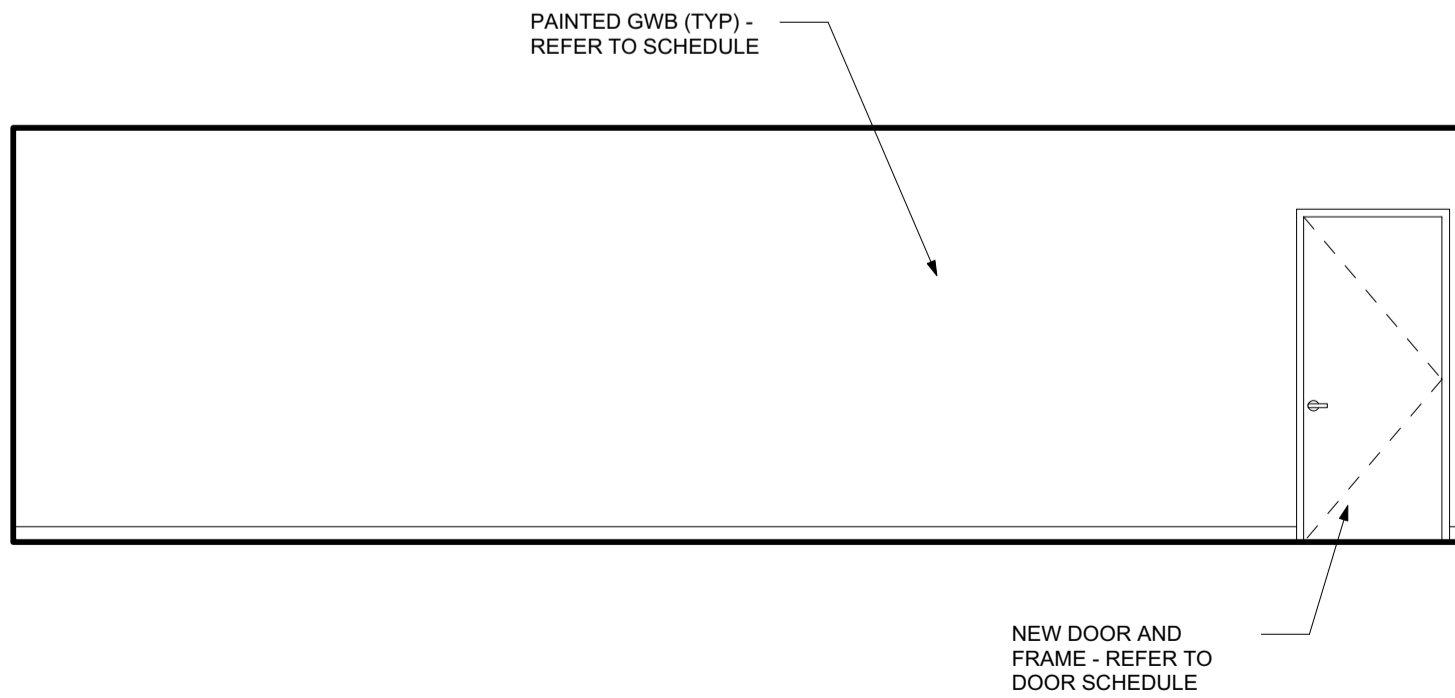


3 TRAINING RM (204) SOUTH  
A3.2 Scale: 1:50

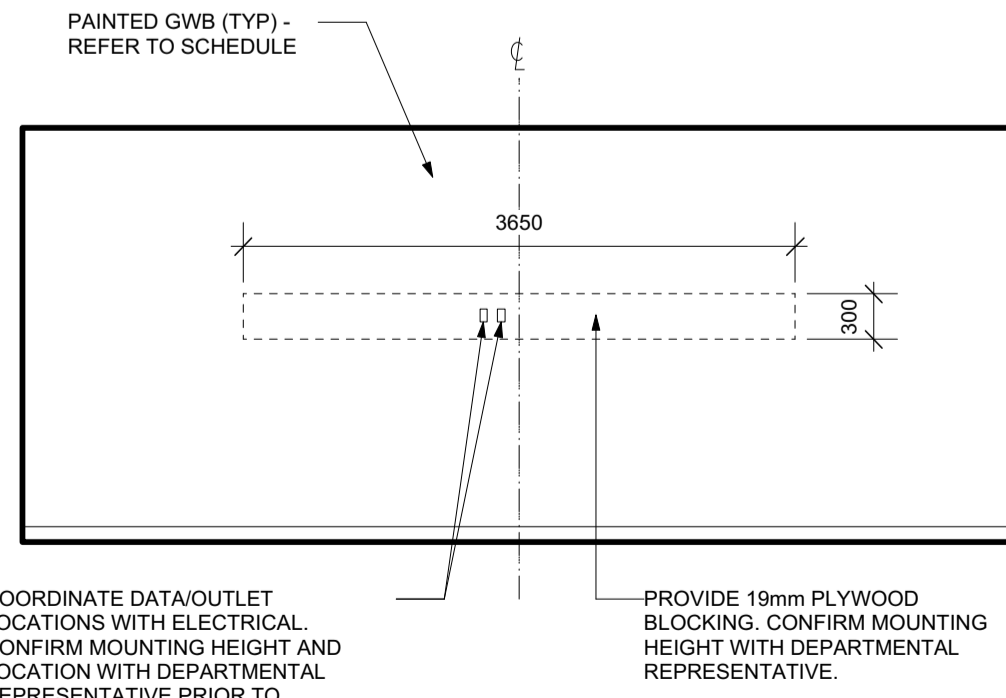


4 TRAINING RM (204) WEST  
A3.2 Scale: 1:50

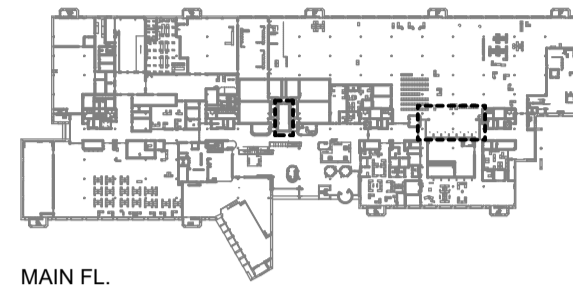

MAIN FL.

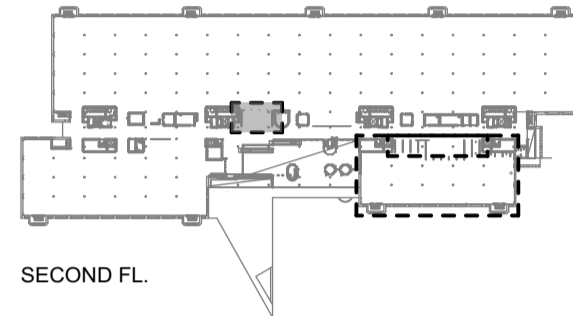

SECOND FL.

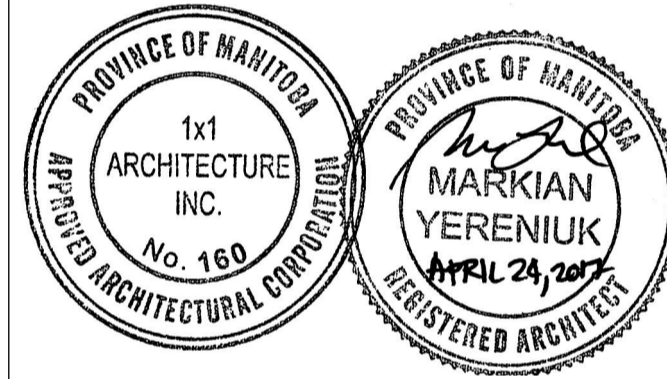

4		
3		
2		
1		
0	ISSUED FOR CONSTRUCTION	17-04-24
Revision	Description	Date
Client		client

#### PUBLIC WORKS AND GOVERNMENT SERVICES CANADA

Project title  
WINNIPEG TAX CENTRE (WTC)  
66 STAPON ROAD, WINNIPEG, MANITOBA

#### CRA WINNIPEG TAX-CENTRE FIT-UP

Designed by MY	Conçu par
Drawn by KK	Dessiné par
Approved by	Approuvé par

PWGSC Project Manager  
Jason Frezza

Administrateur de Projets TPSGC

Drawing title  
ARCHITECTURAL TRAINING ROOM (204) FLOOR PLAN & RCP SECOND FLOOR

Titre du dessin

Project no./No. du projet R.078618	Drawing no./No. du dessin A3.2 OF	Revision no. 0
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