




prime consultant: **ARCHITECTURE 49**



- GENERAL NOTES:**
- CONTRACTOR TO VERIFY ALL DIMENSIONS & EXISTING CONDITIONS ON SITE. ANY DISCREPANCIES OR UNSATISFACTORY CONDITIONS TO BE REPORTED TO THE OWNER'S REPRESENTATIVE BEFORE PROCEEDING WITH THE WORK.
  - COORDINATE ALL MECHANICAL WORK INCLUDING REMOVAL OF EXISTING MECHANICAL EQUIPMENT ON SITE WITH THE GENERAL CONTRACTOR, OTHER TRADES AND THE OWNER'S REPRESENTATIVE.
  - INFORMATION PERTAINING TO EXISTING MECHANICAL EQUIPMENT SHOWN ON THE DRAWINGS IS BASED ON AS-BUILT INFORMATION PROVIDED BY THE OWNER. THESE DRAWINGS MAY NOT FULLY OR ACCURATELY REFLECT THE EXISTING CONDITIONS, EQUIPMENT AND SERVICES MAY NOT BE IN THE EXACT LOCATION SHOWN. CONFIRM ALL EXISTING CONDITIONS IN FIELD. REFER TO ARCHITECTURAL DRAWINGS FOR EXTENT OF ARCHITECTURAL WORK.
  - WHERE MECHANICAL SERVICES (PIPING, DUCT, ELECTRICAL AND CONTROLS) ARE CALLED UP TO BE REMOVED COMPLETE, ALL REDUNDANT SERVICES TO BE CAPPED CONCEALED IN CEILING, WALLS OR BELOW FLOOR. CAP REDUNDANT SERVICES BACK WITHIN 150mm OF PIPE MAIN, DUCT MAIN, JUNCTION BOX, PANEL, ETC
  - TEST ADJUST AND BALANCE ALL AIR SYSTEMS TO VALUES SHOWN ON DRAWINGS AND AS DETAILED IN ACCORDANCE WITH THE CONTROL SEQUENCE. INCLUDE ALL MODES OF OPERATION IN THE TAB. COORDINATE THE SAME WITH THE TAB CONTRACTOR. TAB CONTRACTOR SHALL BE NEBB CERTIFIED.
  - ALL DEMOLITION TO BE CARRIED OUT IN ACCORDANCE TO THE ARCHITECTURAL PHASING DRAWINGS. REFER TO ARCHITECTURAL DRAWINGS A-104 TO A-107.

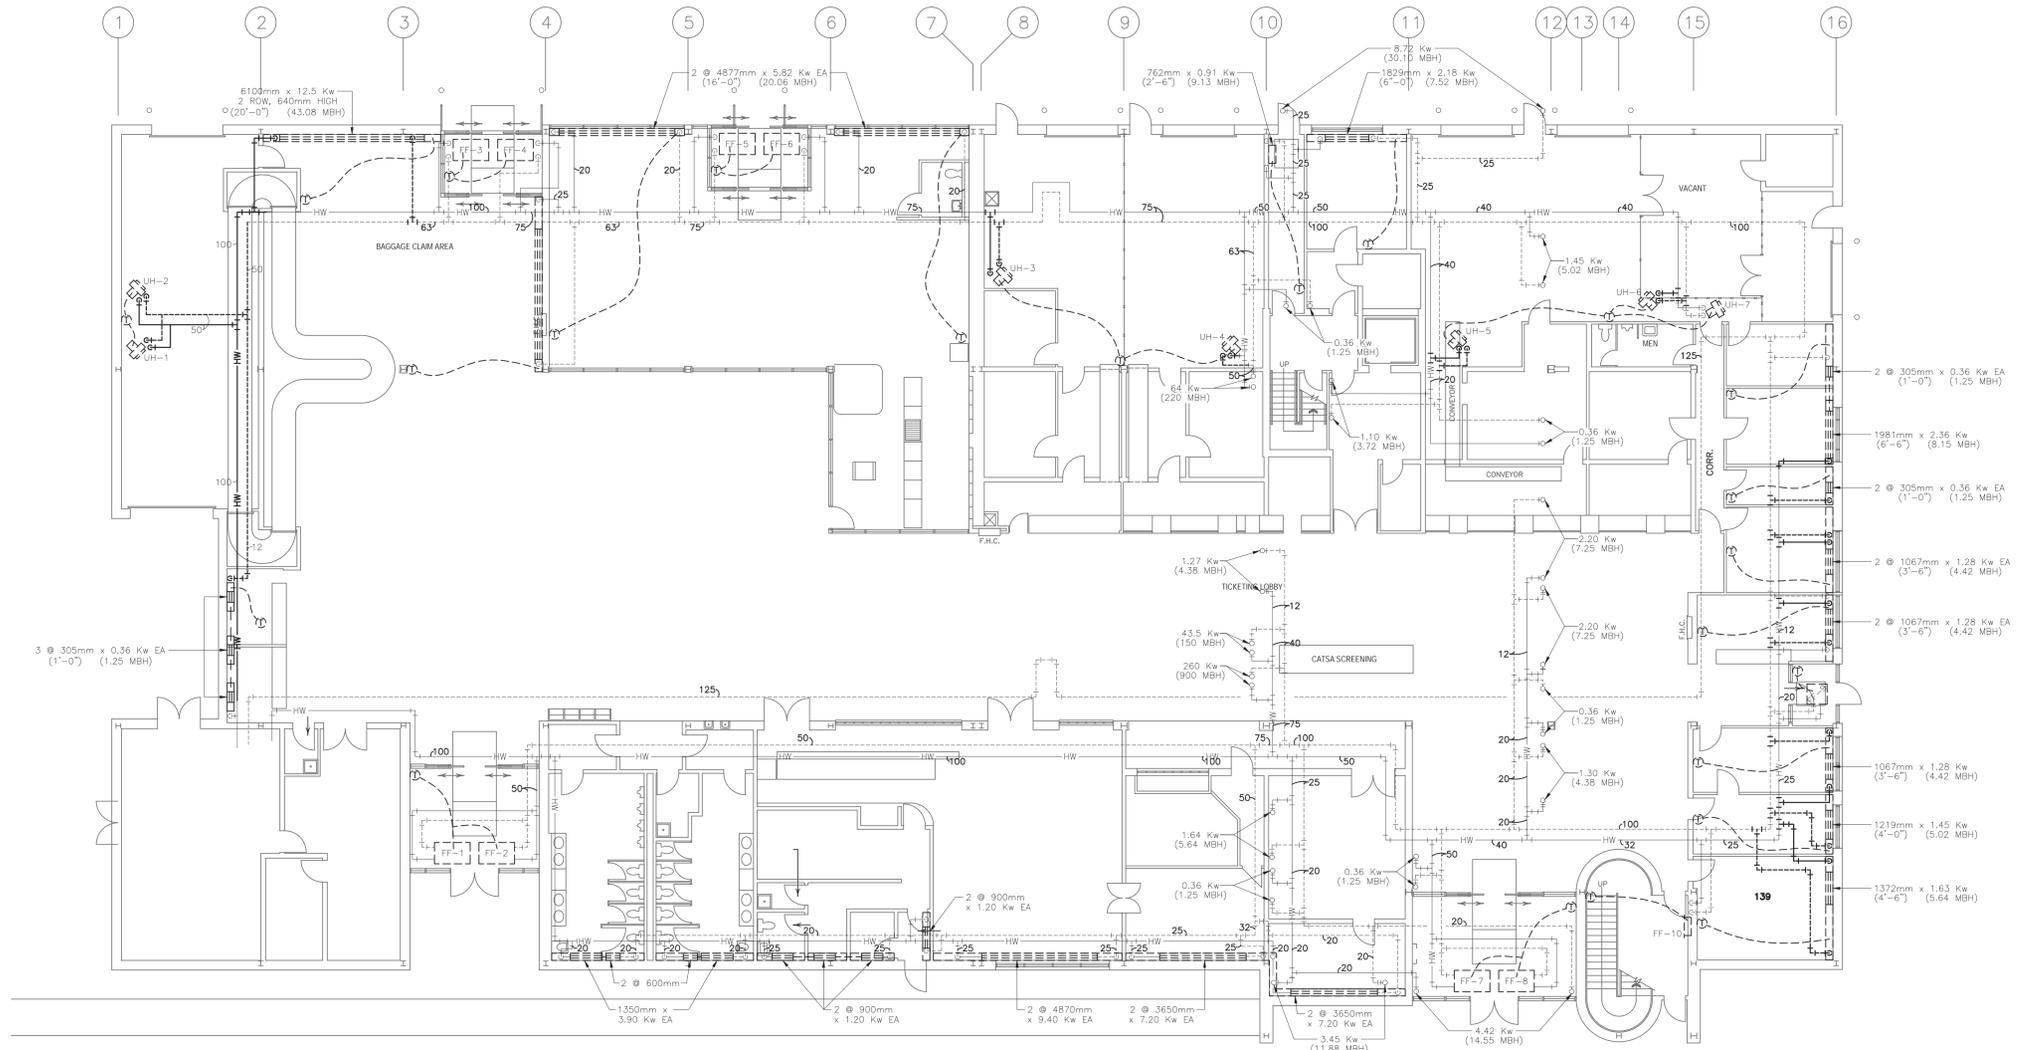

**FLOOR PLAN -- LEVEL 1 HEATING DEMOLITION**

SCALE : 1:125  
0m 1 2 3 4 5 6 7 8 9 10m



0	ISSUED FOR TENDER	MARCH 30, 2017
revisions	DATE	DATE

project **WABUSH ATB RENOVATION**  
**WABUSH AIRPORT**  
WABUSH, NL

drawing **FLOOR PLAN**  
**LEVEL 1 HEATING**  
**DEMOLITION**

designed TG	conçu
drawn KK	dessiné
date APRIL 2016	date
approved	approuvé

date 2017/05/10  
Tender Soumission  
PWSC Project Manager Administrateur de projets TPSCC  
project number no. du projet  
**R.076412.001**

drawing no. **M-800** no. du dessin