

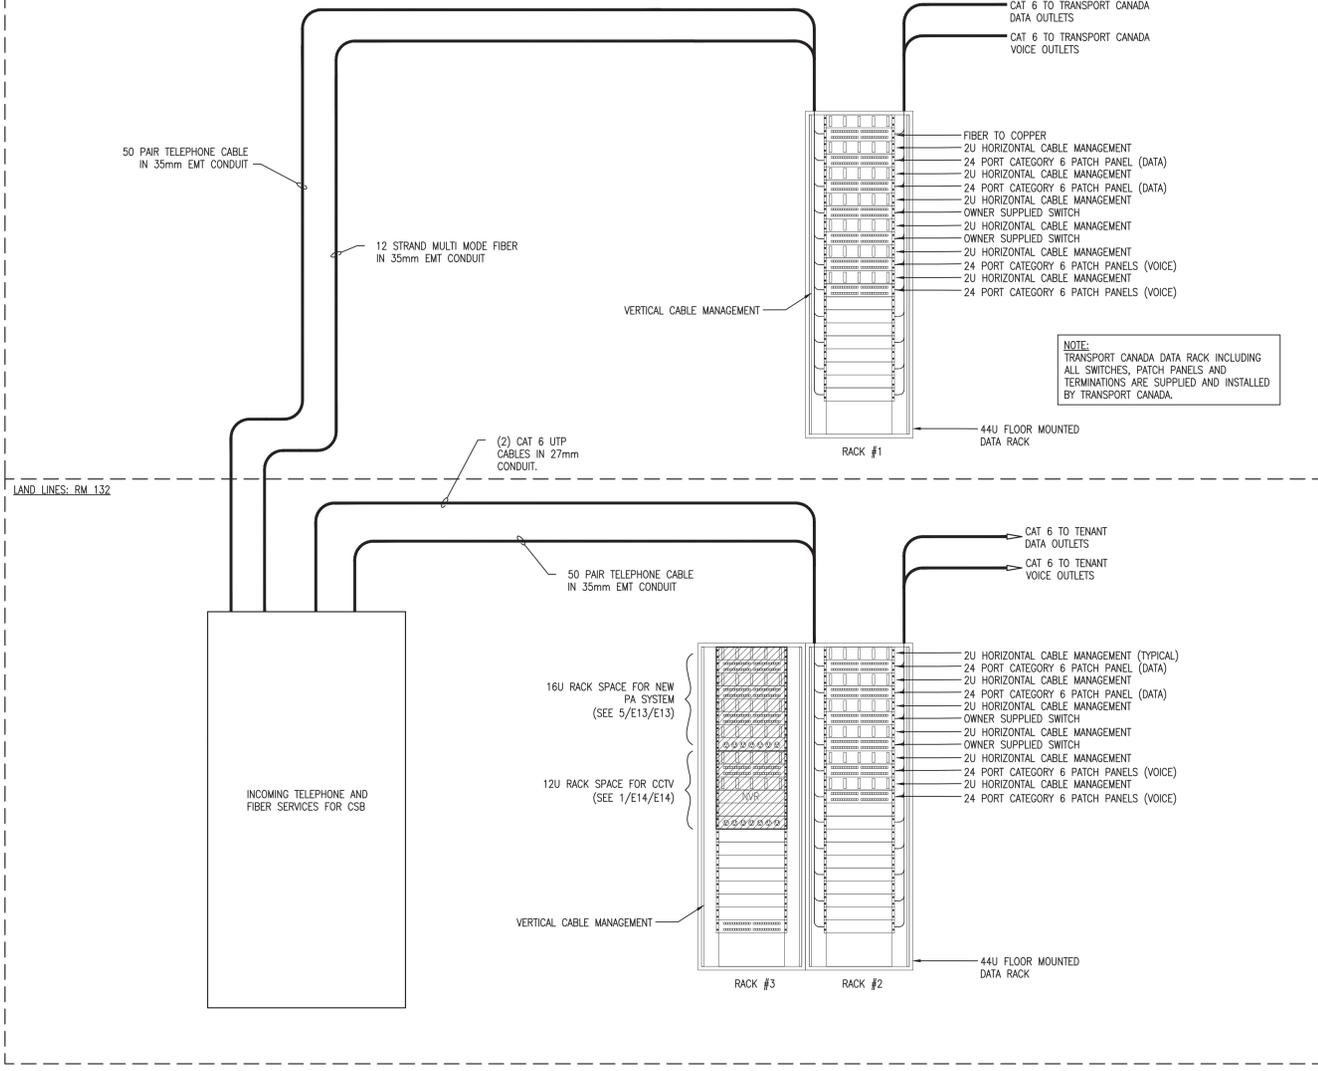
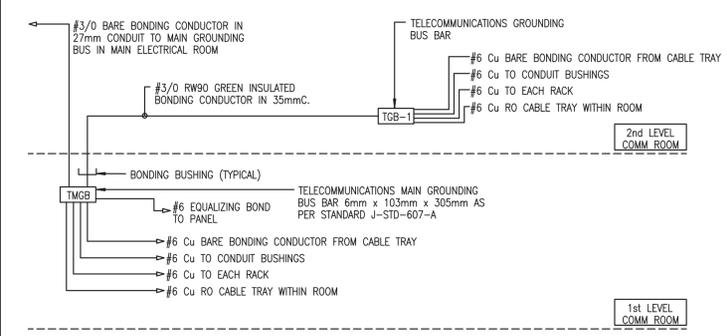


EQUIPMENT ROOM: RM 221

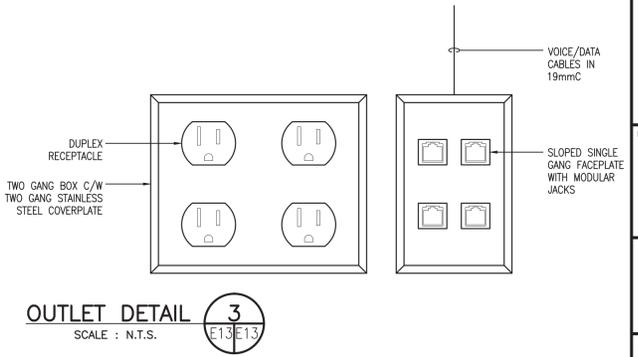


DATA/TELEPHONE RISER 1
SCALE : N.T.S.

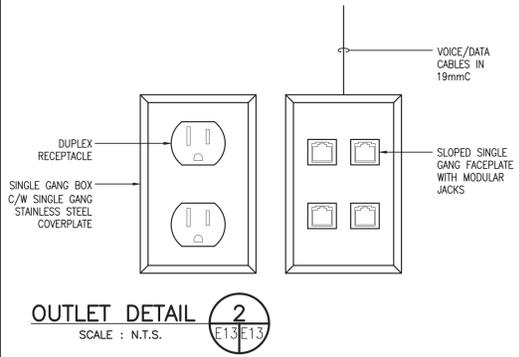

- NOTES**
- ALL BONDING CONNECTORS TO TMGB AND TG BUSHING REQUIRE TWO BOLT LONG BARREL COMPRESSION CONNECTORS.
 - BOND ALL METALLIC RACEWAYS, SLEEVES, PANELBOARD ENCLOSURES, CABLE TRAYS, ETC. WITHIN SERVER ROOM TO TELECOMMUNICATIONS MAIN GROUNDING BUSBAR.
 - MOUNT TMGB AND TGB BUSBARS ON INSULATED SUPPORTS.
 - PROVIDE LAMACOID NAMEPLATE ON COMMUNICATIONS BONDING CONDUCTORS AS FOLLOWS.
 - PROVIDE LAMACOID IDENTIFICATION TAGS AT BOTH ENDS OF EACH BONDING CONDUCTOR INDICATING ROOM NUMBER IT TERMINATES IN.
 - REFER TO SPECIFICATIONS.

TELECOMMUNICATION GROUNDING & BONDING 4
SCALE : N.T.S.

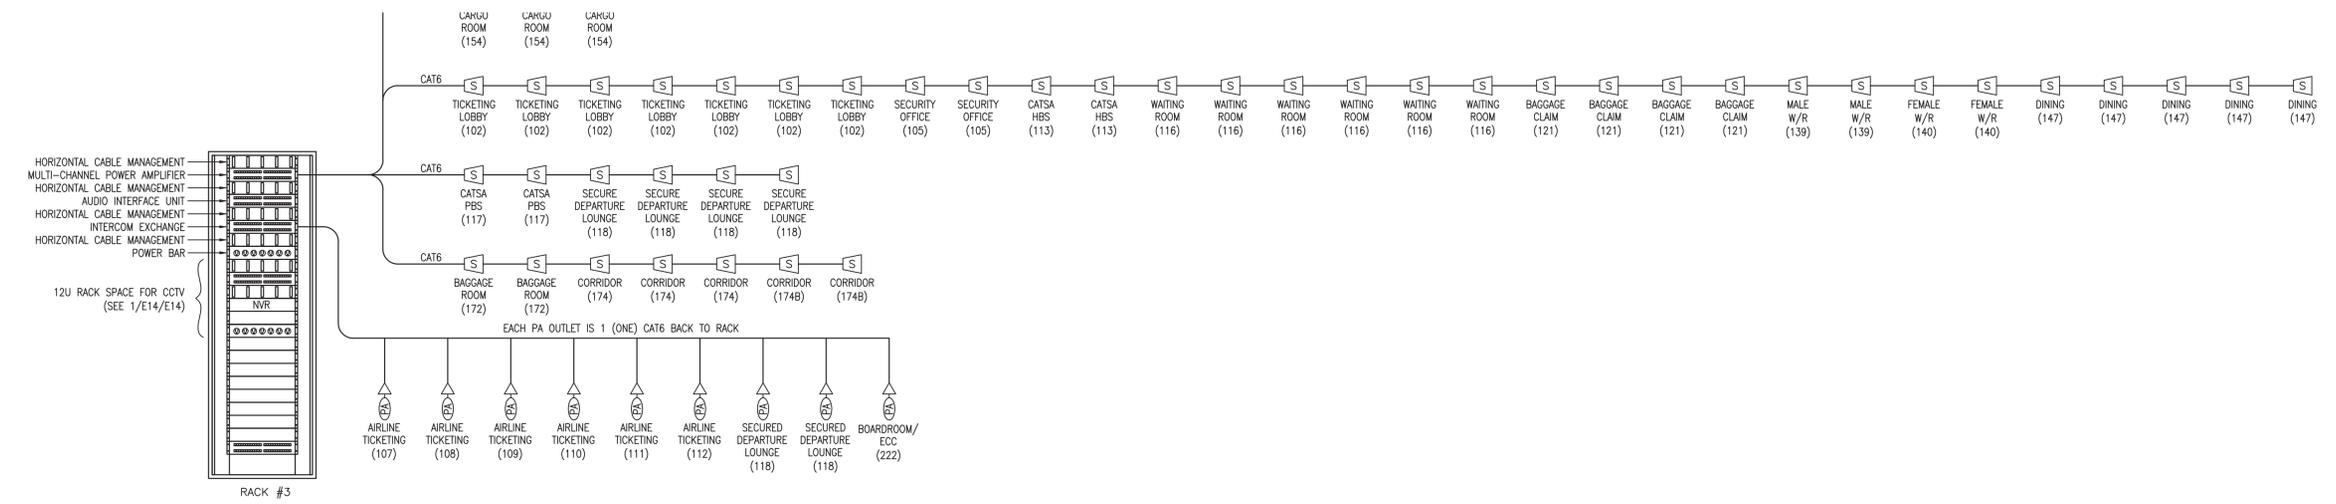

PA SYSTEM RISER 5
SCALE : N.T.S.



prime consultant: **ARCHITECTURE 49**



F	ISSUED FOR TENDER	MAR 30 2017
E	ISSUED FOR 99% REVIEW	FEB 10 2017
D	ISSUED FOR 66% REVIEW	NOV 4 2016
C	ISSUED FOR 33% REVIEW	AUG 5 2016
B	DESIGN DEVELOPMENT	MAY 27 2016
A	DESIGN DEVELOPMENT	MAR 26 2016
revisions		date

project **WABUSH ATB RENOVATIONS** project

WABUSH AIRPORT WABUSH, NL

drawing **COMMUNICATIONS RISERS & DETAILS** dessin

designed	C.MACINTYRE	conçu
date	MAY 2016	
drawn	M.KAMPHUIS	dessiné
date	MAY 2016	
approved	C.MACINTYRE	approuvé
date	MAY 2016	
Tender	2017/05/10	Submission
PWGSC Project Manager	Administrateur de projets TPSGC	
project number	R.076412.001	no. du projet
drawing no.	E13	no. du dessin