


SHROUD - PLAN VIEW

- NOTES:**
1. SPLICES IN ALL ELECTRICAL SHROUD JUNCTION BOXES ARE TO BE MADE USING MECHANICAL BOLTED CONNECTORS AND HEAT SHRINK BOOTS.
 2. EACH SHROUD TO BE BONDED.
 3. ALL DIMENSIONS ARE IN MILLIMETRES AND REPRESENT MINIMUM VALUES.
 4. ALL METAL TO BE GALVANIZED STEEL.


EQUIPMENT/MATERIALS LIST - ALL POWER CENTRES

- 1- 15A, 125V, SINGLE GFCI RECEPTACLE, CSA CONFIGURATION 5-15, MARINE GRADE C/W HINGED AND GASKETTED, MOUNTED IN STANDARD TYPE FD NON-METALLIC DEVICE BOX
- 2- MOULDED PVC JUNCTION BOX, EEMAC 4 X RATED, c/w MOUNTING FEET, GASKETTED SCREW DOWN COVER WITH STAINLESS STEEL SCREWS. 200mm x 200mm x 100mm Dp.

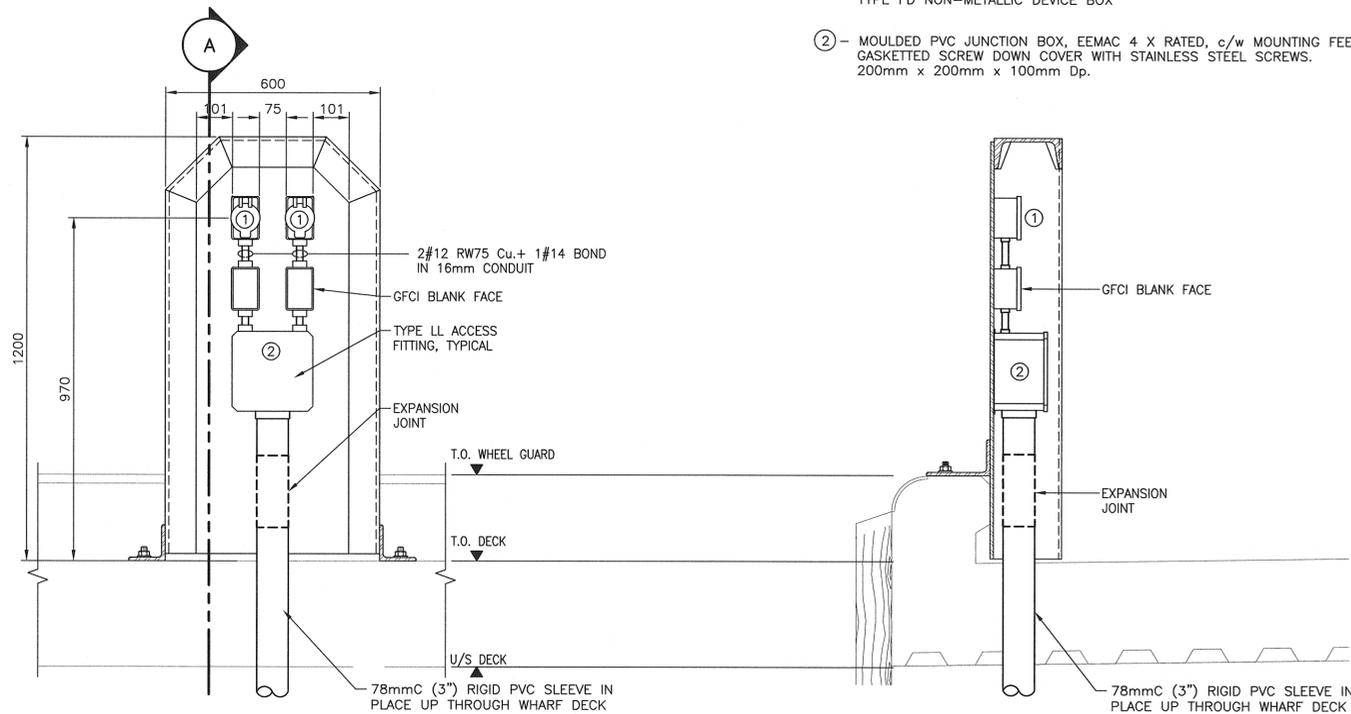

DETAIL - TYPICAL ELECTRICAL SHROUD



SECTION 'A'

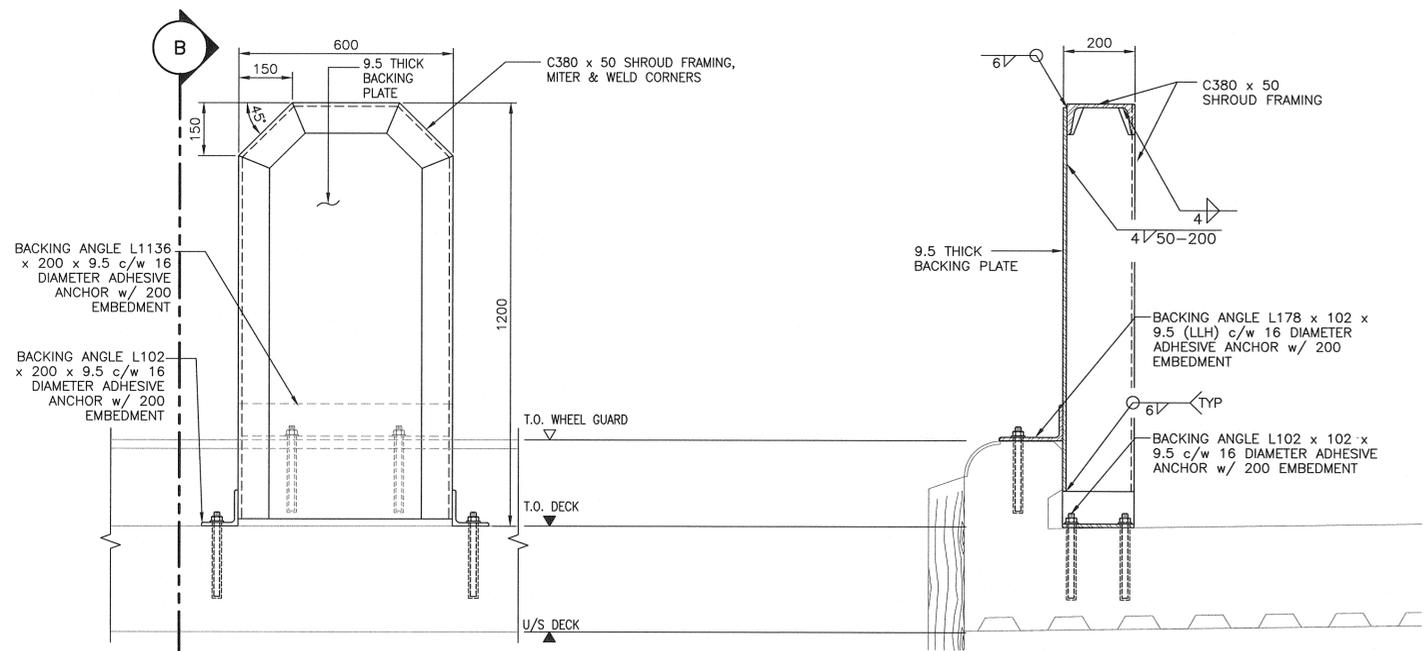

STRUCTURAL DETAIL - ELECTRICAL SHROUD


SECTION 'B'

DETAIL - POWER CENTRE (TYP.)

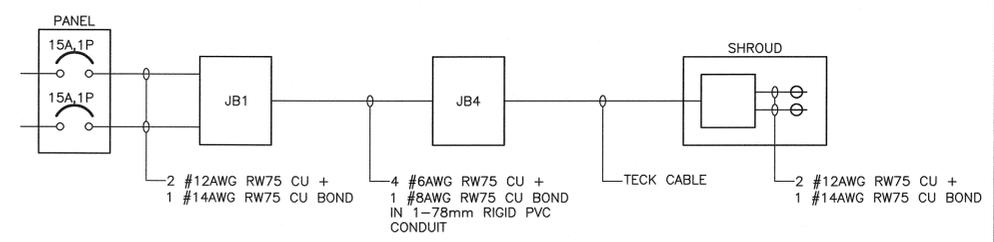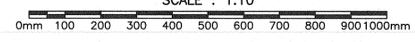


FEEDER WIRING - SHROUD 1 (S1)

SCALE : N.T.S.

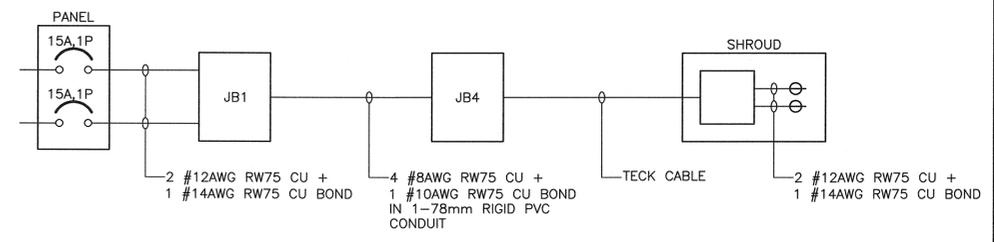


FEEDER WIRING - SHROUD 2 (S2)

SCALE : N.T.S.

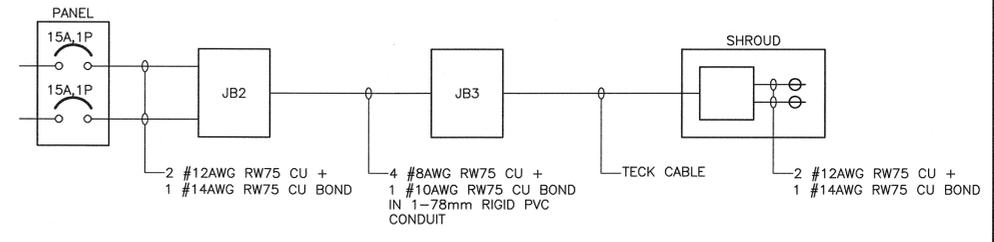


FEEDER WIRING - SHROUD 3 (S3)

SCALE : N.T.S.

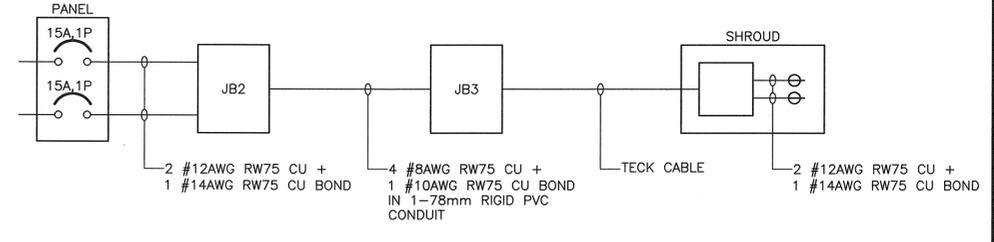

FEEDER WIRING - SHROUD 4 (S4)

SCALE : N.T.S.

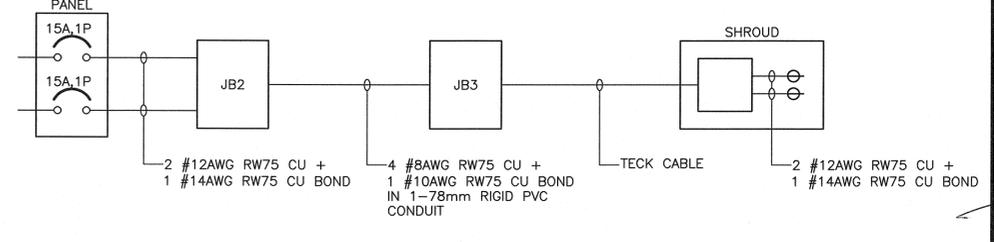

FEEDER WIRING - SHROUD 5 (S5)

SCALE : N.T.S.



0	ISSUED FOR TENDER	JUN 23 2017
revisions		date

project
WHARF RECONSTRUCTION
MARGAREE HARBOUR
INVERNESS COUNTY
NOVA SCOTIA

ELECTRICAL DETAILS

designed	M.NAIDU	conçu
date	JUN. 2017	
drawn	M.KAMPHUIS	dessiné
date	JUN. 2017	
approved	M.NAIDU	approuvé
date	JUN. 2017	
Tender	Soumission	
PWGSC Project Manager	Administrateur de projets	TPSGC
project number	no. du projet	
	R.082860.001	
drawing no.	no. du dessin	
	E5 of 6	