



SHROUD - PLAN VIEW

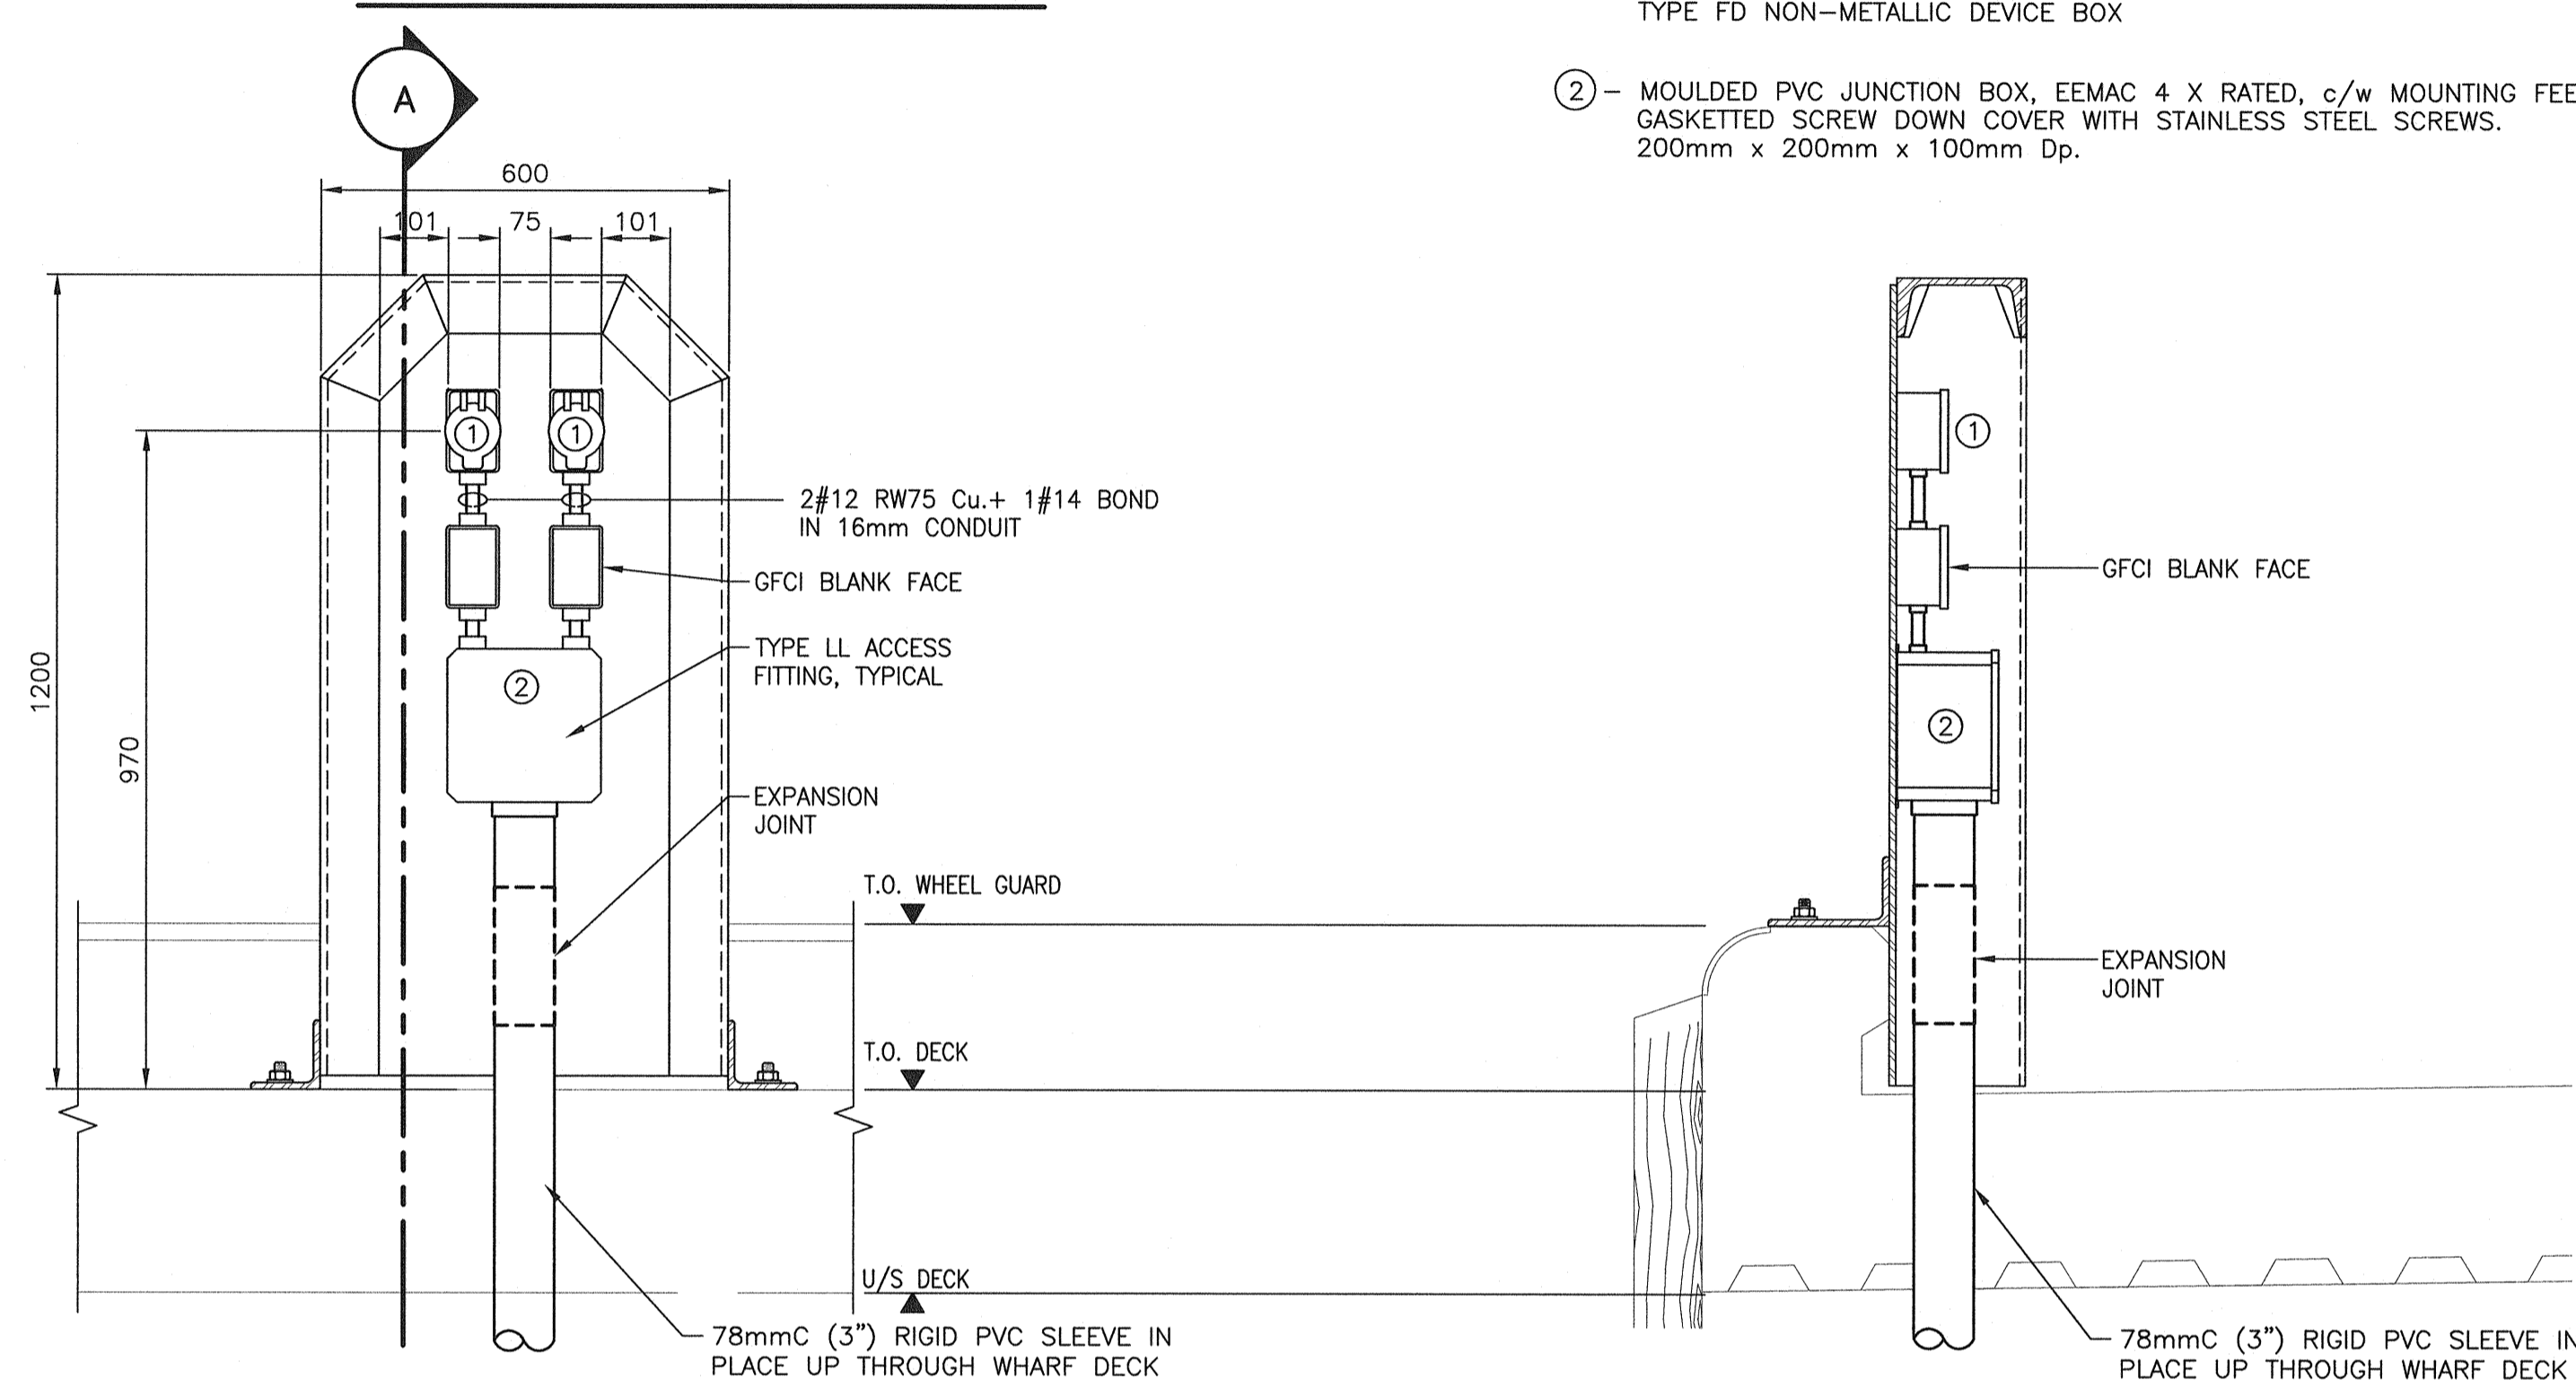

DETAIL - TYPICAL ELECTRICAL SHROUD

SECTION 'A'

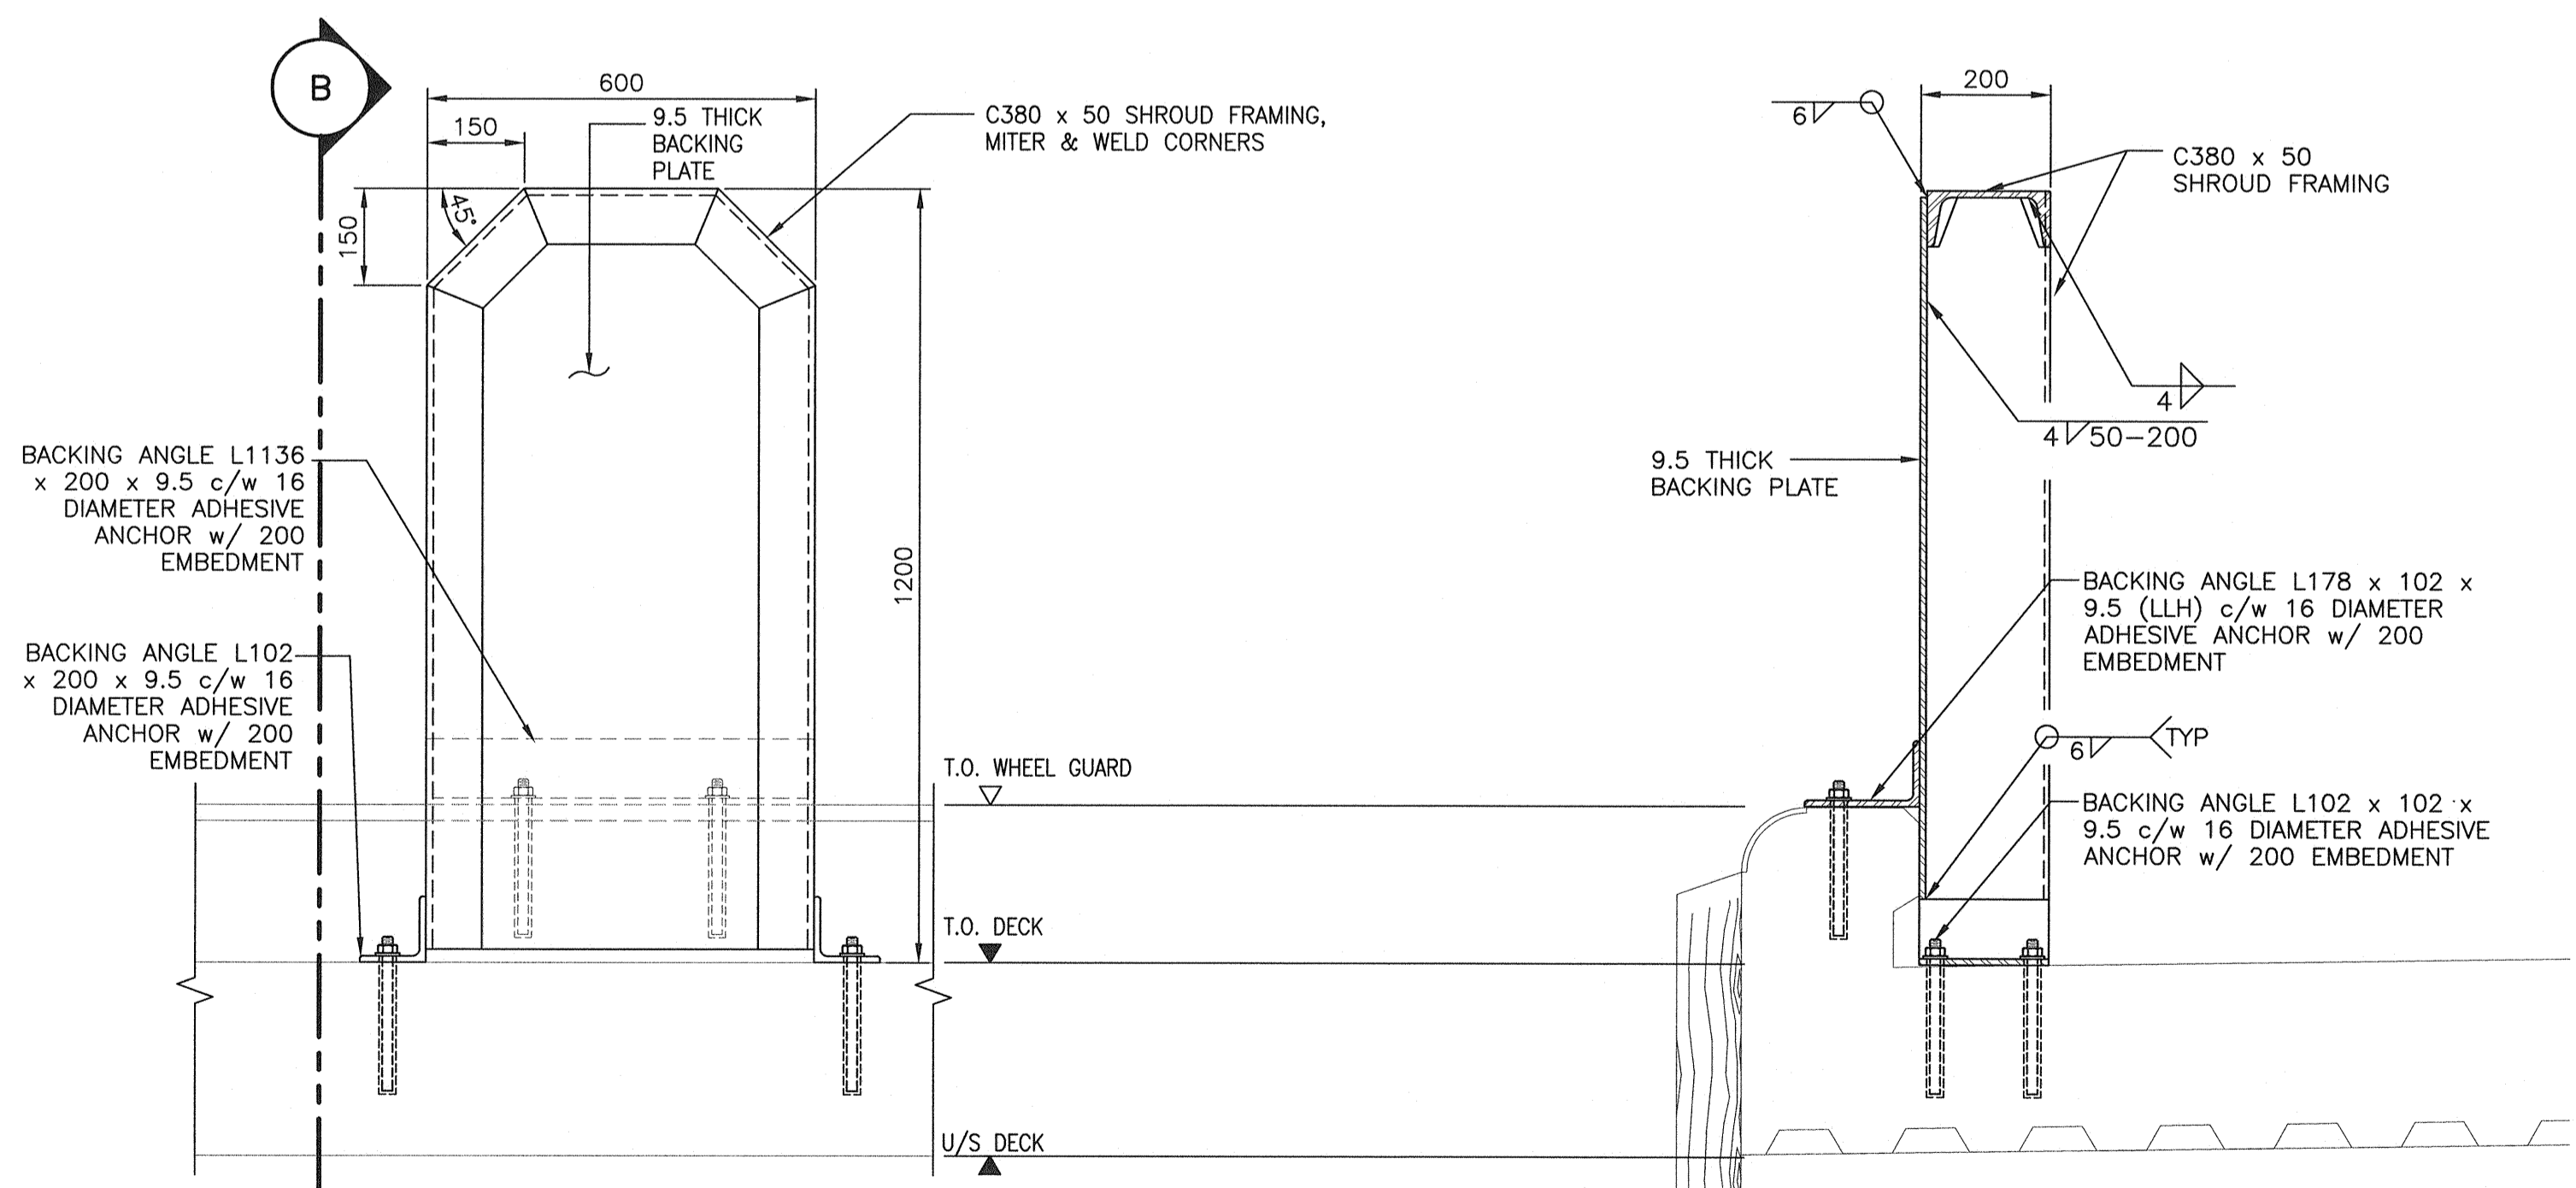

STRUCTURAL DETAIL - ELECTRICAL SHROUD

SECTION 'B'

DETAIL - POWER CENTRE (TYP.)

SCALE : 1:10


0mm 100 200 300 400 500 600 700 800 900 1000mm

NOTES:

1. SPLICES IN ALL ELECTRICAL SHROUD JUNCTION BOXES ARE TO BE MADE USING MECHANICAL BOLTED CONNECTORS AND HEAT SHRINK BOOTS.
2. EACH SHROUD TO BE BONDED.
3. ALL DIMENSIONS ARE IN MILLIMETRES AND REPRESENT MINIMUM VALUES.
4. ALL METAL TO BE GALVANIZED STEEL.


EQUIPMENT/MATERIALS LIST - ALL POWER CENTRES

- 1- 15A, 125V, SINGLE GFCI RECEPTACLE, CSA CONFIGURATION 5-15, MARINE GRADE C/W HINGED AND GASKETTED. MOUNTED IN STANDARD TYPE FD NON-METALLIC DEVICE BOX
- 2- MOULDED PVC JUNCTION BOX, EEMAC 4 X RATED, c/w MOUNTING FEET, GASKETTED SCREW DOWN COVER WITH STAINLESS STEEL SCREWS. 200mm x 200mm x 100mm Dp.

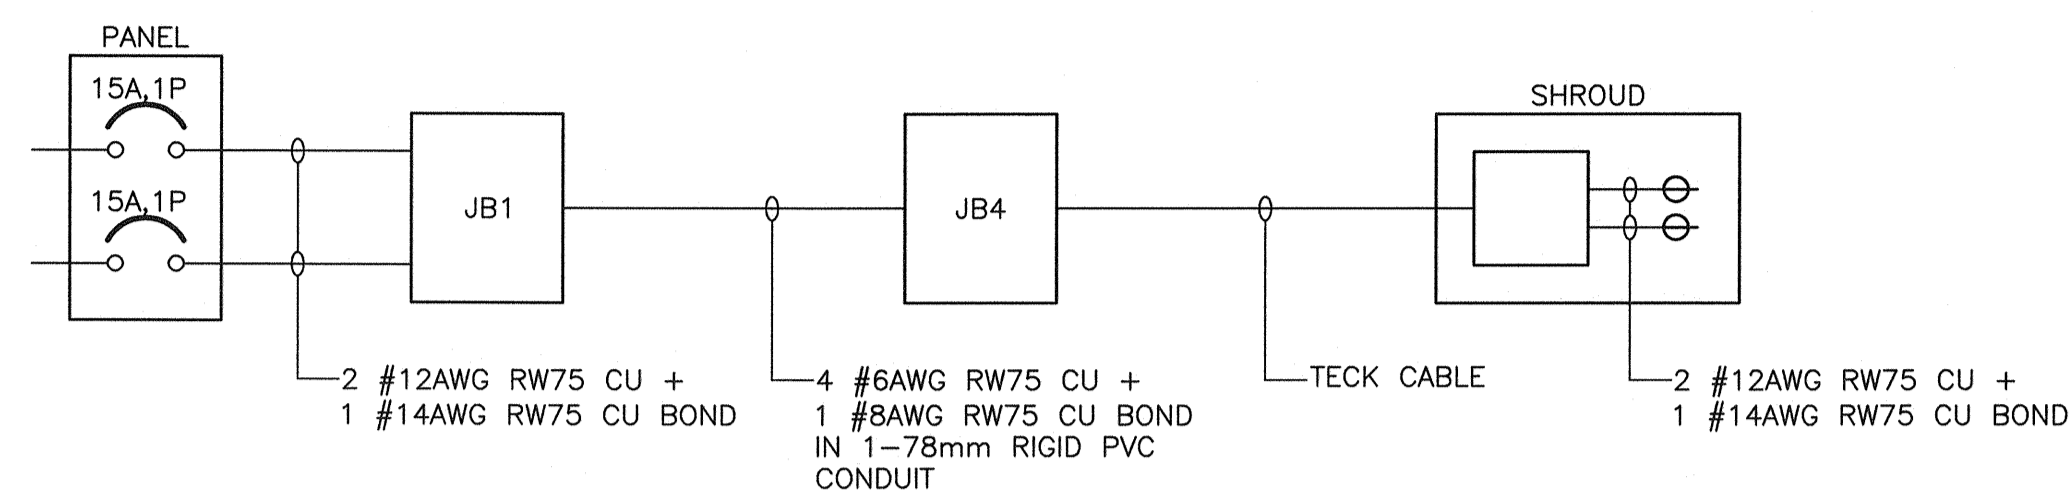


FEEDER WIRING - SHROUD 1 (S1)

SCALE : N.T.S.

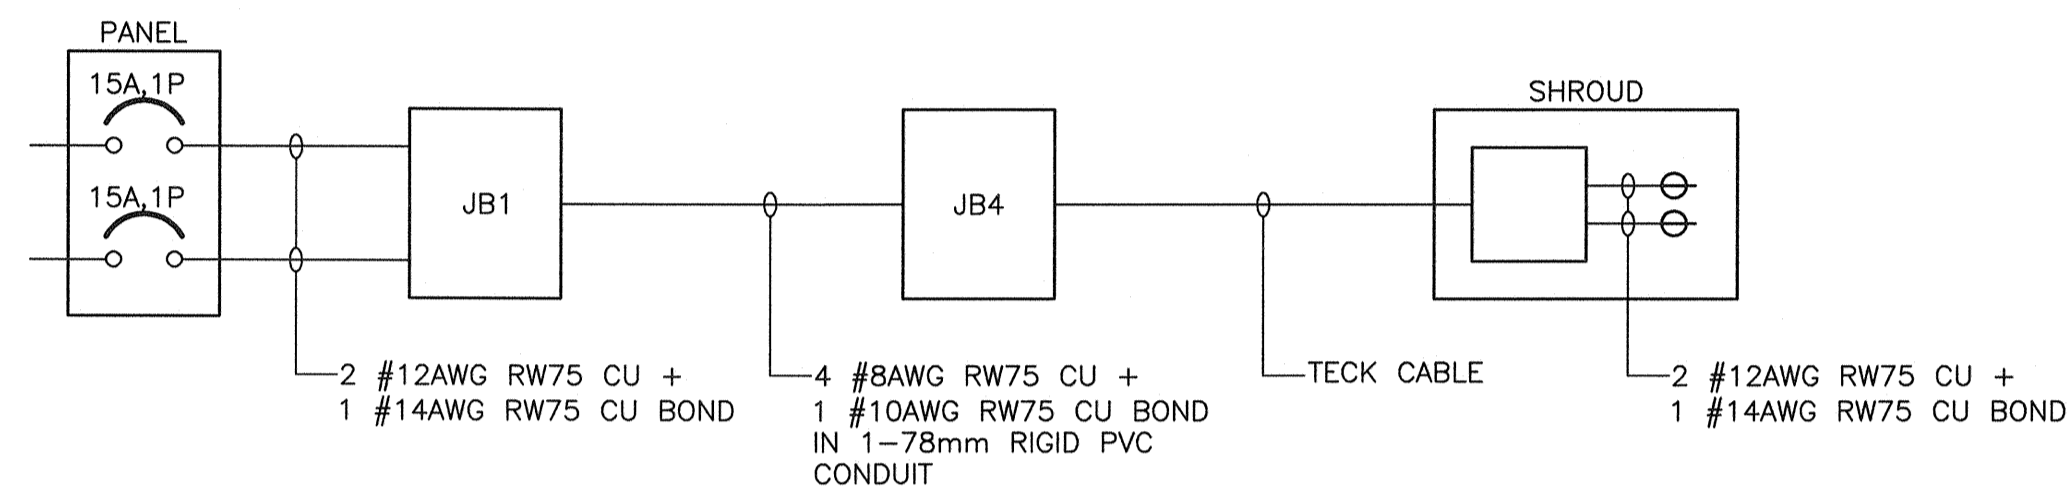


FEEDER WIRING - SHROUD 2 (S2)

SCALE : N.T.S.

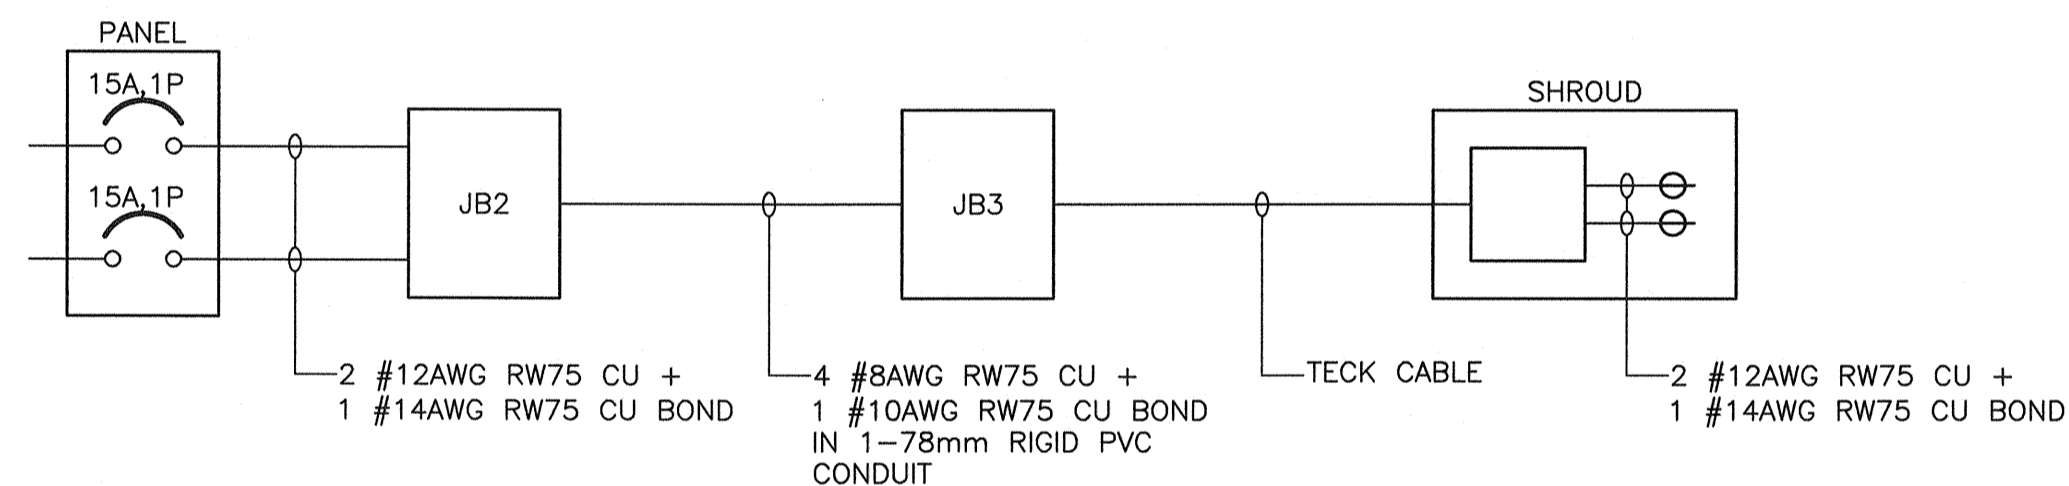


FEEDER WIRING - SHROUD 3 (S3)

SCALE : N.T.S.

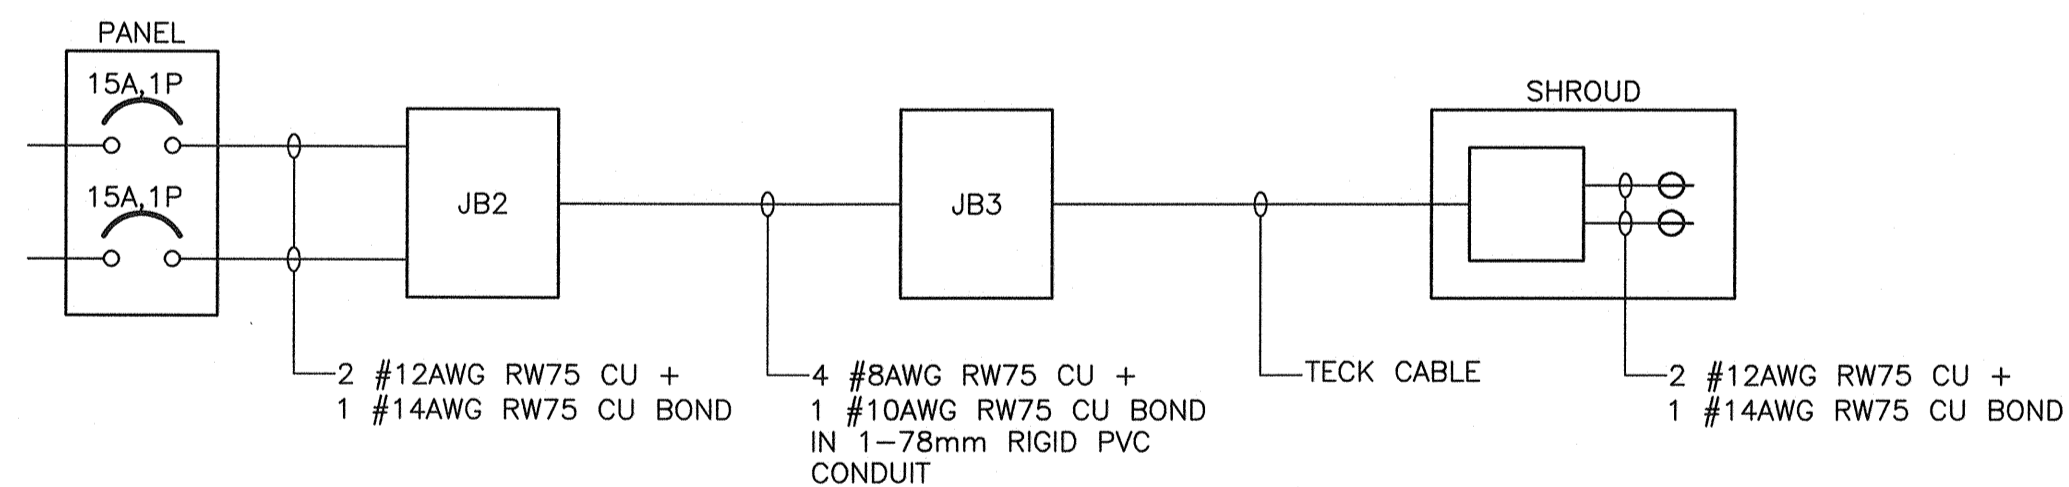


FEEDER WIRING - SHROUD 4 (S4)

SCALE : N.T.S.

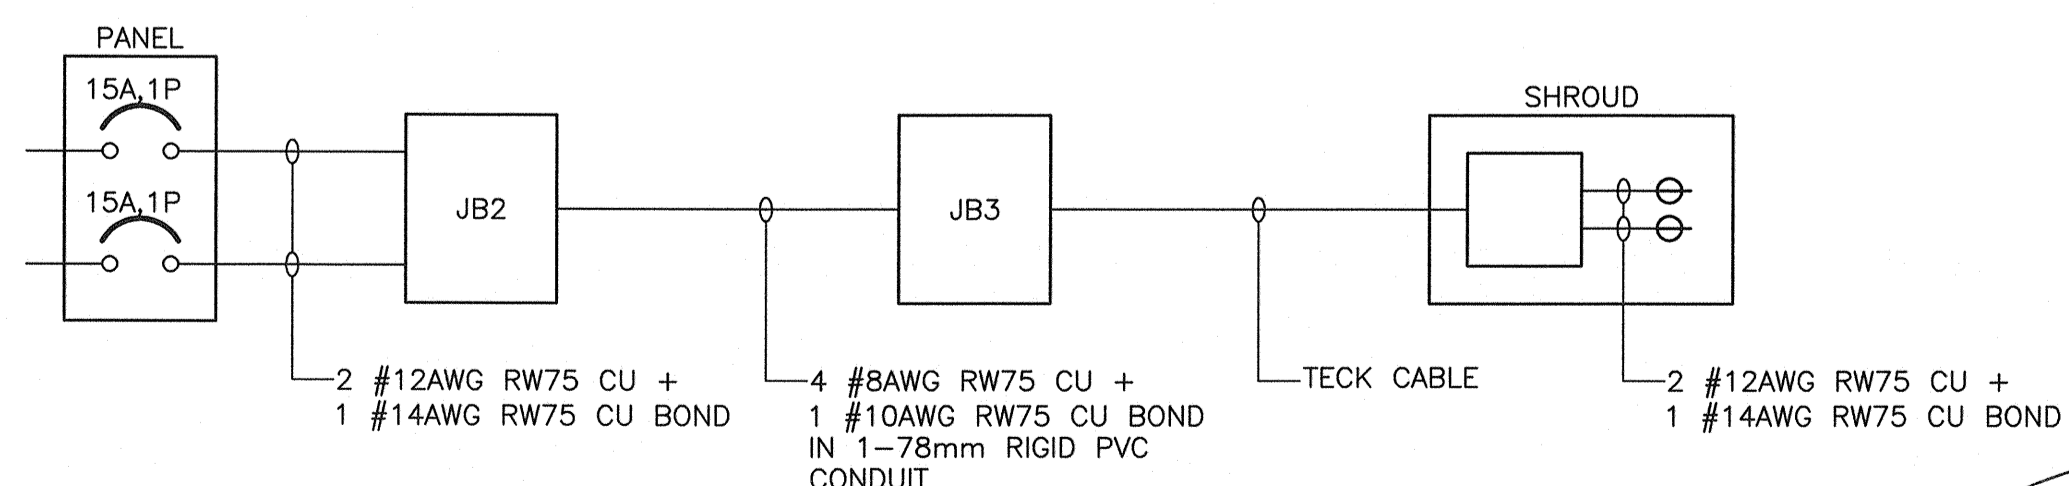

FEEDER WIRING - SHROUD 5 (S5)

SCALE : N.T.S.

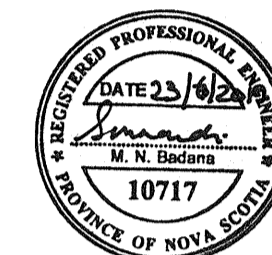

0	ISSUED FOR TENDER	JUN 23 2017
revisions		date
project		projet

WHARF RECONSTRUCTION  
MARGAREE HARBOUR  
INVERNESS COUNTY  
NOVA SCOTIA

drawing dessin

ELECTRICAL DETAILS

designed	M.NAIDU	conçu
date	JUN. 2017	
drawn	M.KAMPHUIS	dessiné
date	JUN. 2017	
approved	M.NAIDU	approuvé
date	JUN. 2017	
Tender		Soumission
PWGSC Project Manager	Administrateur de projets TPSGC	
project number		no. du projet
	R.082860.001	
drawing no.		no. du dessin
	E5 of 6	