


SITE PLAN

SCALE : 1:250

1
E-1

OLDCASTLE #H-SERIES 2436 POLYMER CONCRETE ENCLOSURE AND LID (OR APPROVED EQUAL) 610mm X 914mm, DEPTH TO BE SPECIFIED.

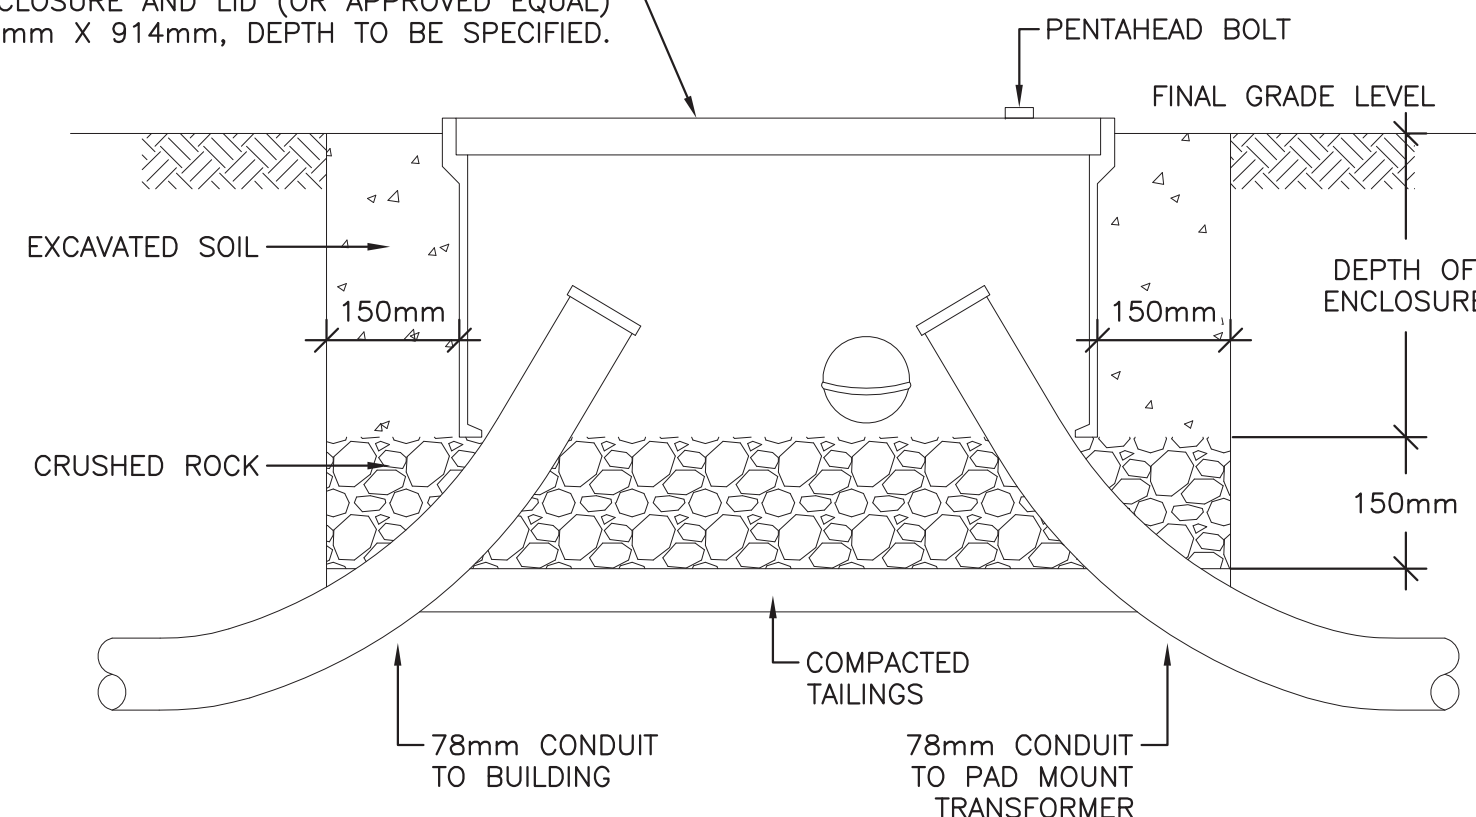

NOTES:



1. REFER TO PLANS FOR CONDUIT QUANTITIES.
2. COORDINATE INSTALLATION WITH NB POWER AND OWNER.

U/G PULL PIT
SCALE : N.T.S.

3
E-1

TRENCH A-A DETAIL

SCALE : N.T.S.

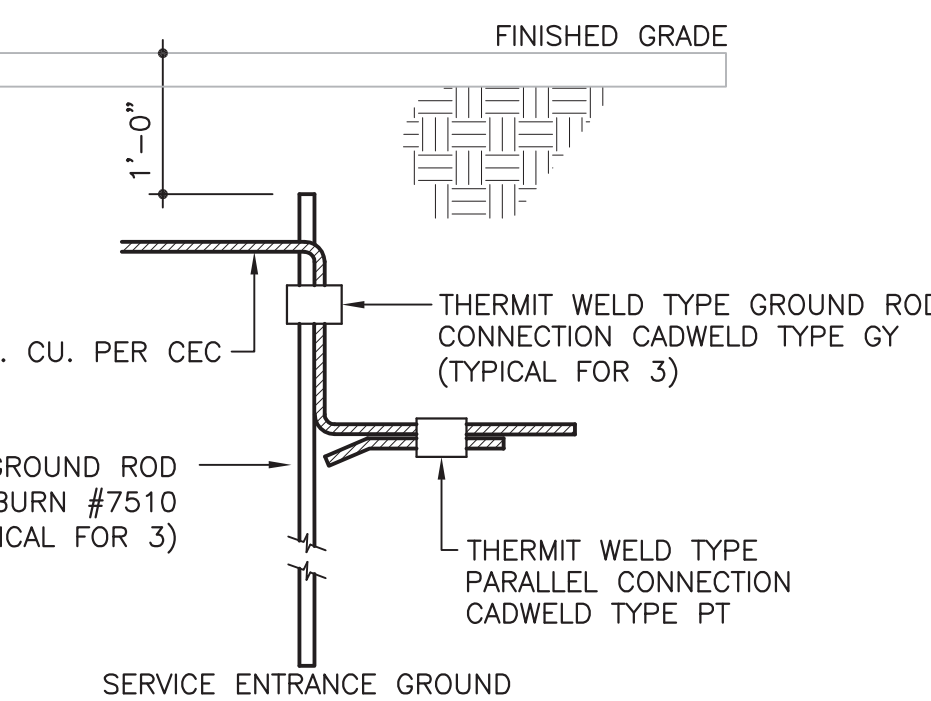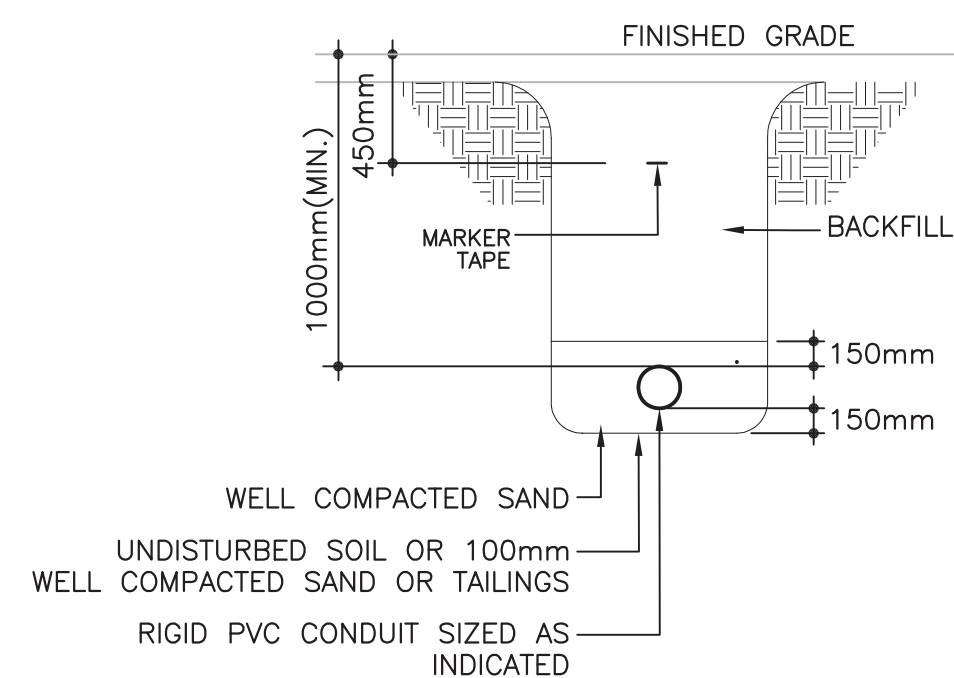

GROUND ROD DETAIL

SCALE : N.T.S.

5
E-1


LEGEND

SCALE : N.T.S.

2
E-1

SPECIFIC NOTES:

- ◇ COORDINATE EXACT LOCATION OF LUMINAIRE WITH CIVIL DRAWINGS AND ON SITE PERSONNEL PRIOR TO ROUGH-IN. ORIENT FIXTURE SUCH THAT ASYMMETRIC DISTRIBUTION IS MAXIMIZED TO ILLUMINATE PATHWAY.

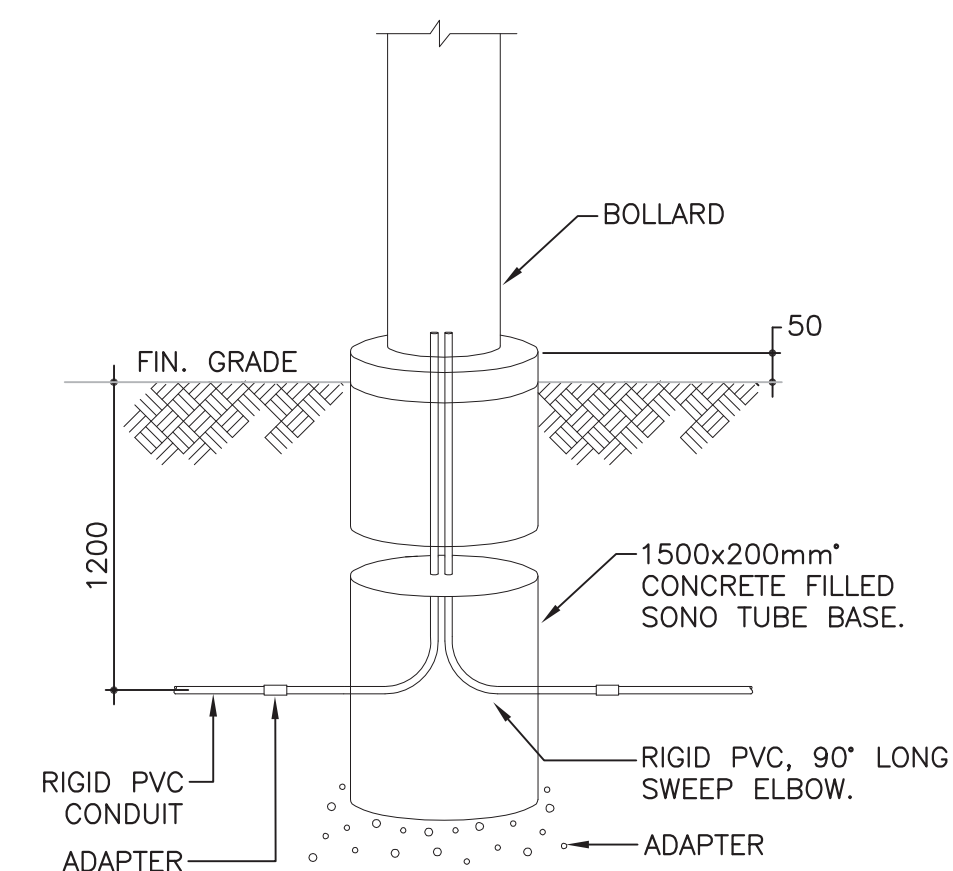

LIGHTING STANDARD BASE DETAIL

SCALE : N.T.S.

6
E-1

- LINEAR LUMINAIRE, TYPE AS SPECIFIED - REFER TO LUMINAIRE SCHEDULE.
- CEILING MOUNTED LUMINAIRE, TYPE AS SPECIFIED - REFER TO LUMINAIRE SCHEDULE.
- WALL MOUNTED LUMINAIRE, TYPE AS SPECIFIED - REFER TO LUMINAIRE SCHEDULE.
- ⦿ EMERGENCY LIGHTING SYSTEM DUAL REMOTE HEADS, 'BU-1' INDICATES WHICH BATTERY UNIT SERVES REMOTE. REFER TO LUMINAIRE SCHEDULE.
- ⦿ EMERGENCY LIGHTING BATTERY UNIT C/W DUAL HEADS, 'BU-1'. REFER TO LUMINAIRE SCHEDULE.
- ⦿ GREEN LED "RUNNING MAN" EXIT SIGN, RECESSED CEILING MOUNT OR WALL MOUNTED AS INDICATED, NUMBER OF FACES AND DIRECTIONAL ARROWS AS SHOWN. REFER TO LUMINAIRE SCHEDULE.
- ⦿ CEILING MOUNTED OCCUPANCY SENSOR, TYPE AS SPECIFIED
- ⦿ WALL MOUNTED PHOTOCELL, TYPE AS SPECIFIED
- ⦿ SINGLE POLE TOGGLE SWITCHES
- ⦿ 3-WAY SWITCH
- ⦿ THREE GANG SINGLE POLE TOGGLE SWITCHES
- ⦿ SWITCH MOUNTED OCCUPANCY SENSOR
- ⦿ 5-15R, 15A, 120V T-SLOT U-GROUND DUPLEX RECEPTACLE - STANDARD MOUNTING HEIGHT AND MOUNTED ABOVE COUNTER
- ⦿ 5-20R, 20A, 120V T-SLOT U-GROUND DUPLEX RECEPTACLE - STANDARD MOUNTING HEIGHT AND MOUNTED ABOVE COUNTER
- ⦿ 5-20R, 20A, 120V T-SLOT U-GROUND DUPLEX RECEPTACLE C/W GROUND FAULT CIRCUIT INTERRUPTER - STANDARD MOUNTING HEIGHT AND MOUNTED ABOVE COUNTER
- ELECTRICAL PANEL
- MOTOR CONNECTION AS SPECIFIED
- ⦿ 120/240 DIRECT CONNECTION.
- DISCONNECT SWITCH
- ⦿ RELAY
- ⦿ MOTOR STARTER AS SPECIFIED
- ⦿ RECESSED FAN FORCED HEATER, WHITE FINISH, C/W TAMPER PROOF B.I.T. RATED AS NOTED, 240, 1ø - STELPRO 'RWF' SERIES OR EQUAL BY OUELLET OR DUPLEX
- ▲ UNDERGROUND SECTION DETAIL IDENTIFIER. REFER TO DETAIL INDICATED.
- ◇ SPECIFIC NOTE TAG.
- 1 MECHANICAL EQUIPMENT TAG.
- B.I.T. INDICATES BUILT IN THERMOSTAT
- EX INDICATES EXISTING DEVICE TO REMAIN
- DW DISHWASHER
- WP WEATHER PROOF


A1544 (B)

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CHIGNECTO SOUTH KEY PLAN
FUNDY NATIONAL PARK
NOT TO SCALE



C	ISSUED FOR TENDER	MAR 29 2017
B	ISSUED FOR 99% REVIEW	FEB 06 2017
A	ISSUED FOR 66% REVIEW	DEC 21 2016
revisions		date

project
CHIGNECTO SOUTH MULTI PURPOSE BUILDING
FUNDY NATIONAL PARK
ALMA, NB
ALBERT COUNTY, NB

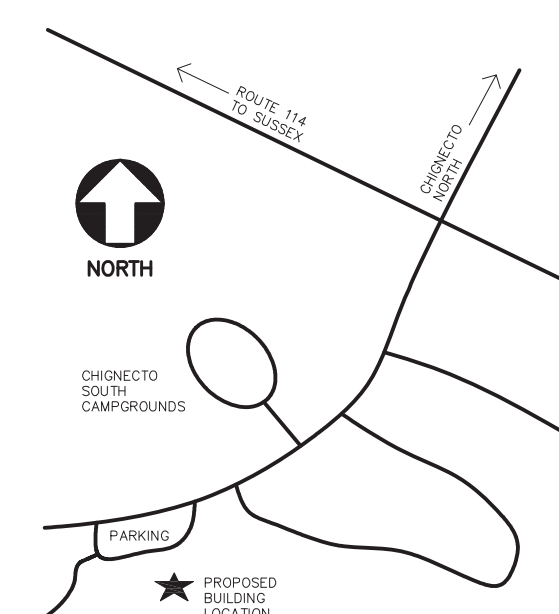drawing
SITE PLAN, DETAILS AND LEGEND
dessin

designed	D.KNICKLE	conçu
date	MAR. 29, 2017	
drawn	P.HALL	dessiné
date	MAR. 29, 2017	
approved	G.MacNEILL	approuvé
date	MAR. 29, 2017	
Tender		Soumission
PWGC Project Manager	Administrateur de projets (PWGC)	
project number	R.075816.001	no. du projet
drawing no.	E-1 OF 3	no. du dessin