



EXISTING / DEMOLITION PLAN

SCALE : 1:100

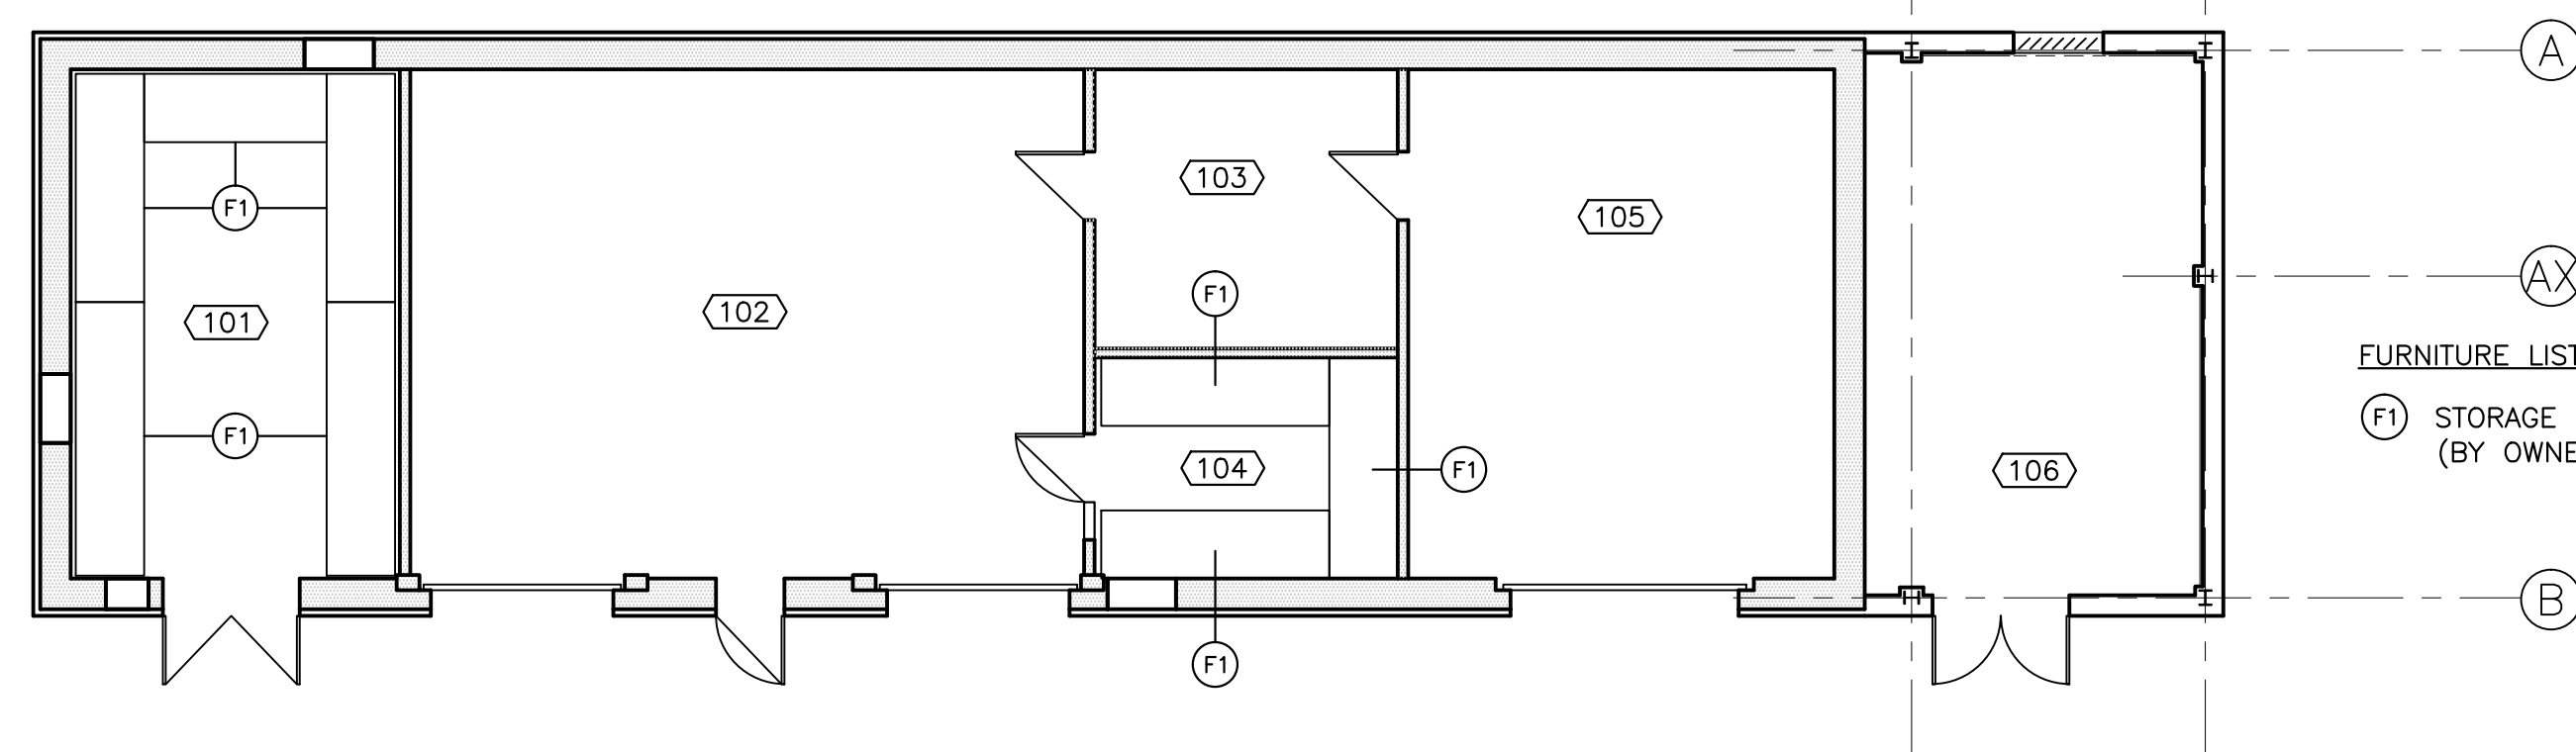


FURNITURE/EQUIPMENT PLAN

SCALE : 1:100

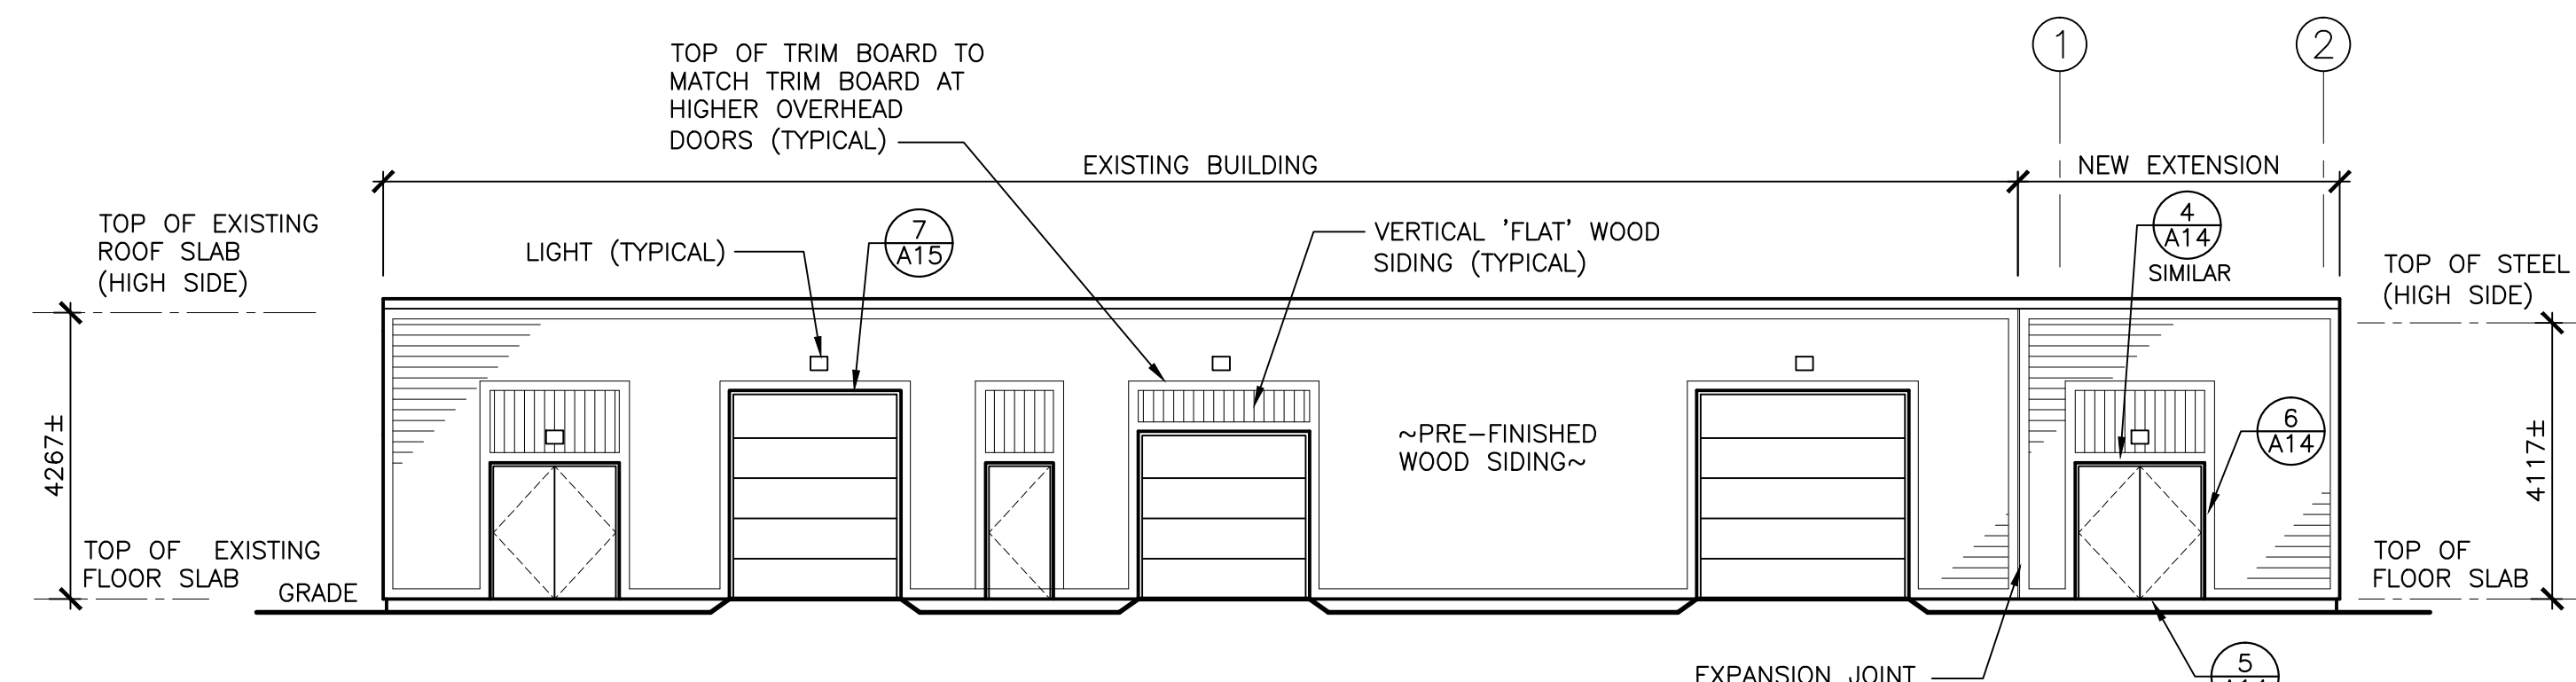

EAST ELEVATION

SCALE : 1:100

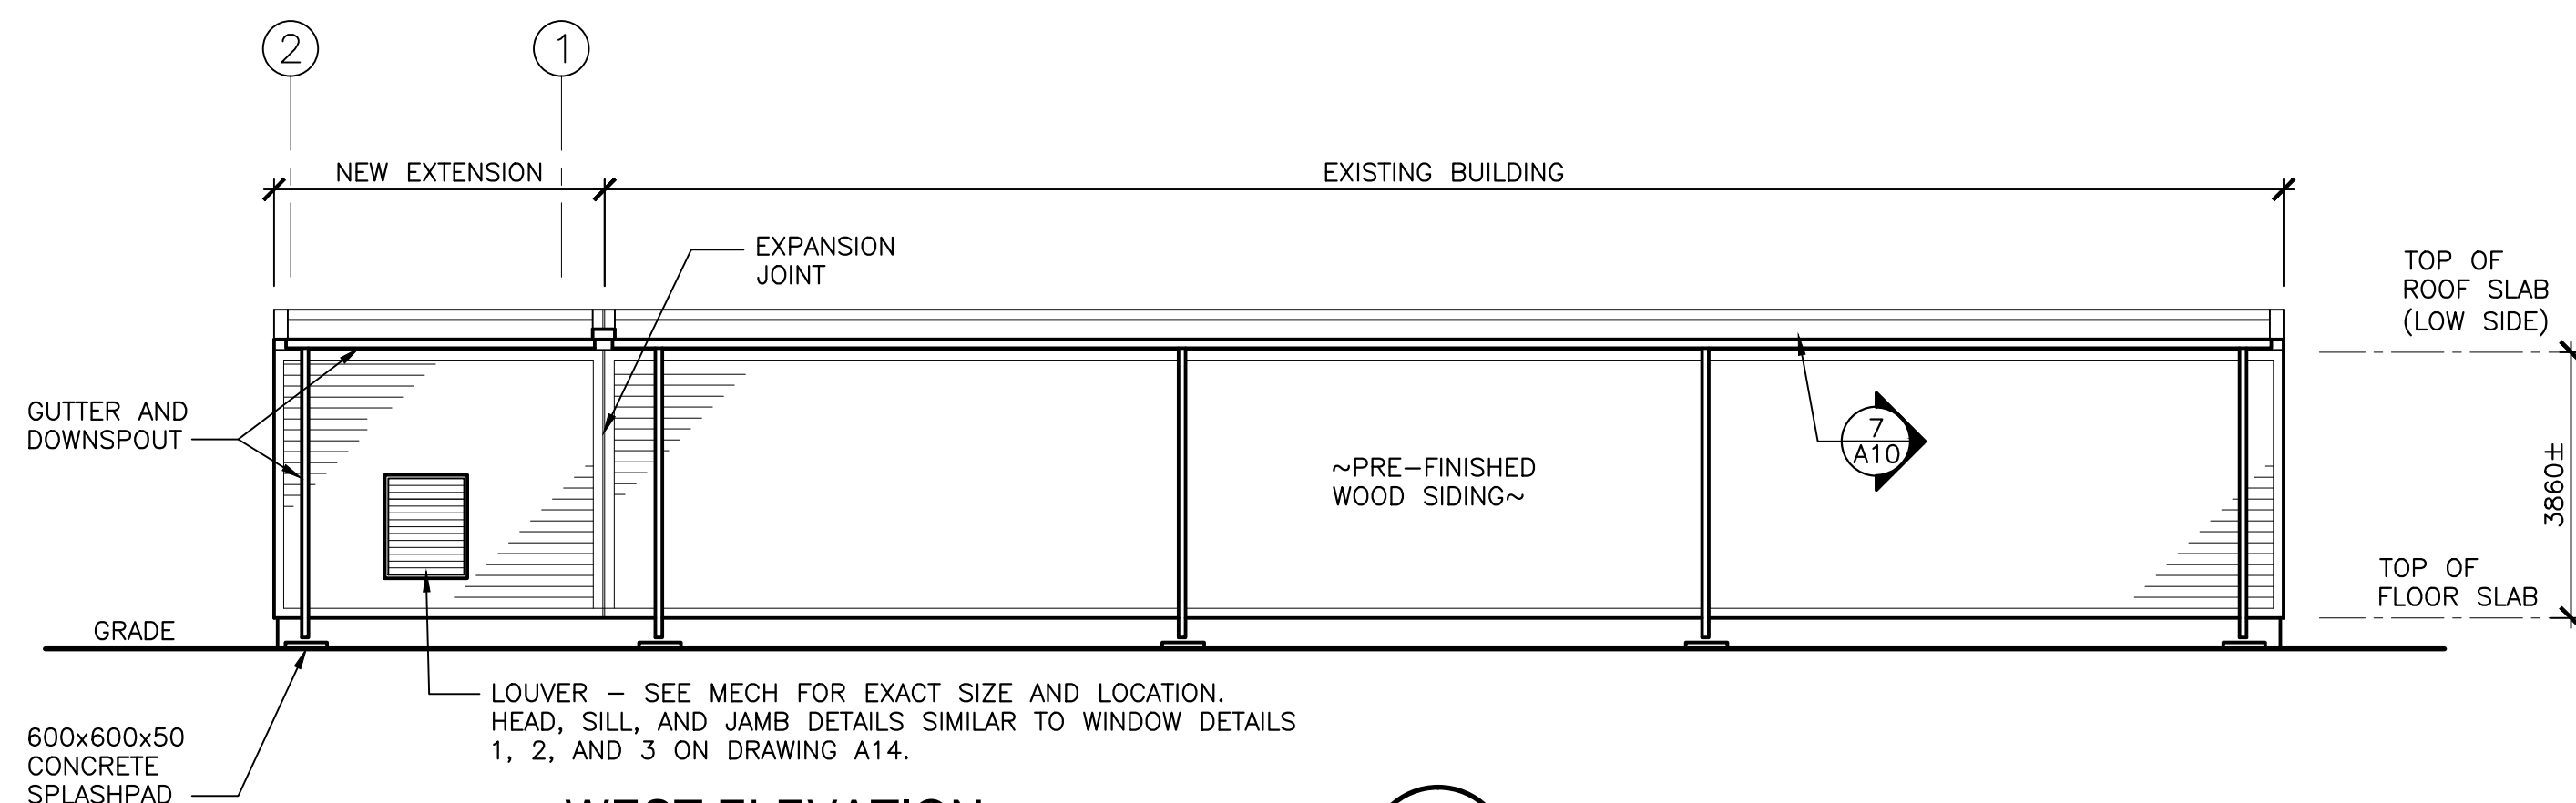


WEST ELEVATION

SCALE : 1:100

DEMOLITION KEYNOTES:


- (D1) REMOVE EXTERIOR FINISH (METAL SIDING, AIR/VAPOUR BARRIER, WOOD STRAPPING, RIGID INSULATION, AND ROOF EDGE FLASHING) TO EXPOSE EXISTING CONCRETE BLOCK.
- (D2) REMOVE METAL FLASHING AROUND PERIMETER OF ROOF
- (D3) REMOVE MECHANICAL HOOD AND ASSOCIATED COMPONENTS
- (D4) REMOVE OVERHEAD DOOR AND ASSOCIATED COMPONENTS
- (D5) REMOVE CONCRETE BLOCK ABOVE OVERHEAD DOOR AS REQUIRED FOR INSTALLATION OF NEW HIGHER OVERHEAD DOOR
- (D6) REMOVE CONCRETE BLOCK AND GYPSUM BOARD FURRING AS REQUIRED FOR INSTALLATION OF PERSON DOOR
- (D7) REMOVE/RELOCATE DOOR, FRAME, AND HARDWARE TO MAIN STORAGE AREA (SEE NEW FLOOR PLAN)
- (D8) REMOVE WASHROOM IN ITS ENTIRETY
- (D9) REMOVE BUILT-UP ROOFING MEMBRANES, INSULATION AND VAPOUR BARRIER DOWN TO EXISTING CONCRETE DECK, AND PERIMETER ROOF EDGE BLOCKING
- (D10) REMOVE 140 mm CONCRETE BLOCK PARTITION AS REQUIRED TO RELOCATE DOOR
- (D11) REMOVE/RELOCATE DOOR, FRAME, AND HARDWARE TO ROOM 104 (SEE NEW FLOOR PLAN)

NOTE: REFER TO CIVIL, STRUC, MECH, AND ELEC DRAWINGS FOR ADDITIONAL DEMOLITION REQUIREMENTS

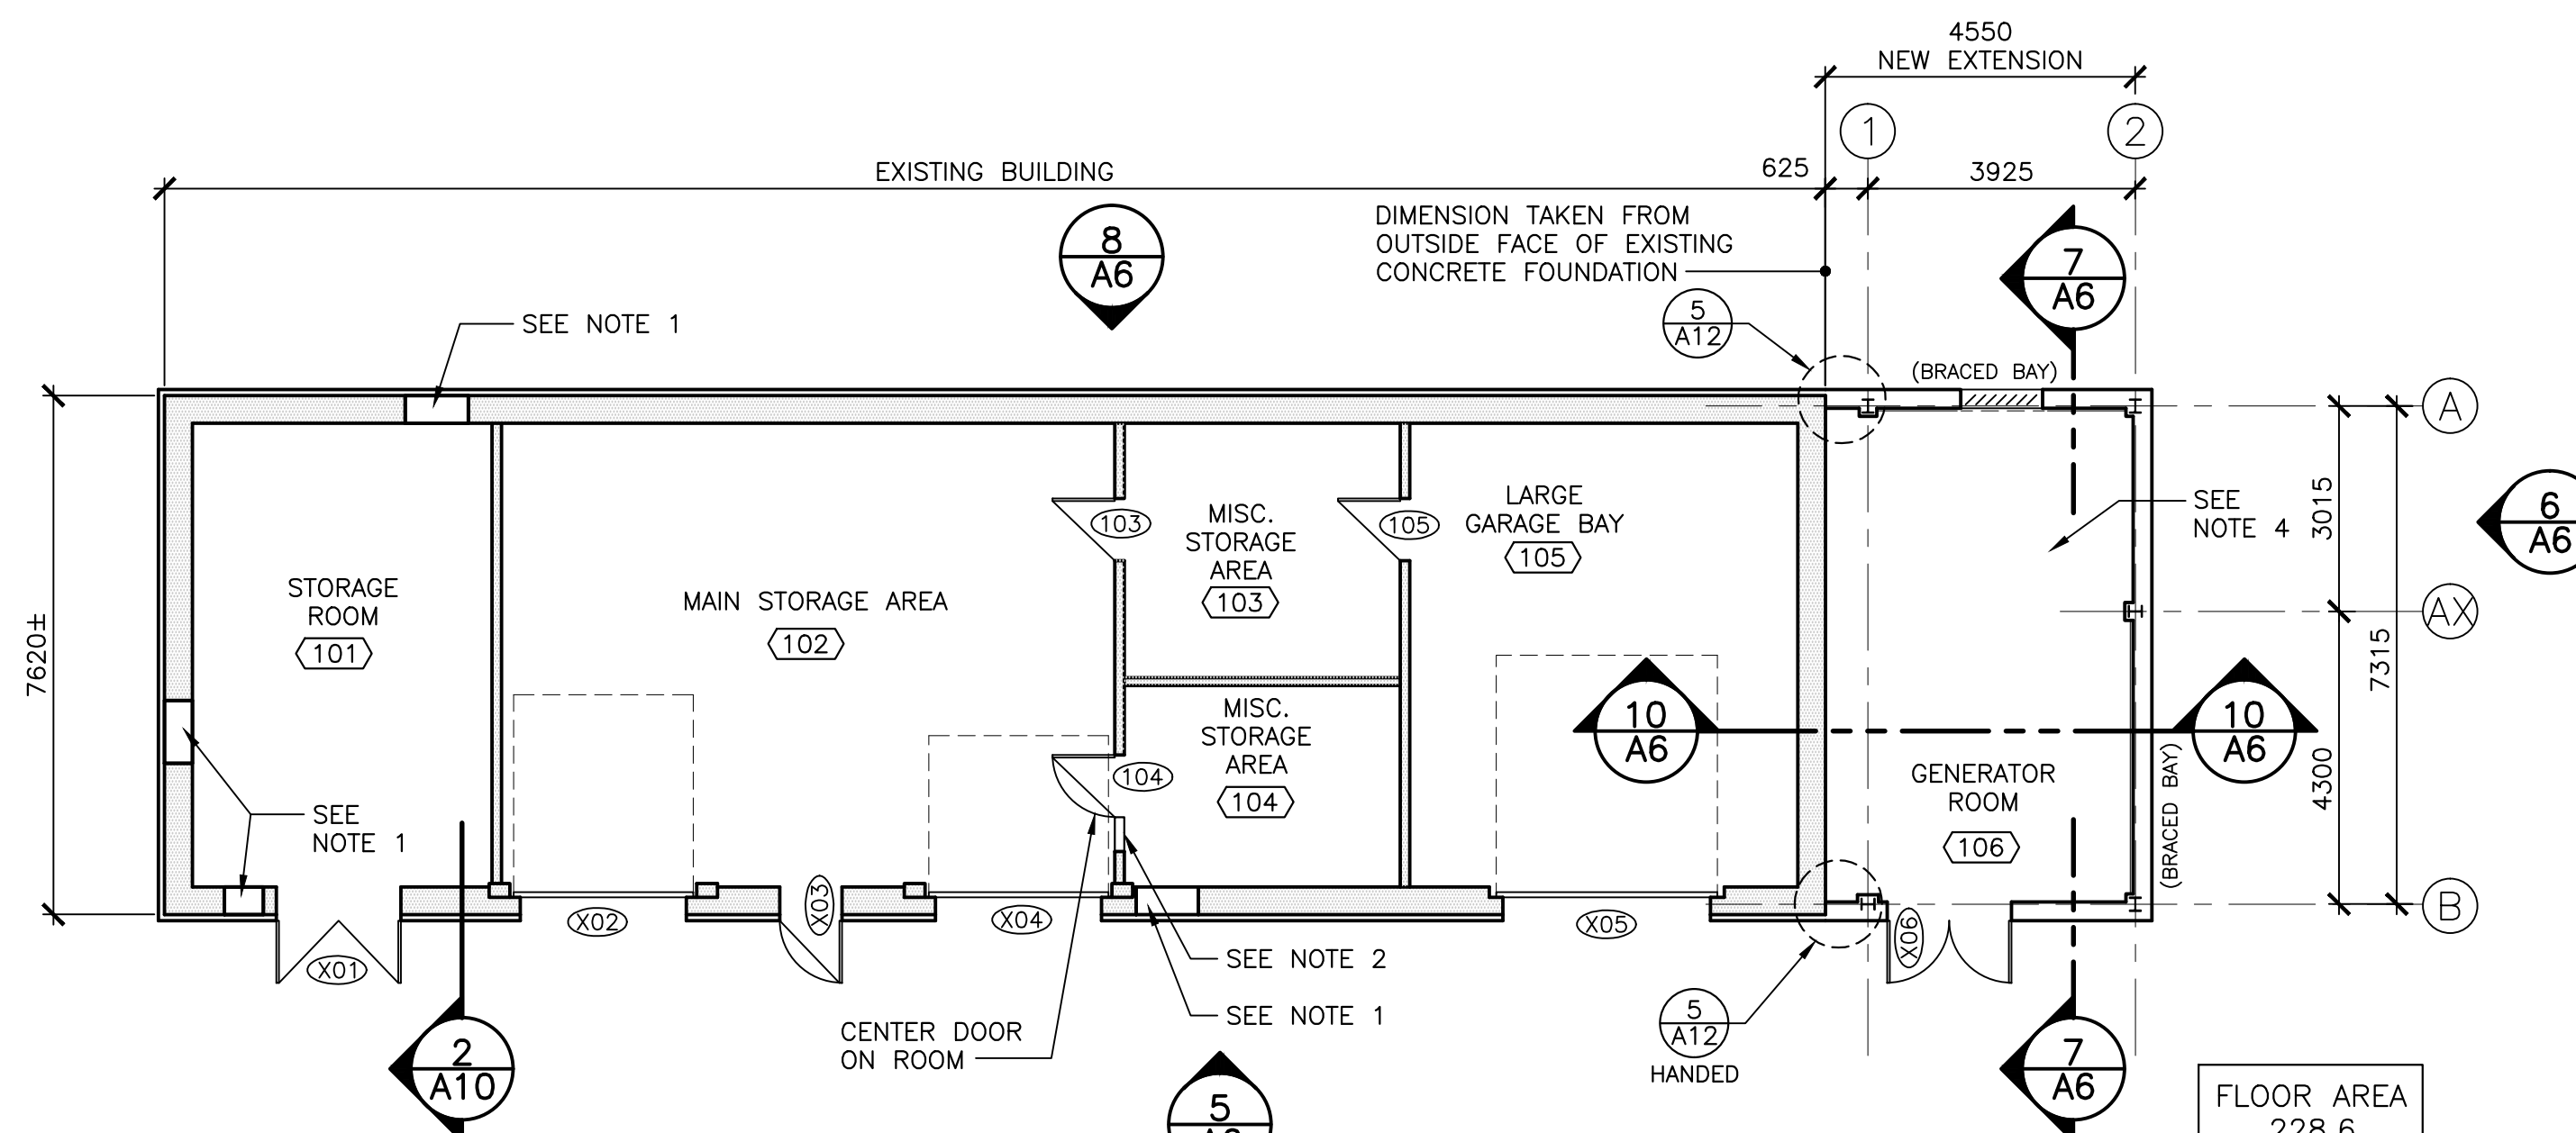


NEW FLOOR PLAN

SCALE : 1:100

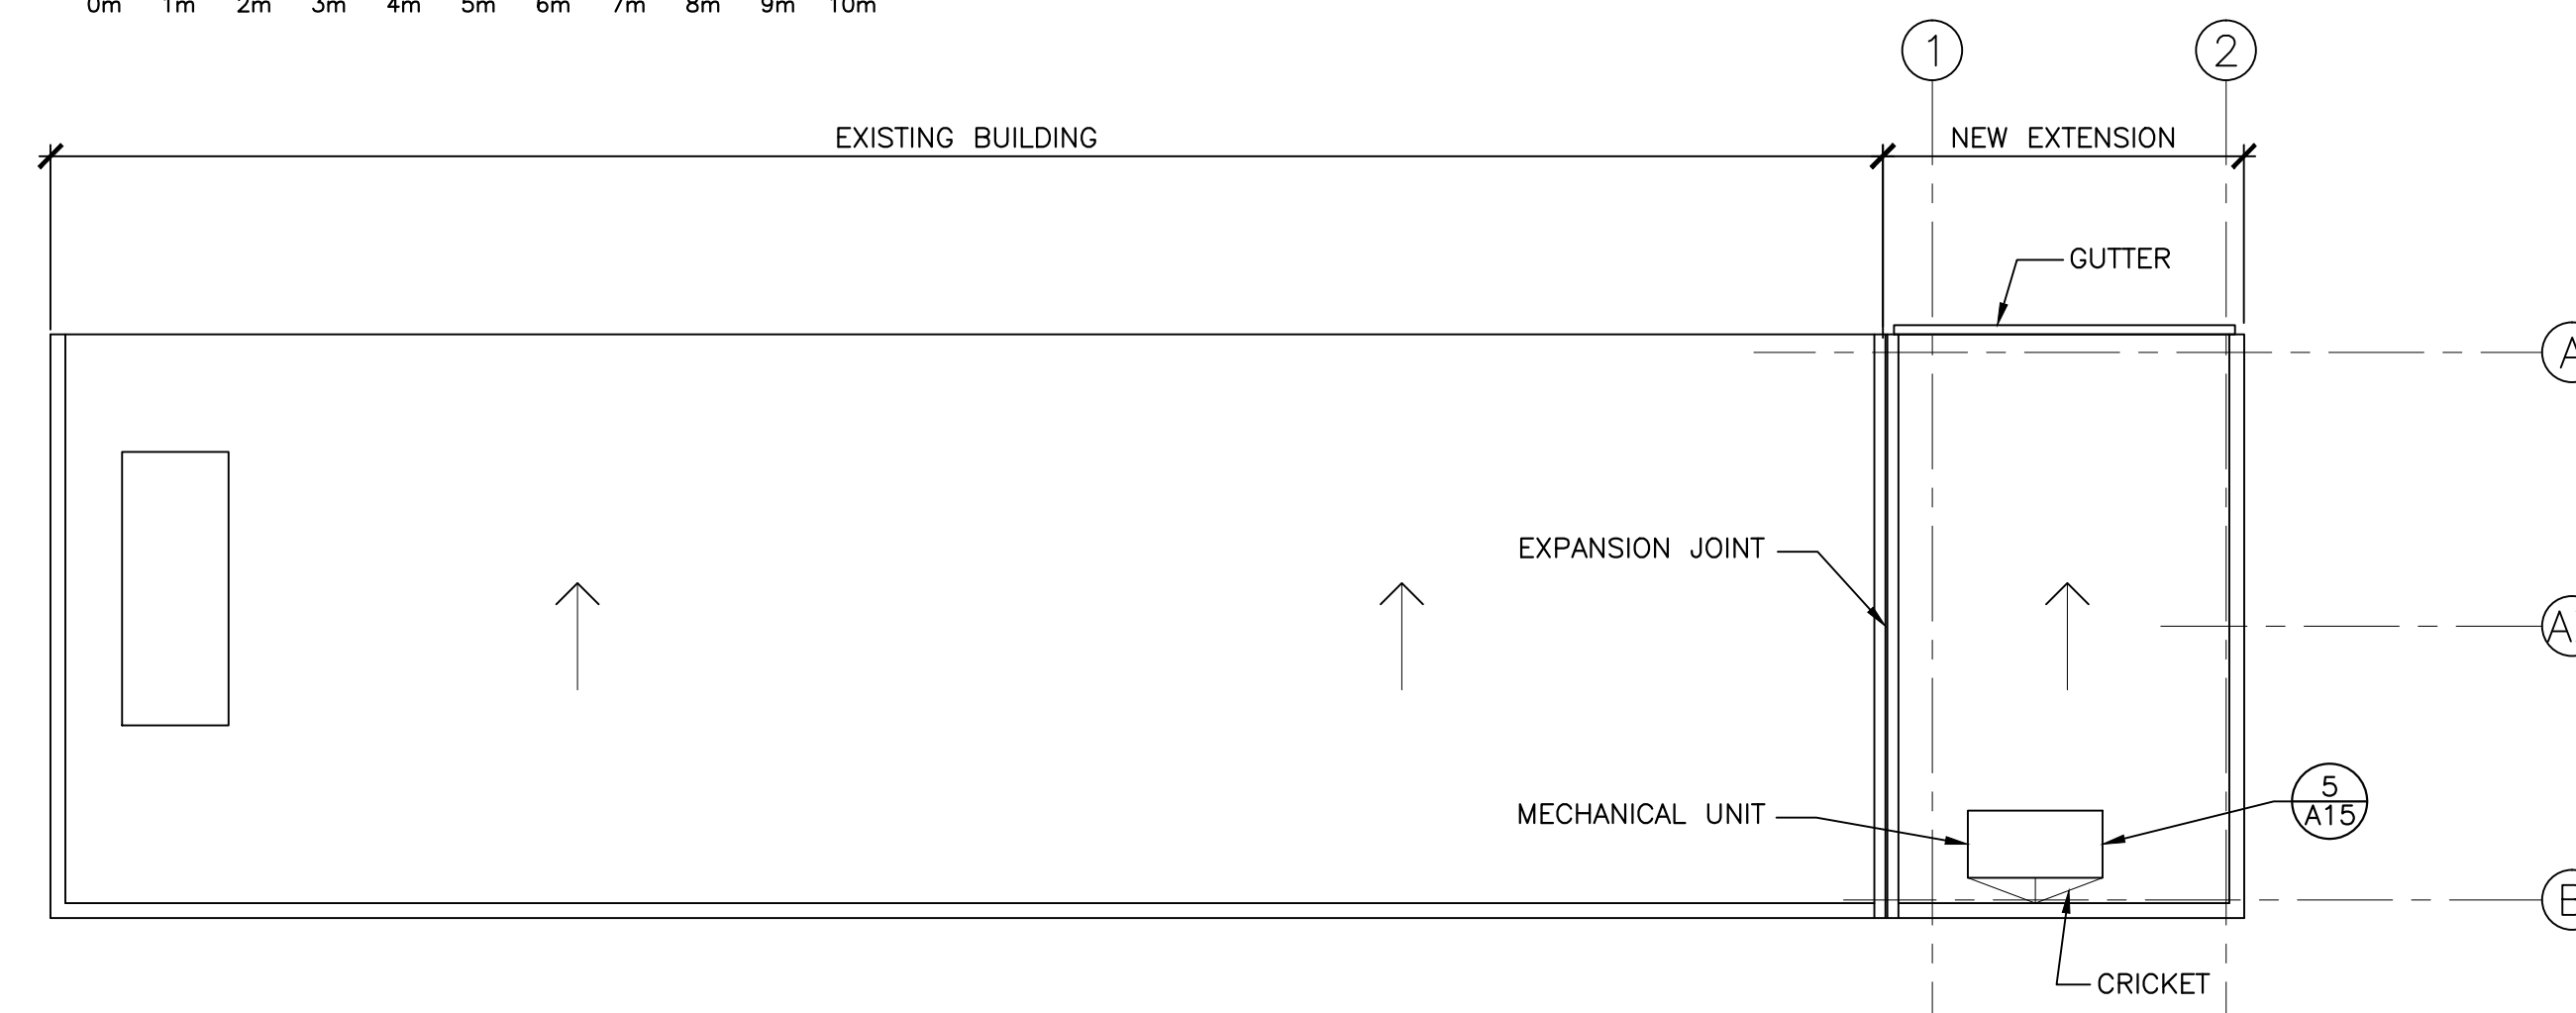


ROOF PLAN

SCALE : 1:100

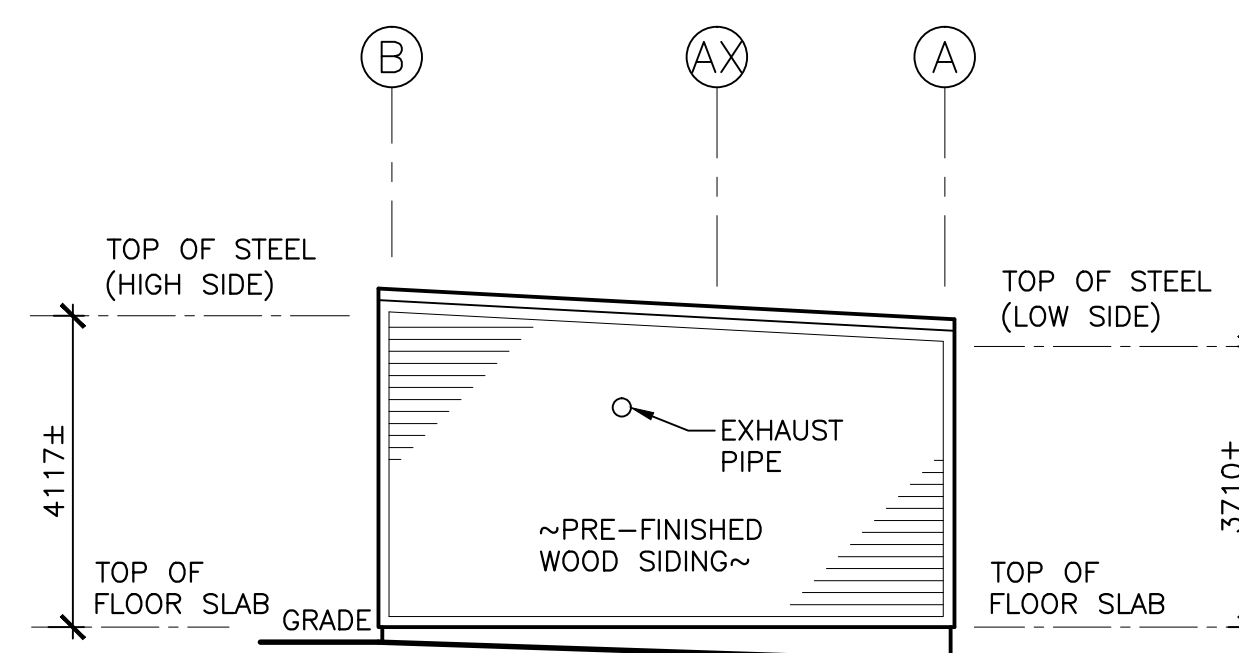


NORTH ELEVATION

SCALE : 1:100

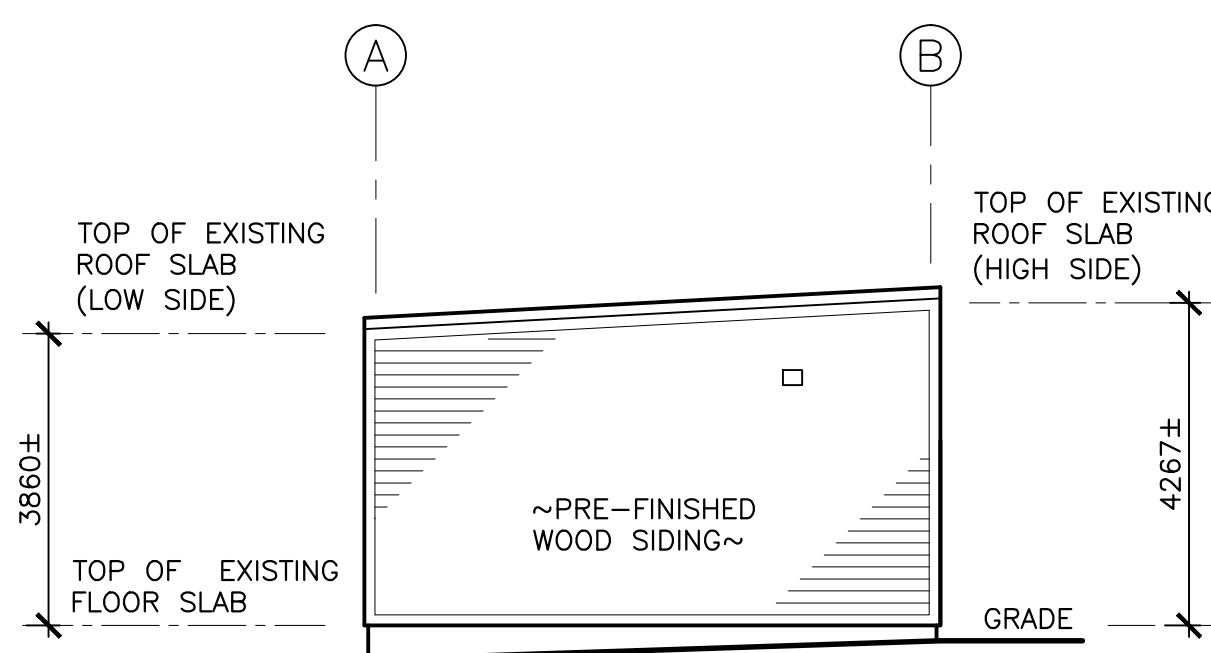


SOUTH ELEVATION

SCALE : 1:100

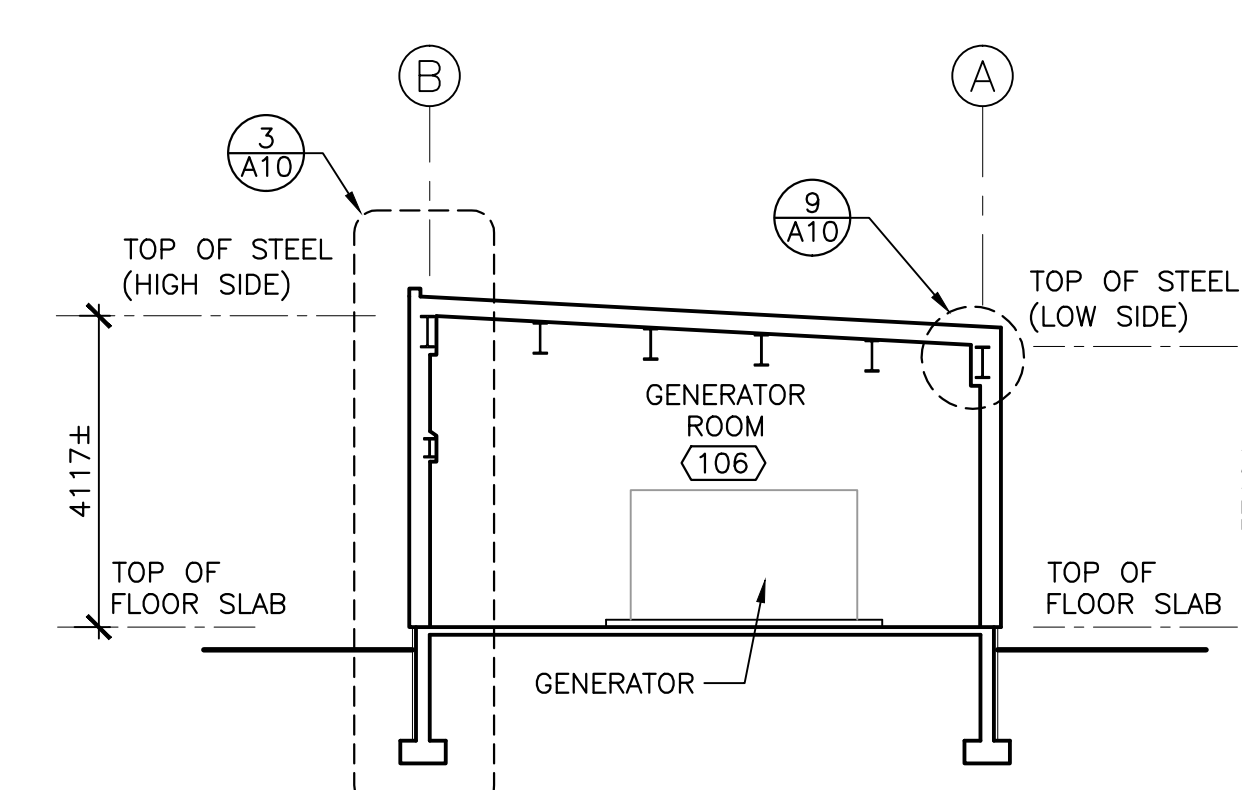


BUILDING SECTION

SCALE : 1:100

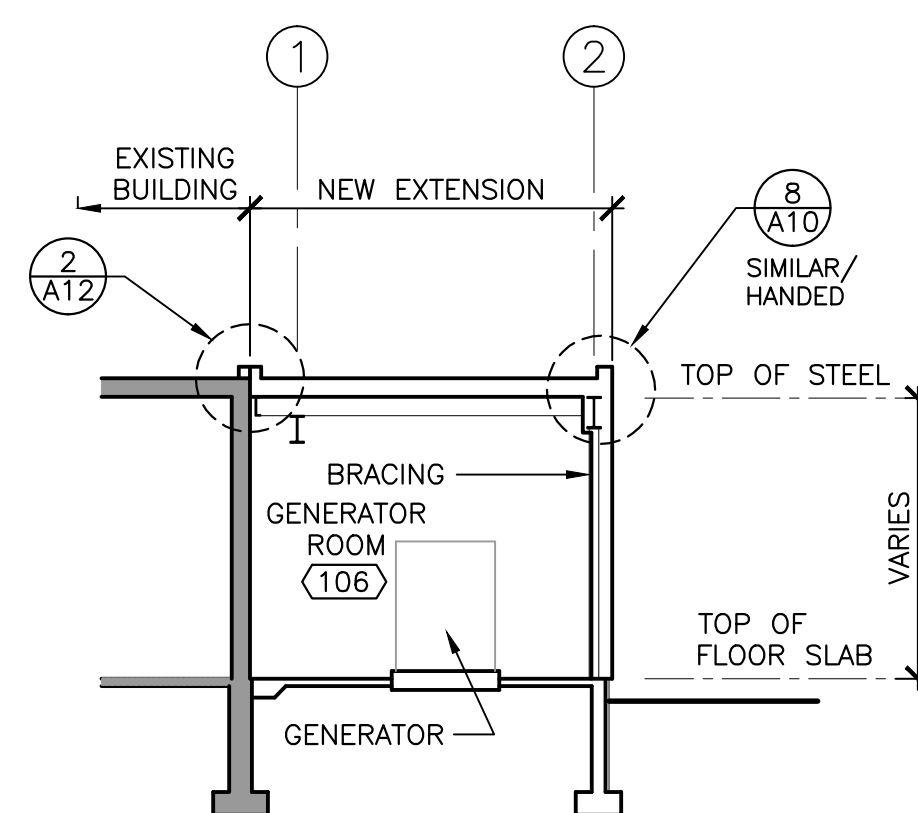

BUILDING SECTION

SCALE : 1:100

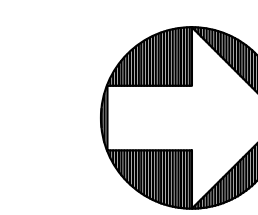

APPROX. NORTH

NOTES:

1. INFILL OPENING WITH CONSTRUCTION TO MATCH EXISTING EXTERIOR WALL. SEE WALL SECTION 2 ON DRAWING A10 FOR CONSTRUCTION.
2. NEW CONCRETE BLOCK PARTITION. WIDTH AND COURSING TO MATCH EXISTING ADJACENT CONCRETE BLOCK PARTITION.
3. COORDINATE TYPES, QUANTITIES, SIZES, AND LOCATIONS OF MECHANICAL AND ELECTRICAL ITEMS ON ELEVATIONS. MAINTAIN INTEGRITY OF AIR AND VAPOUR BARRIER AROUND OPENINGS AND MAKE WEATHER-TIGHT.
4. CONCRETE PAD FOR GENERATOR. COORDINATE SIZE AND LOCATION WITH MECHANICAL.

E	ISSUED FOR TENDER	JUL 11 2017
D	ISSUED FOR TENDER	JUN 28 2017
C	ISSUED FOR 99% REVIEW	MAY 25 2017
B	ISSUED FOR CLIENT REVIEW	APR 24 2017
A	ISSUED FOR 66% REVIEW	MAR 24 2017
revisions		date

project

MCTS CENTRE AND C&P BUILDING

PLACENTIA

drawing

ITS STORAGE BUILDING

PLANS, ELEVATIONS AND BUILDING SECTIONS

designed	JULY 11, 2017	conçu
date	JULY 11, 2017	
drawn	DwF	dessiné
date	JULY 11, 2017	
approved	JB	approuvé
date	JULY 11, 2017	
Tender	G.F. MACGILL-VAUGHAN	Submission
PWSSC Project Manager	Administrateur de projets TPSSC	
project number	R.081781.004	no. du projet
drawing no.	A6	no. du dessin