

Parks Canada Agency

Northern Ontario Field Unit

TRAIL BRIDGE STRUCTURE REHABILITATION PROJECT

PROJECT # 1433

JUNE 2017

Canada

Agence Parcs Canada

Unité de Gestion de Nord de l'Ontario

PUKASKWA NATIONAL PARK


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185 EAST STREET SAULT STE.MARIE ONTARIO CANADA P6A 3C8 TEL.: 705-942-2070 | FAX: 705-942-3532 | WWW.WSPGROUP.COM

WSP PROJECT # (151-06165-07)



GENERAL

С.

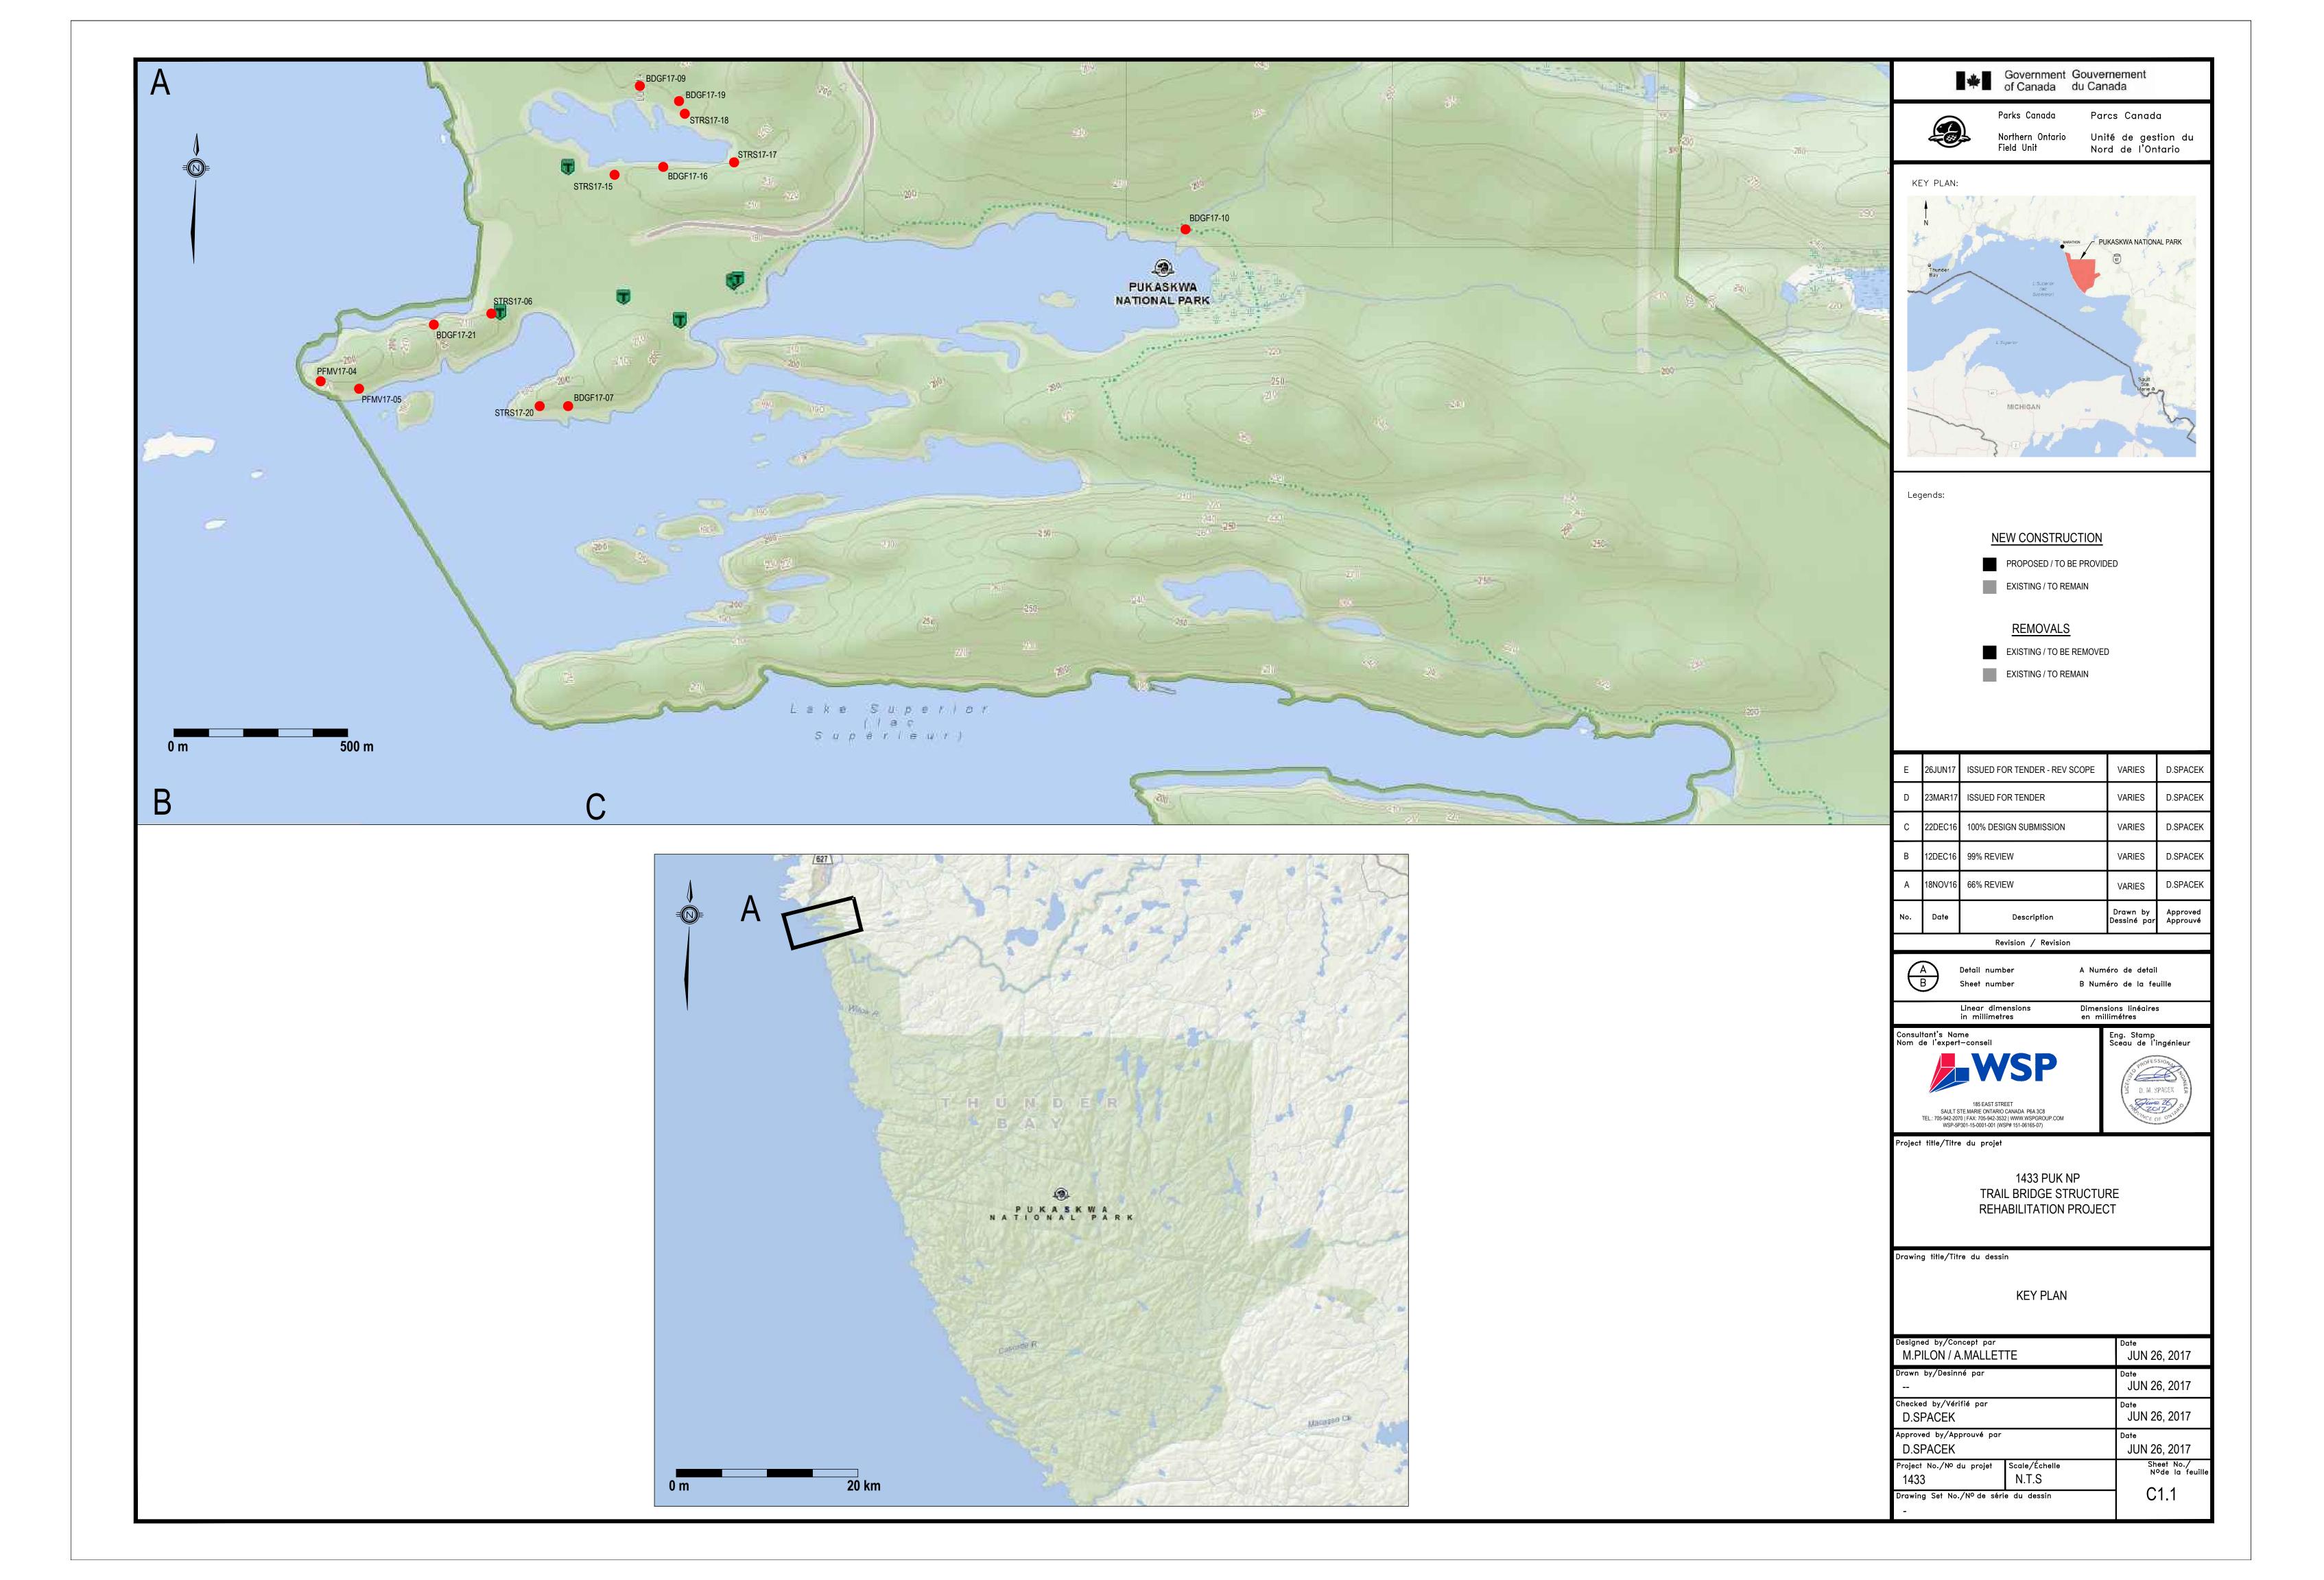- 1. DRAWINGS TO BE READ IN CONJUNCTION WITH THE PROJECT SPECIFICATIONS.
- 2. THE SCOPE OF WORK INDICATED ON THE DRAWINGS IS TO SERVE AS A GUIDE ONLY. ALL WORK INDICATED ON THE DRAWINGS SHALL BE COMPLETED REGARDLESS OF INCLUSION IN THE GENERAL SCOPE OF WORK. NOTIFY DEPARTMENTAL REPRESENTATIVE IF ANY DISCREPANCIES ARE FOUND BETWEEN THESE NOTES AND THE SPECIFICATIONS.

- ALL WORK IS TO CONFORM TO LATEST EDITION OF THE NATIONAL BUILDING CODE OF CANADA AND WITH ALL APPLICABLE CODES AND BYLAWS.

- STRUCTURE DRAWINGS. OBTAIN THE DEPARTMENTAL REPRESENTATIVES' APPROVAL BEFORE MODIFYING WORK TO SUIT EXISTING CONDITIONS WHICH ARE NOT SHOWN ON THE DRAWINGS. ALL DIMENSIONS GIVEN ON STRUCTURAL DRAWINGS ARE IN METRIC SYSTEM UNLESS OTHERWISE NOTED. DO NOT SCALE DRAWINGS.

- THIS RANGE.

13. ALL CONTRACTOR SUBMITTALS SHALL BE DONE IN S.I. UNITS (METRIC) AND REFERENCE THE NOMINAL IMPERIAL MEASUREMENTS (I.E. 2X4).

19. THE CONTRACTOR SHALL MAINTAIN THE WORKSITE IN A TIDY CONDITION AND FREE FROM THE ACCUMULATION OF WASTE PRODUCTS AND DEBRIS.

29. THE CONTRACTOR SHALL REFER TO AND ADHERE BY THE PARKS CANADA (PCA) GUIDELINES FOR THE USE, HANDLING AND DISPOSAL OF TREATED WOOD

THE CONTRACTOR SHALL REPLACE AT THEIR COST ANY DAMAGED WOOD AS A RESULT OF CONSTRUCTION THAT IS NOT SPECIFIED FOR REMOVAL. 4. LUMBER TO CSA 141-05 & NLGA-2004 STANDARD GRADING RULES FOR CANADIAN LUMBER. ALL WOOD SHALL BEAR A CERTIFICATION/GRADE STAMP.

20. ALTERNATIVES MAY BE CONSIDERED. SUBMIT PROPOSAL IN WRITING FOR ALTERNATIVE PRODUCTS AND ALLOW FOR RESPONSE TIME OF 7 CALENDAR DAYS.

22. SIMPSON DRT 77 SHALL BE INSTALLED ON ALL NEW AND EXISTING POSTS ACTING WITHIN A HANDRAIL SYSTEM. THIS IS REQUIRED ON ALL STRUCTURES.

30. THE CONTRACTOR SHALL REFER TO AND ADHERE BY THE PARKS CANADA (PCA) BEST MANAGEMENT PRACTICES FOR TRAIL MAINTENANCE AND MODIFICATION.

24. THE CONTRACTOR SHALL PROVIDE FOUR (4) COMPLETE SETS OF AS-CONSTRUCTED RECORD DRAWINGS. ALL CHANGES ARE TO BE SHOWN IN RED AND MUST BE CLEAN AND LEGIBLE.

TREATED WOOD ENTERS THE ENVIRONMENT. THIS ALSO APPLIES FOR THE END TREATMENT OF WOOD MEMBERS.

21. ALL SECTIONS, DETAILS AND STATEMENTS NOTED AS "TYPICAL" APPLY TO LIKE/SIMILAR CONDITIONS IN THE STRUCTURE.

22. DRAWINGS SHOW THE COMPLETED STRUCTURE ONLY AND DO NOT SHOW TEMPORARY WORKS (IF REQUIRED).

27. THE CONTRACTOR SHALL SUBMIT A SEDIMENT AND EROSION CONTROL PLAN PRIOR TO CONSTRUCTION.

28. THE CONTRACTOR SHALL PROVIDE ALL SHOP DRAWINGS IN ACCORDANCE WITH THE CONTRACT SPECIFICATIONS.

33. ALL WORK SHALL CONFORM TO THE ENVIRONMENTAL BASIC IMPACT ANALYSIS (BIA). REFER TO THE CONTRACT SPECIFICATIONS.

NO DUST FROM THE CUTTING OF WOODEN COMPONENTS, OR CHEMICALS FROM END-TREATMENT ENTERS THE ENVIRONMENT.

18. ALL NAILS ARE TO BE HAND DRIVEN. REQUESTS FOR POWER DRIVEN NAILS MUST BE REVIEWED BY THE CONSULTANT PRIOR TO USE.

ONTARIO BUILDING CODE 2012 (OBC)

RESOURCES OF INTEREST ARE LOCATED DURING CONSTRUCTION.

NATIONAL BUILDING CODE OF CANADA 2010 (NBCC)

CAN/CSA 086-14 ENGINEERING DESIGN IN WOOD CAN/CSA A23.3-14 DESIGN OF CONCRETE STRUCTURES

BY THE DEPARTMENTAL REPRESENTATIVE/DELEGATE.

DEPARTMENTAL REPRESENTATIVE/DELEGATE.

MAINTAIN A QUALITY CONTROL PROGRAM.

ALLOW FOR THE REHABILITATION OF VEGETATION.

2. MATERIAL USED FOR CONSTRUCTION SHALL BE FREE OF ANY DEFECTS.

9. NO OVERCUTTING OF WOOD COMPONENTS ARE PERMITTED.

12. ALL HARDWARE TO BE GALVANIZED (600G/M2) UNLESS OTHERWISE NOTED.

ALL PRESERVATIVE TREATED WOOD SPF NO.2 OR BETTER UNLESS OTHERWISE NOTED.

19. ALL WOOD MEMBERS TO BE CONTINUOUS (NO SPLICING) UNLESS OTHERWISE NOTED.

CONSTRUCTION DEBRIS SHALL BE REMOVED FROM THE CONSTRUCTION SITE DAILY.

4. THE CONTRACTOR IS RESPONSIBLE FOR ALL DISPOSAL/TIPPING FEES.

11. ADHESIVES USE LOCTITE PL PREMIUM CONSTRUCTION ADHESIVE OR APPROVED ALTERNATE TO CSA 0122-16

17. NAILS AND SPIKES TO BE COMMON ROUND STEEL WIRE NAILS TO CSA B111-74 UNLESS NOTED OTHERWISE.

13. ALL HARDWARE AND FASTENERS SHALL BE AMMONIACAL COPPER QUATERNARY (ACQ) COMPATIBLE.

25. NO BURNING IS PERMITTED.

32. THE USE OF SEED IS PROHIBITED.

5. PRESERVED WOOD TO CSA -080 SERIES-15.

14. ALL LAG BOLTS SHALL BE PROPERLY PRE-DRILLED.

16. USE ONLY HOT DIPPED GALVANIZED NAILS AND SCREWS.

15. HOT-DIP GALVANIZING TO CSA G164-92.

MATERIALS

REMOVALS

CANADIAN HIGHWAY BRIDGE DESIGN CODE 2014 (CHBDC)

13. ALL STRUCTURES SHALL BE IN CONFORMANCE WITH THE FOLLOWING DESIGN STANDARDS:

4. IN CASE OF CONFLICTING INFORMATION BETWEEN CONTRACT DRAWINGS AND SPECIFICATIONS, THE MORE STRINGENT SHALL GOVERN OR CONTRACTOR MUST SEEK CLARIFICATION IN WRITING FROM DEPARTMENTAL REPRESENTATIVE.

BEFORE PROCEEDING WITH WORK, VERIFY DIMENSIONS SHOWN ON THE DRAWINGS AND REPORT DISCREPANCIES TO THE DEPARTMENTAL REPRESENTATIVE. REFER TO OTHER DRAWINGS FOR LOCATIONS AND DIMENSIONING OF APPURTENANCES NOT SHOWN ON THE

8. WHERE EXISTING STAIR HANDRAILS ARE TO REMAIN, THE CONTRACTOR SHALL CONFIRM THE HEIGHT OF THE RAILING IS BETWEEN 865 MM AND 965 MM PRIOR TO INSTALLING GUARDS. NOTIFY THE DEPARTMENTAL REPRESENTATIVE OR DELEGATE IF THE HEIGHTS ARE OUTSIDE

9. THE CONTRACTOR SHALL FACILITATE ALL MATERIAL TESTING REQUIRED BY THE DEPARTMENTAL REPRESENTATIVE. CONTRACTOR TO ORGANIZE AND COORDINATE AS REQUESTED.

10. THE PROJECT IS LOCATED IN A HISTORIC NATIONAL PARK OF CANADA, THEREFORE STANDARDS FOR ENVIRONMENTAL PROTECTION AND FOR VISUAL AESTHETICS OF FINAL PRODUCT SHALL BE OF THE HIGHEST QUALITY STANDARD. CONTRACT LIMITS SHALL BE STRICTLY ADHERED TO AND CONTRACTOR IS TO TAKE SPECIAL CARE TO MINIMIZE DAMAGE, DISRUPTION, AND PROTECT EXISTING FEATURES OF THE NATIONAL PARK ECOSYSTEM. THE DEPARTMENTAL REPRESENTATIVE OR DELEGATE IS TO BE NOTIFIED IMMEDIATELY IF ANY NATURAL OR CULTURAL

11. ALL WORK IS TO BE CONDUCTED IN ACCORDANCE WITH THE ONTARIO OCCUPATIONAL HEALTH AND SAFETY ACT.

12. THE CONTRACTOR SHALL FOLLOW THE RISK MANAGEMENT PLAN (RMP) PUT IN-PLACE BY THE DEPARTMENTAL REPRESENTATIVE. THIS IS AN ACTIVE PLAN AND MAY CHANGE DURING CONSTRUCTION BASED ON THE INCLUSION/EXCLUSION OF RISKS.

1. ALL REMOVALS ARE TO BE CARRIED OUT WITH PRECAUTIONS FOR THE SAFETY OF THE WORKERS AND THE PARK USERS.

1. ALL PROPOSED UPGRADES SHALL BE CONSTRUCTED WITH NEW MATERIAL ONLY. EXISTING WOODEN COMPONENTS ARE TO BE REMOVED FROM THE SITE AND PROPERLY DISPOSED OF IN STRICT ACCORDANCE WITH APPLICABLE STANDARDS.

TRAFFIC SAFE MEANS OF CROSSING DURING CONSTRUCTION AS THE TRAILS WILL BE OPEN TO THE PUBLIC. TEMPORARY CROSSING FOR PARK USERS MUST BE APPROVED BY THE DEPARTMENTAL REPRESENTATIVE.

31. ALL WORK WITHIN A 30 METER DISTANCE OF A WATER WAY SHALL ADHERE TO THE FISHERIES ACT. THE CONTRACTOR SHALL SUBMIT A WORK PLAN FOR ALL WORK WITHIN A 30 METER DISTANCE TO A WATERWAY

6. PRESERVED WOOD SHALL BE TREATED WITH AMMONIACAL COPPER QUATERNARY (ACQ). ANY OTHER PROPOSED TREATMENTS ARE SUBJECT TO APPROVAL BY THE DEPARTMENTAL REPRESENTATIVE OR DELEGATE.

10. FOR ALL BURIED, PERMANENT GROUND CONTACT, OR CONTINUALLY WET WOOD COMPONENTS, USE HEMLOCK (NON-PRESSURE TREATED) BLOCKING UNDER PRESSURE TREATED COMPONENTS.

17. DESIGN OF ANY TEMPORARY CROSSINGS OR WORKS MUST BE CARRIED OUT BY A PROFESSIONAL ENGINEER REGISTERED IN THE PROVINCE OF ONTARIO. THE ENGINEER SHALL BE RETAINED BY THE CONTRACTOR AT NO ADDITIONAL COST TO THE OWNER.

18. THE CONTRACTOR SHALL SUBMIT A FIELD CUTTINGS MITIGATION PLAN TO THE DEPARTMENTAL REPRESENTATIVE FOR APPROVAL PRIOR TO CONSTRUCTION. THIS PLAN SHALL TAKE THE NECESSARY MEASURES TO ENSURE THAT NO DUST FROM THE CUTTING OF PRESSURE

23. THE CONSULTANT AND THE DEPARTMENTAL REPRESENTATIVE, AT TIMES, WILL CONDUCT INSPECTIONS OF THE WORK TO ENSURE GENERAL CONFORMANCE WITH THE DESIGN DRAWINGS. THIS DOES NOT REPLACE THE CONTRACTOR'S RESPONSIBILITY TO IMPLEMENT AND

20. USE DRAWINGS THAT ARE "ISSUED FOR CONSTRUCTION" AND WHICH ARE STAMPED BY A PROFESSIONAL ENGINEER LICENSED IN THE PROVINCE OF ONTARIO. REFER TO THE DEPARTMENTAL REPRESENTATIVE TO ENSURE THE MOST CURRENT REVISIONS ARE USED.

DEMOLITION WORK SHALL BE CARRIED OUT WITHOUT CAUSING OVERSTRESS OR EXCESSIVE DEFLECTION TO ANY PART OF THE EXISTING WORK WHICH IS TO REMAIN. THE CONTRACTOR IS RESPONSIBLE TO MAKE GOOD ANY DAMAGE CAUSED DURING DEMOLITION.

THE CONTRACTOR SHALL DISPOSE OF CONSTRUCTION DEBRIS AT LEGALLY DESIGNATED SITES IN ACCORDANCE WITH APPLICABLE LAWS.

21. THE CONTRACTOR SHALL ADJUST THE LOCATIONS OF THE HANDRAIL POSTS IN THE FIELD TO ALLOW FOR INSTALLATION OF SIMPSON DPT 77 HANDRAIL POST FASTENER. ENSURE A MAXIMUM POST SPACING (CENTRE TO CENTRE) OF 1.2 METERS IS MAINTAINED.

6. THE REMOVAL OF STRUCTURE 17-10 SHALL BE CONDUCTED WITH RESPECT TO THE SURROUNDING ENVIRONMENT. THE CONTRACTOR SHALL MAKE PROVISIONS SUCH THAT NO DEBRIS IS ALLOWED TO ENTER INTO THE WATERWAY DURING THE REMOVAL OF THESE STRUCTURES.

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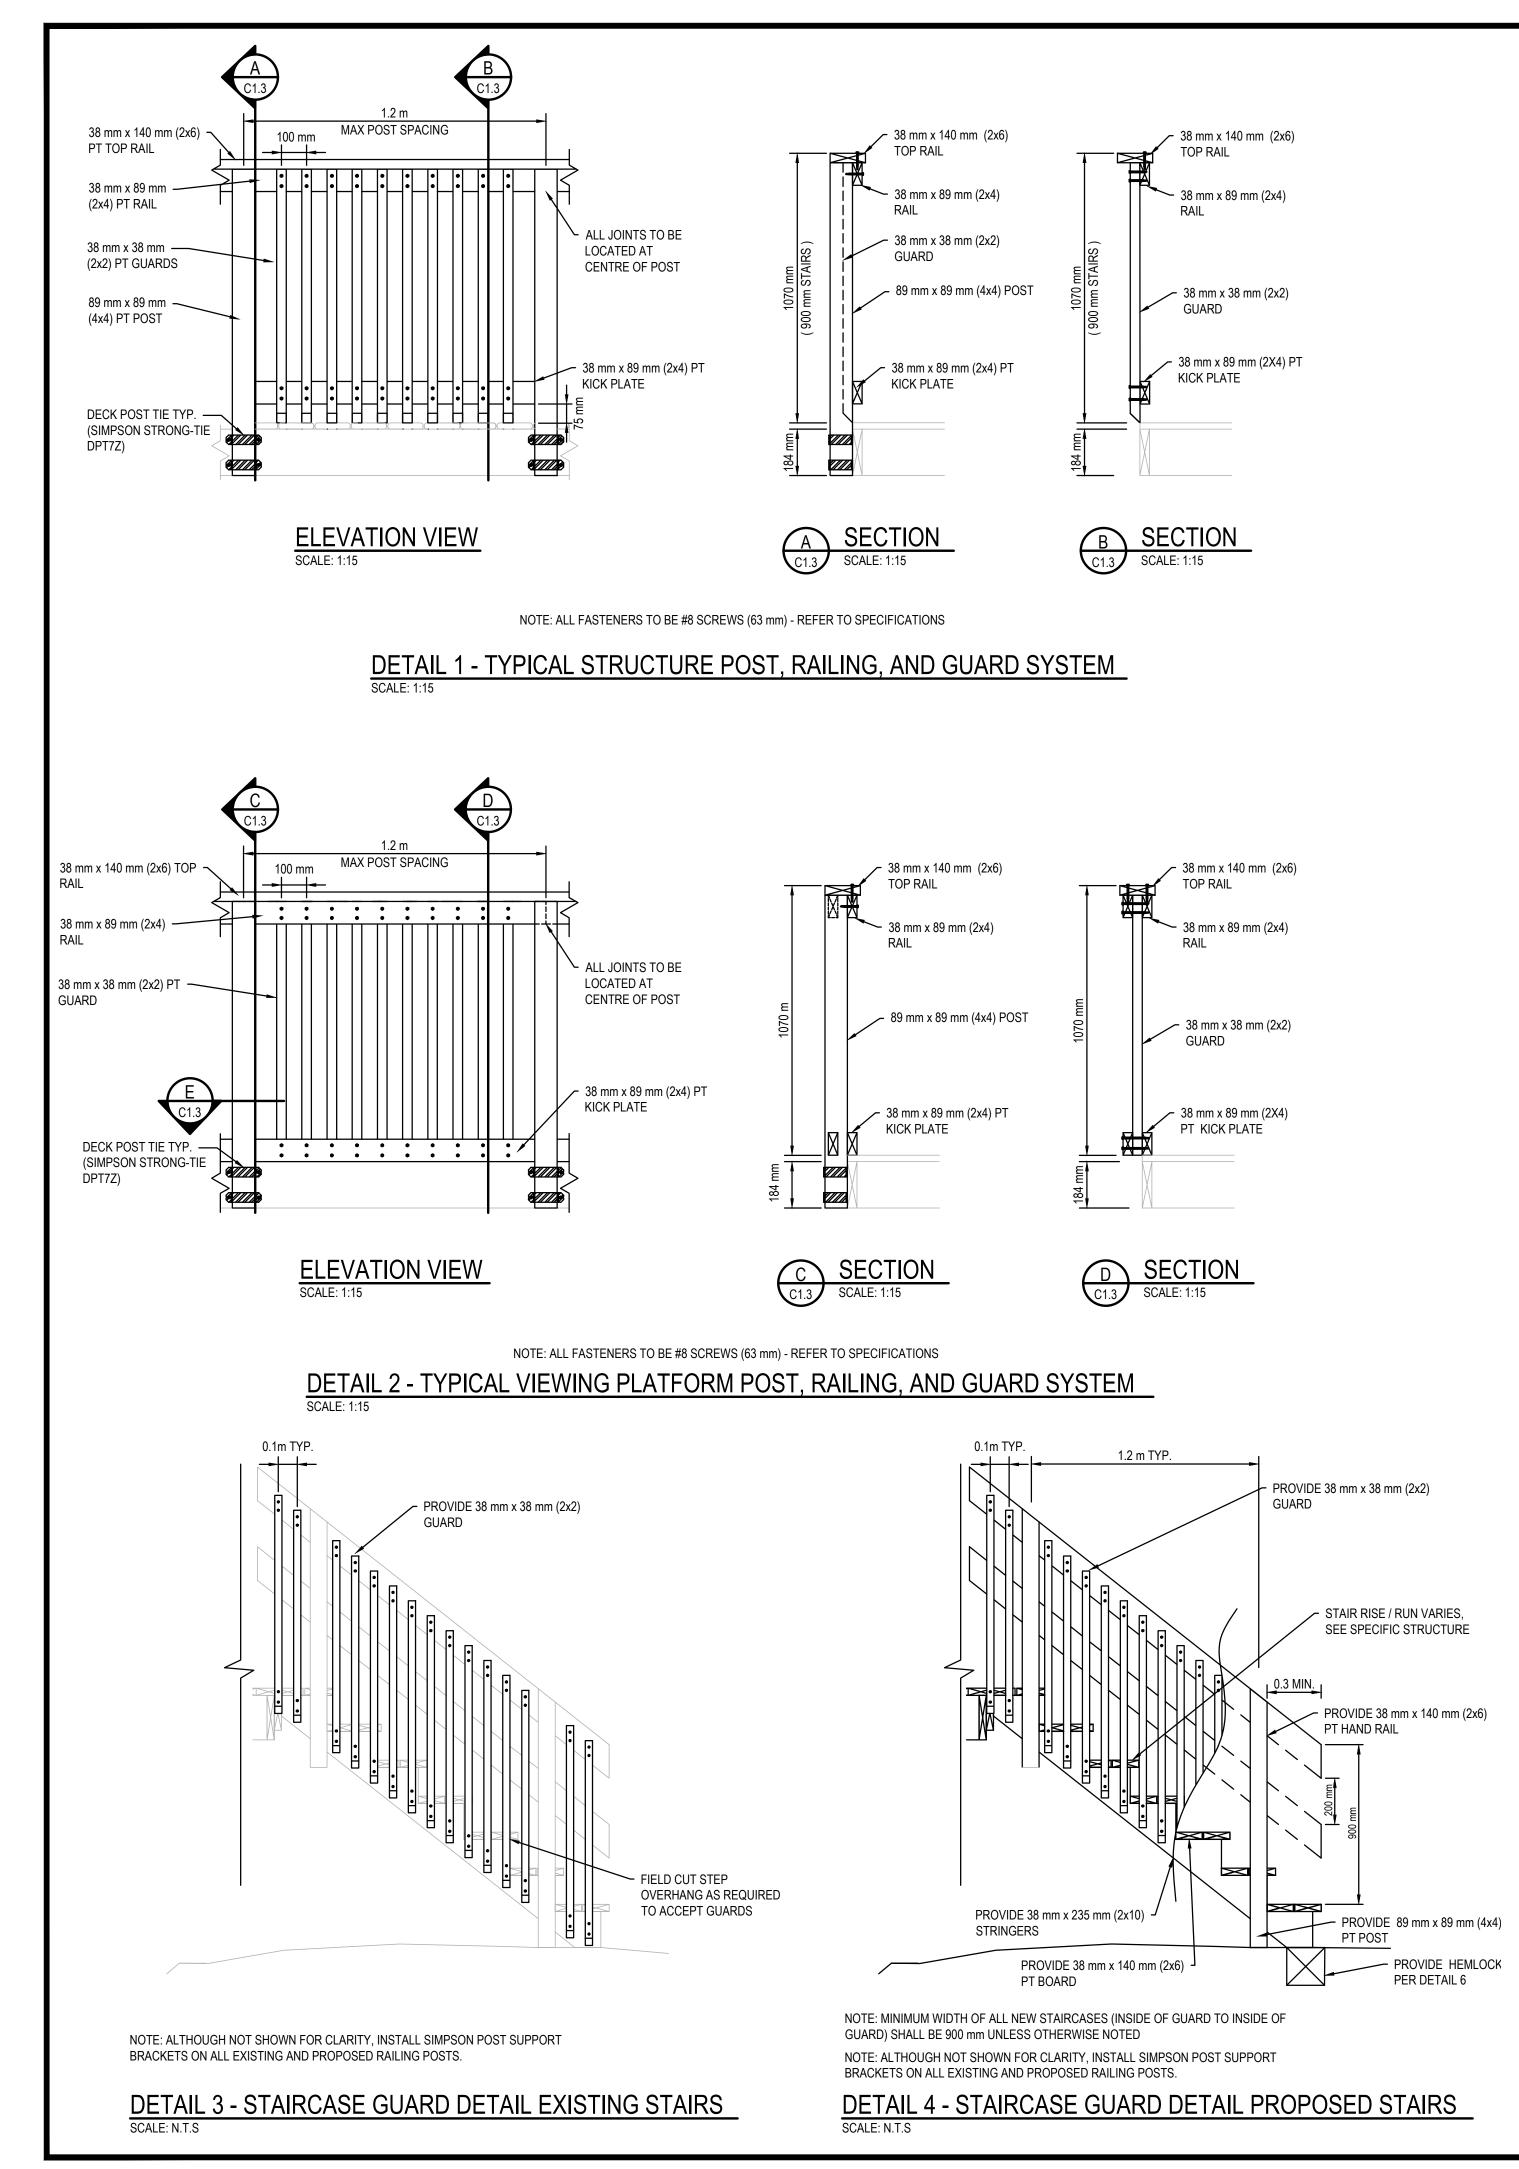
14. THE CONTRACTOR SHALL SUBMIT A PROJECT SPECIFIC HEALTH AND SAFETY PLAN FOR REVIEW PRIOR TO COMMENCING CONSTRUCTION. THE CONTRACTOR SHALL ONLY PROCEED WITH CONSTRUCTION UPON ACCEPTANCE OF THE PROJECT SPECIFIC HEALTH AND SAFETY PLAN


15. THE CONTRACTOR SHALL SUBMIT A DEMOLITION PLAN FOR STRUCTURE 17-10 FOR REVIEW BY THE DEPARTMENTAL REPRESENTATIVE PRIOR TO DEMOLITION. THE CONTRACTOR SHALL ONLY PROCEED WITH CONSTRUCTION UPON ACCEPTANCE OF THE DEMOLITION PLAN BY THE


16. THE CONTRACTOR SHALL SUBMIT A TEMPORARY CROSSING PLAN FOR REVIEW PRIOR TO COMMENCING CONSTRUCTION FOR ALL STRUCTURES WHERE PUBLIC ACCESS WILL BE IMPACTED DURING CONSTRUCTION. THE CONTRACTOR IS RESPONSIBLE FOR PROVIDING PEDESTRIAN

26. THE CONTRACTOR SHALL ERECT SILT FENCING ALONG ALL WATER COURSES DURING CONSTRUCTION. WHERE DISTURBANCE IS CAUSED ON SLOPES (I.E. ABUTMENTS, ETC.) THE CONTRACTOR SHALL LEAVE THE SILT FENCING IN-PLACE ONCE THE WORK HAS BEEN COMPLETED TO


8. ALL PRESERVATIVE TREATED WOOD SHALL BE SHOP CUT AS MUCH AS POSSIBLE. WHERE FIELD CUTS ARE REQUIRED, TOUCH UP WITH CLEAR-COLOURED SURFACE WOOD PRESERVATIVE TO ALL CUTS. THE CONTRACTOR SHALL TAKE THE NECESSARY MEASURES TO ENSURE THAT



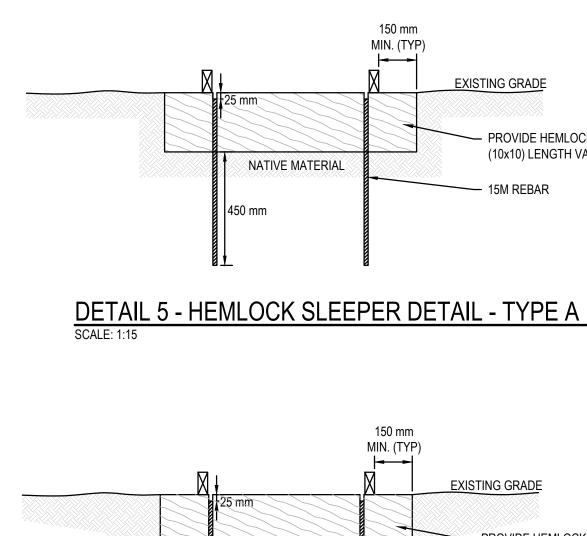


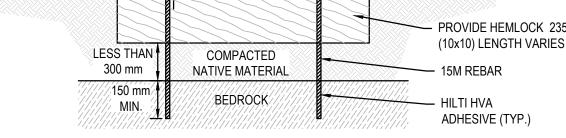

DETAIL 6 - HEMLOCK SLEEPER DETAIL - TYPE B SCALE: 1:15

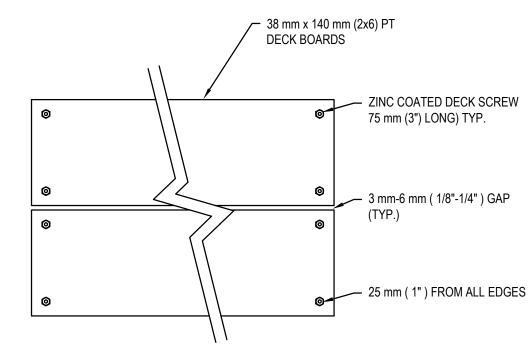




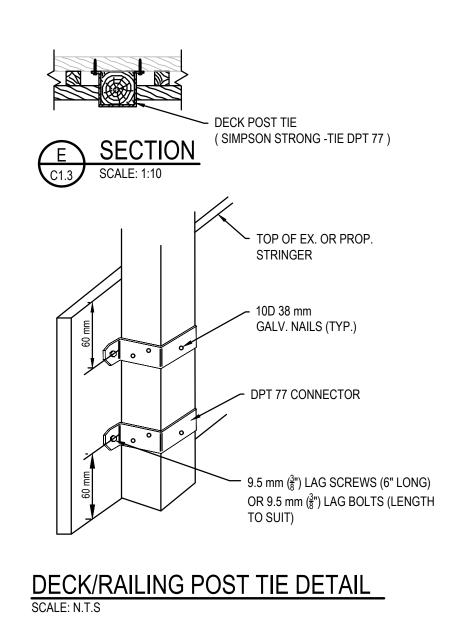


PROVIDE HEMLOCK 235 mm x 235 mm (10x10) LENGTH VARIES

PROVIDE HEMLOCK 235 mm x 235 mm


Government Gouvernement of Canada du Canada Parks Canada Parcs Canada Ð Unité de gestion du Northern Ontario Field Unit Nord de l'Ontario KEY PLAN: PUKASKWA NATIONAL PARK MICHIGA Legends: NEW CONSTRUCTION PROPOSED / TO BE PROVIDED EXISTING / TO REMAIN REMOVALS EXISTING / TO BE REMOVED EXISTING / TO REMAIN 26JUN17 ■ **ISSUED FOR TENDER - REV SCOPE** VARIES D.SPACEK ISSUED FOR TENDER VARIES D.SPACEK 23MAR17 C 22DEC16 100% DESIGN SUBMISSION VARIES D.SPACEK 12DEC16 99% REVIEW VARIES D.SPACEK 18NOV16 66% REVIEW D.SPACEK VARIES Drawn by Approved Approuvé Date Description Dessiné par Revision / Revision (A) Detail number A Numéro de detail B Sheet number B Numéro de la feuille Dimensions linéaires en millimétres Linear dimensions in millimetres Consultant's Name Nom de l'expert—conseil Eng. Stamp Sceau de l'ingénieur **WSP** 2 CC D. M. SPACEK 13 ZOIT 185 EAST STREET SAULT STE MARIE ONTARIO CANADA P6A 3C8 TEL: 705-942-2070 | FAX: 705-942-3532 | WWW.WSPGROUP.COM WSP-5P301-15-0001-001 (WSP# 151-06165-07) Project title/Titre du projet 1433 PUK NP TRAIL BRIDGE STRUCTURE **REHABILITATION PROJECT** Drawing title/Titre du dessin DETAILS SHEET 1 OF 2 Designed by/Concept par JUN 26, 2017 M.PILON / A.MALLETTE Drawn by/Desinné par JUN 26, 2017 T.PILON Checked by/Vérifié par JUN 26, 2017 D.SPACEK Approved by/Approuvé par Date JUN 26, 2017 D.SPACEK Sheet No./ N^ode la feuille Project No./Nº du projet Scale/Échelle 1433 AS NOTED C1.3 rawing Set No./N^o de série du dessin

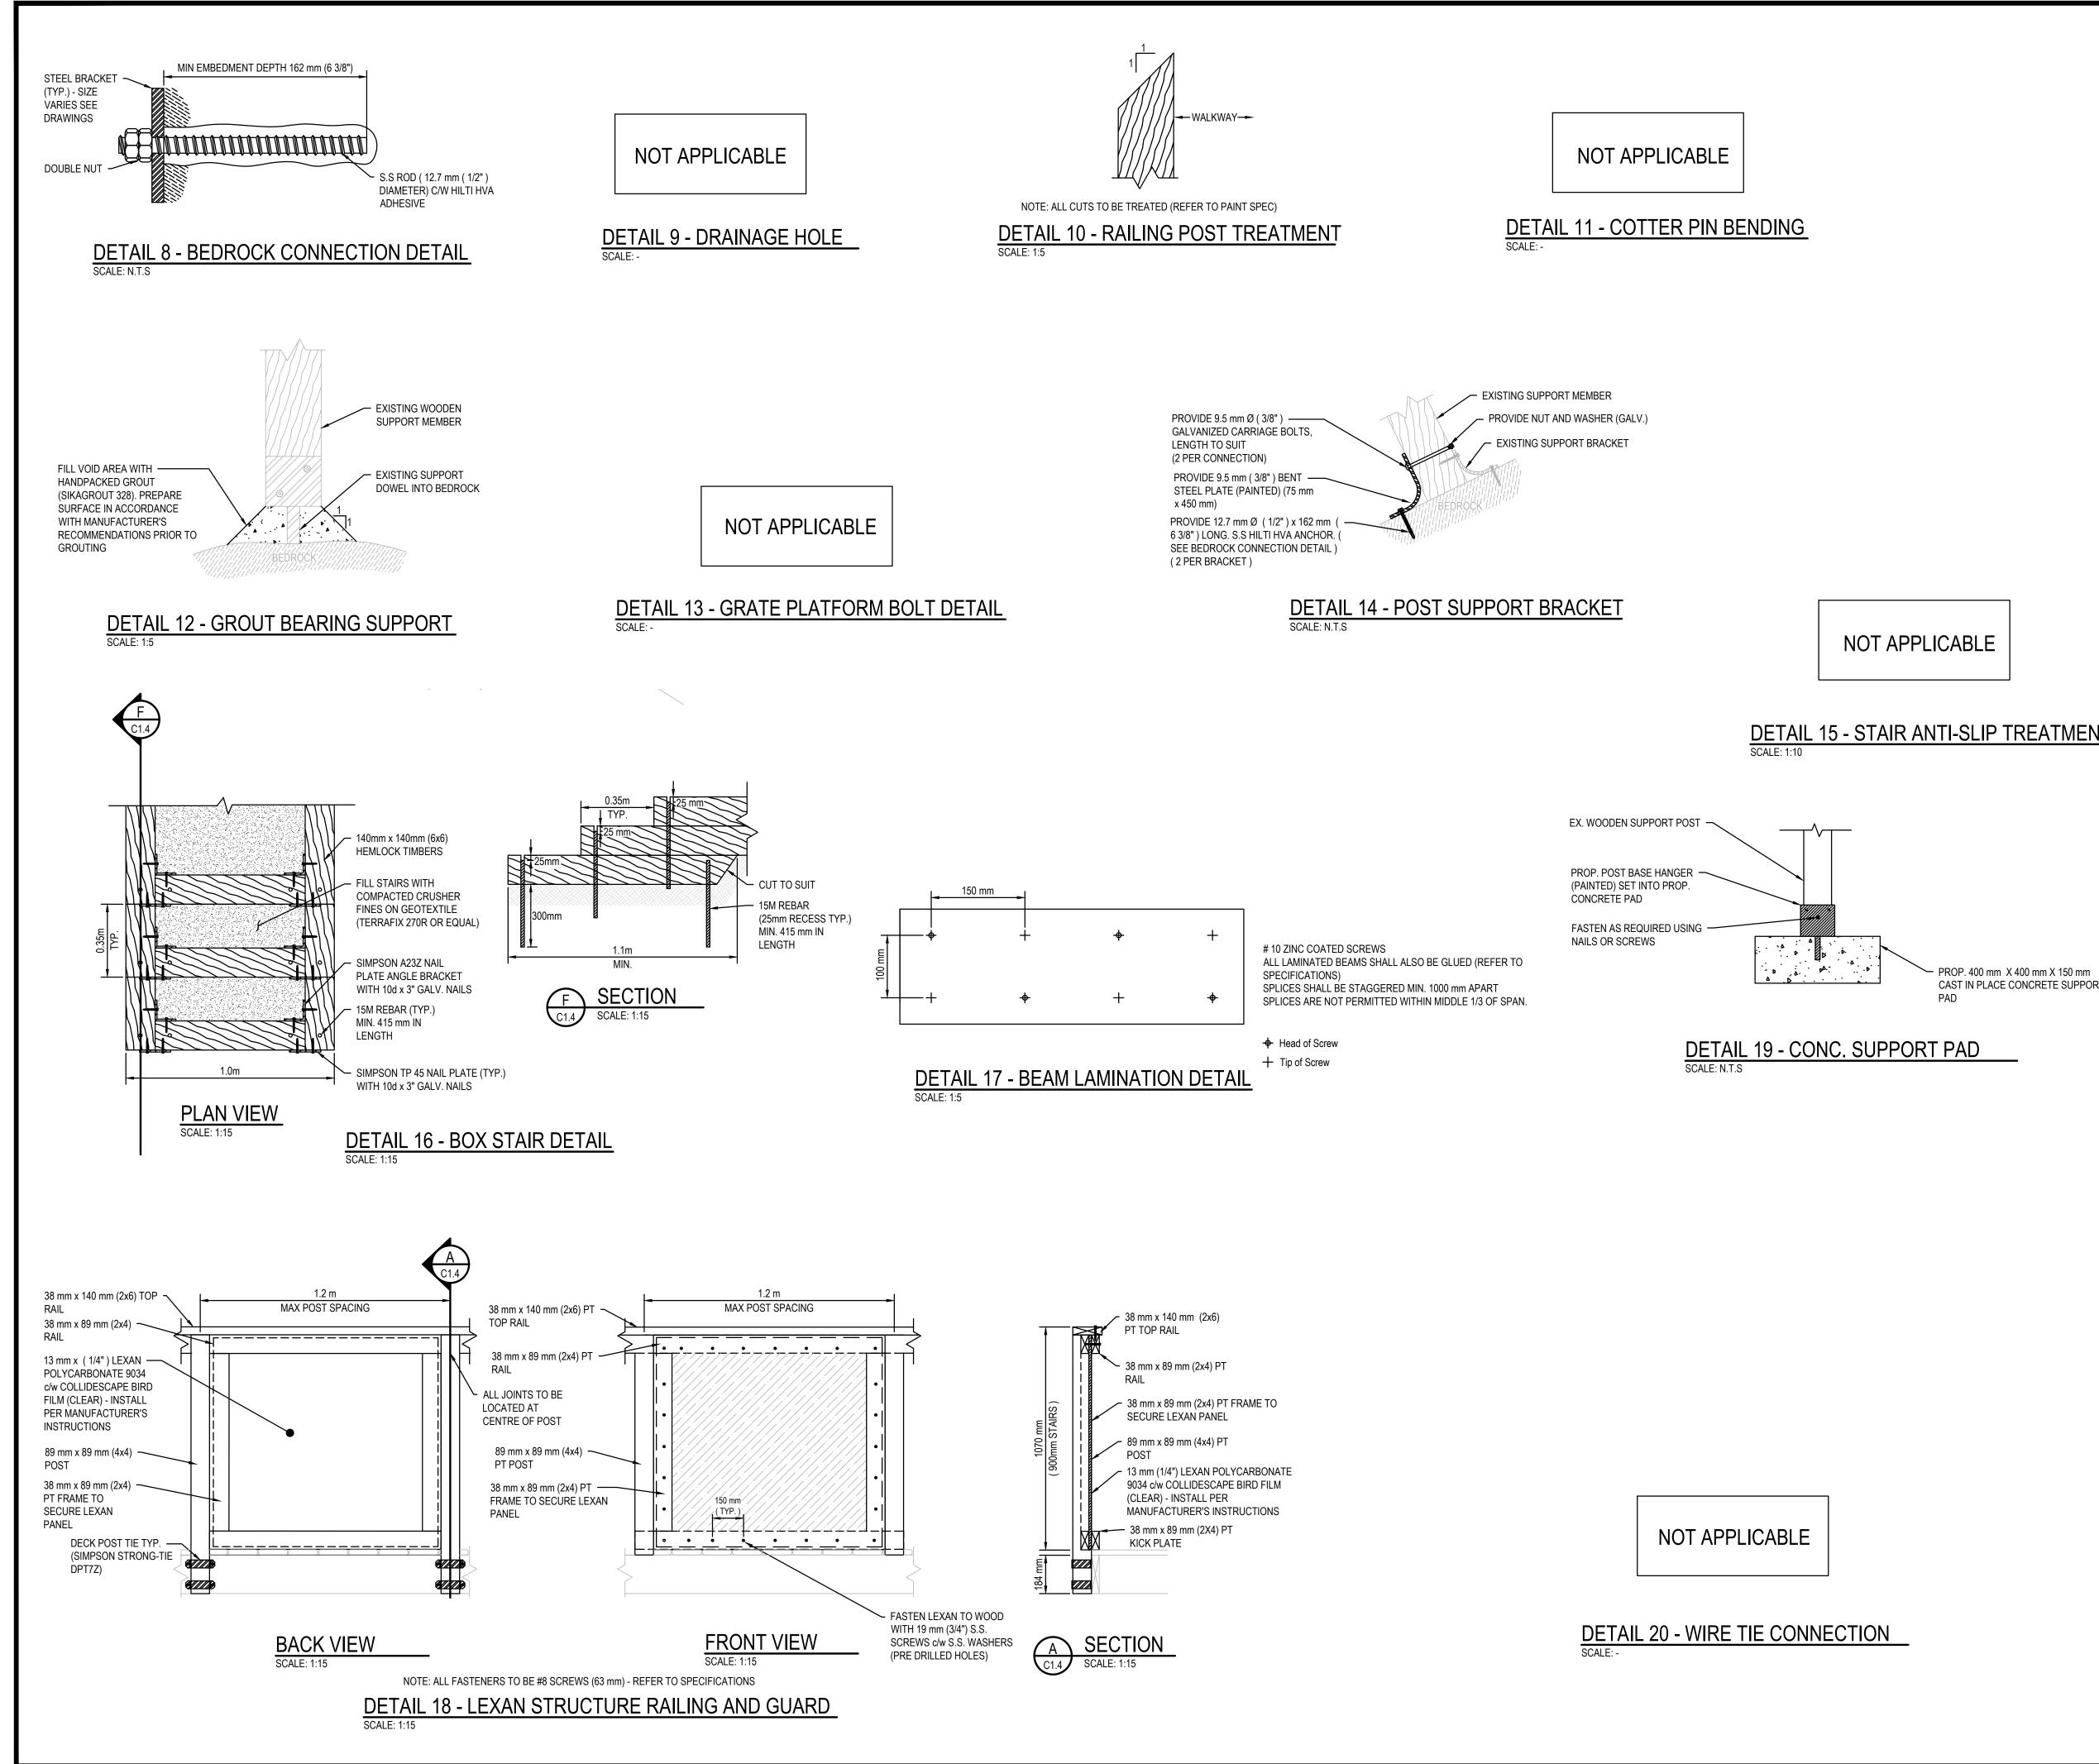


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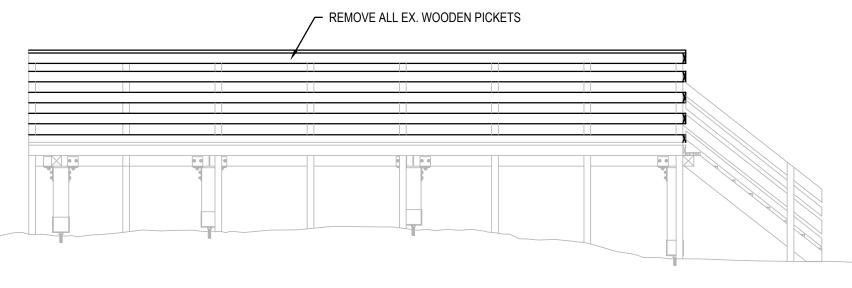


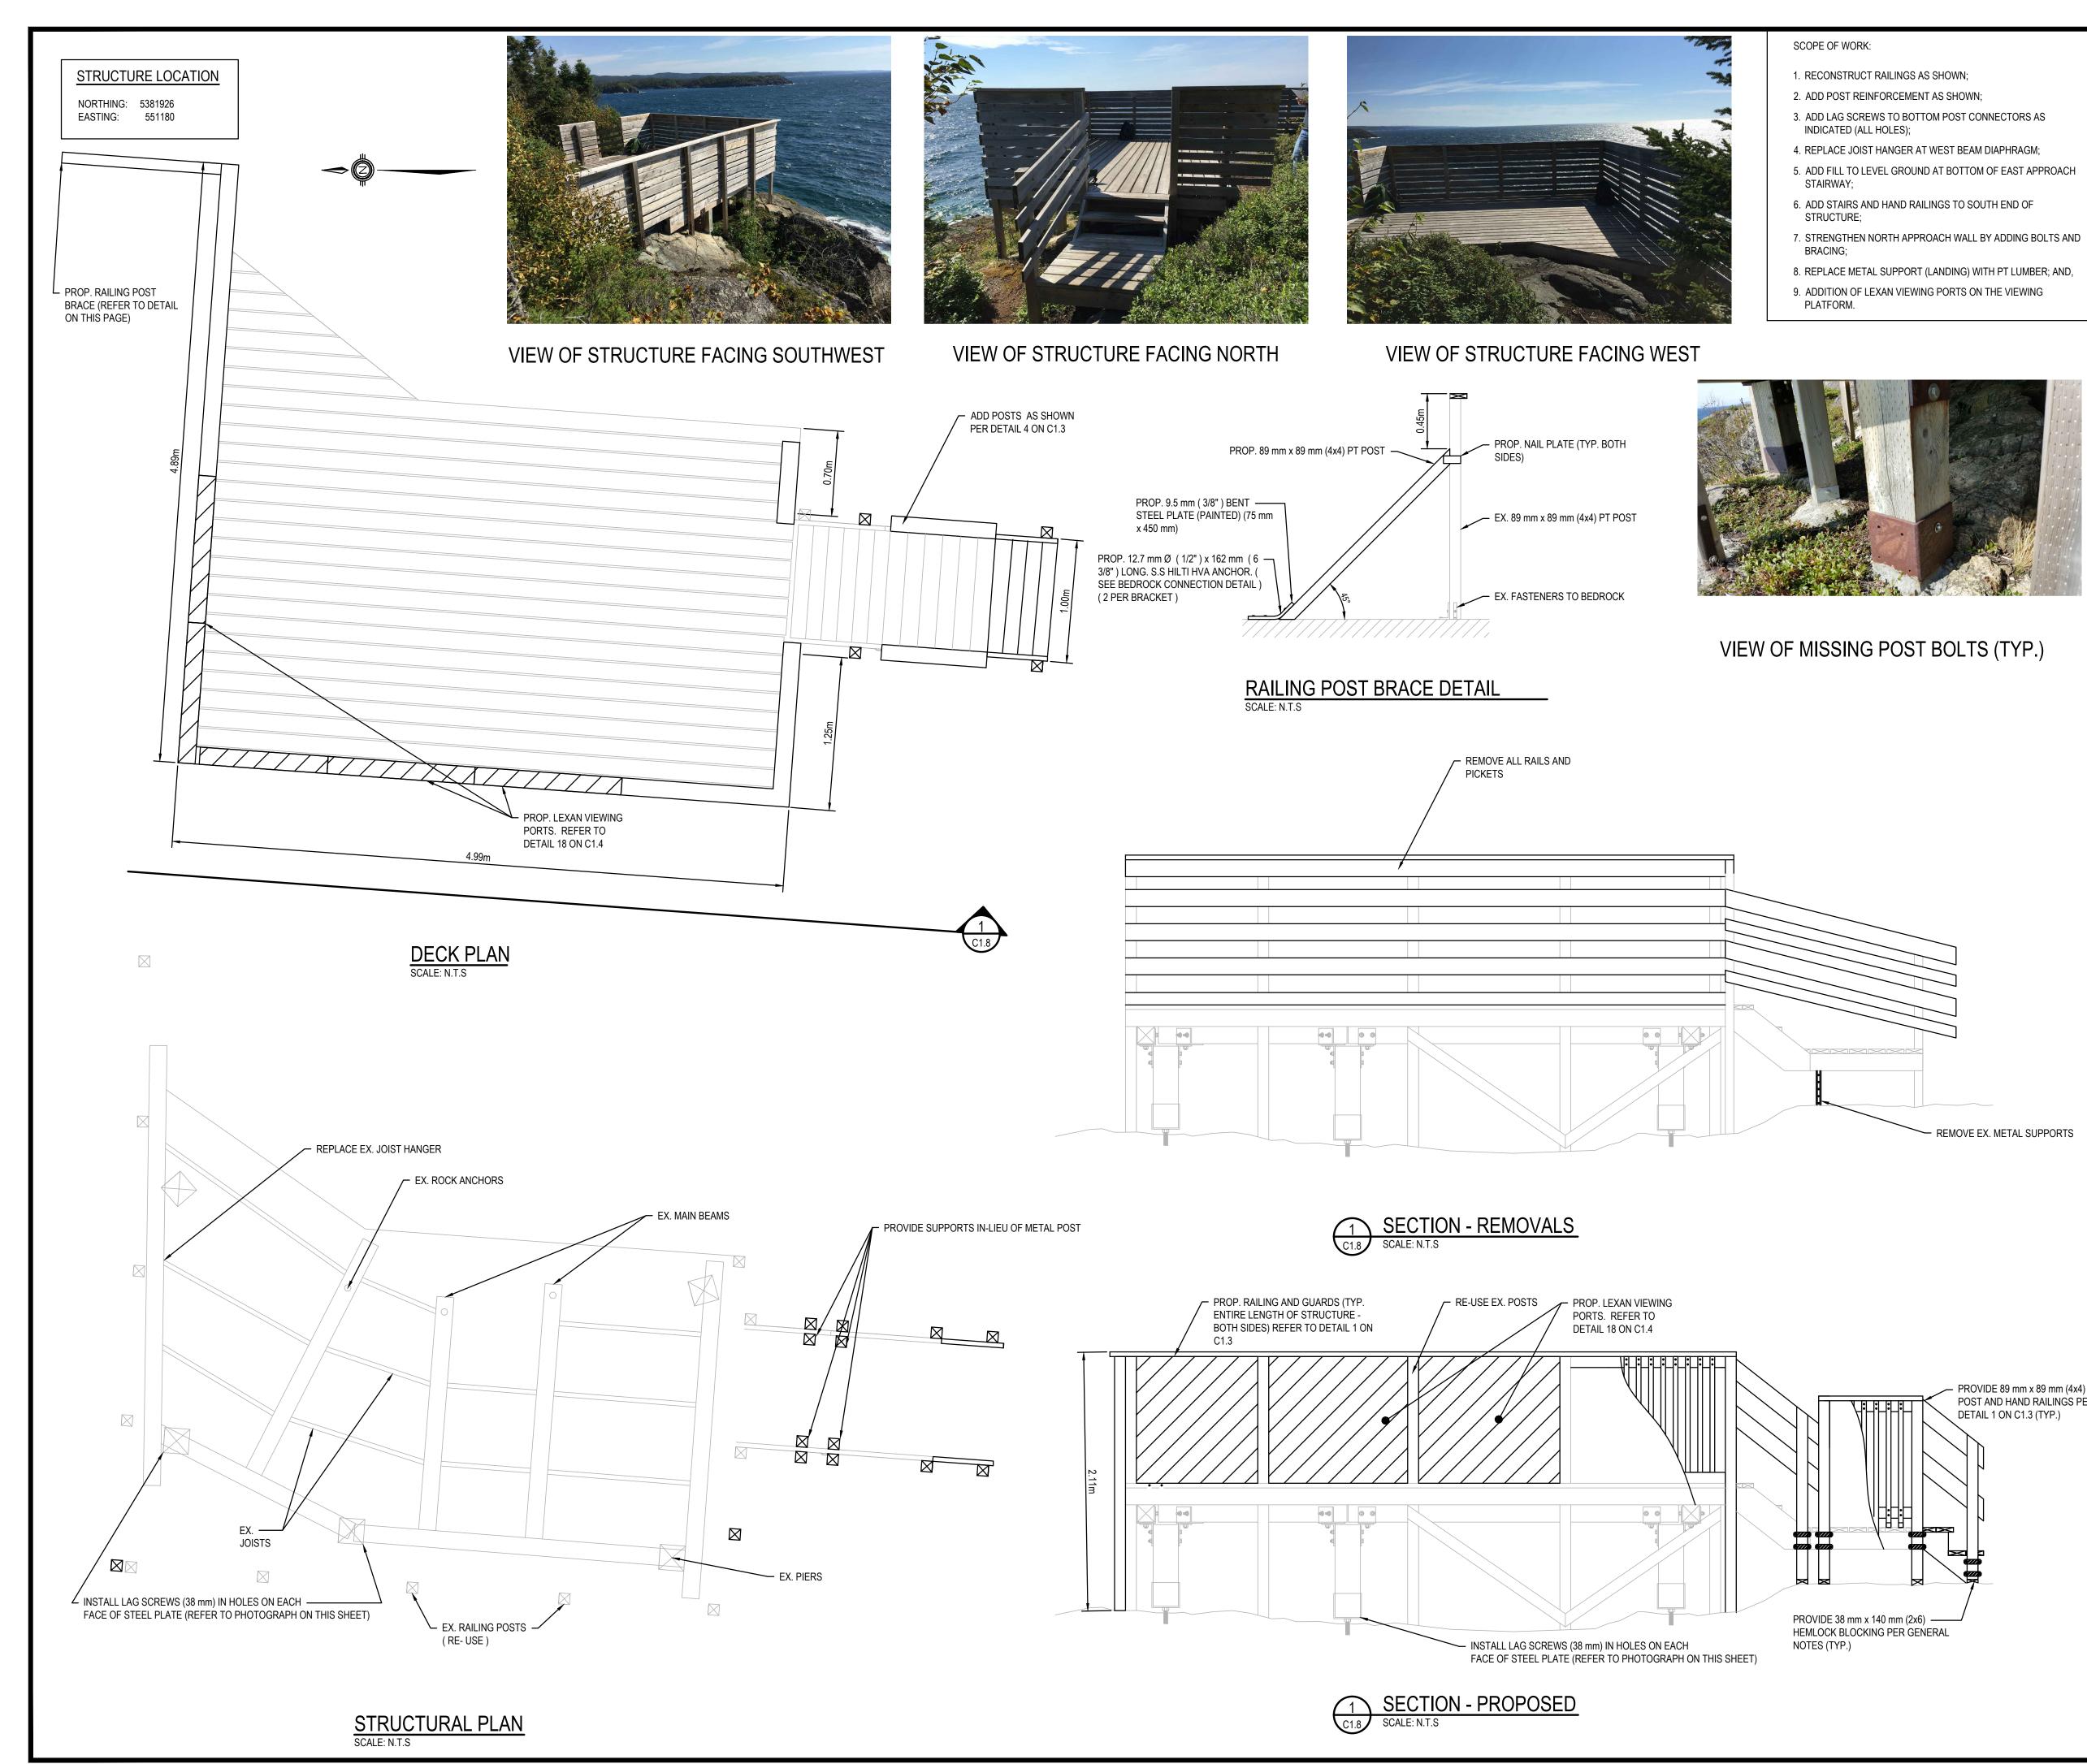- PROVIDE 89 mm x 89 mm (4x4) PT POST AND HAND RAILINGS PER DETAIL 1 ON C1.3 (TYP.)




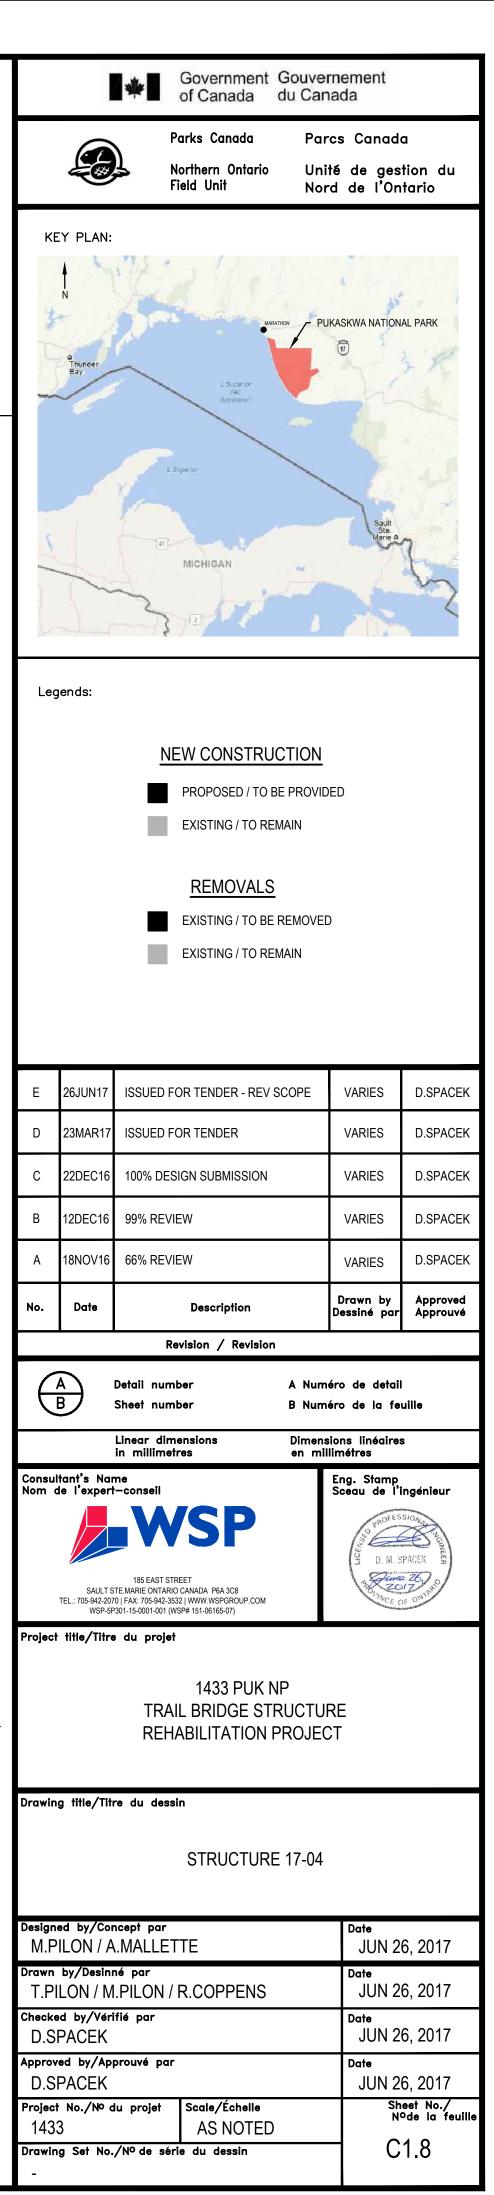

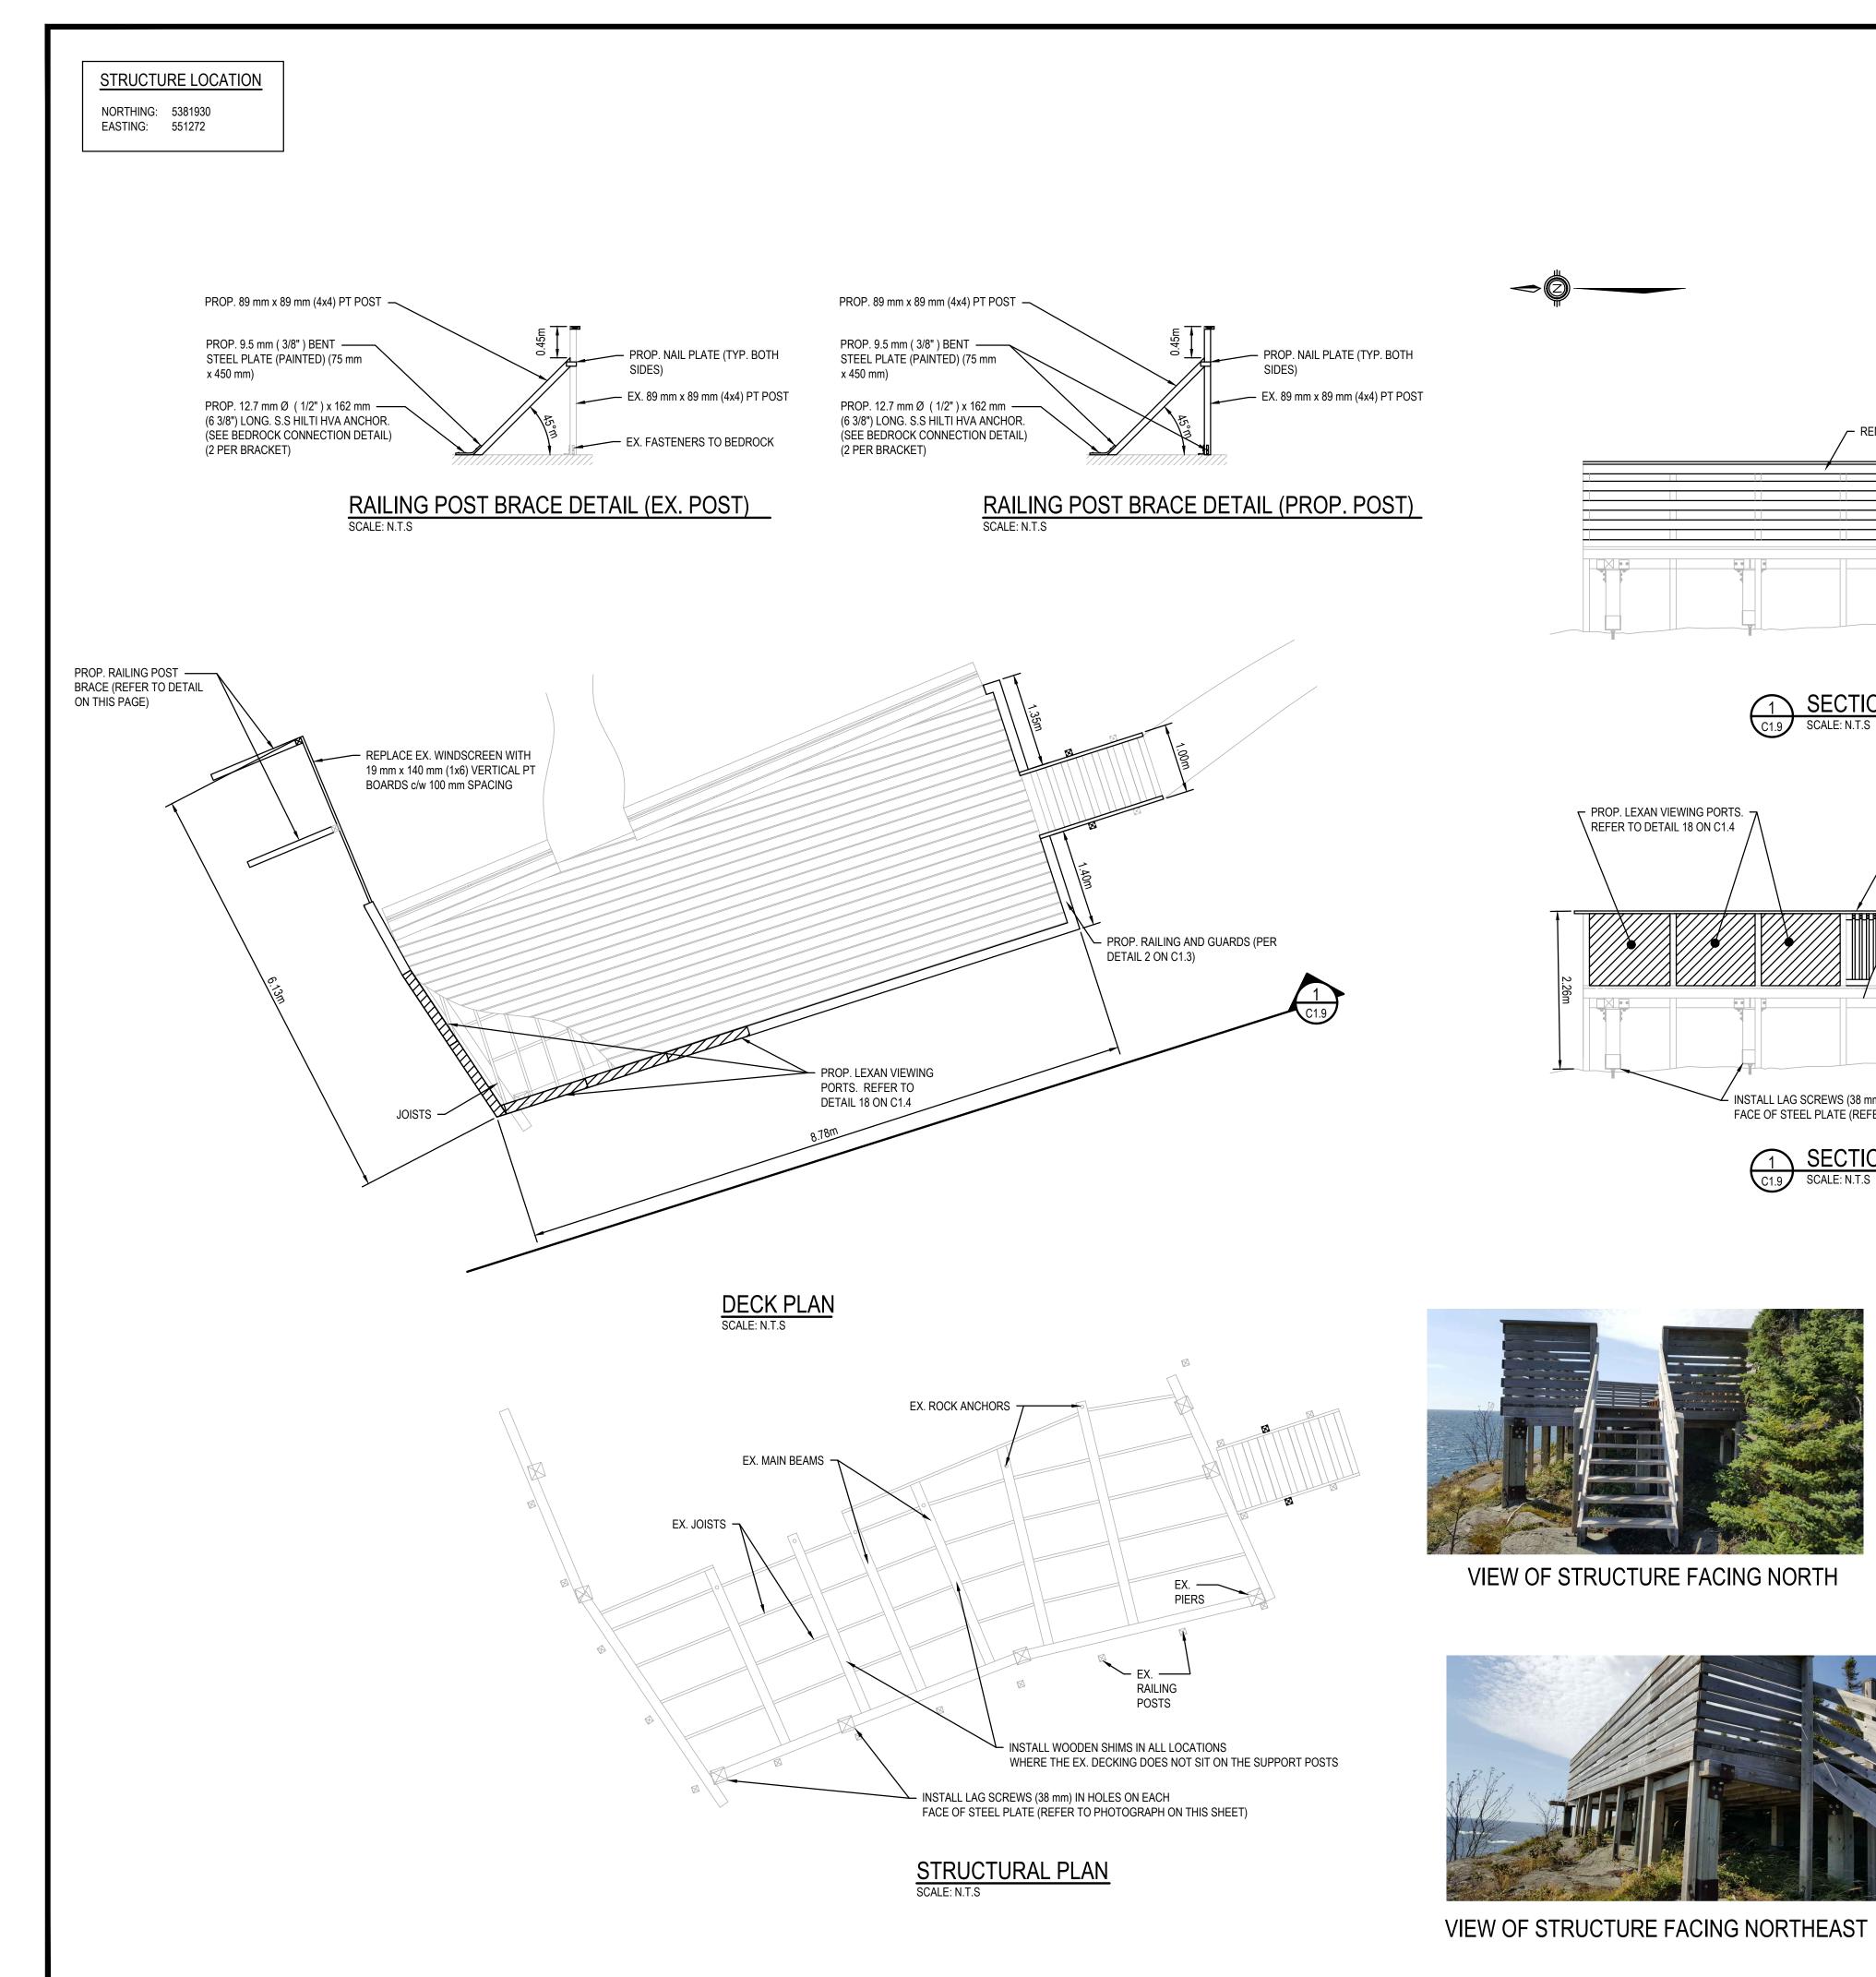





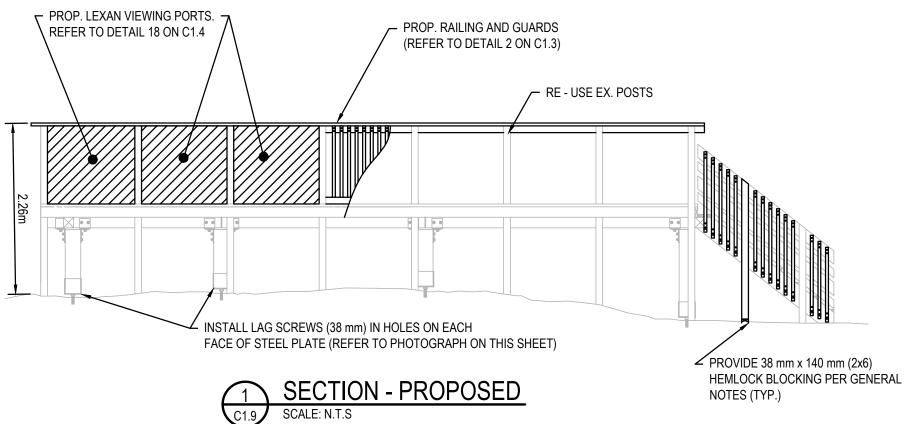







- 1. RECONSTRUCT RAILINGS WITH GUARDS AS SHOWN;
- 2. ADD RAILING POST REINFORCEMENT AS SHOWN;
- 3. ADD LAG SCREWS TO BOTTOM POST CONNECTORS AS INDICATED (ALL HOLES);
- 4. DECK JOISTS NOT BEARING ON SOUTH BEAM AT SOME LOCATIONS. ADD SHIMS TO PROVIDE BEARING ON BEAM;
- 5. SUPPORT ON WALL EXTENSION NOT PROPERLY FASTENED, ADD BRACE FOR ENHANCED SUPPORT;
- 6. SHIMS SHOULD BE ADDED BENEATH THE STRUCTURE FOR ADEQUATE LOAD TRANSFER;
- 7. EX. WINDSCREEN REPLACE HORIZONTAL PICKETS WITH VERTICAL PICKETS SPACED AT 100 MM; AND,
- 8. ADDITION OF LEXAN VIEWING PORTS ON THE VIEWING PLATFORM.




VIEW OF STRUCTURE FACING SOUTHWEST


VIEW OF MISSING SUPPORT BOLTING ADD LAG SCREWS

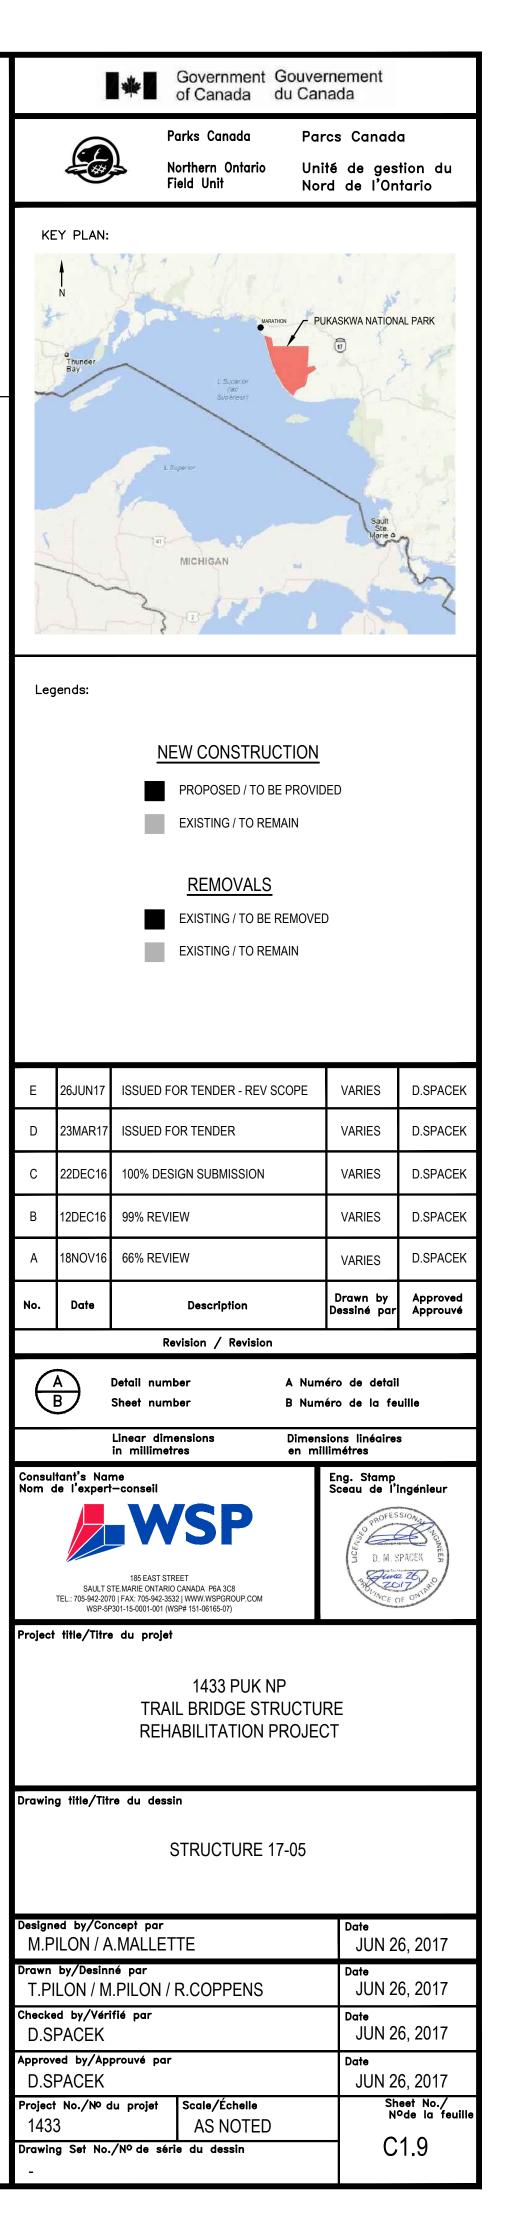

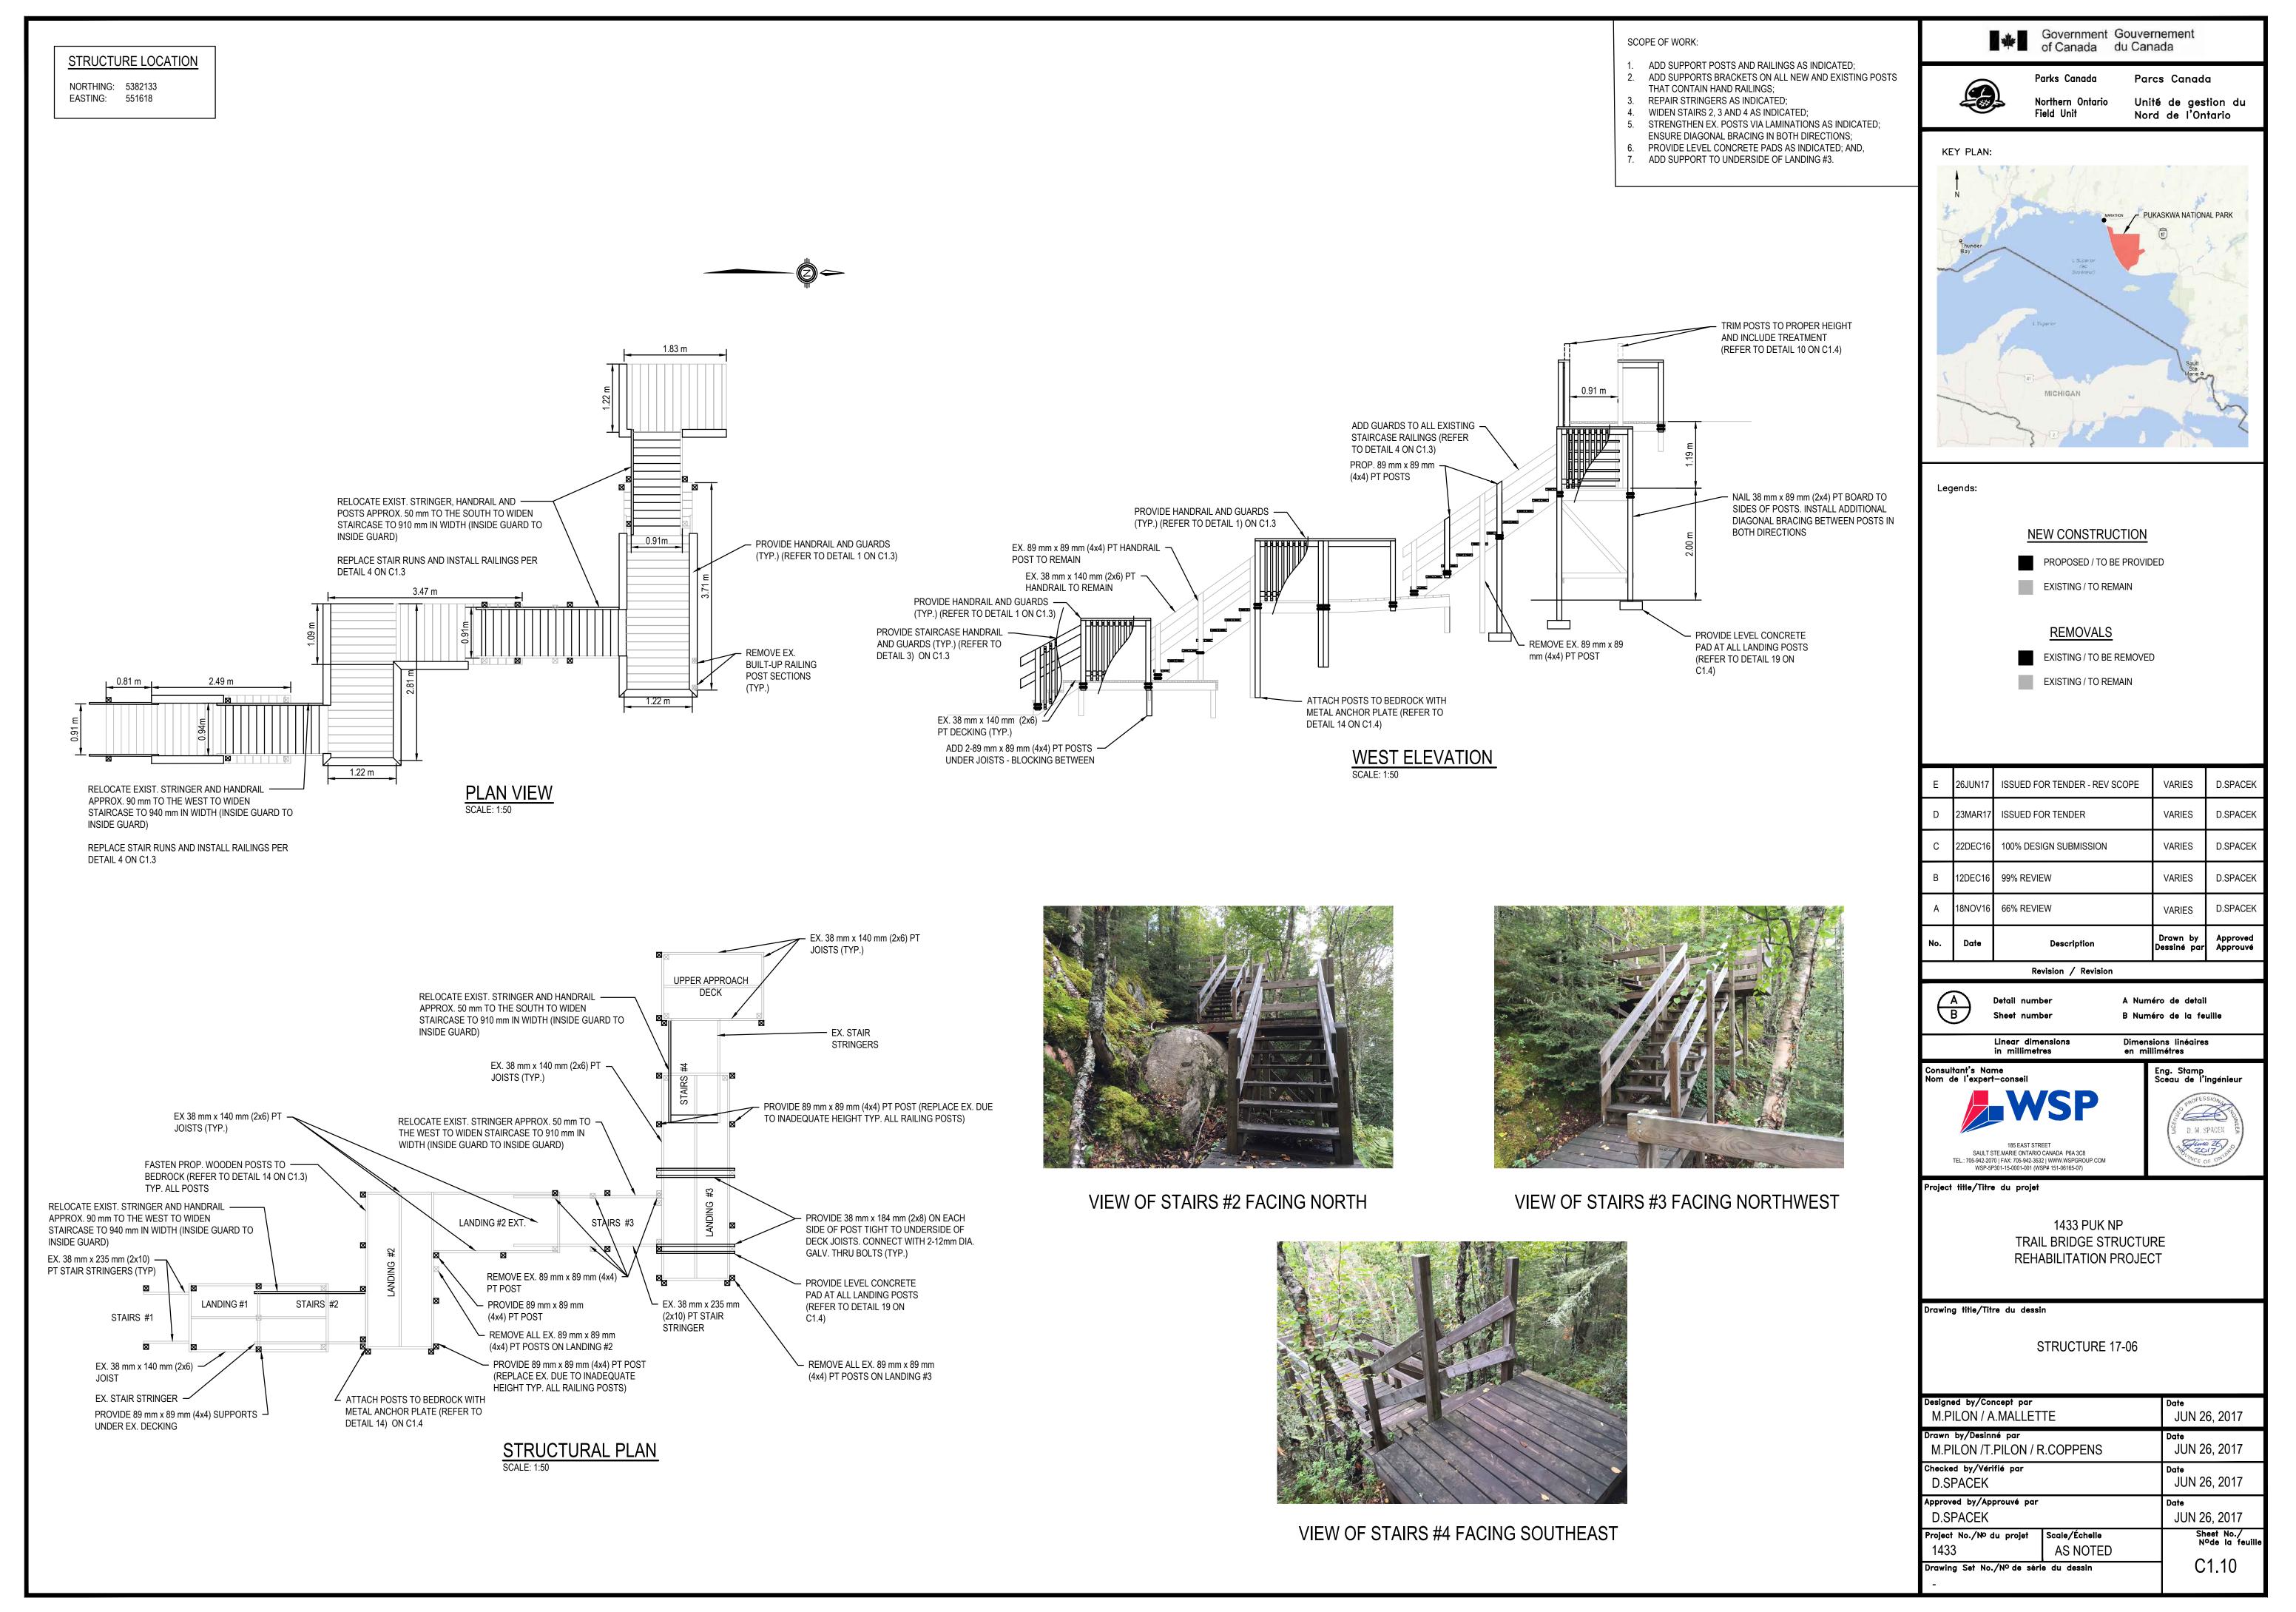


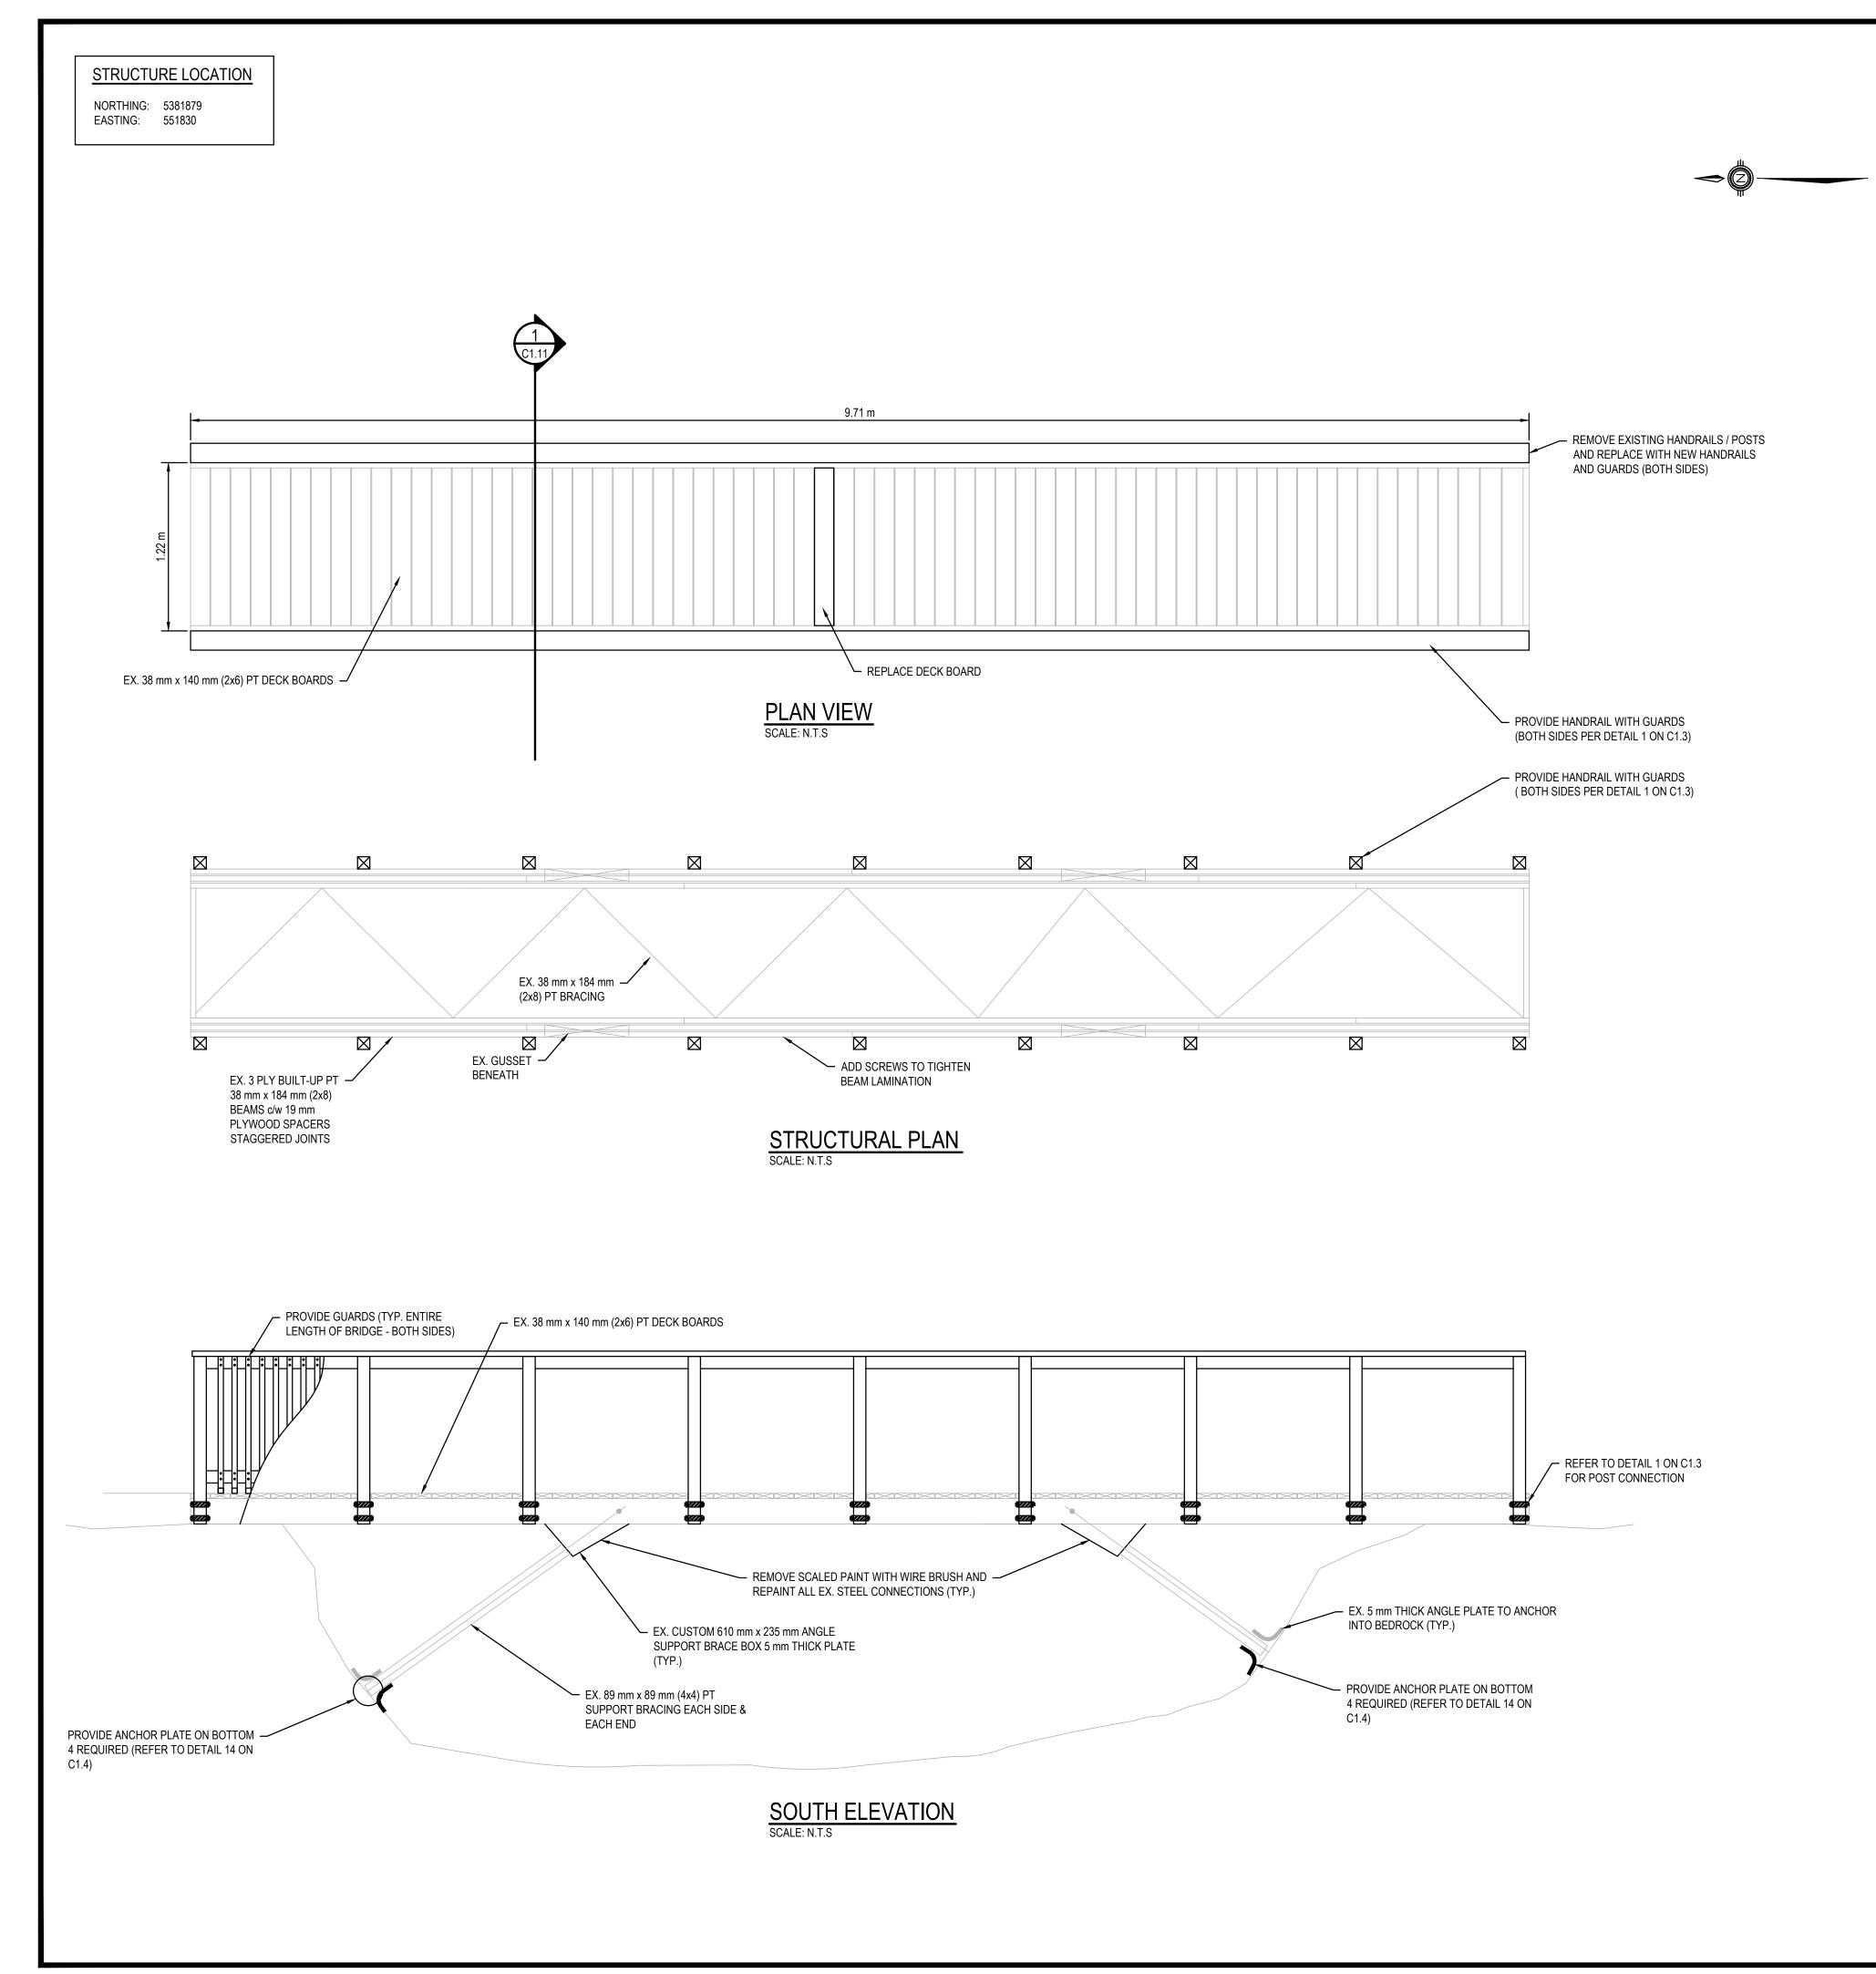



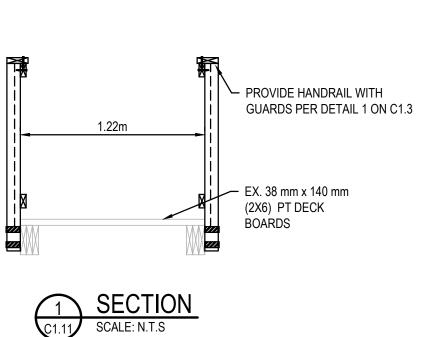

- 1. BEAM LAMINATIONS ARE LOOSE. ADD SCREWS TO TIGHTEN;
- 2. CONNECT KNEE BRACING TO BEDROCK AS INDICATED;
- 3. REPLACE ONE WEAK DECK BOARD NEXT TO CENTER RAIL POST;
- 4. REPLACE HAND RAILINGS AND GUARDS AS SHOWN;
- 5. PAINT GUSSET BRACKETS AS INDICATED; AND,
- 6. REPLACE CRACKED DECK BOARDS (APPROX. 5).

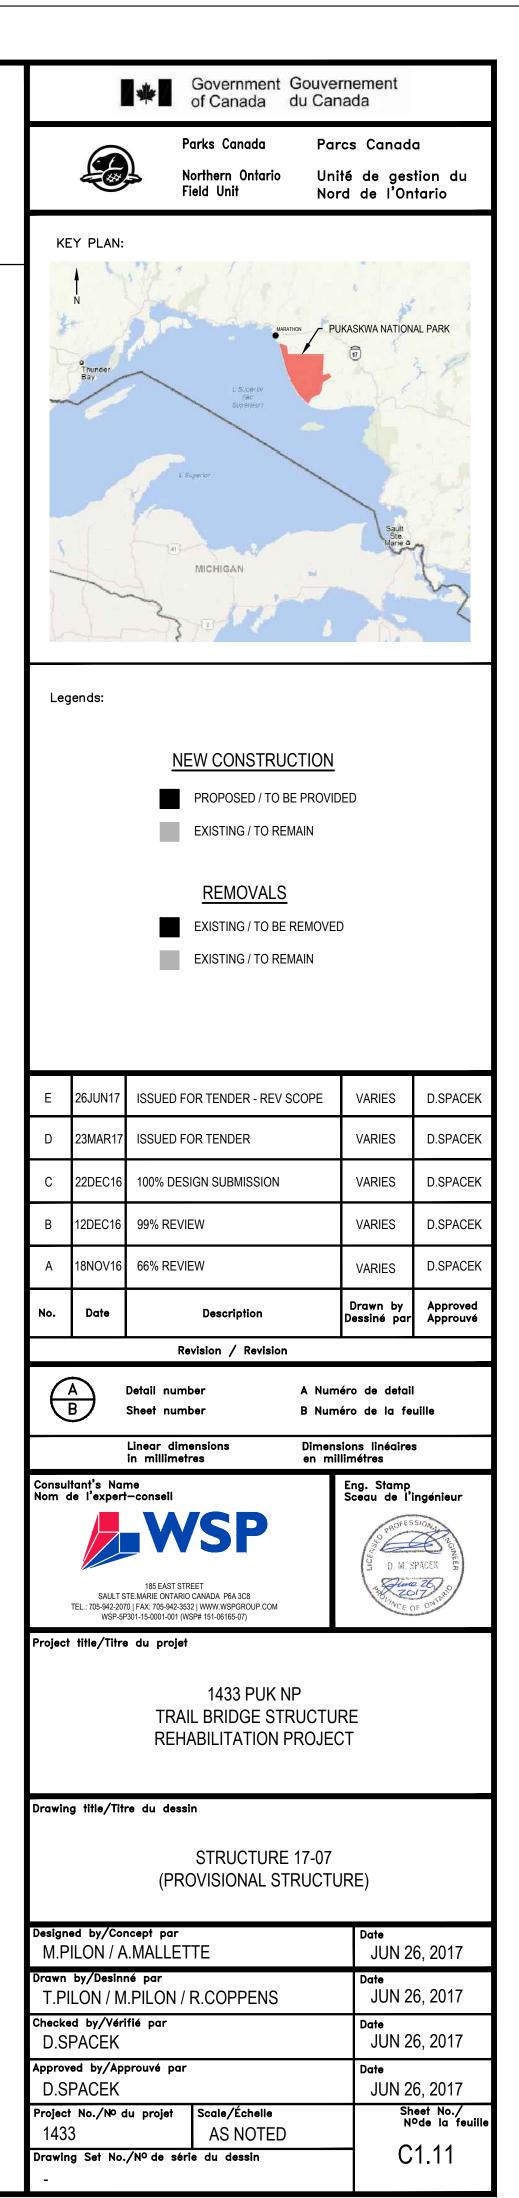






VIEW OF STRUCTURE FACING NORTH





VIEW OF STRUCTURE FACING SOUTH

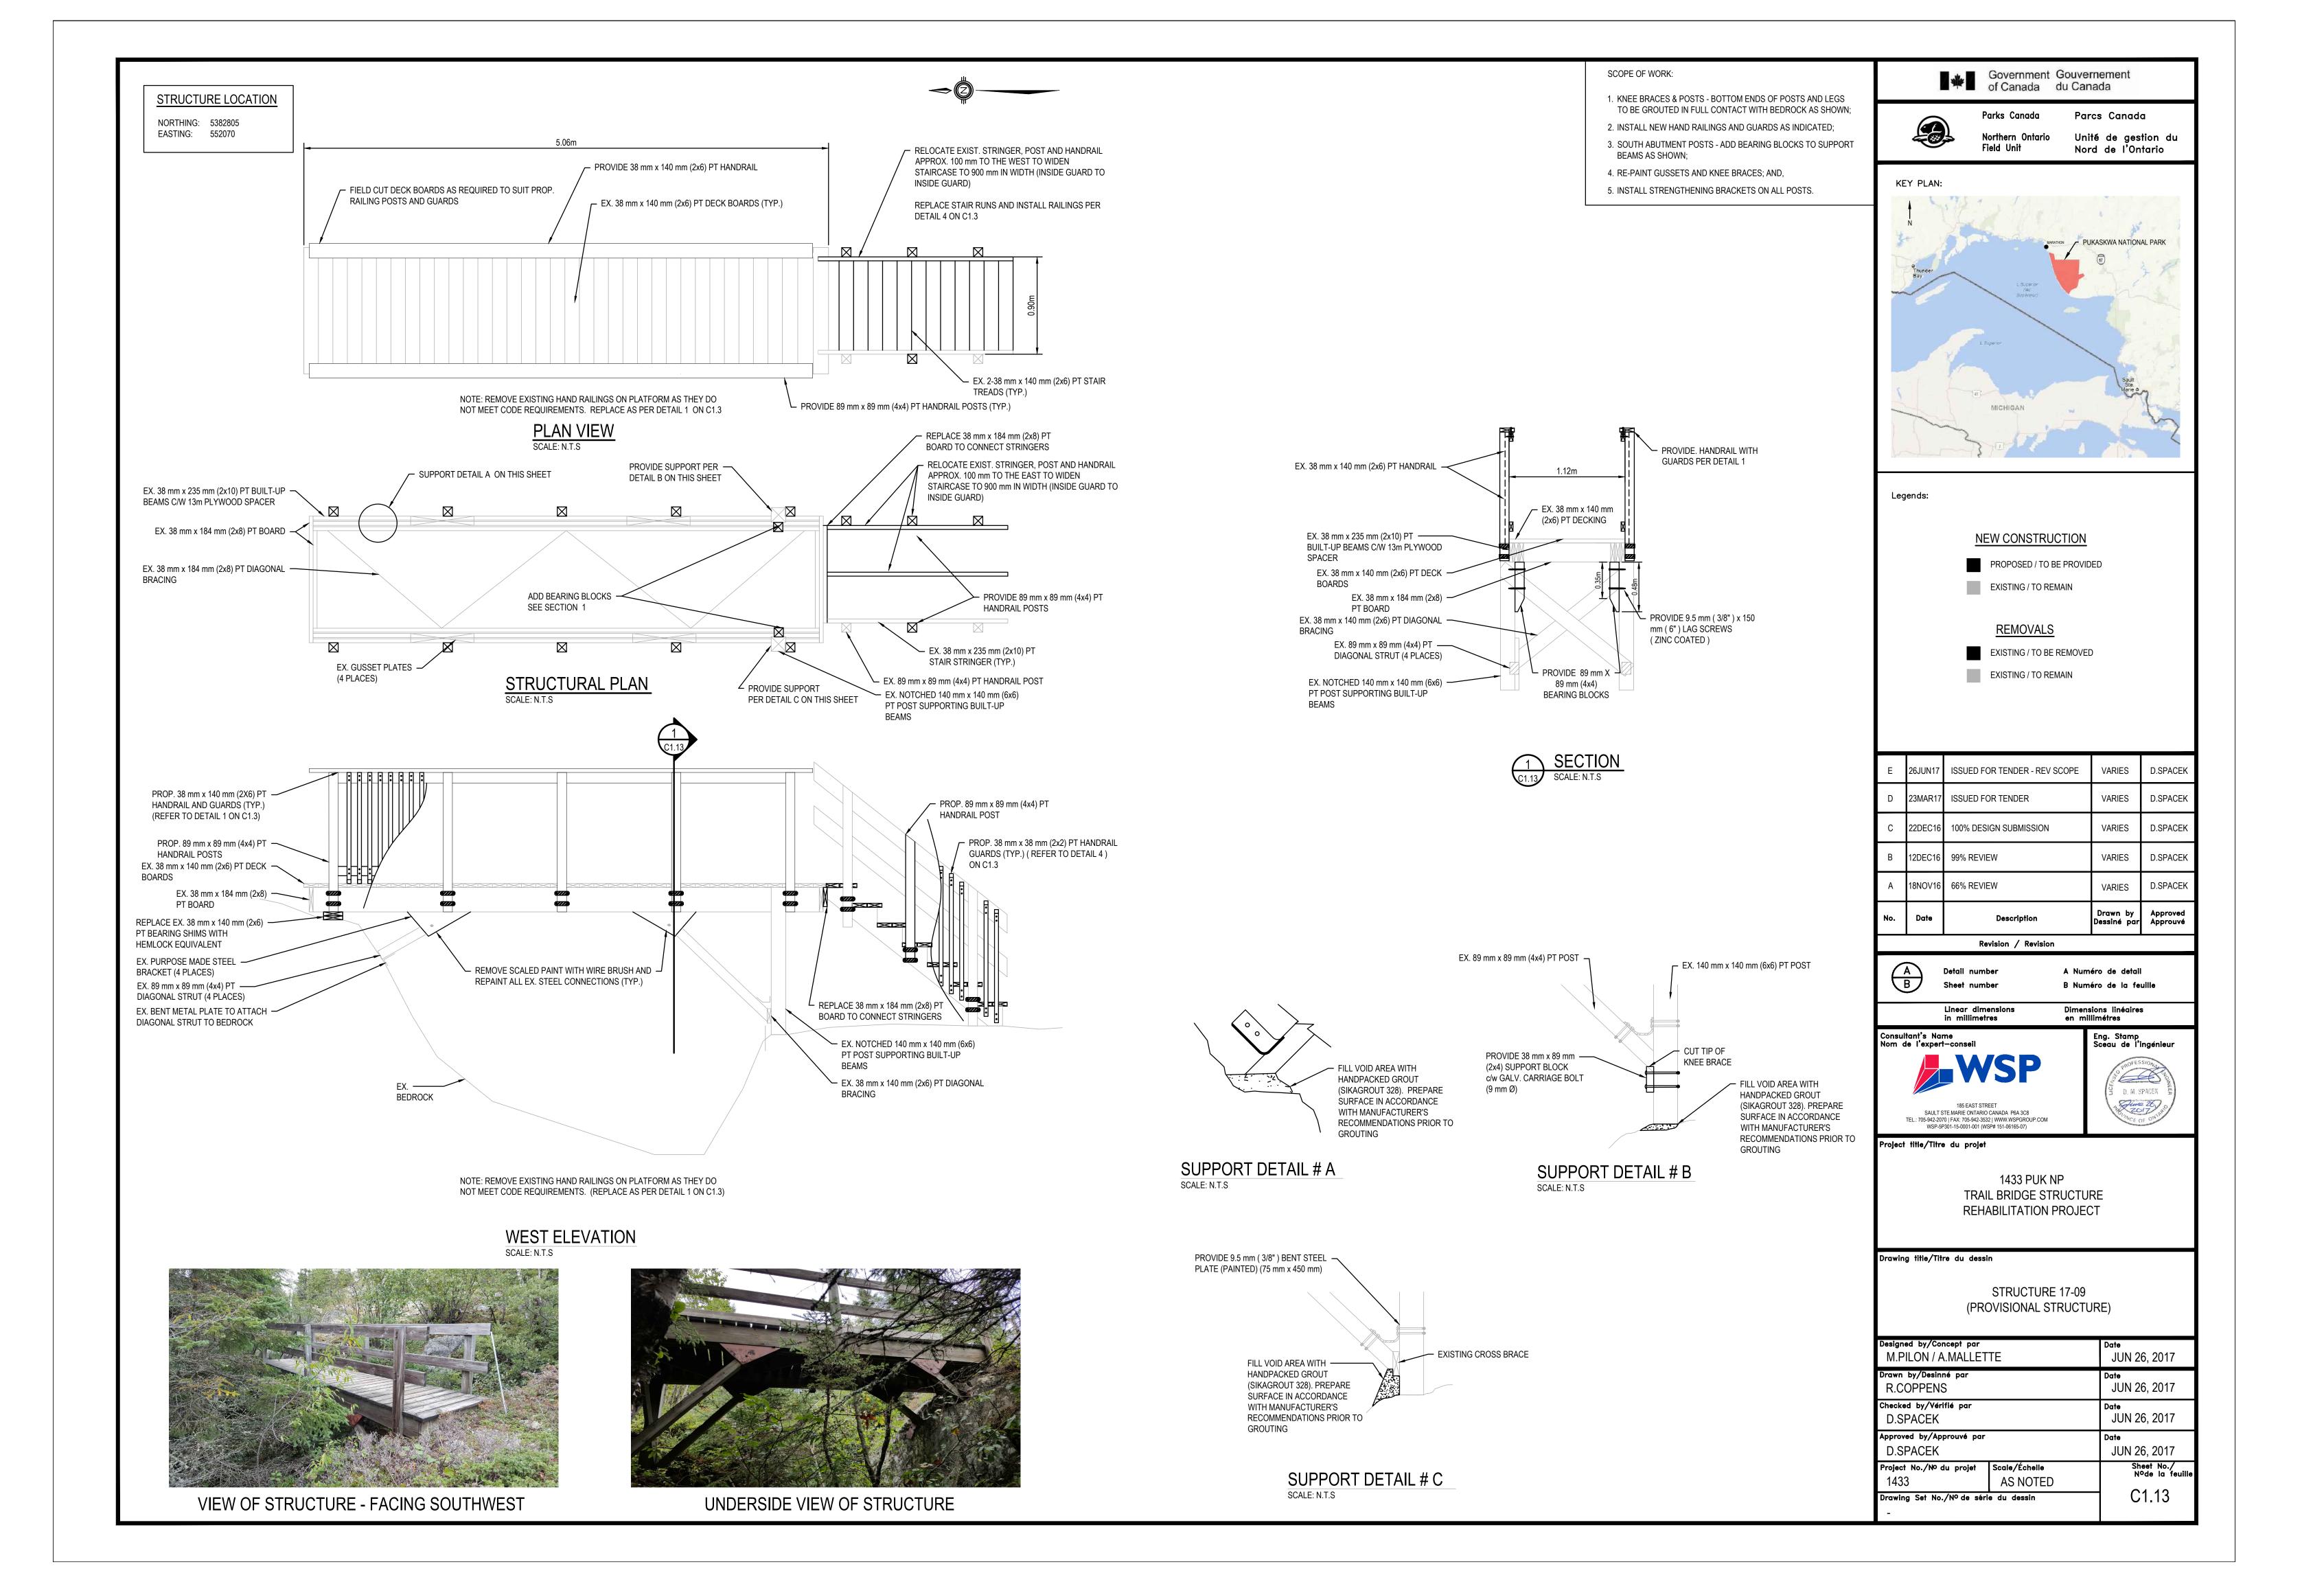


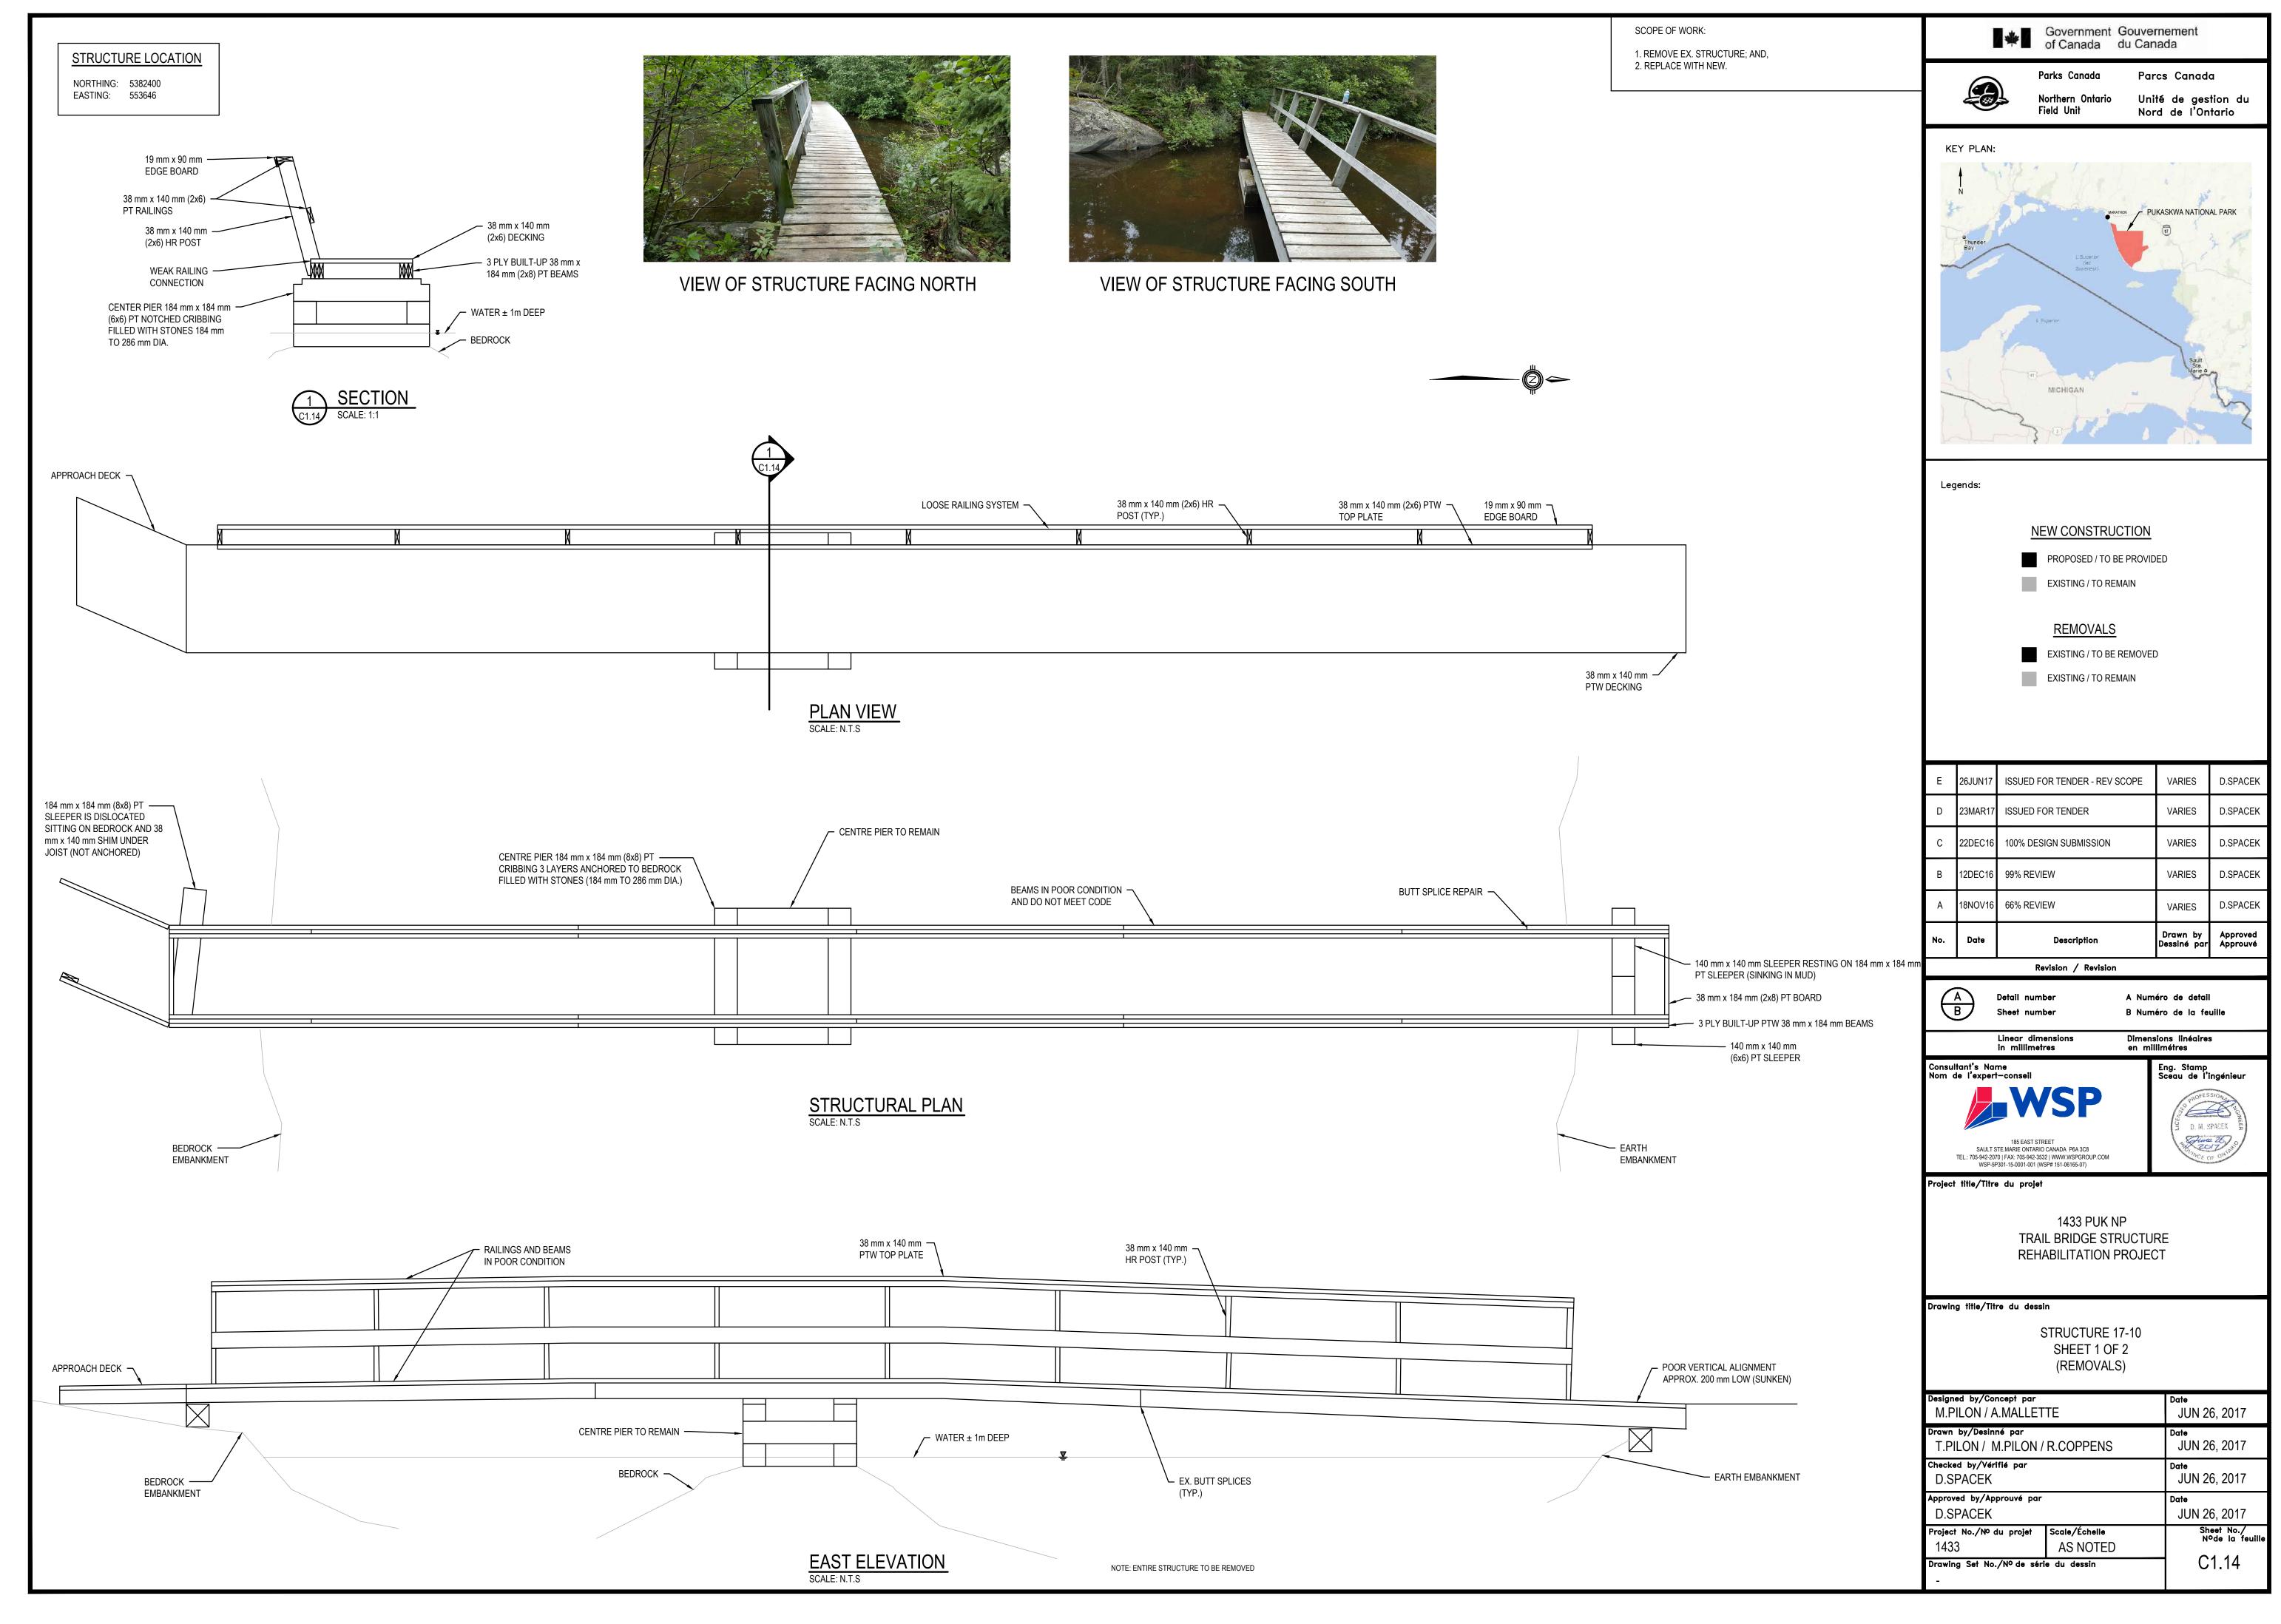

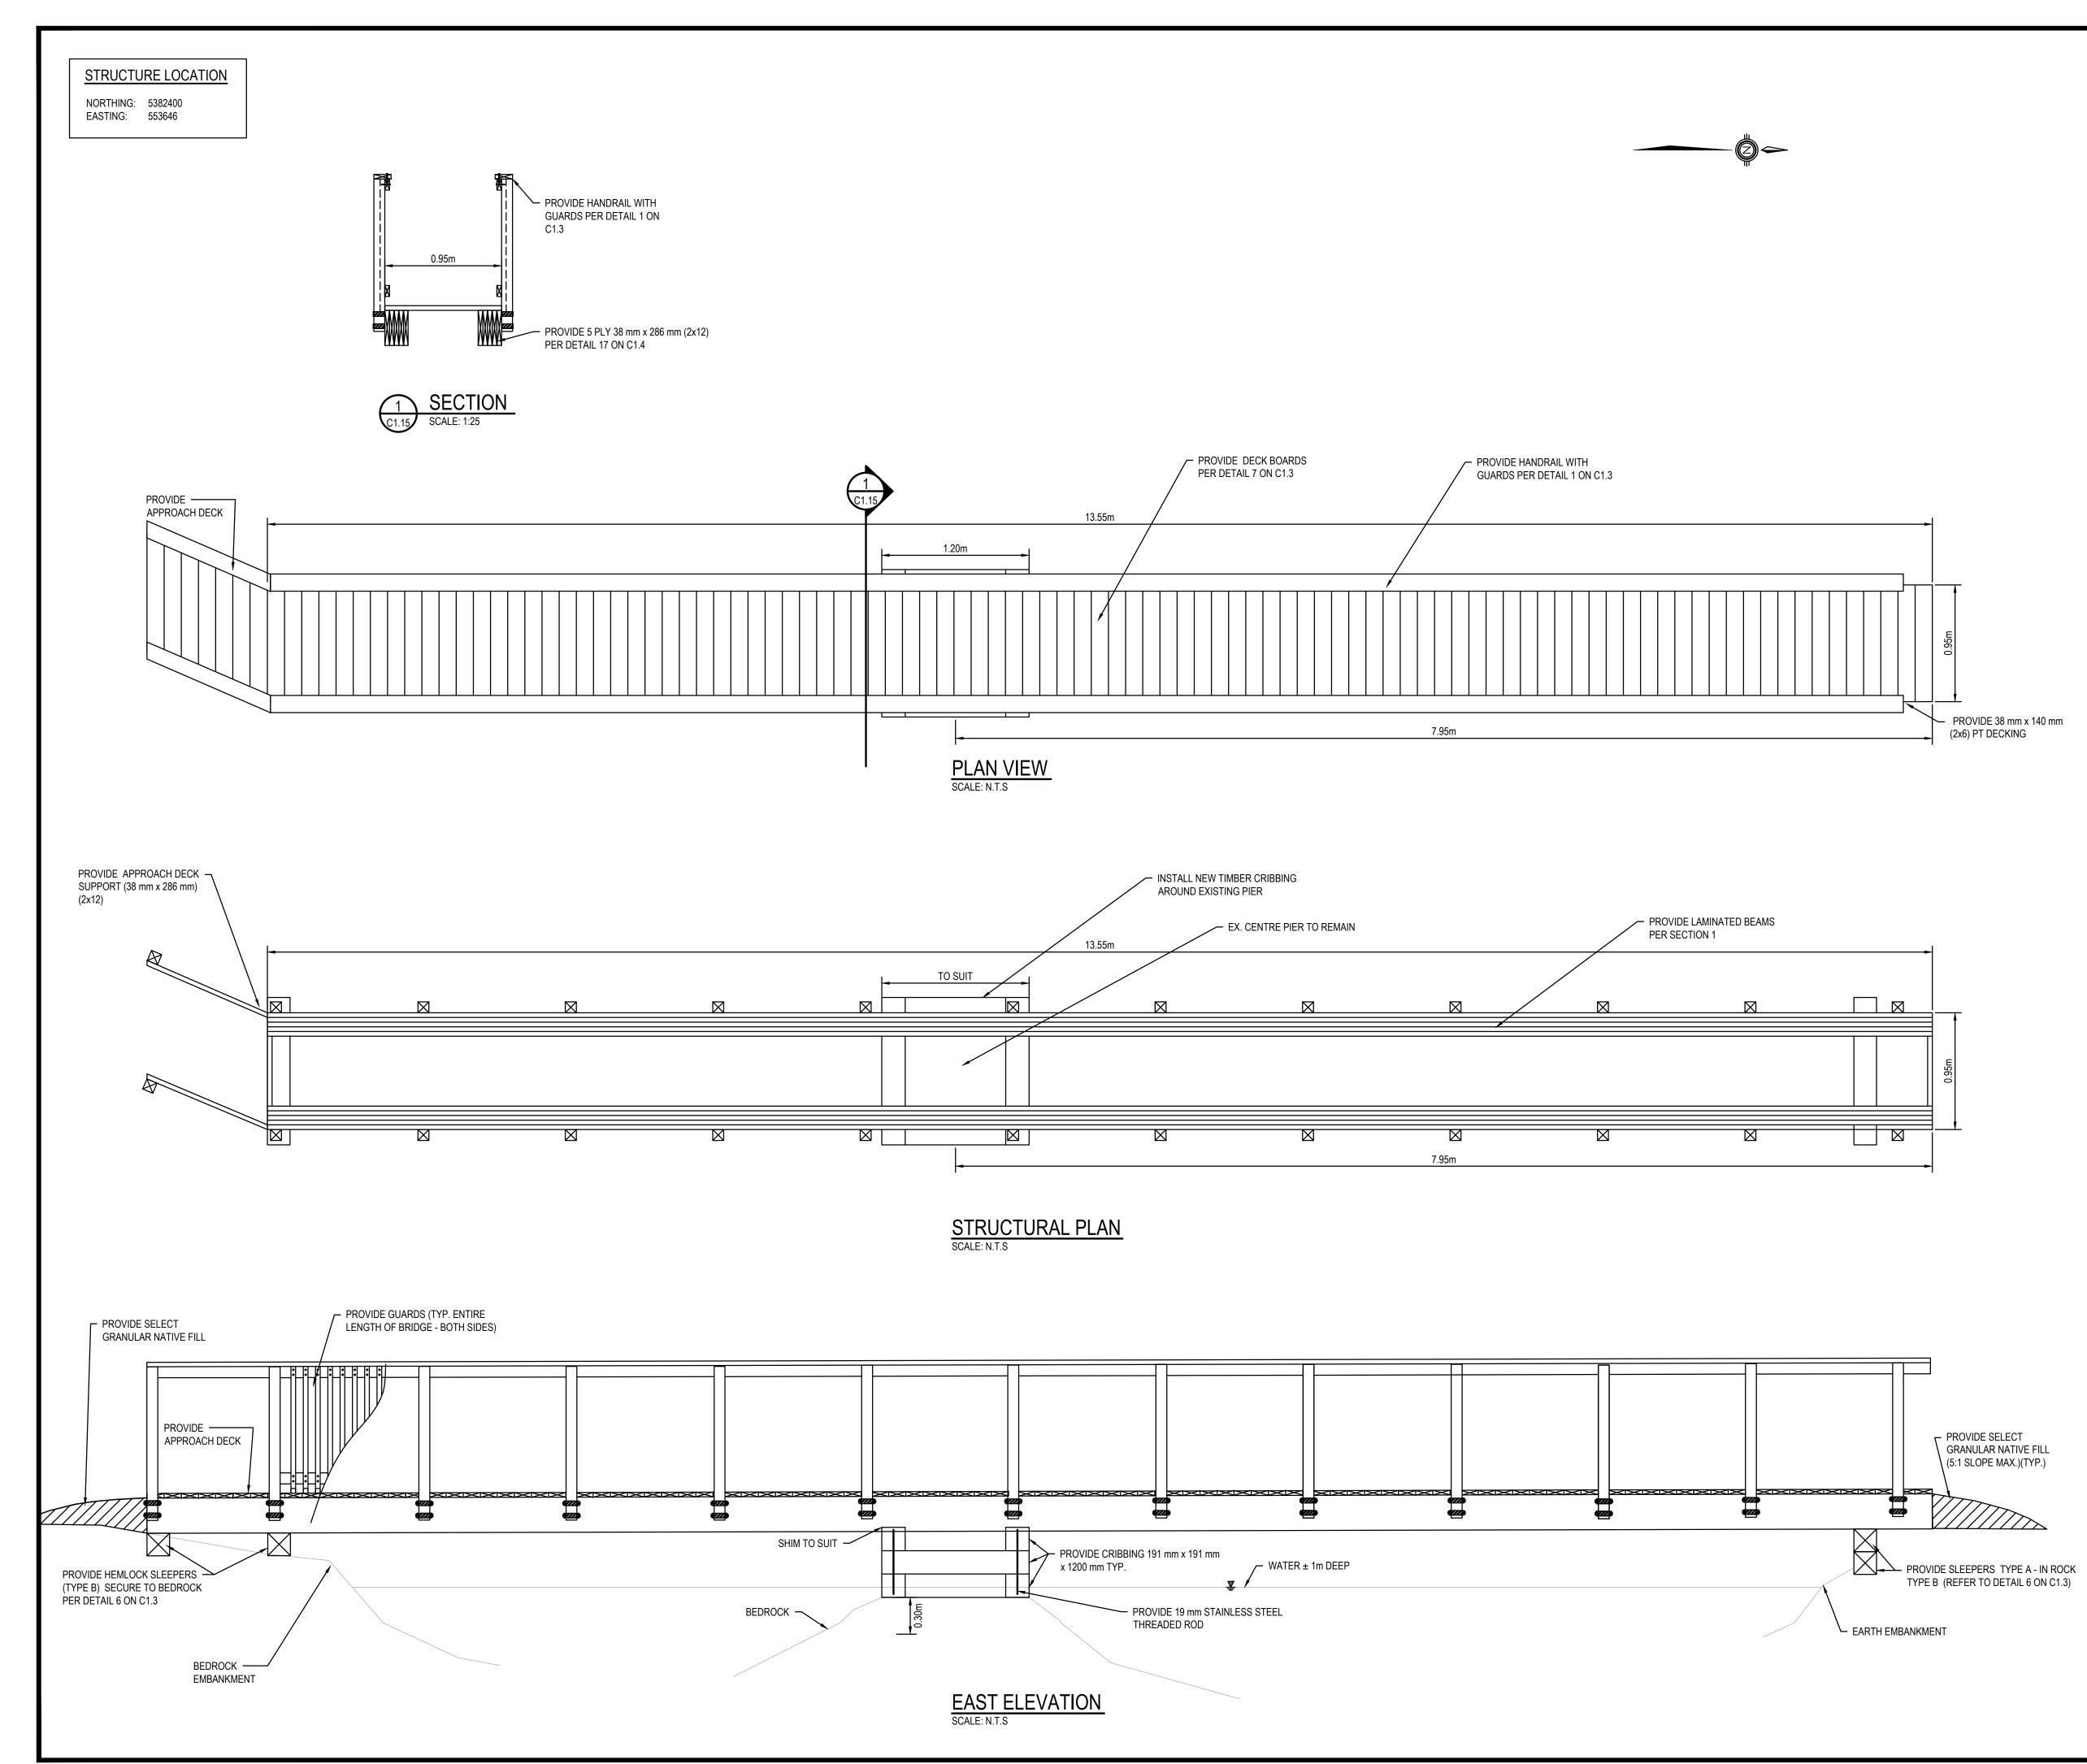


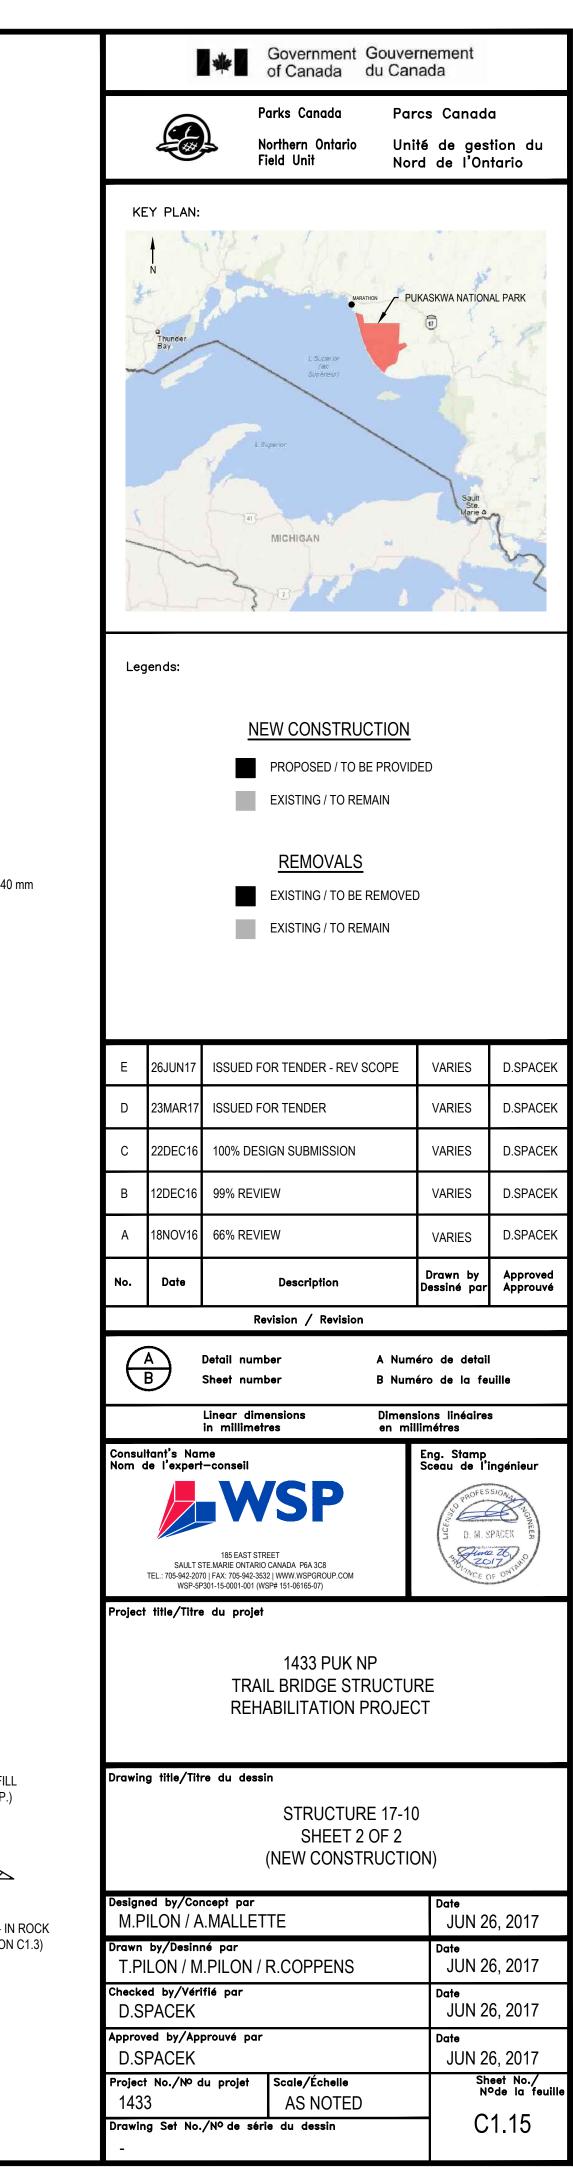

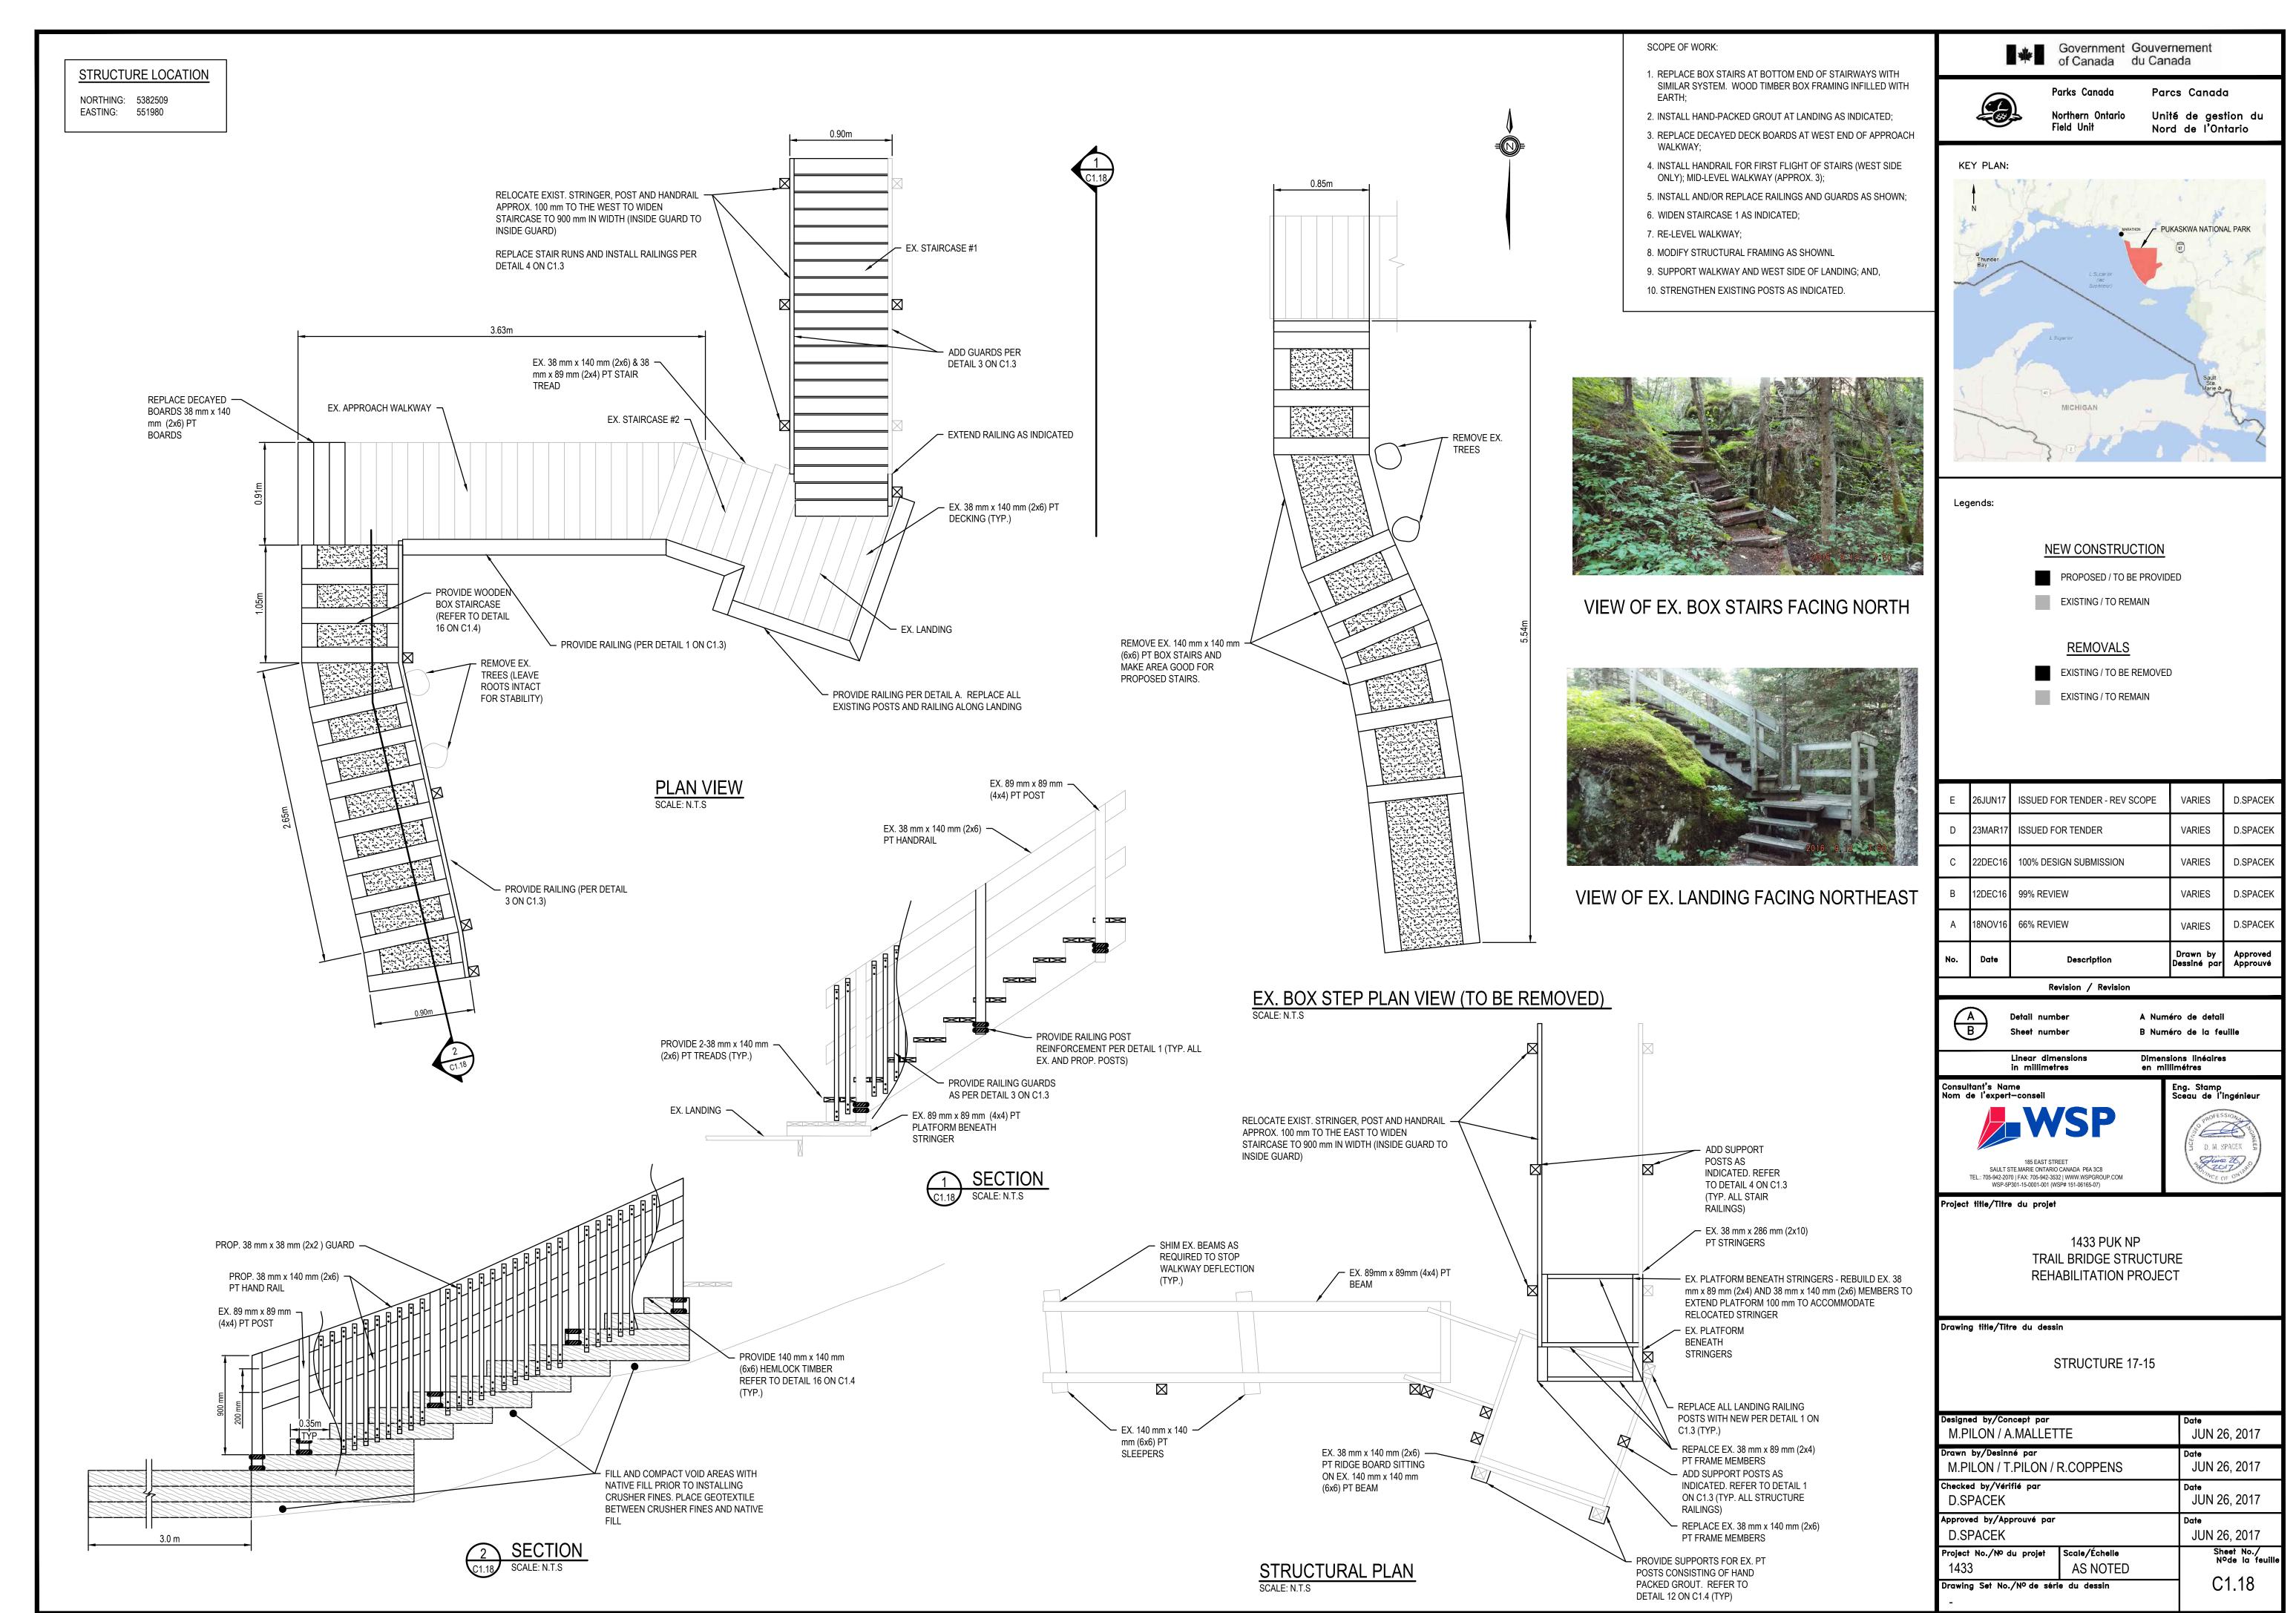

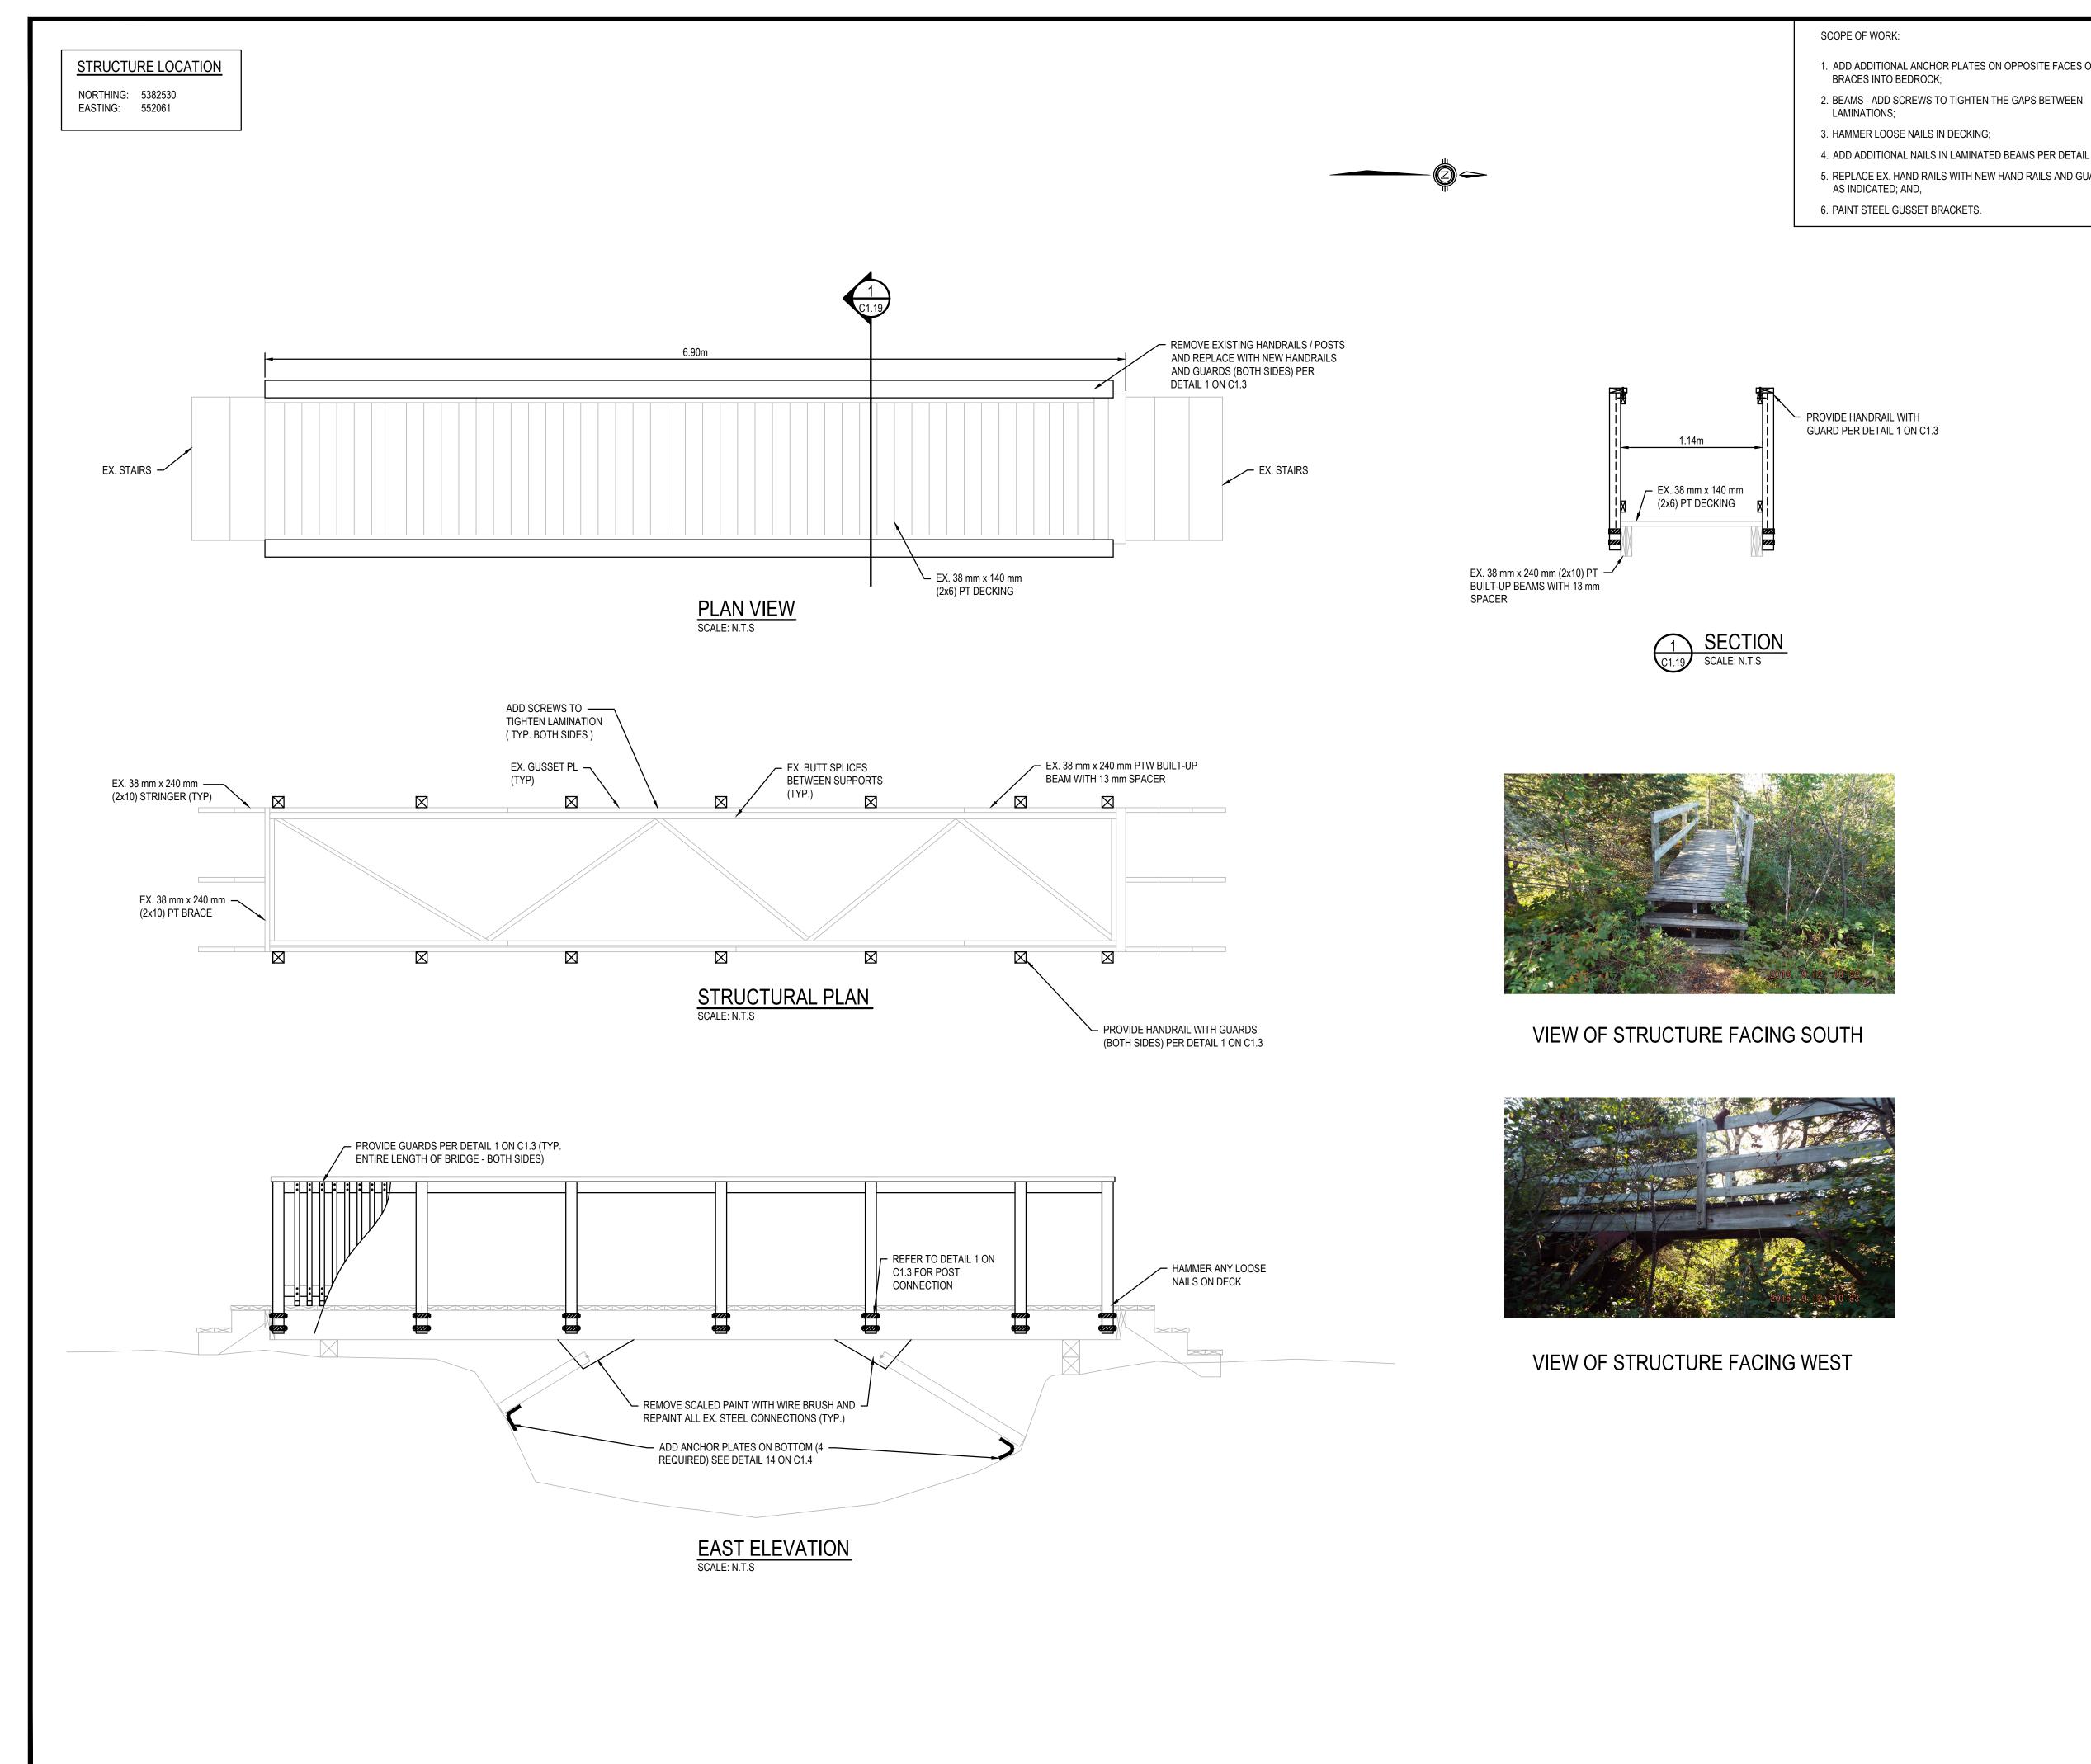




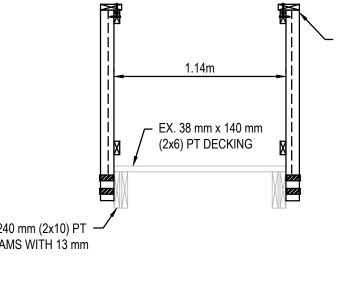


- 1. ADD ADDITIONAL ANCHOR PLATES ON OPPOSITE FACES OF KNEE BRACES INTO BEDROCK;
- LAMINATIONS;
- 3. HAMMER LOOSE NAILS IN DECKING;
- 4. ADD ADDITIONAL NAILS IN LAMINATED BEAMS PER DETAIL 17;
- 5. REPLACE EX. HAND RAILS WITH NEW HAND RAILS AND GUARDS AS INDICATED; AND,
- 6. PAINT STEEL GUSSET BRACKETS.

GUARD PER DETAIL 1 ON C1.3

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KI	EY PLAN:								
	n Thunder Bay	L Superior	PUKAS	Sault	IAL PARK				
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D	23MAR17	ISSUED FOR TENDER		VARIES	D.SPACE				
С	22DEC16	100% DESIGN SUBMISSION		VARIES	D.SPACE				
B	12DEC16	99% REVIEW		VARIES	D.SPACE				
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185 EAST STREET SAULT STE.MARIE ONTARIO CANADA P6A 3C8 TEL.: 705-942-2070 FAX: 705-942-3532 WWW.WSPGROUP.COM				D. M. SPACEK					
		301-15-0001-001 (WSP# 151-06165-07)		Project title/Titre du projet 1433 PUK NP TRAIL BRIDGE STRUCTURE REHABILITATION PROJECT Drawing title/Titre du dessin STRUCTURE 17-16 (PROVISIONAL STRUCTURE)					
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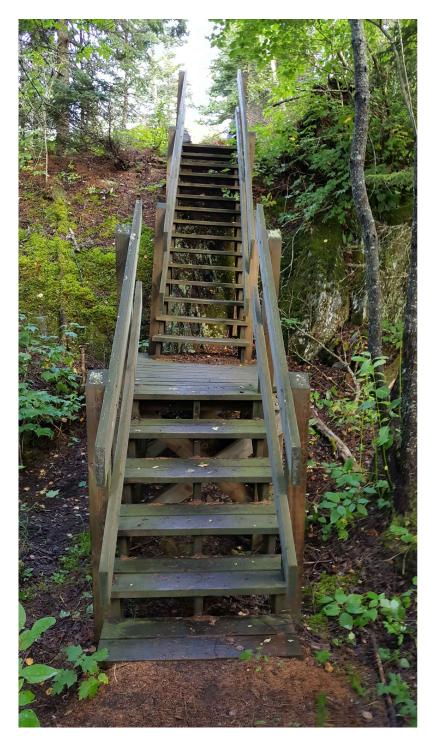


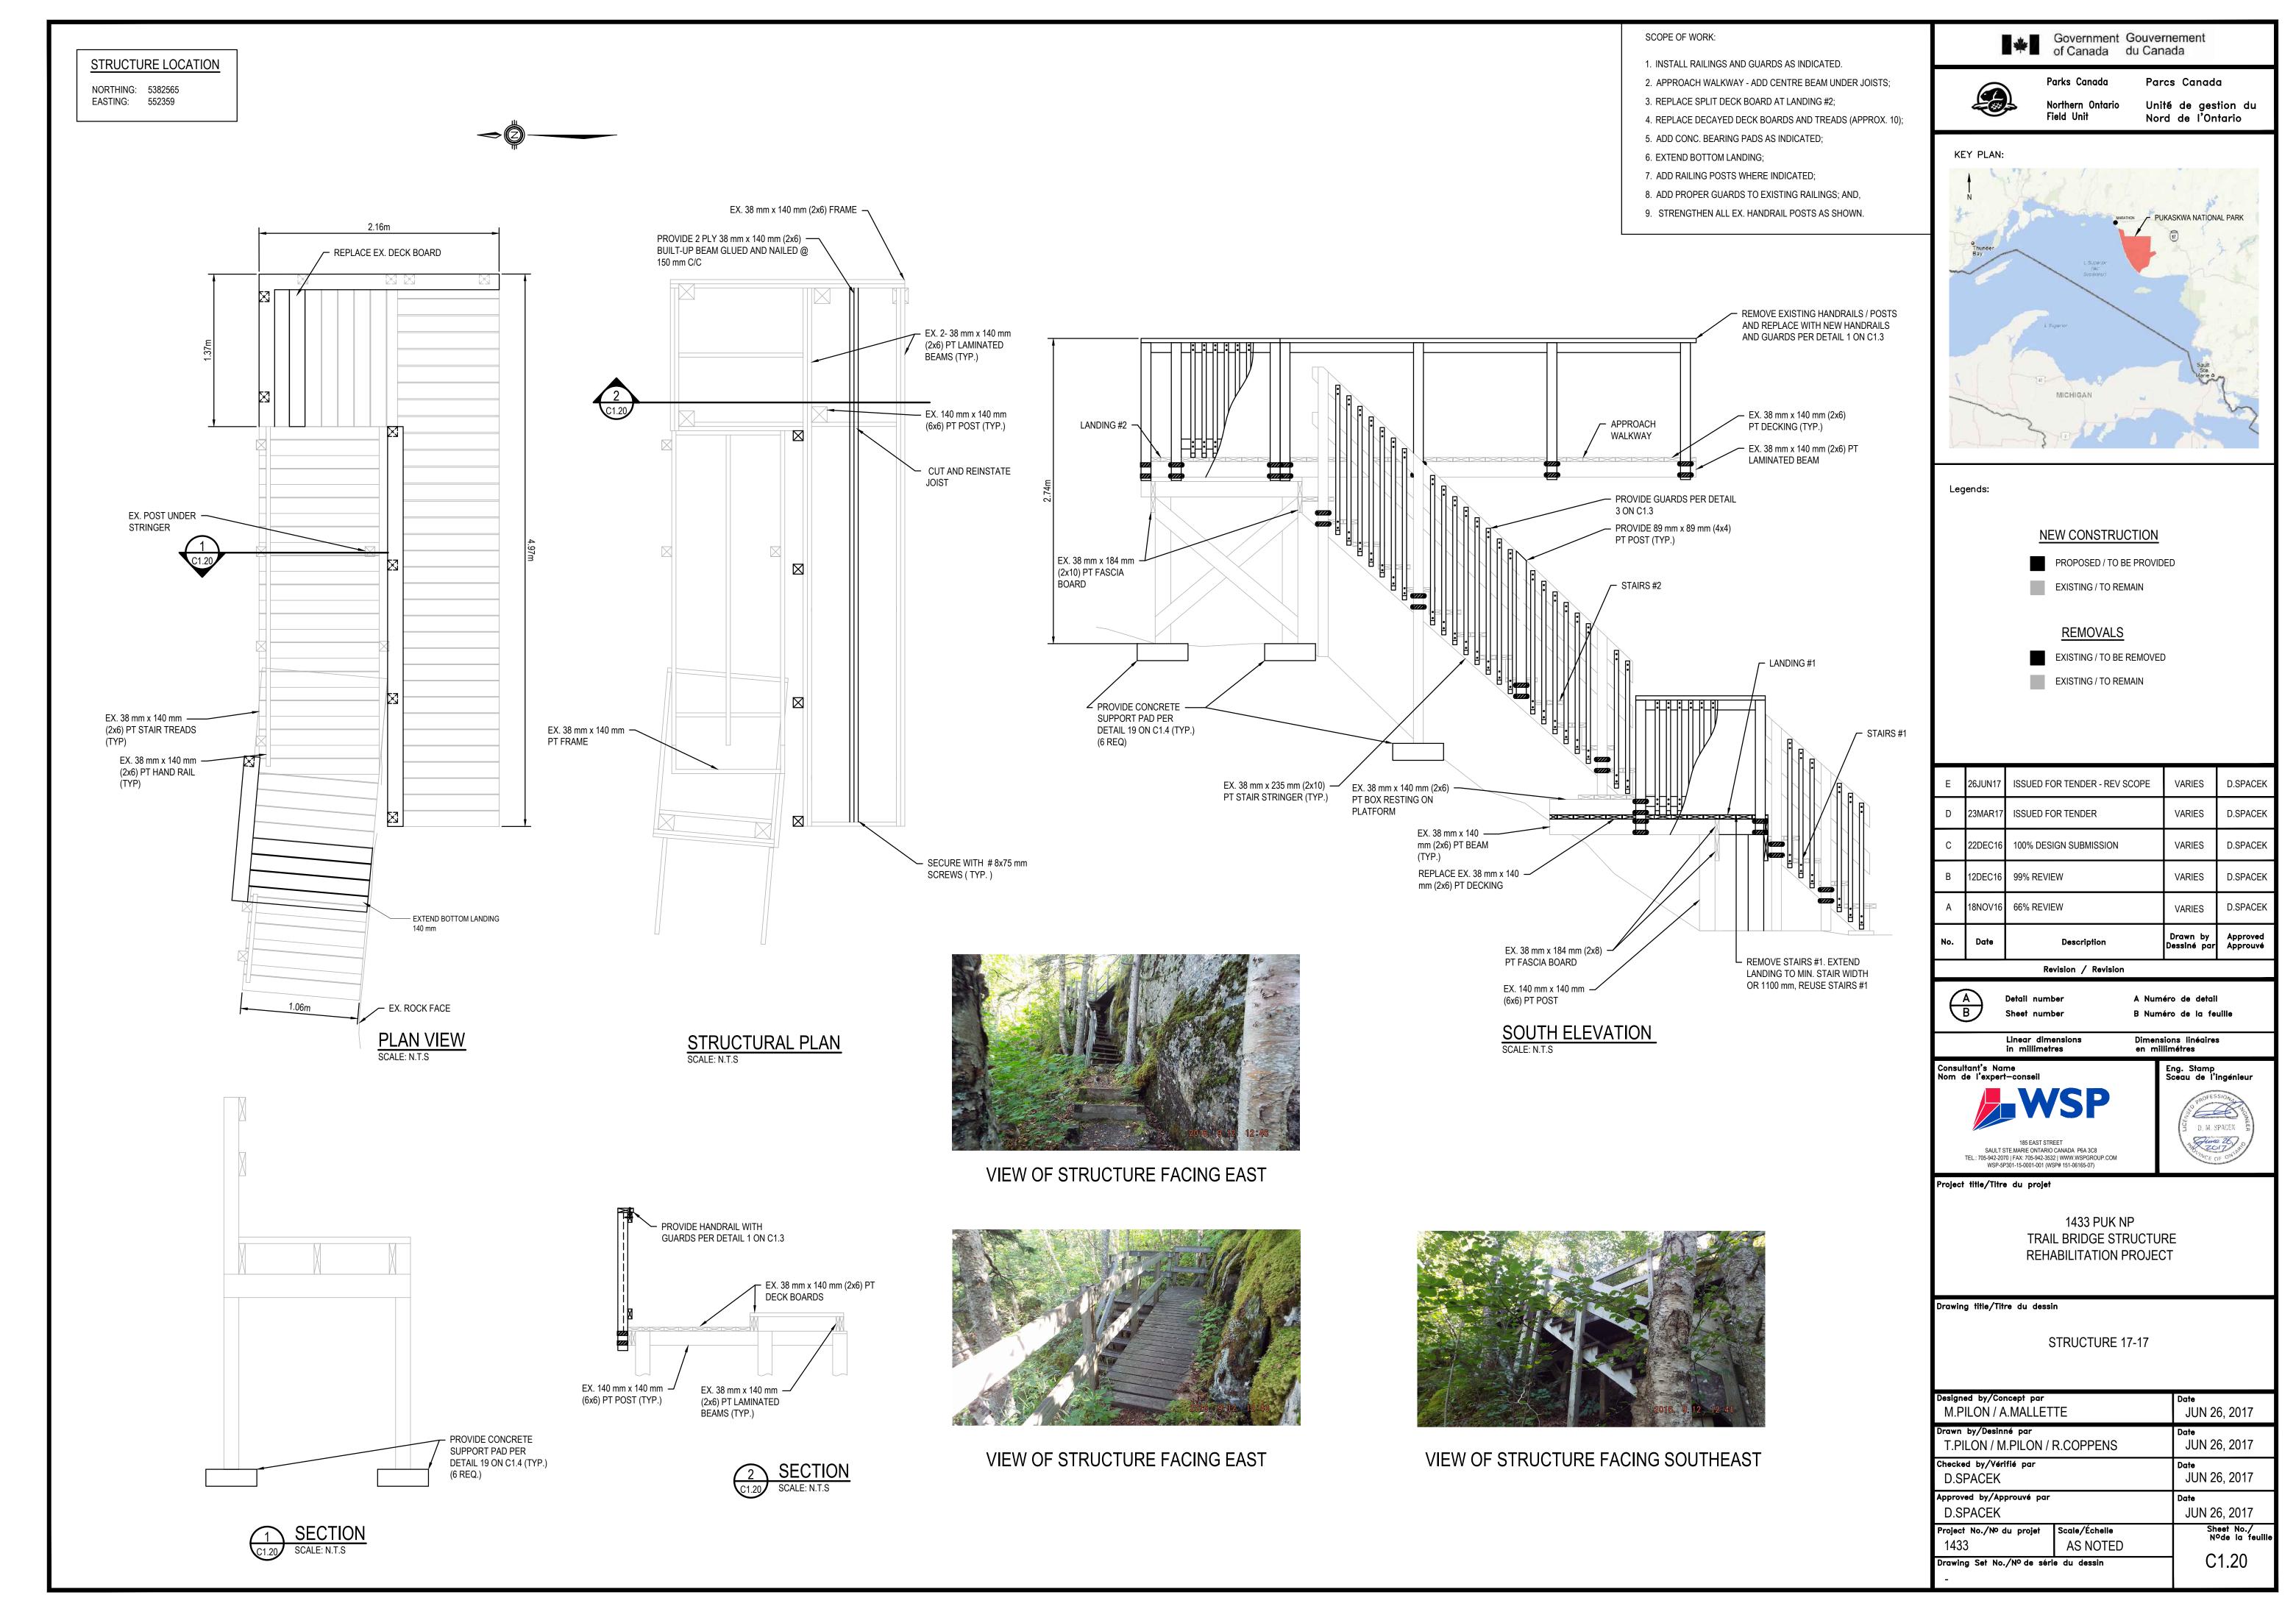

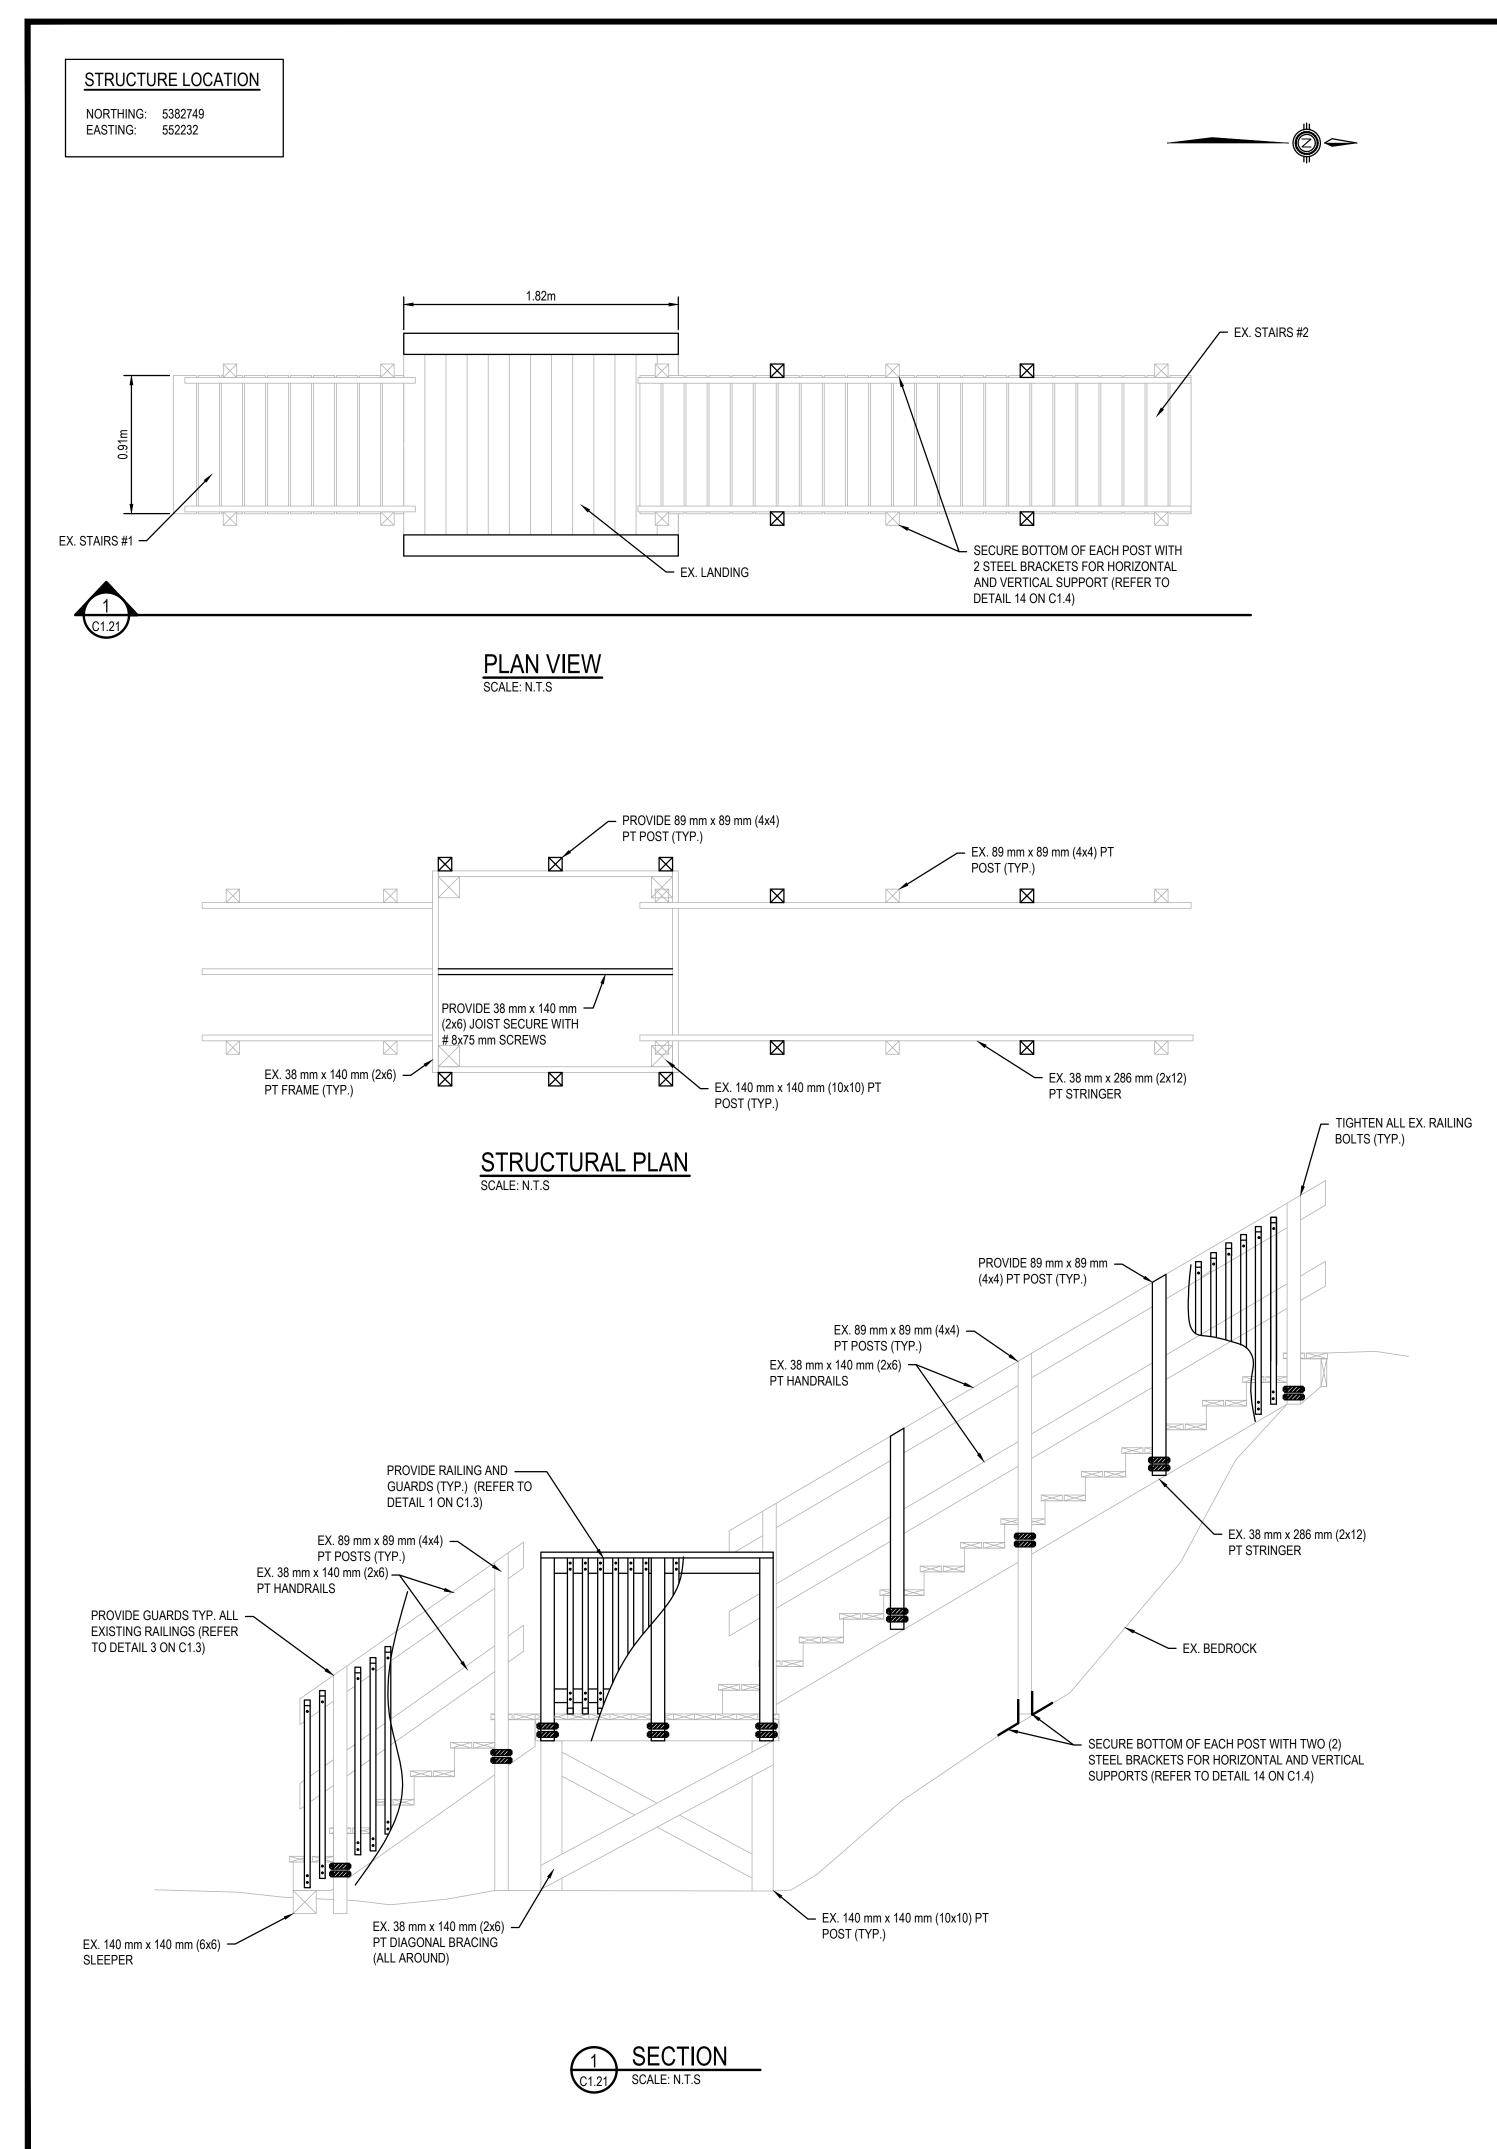VIEW OF STRUCTURE FACING NORTHEAST




VIEW OF STRUCTURE FACING EAST




VIEW OF STRUCTURE FACING NORTH

- 1. SECURE POSTS TO BEDROCK USING STEEL BRACKETS AS
- SHOWN; 2. SECURE DECK AND TREAD BOARDS WITH SCREWS WHERE NAILS
- ARE POPPING OUT; 3. LANDING - ADD CENTRE JOIST TO SUPPORT DECK BOARDS;
- 4. TIGHTEN ALL BOLTS TO RAILINGS;
- 5. ADD GUARDS TO EX. STAIR RAILINGS;
- 6. ADD ADDITIONAL HANDRAIL POSTS AS INDICATED;
- 7. ADD RAILINGS AND GUARDS TO MID-PLATFORM; AND,
- 8. STRENGTHEN EXISTING RAILINGS.



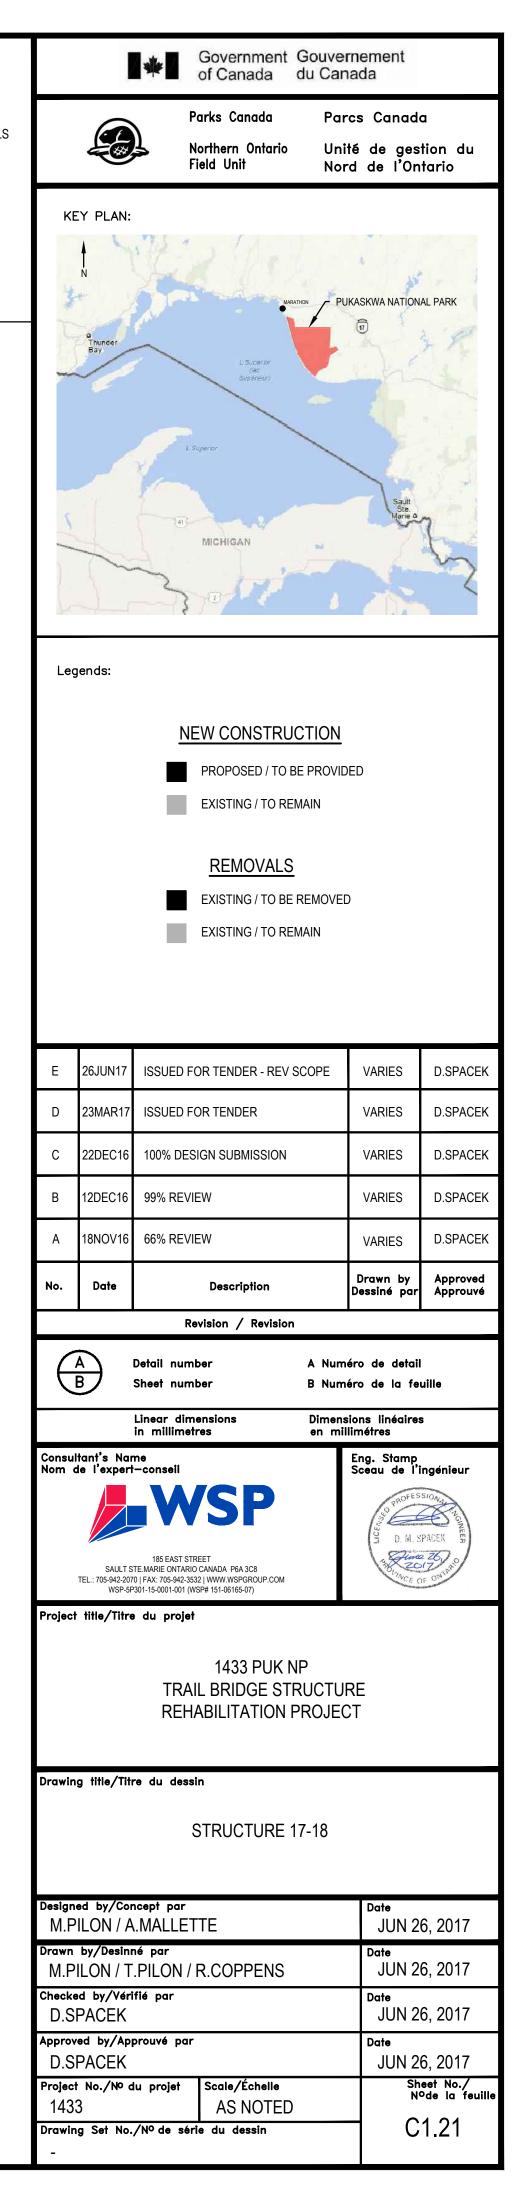

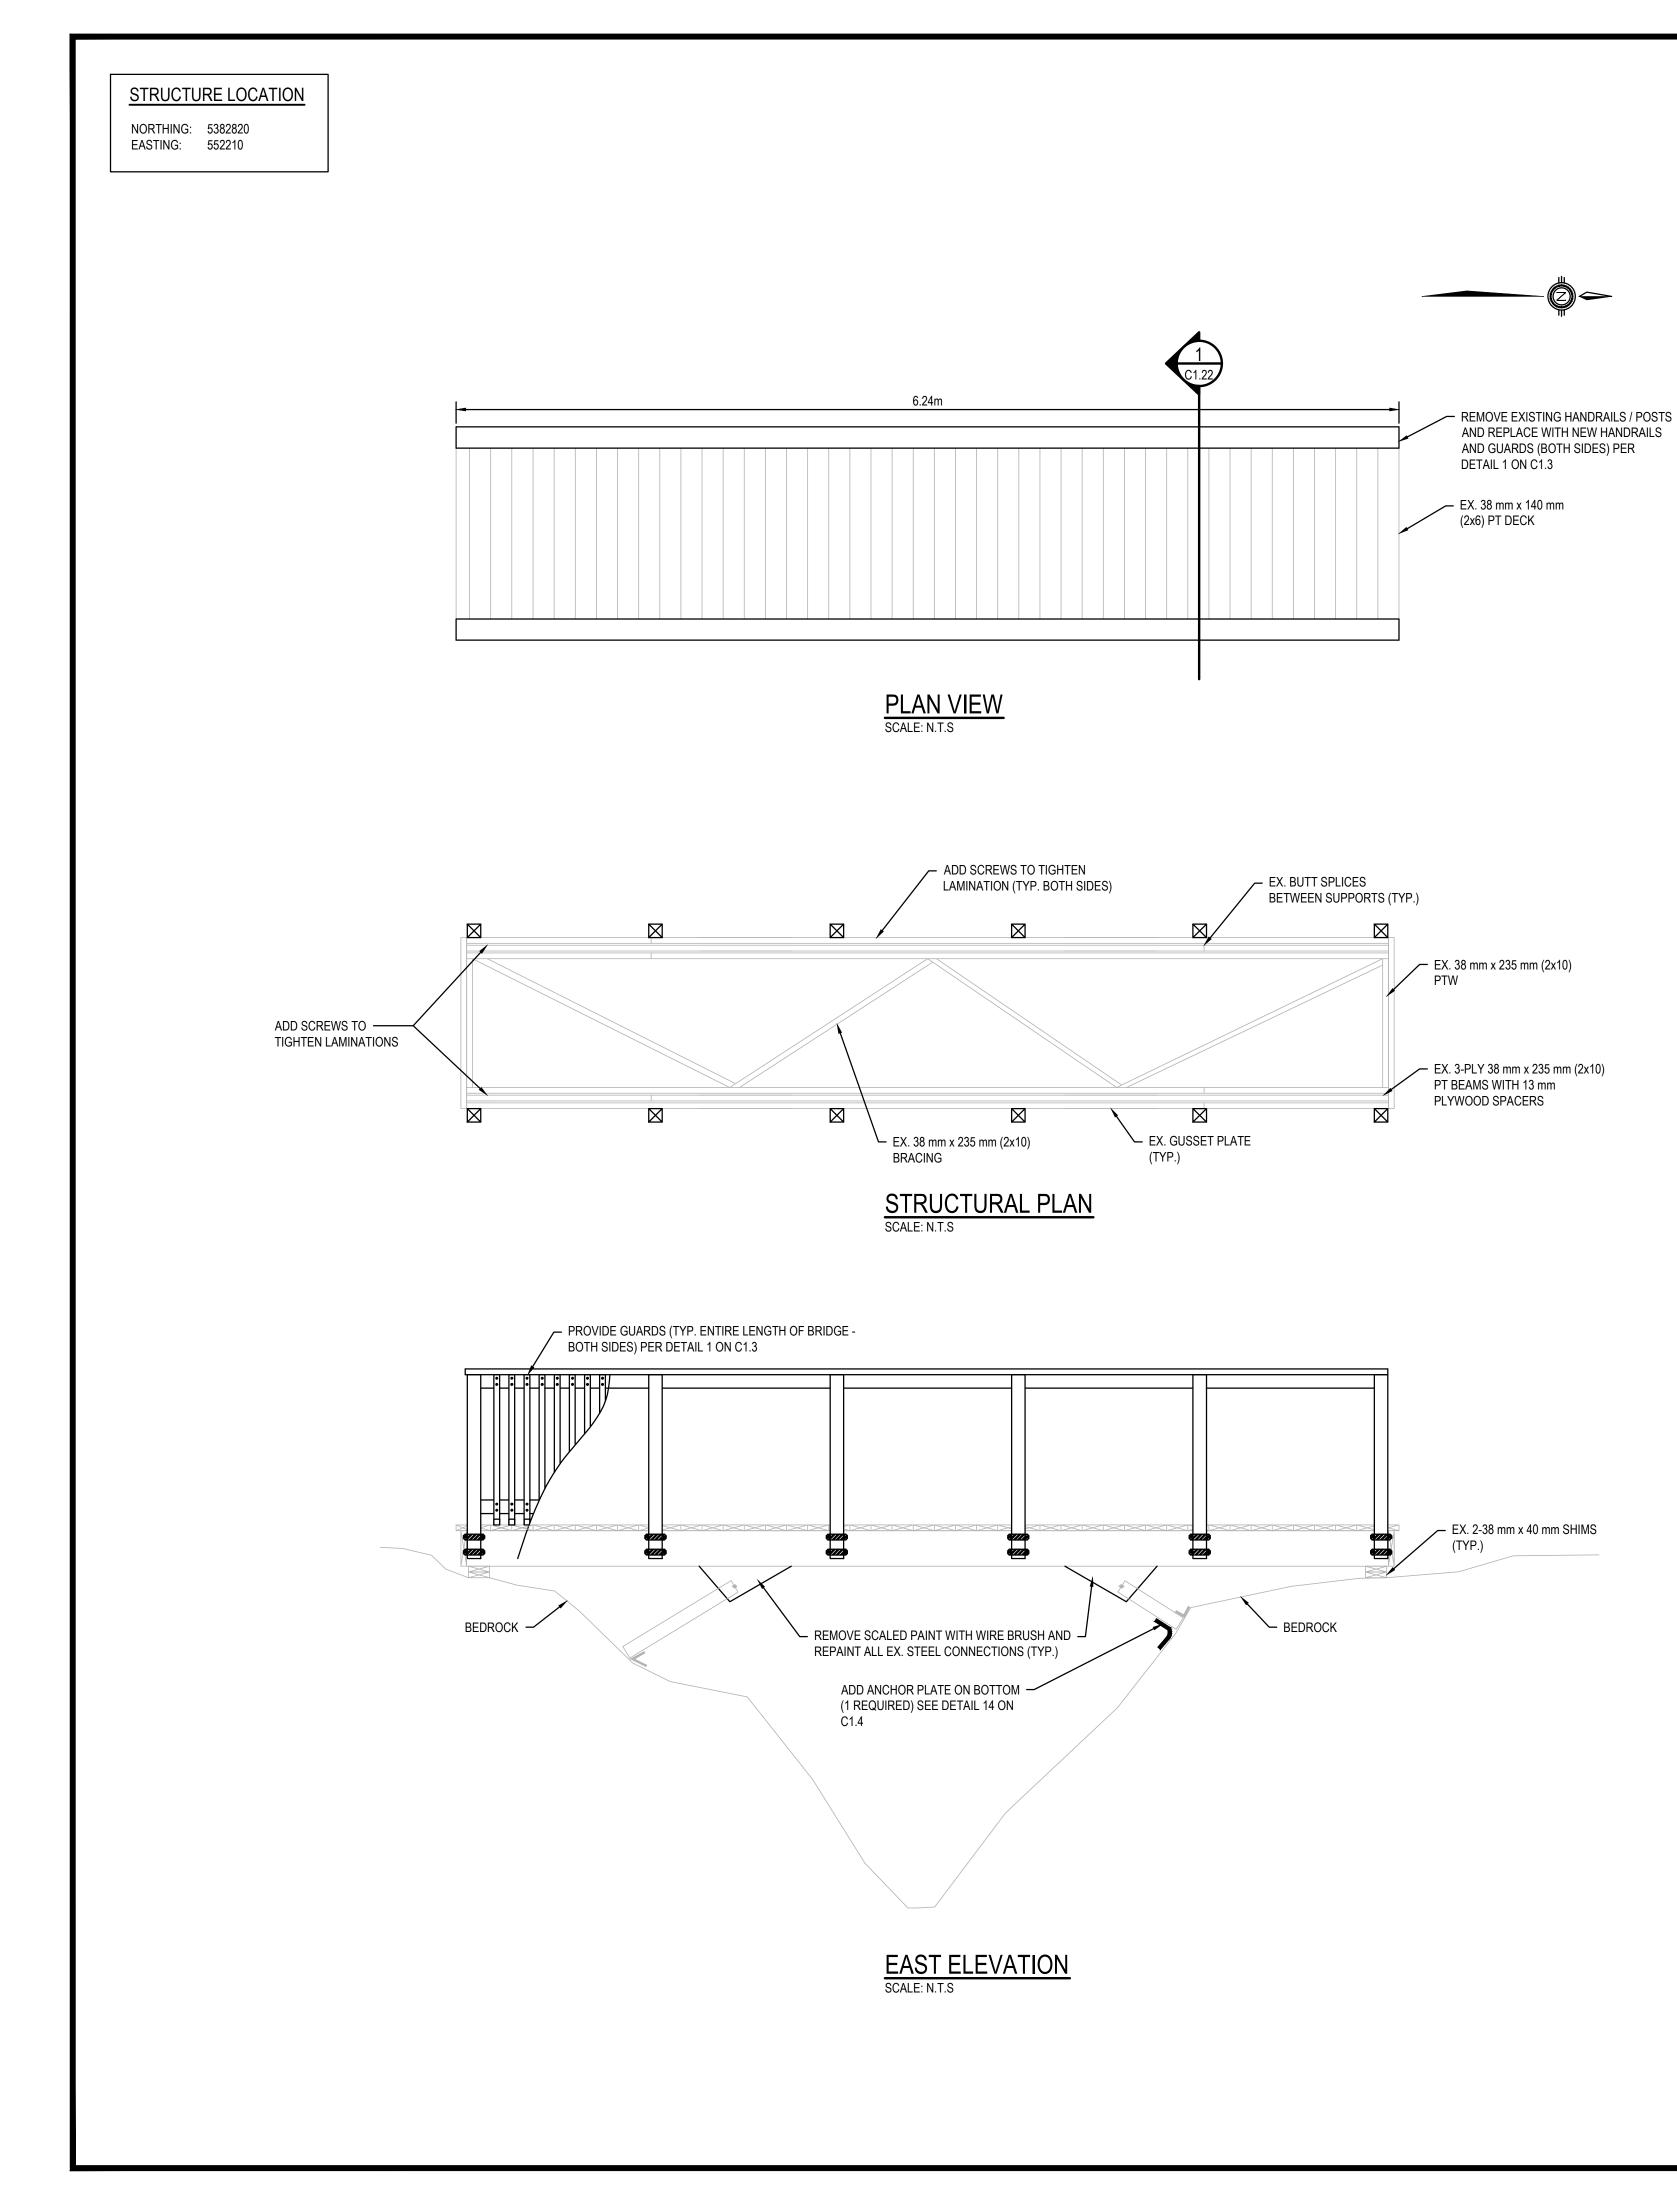

1.10m FIELD CUT OVERHANG AS \neg REQUIRED TO ACCEPT EX. 38 mm x 140 mm -GUARDS (2x6) PT DECK

EX. 3-PLY 38 mm x 235 mm (2x10) PTW BEAMS WITH 13 mm PLYWOOD SPACERS





VIEW OF STRUCTURE FACING NORTHEAST



VIEW OF STRUCTURE FACING SOUTH




VIEW OF STRUCTURAL KNEE BRACING


SCOPE OF WORK:

- PROVIDE HANDRAIL WITH GUARDS (PER DETAIL 1 ON

C1.3)

- 1. ADD ADDITIONAL ANCHOR PLATES ON OPPOSITE FACES OF KNEE BRACES INTO BEDROCK;
- 2. BEAM ADD SCREWS TO TIGHTEN THE GAPS BETWEEN LAMINATIONS PER DETAIL 17;
- 3. REPLACE HANDRAILS WITH NEW HANDRAILS, POSTS AND GUARDS.

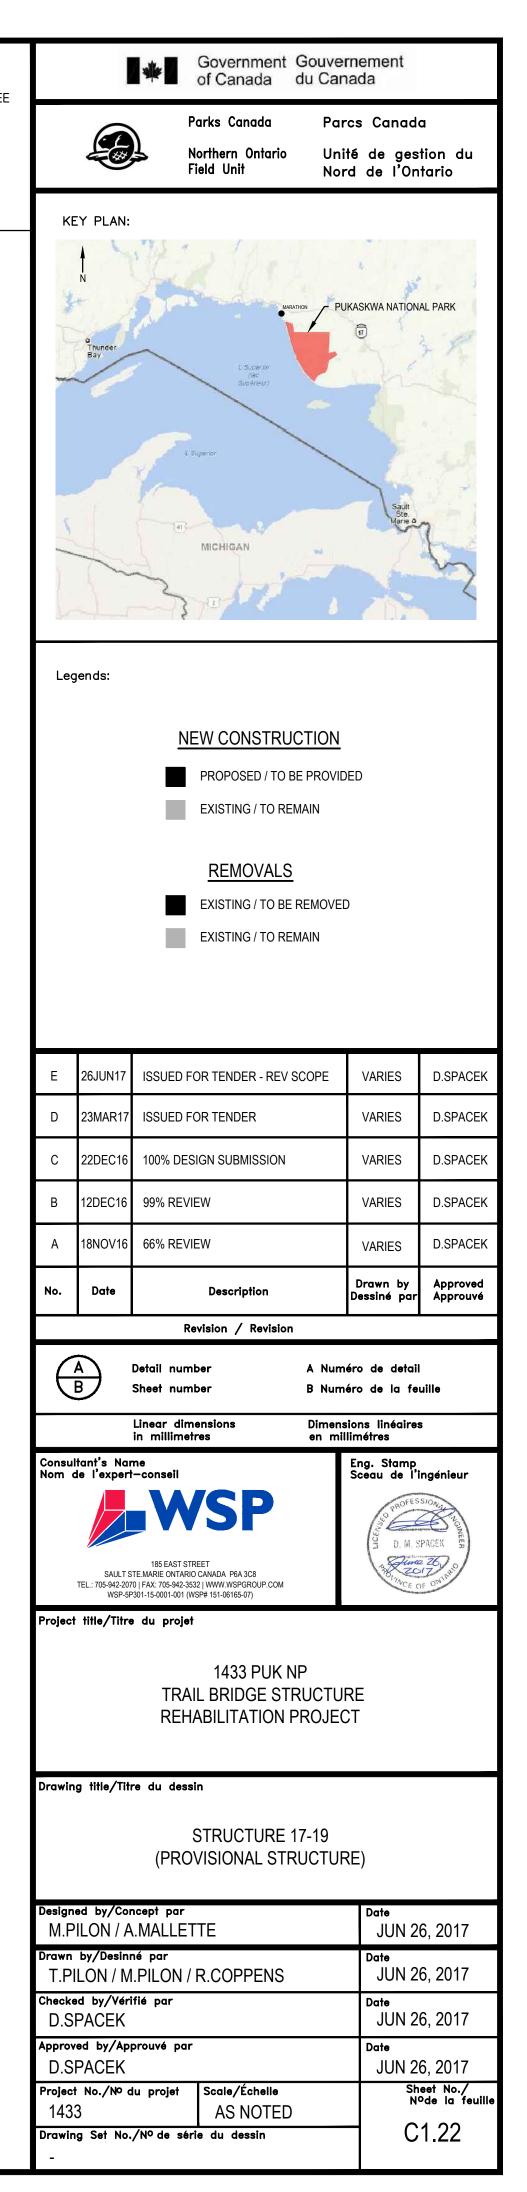

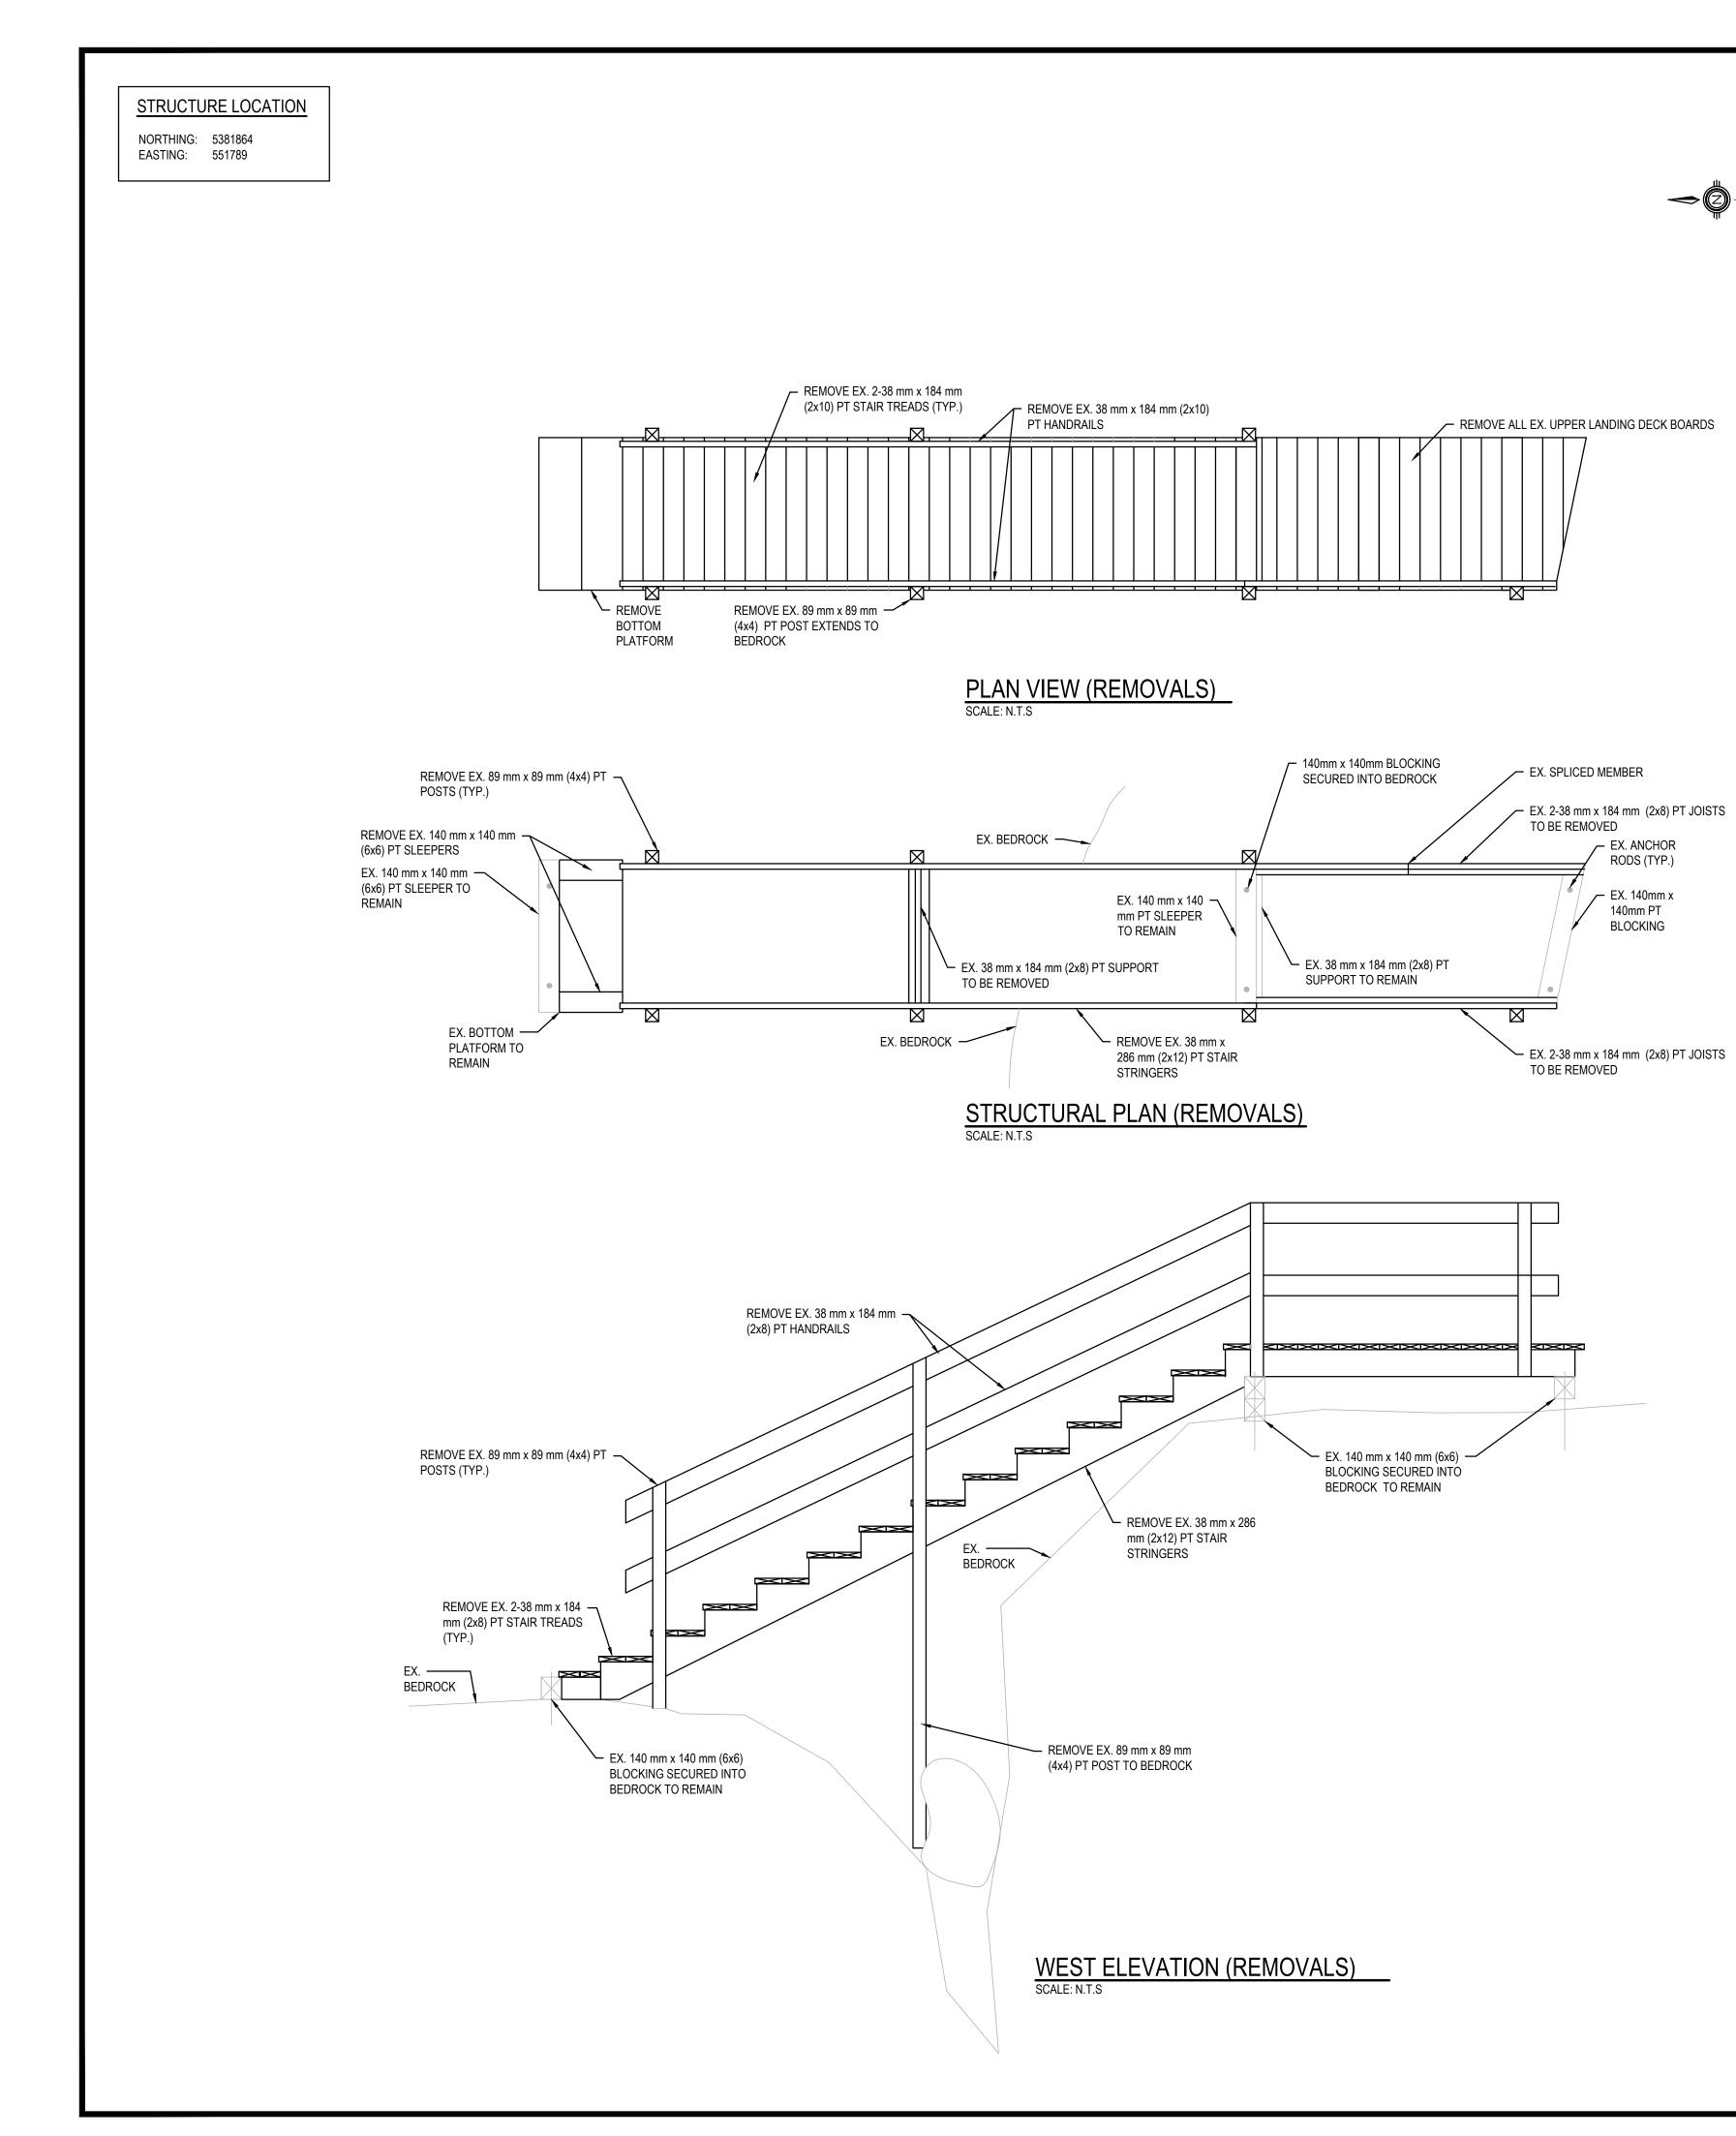






VIEW OF STRUCTURE FACING NORTHEAST



VIEW OF STRUCTURE FACING SOUTHEAST

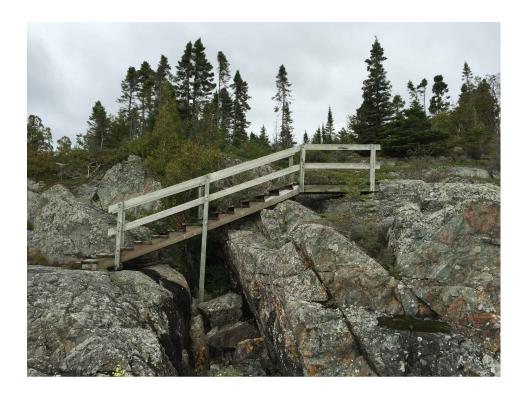



VIEW OF STRUCTURE FACING EAST


SCOPE OF WORK:


1. CONDUCT REMOVALS AS INDICATED

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		Northern Ontari Field Unit		i de ges de l'On	tion du tario
	Thunder Bay	L Superior de Buperior	NARATHON	ASKWA NATION	AL PARK
Leg	jends:				
		NEW CONSTR	D BE PROVIDE REMAIN <u>-S</u> BE REMOVED	D	
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D	23MAR17	ISSUED FOR TENDER		VARIES	D.SPACEK
С	22DEC16	100% DESIGN SUBMISSIO	N	VARIES	D.SPACEK
В	12DEC16	99% REVIEW		VARIES	D.SPACEK
A	18NOV16	66% REVIEW		VARIES	D.SPACEK
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STRUCTURE 17-20 SHEET 1 OF 2 (REMOVALS)					
Designed by/Concept par M.PILON / A.MALLETTE JUN 26, 2017					6, 2017
Drawn by/Desinné par M.PILON / T.PILON / R.COPPENS JUN 26, 2017				6, 2017	
Checked by/Vérifié parDateD.SPACEKJUN 26, 2017				6, 2017	
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CHISEL EX. ROCK TO ALLOW FOR WATER DRAINAGE (EX. LOW SPOT)

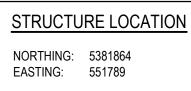BOTH ENDS

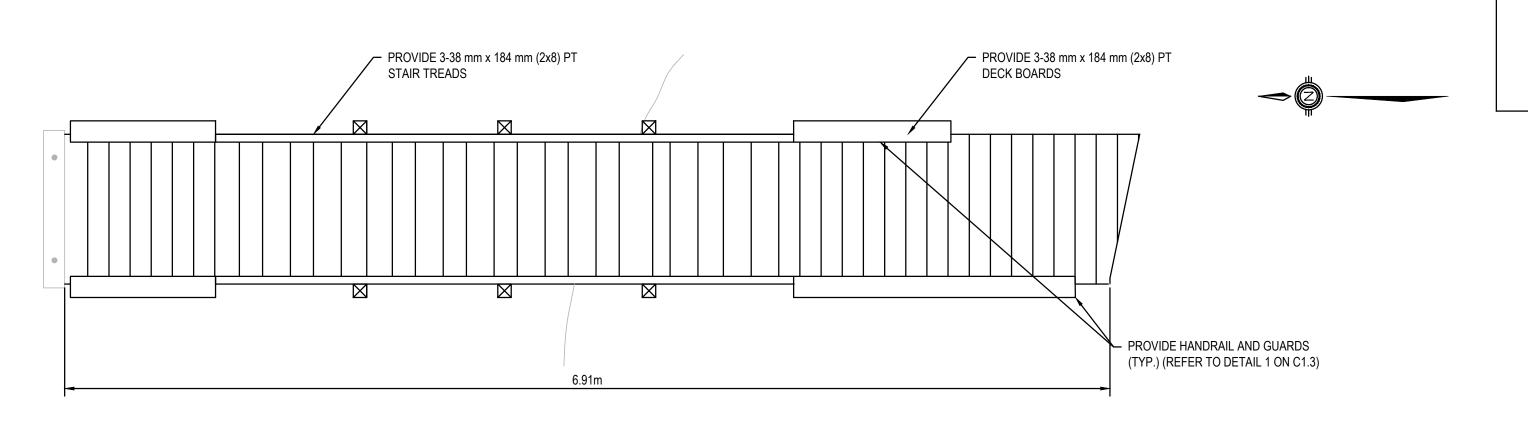PLAN VIEW (NEW CONSTRUCTION)

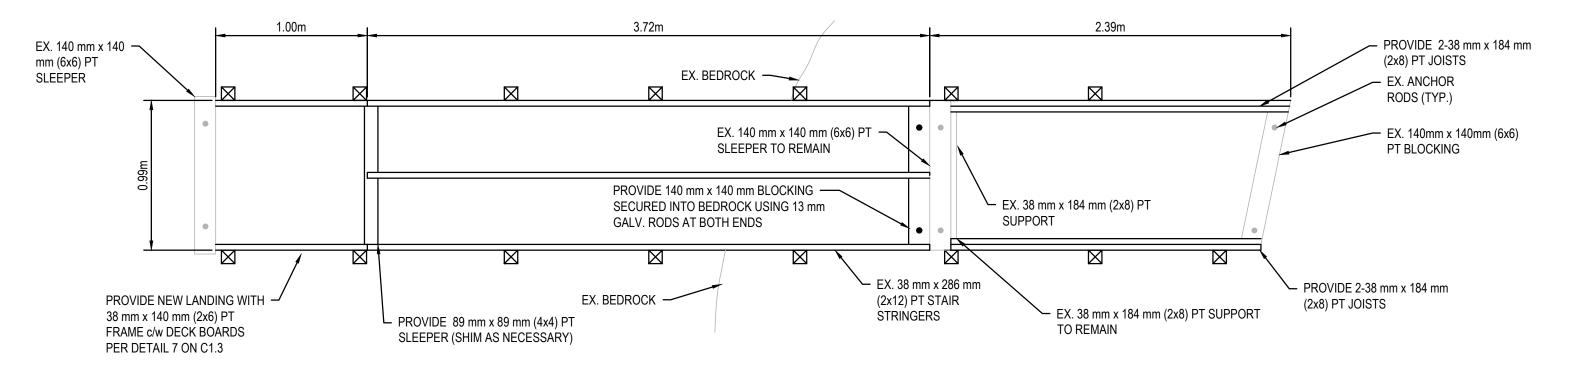


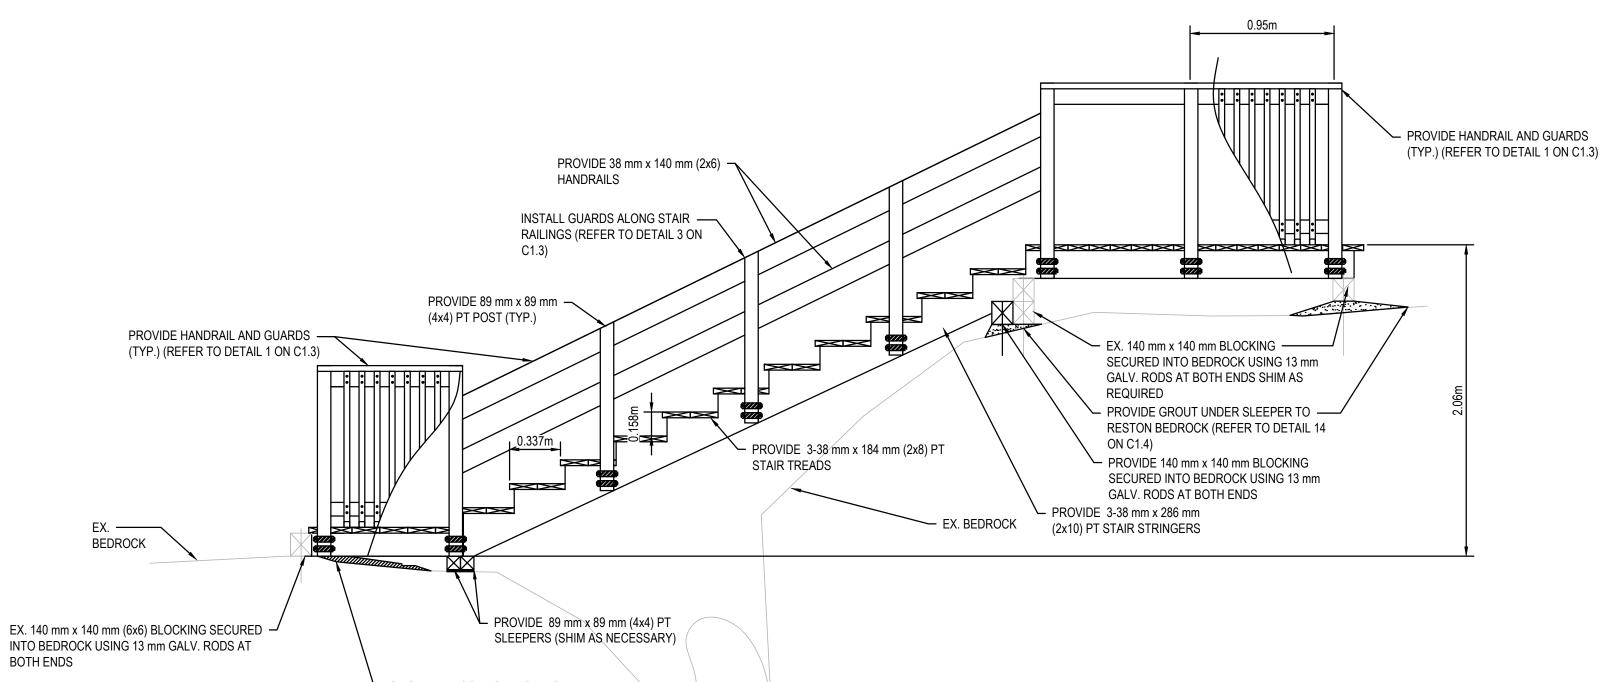
STRUCTURAL PLAN (NEW CONSTRUCTION) SCALE: N.T.S

WEST ELEVATION (NEW CONSTRUCTION) SCALE: N.T.S

SCOPE OF WORK:


- 1. CHISEL ROCK SUCH THAT WATER DRAINS SOUTH;
- 2. GROUT DOWELED BEARING SUPPORTS (TYP);
- 3. RECONSTRUCT STRUCTURE AS INDICATED

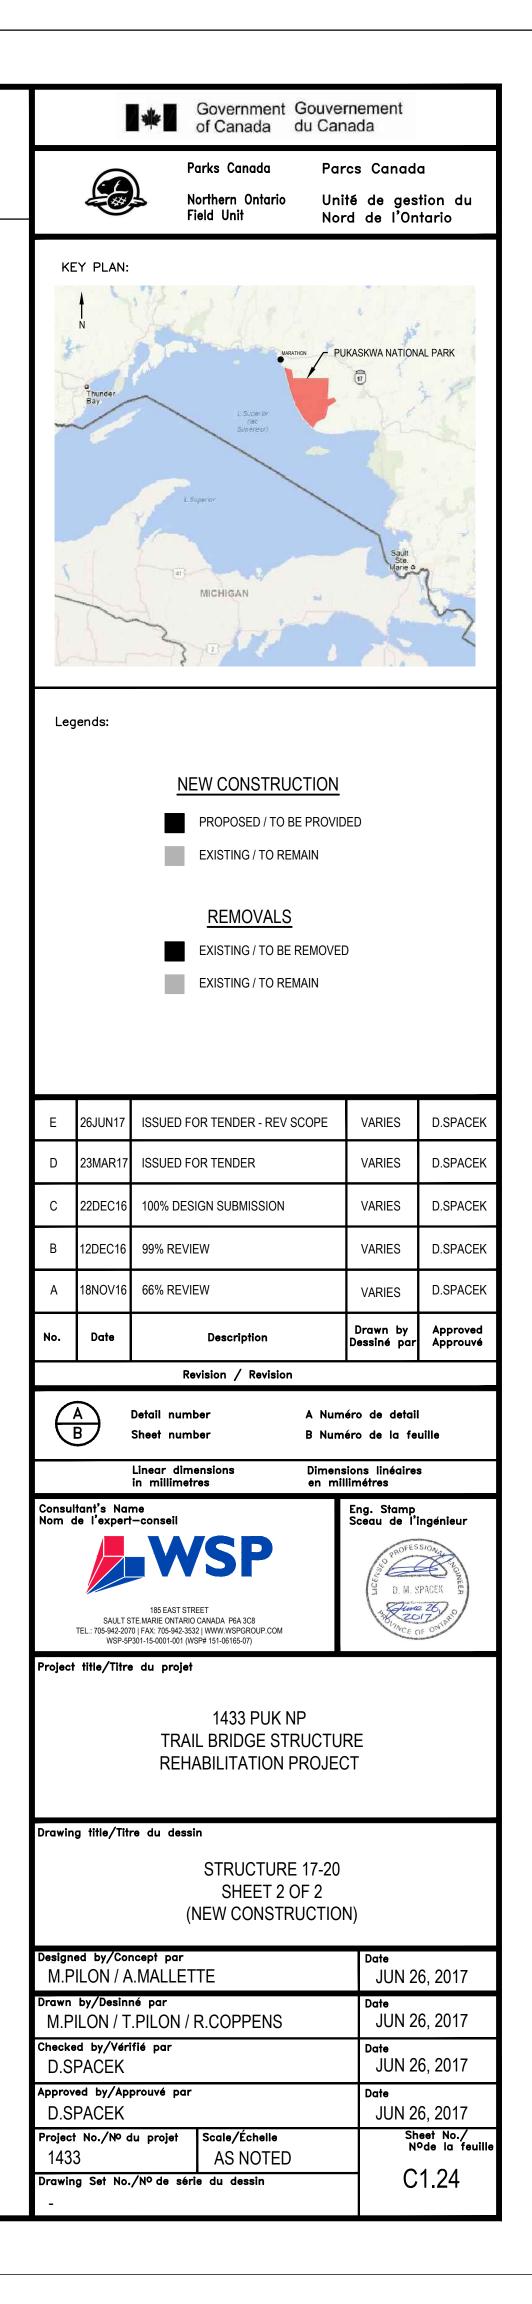


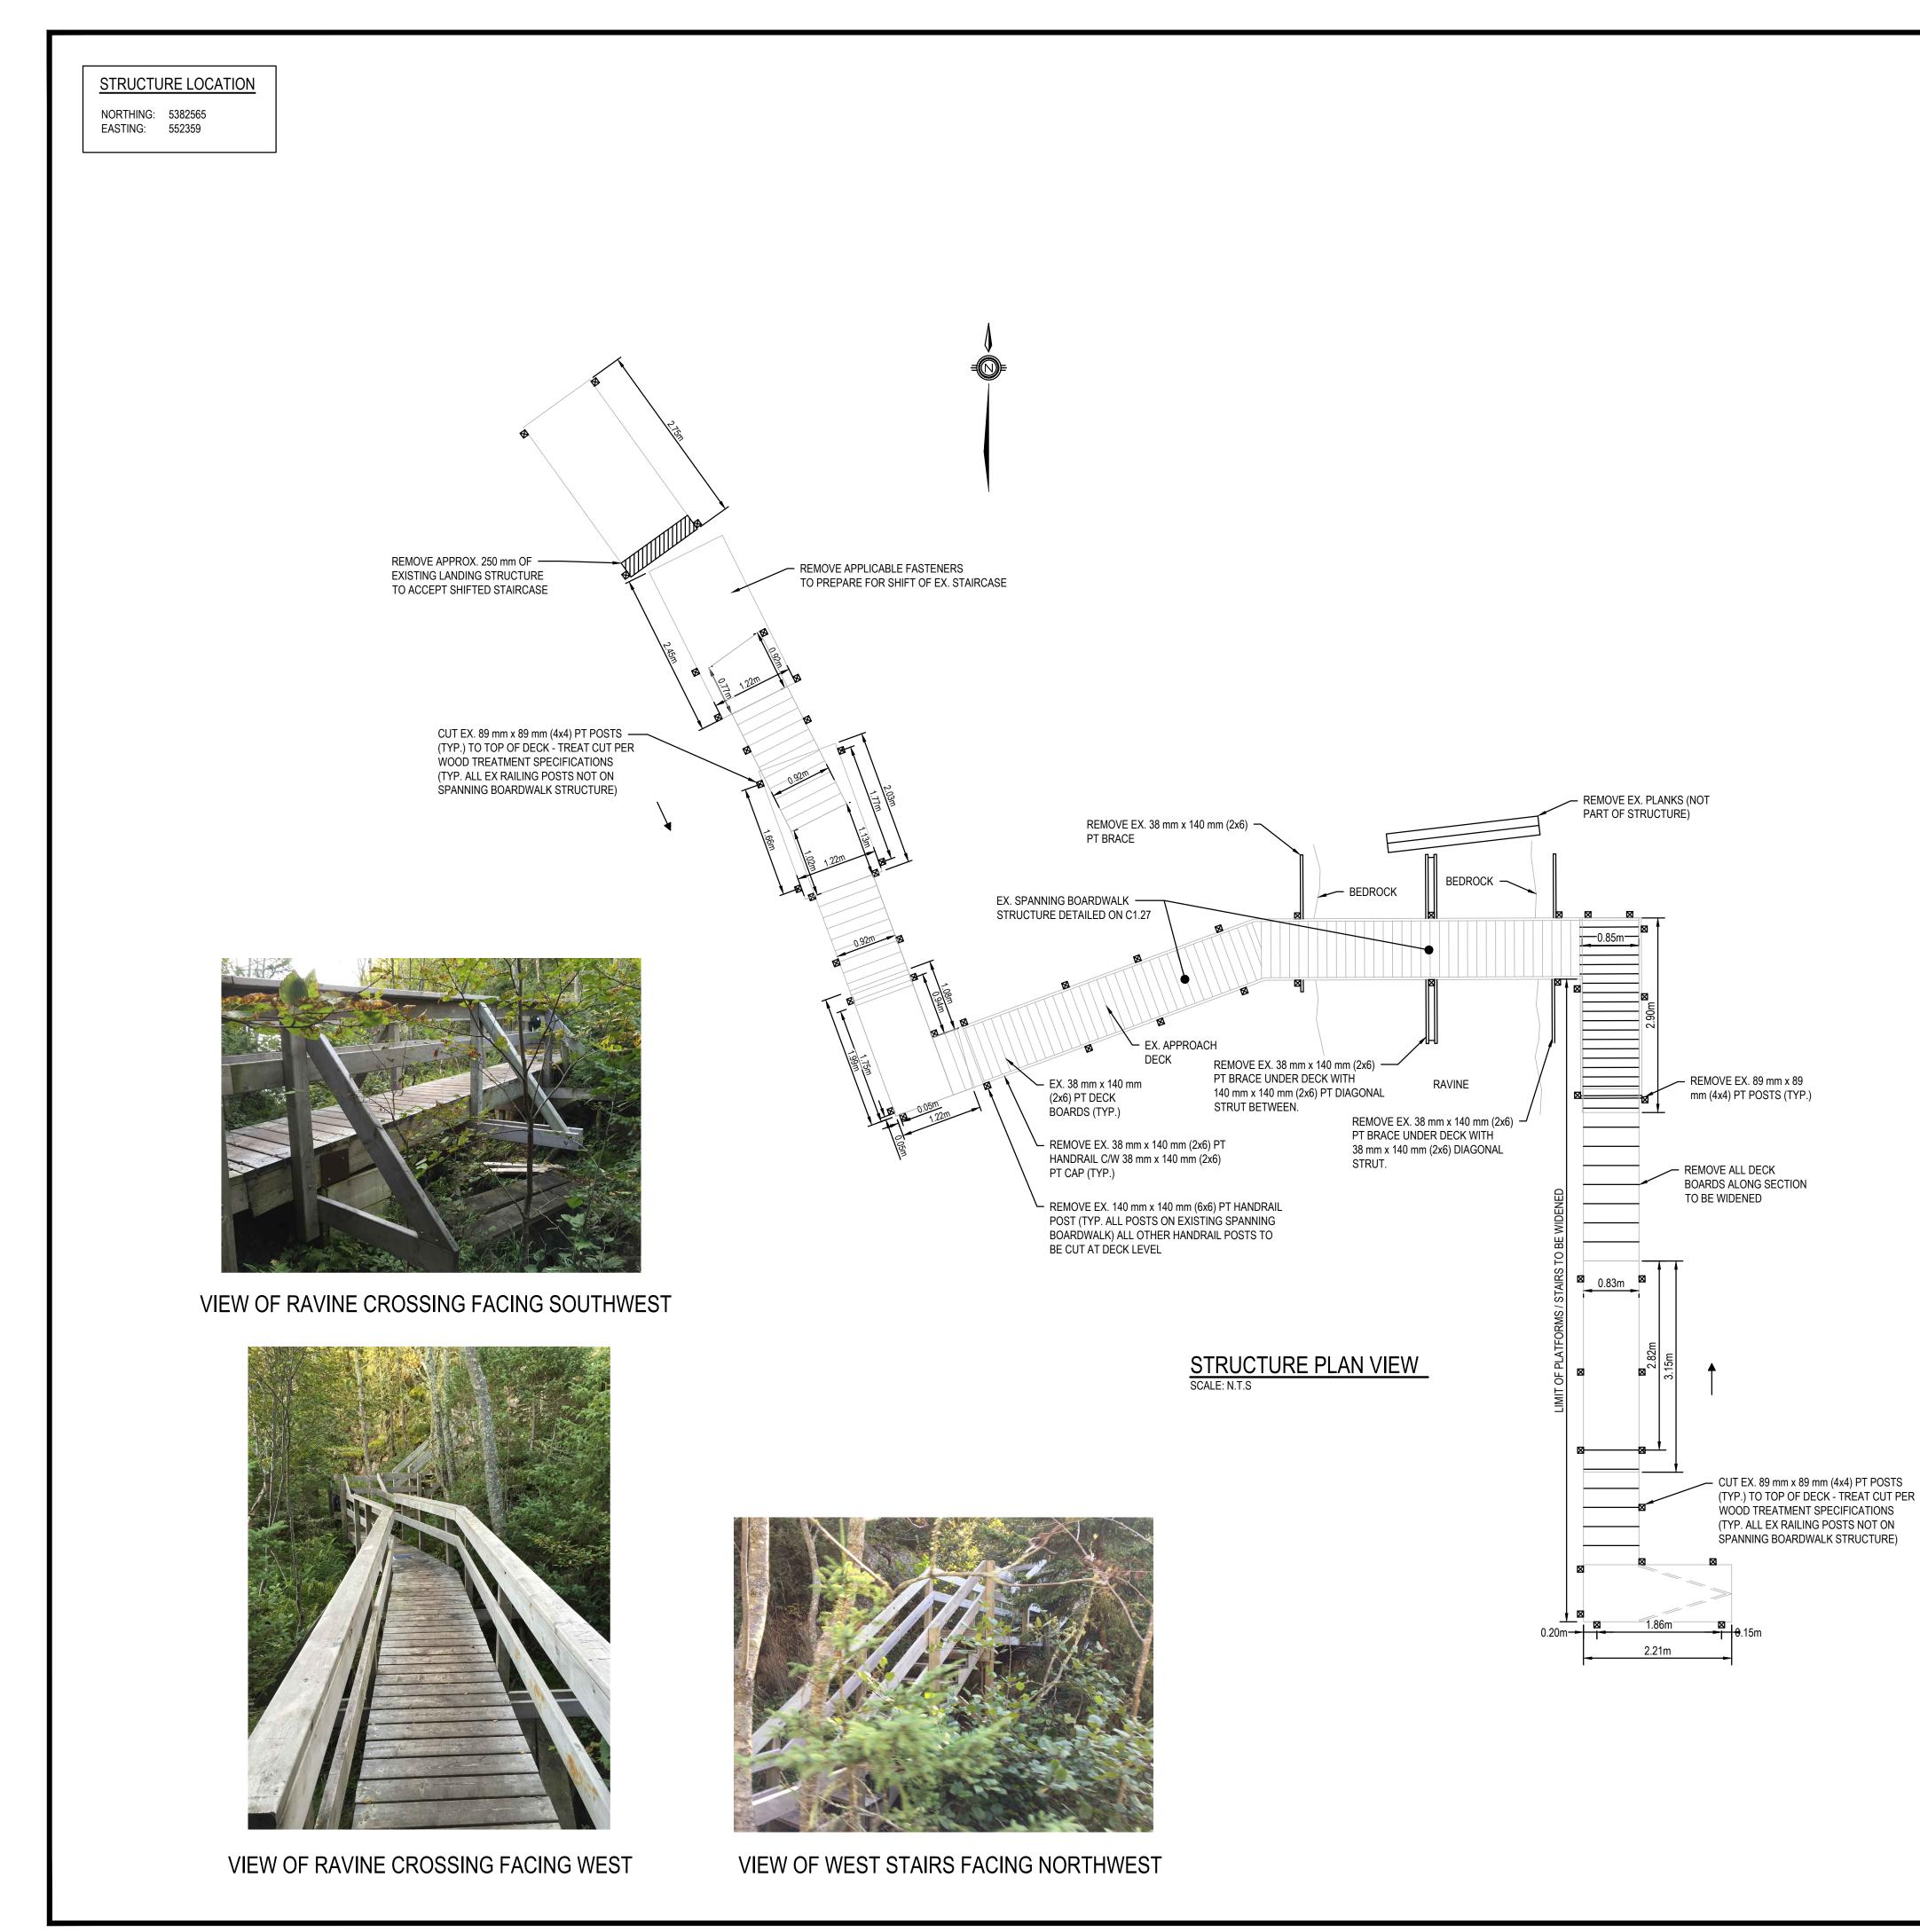



1. CONDUCT REMOVALS AS INDICATED

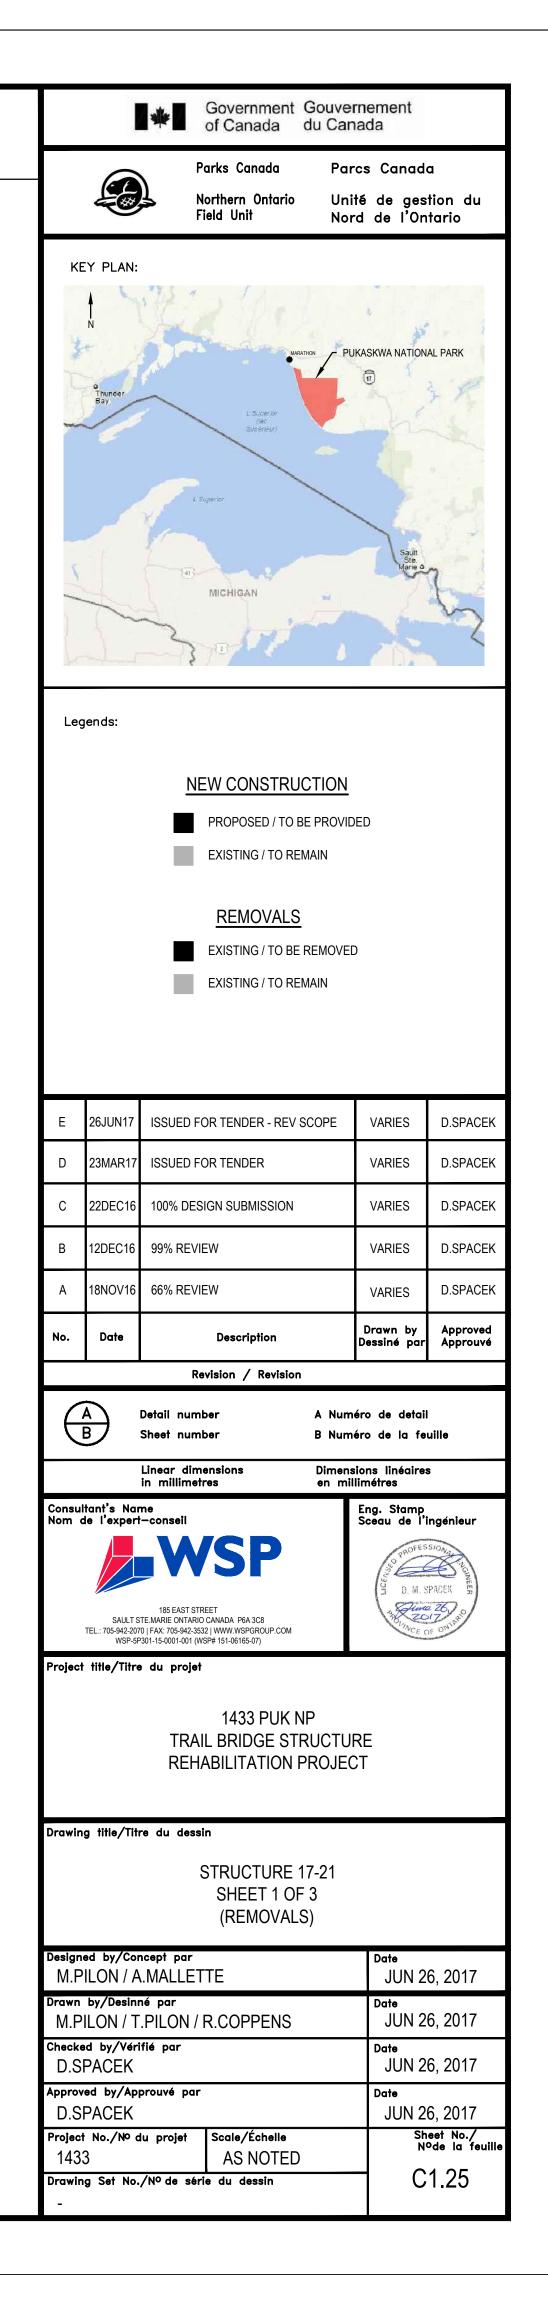

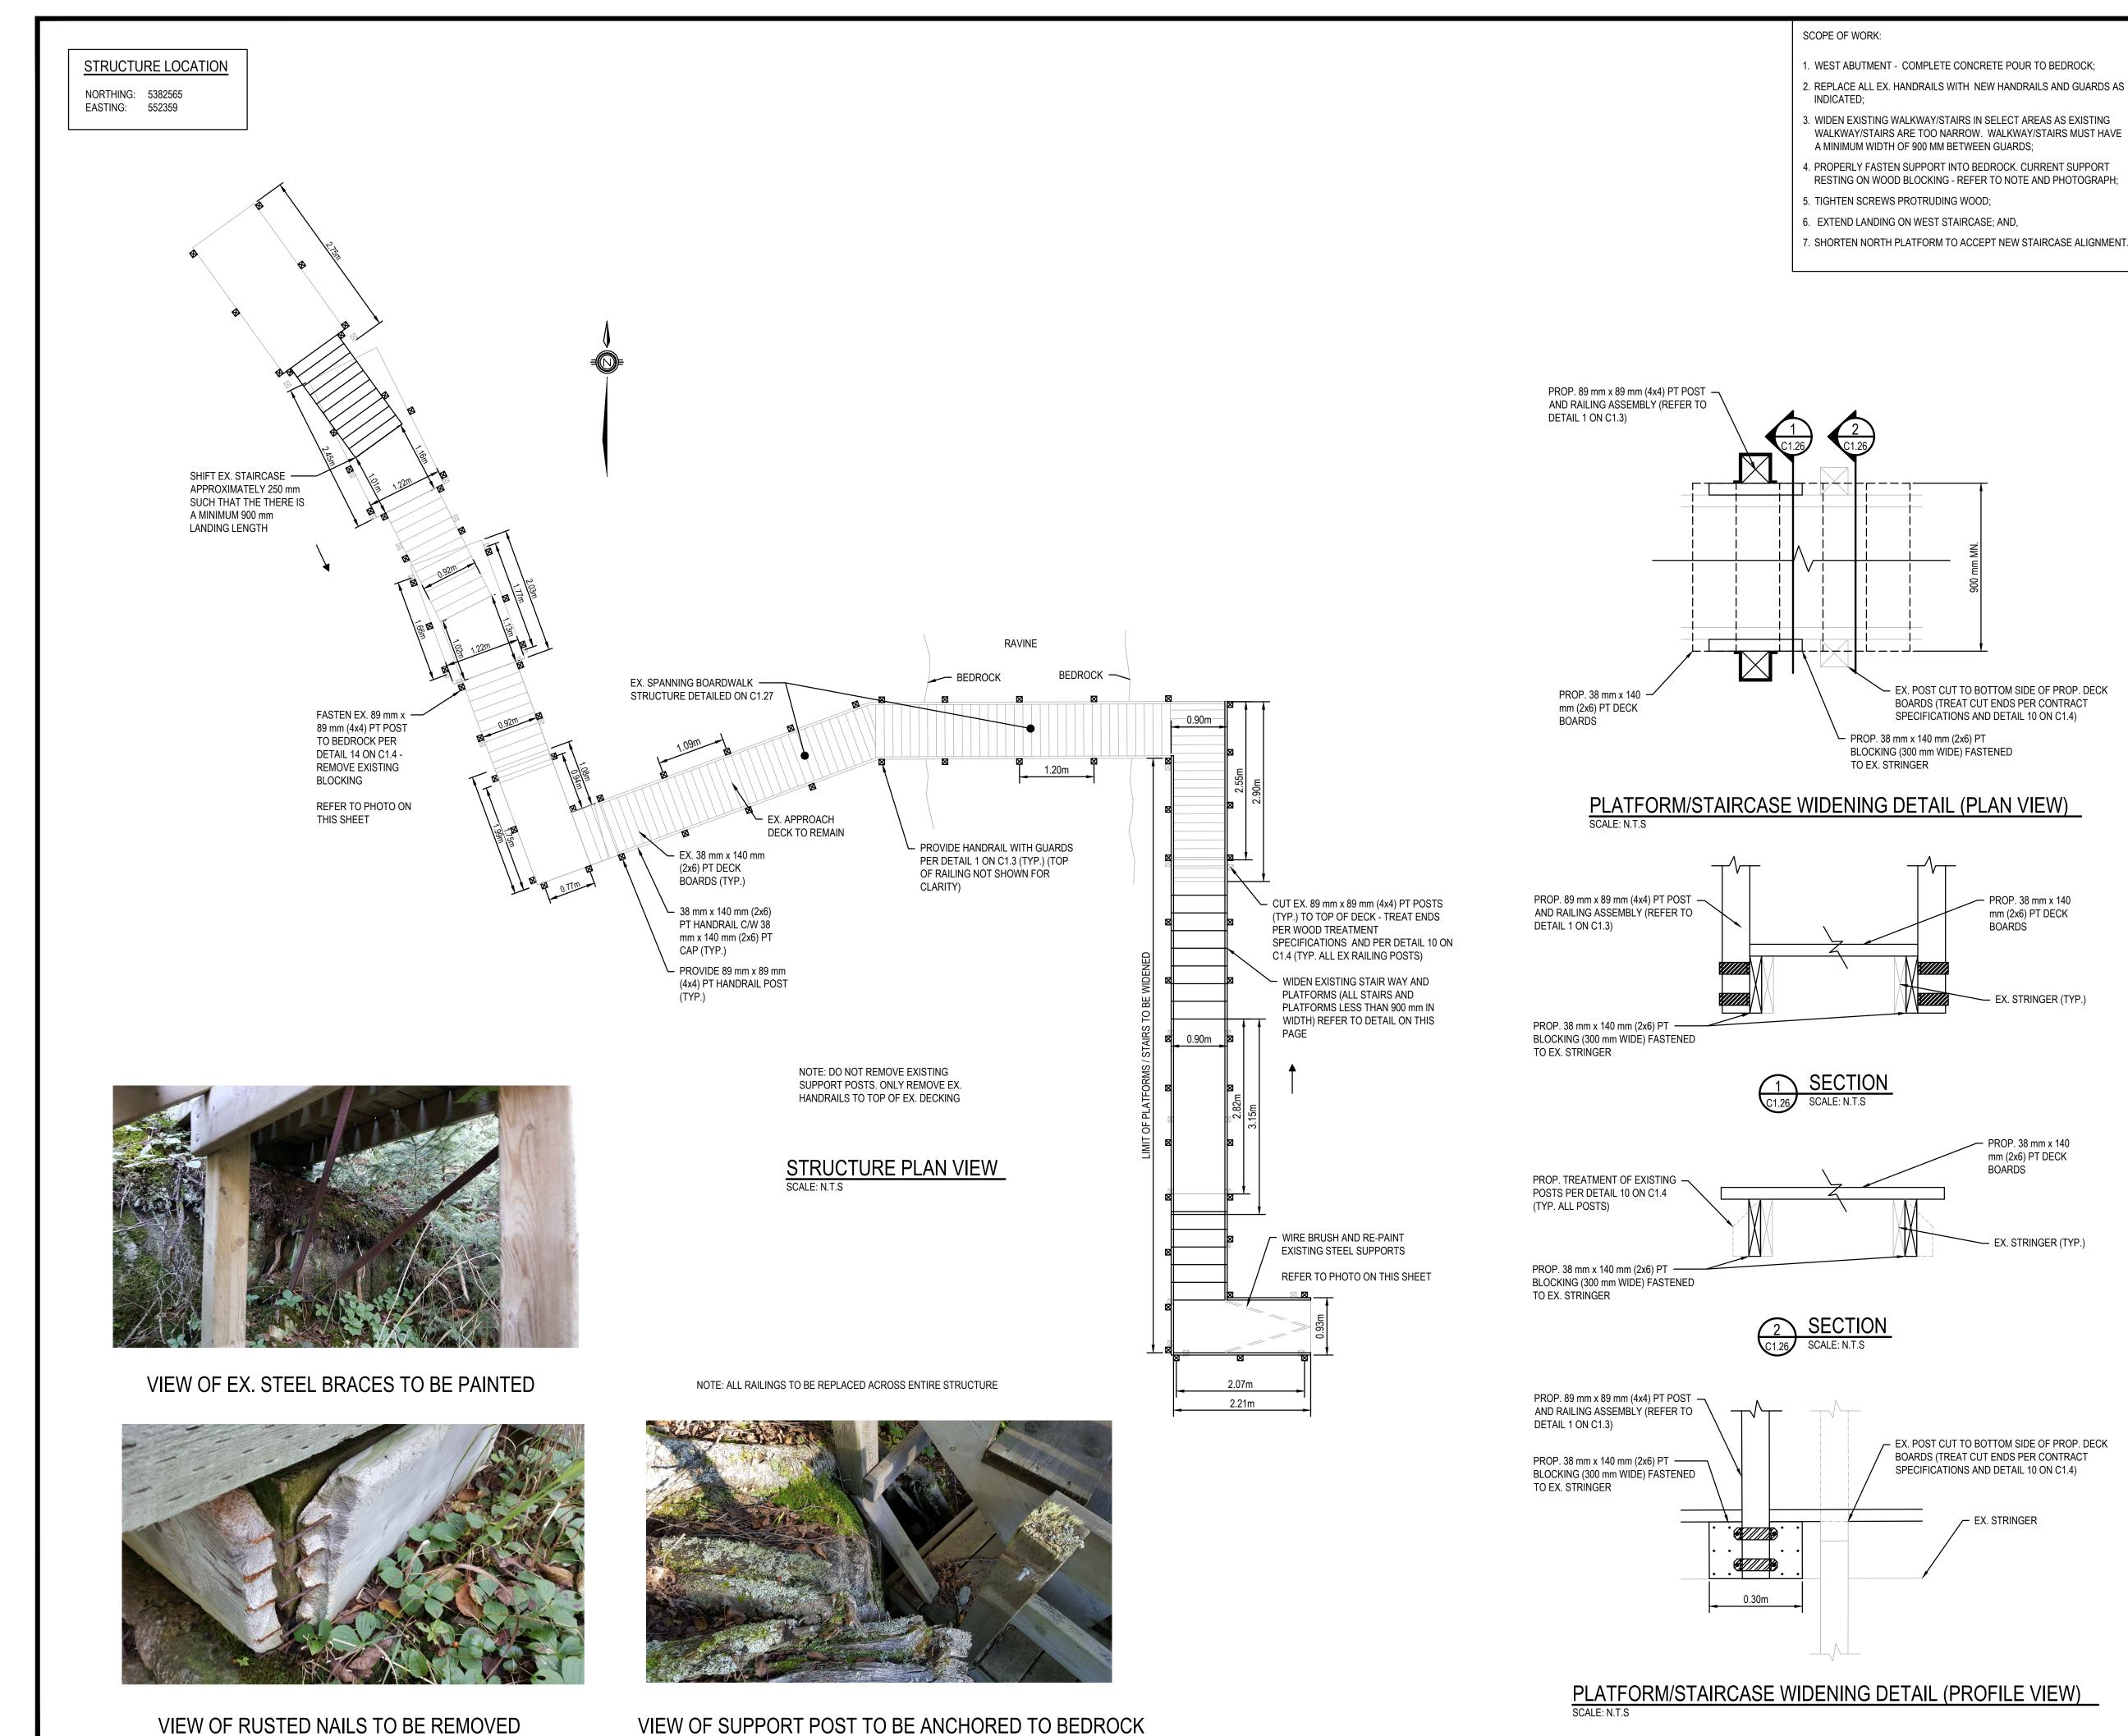

VIEW OF SUPPORT POST TO BE ANCHORED TO BEDROCK

