






NOTE:
1. COORDINATE TYPES, QUANTITIES, SIZES, AND LOCATIONS OF MECHANICAL AND ELECTRICAL ITEMS ON ELEVATIONS. MAINTAIN INTEGRITY OF AIR AND VAPOUR BARRIER AROUND OPENINGS AND MAKE PENETRATIONS WEATHER-TIGHT.

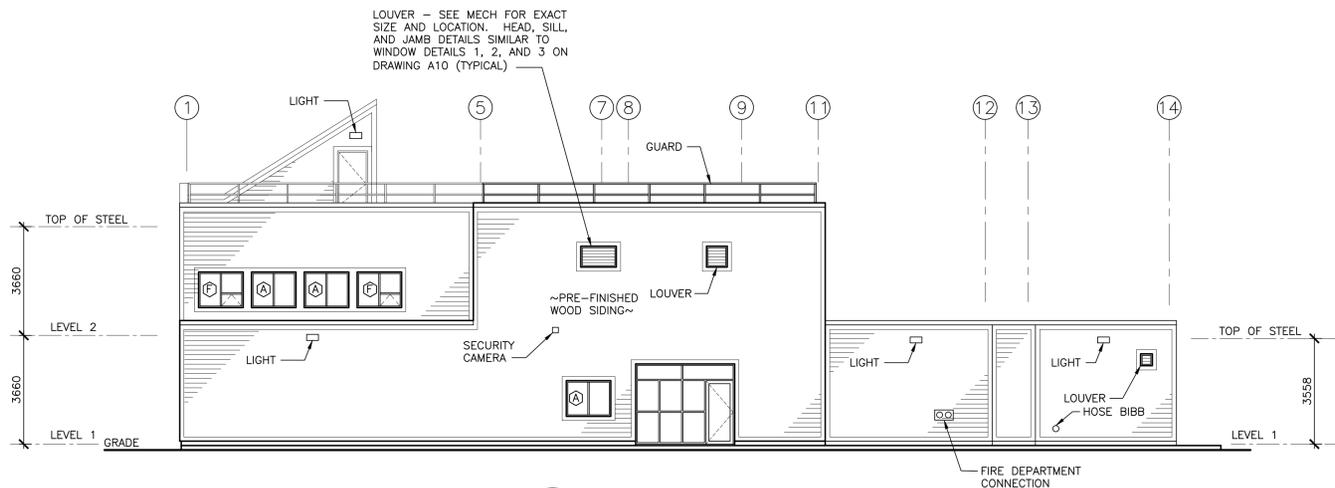


SOUTH ELEVATION
SCALE : 1:100
1 A2

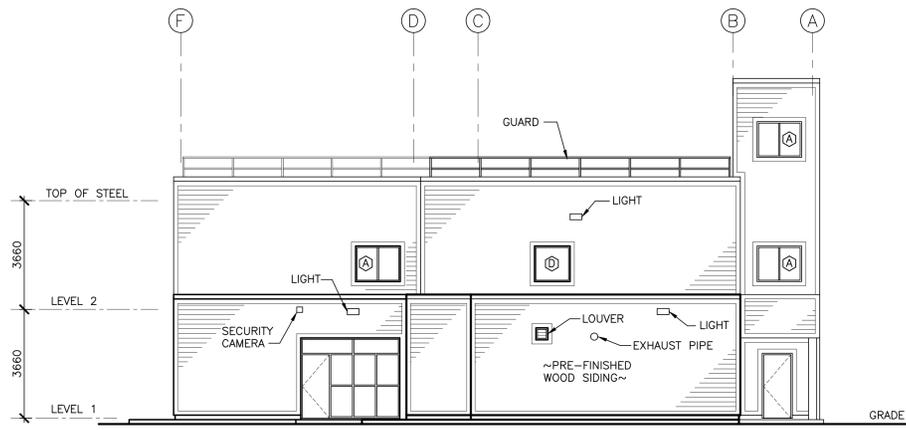


EAST ELEVATION
SCALE : 1:100
2 A2

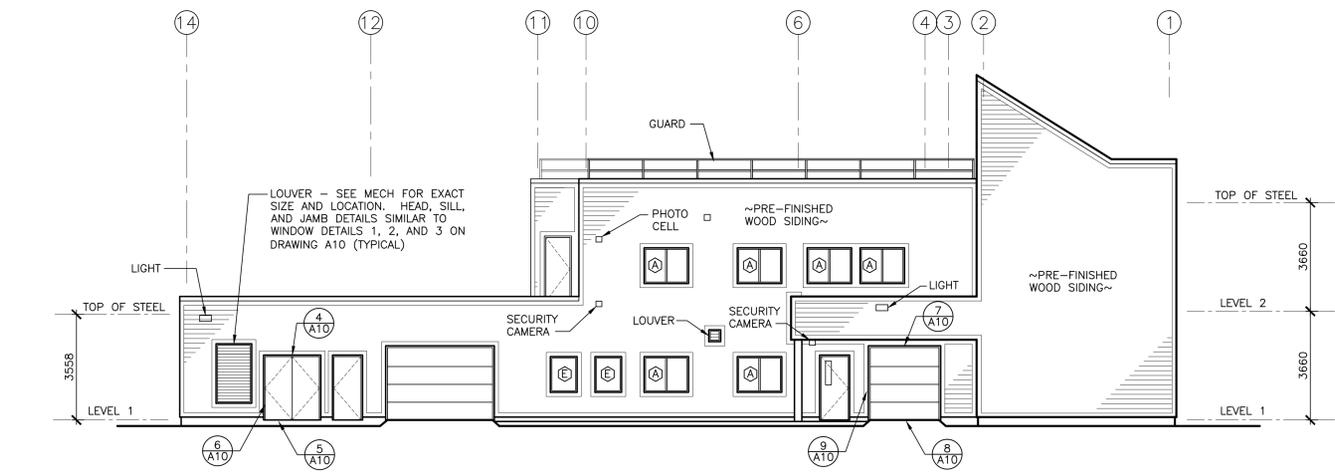


NORTH ELEVATION
SCALE : 1:100
3 A2

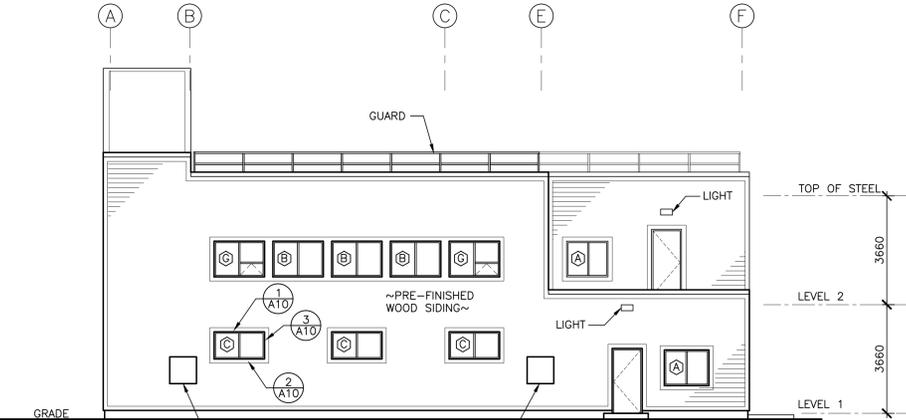

WEST ELEVATION
SCALE : 1:100
4 A2

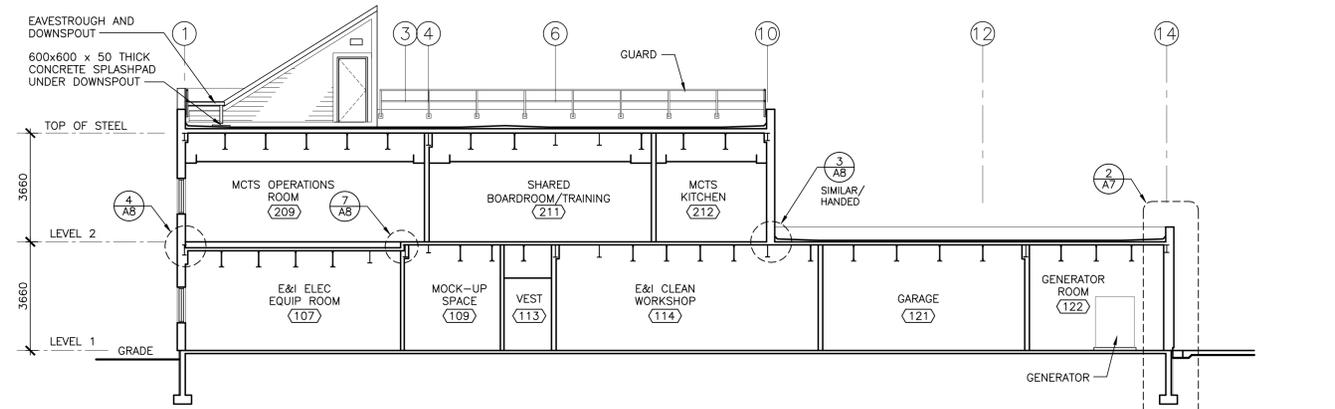

BUILDING SECTION
SCALE : 1:100
5 A2

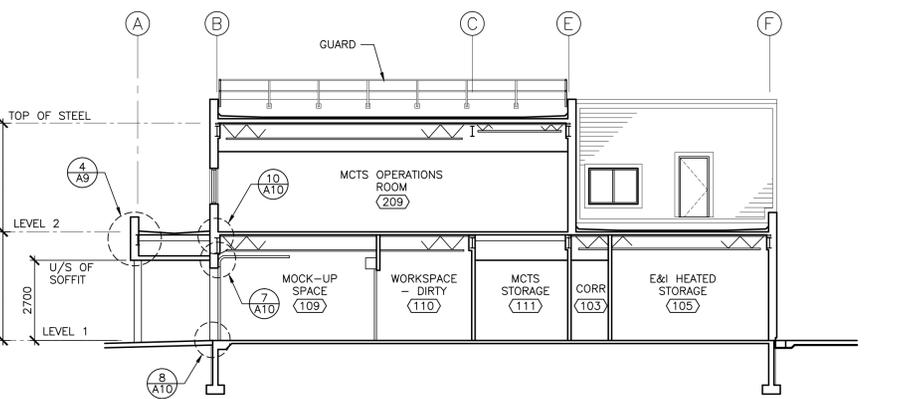

BUILDING SECTION
SCALE : 1:100
6 A2

WINDOW SCHEDULE

Window A: 1500 x 1200, 2184 height	Window C: 1700 x 900, 2743 height	Window E: 900 x 1200, 2184 height	Window G: 1700 x 1200, 2184 height
Window B: 1700 x 1200, 2184 height	Window D: 1200 x 1200, 2184 height	Window F: 1500 x 1200, 2184 height	

E	ISSUED FOR TENDER	JUL 11 2017
D	ISSUED FOR TENDER	JUN 28 2017
C	ISSUED FOR 99% REVIEW	MAY 25 2017
B	ISSUED FOR CLIENT REVIEW	APR 24 2017
A	ISSUED FOR 66% REVIEW	MAR 24 2017

MCTS CENTRE
PORT AUX BASQUES

ELEVATIONS AND BUILDING SECTIONS

designed	conçu
date	JULY 11, 2017
drawn	dessiné
date	JULY 11, 2017
approved	approuvé
date	JULY 11, 2017
Tender	g.f. macgillivray July 14/17
Project Manager	Administrateur des projets TPSCC
project number	no. du projet
R.082780.004	
drawing no.	no. du dessin
A4	