




APPROX. NORTH


- NOTES:
- COLUMN FINISH: 2 LAYERS OF 6 mm GYPSUM BOARD ON 41 mm METAL STUDS @ 300 OC. OUTSIDE DIAMETER OF COLUMN TO BE 350 mm ±.
 - PROVIDE/INSTALL FRP PANEL ON WALL BEHIND JANITOR'S SINK TO MINIMUM 200 mm PAST SINK, AND TO MINIMUM 900 mm ABOVE FLOOR. PROVIDE/INSTALL MOP RACK ABOVE JANITOR'S SINK.
 - 100 mm THICK CONCRETE PAD FOR HOT WATER TANK (LENGTH AND WIDTH TO SUIT).
 - CONCRETE PAD FOR GENERATOR. COORDINATE SIZE AND LOCATION WITH MECHANICAL.

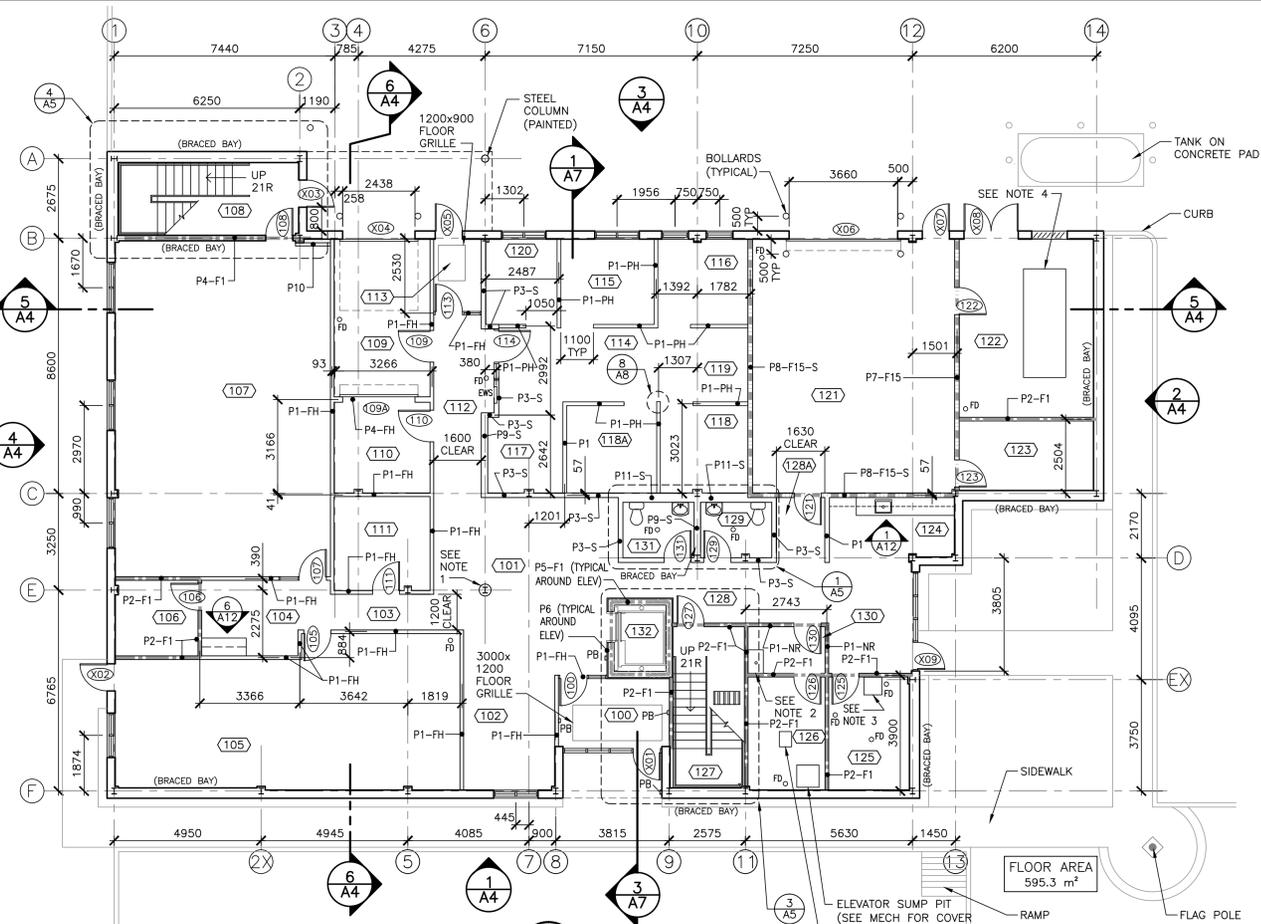

FLOOR PLAN - LEVEL 1

SCALE : 1:100


FLOOR AREA
595.3 m²

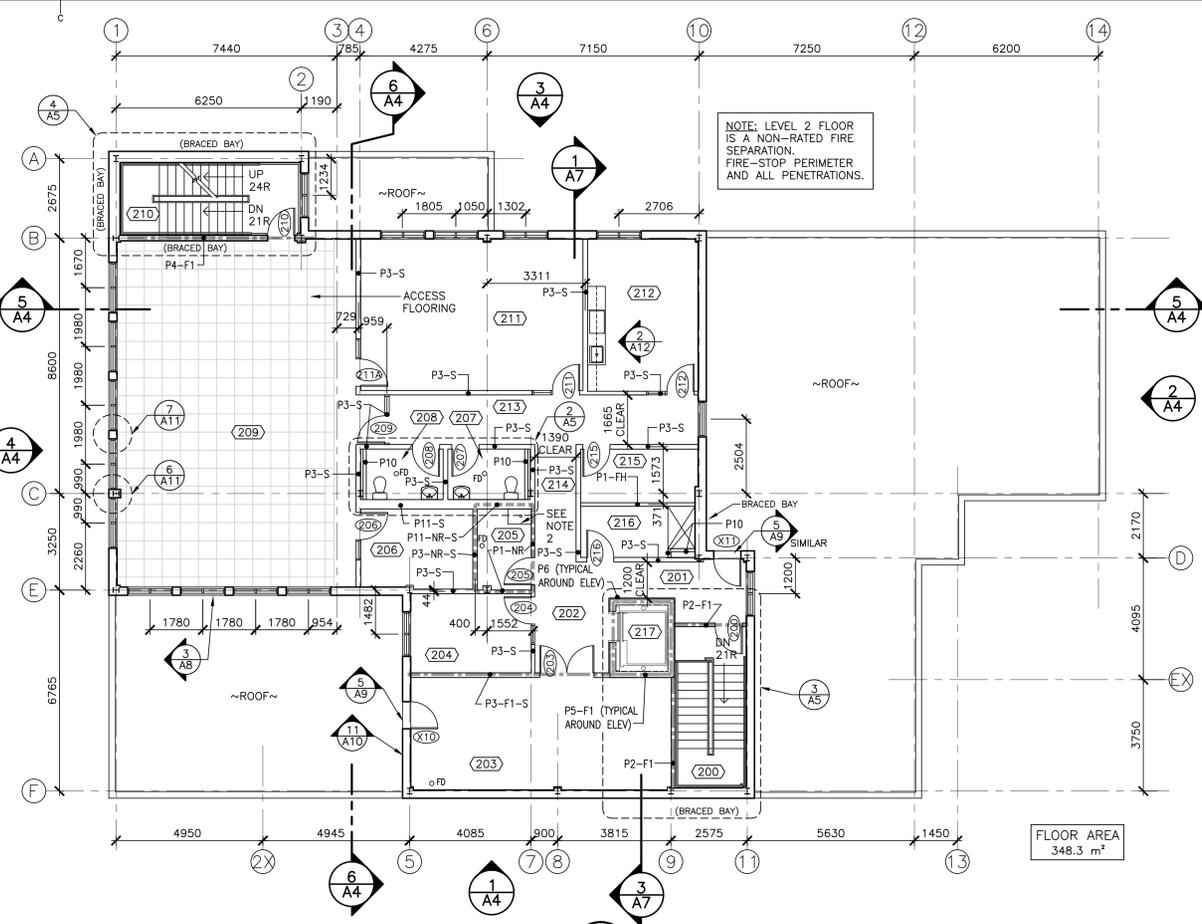

FLOOR PLAN - LEVEL 2

SCALE : 1:100


FLOOR AREA
348.3 m²

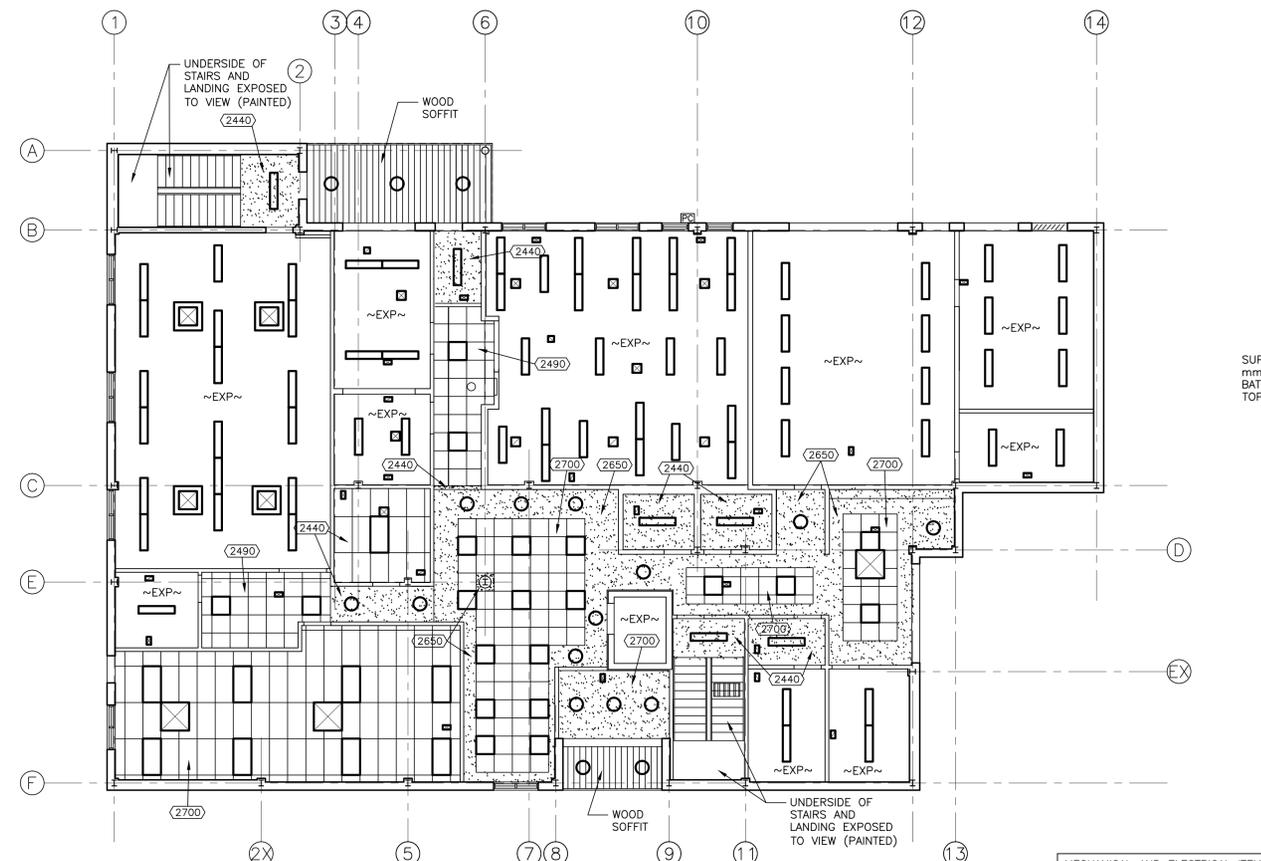

CEILING PLAN - LEVEL 1

SCALE : 1:100

MECHANICAL AND ELECTRICAL ITEMS SHOWN ON CEILING PLANS ARE FOR INFORMATION PURPOSES ONLY. REFER TO MECHANICAL AND ELECTRICAL DRAWINGS FOR TYPE, NUMBER, AND LOCATION OF CEILING MOUNTED FIXTURES.

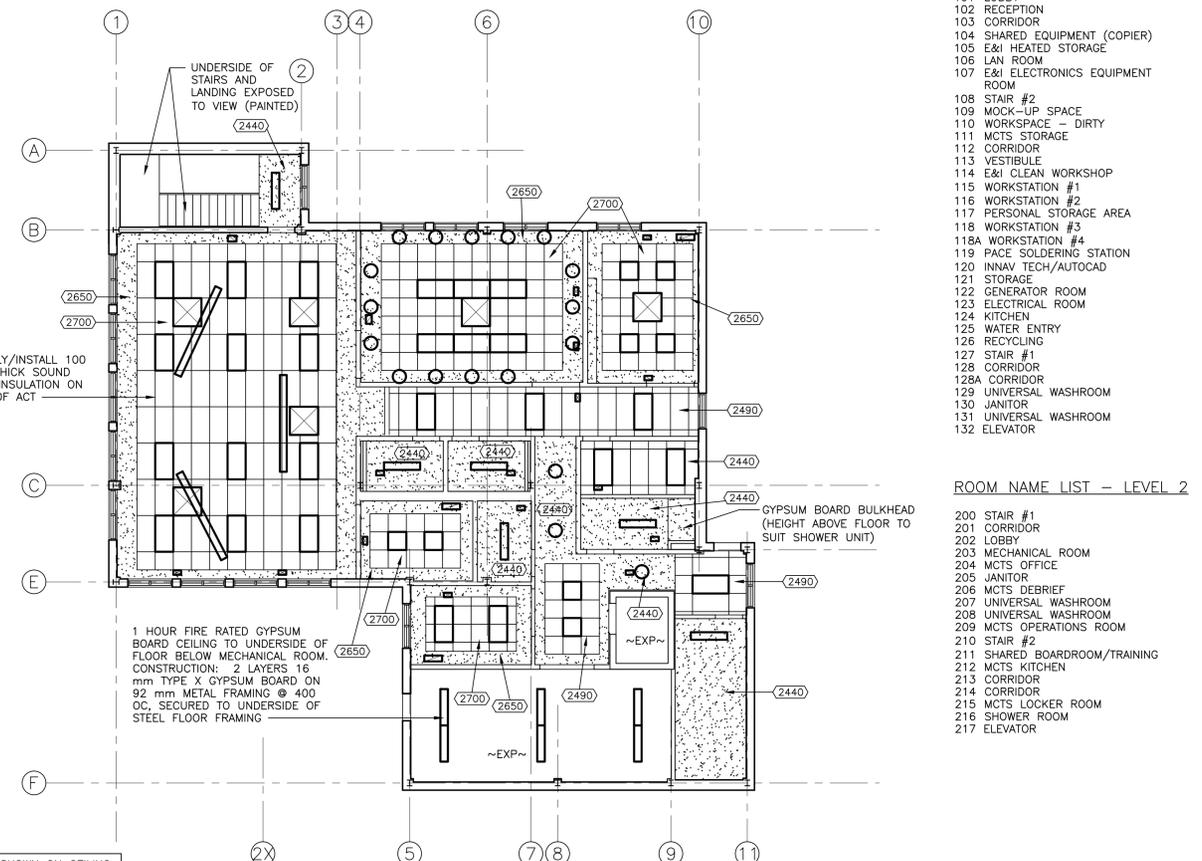

CEILING PLAN - LEVEL 2

SCALE : 1:100

ROOM NAME LIST - LEVEL 1

- 100 VESTIBULE
- 101 LOBBY
- 102 CORRIDOR
- 103 CORRIDOR
- 104 SHARED EQUIPMENT (COPIER)
- 105 E&I HEATED STORAGE
- 106 LAN ROOM
- 107 E&I ELECTRONICS EQUIPMENT ROOM
- 108 STAIR #2
- 109 MOCK-UP SPACE
- 110 WORKSPACE - DIRTY
- 111 MCTS STORAGE
- 112 CORRIDOR
- 113 VESTIBULE
- 114 E&I CLEAN WORKSHOP
- 115 WORKSTATION #1
- 116 WORKSTATION #2
- 117 PERSONAL STORAGE AREA
- 118 WORKSTATION #3
- 118A WORKSTATION #4
- 119 PACE SOLDERING STATION
- 120 INNAV TECH/AUTOCAD
- 121 STORAGE
- 122 GENERATOR ROOM
- 123 ELECTRICAL ROOM
- 124 KITCHEN
- 125 WATER ENTRY
- 126 RECYCLING
- 127 STAIR #1
- 128 CORRIDOR
- 128A CORRIDOR
- 129 UNIVERSAL WASHROOM
- 130 JANITOR
- 131 UNIVERSAL WASHROOM
- 132 ELEVATOR

ROOM NAME LIST - LEVEL 2

- 200 STAIR #1
- 201 CORRIDOR
- 202 LOBBY
- 203 MECHANICAL ROOM
- 204 MCTS OFFICE
- 205 JANITOR
- 206 MCTS DEBRIEF
- 207 UNIVERSAL WASHROOM
- 208 UNIVERSAL WASHROOM
- 209 MCTS OPERATIONS ROOM
- 210 STAIR #2
- 211 SHARED BOARDROOM/TRAINING
- 212 MCTS KITCHEN
- 213 CORRIDOR
- 214 CORRIDOR
- 215 MCTS LOCKER ROOM
- 216 SHOWER ROOM
- 217 ELEVATOR

revision	description	date
E	ISSUED FOR TENDER	JUL 11 2017
D	ISSUED FOR TENDER	JUN 28 2017
C	ISSUED FOR 99% REVIEW	MAY 25 2017
B	ISSUED FOR CLIENT REVIEW	APR 24 2017
A	ISSUED FOR 66% REVIEW	MAR 24 2017

MCTS CENTRE

PORT AUX BASQUES

FLOOR AND CEILING PLANS

designed	<i>[Signature]</i>	conçu
date	JULY 11, 2017	
drawn	<i>[Signature]</i>	dessiné
date	JULY 11, 2017	
approved	<i>[Signature]</i>	approuvé
date	JULY 11, 2017	
Tender	<i>[Signature]</i>	Soumission
Project Manager	<i>[Signature]</i>	Administrateur de projet TPSCC
project number	R.082780.004	no. du projet
drawing no.	A2	no. du dessin