

NIAGARA-ON-THE-LAKE, ONTARIO. PARKS CANADA

FORT MISSISSAUGA STABILIZATION PHASE II PCA Proj. No.: PRO000808

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- S9 OBSERVATION DECK

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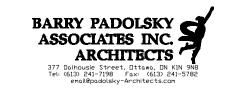
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| 04 | Issued for tender | 2016/05/12 |
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| 01 | Issued for 33% review | 2016.02.05 |
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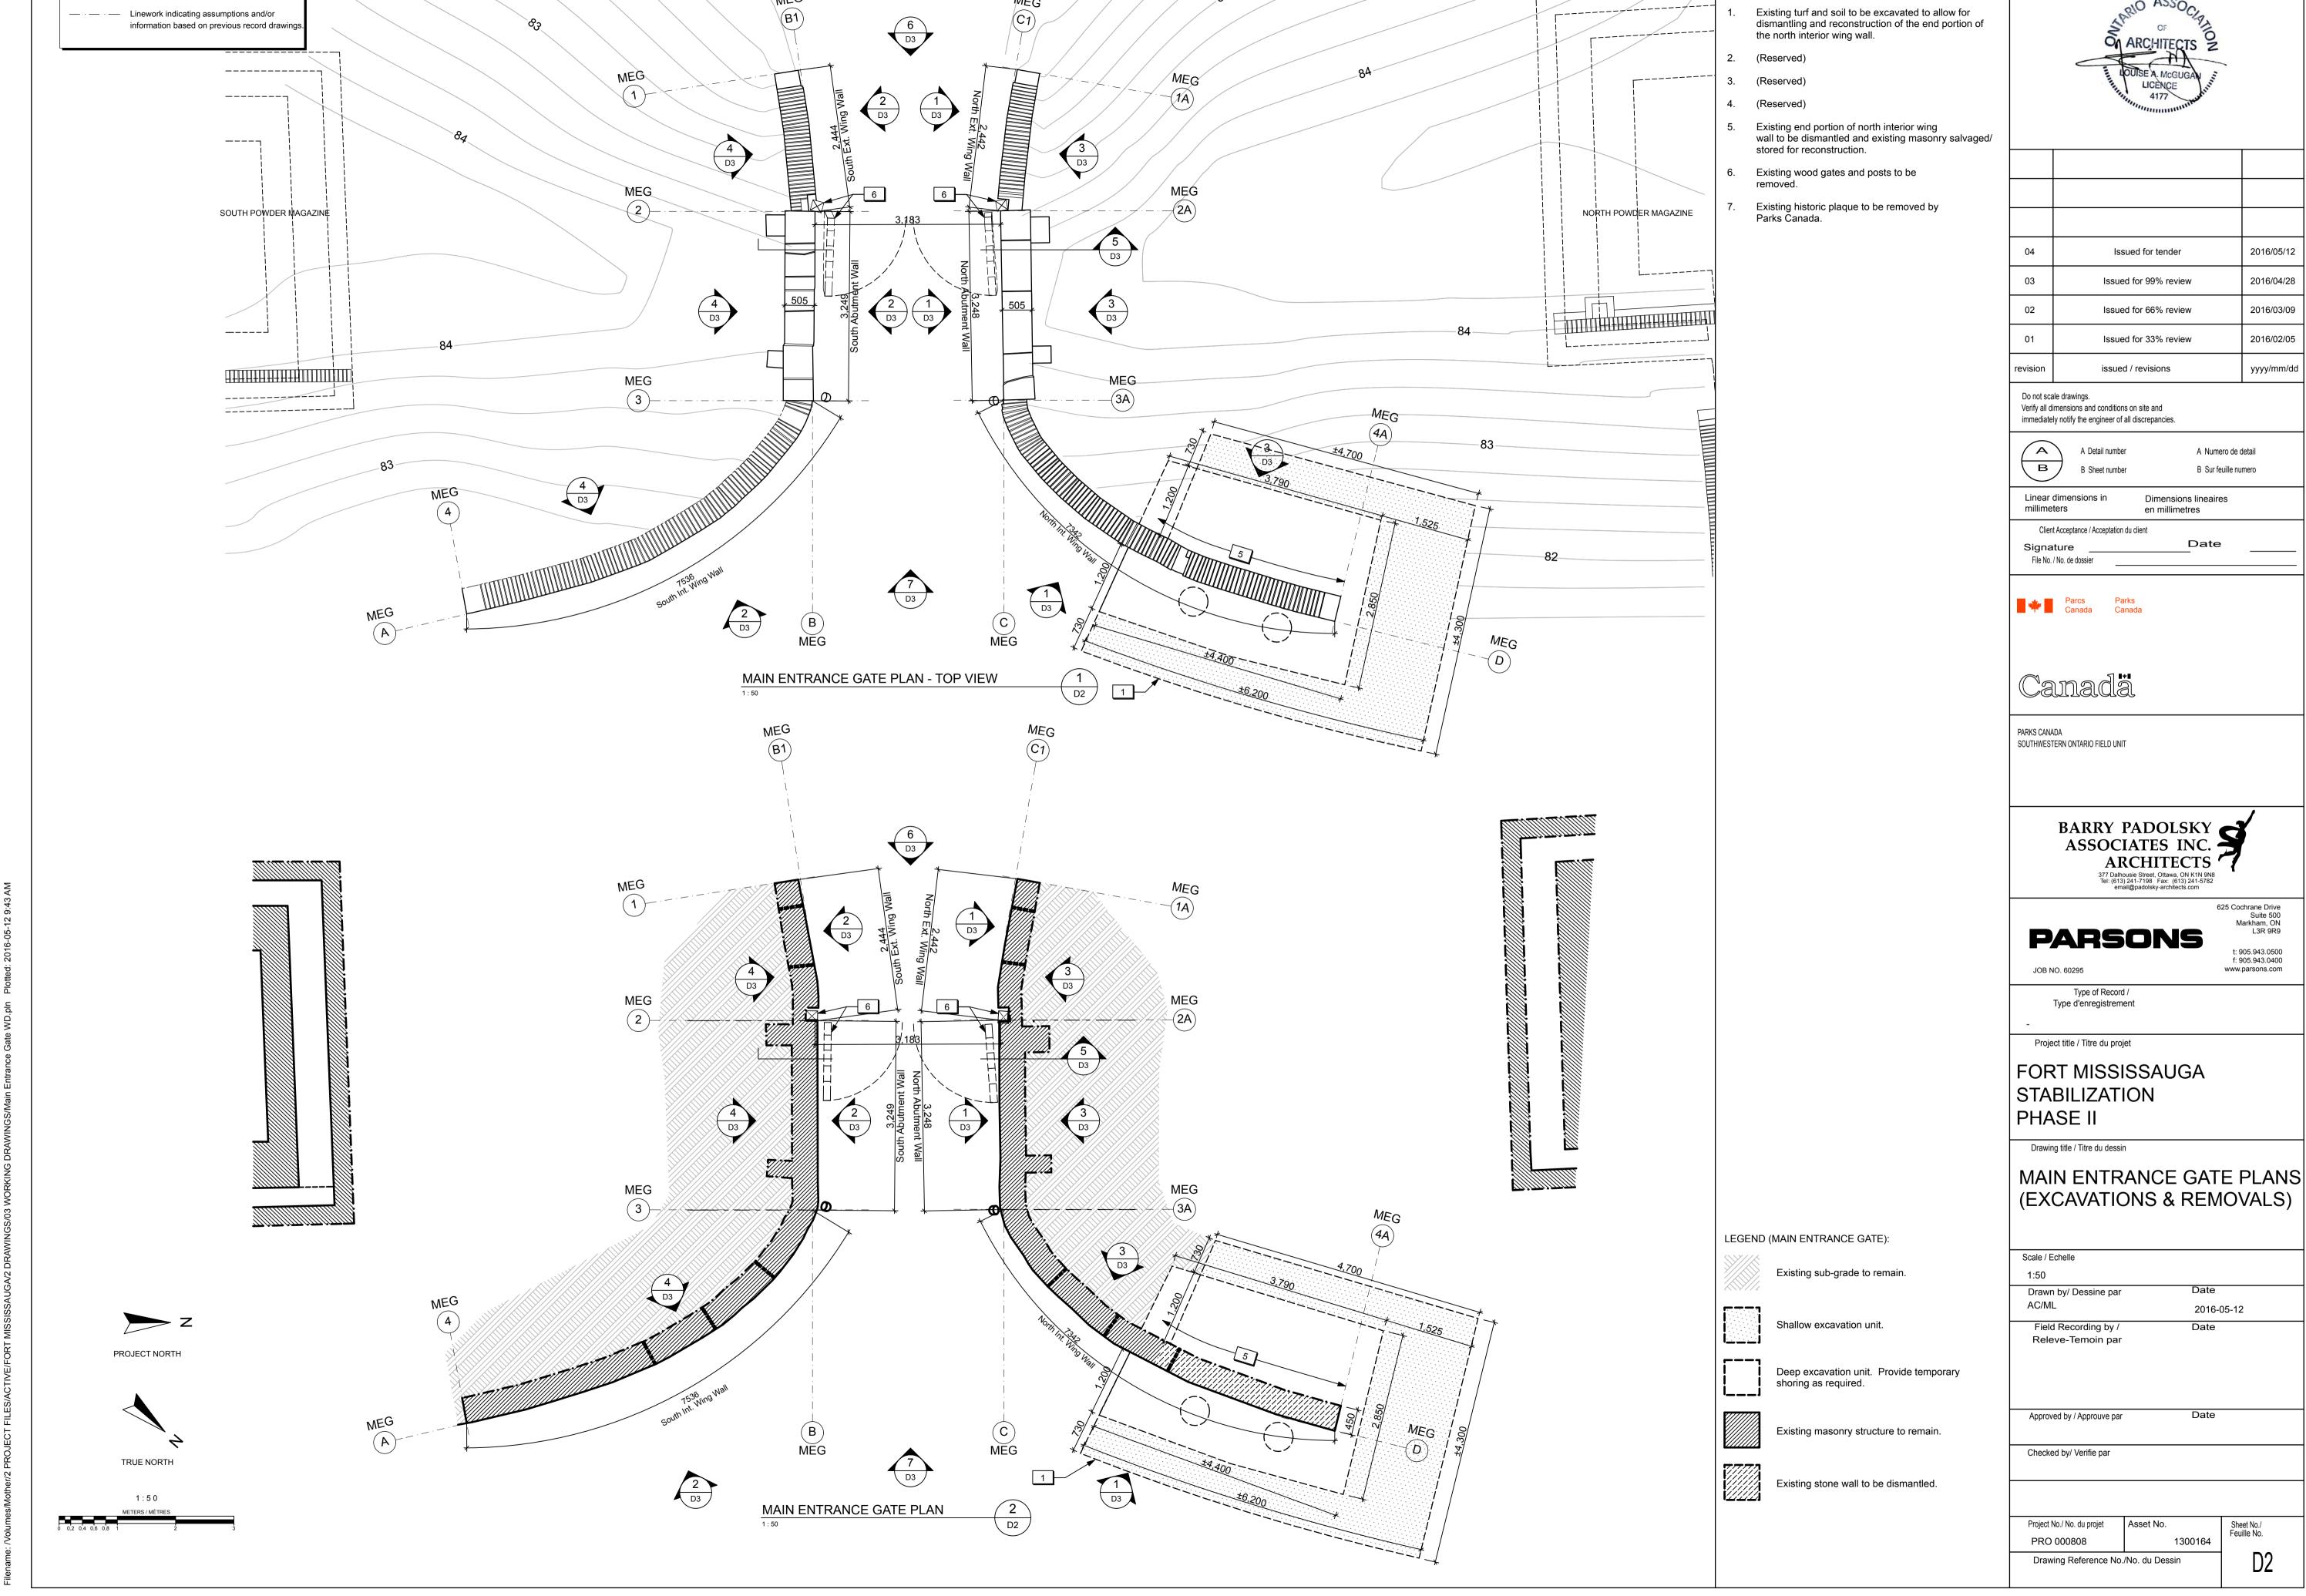
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SITE PLAN (EXCAVATION &


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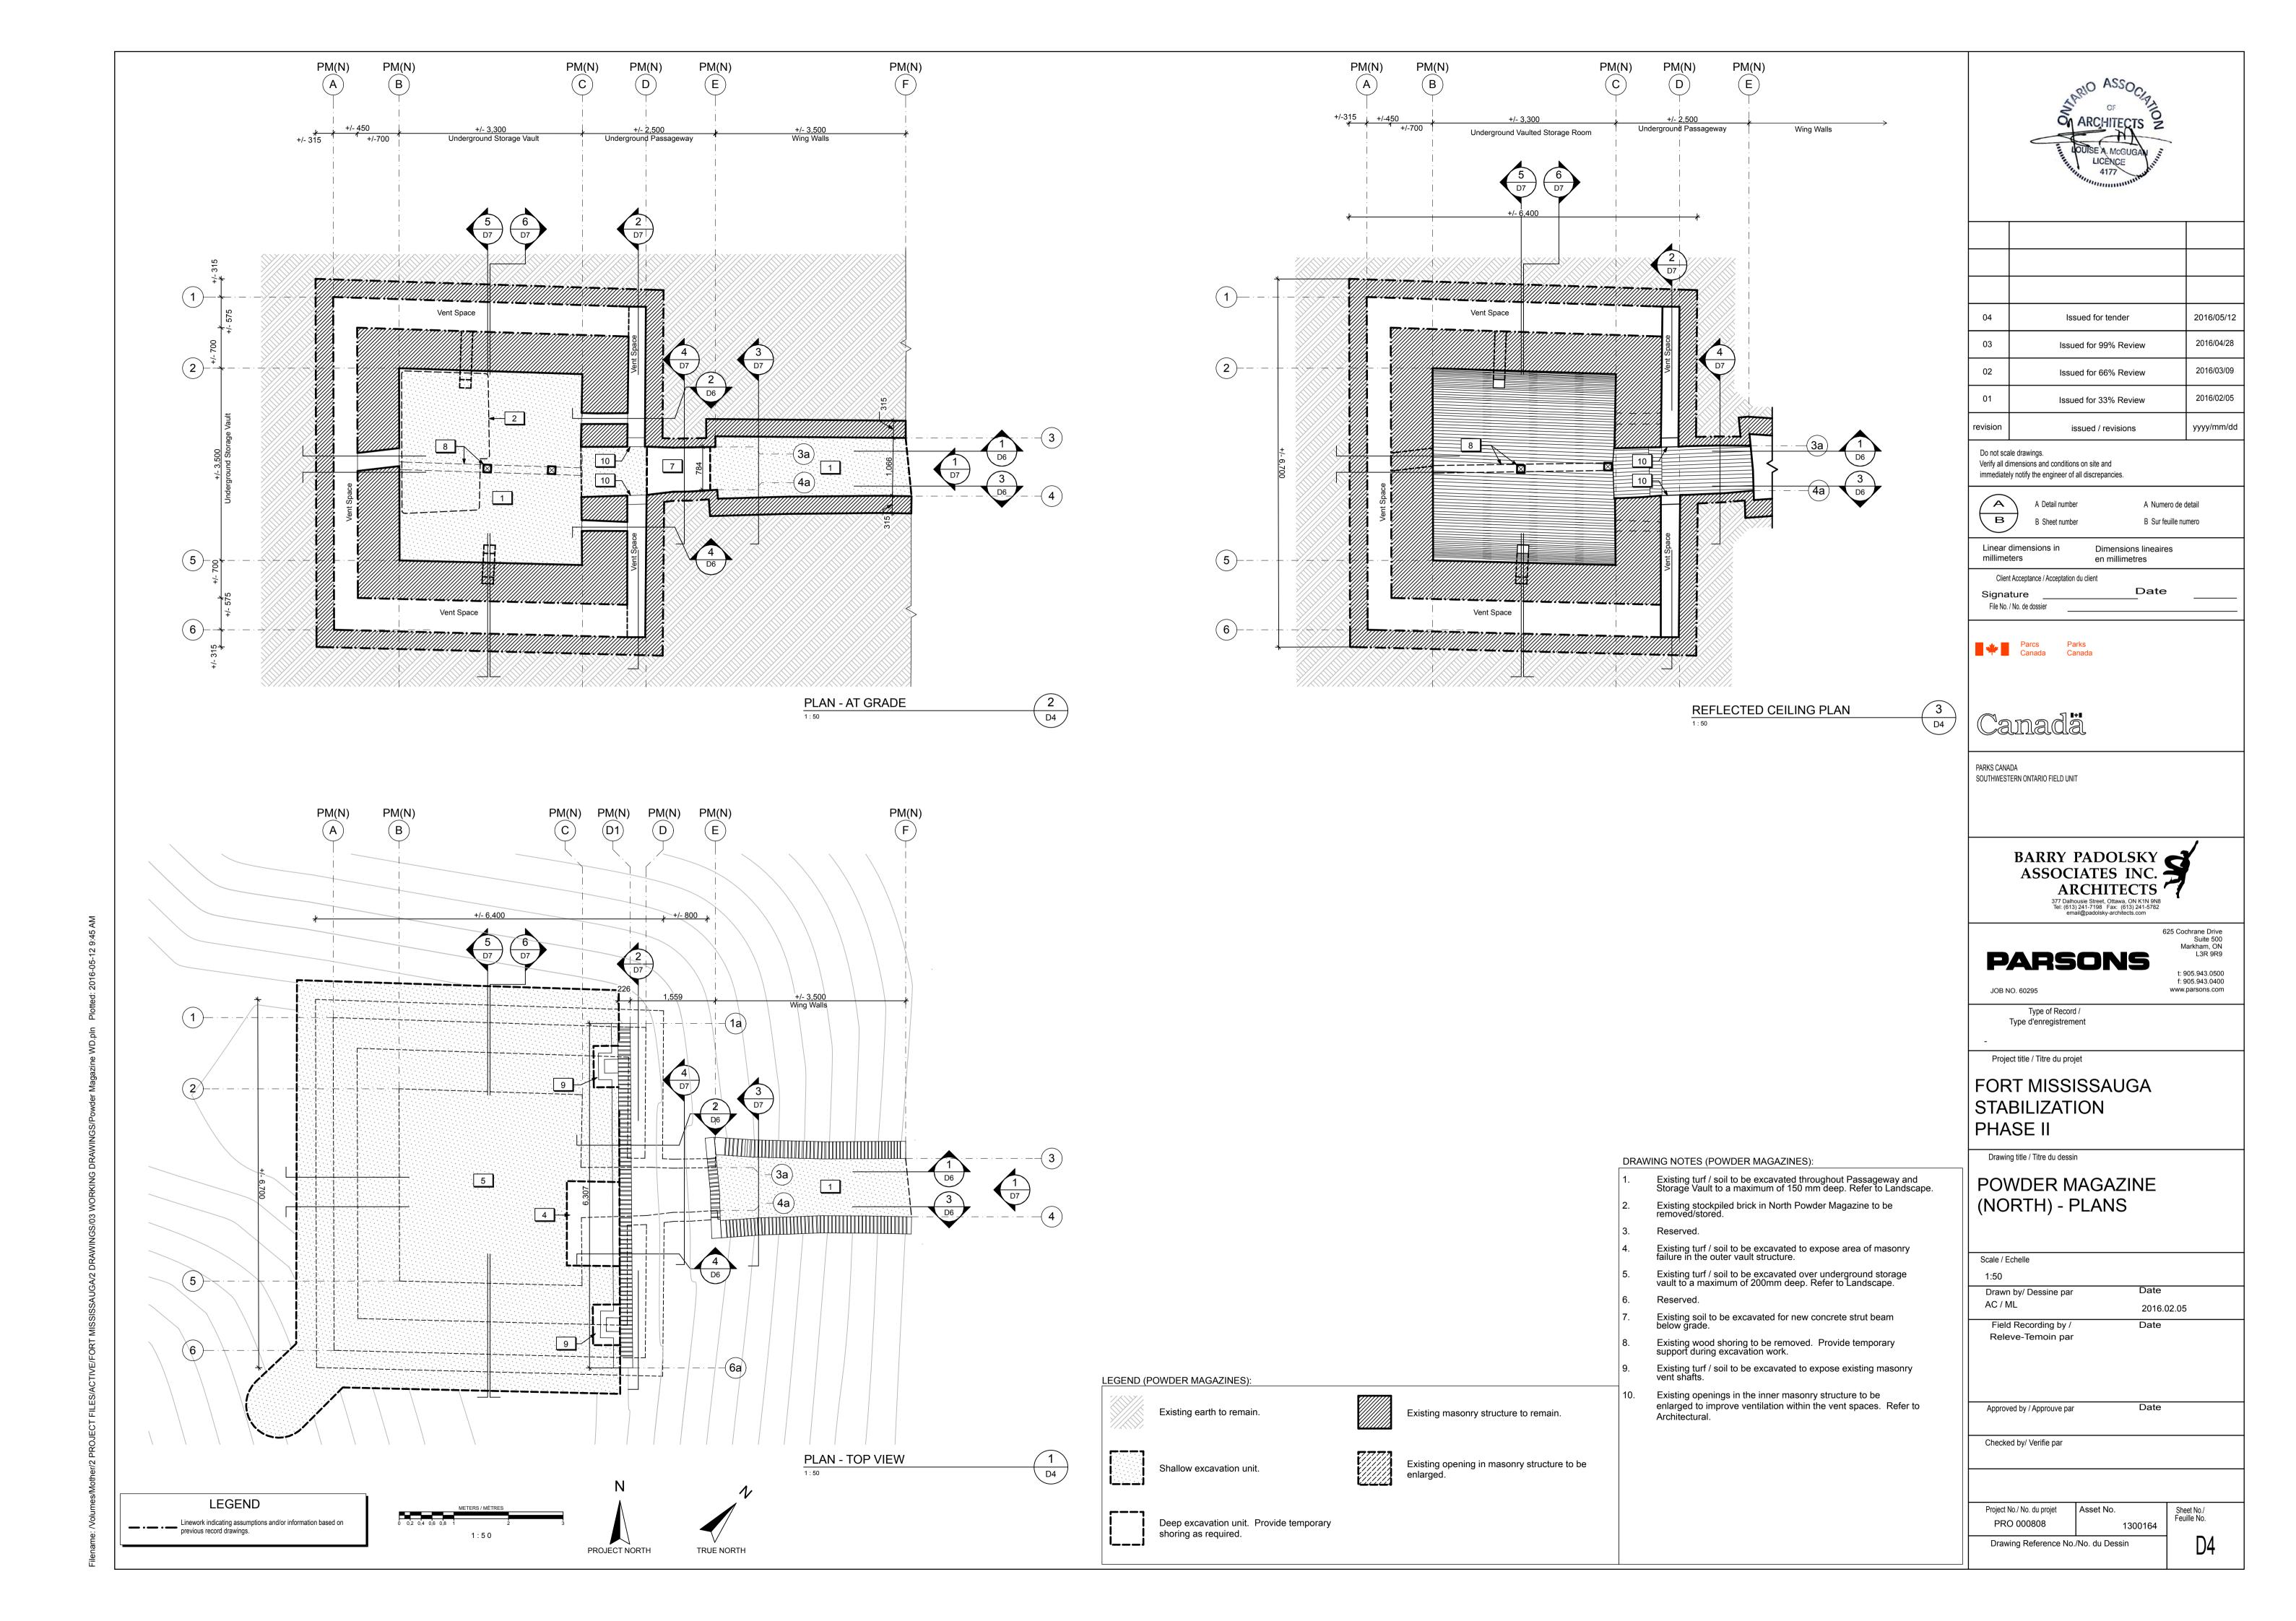
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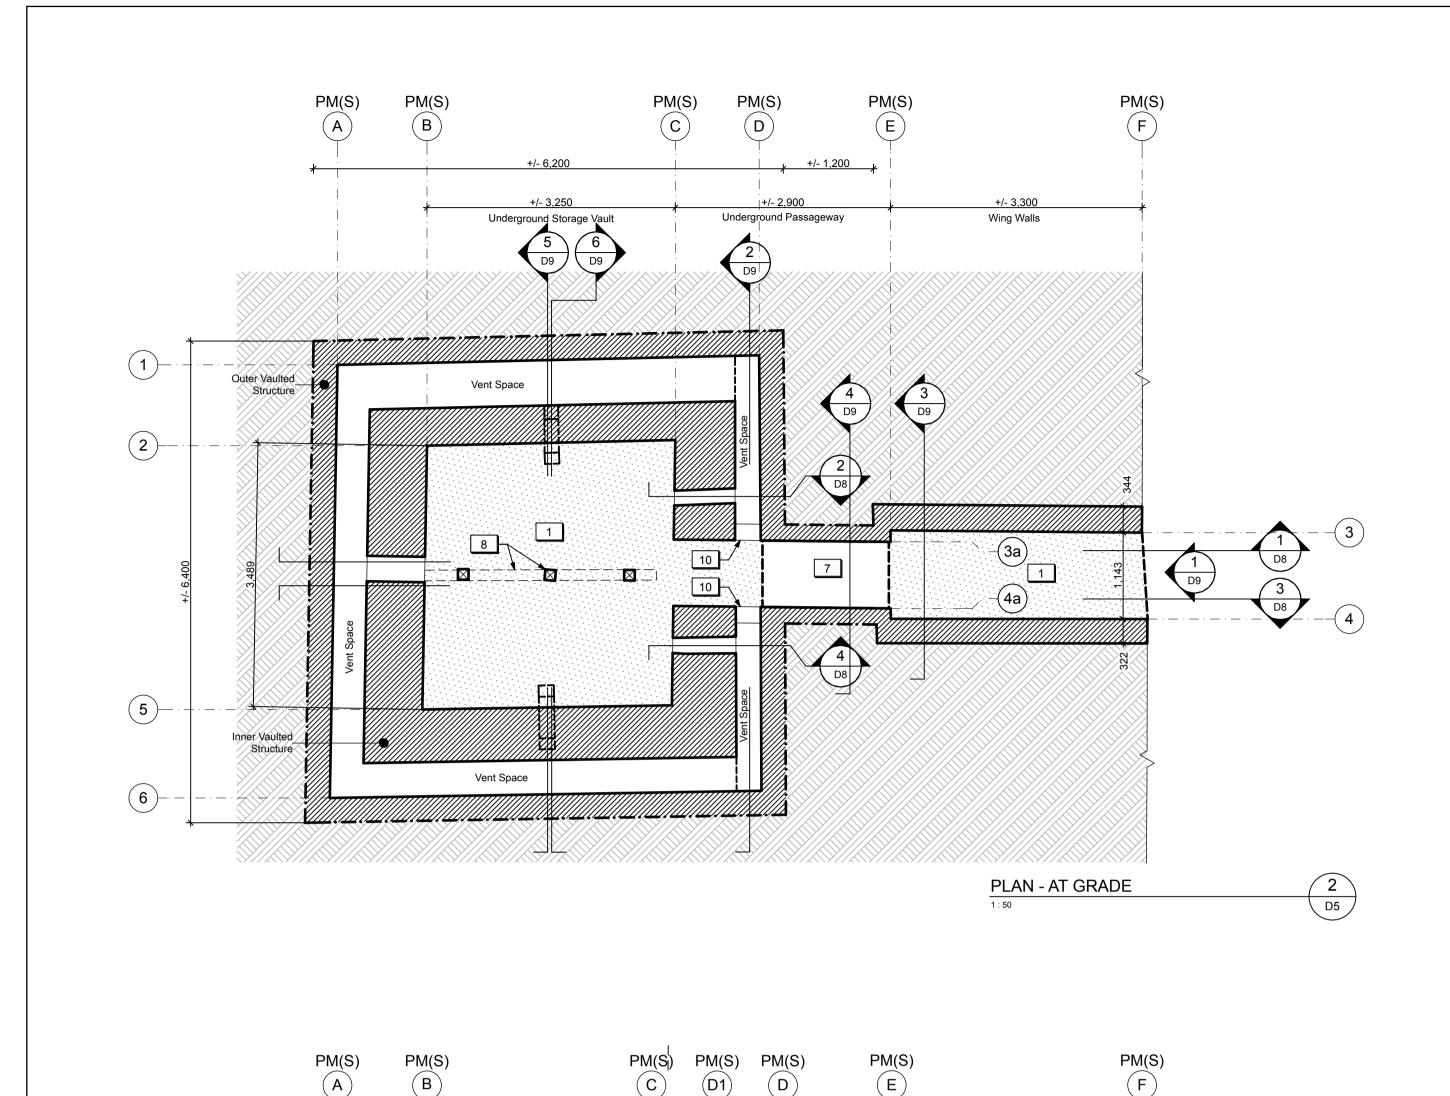



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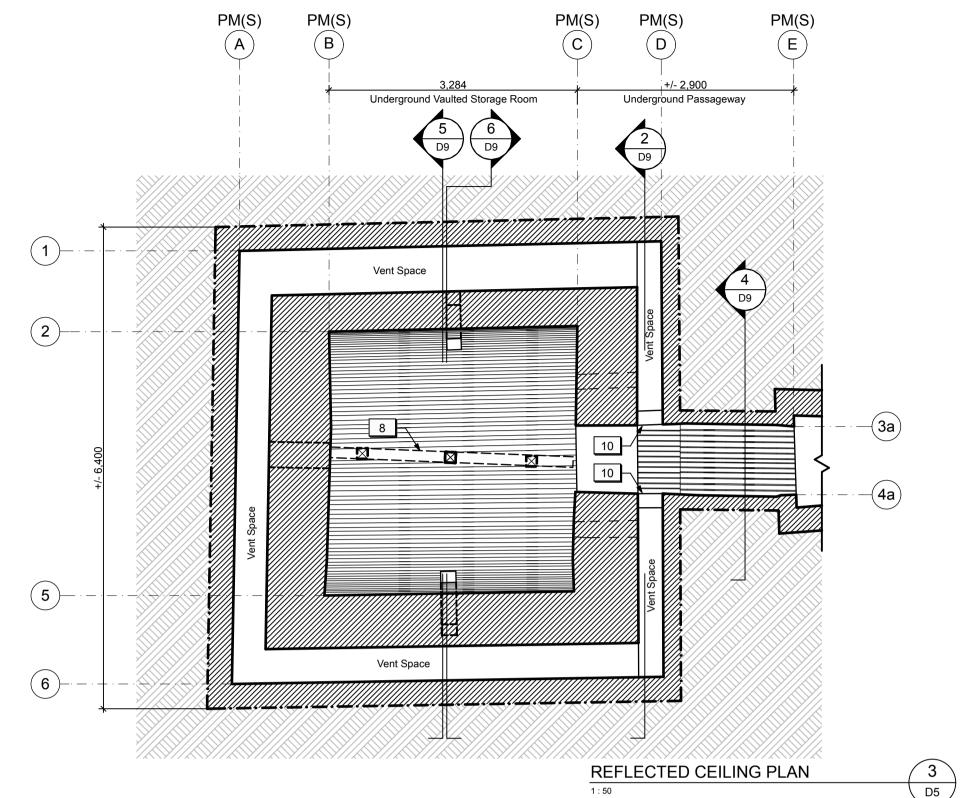
DRAWING NOTES (MAIN ENTRANCE GATE)







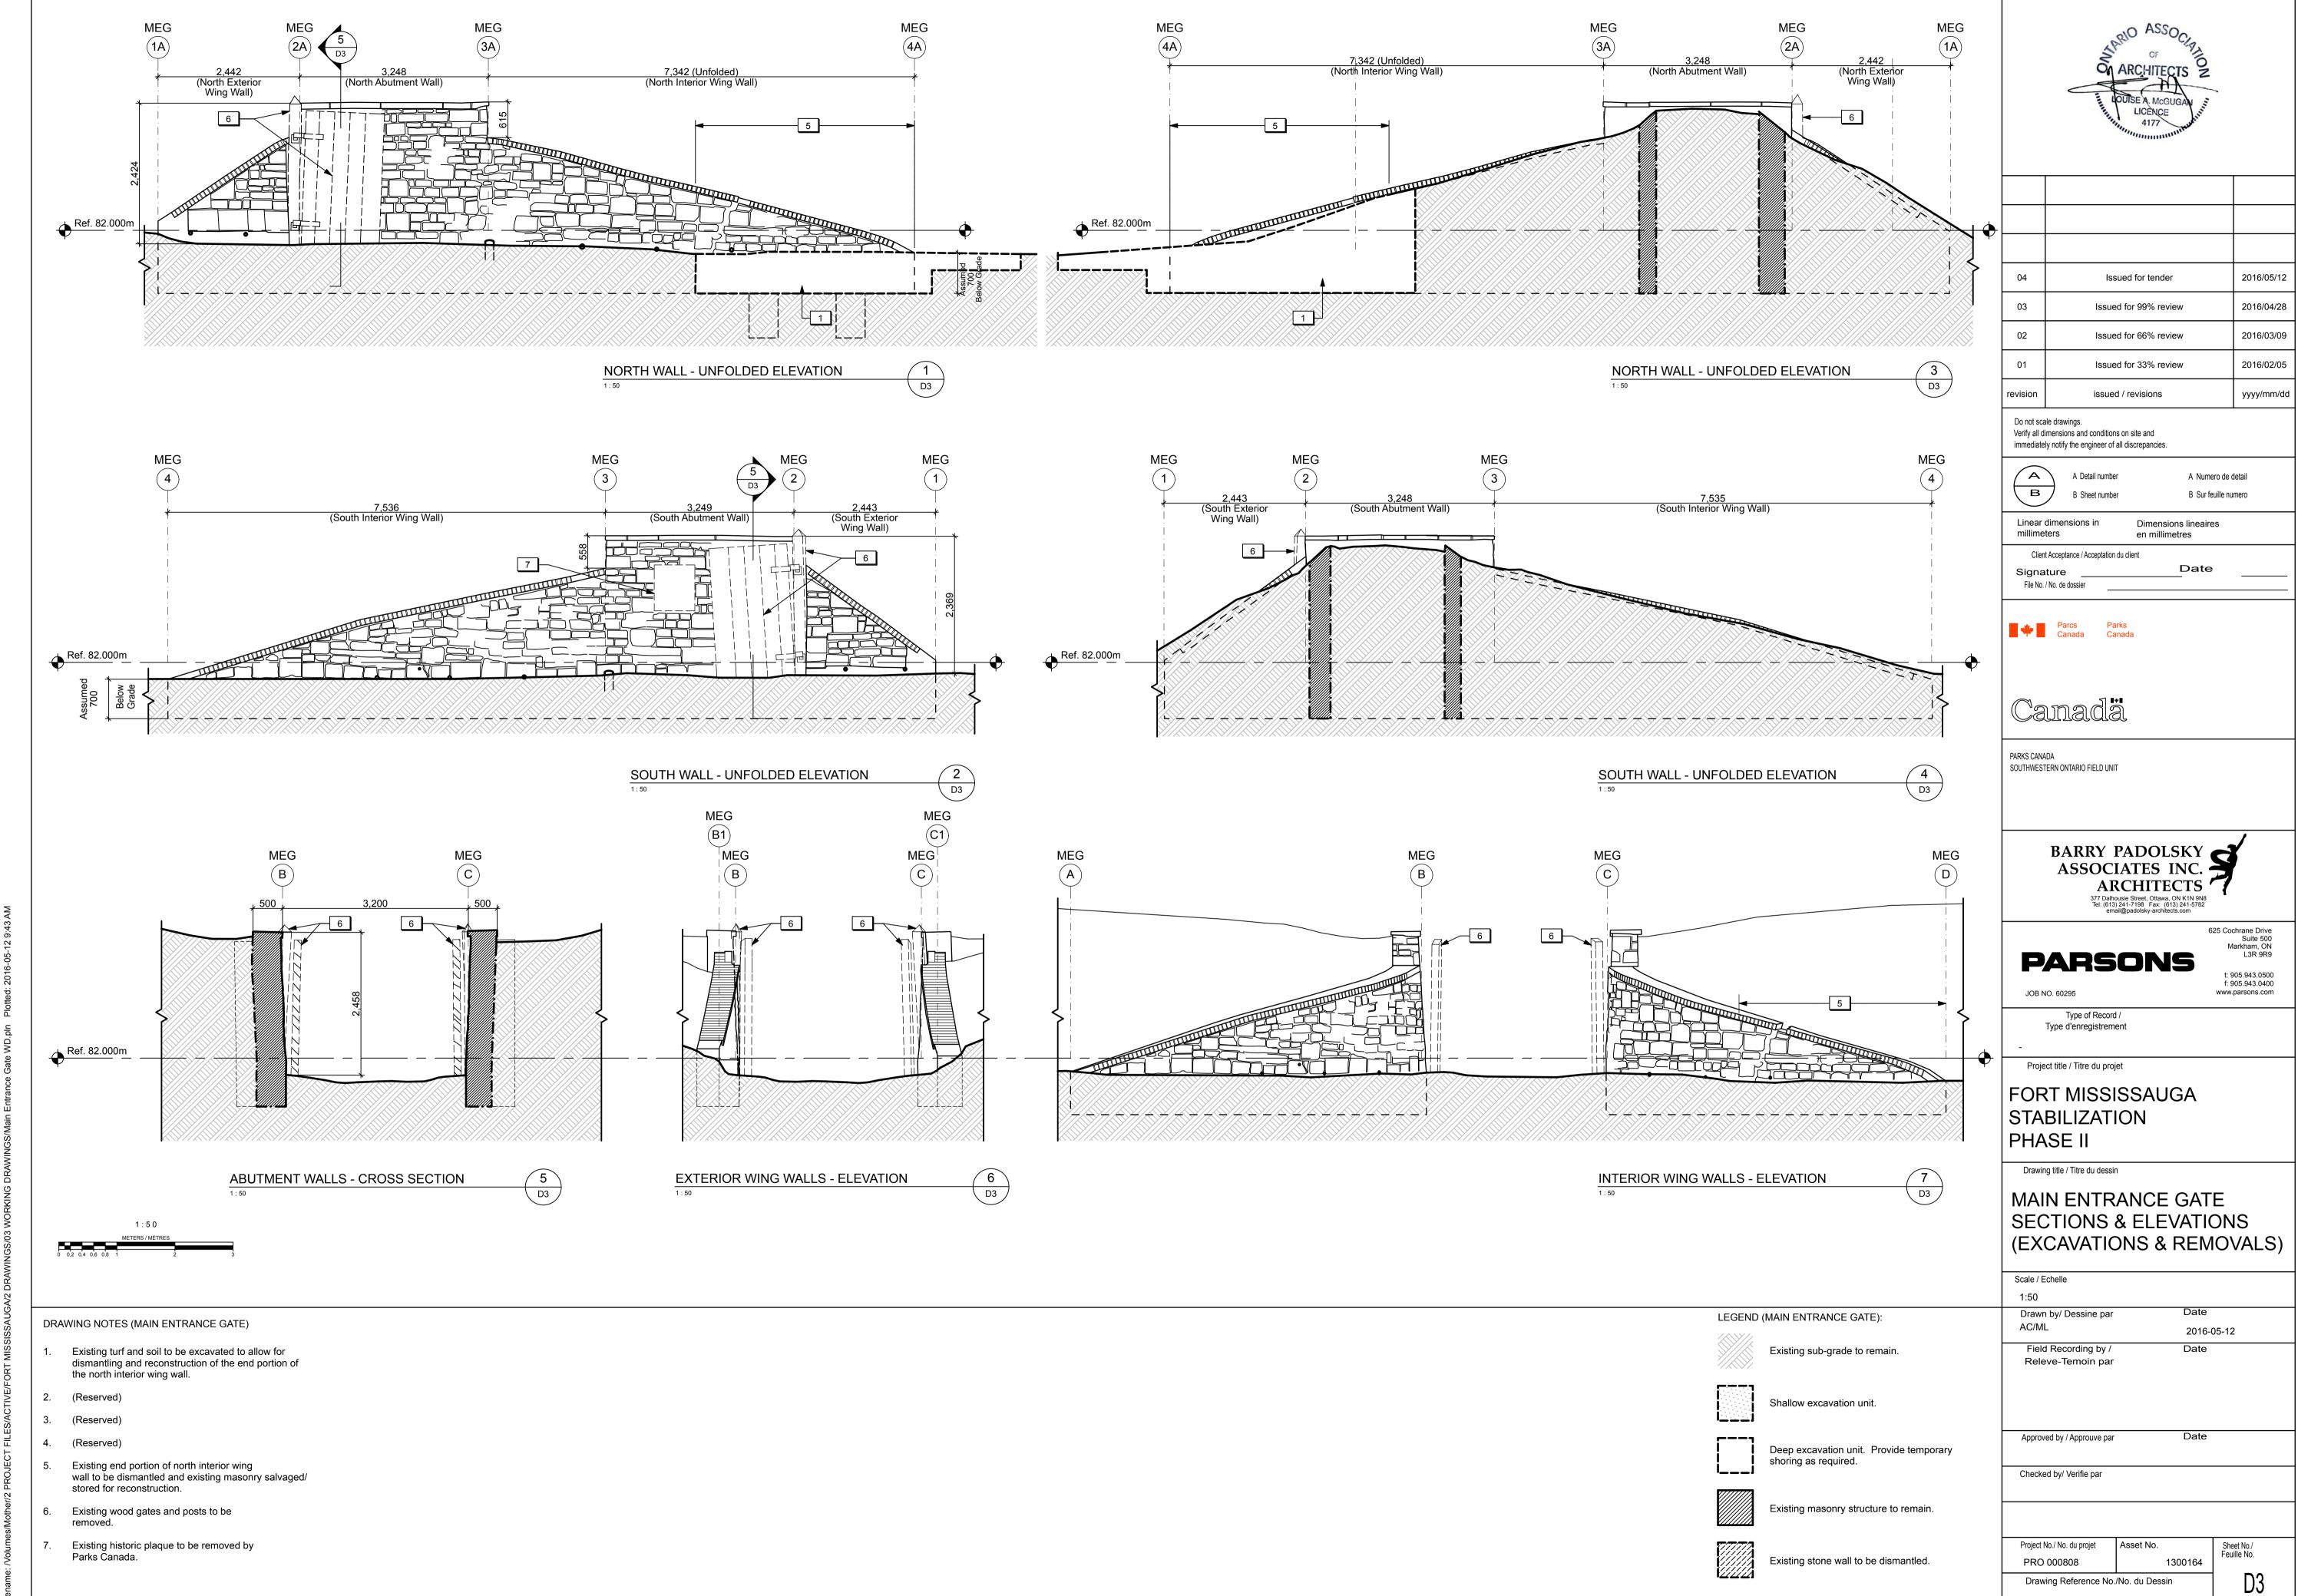

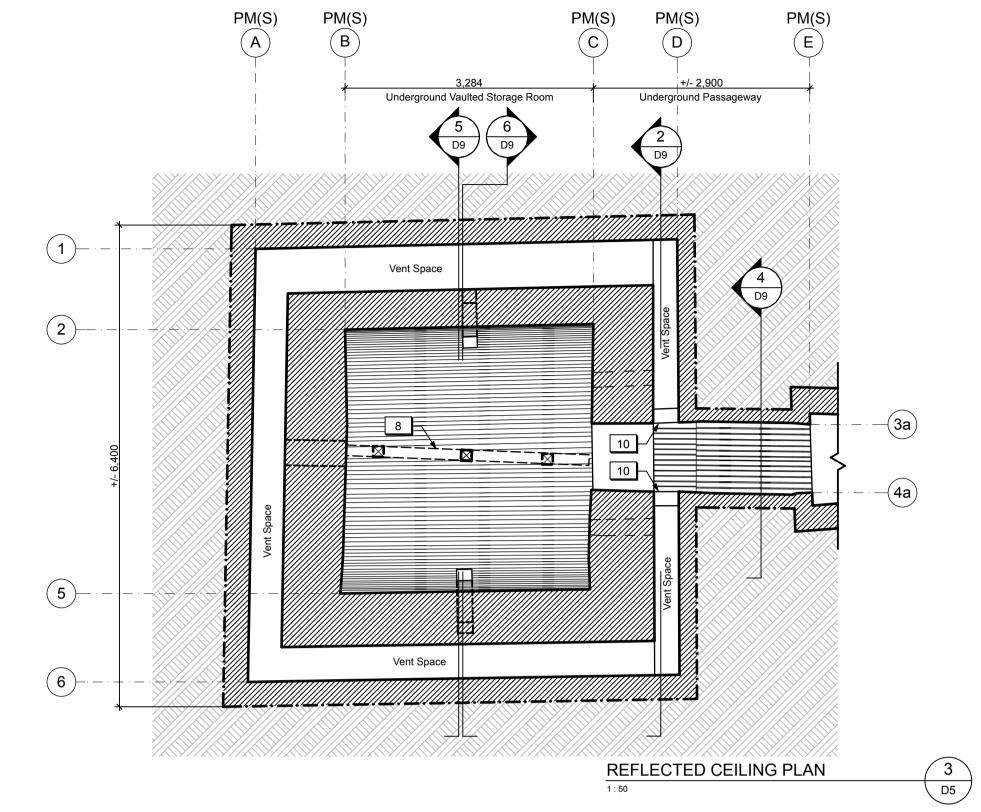



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SOUTHWESTERN ONTARIO FIELD UNIT

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Type of Record / Type d'enregistrement

Project title / Titre du projet

FORT MISSISSAUGA STABILIZATION PHASE II

Drawing title / Titre du dessin

POWDER MAGAZINE (SOUTH) - PLANS


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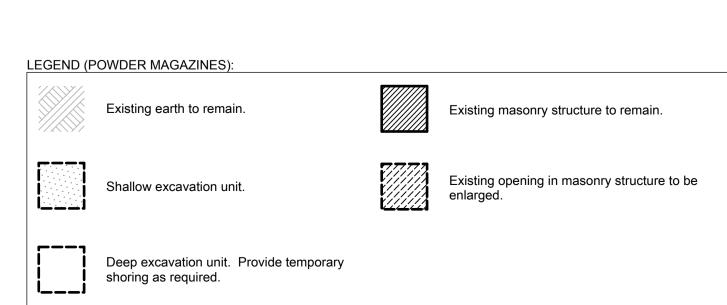
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Existing turf / soil to be excavated to expose area of masonry failure in the outer vault structure. Existing turf / soil to be excavated over underground storage vault to a maximum of 200mm deep. Refer to Landscape. Existing soil to be excavated for new concrete strut beam below grade. Existing wood shoring to be removed. Provide temporary support during excavation work.


DRAWING NOTES (POWDER MAGAZINES):


Existing turf / soil to be excavated to expose existing masonry vent shafts. Existing openings in the inner masonry structure to be


enlarged to improve ventilation within the vent spaces. Refer to Architectural.


Existing turf / soil to be excavated throughout Passageway and Storage Vault to a maximum of 150 mm deep. Refer to Landscape.

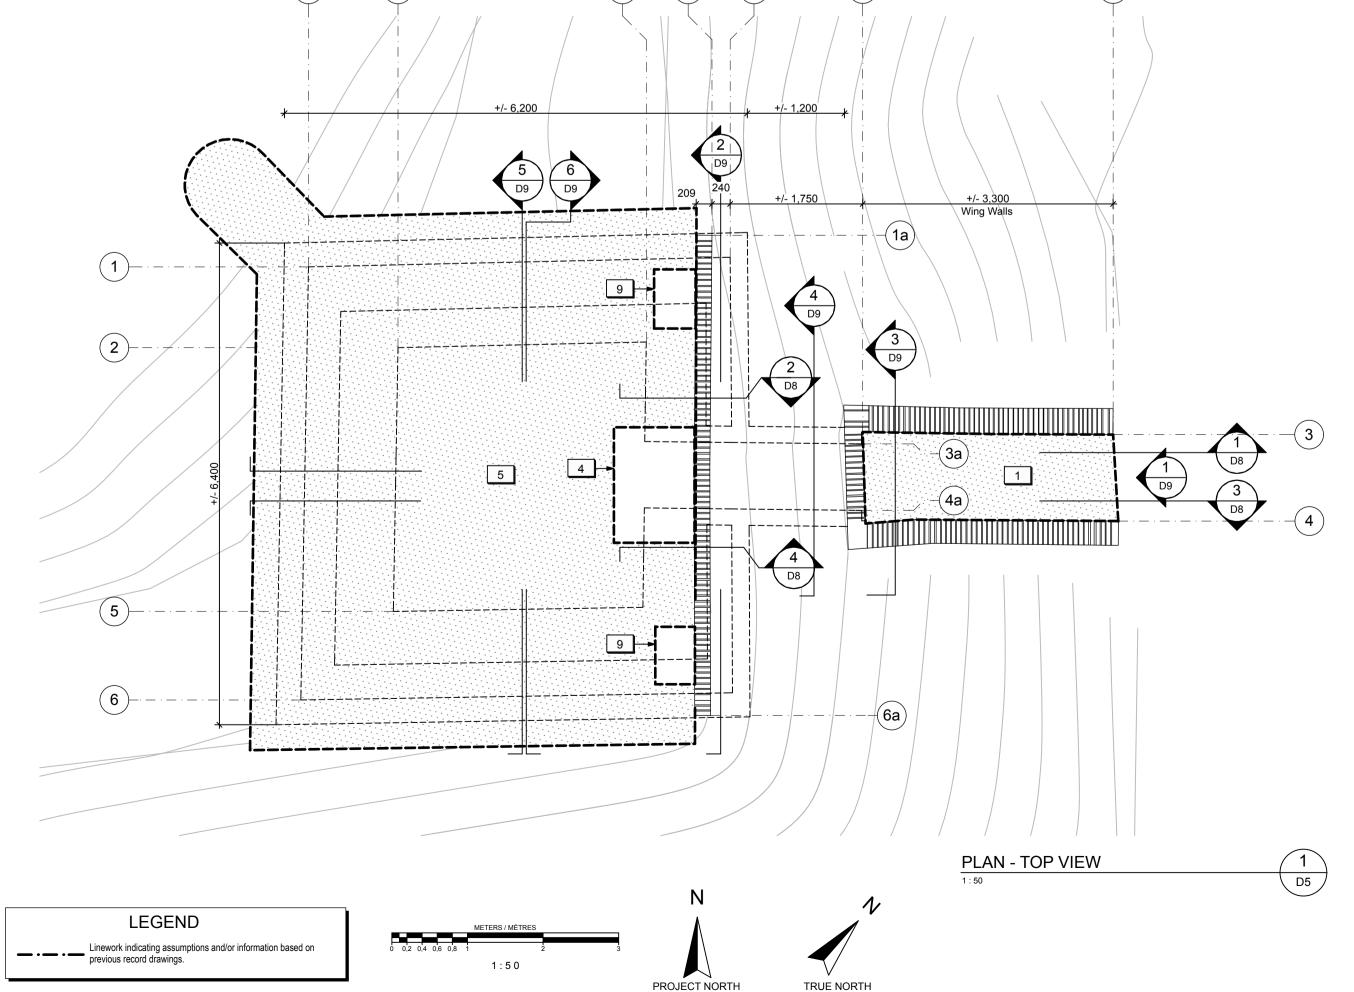Existing stockpiled brick in North Powder Magazine to be removed/stored.

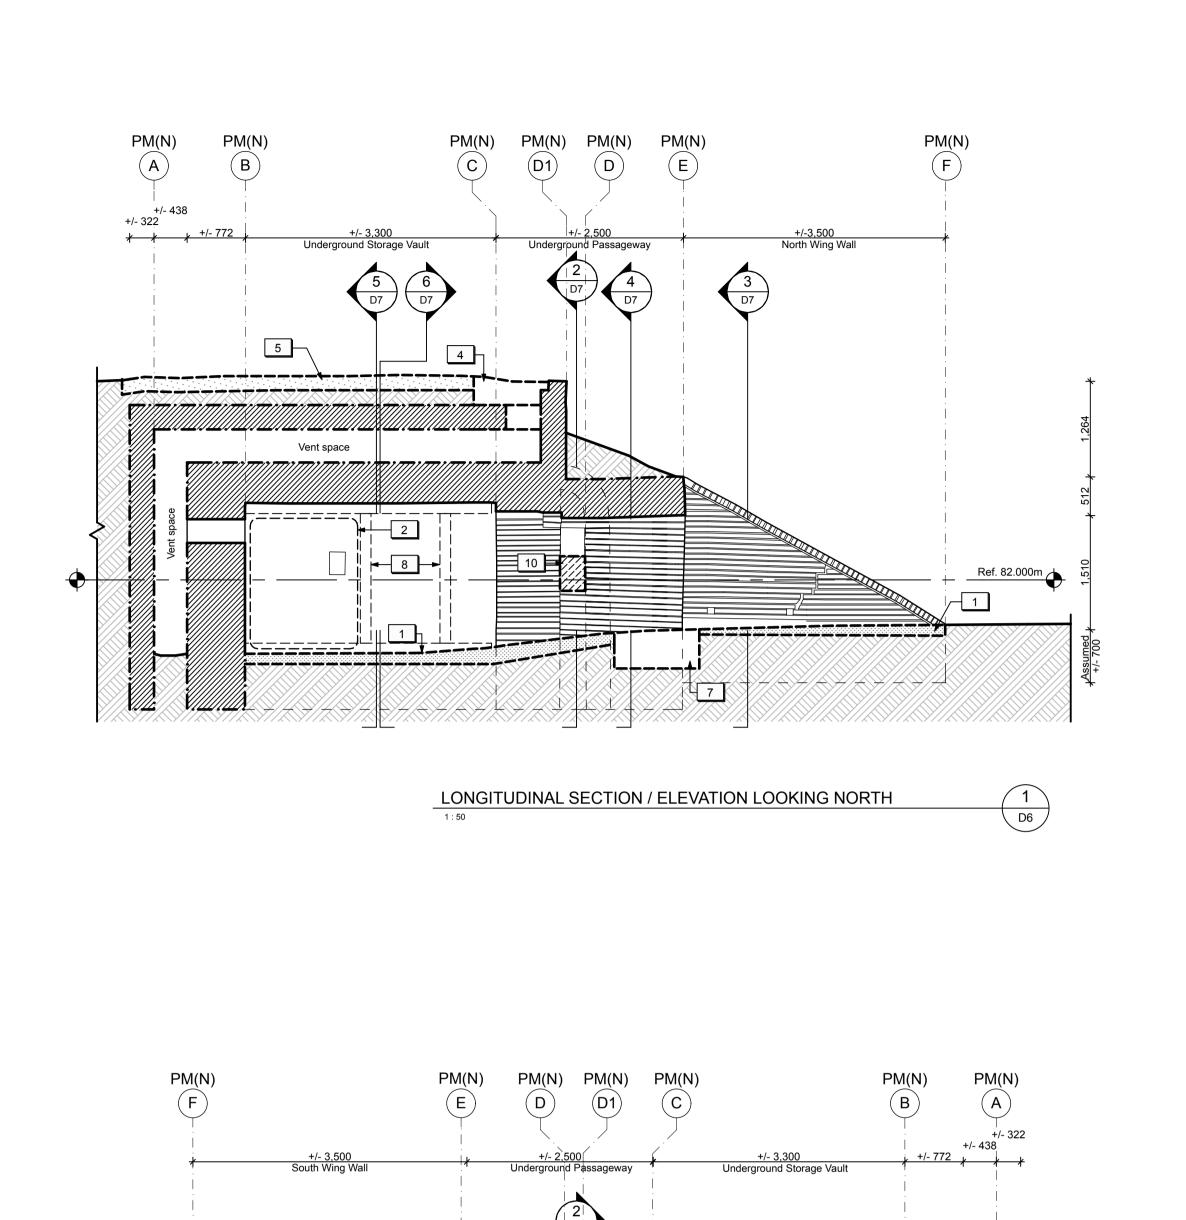

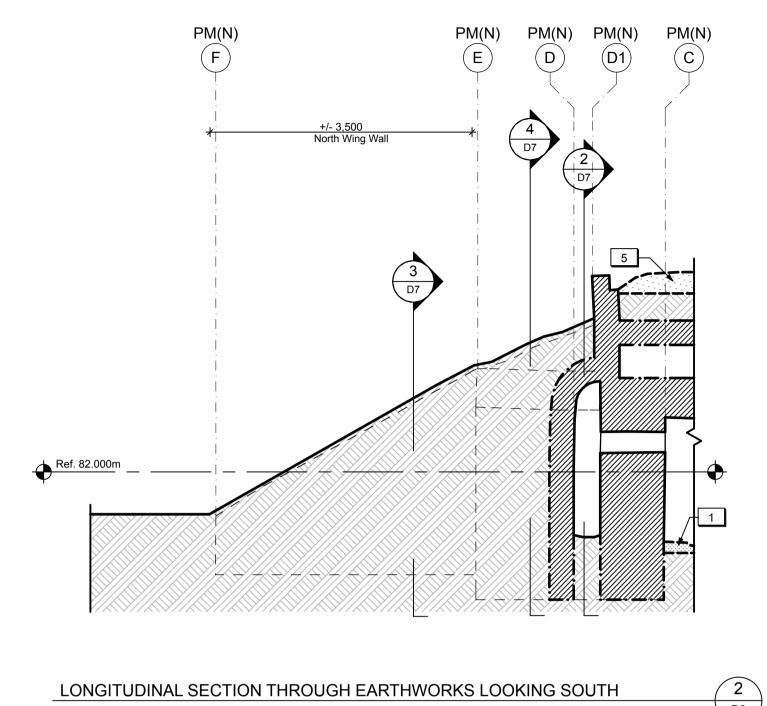


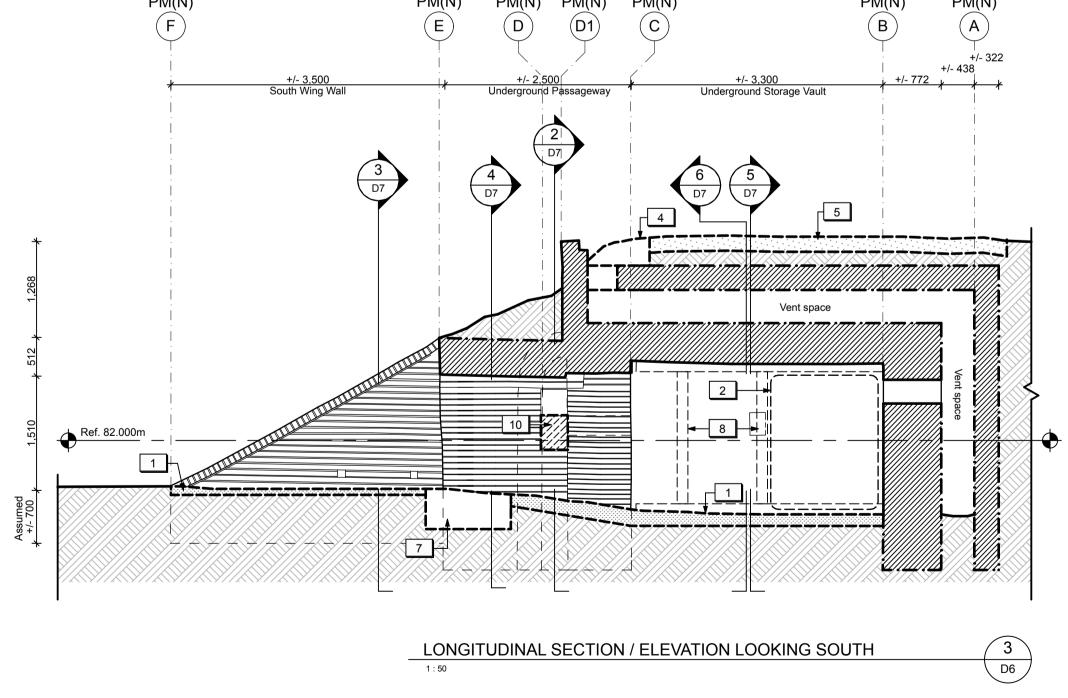

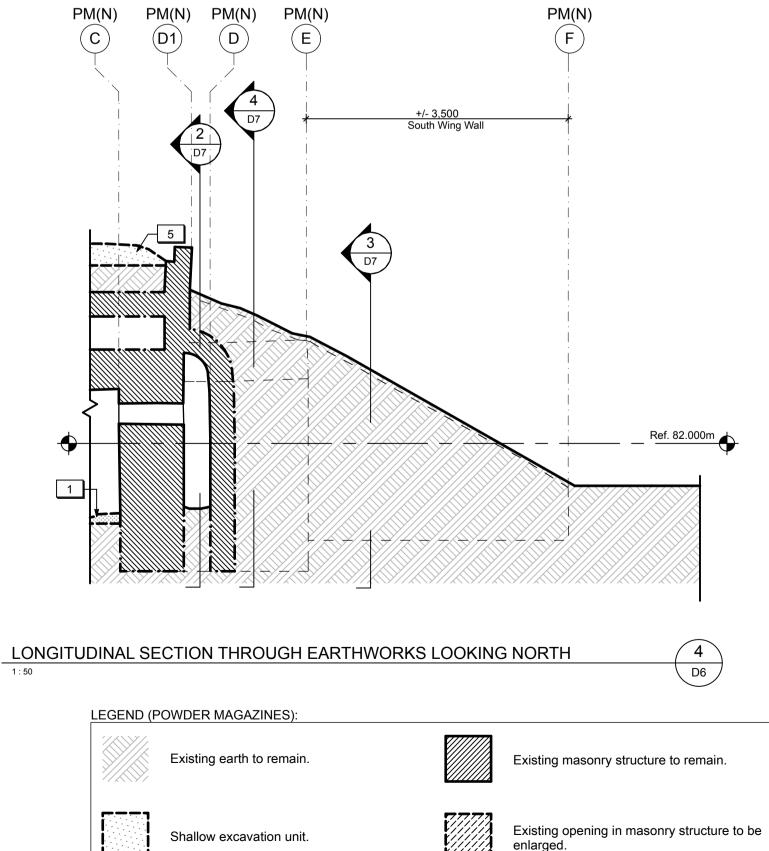

Deep excavation unit. Provide temporary

shoring as required.

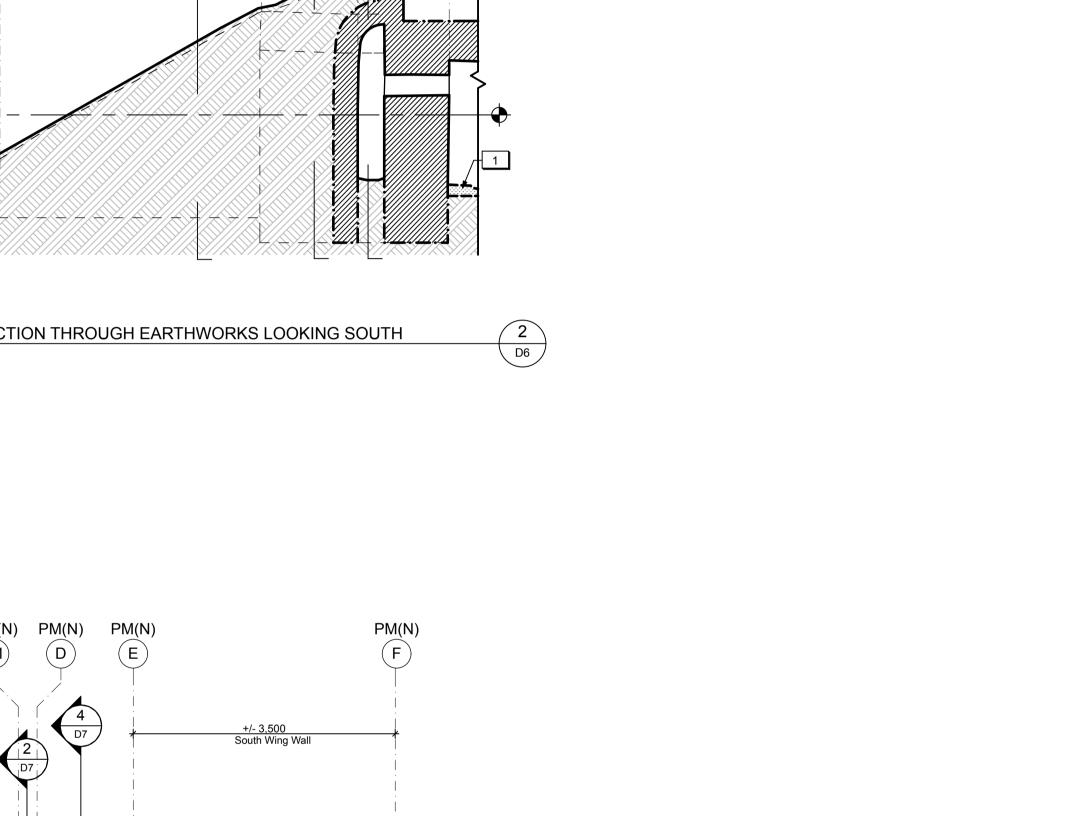

DRAWING NOTES (POWDER MAGAZINES):

Architectural.

Existing turf / soil to be excavated throughout Passageway and Storage Vault to a maximum of 150 mm deep. Refer to Landscape.

Existing stockpiled brick in North Powder Magazine to be removed/stored.

Existing turf / soil to be excavated to expose area of masonry failure in the outer vault structure.

Existing turf / soil to be excavated over underground storage vault to a maximum of 200mm deep. Refer to Landscape.

Existing soil to be excavated for new concrete strut beam below grade.

Existing wood shoring to be removed. Provide temporary support during excavation work.

Existing openings in the inner masonry structure to be

Existing turf / soil to be excavated to expose existing masonry vent shafts.

enlarged to improve ventilation within the vent spaces. Refer to



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A Numero de detail B Sur feuille numero

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FORT MISSISSAUGA STABILIZATION

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PHASE II

POWDER MAGAZINE (NORTH) - SECTIONS & **ELEVATIONS 1**


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LEGEND

Linework indicating assumptions and/or information based on previous record drawings.

1:50



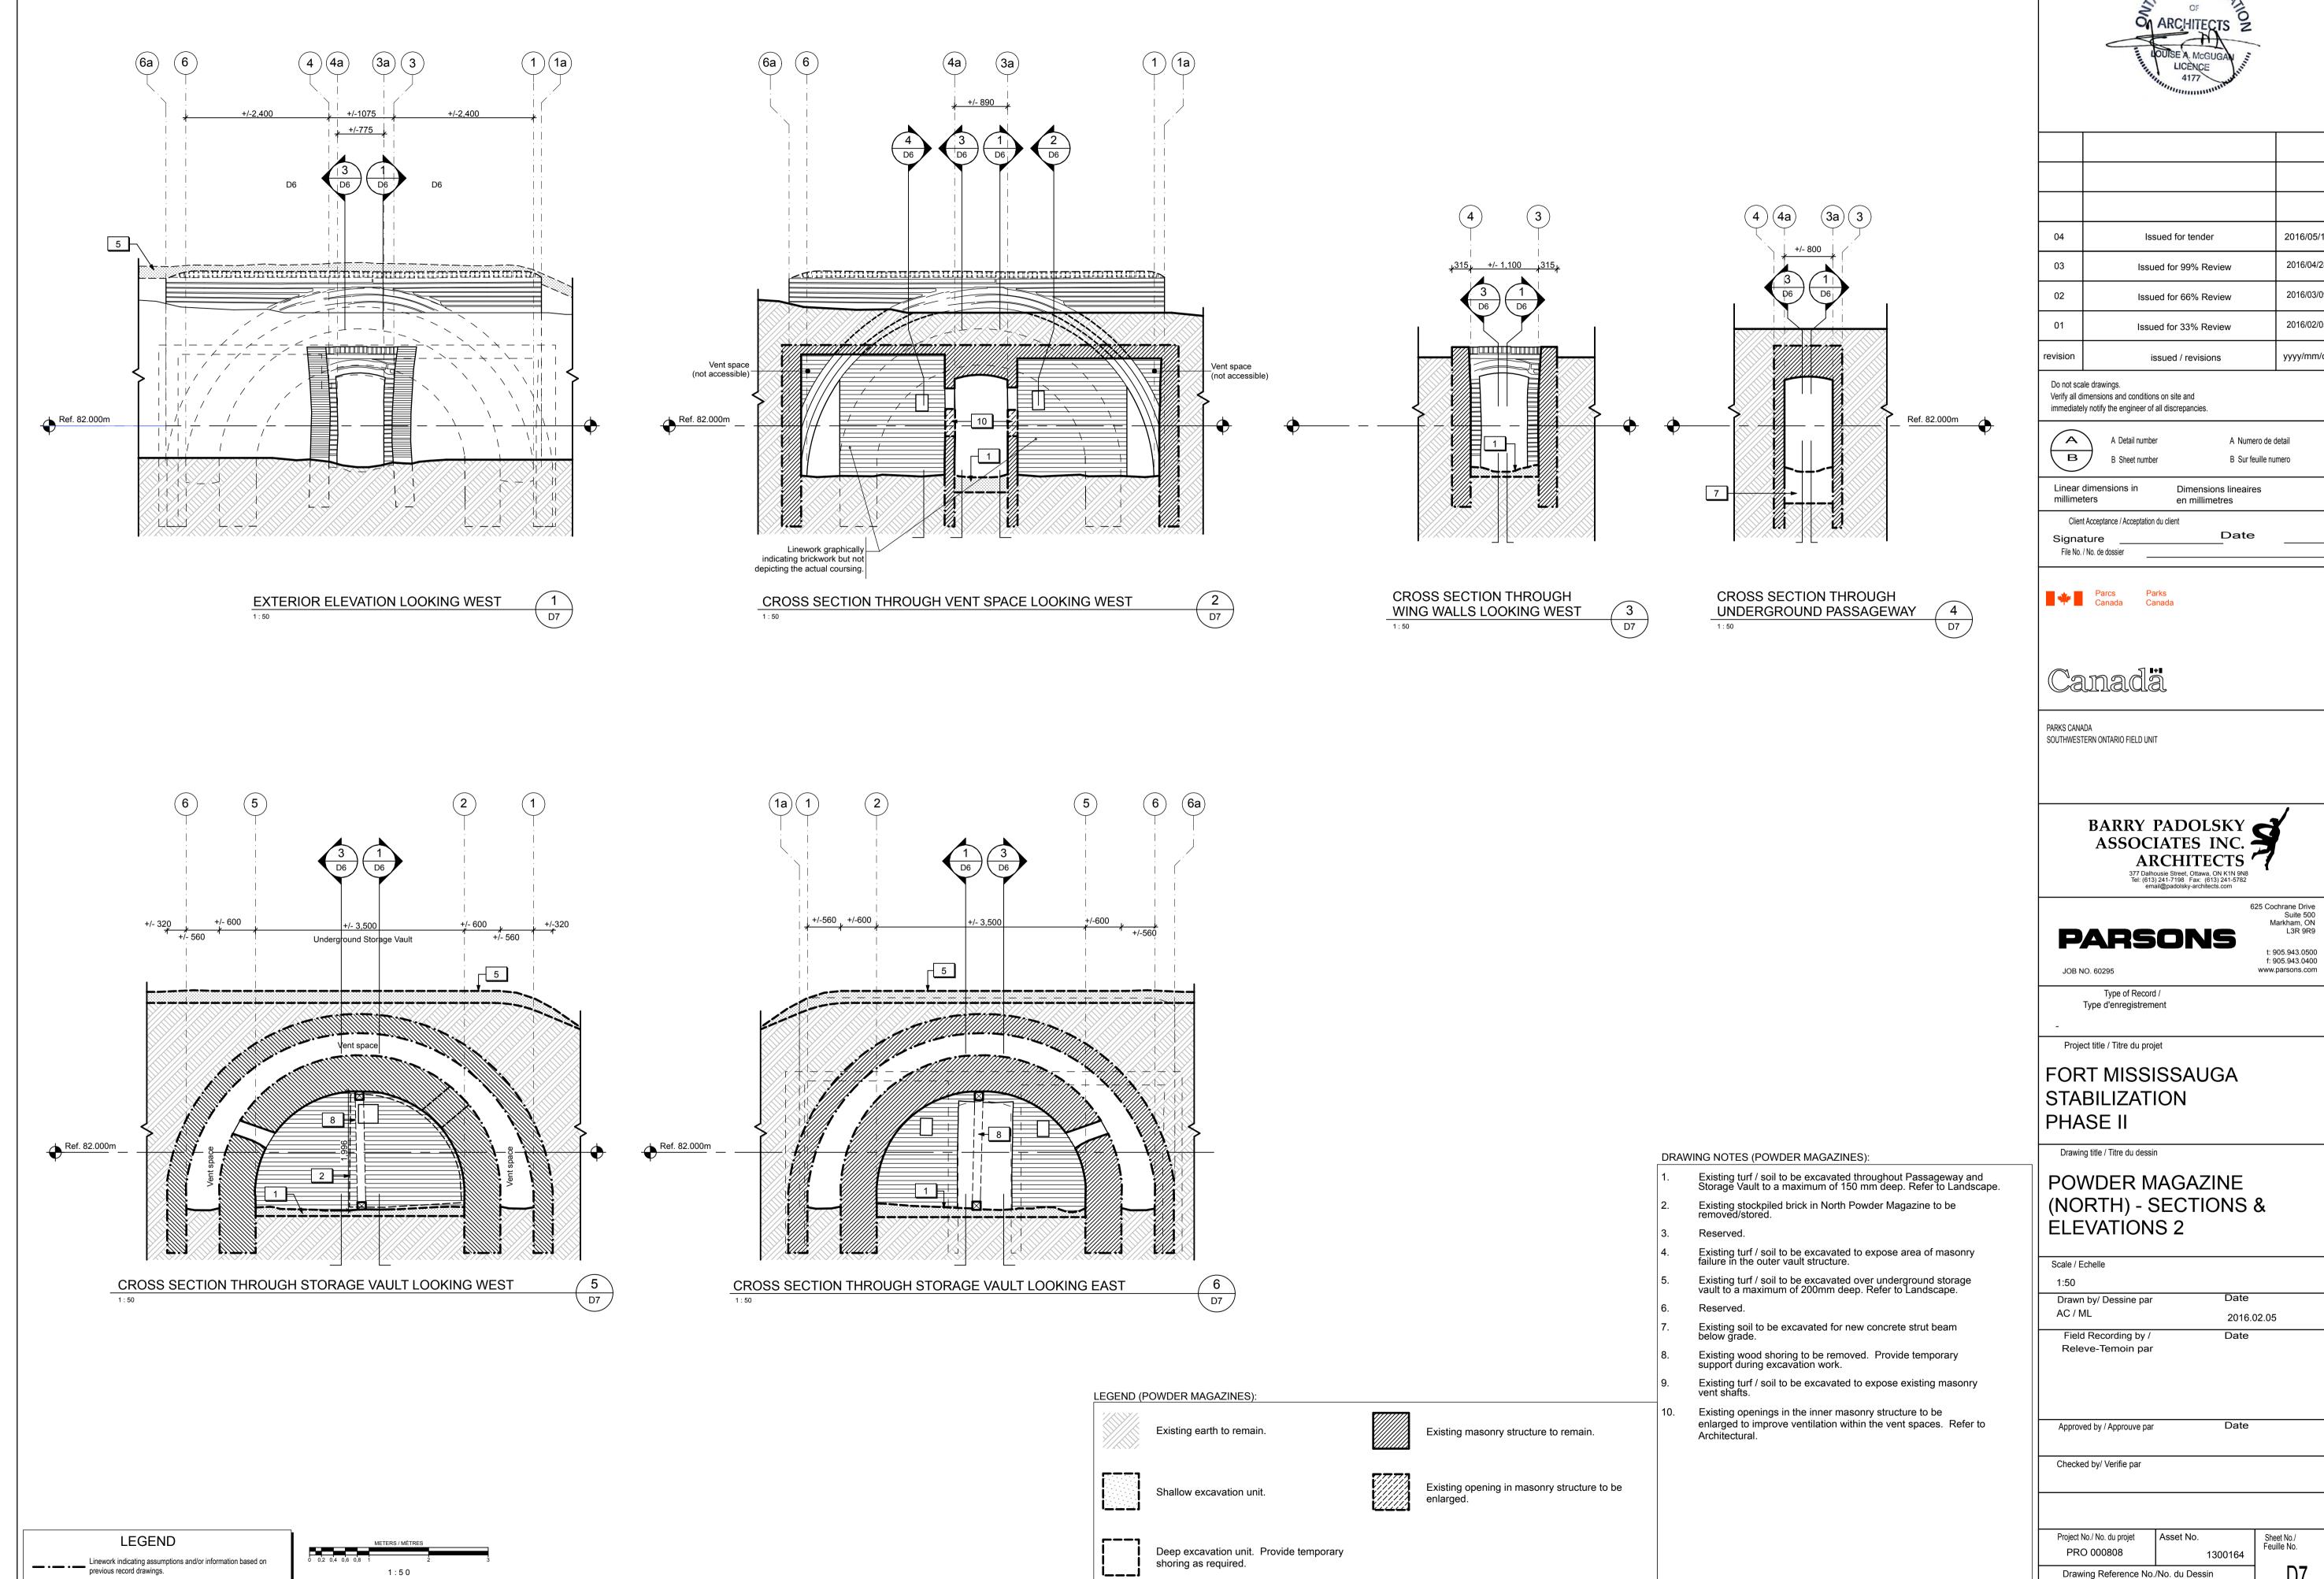


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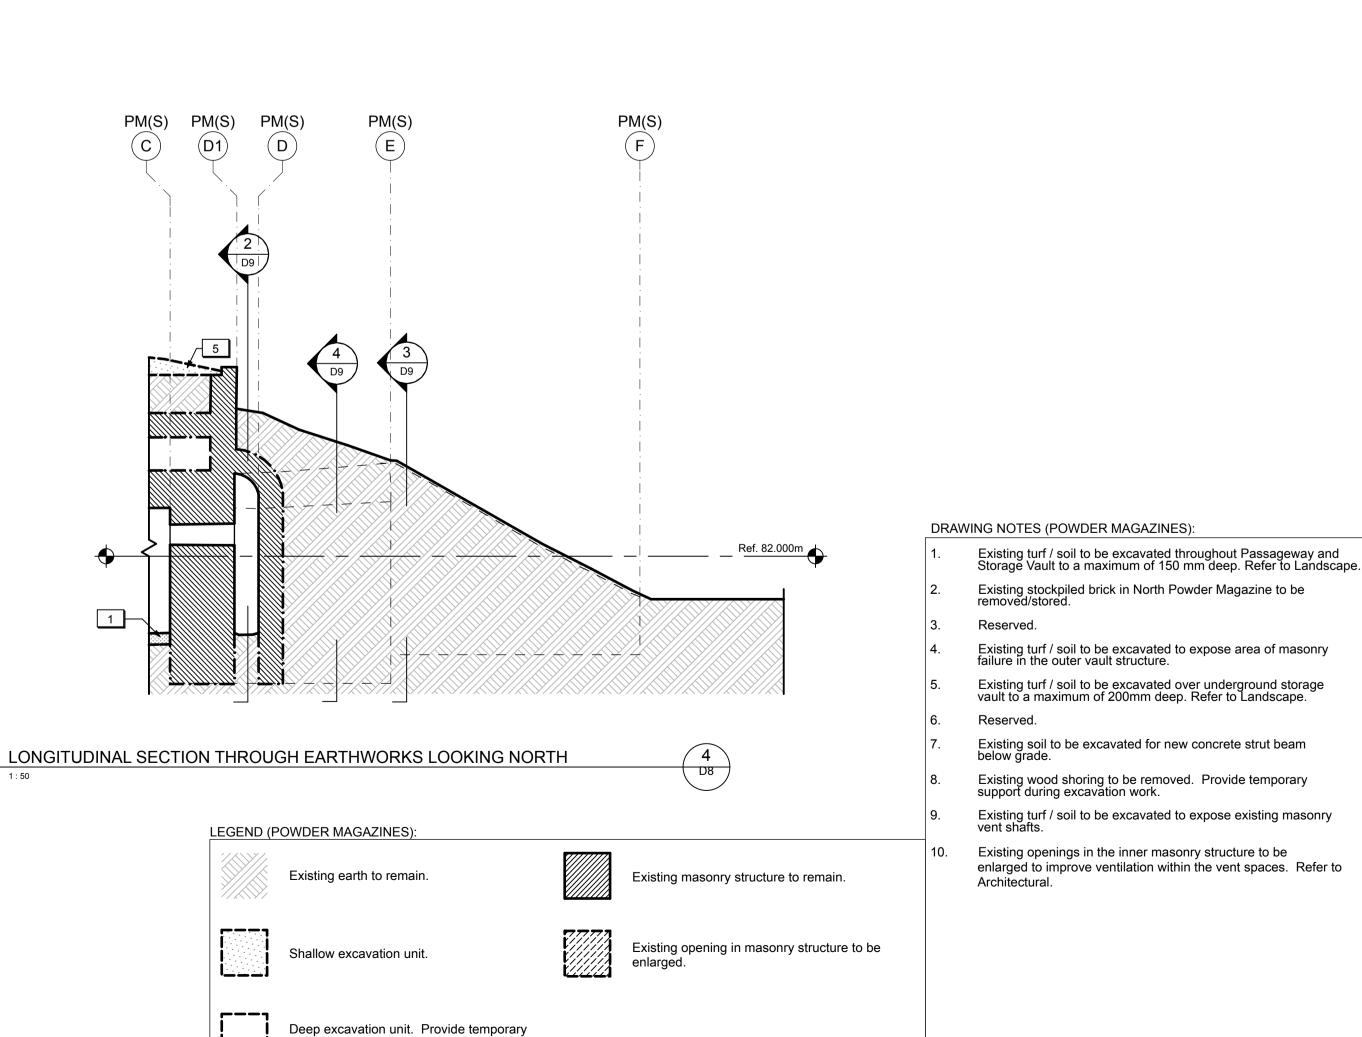
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(NORTH) - SECTIONS &

2016.02.05





shoring as required.

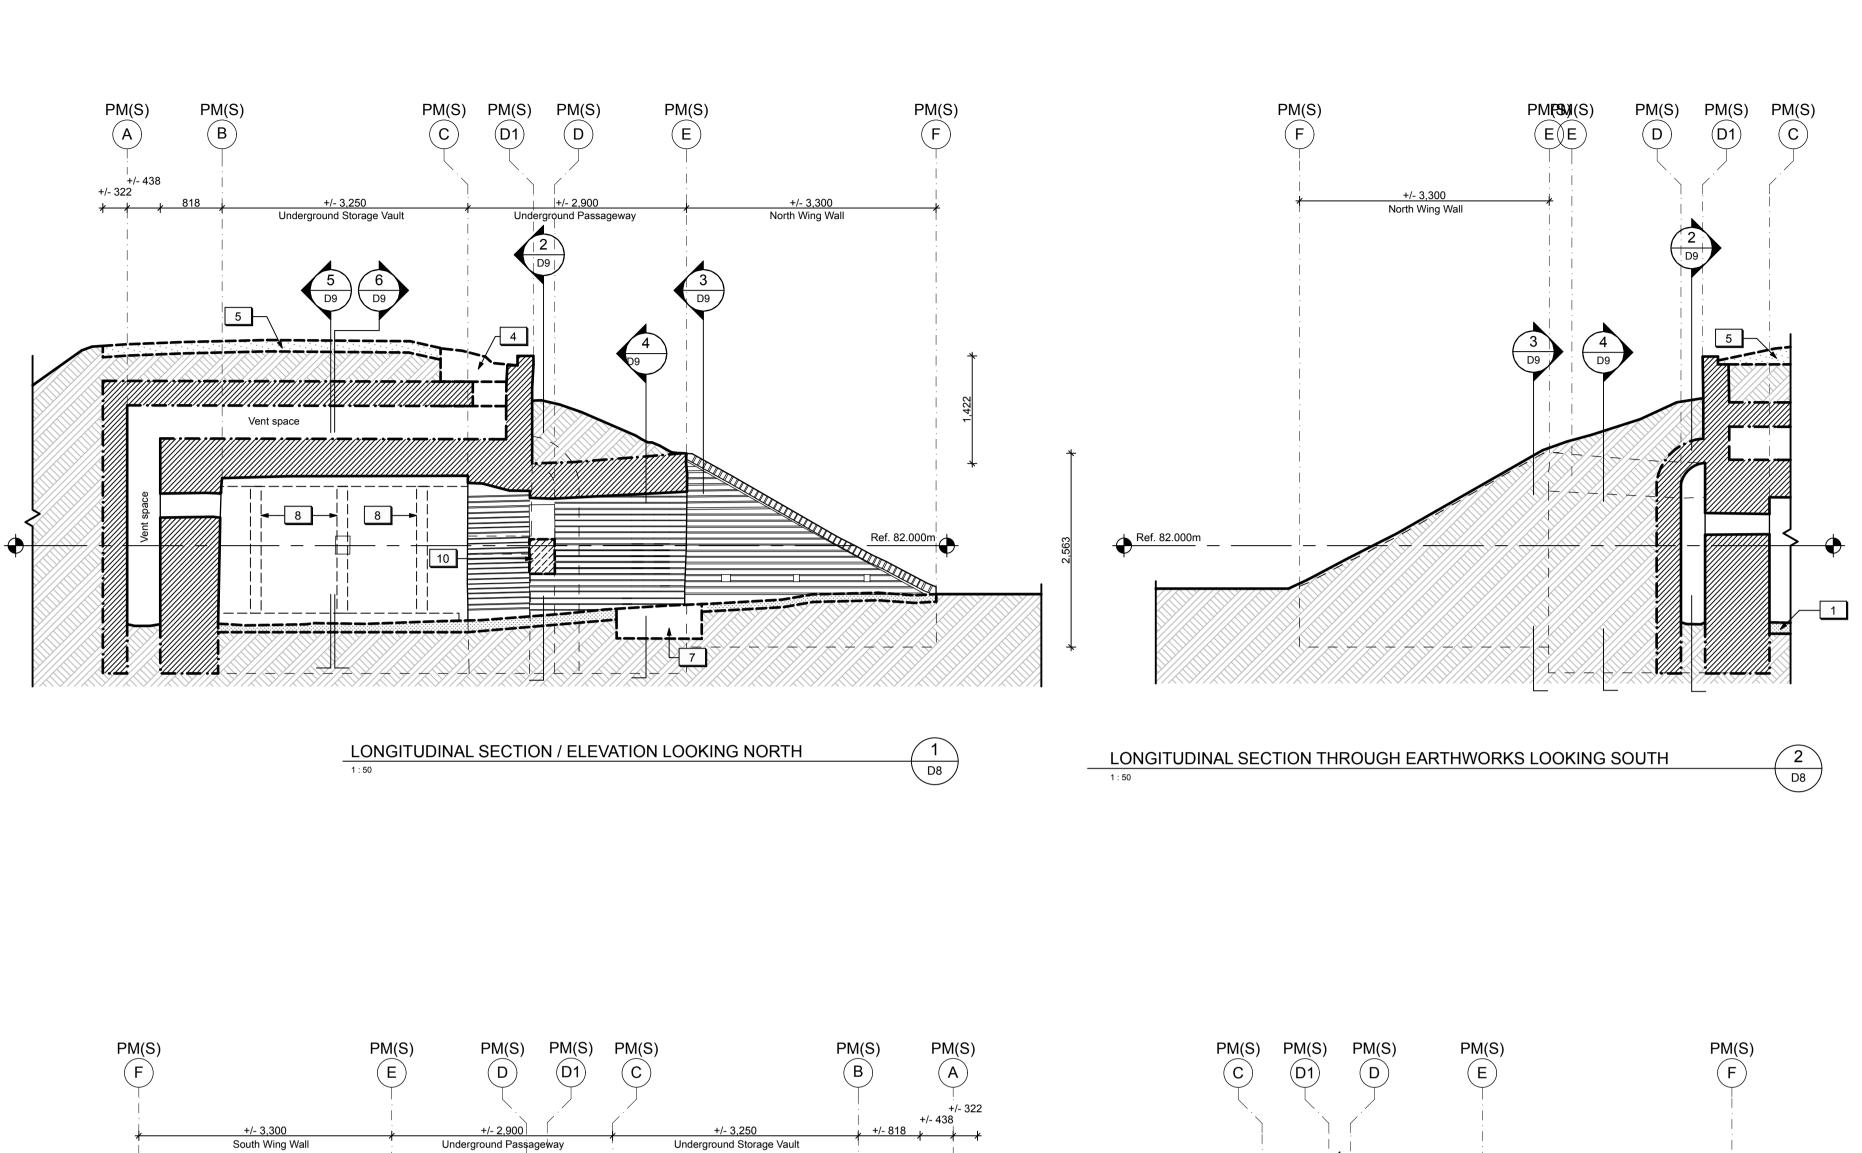

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POWDER MAGAZINE (SOUTH) - SECTIONS & **ELEVATIONS 1**

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LEGEND

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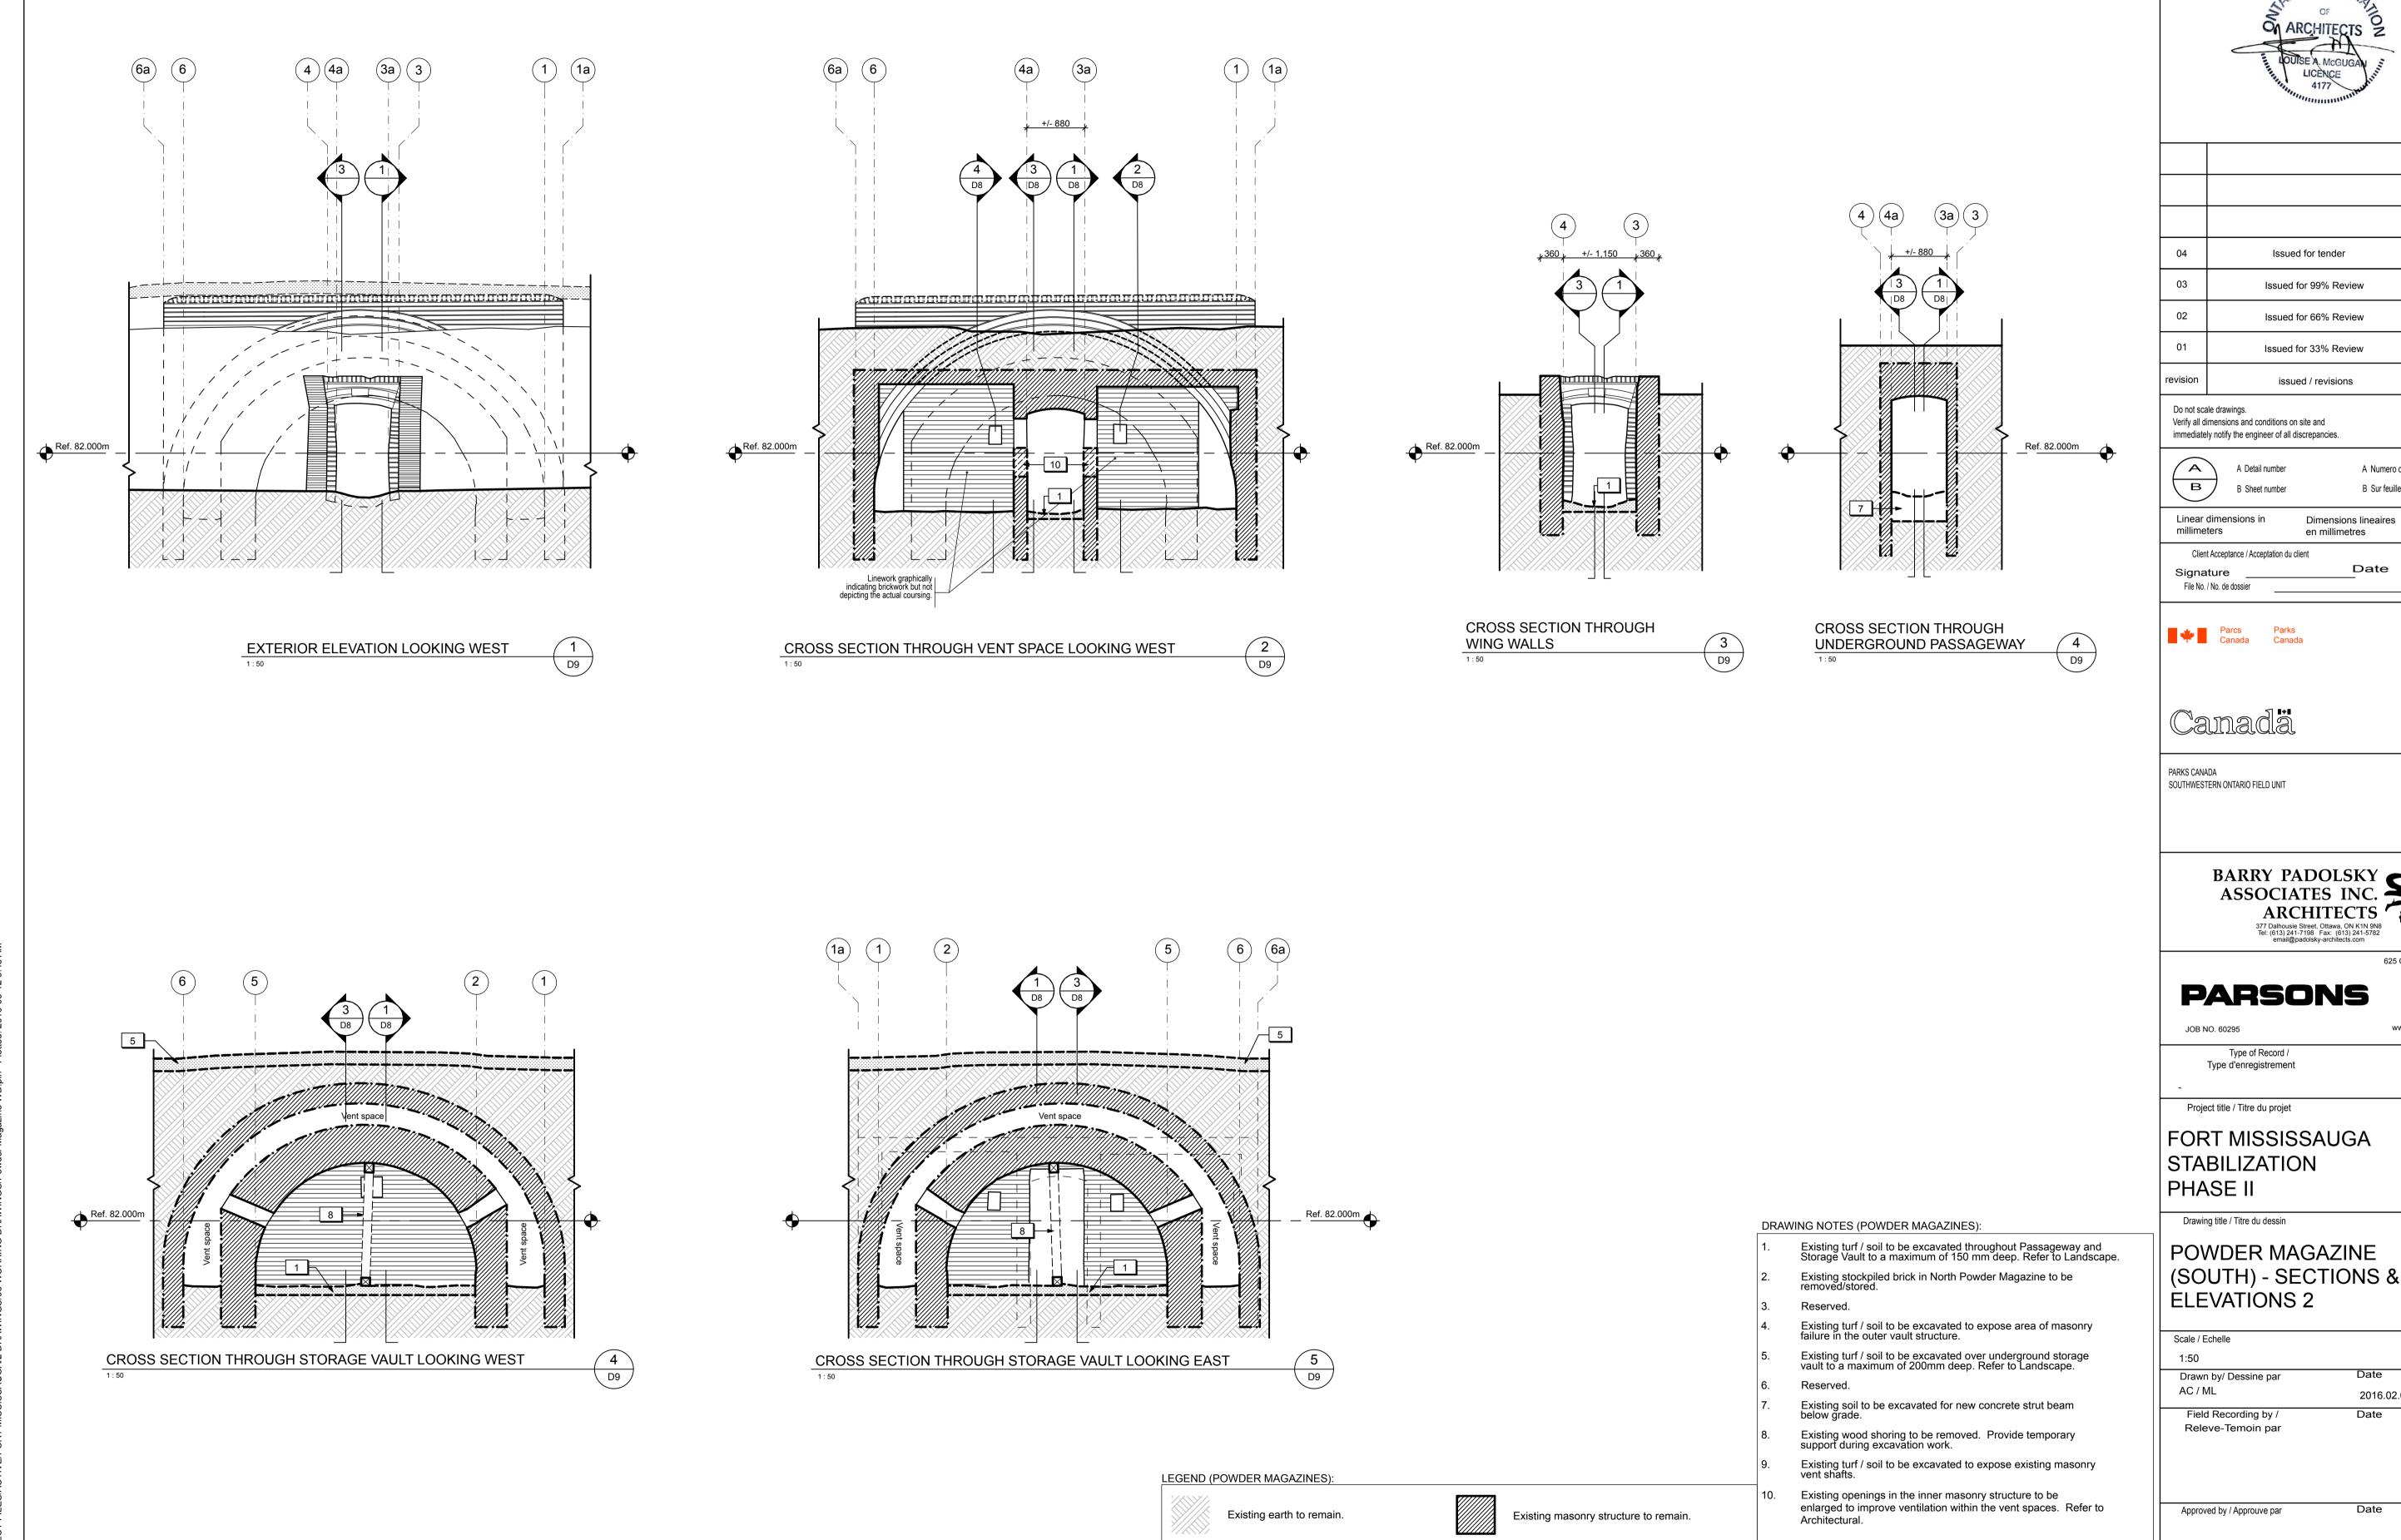
Underground Passageway

Underground Storage Vault

8

LONGITUDINAL SECTION / ELEVATION LOOKING SOUTH

Vent space



Shallow excavation unit.

shoring as required.

Deep excavation unit. Provide temporary

LEGEND

Linework indicating assumptions and/or information based on previous record drawings.

Existing opening in masonry structure to be

2016/05/12 2016/04/28 2016/03/09 2016/02/05 yyyy/mm/dd

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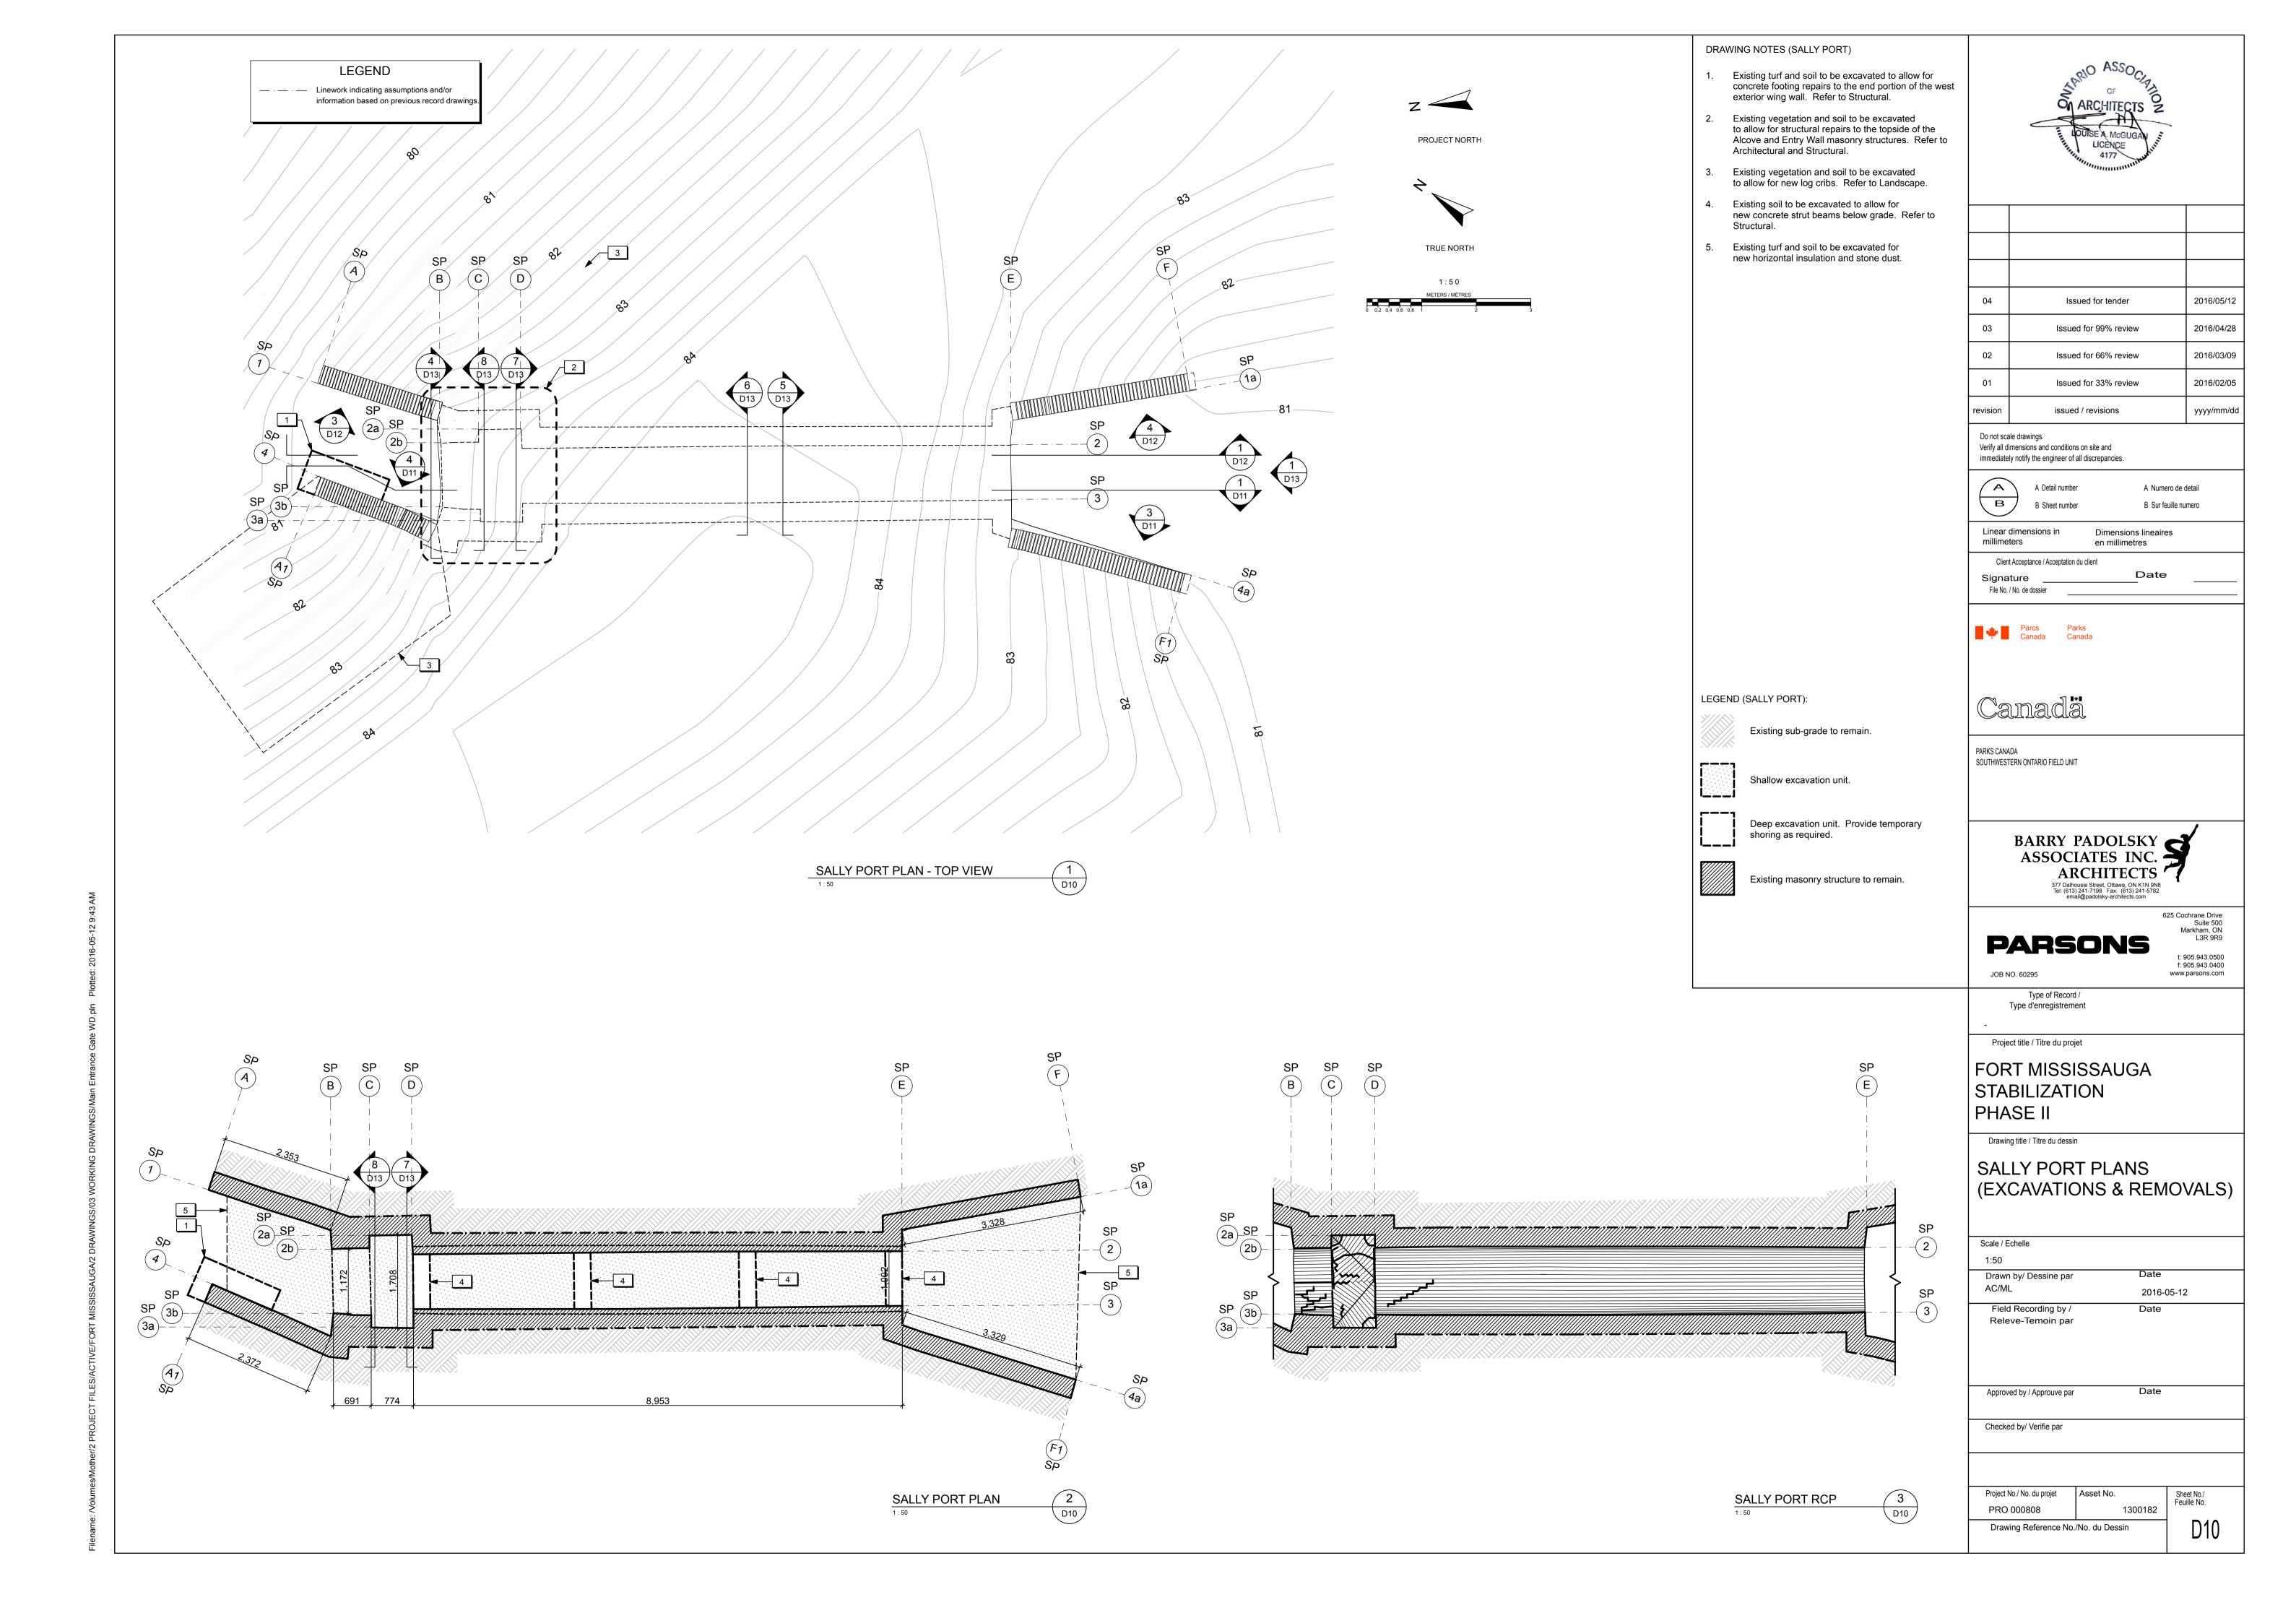
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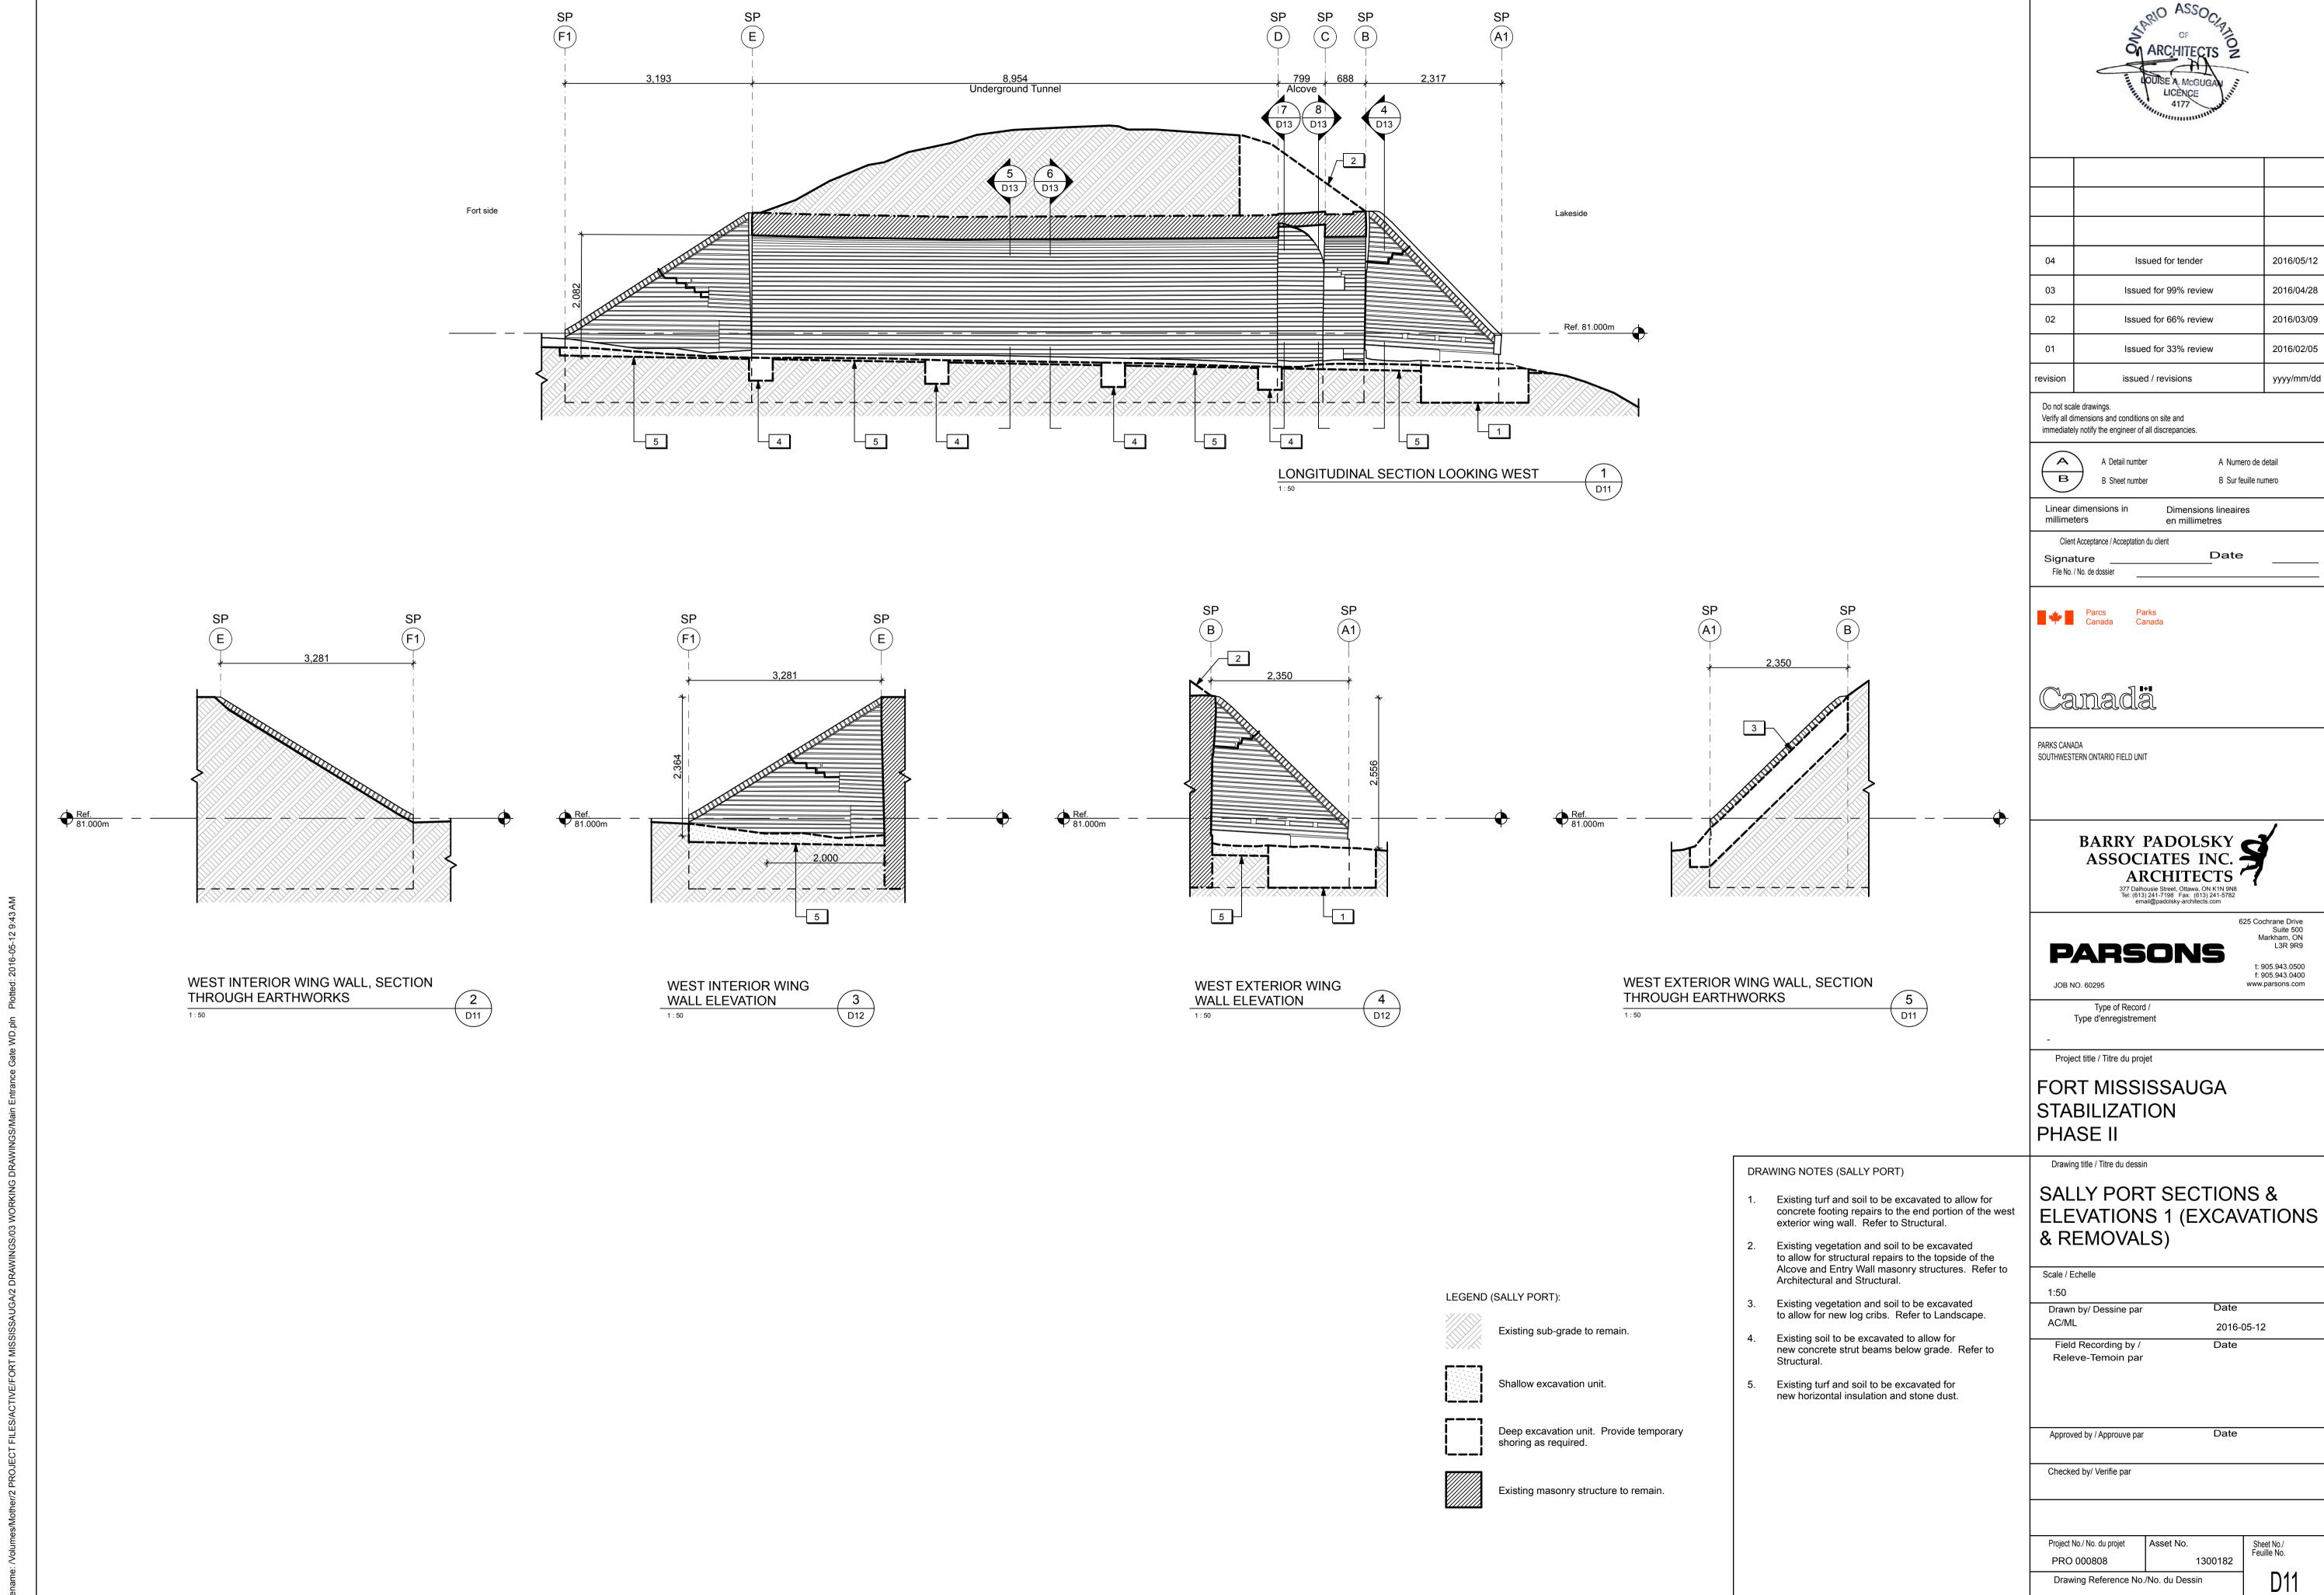
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POWDER MAGAZINE (SOUTH) - SECTIONS &


2016.02.05 Date


PRO 000808






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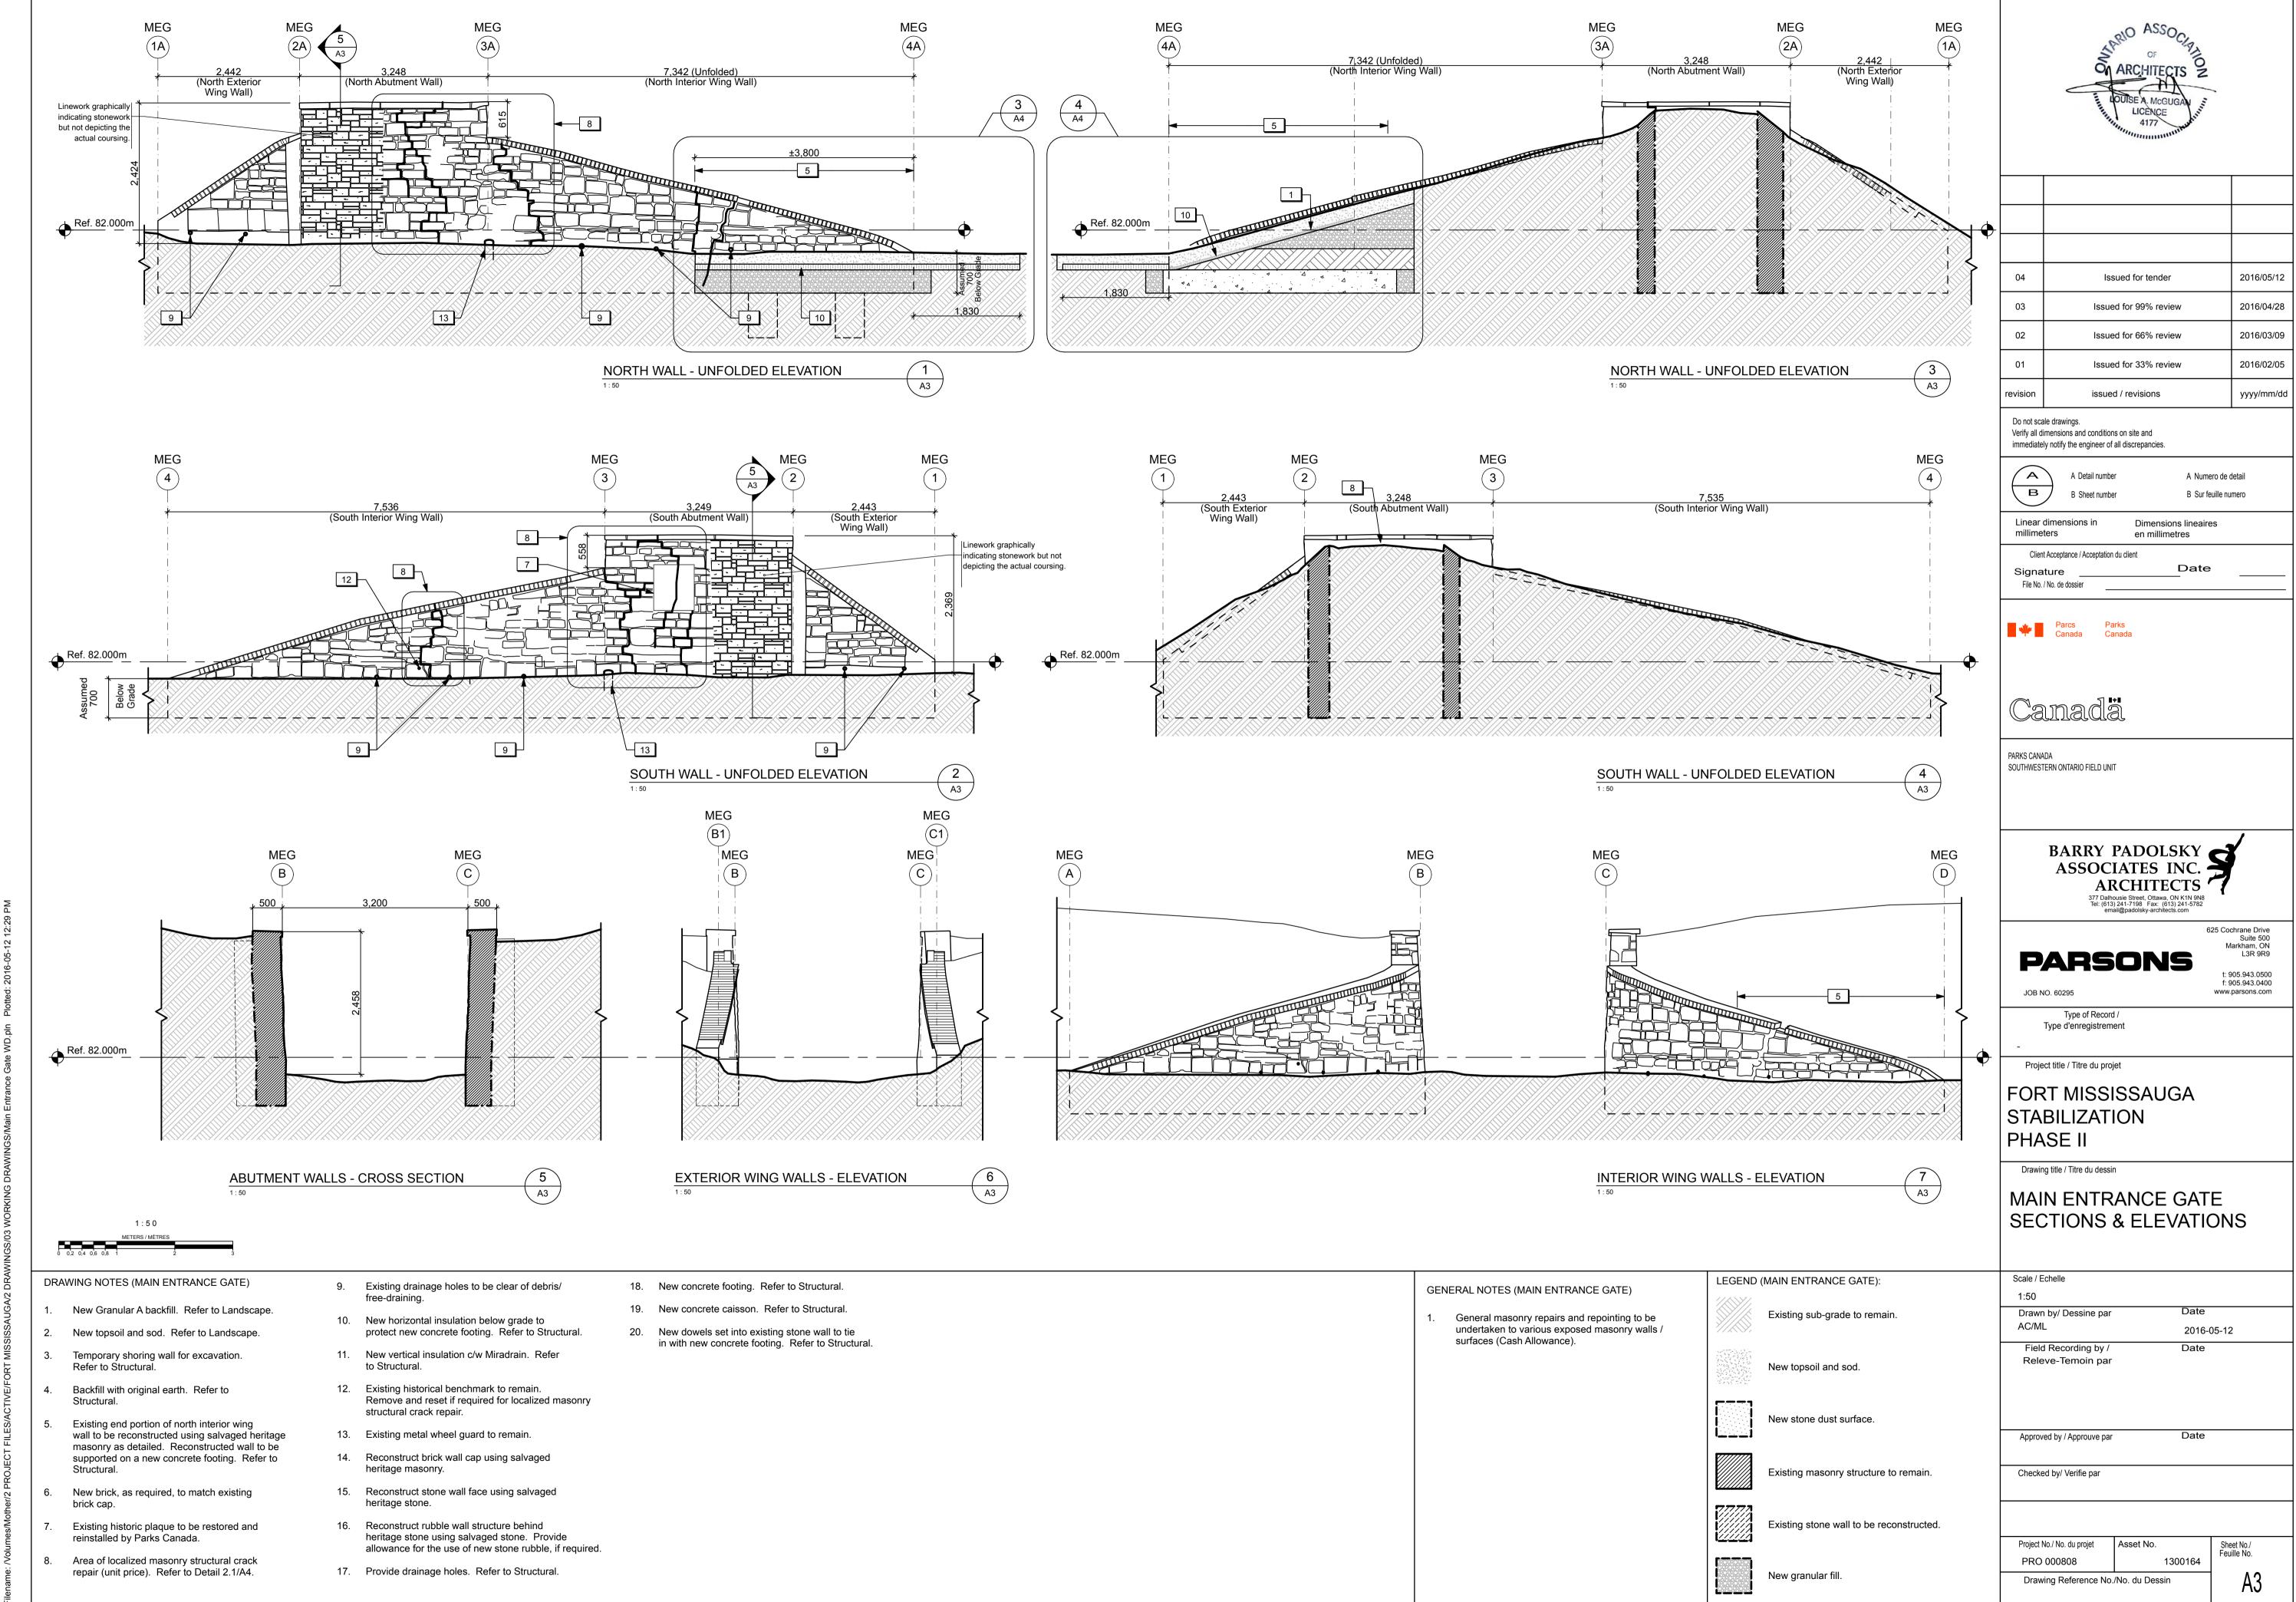


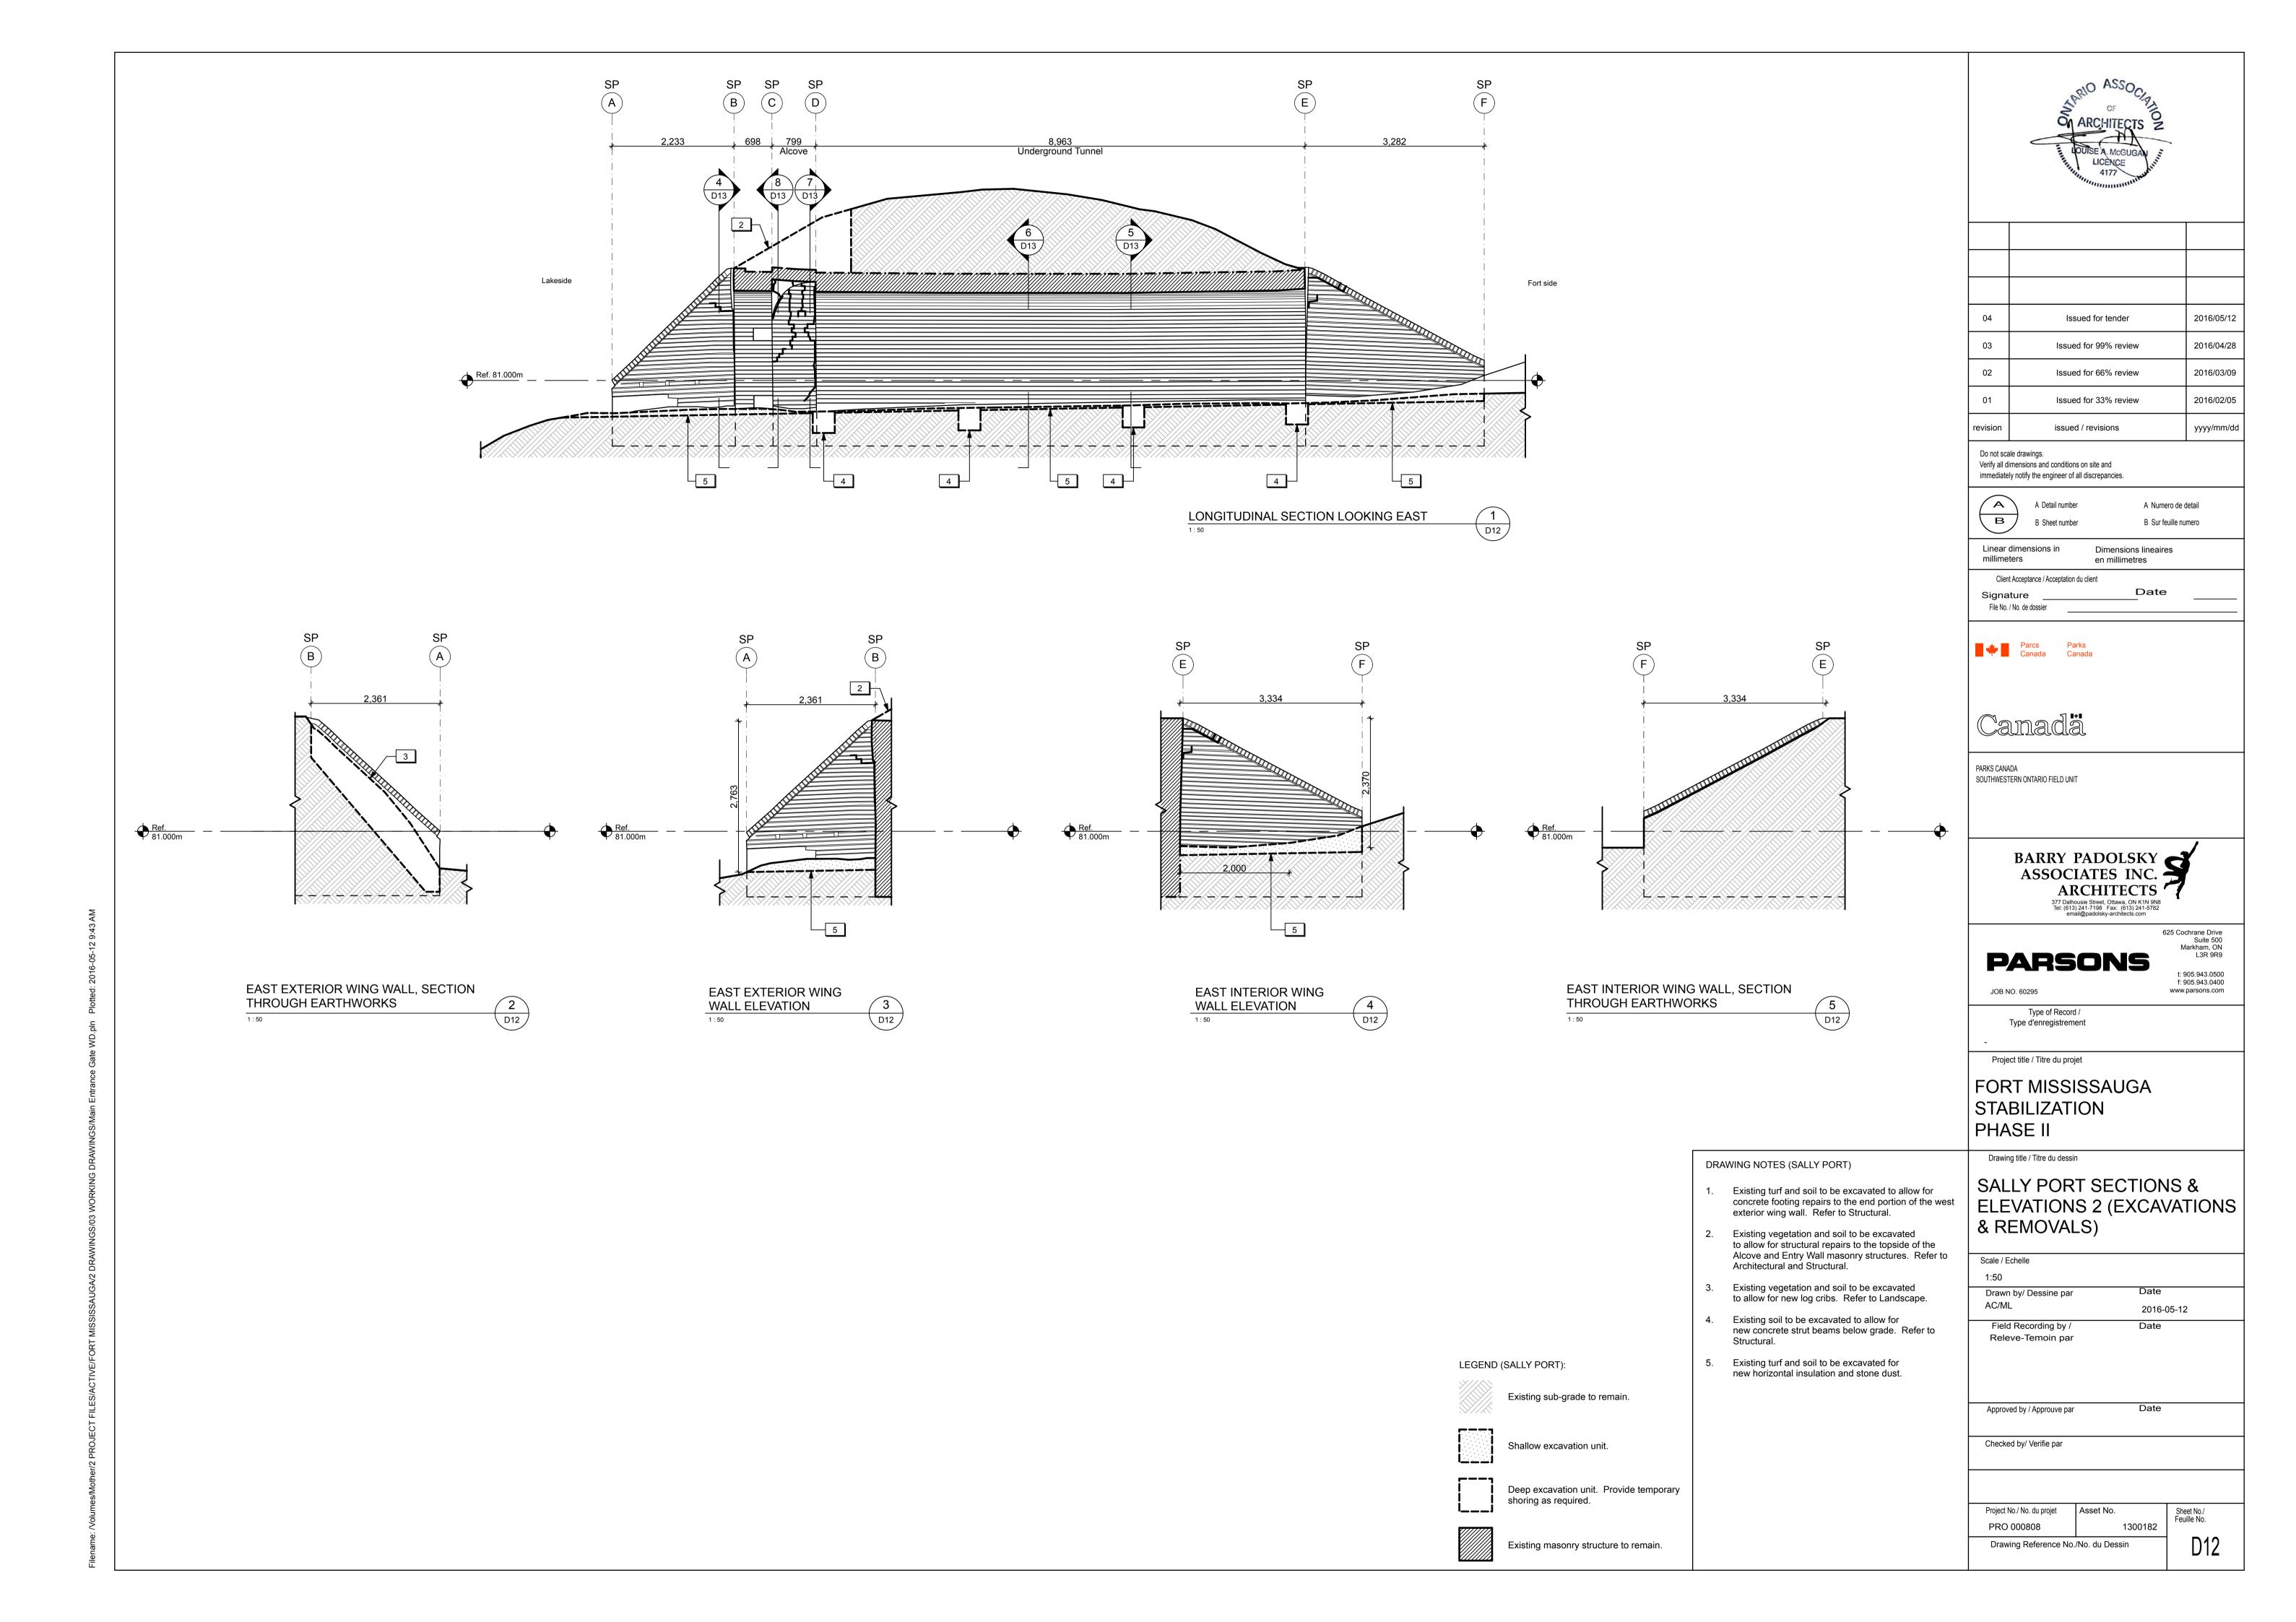


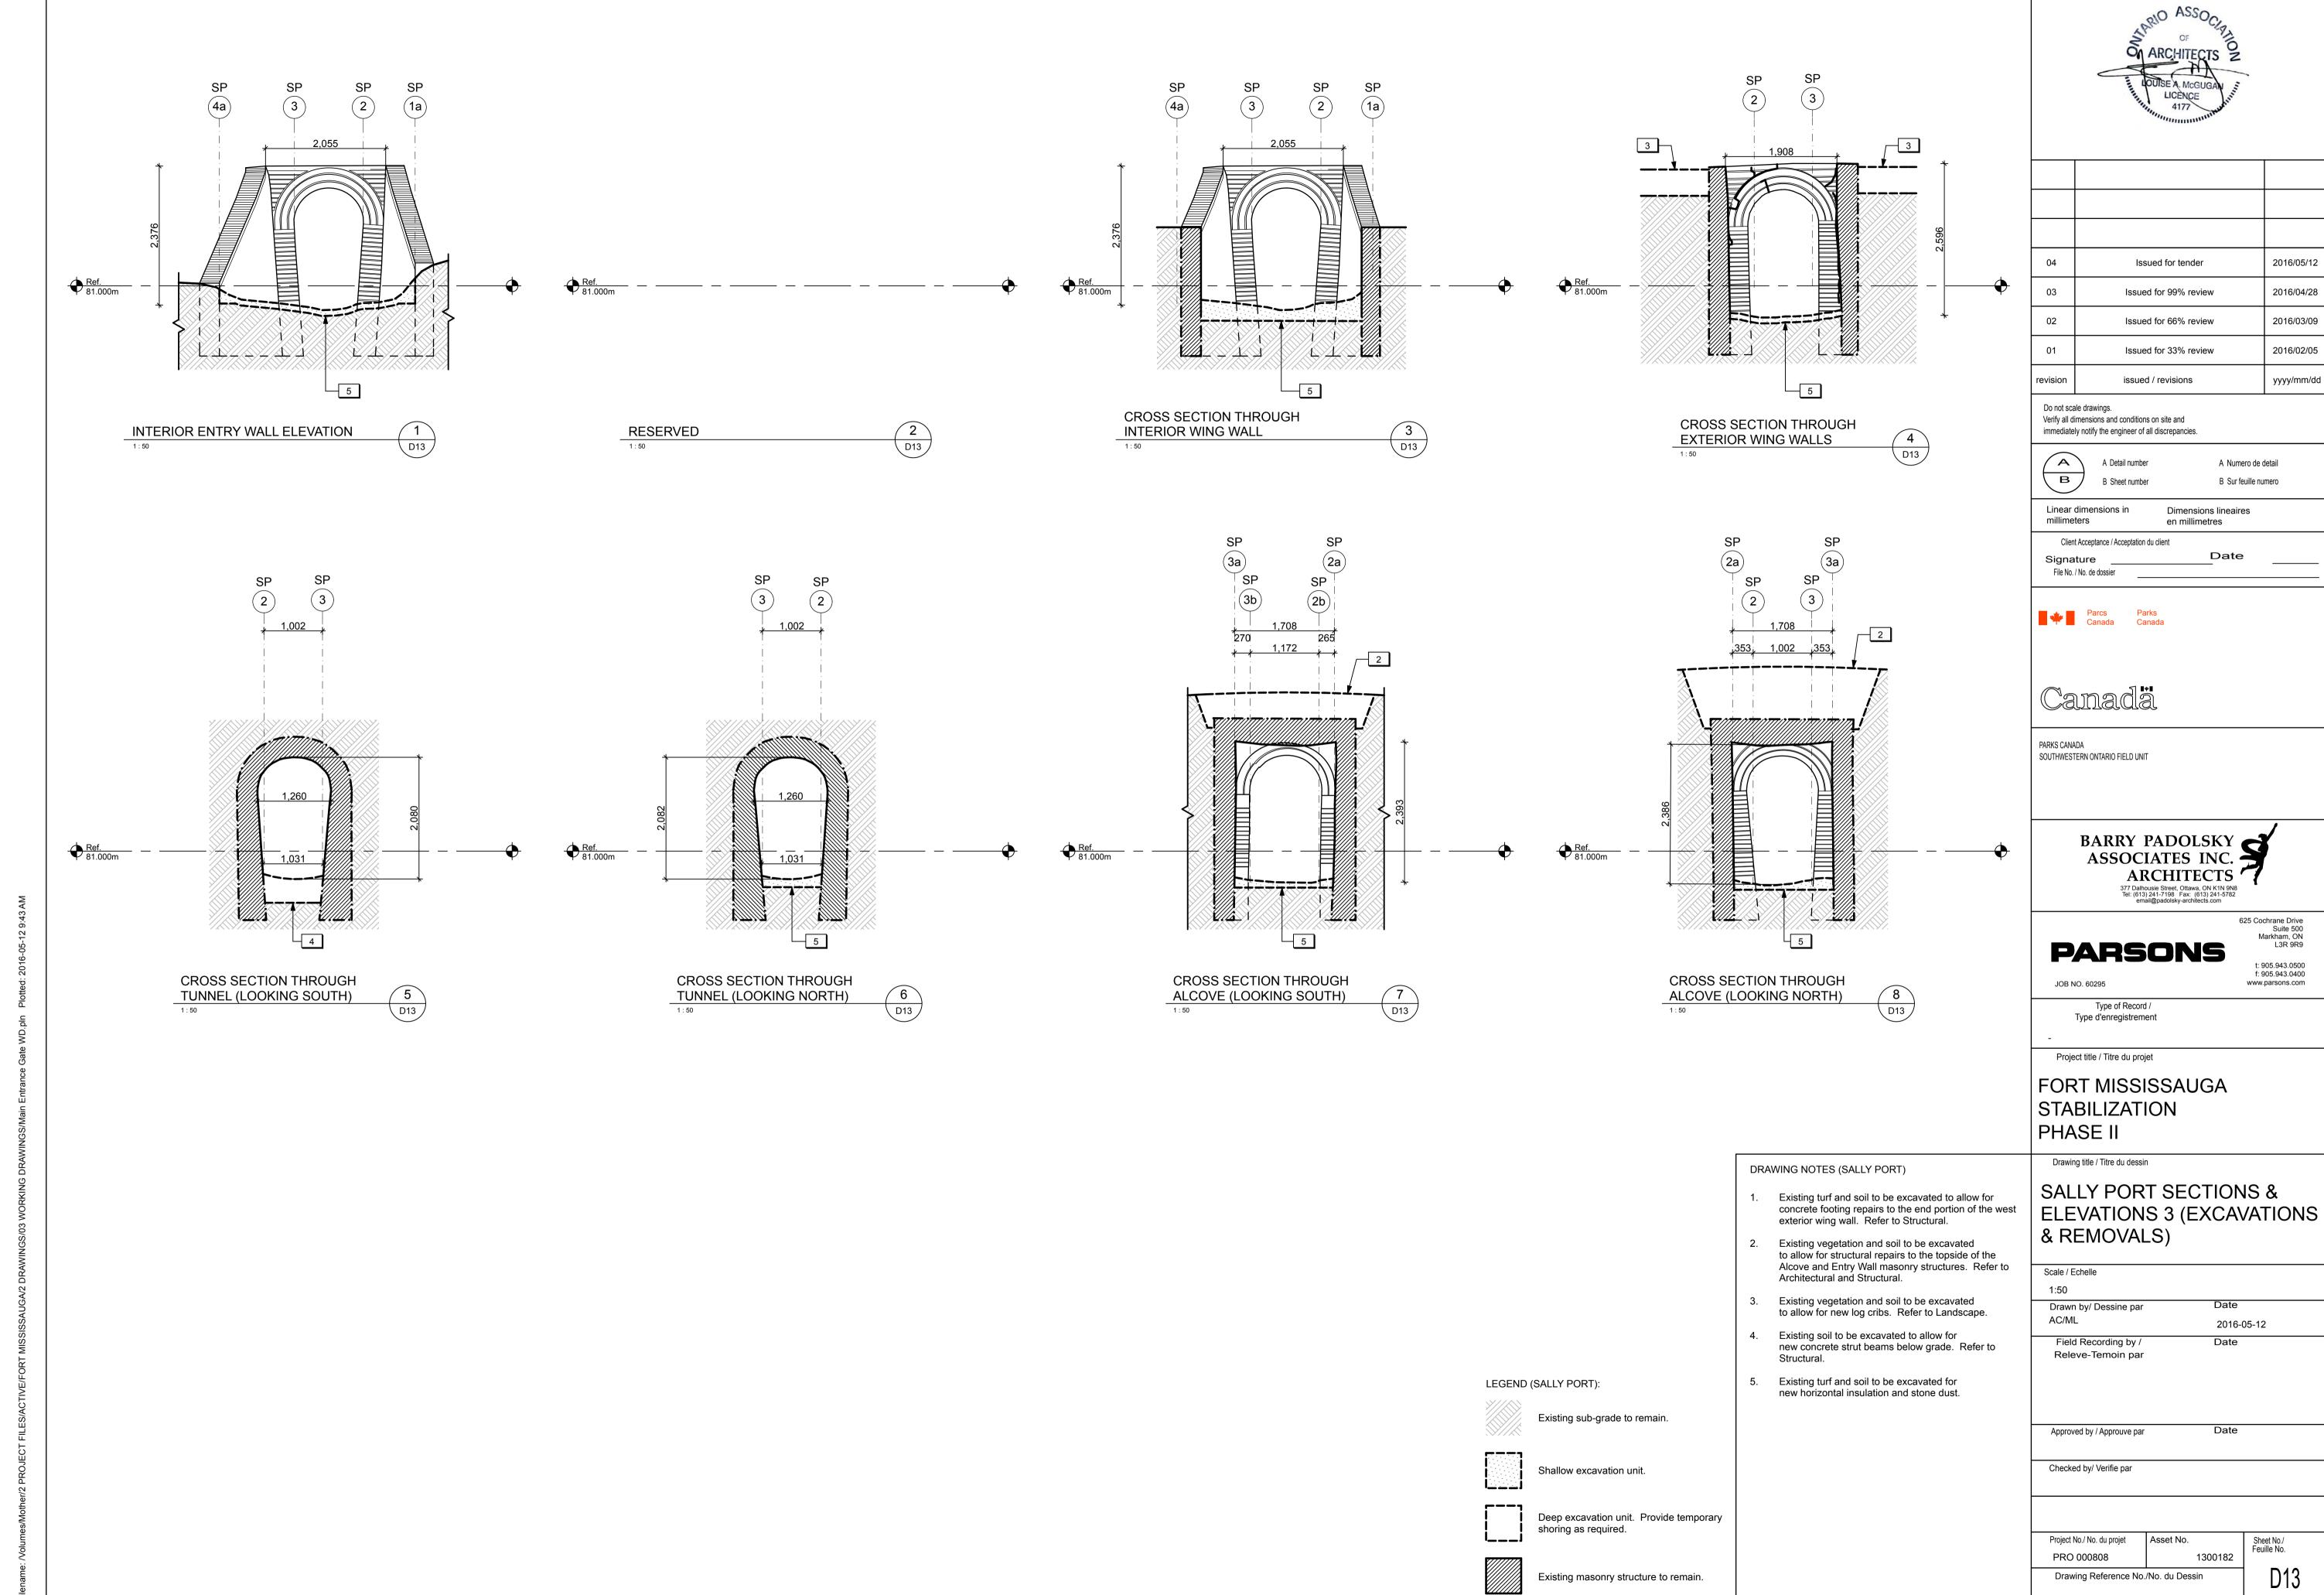


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POWDER MAGAZINE (NORTH) - PLANS


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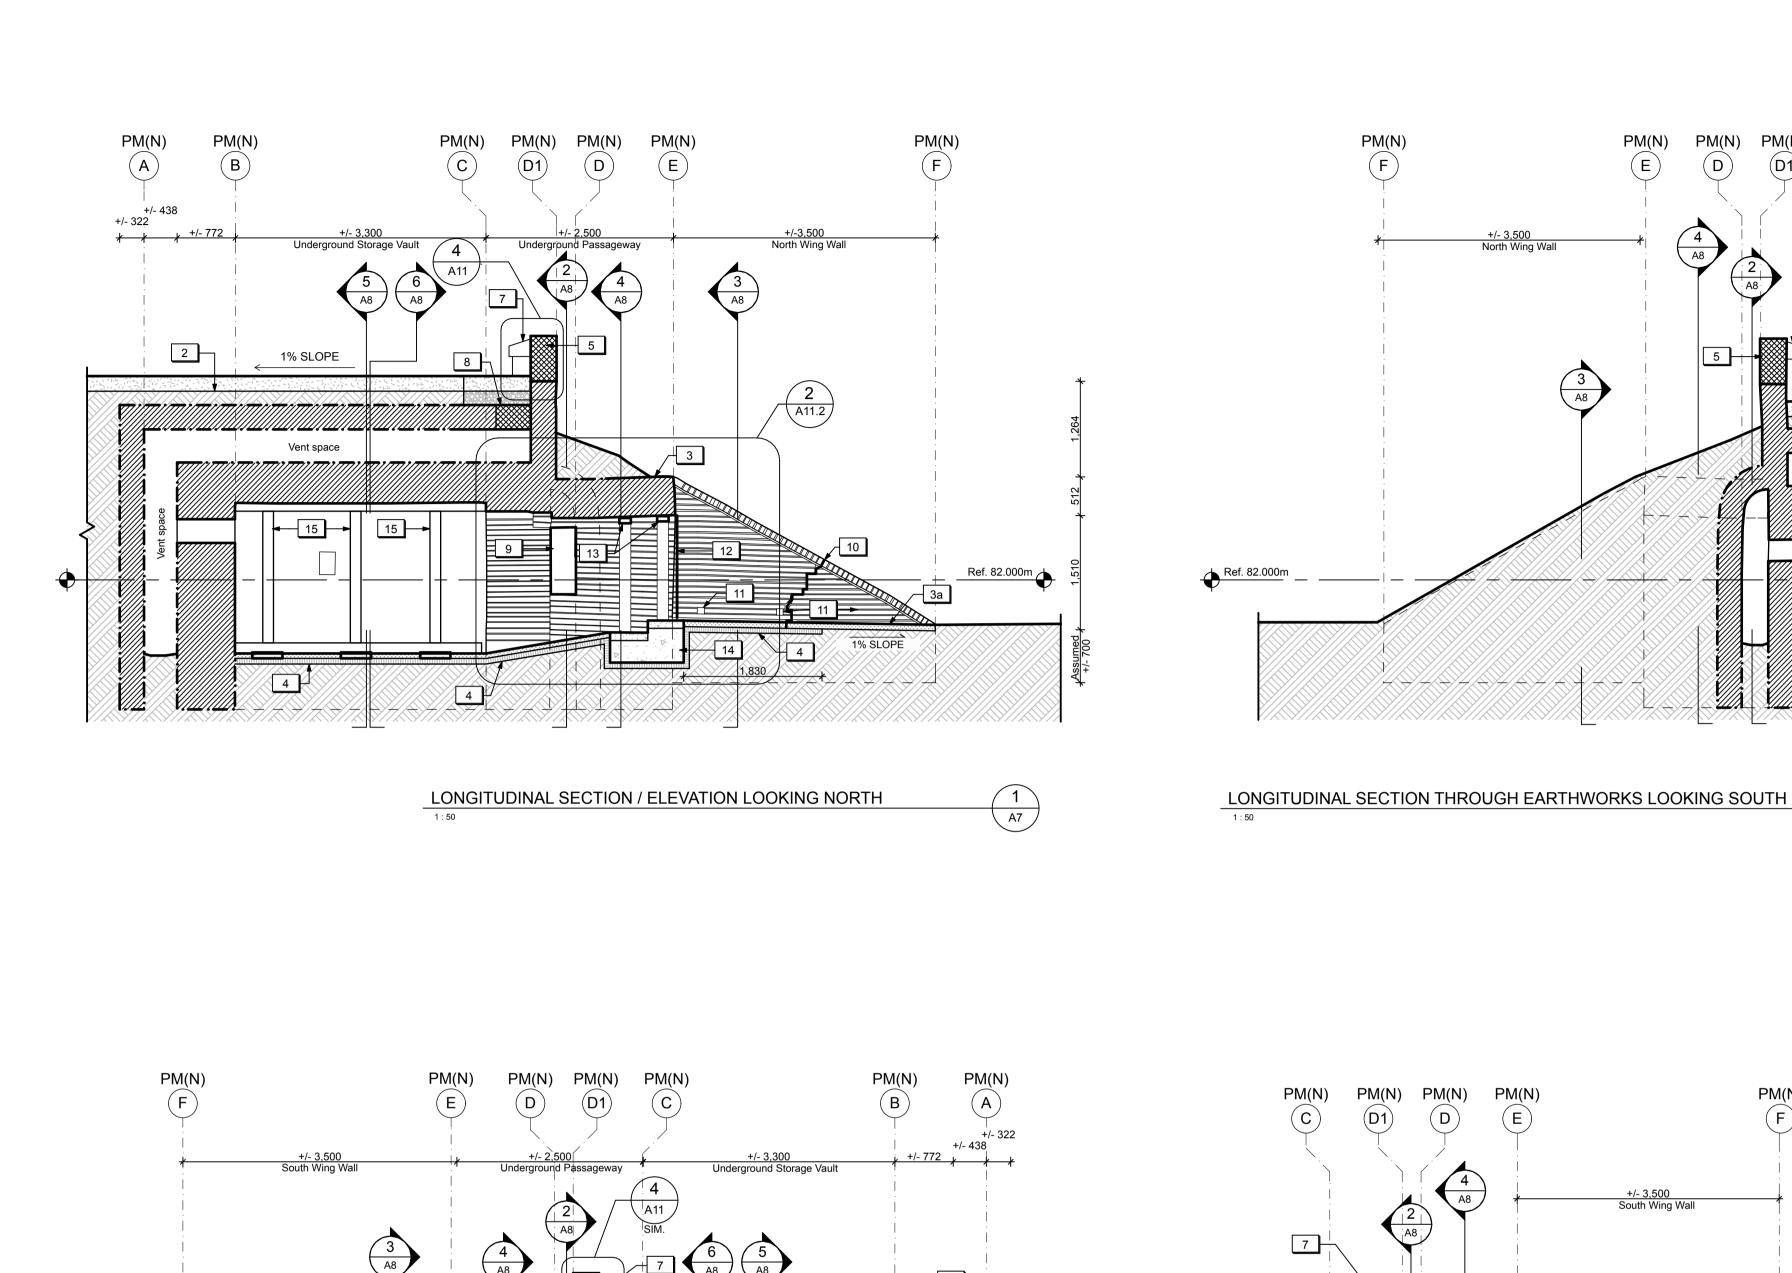
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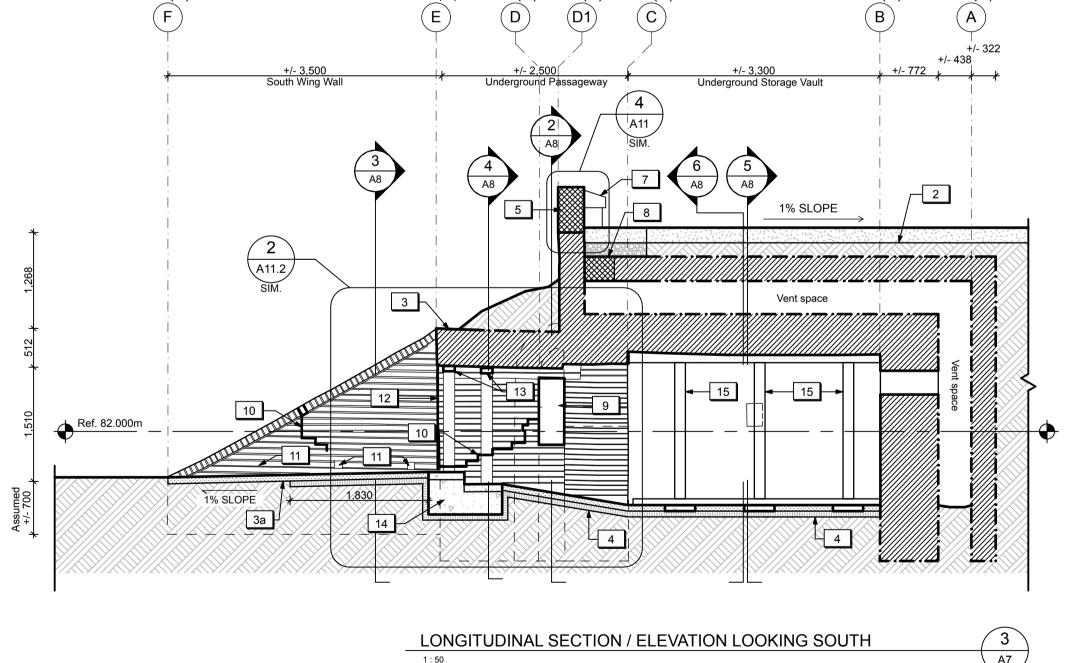
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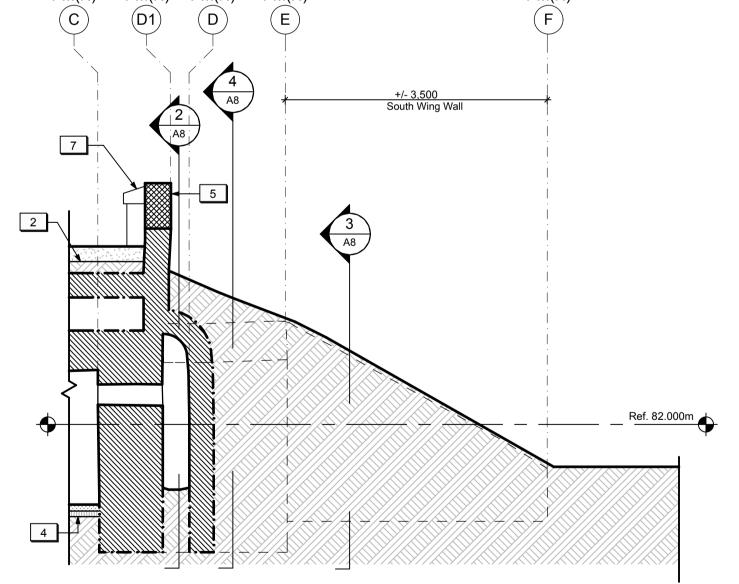
POWDER MAGAZINE (NORTH) - SECTIONS & **ELEVATIONS 1**
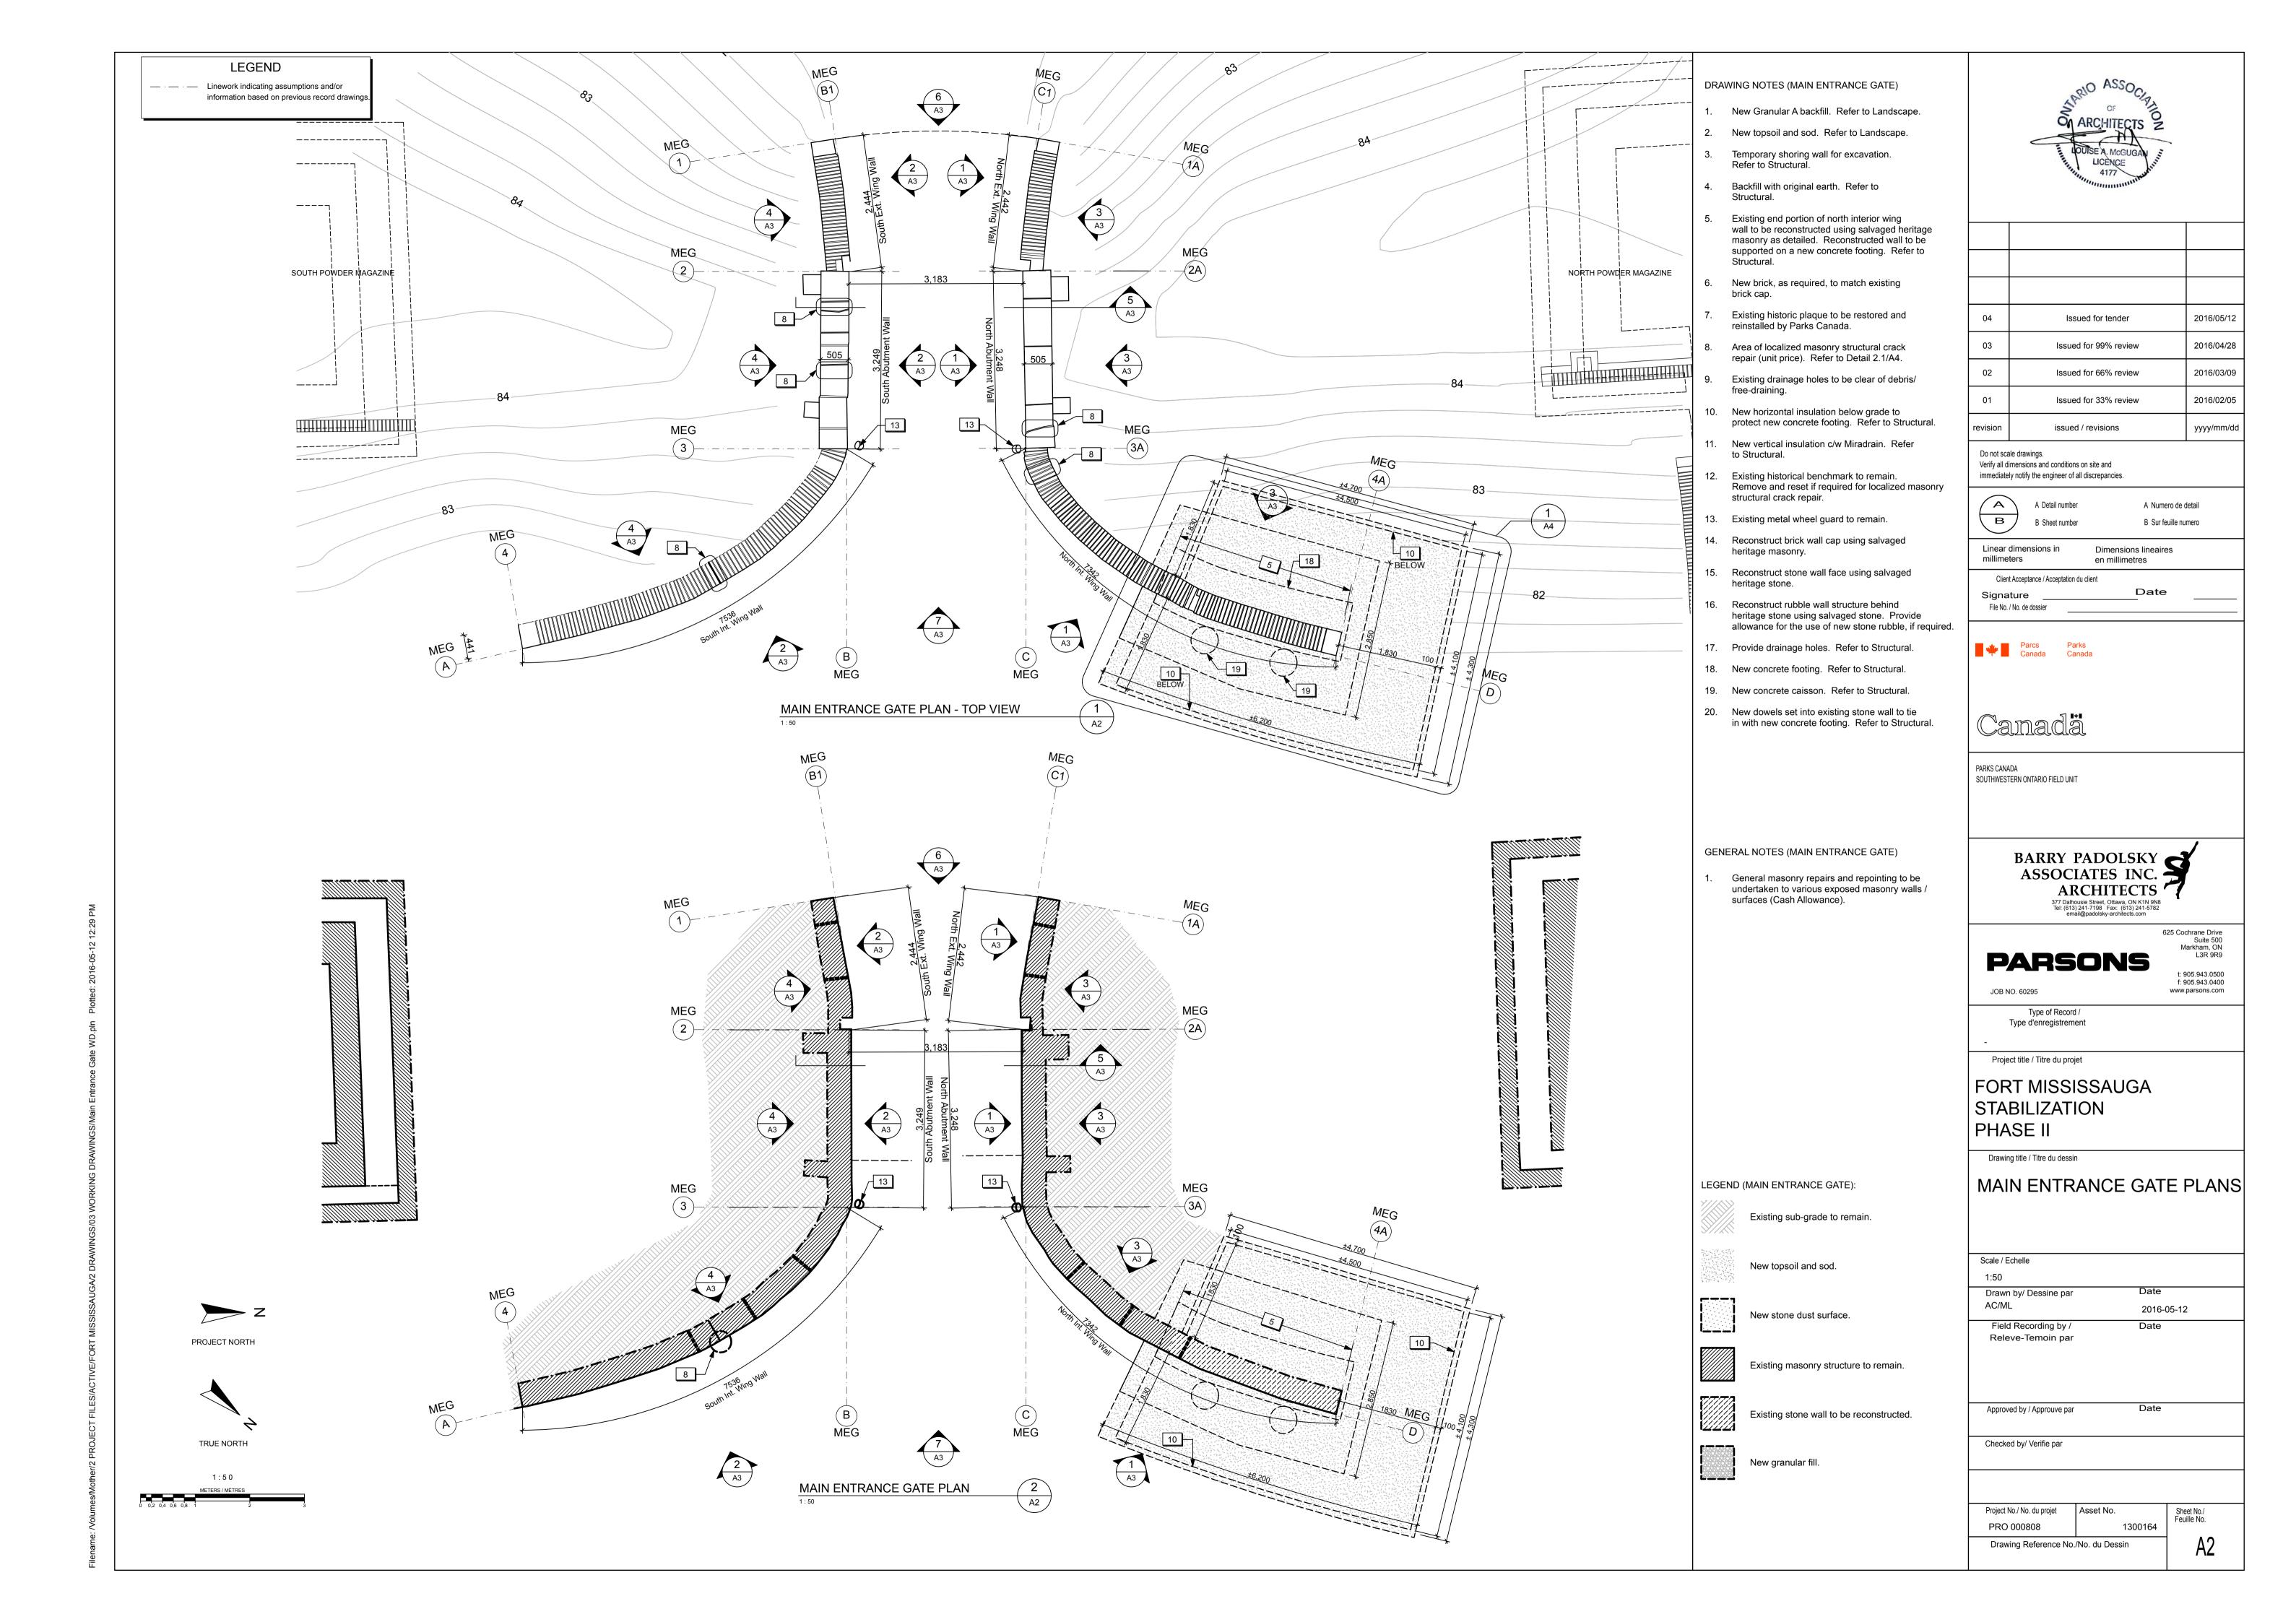
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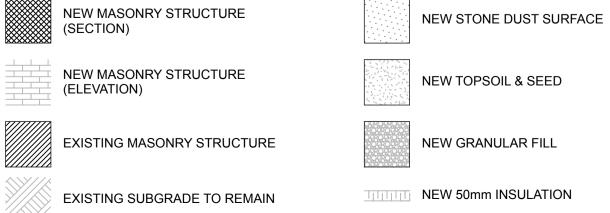
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LONGITUDINAL SECTION THROUGH EARTHWORKS LOOKING NORTH

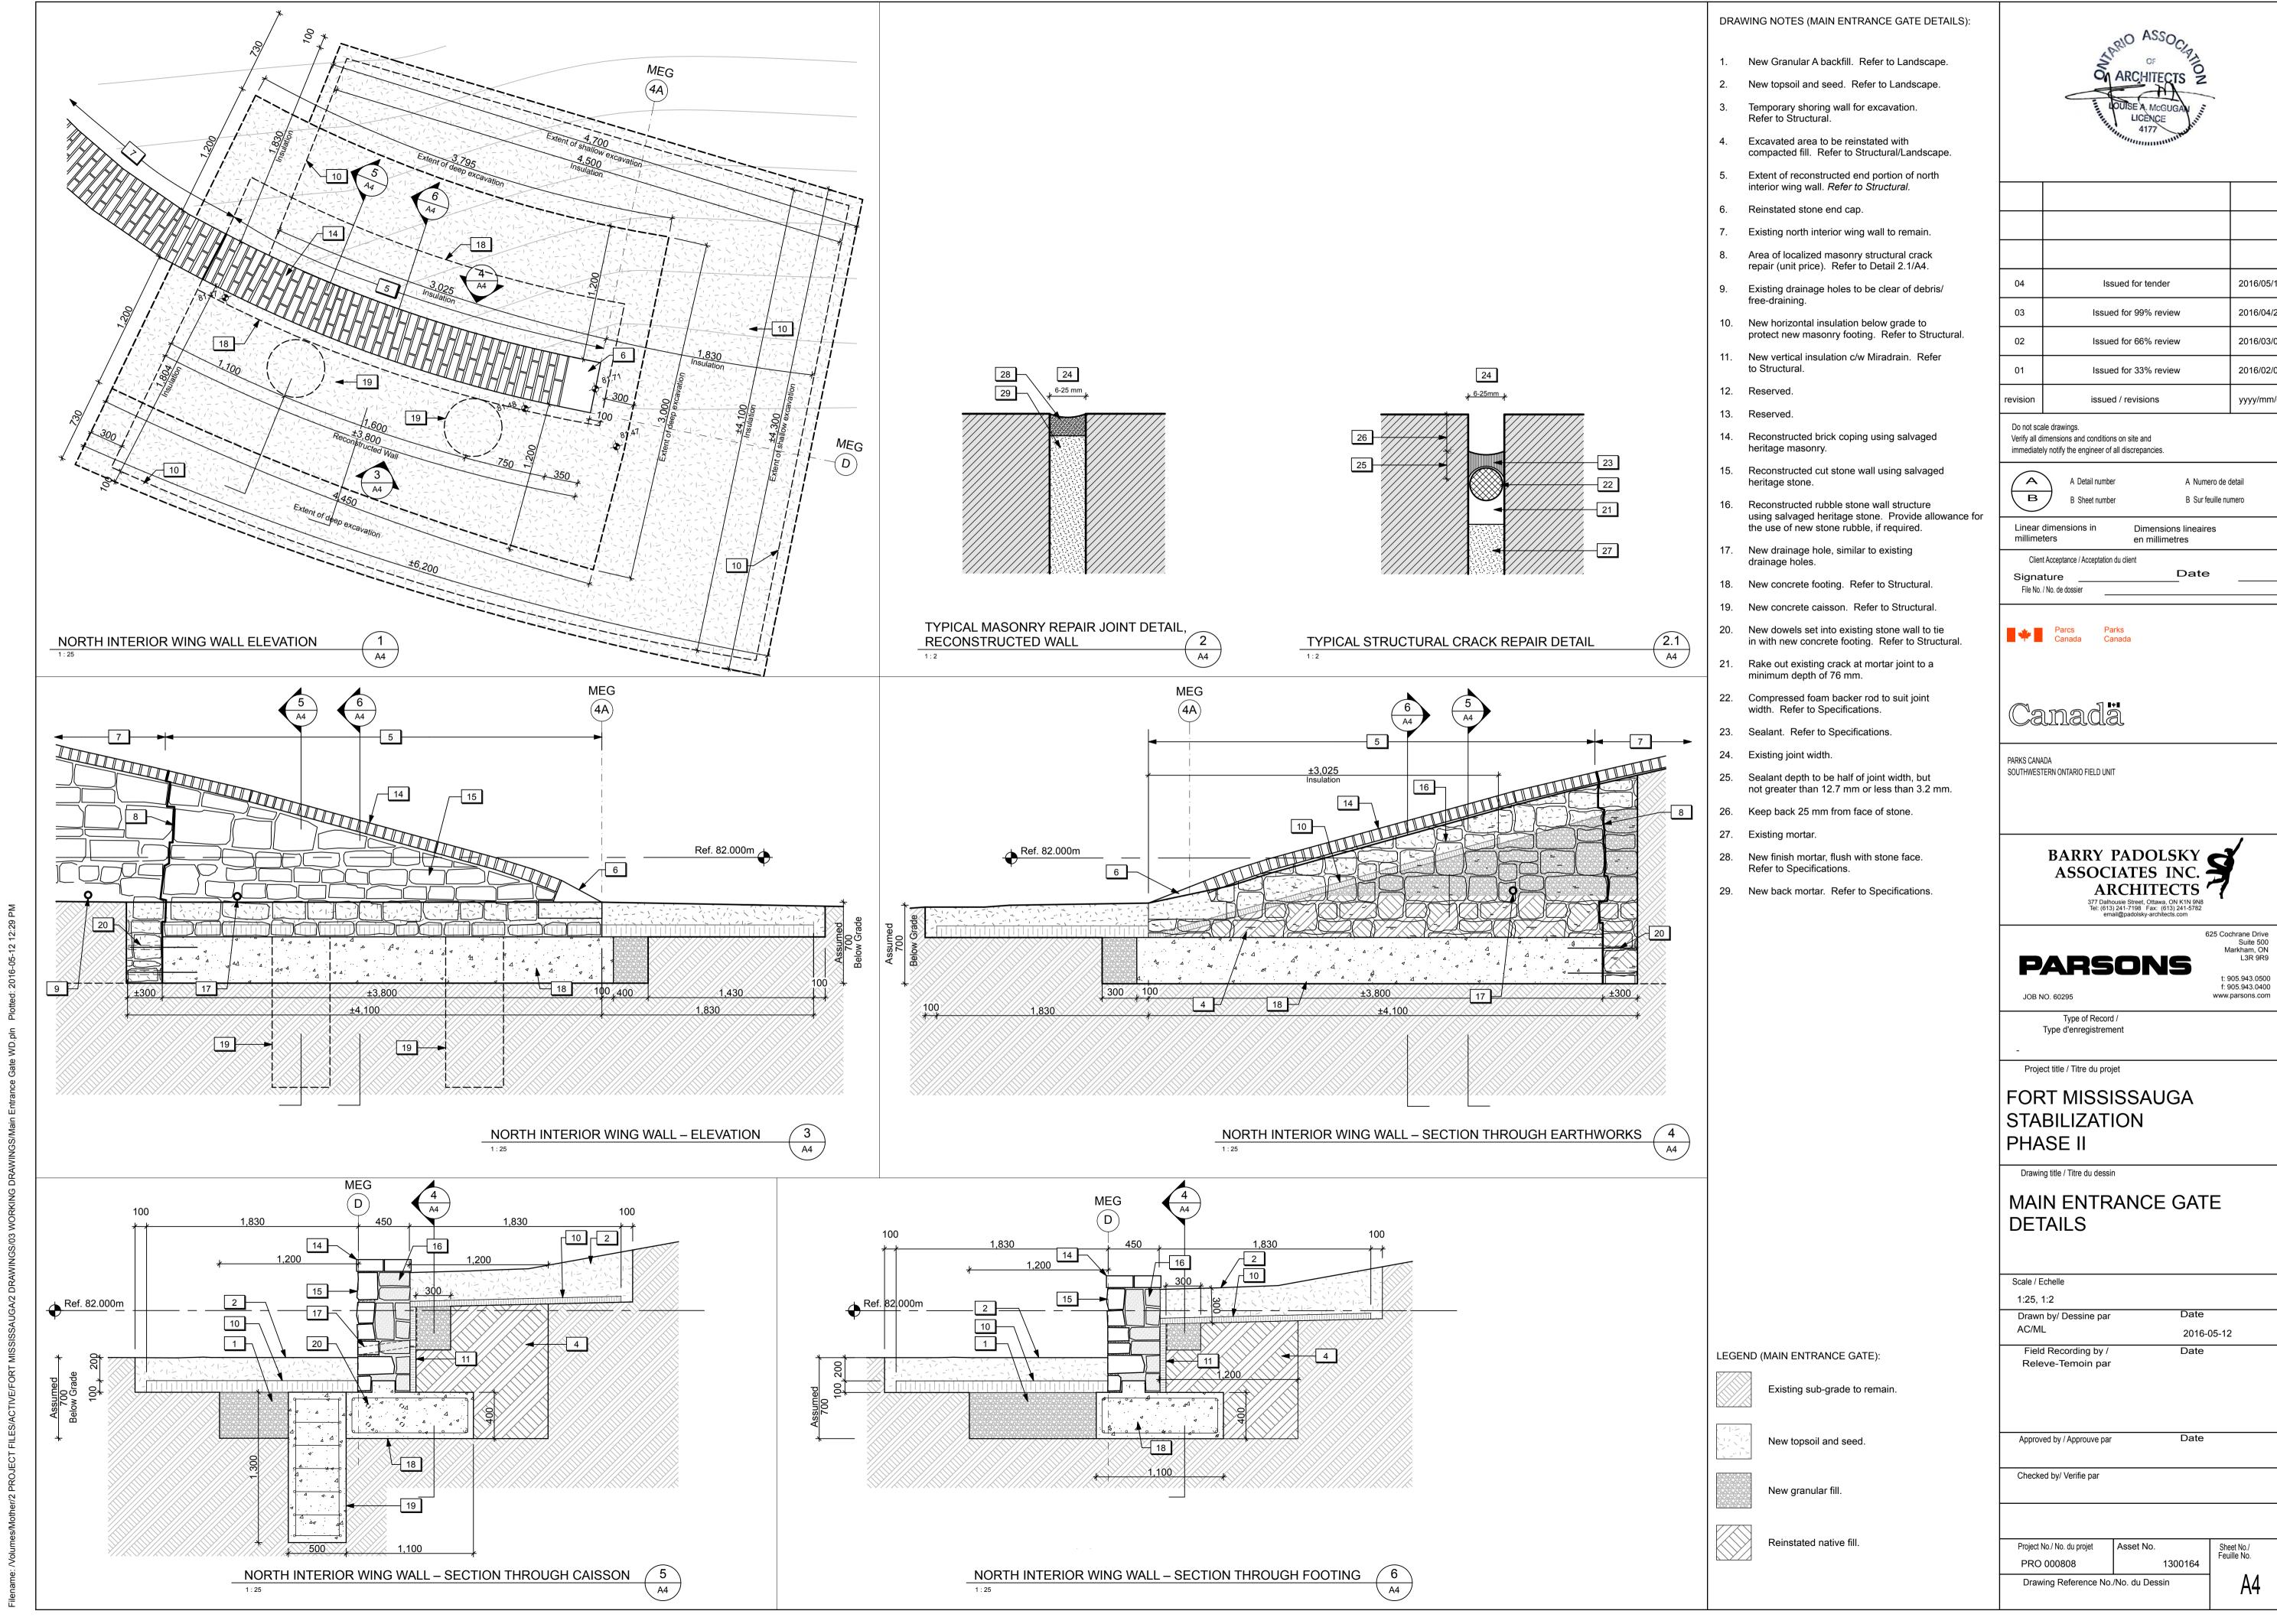LEGEND (POWDER MAGAZINES):

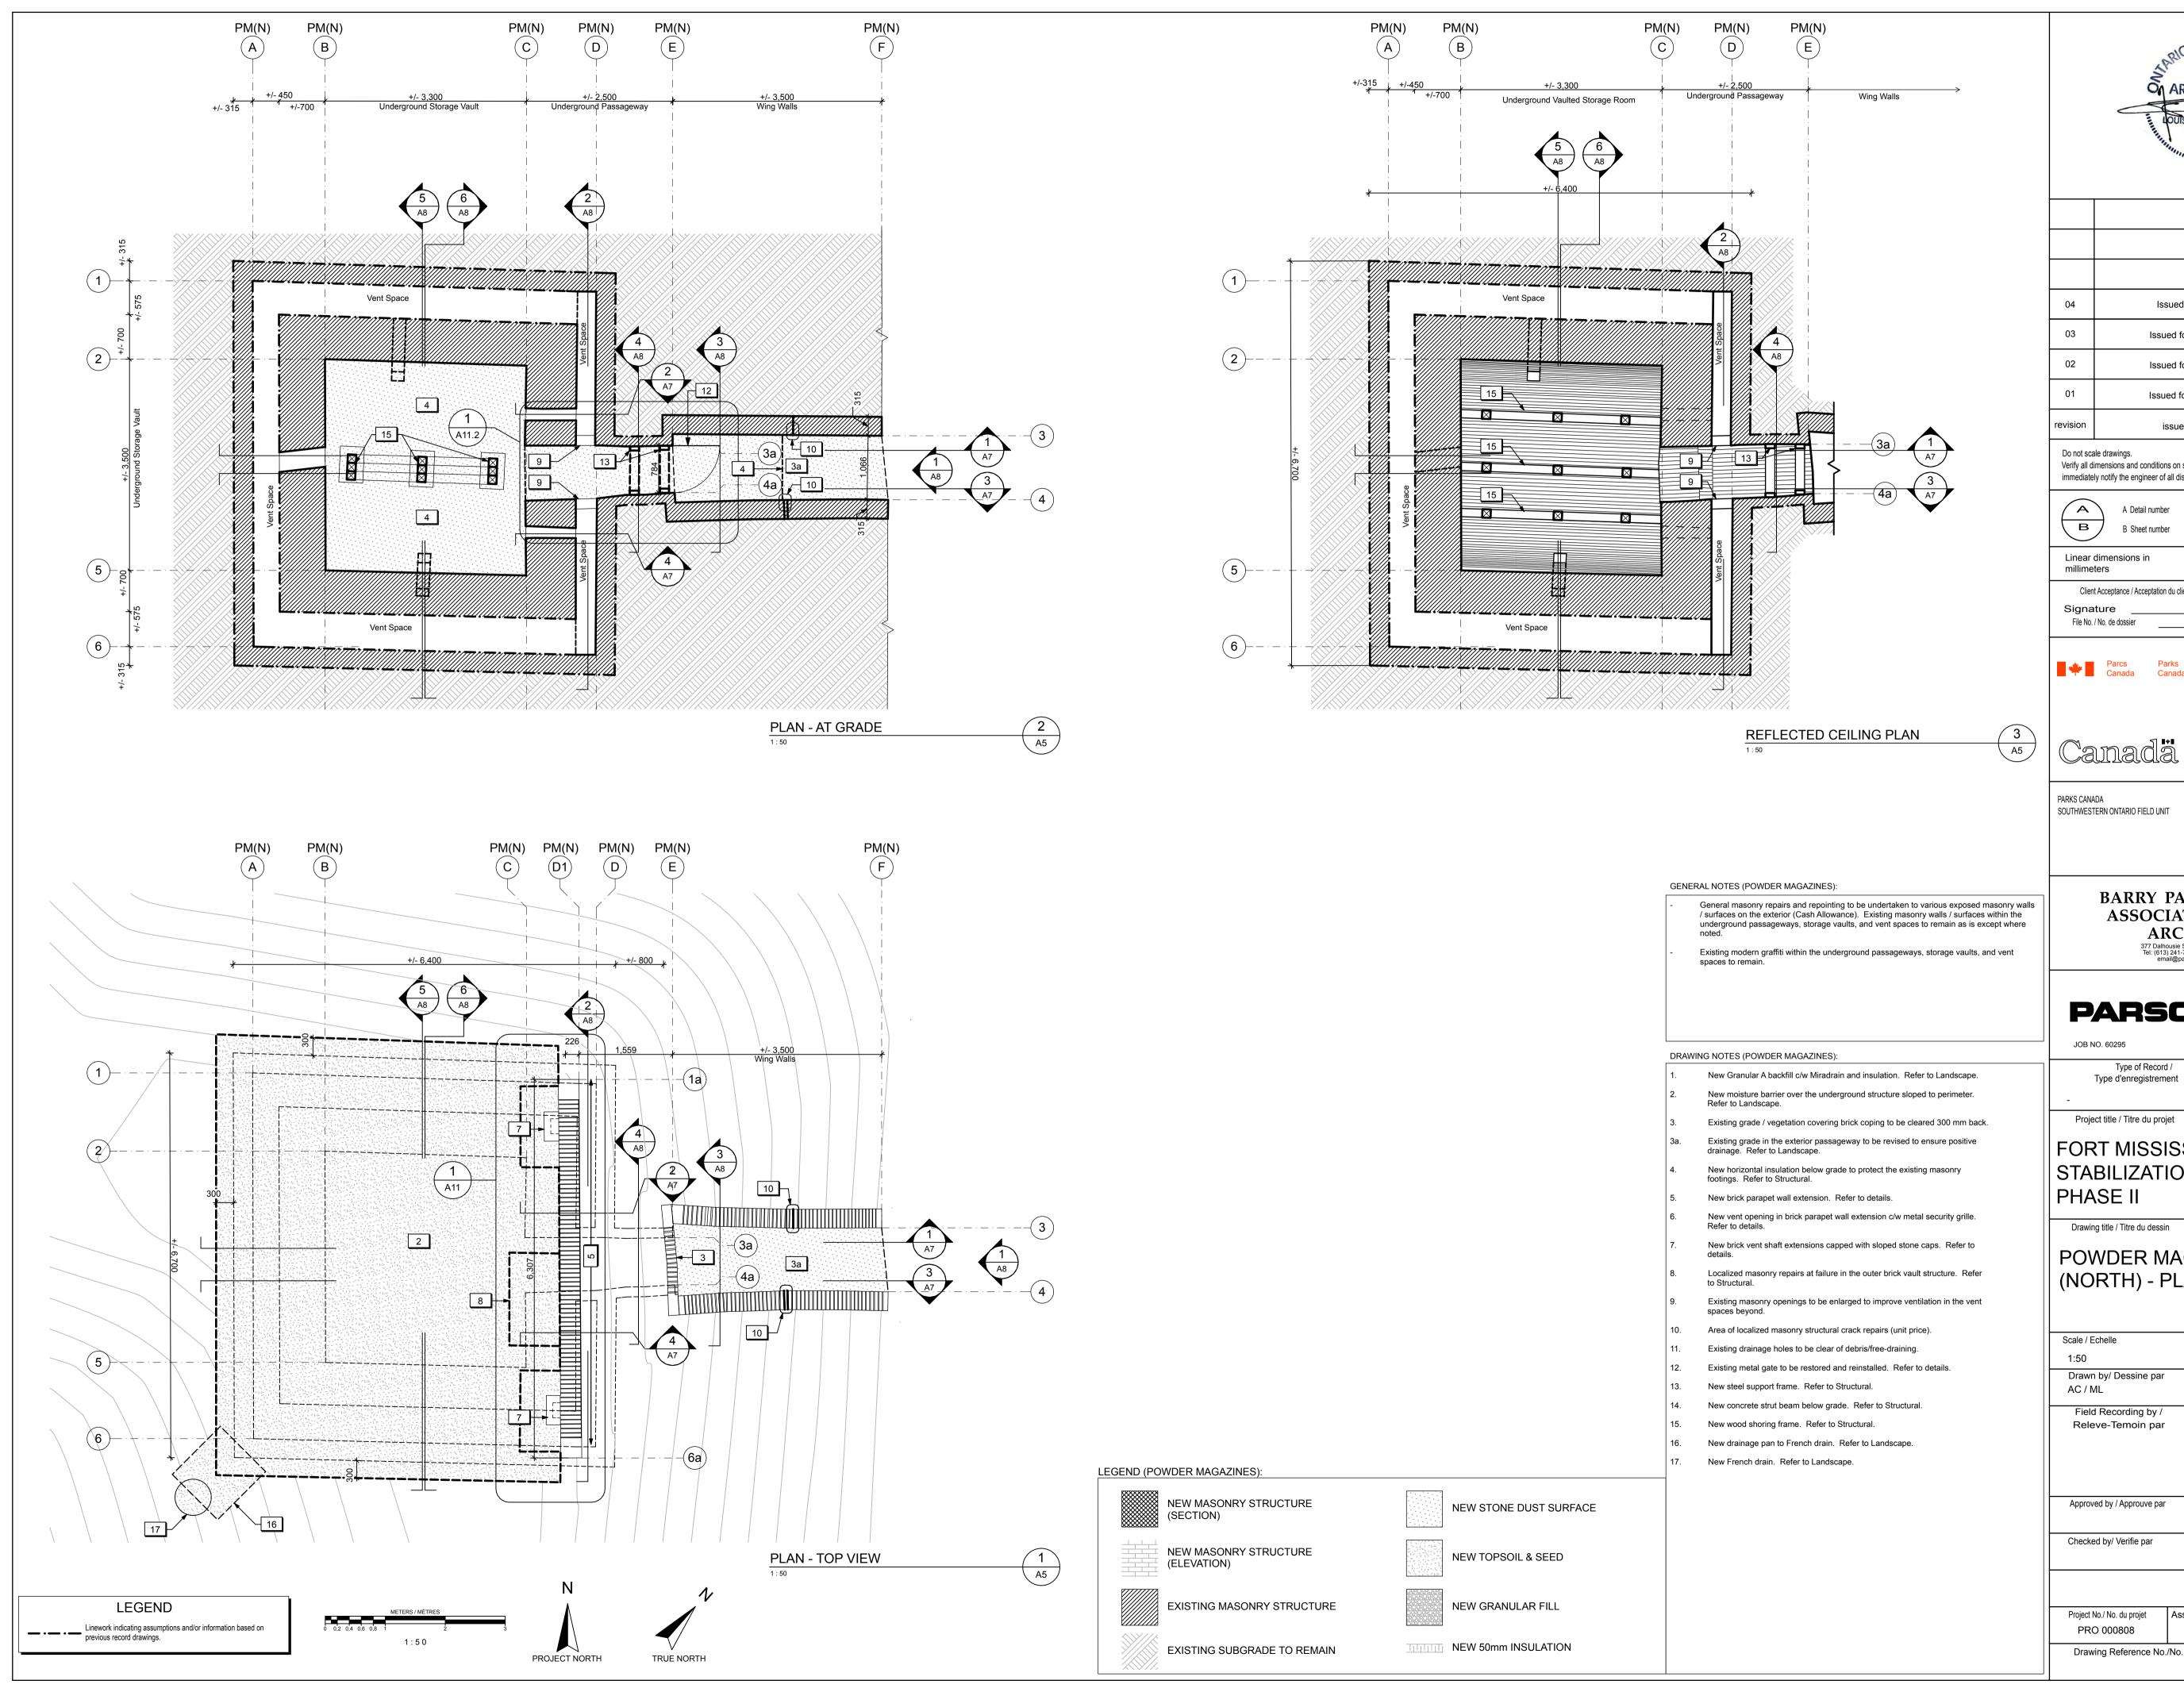

Linework indicating assumptions and/or information based on previous record drawings. 1:50

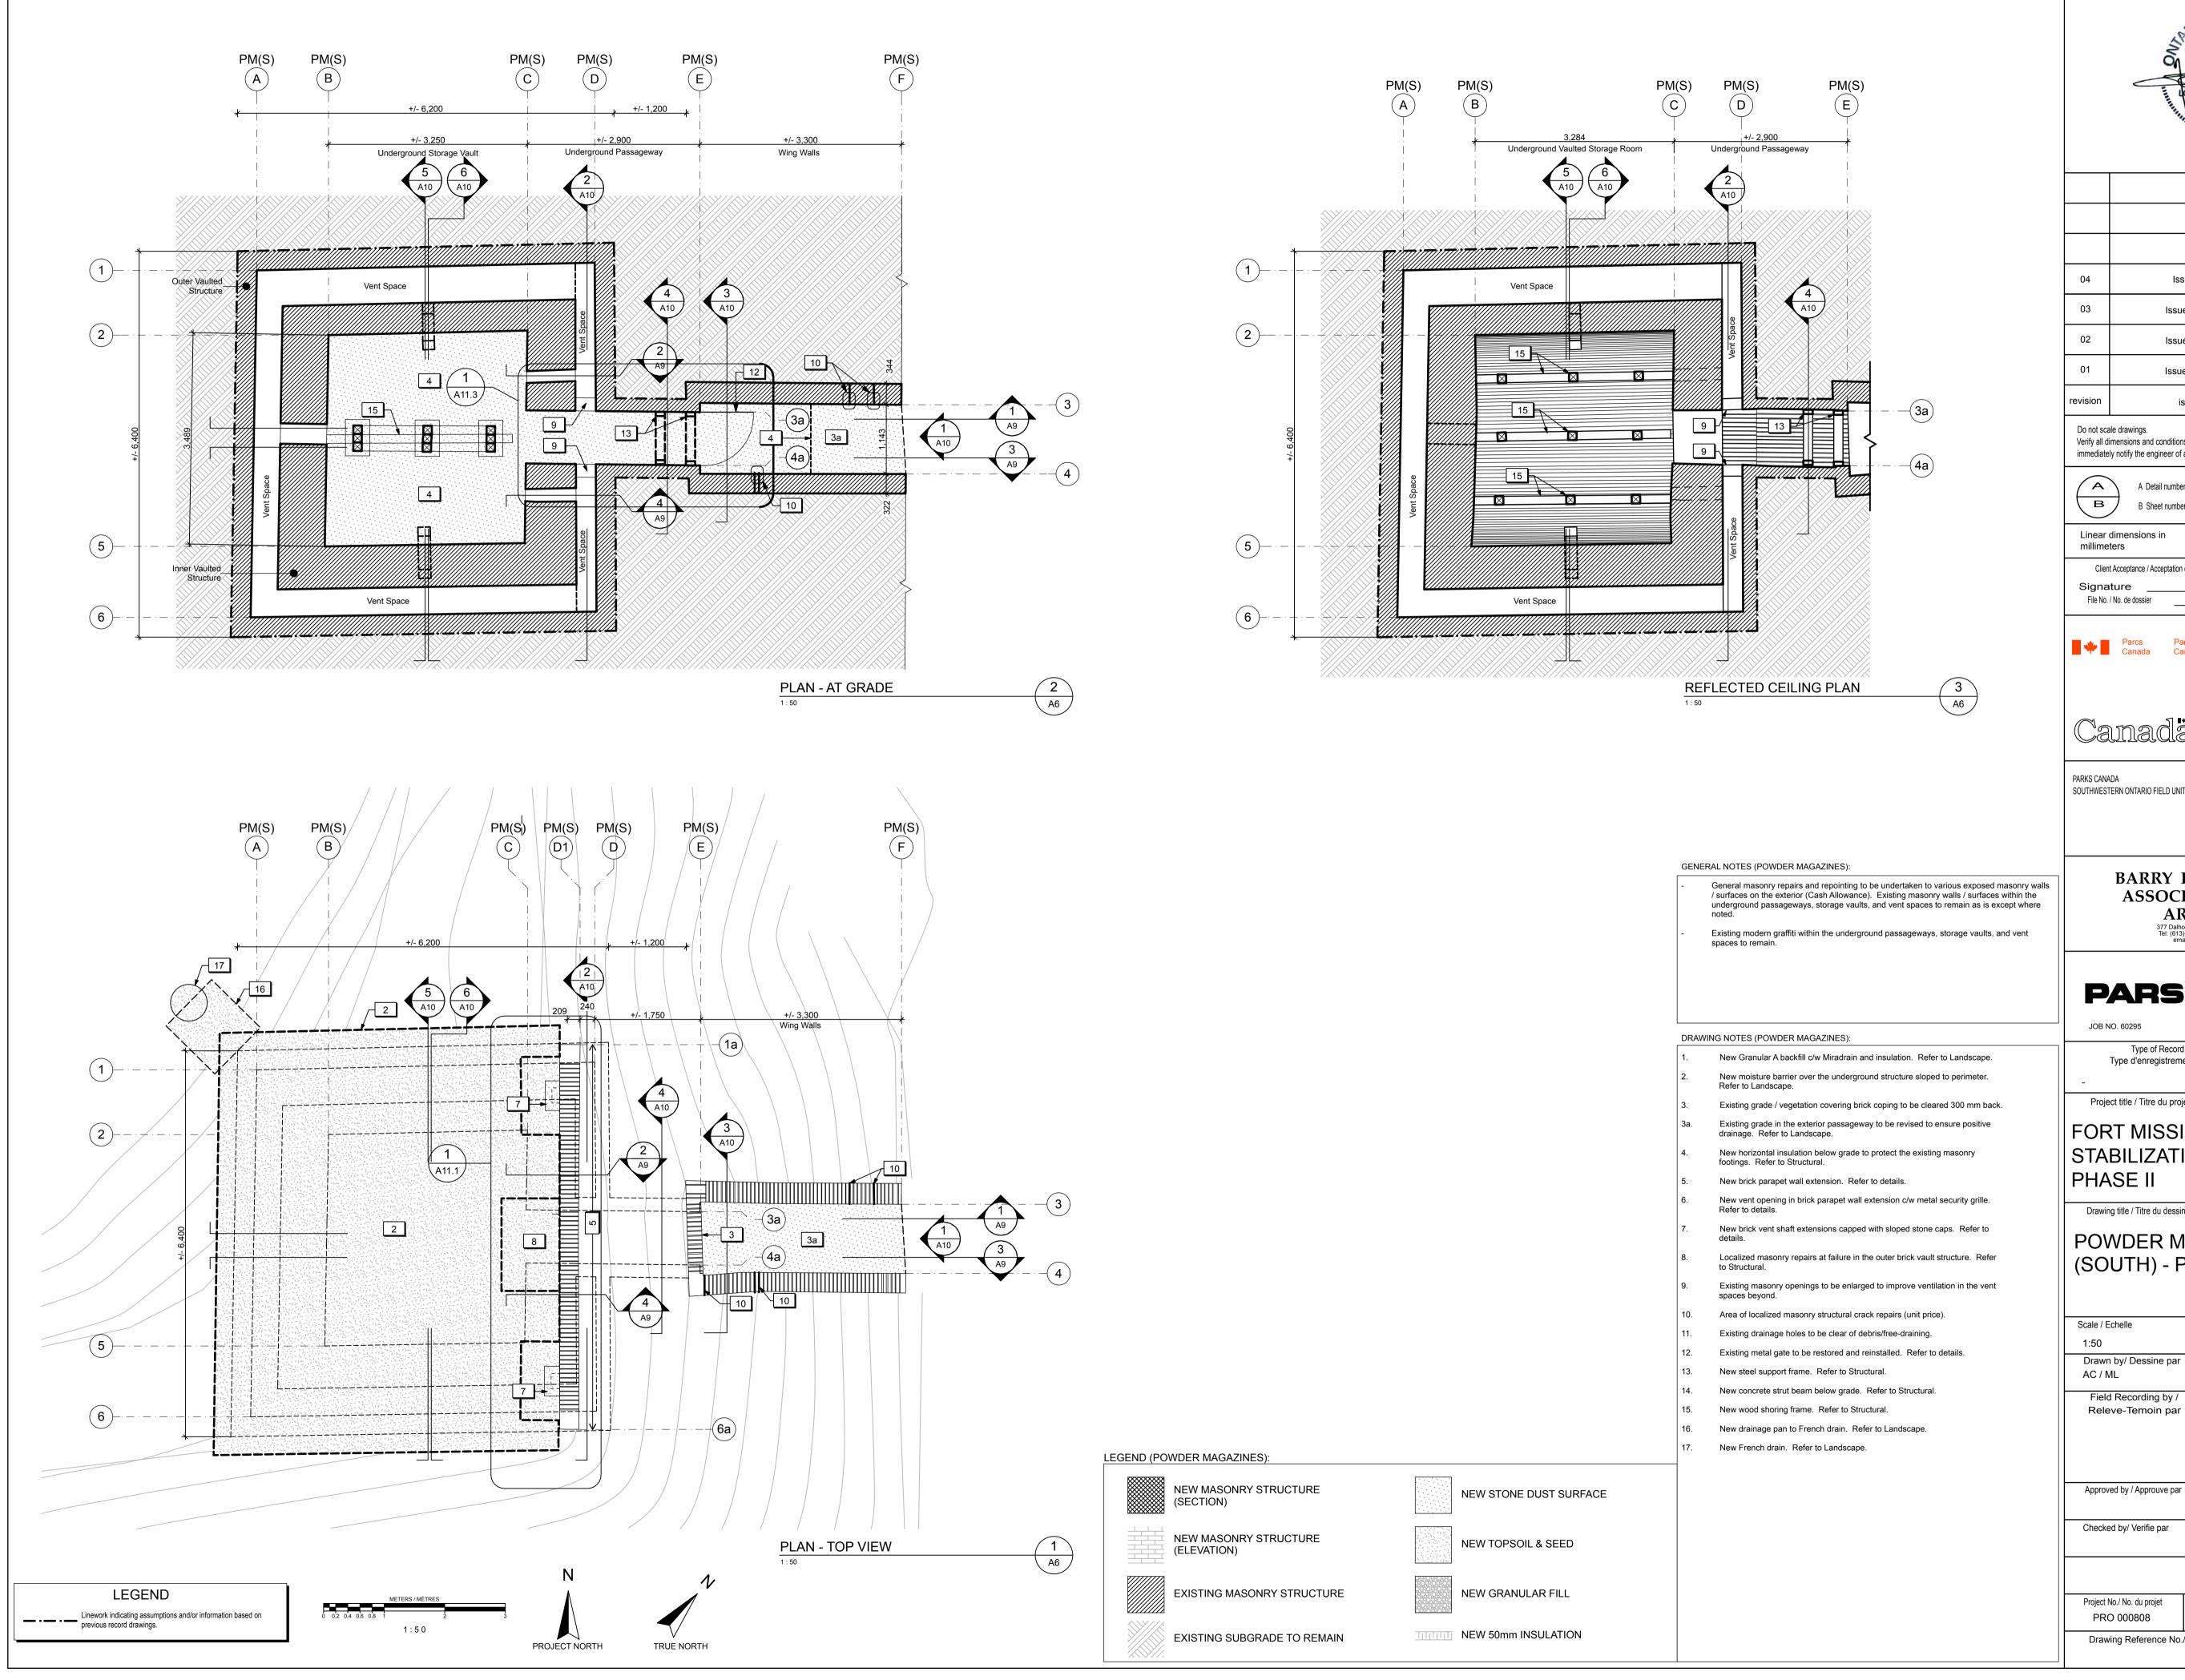LEGEND

Existing drainage holes to be clear of debris/free-draining. Existing metal gate to be restored and reinstalled. Refer to details. New steel support frame. Refer to Structural.

New concrete strut beam below grade. Refer to Structural. New wood shoring frame. Refer to Structural.

Area of localized masonry structural crack repairs (unit price).

GENERAL NOTES (POWDER MAGAZINES):

DRAWING NOTES (POWDER MAGAZINES):

drainage. Refer to Landscape.

footings. Refer to Structural.

Refer to details.

to Structural.

spaces beyond.

spaces to remain.

/ surfaces on the exterior (Cash Allowance). Existing masonry walls / surfaces within the

underground passageways, storage vaults, and vent spaces to remain as is except where

Existing modern graffiti within the underground passageways, storage vaults, and vent

New Granular A backfill c/w Miradrain and insulation. Refer to Landscape.

New moisture barrier over the underground structure sloped to perimeter.

New horizontal insulation below grade to protect the existing masonry

New vent opening in brick parapet wall extension c/w metal security grille.

New brick vent shaft extensions capped with sloped stone caps. Refer to

Localized masonry repairs at failure in the outer brick vault structure. Refer

Existing masonry openings to be enlarged to improve ventilation in the vent

New brick parapet wall extension. Refer to details.


Existing grade / vegetation covering brick coping to be cleared 300 mm back. Existing grade in the exterior passageway to be revised to ensure positive

New French drain. Refer to Landscape.

New drainage pan to French drain. Refer to Landscape.

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POWDER MAGAZINE (NORTH) - SECTIONS & **ELEVATIONS 2**


Scale / Echelle Drawn by/ Dessine par 2016.02.05 Field Recording by / Date Releve-Temoin par

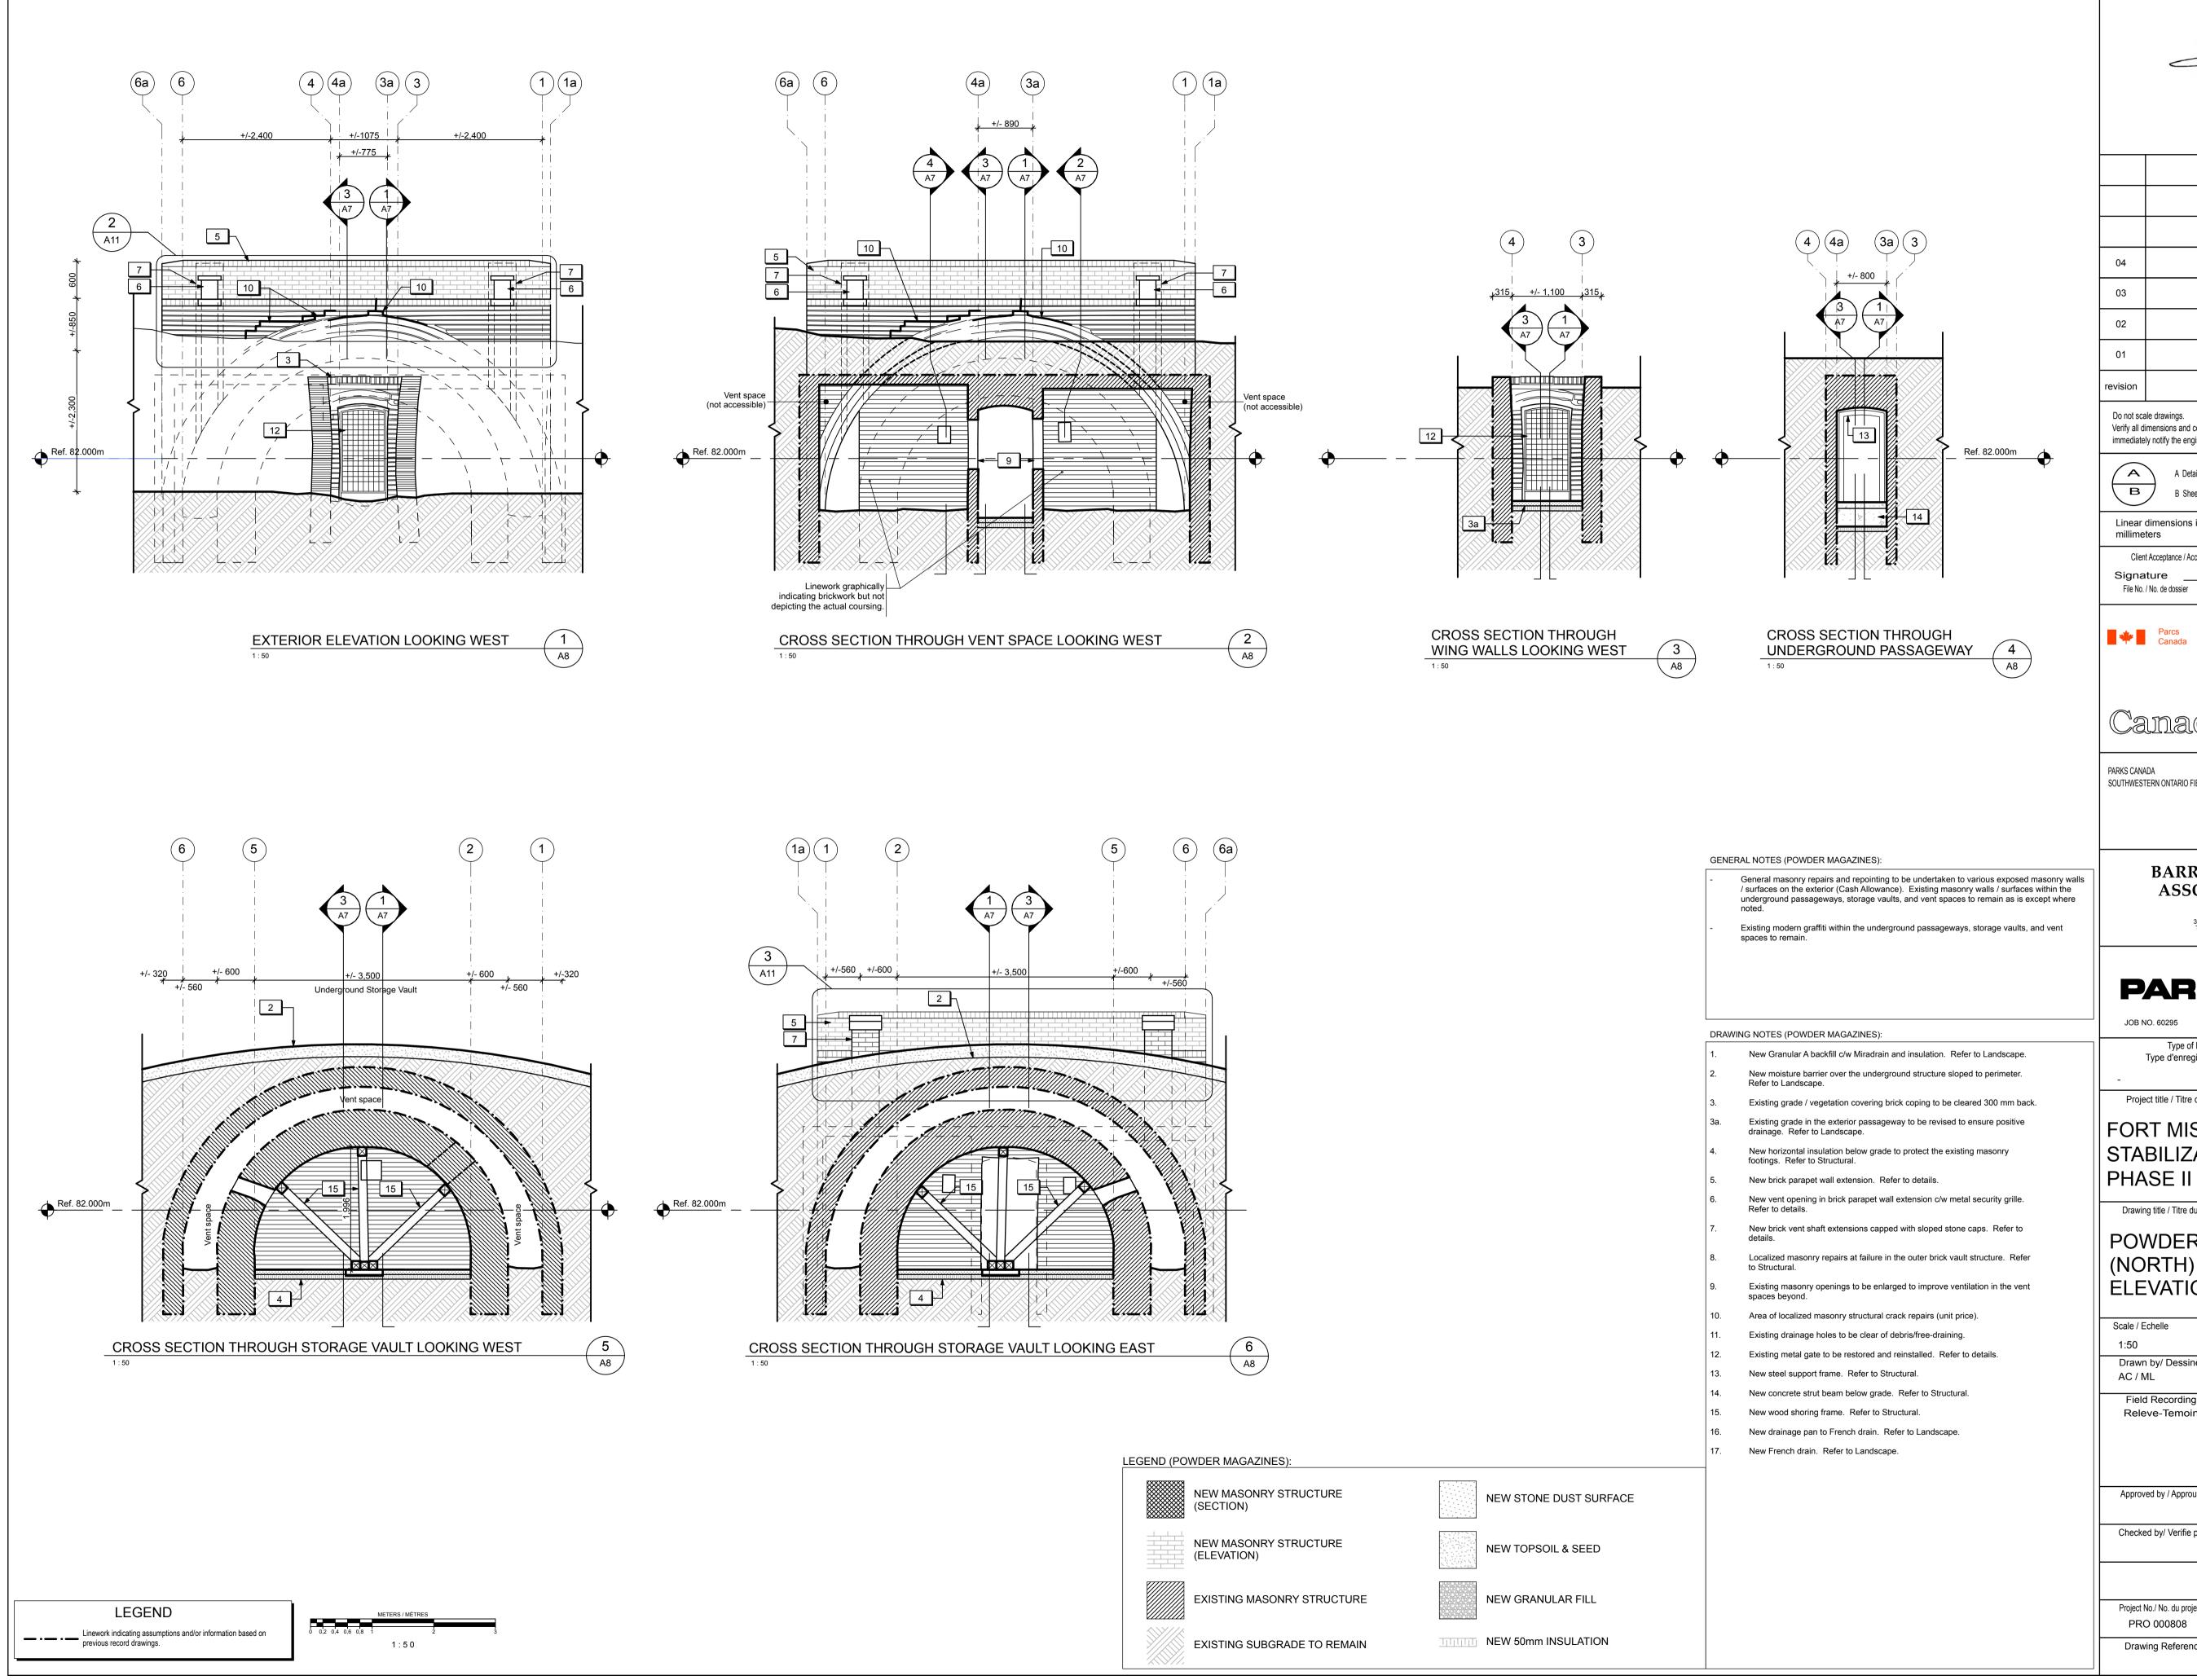Approved by / Approuve par

Checked by/ Verifie par

Project No./ No. du projet PRO 000808 1300164 Drawing Reference No./No. du Dessin

Date

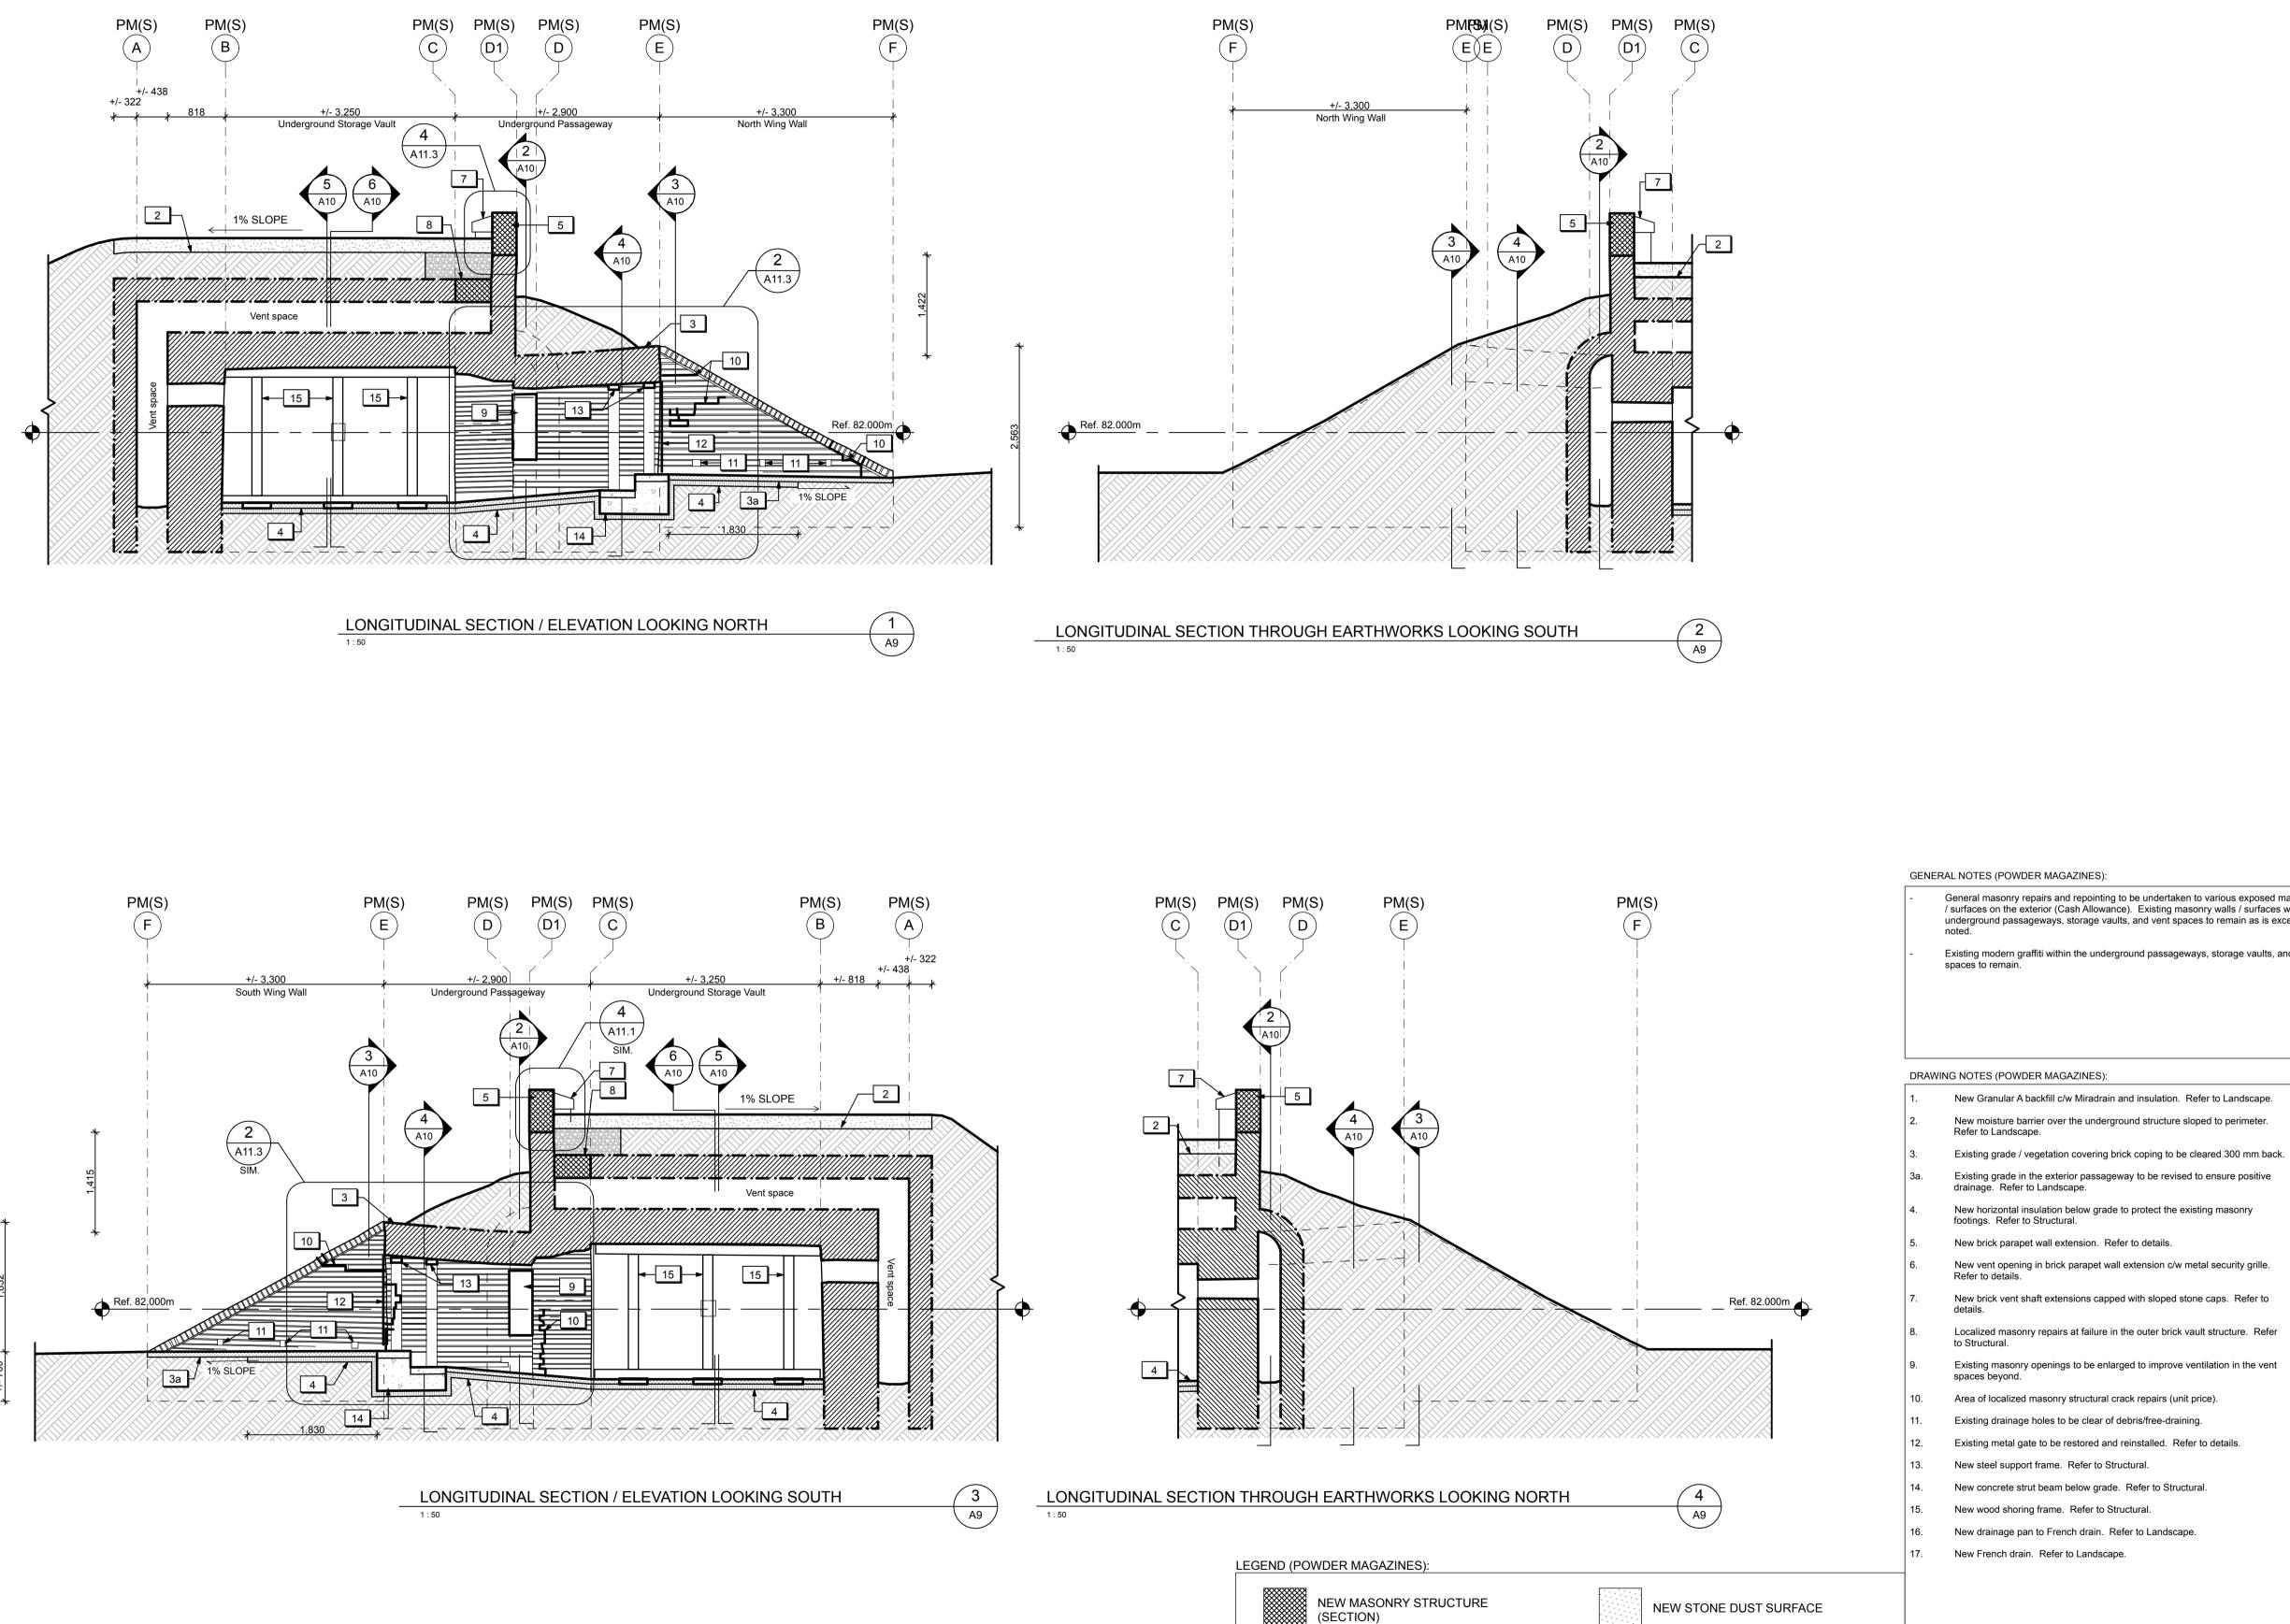

LEGEND

Linework indicating assumptions and/or information based on previous record drawings.

1:50

NEW MASONRY STRUCTURE

EXISTING MASONRY STRUCTURE

EXISTING SUBGRADE TO REMAIN

(ELEVATION)

NEW TOPSOIL & SEED

NEW GRANULAR FILL

NEW 50mm INSULATION



| 04 | Issued for tender | 2016/05/12 |
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| 03 | Issued for 99% Review | 2016/04/28 |
| 02 | Issued for 66% Review | 2016/03/09 |
| 01 | Issued for 33% Review | 2016/02/05 |
| revision | issued / revisions | yyyy/mm/dd |

Do not scale drawings. Verify all dimensions and conditions on site and immediately notify the engineer of all discrepancies.



A Numero de detail B Sur feuille numero

Dimensions lineaires

millimeters

en millimetres Client Acceptance / Acceptation du client

Signature File No. / No. de dossier





SOUTHWESTERN ONTARIO FIELD UNIT

/ surfaces on the exterior (Cash Allowance). Existing masonry walls / surfaces within the underground passageways, storage vaults, and vent spaces to remain as is except where

Existing modern graffiti within the underground passageways, storage vaults, and vent

ASSOCIATES INC.
ARCHITECTS 377 Dalhousie Street, Ottawa, ON K1N 9N8 Tel: (613) 241-7198 Fax: (613) 241-5782 email@padolsky-architects.com 625 Cochrane Drive Suite 500 Markham, ON L3R 9R9

BARRY PADOLSKY

PARSONS

JOB NO. 60295

Type of Record / Type d'enregistrement

Project title / Titre du projet

FORT MISSISSAUGA STABILIZATION PHASE II

Drawing title / Titre du dessin

POWDER MAGAZINE (SOUTH) - SECTIONS & **ELEVATIONS 1**

| Scale / Echelle | |
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| Drawn by/ Dessine par | Date |
| AC / ML | 2016.02.05 |
| Field Recording by / | Date |
| Releve-Temoin par | |
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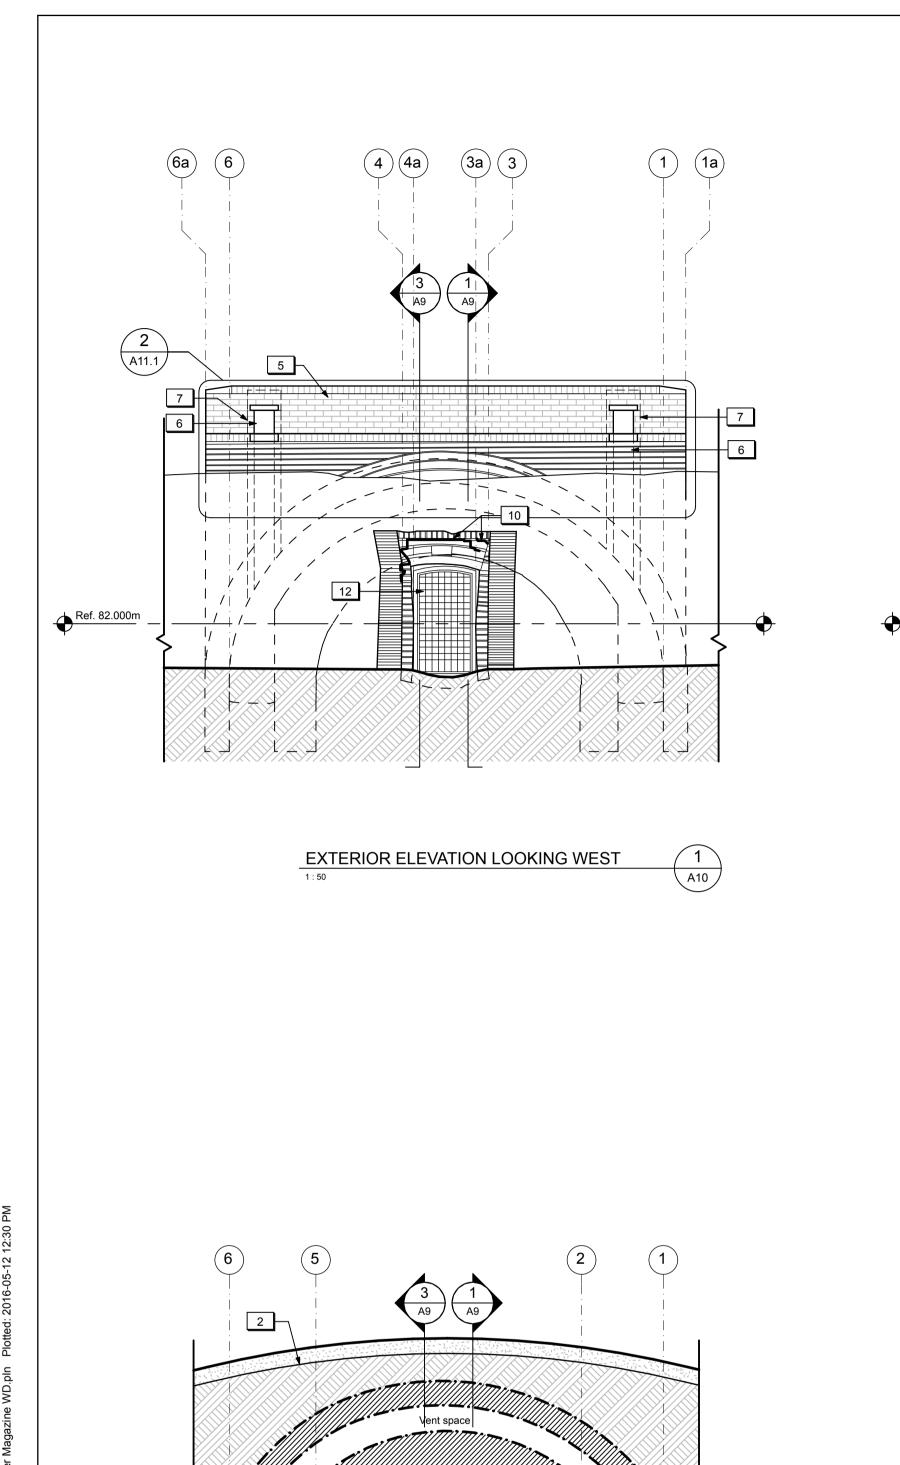
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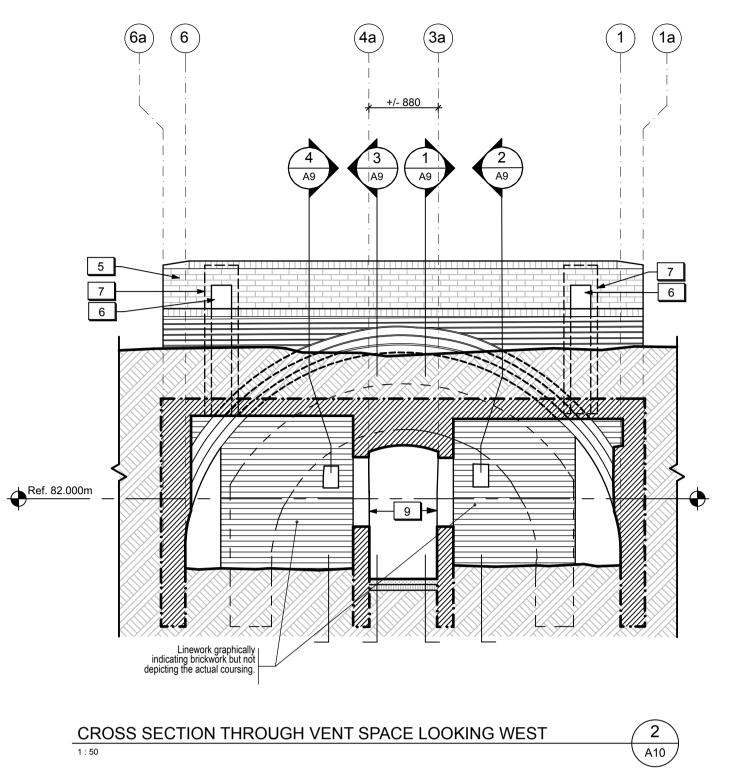
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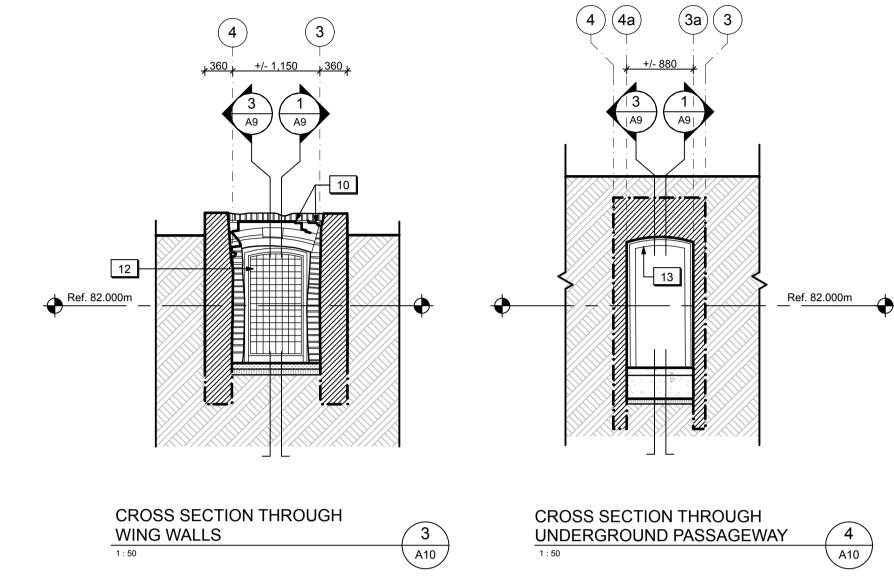
Approved by / Approuve par

Project No./ No. du projet PRO 000808 1300164 Drawing Reference No./No. du Dessin

t: 905.943.0500







GENERAL NOTES (POWDER MAGAZINES):

DRAWING NOTES (POWDER MAGAZINES):

Refer to Landscape.

drainage. Refer to Landscape.

footings. Refer to Structural.

Refer to details.

to Structural.

spaces beyond.

spaces to remain.

/ surfaces on the exterior (Cash Allowance). Existing masonry walls / surfaces within the underground passageways, storage vaults, and vent spaces to remain as is except where

Existing modern graffiti within the underground passageways, storage vaults, and vent

New Granular A backfill c/w Miradrain and insulation. Refer to Landscape.

New moisture barrier over the underground structure sloped to perimeter.

New horizontal insulation below grade to protect the existing masonry

New vent opening in brick parapet wall extension c/w metal security grille.

New brick vent shaft extensions capped with sloped stone caps. Refer to

Localized masonry repairs at failure in the outer brick vault structure. Refer

Existing masonry openings to be enlarged to improve ventilation in the vent

Area of localized masonry structural crack repairs (unit price).

Existing metal gate to be restored and reinstalled. Refer to details.

Existing drainage holes to be clear of debris/free-draining.

New concrete strut beam below grade. Refer to Structural.

New drainage pan to French drain. Refer to Landscape.


New steel support frame. Refer to Structural.


New wood shoring frame. Refer to Structural.


New French drain. Refer to Landscape.


New brick parapet wall extension. Refer to details.

Existing grade / vegetation covering brick coping to be cleared 300 mm back. Existing grade in the exterior passageway to be revised to ensure positive

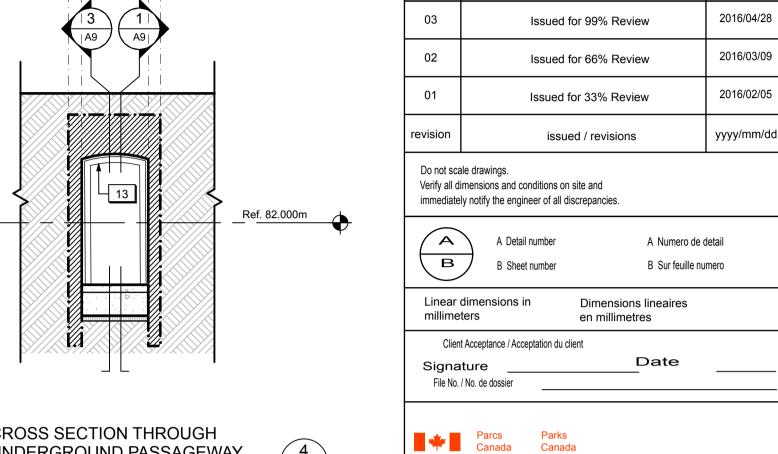

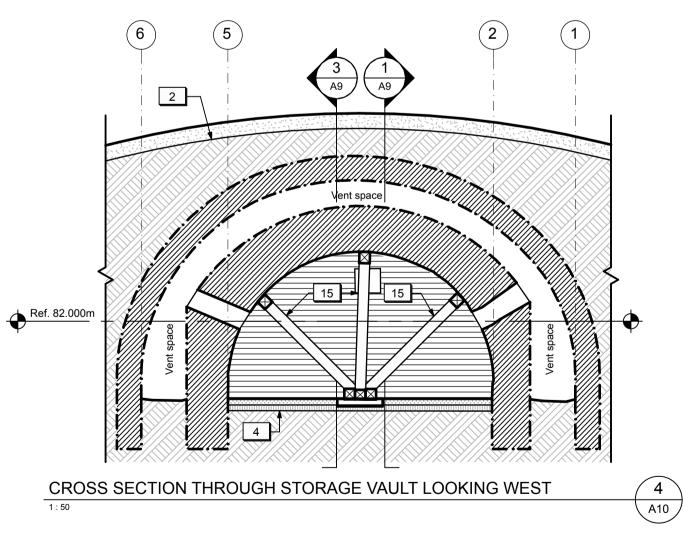

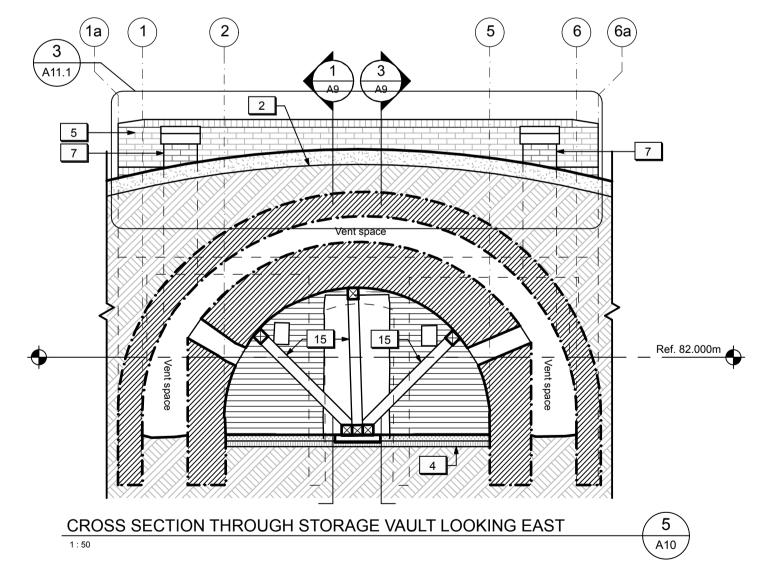

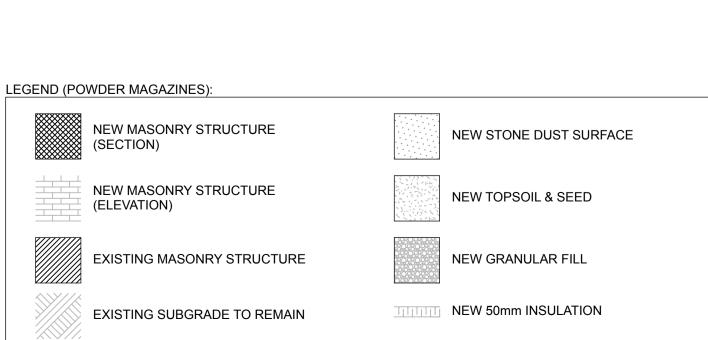



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2016/05/12

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Project title / Titre du projet

FORT MISSISSAUGA STABILIZATION PHASE II

Drawing title / Titre du dessin

POWDER MAGAZINE (SOUTH) - SECTIONS & **ELEVATIONS 2**


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Project No./ No. du projet PRO 000808 1300164

Drawing Reference No./No. du Dessin


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Linework indicating assumptions and/or information based on previous record drawings.




Area of localized masonry structural crack repairs (unit price).

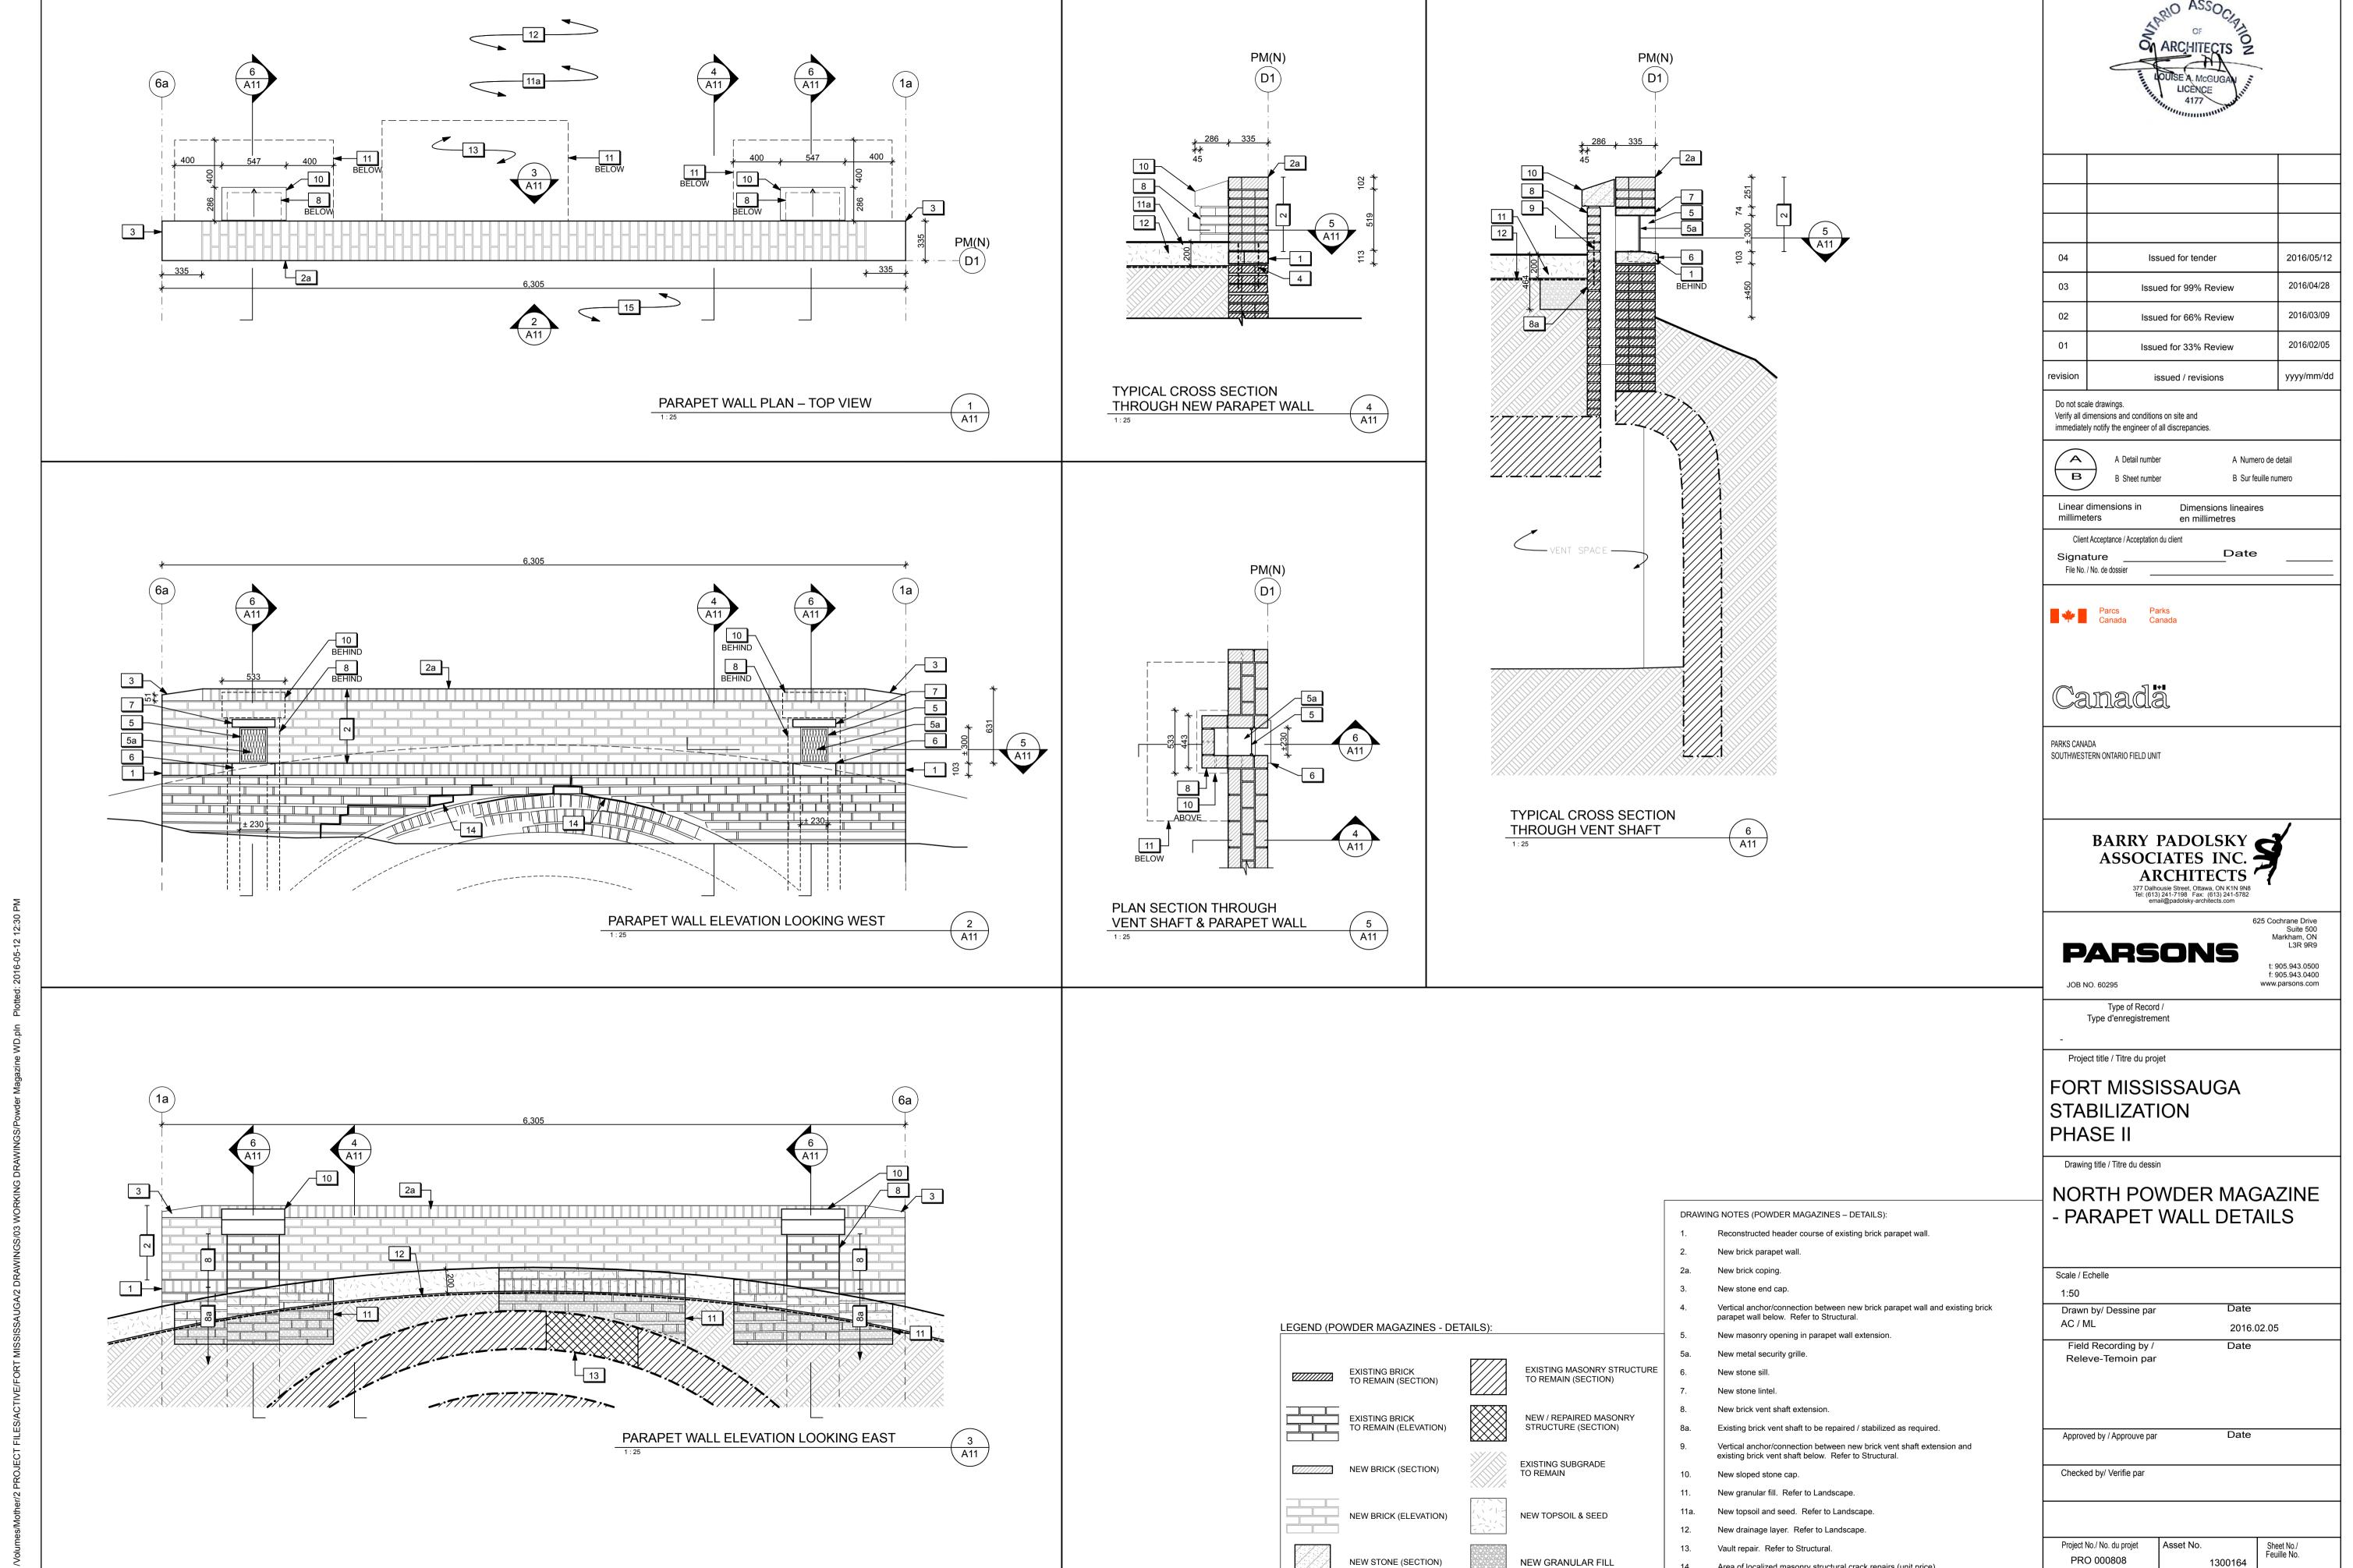
Reserved.

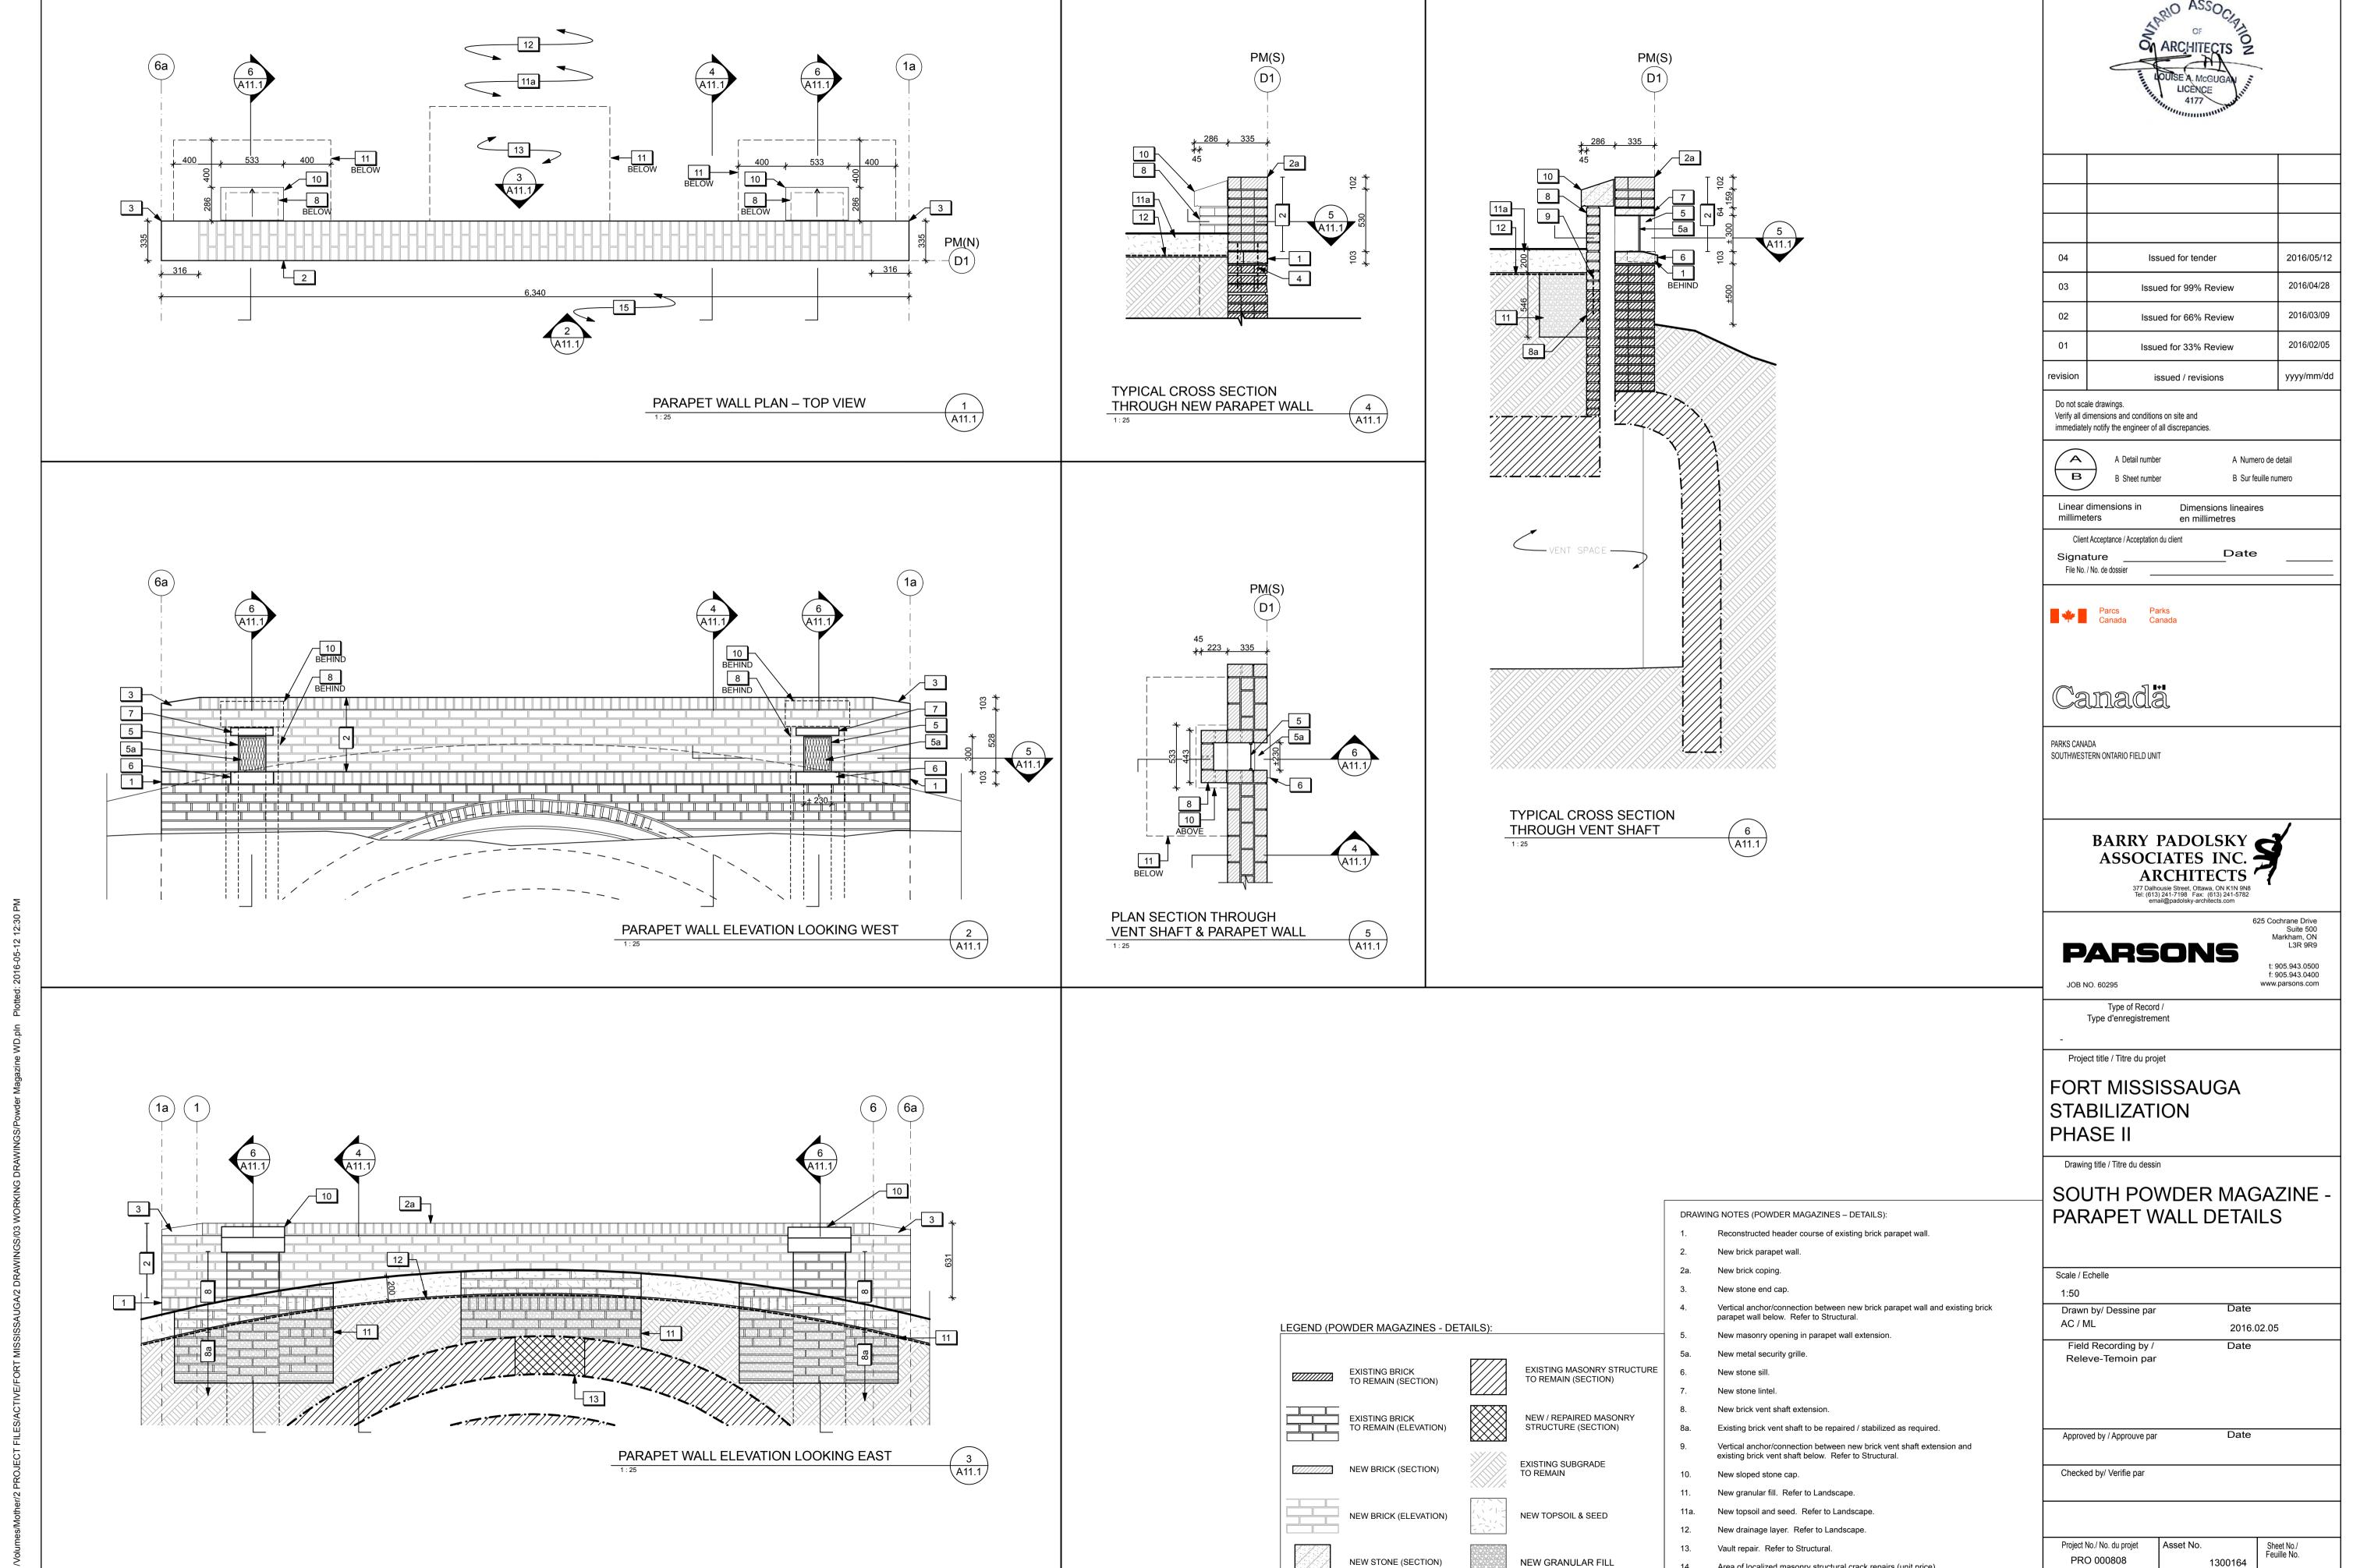


Area of localized masonry structural crack repairs (unit price).

Reserved.

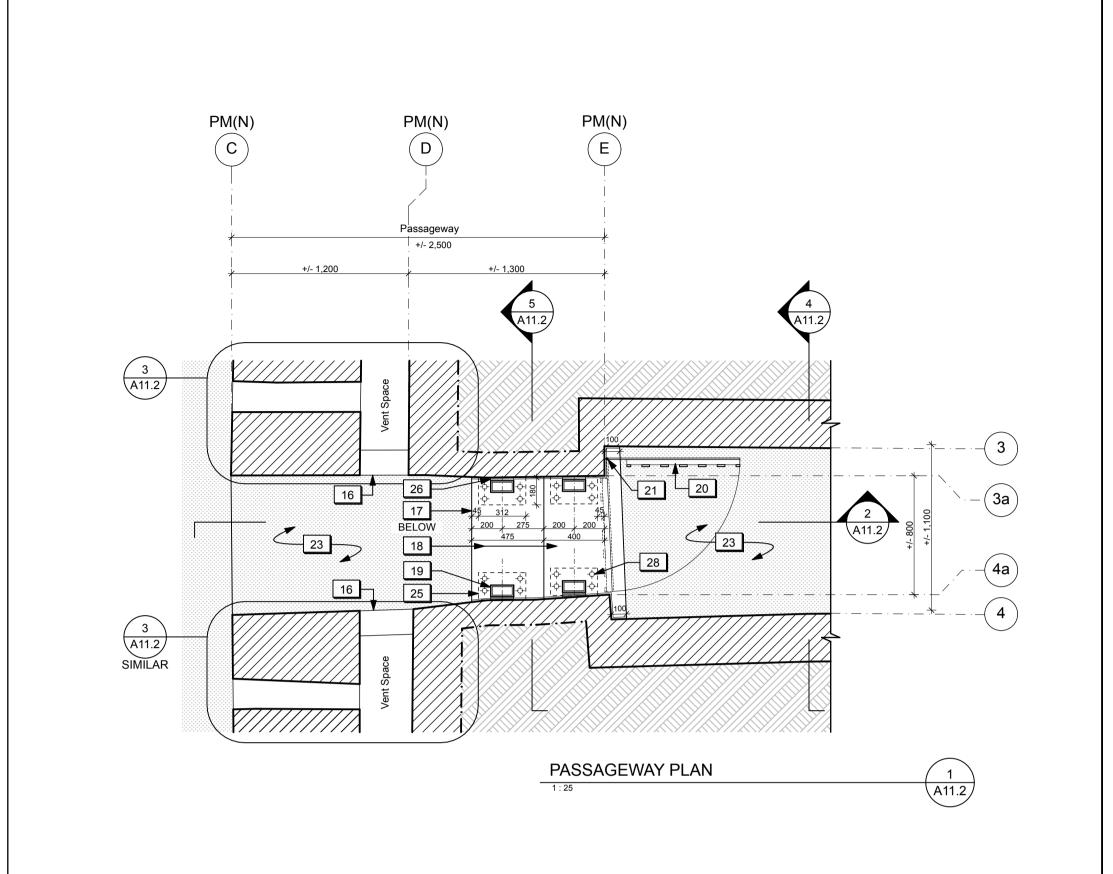

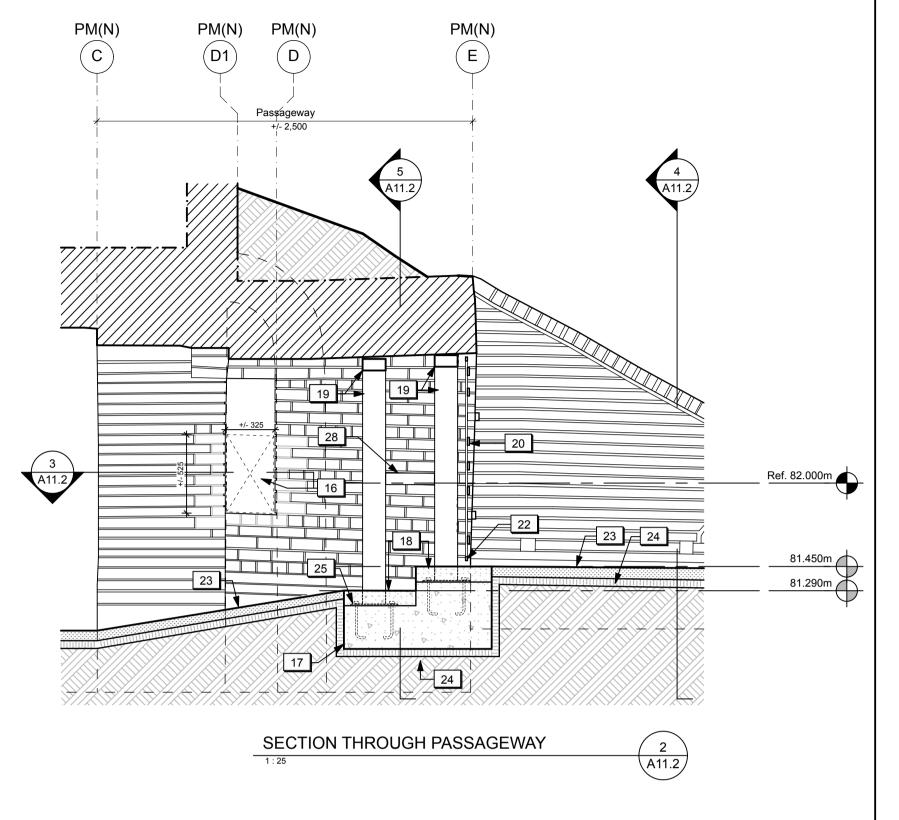

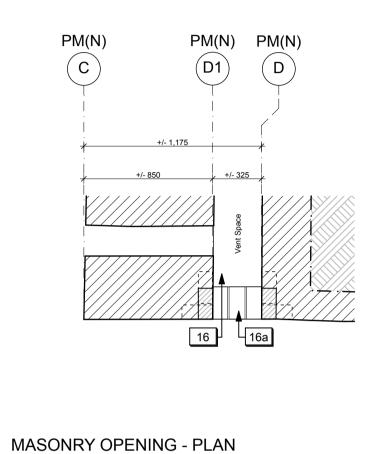



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| 01 | Issued for 33% Review | 2016/02/05 |
| revision | issued / revisions | yyyy/mm/dd |

B Sur feuille numero Dimensions lineaires en millimetres

A Numero de detail

millimeters Client Acceptance / Acceptation du client Signature

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SOUTHWESTERN ONTARIO FIELD UNIT



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Project title / Titre du projet

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Type of Record /

FORT MISSISSAUGA STABILIZATION PHASE II

Drawing title / Titre du dessin


NORTH POWDER MAGAZINE - PASSAGEWAY DETAILS


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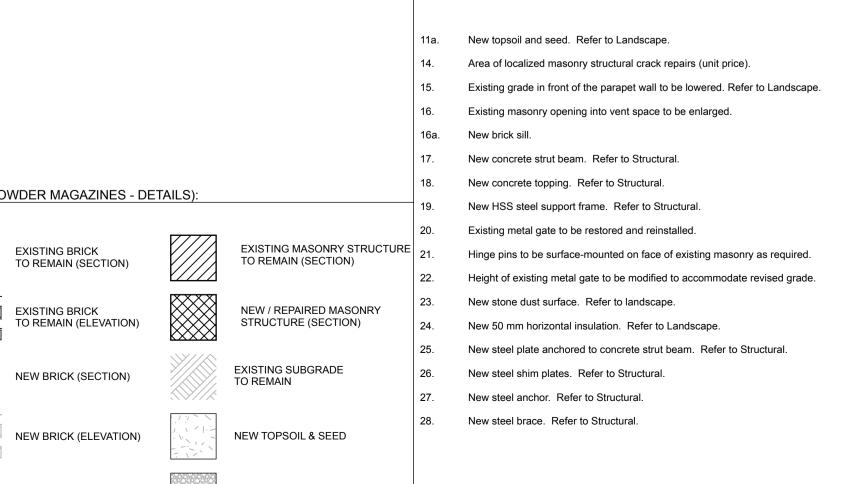
Drawing Reference No./No. du Dessin

EXISTING BRICK TO REMAIN (SECTION) EXISTING BRICK TO REMAIN (ELEVATION) EXISTING SUBGRADE NEW BRICK (SECTION) TO REMAIN NEW BRICK (ELEVATION) **NEW TOPSOIL & SEED** NEW GRANULAR FILL NEW STONE (SECTION)


LEGEND (POWDER MAGAZINES - DETAILS): EXISTING MASONRY STRUCTURE TO REMAIN (SECTION) NEW / REPAIRED MASONRY STRUCTURE (SECTION)




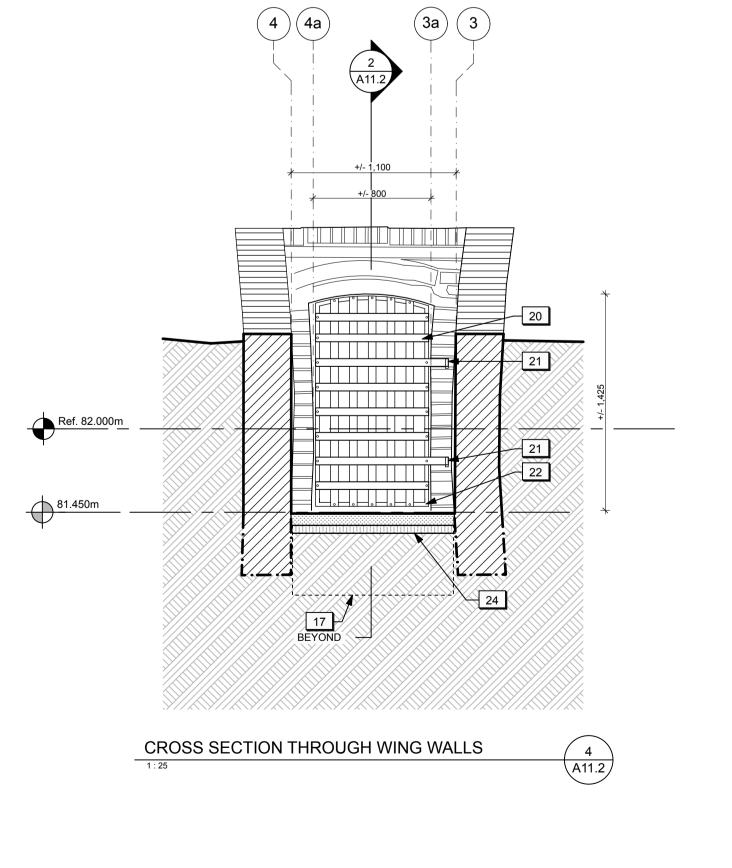


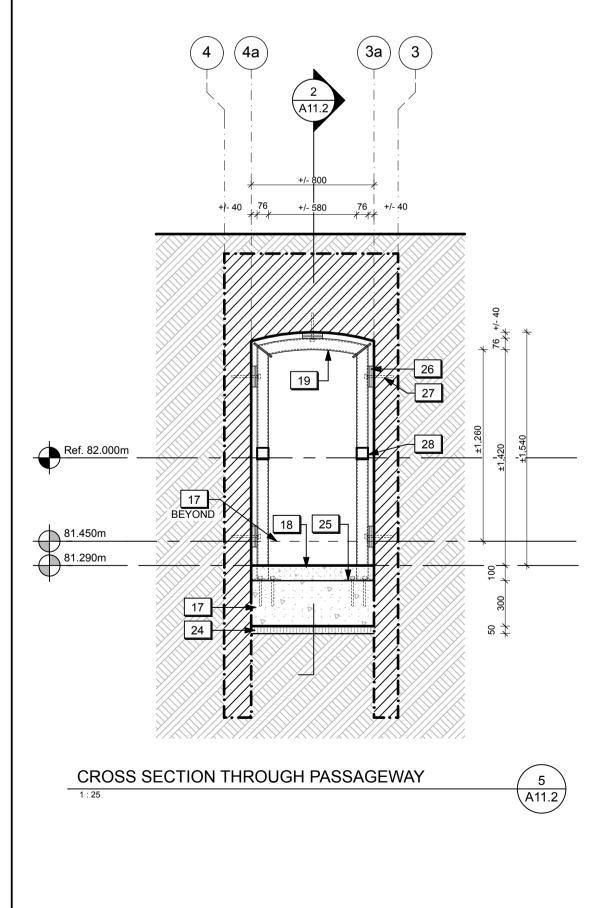

DRAWING NOTES (POWDER MAGAZINES – DETAILS):

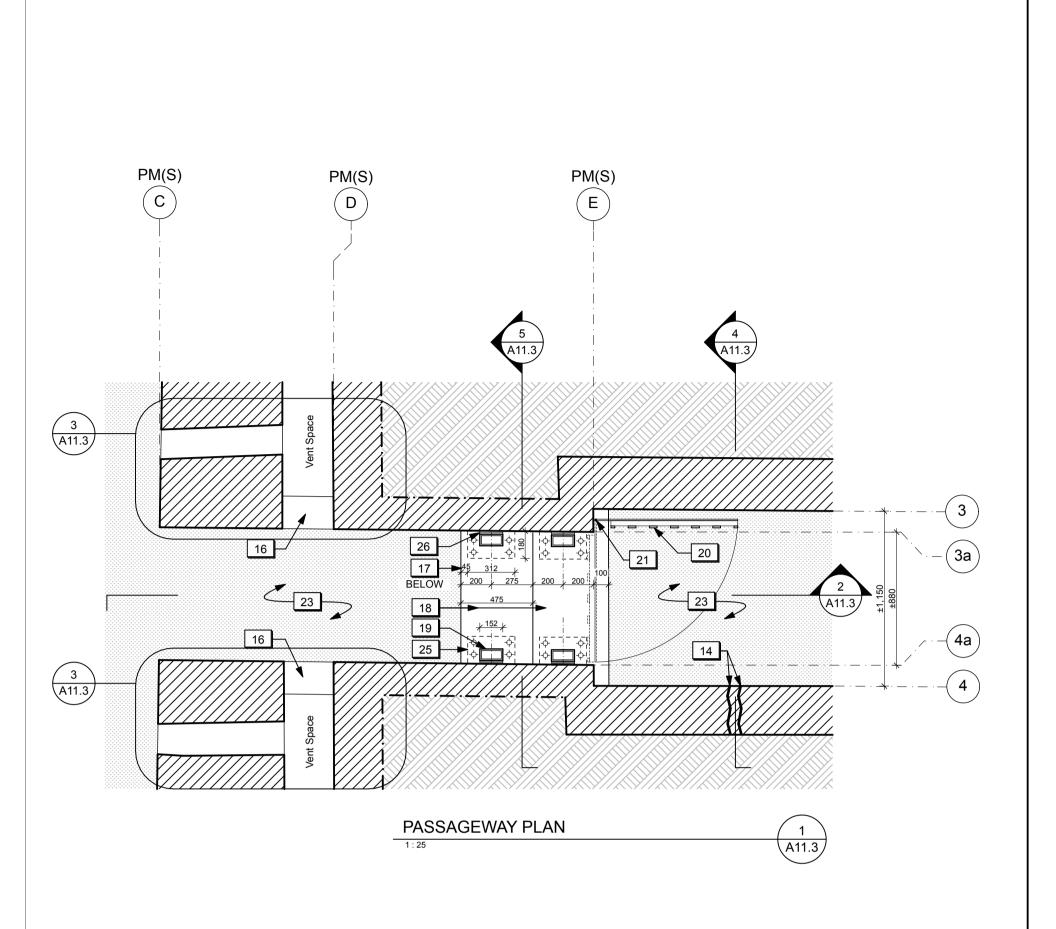

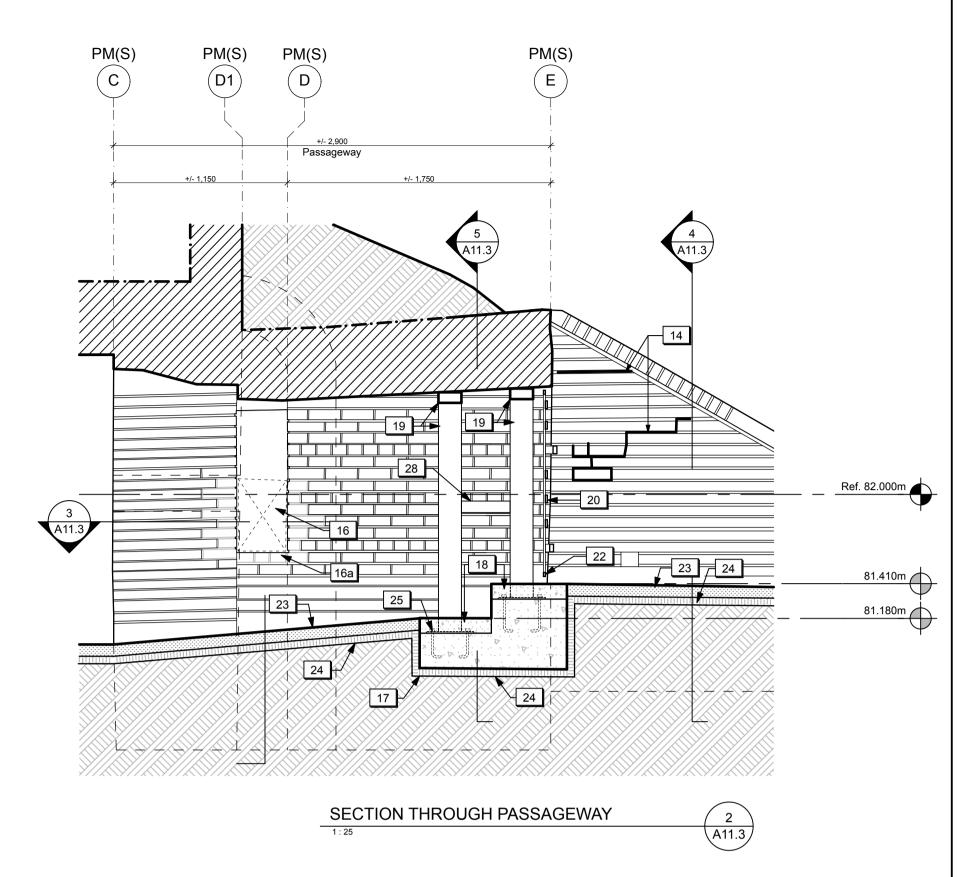

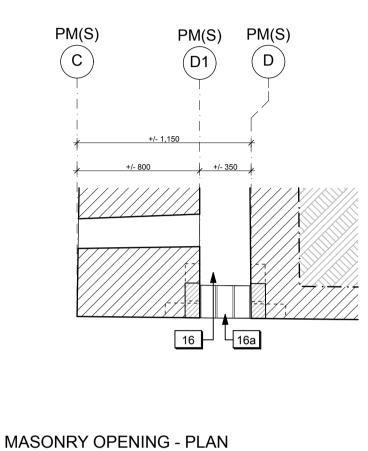



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| revision | issued / revisions | yyyy/mm/dd |

A Numero de detail B Sur feuille numero

Dimensions lineaires

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Signature File No. / No. de dossier


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Type of Record / Type d'enregistrement

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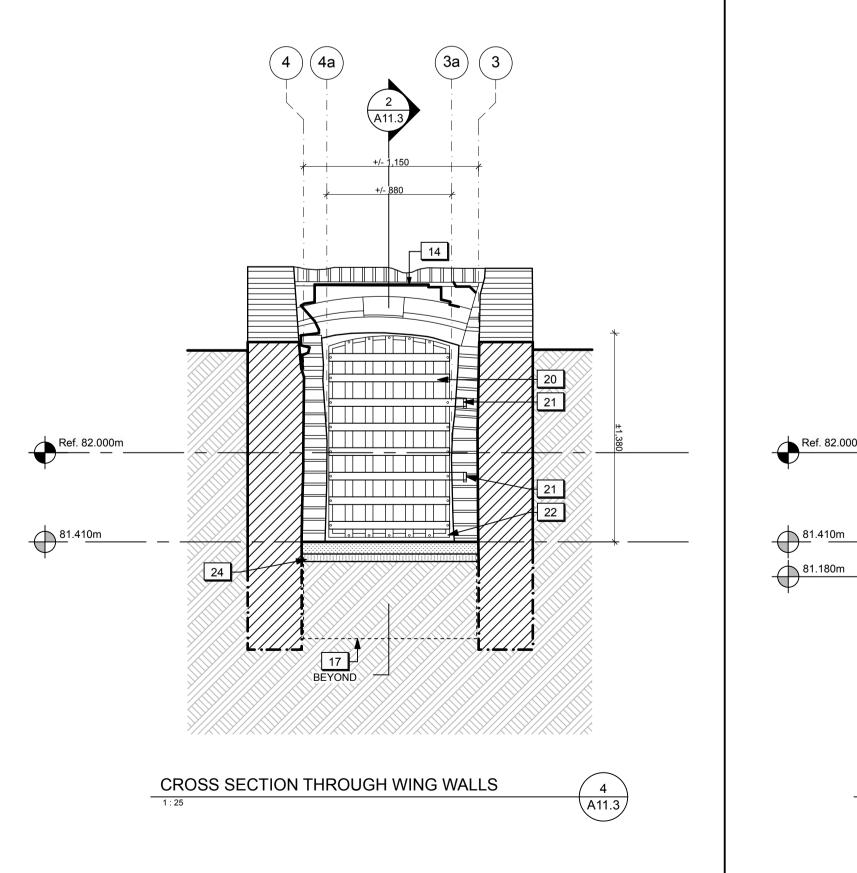
FORT MISSISSAUGA STABILIZATION PHASE II


Drawing title / Titre du dessin


SOUTH POWDER MAGAZINE -PASSAGEWAY DETAILS

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| C / ML | 2016.02.05 |
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Project No./ No. du projet PRO 000808 1300164 Drawing Reference No./No. du Dessin

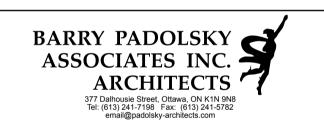



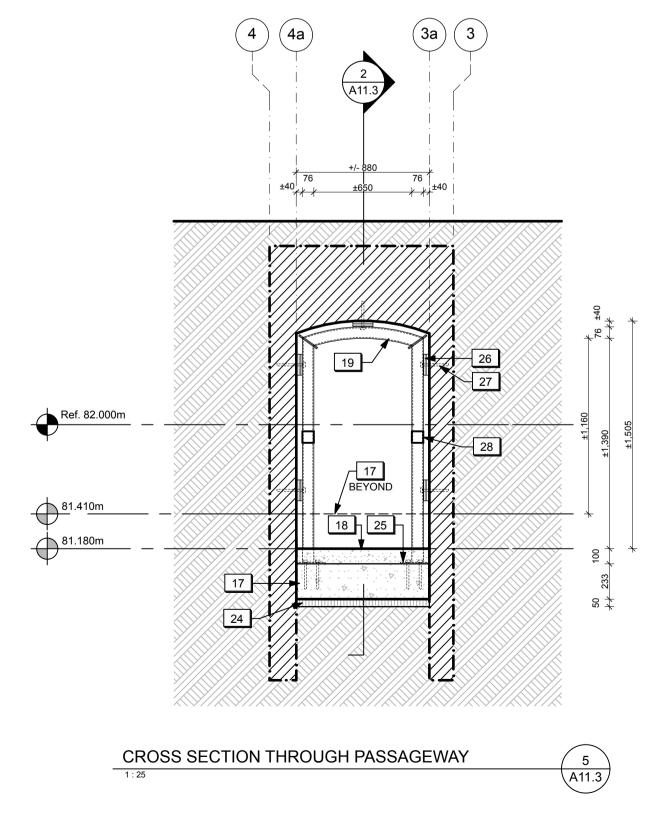


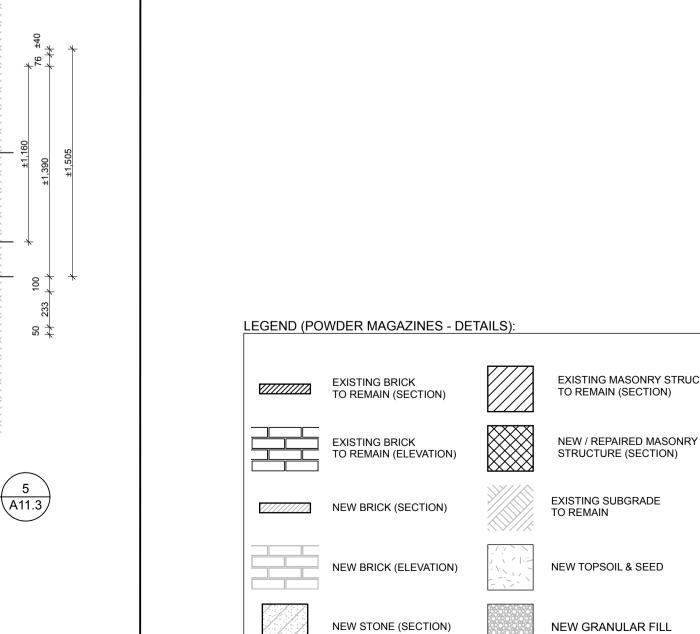
Existing grade in front of the parapet wall to be lowered. Refer to Landscape. Existing masonry opening into vent space to be enlarged. New brick sill. New concrete strut beam. Refer to Structural. New concrete topping. Refer to Structural. New HSS steel support frame. Refer to Structural. Existing metal gate to be restored and reinstalled. EXISTING MASONRY STRUCTURE TO REMAIN (SECTION) Hinge pins to be surface-mounted on face of existing masonry as required. Height of existing metal gate to be modified to accommodate revised grade. New stone dust surface. Refer to landscape. New 50 mm horizontal insulation. Refer to Landscape. New steel plate anchored to concrete strut beam. Refer to Structural. New steel shim plates. Refer to Structural. New steel anchor. Refer to Structural. New steel brace. Refer to Structural.

DRAWING NOTES (POWDER MAGAZINES – DETAILS):


New topsoil and seed. Refer to Landscape.

Area of localized masonry structural crack repairs (unit price).

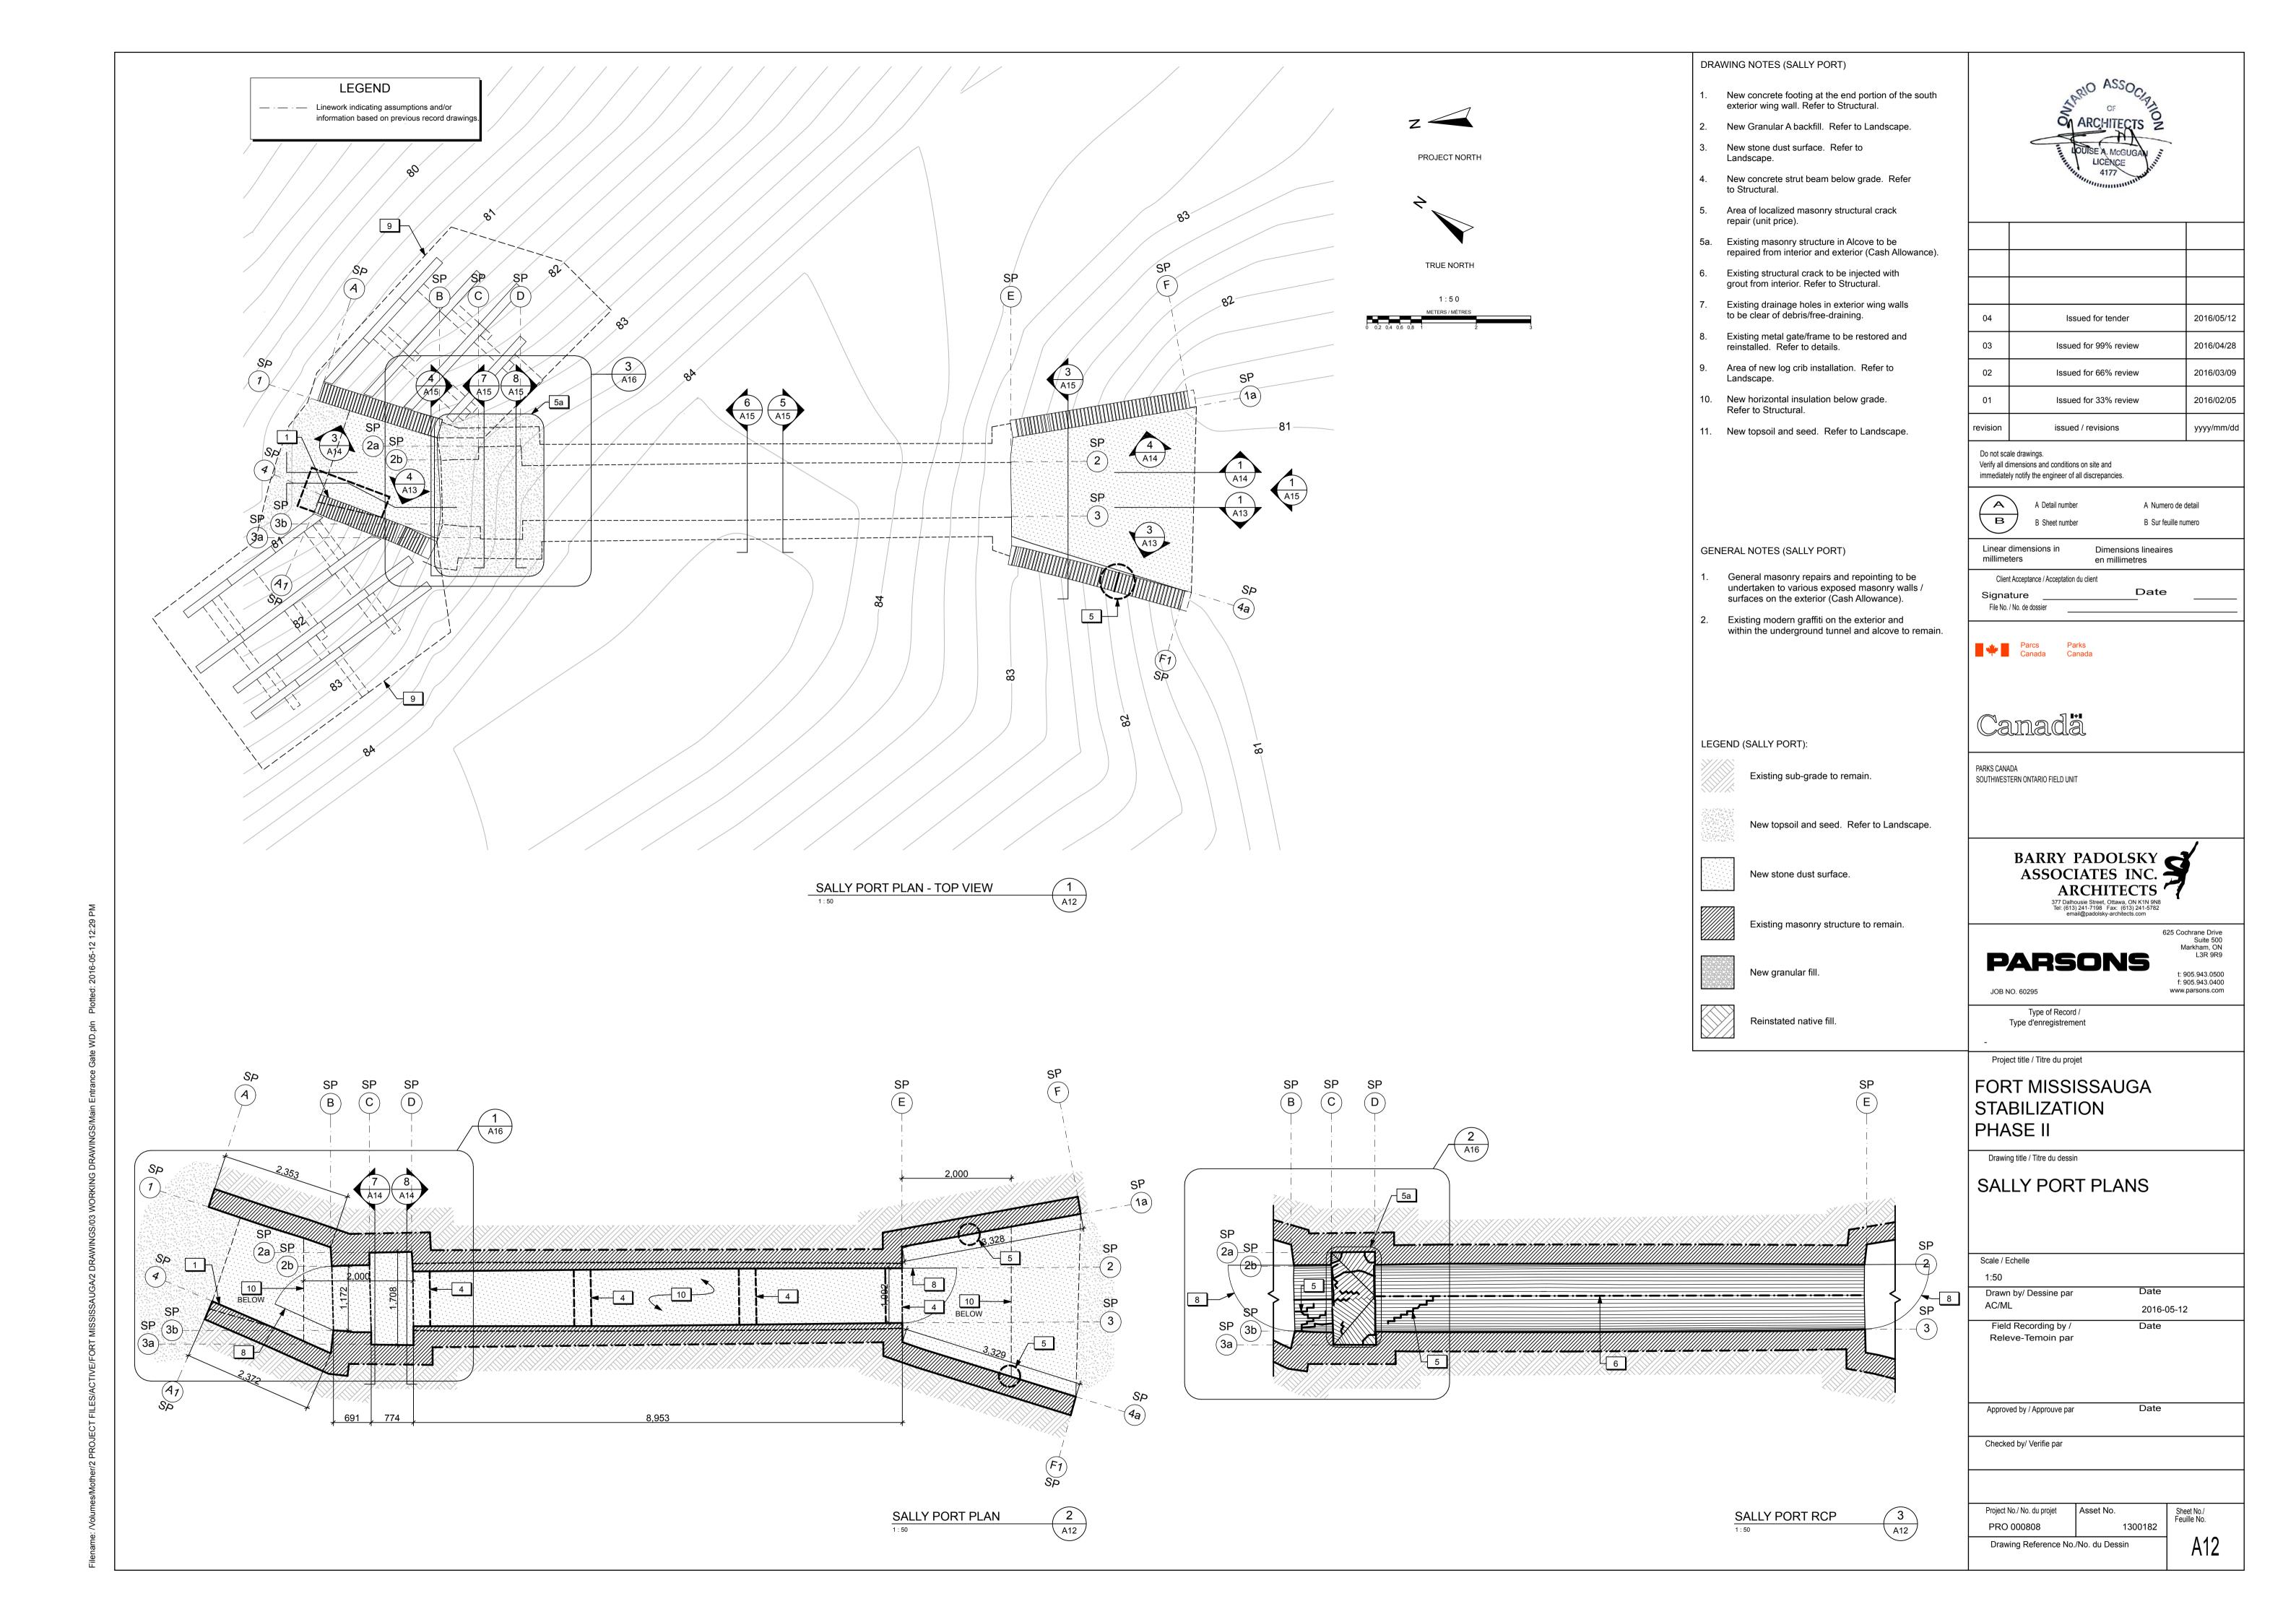


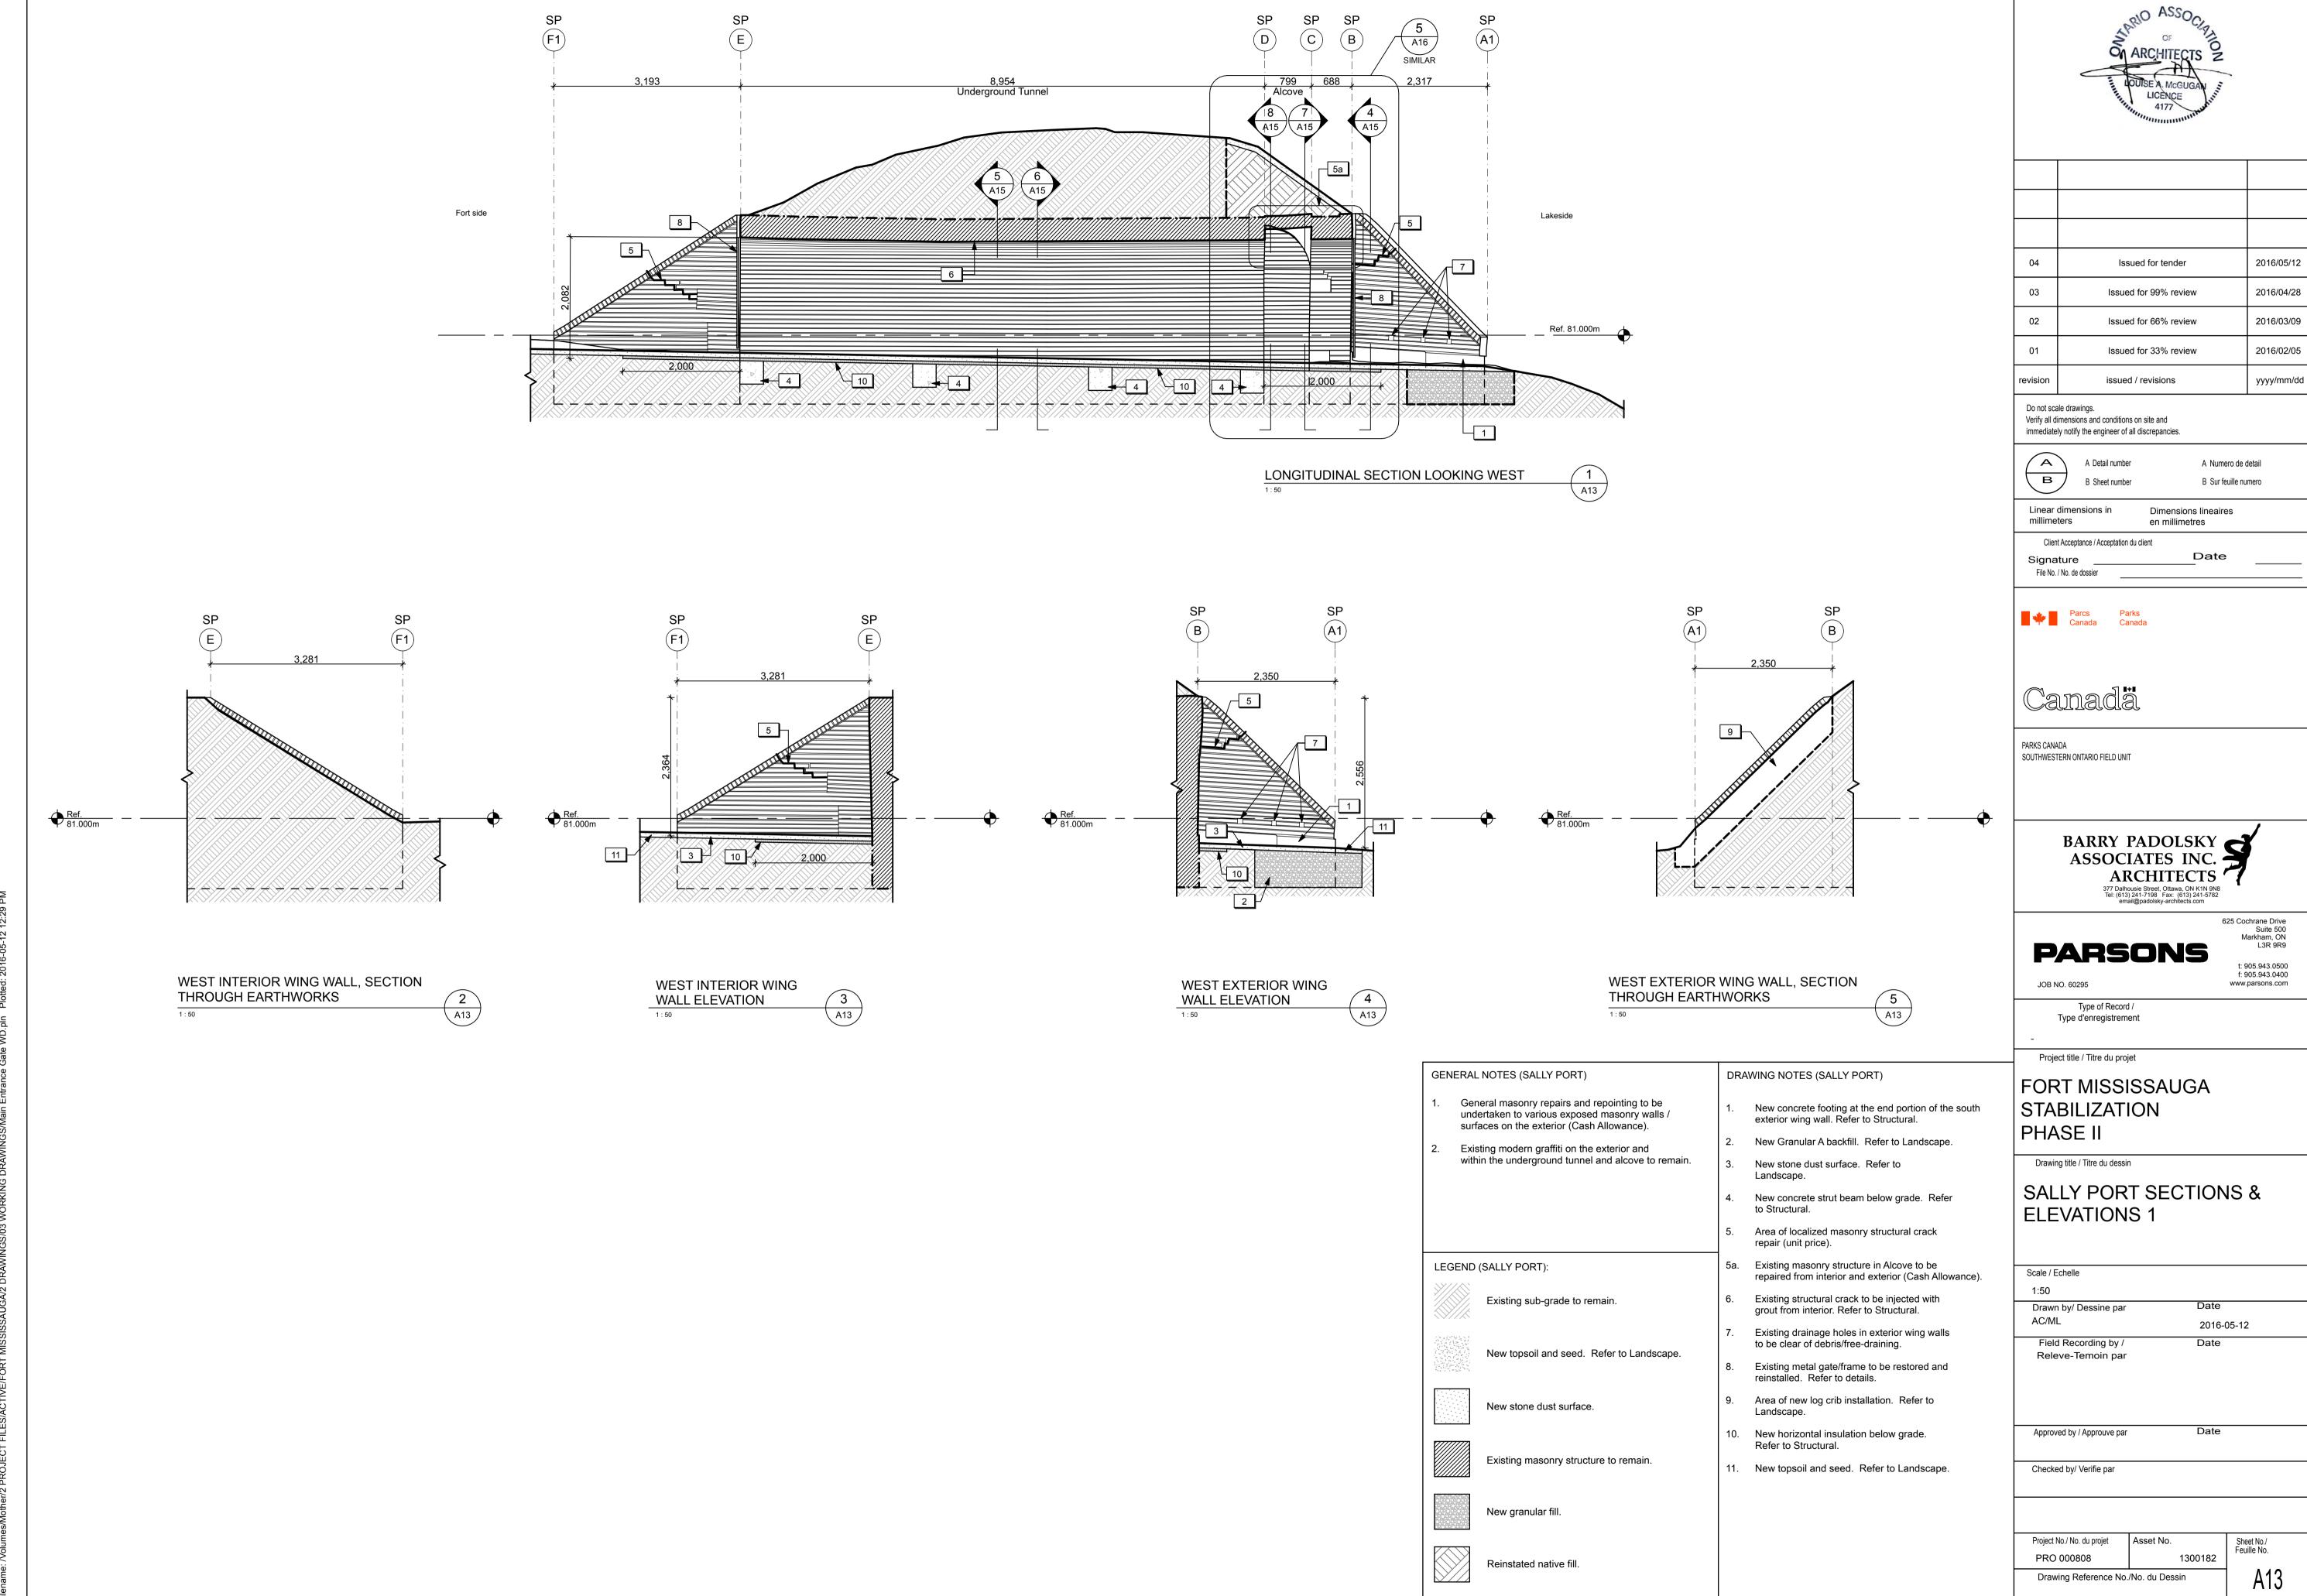



| 04 | Issued for tender | 2016/05/12 |
|----------|-----------------------|------------|
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| 02 | Issued for 66% review | 2016/03/09 |
| 01 | Issued for 33% review | 2016/02/05 |
| revision | issued / revisions | yyyy/mm/dd |

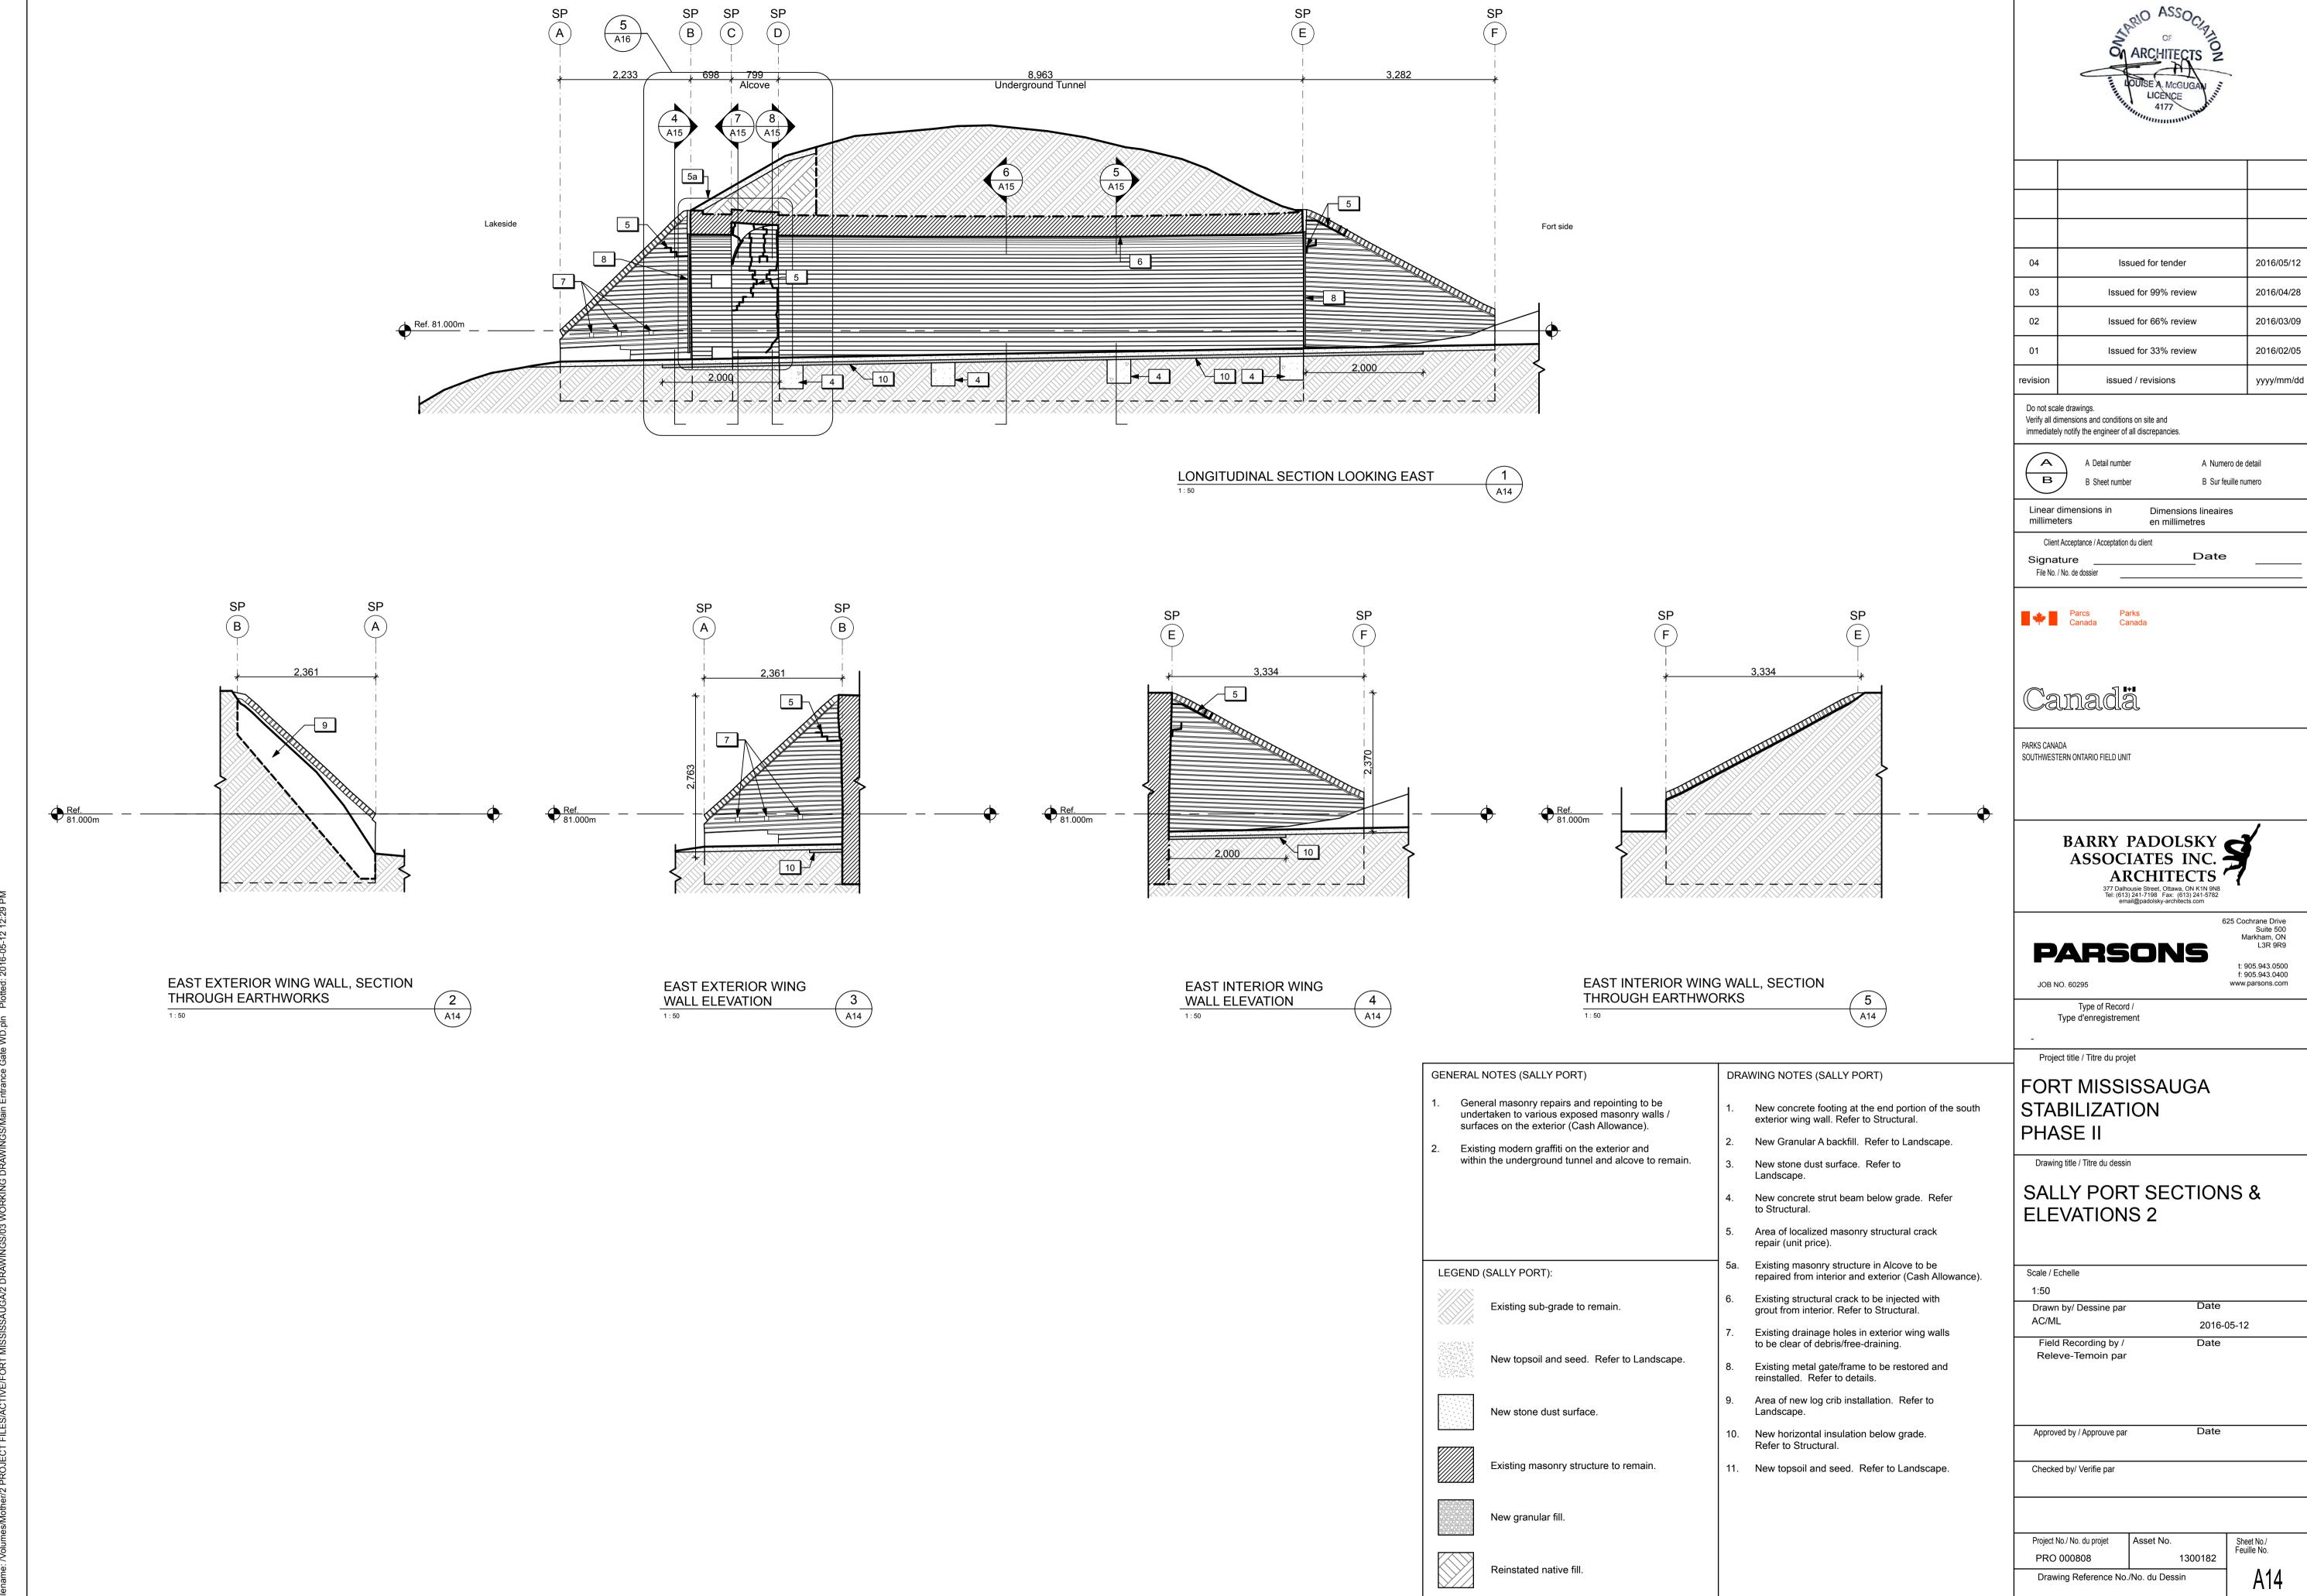


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A Numero de detail B Sur feuille numero

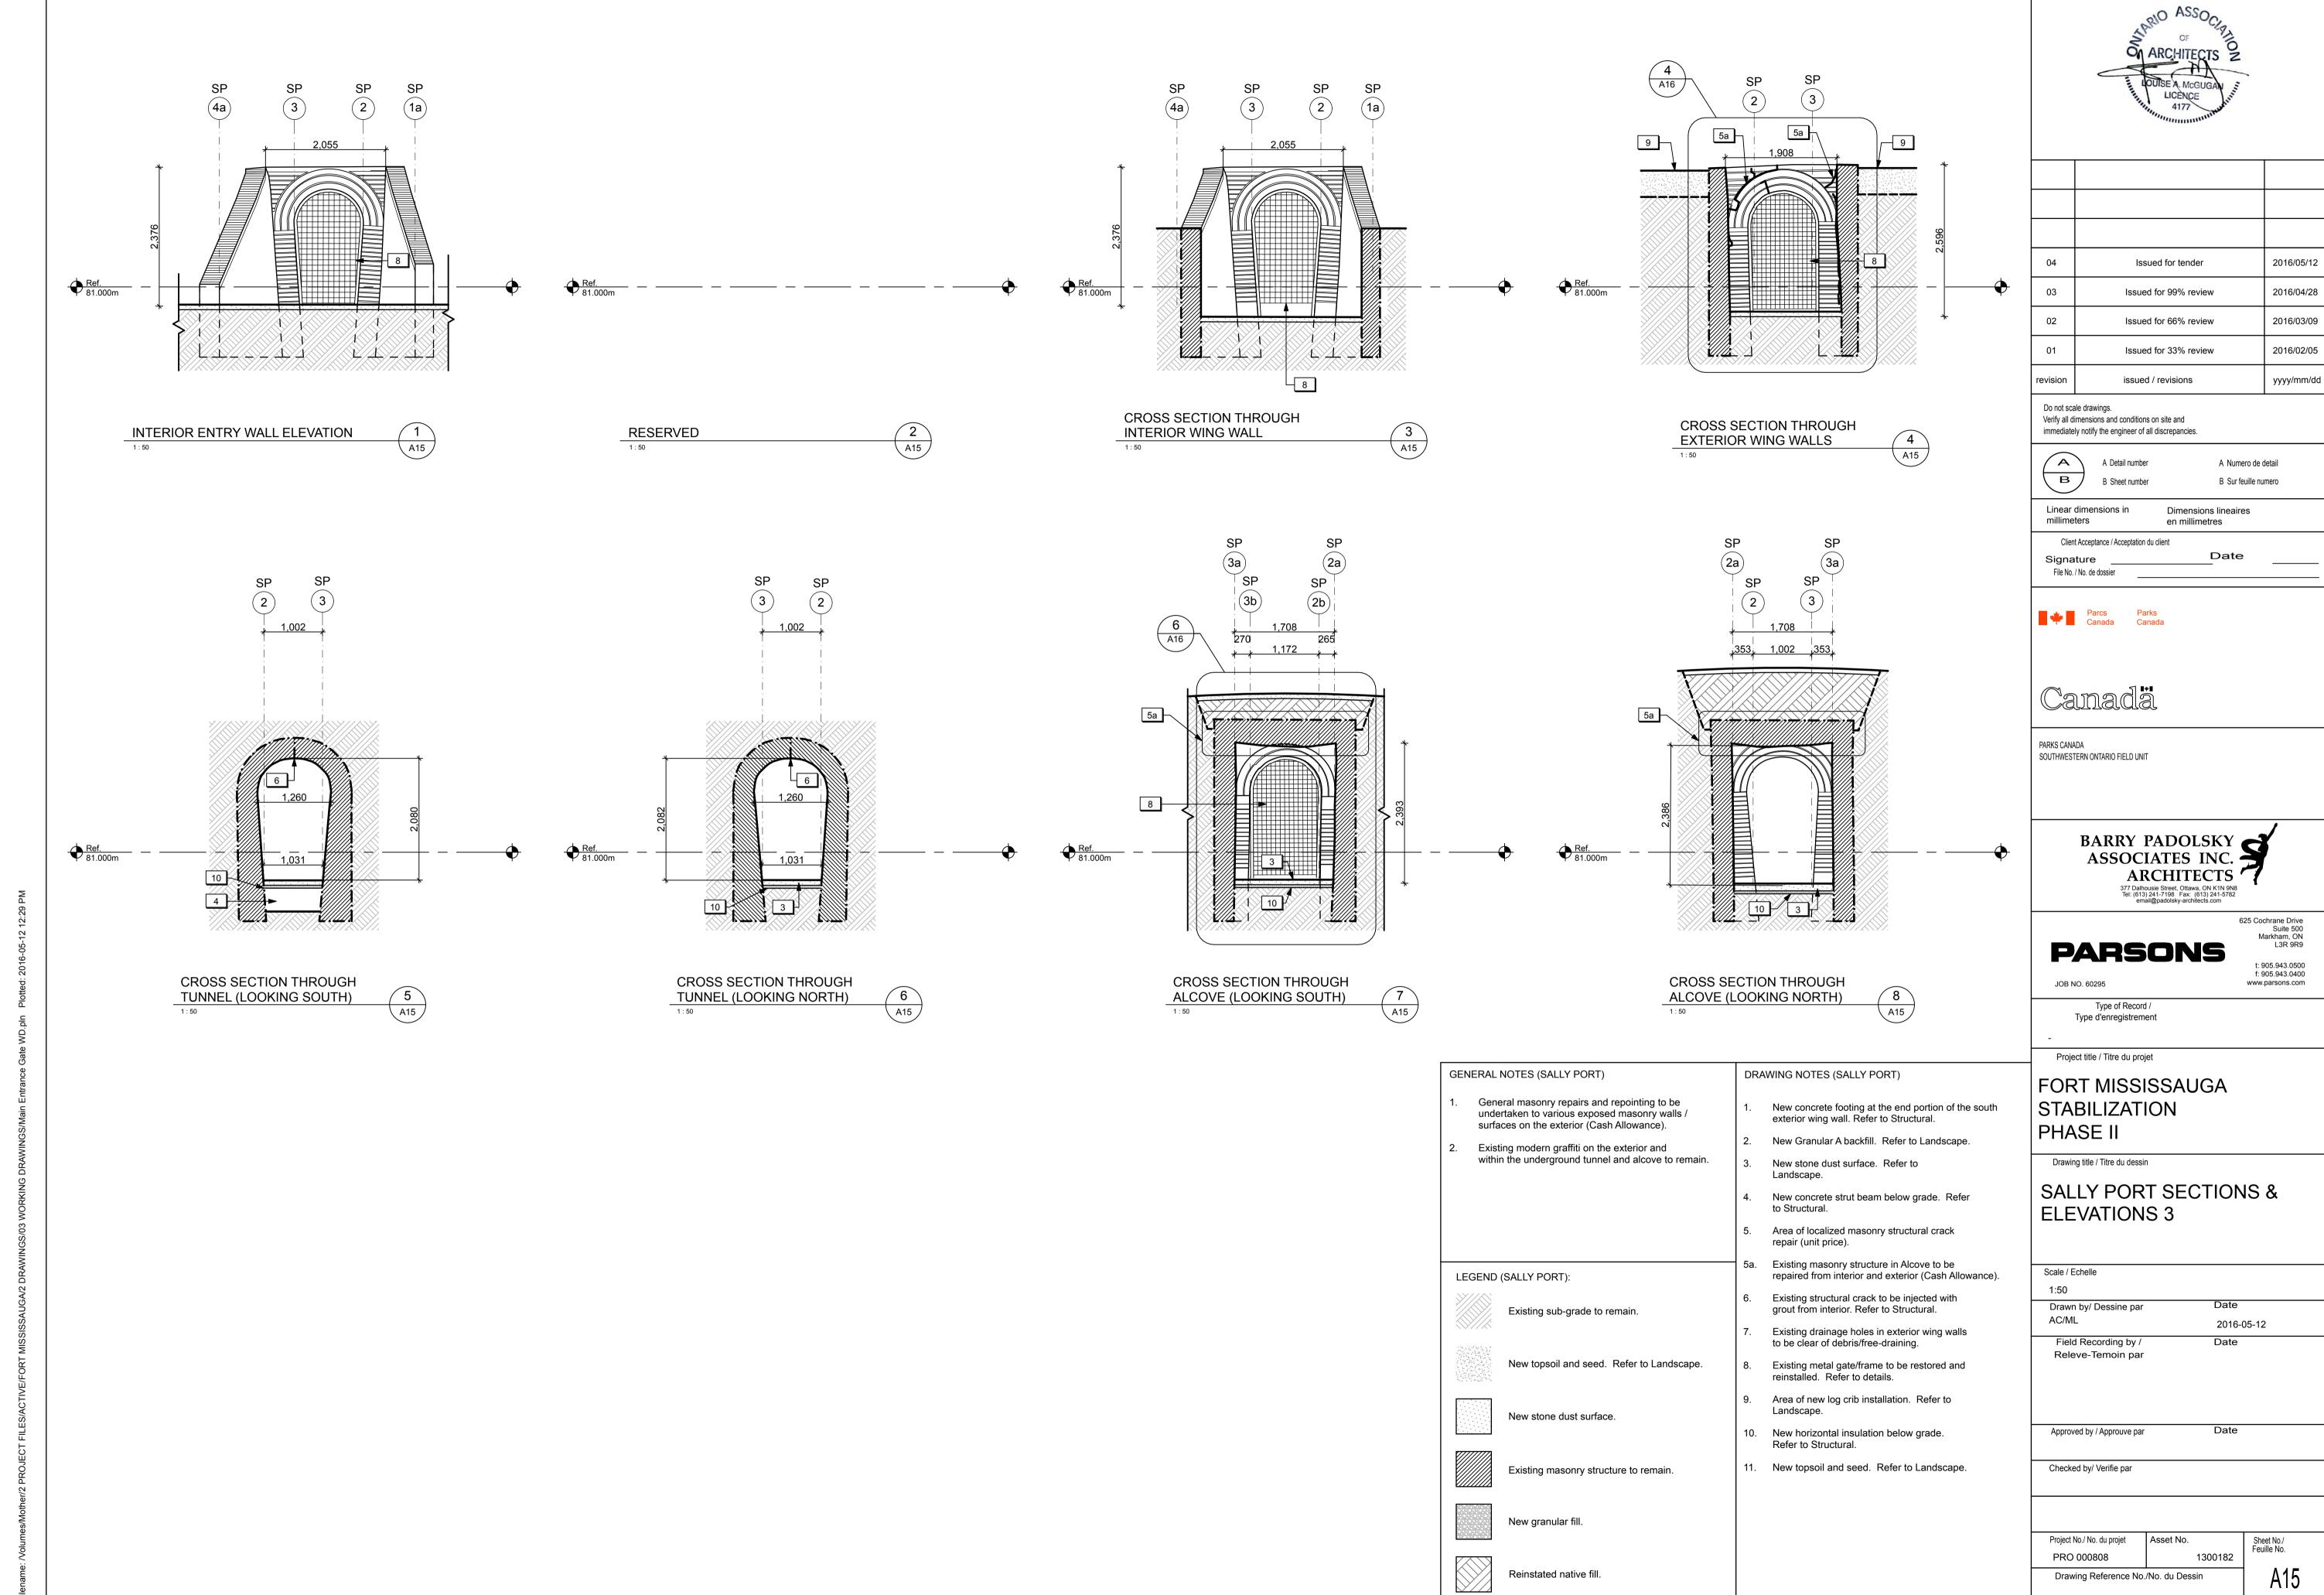
Dimensions lineaires en millimetres

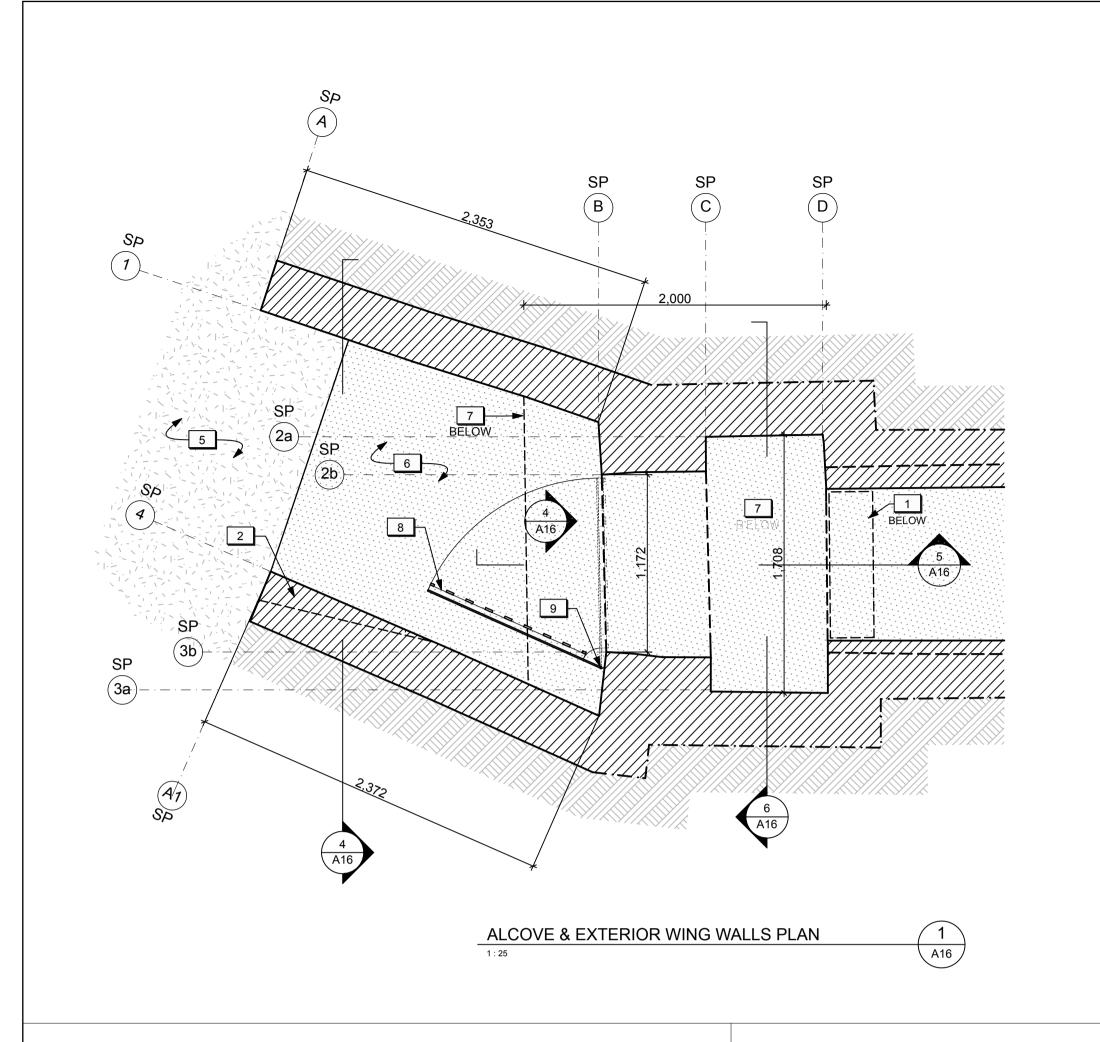Client Acceptance / Acceptation du client Signature File No. / No. de dossier

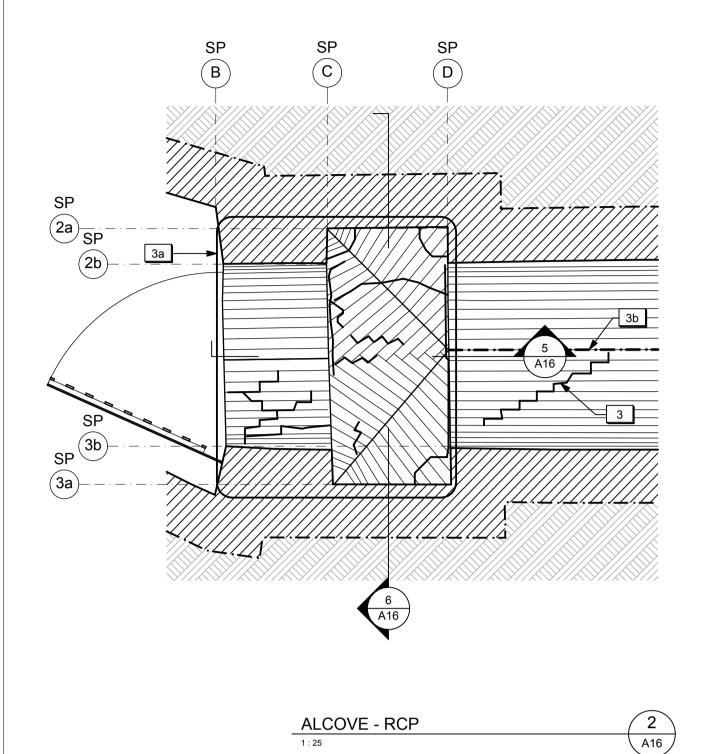

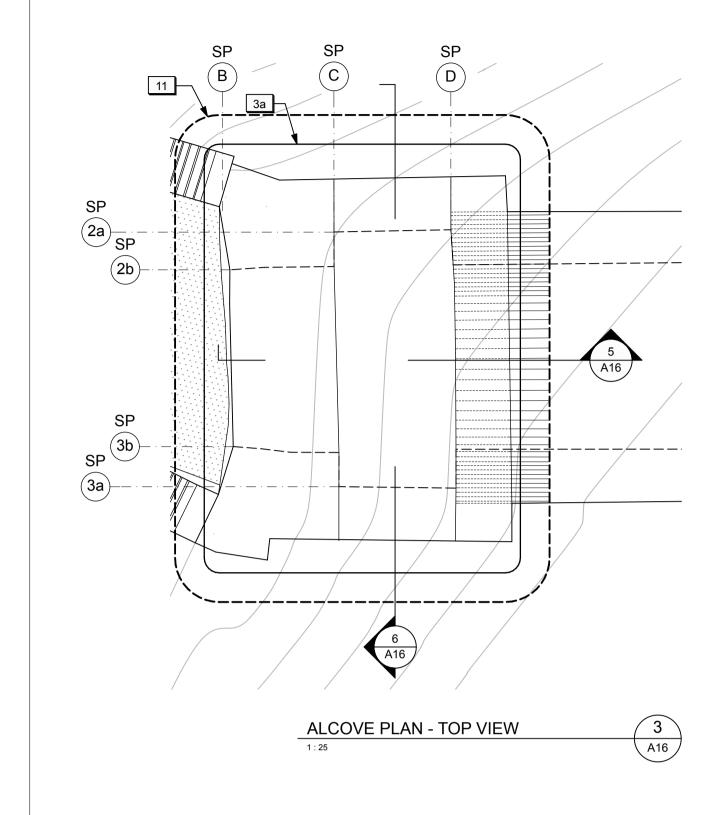

SOUTHWESTERN ONTARIO FIELD UNIT

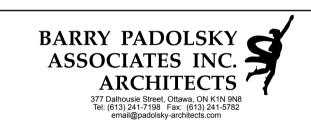

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Type d'enregistrement


Project title / Titre du projet

Type of Record /

FORT MISSISSAUGA STABILIZATION PHASE II

Drawing title / Titre du dessin

SALLY PORT DETAILS

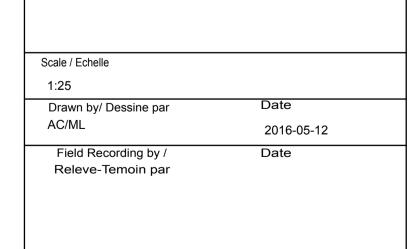


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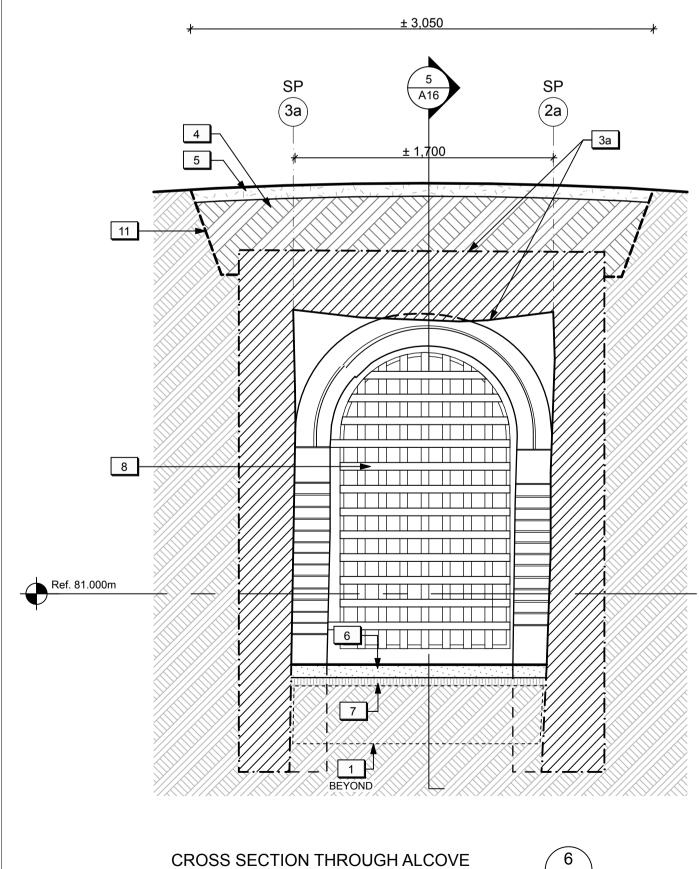
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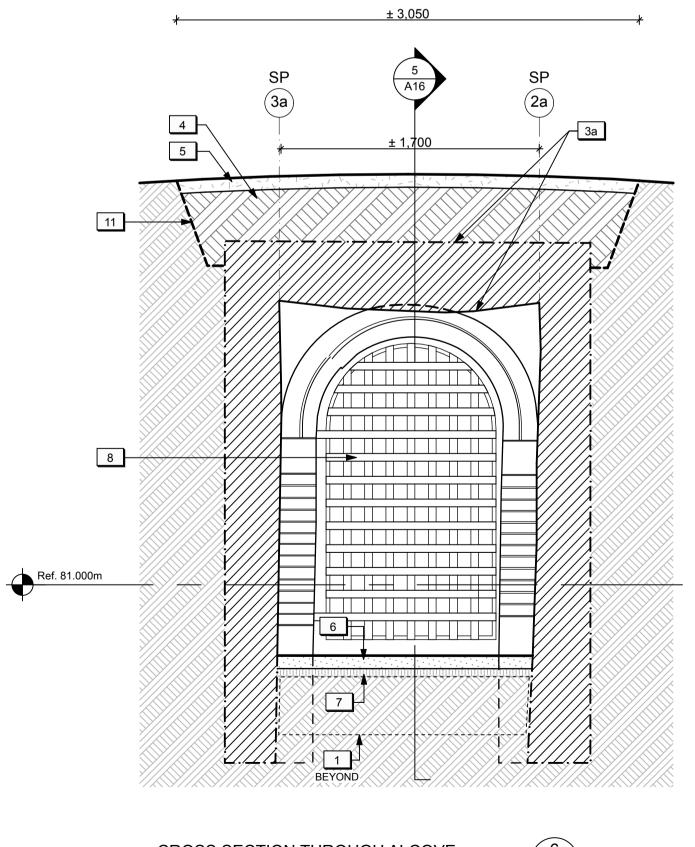
Project No./ No. du projet 1300182 PRO 000808 Drawing Reference No./No. du Dessin

3a 3a — Ref. 81.000m CROSS SECTION THROUGH EXTERIOR WING WALLS

1: 25 A16





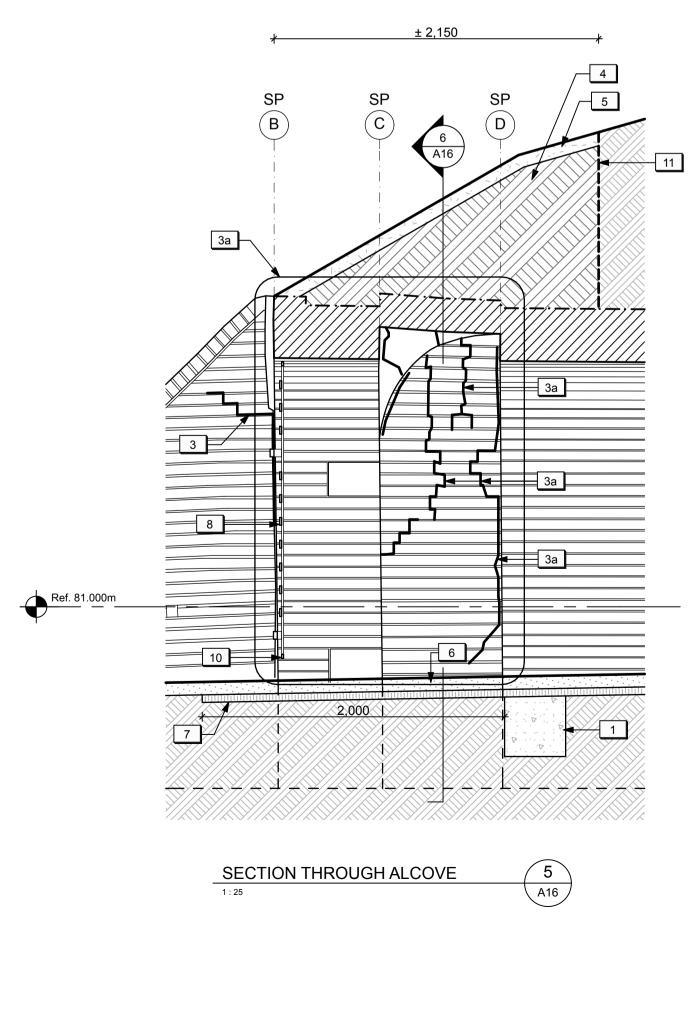

A16

New concrete strut beam below grade. Refer to Structural. New concrete footing at the end portion of the south exterior wing wall. Refer to Structural.

DRAWING NOTES (SALLY PORT - DETAILS):

LEGEND (SALLY PORT):

Existing sub-grade to remain.

New topsoil and seed.

New granular fill.

Reinstated native fill.

Area of localized masonry structural crack repairs (unit price). Existing masonry structure in Alcove to be repaired from

interior and exterior (Cash Allowance). Existing structural crack to be injected with epoxy from interior. Refer to Structural.

New granular fill. Refer to Landscape.


New topsoil and seed. Refer to Landscape.


New stone dust surface. Refer to Landscape. New horizontal insulation. Refer to Landscape.

Existing metal gate to be restored and reinstalled. Hinge pins to be surface-mounted on face of existing

Height of existing metal gate to be modified to accommodate new/revised grade. Extent of hand excavation above Alcove structure. Refer to

12. New log cribs walls. Refer to Landscape.

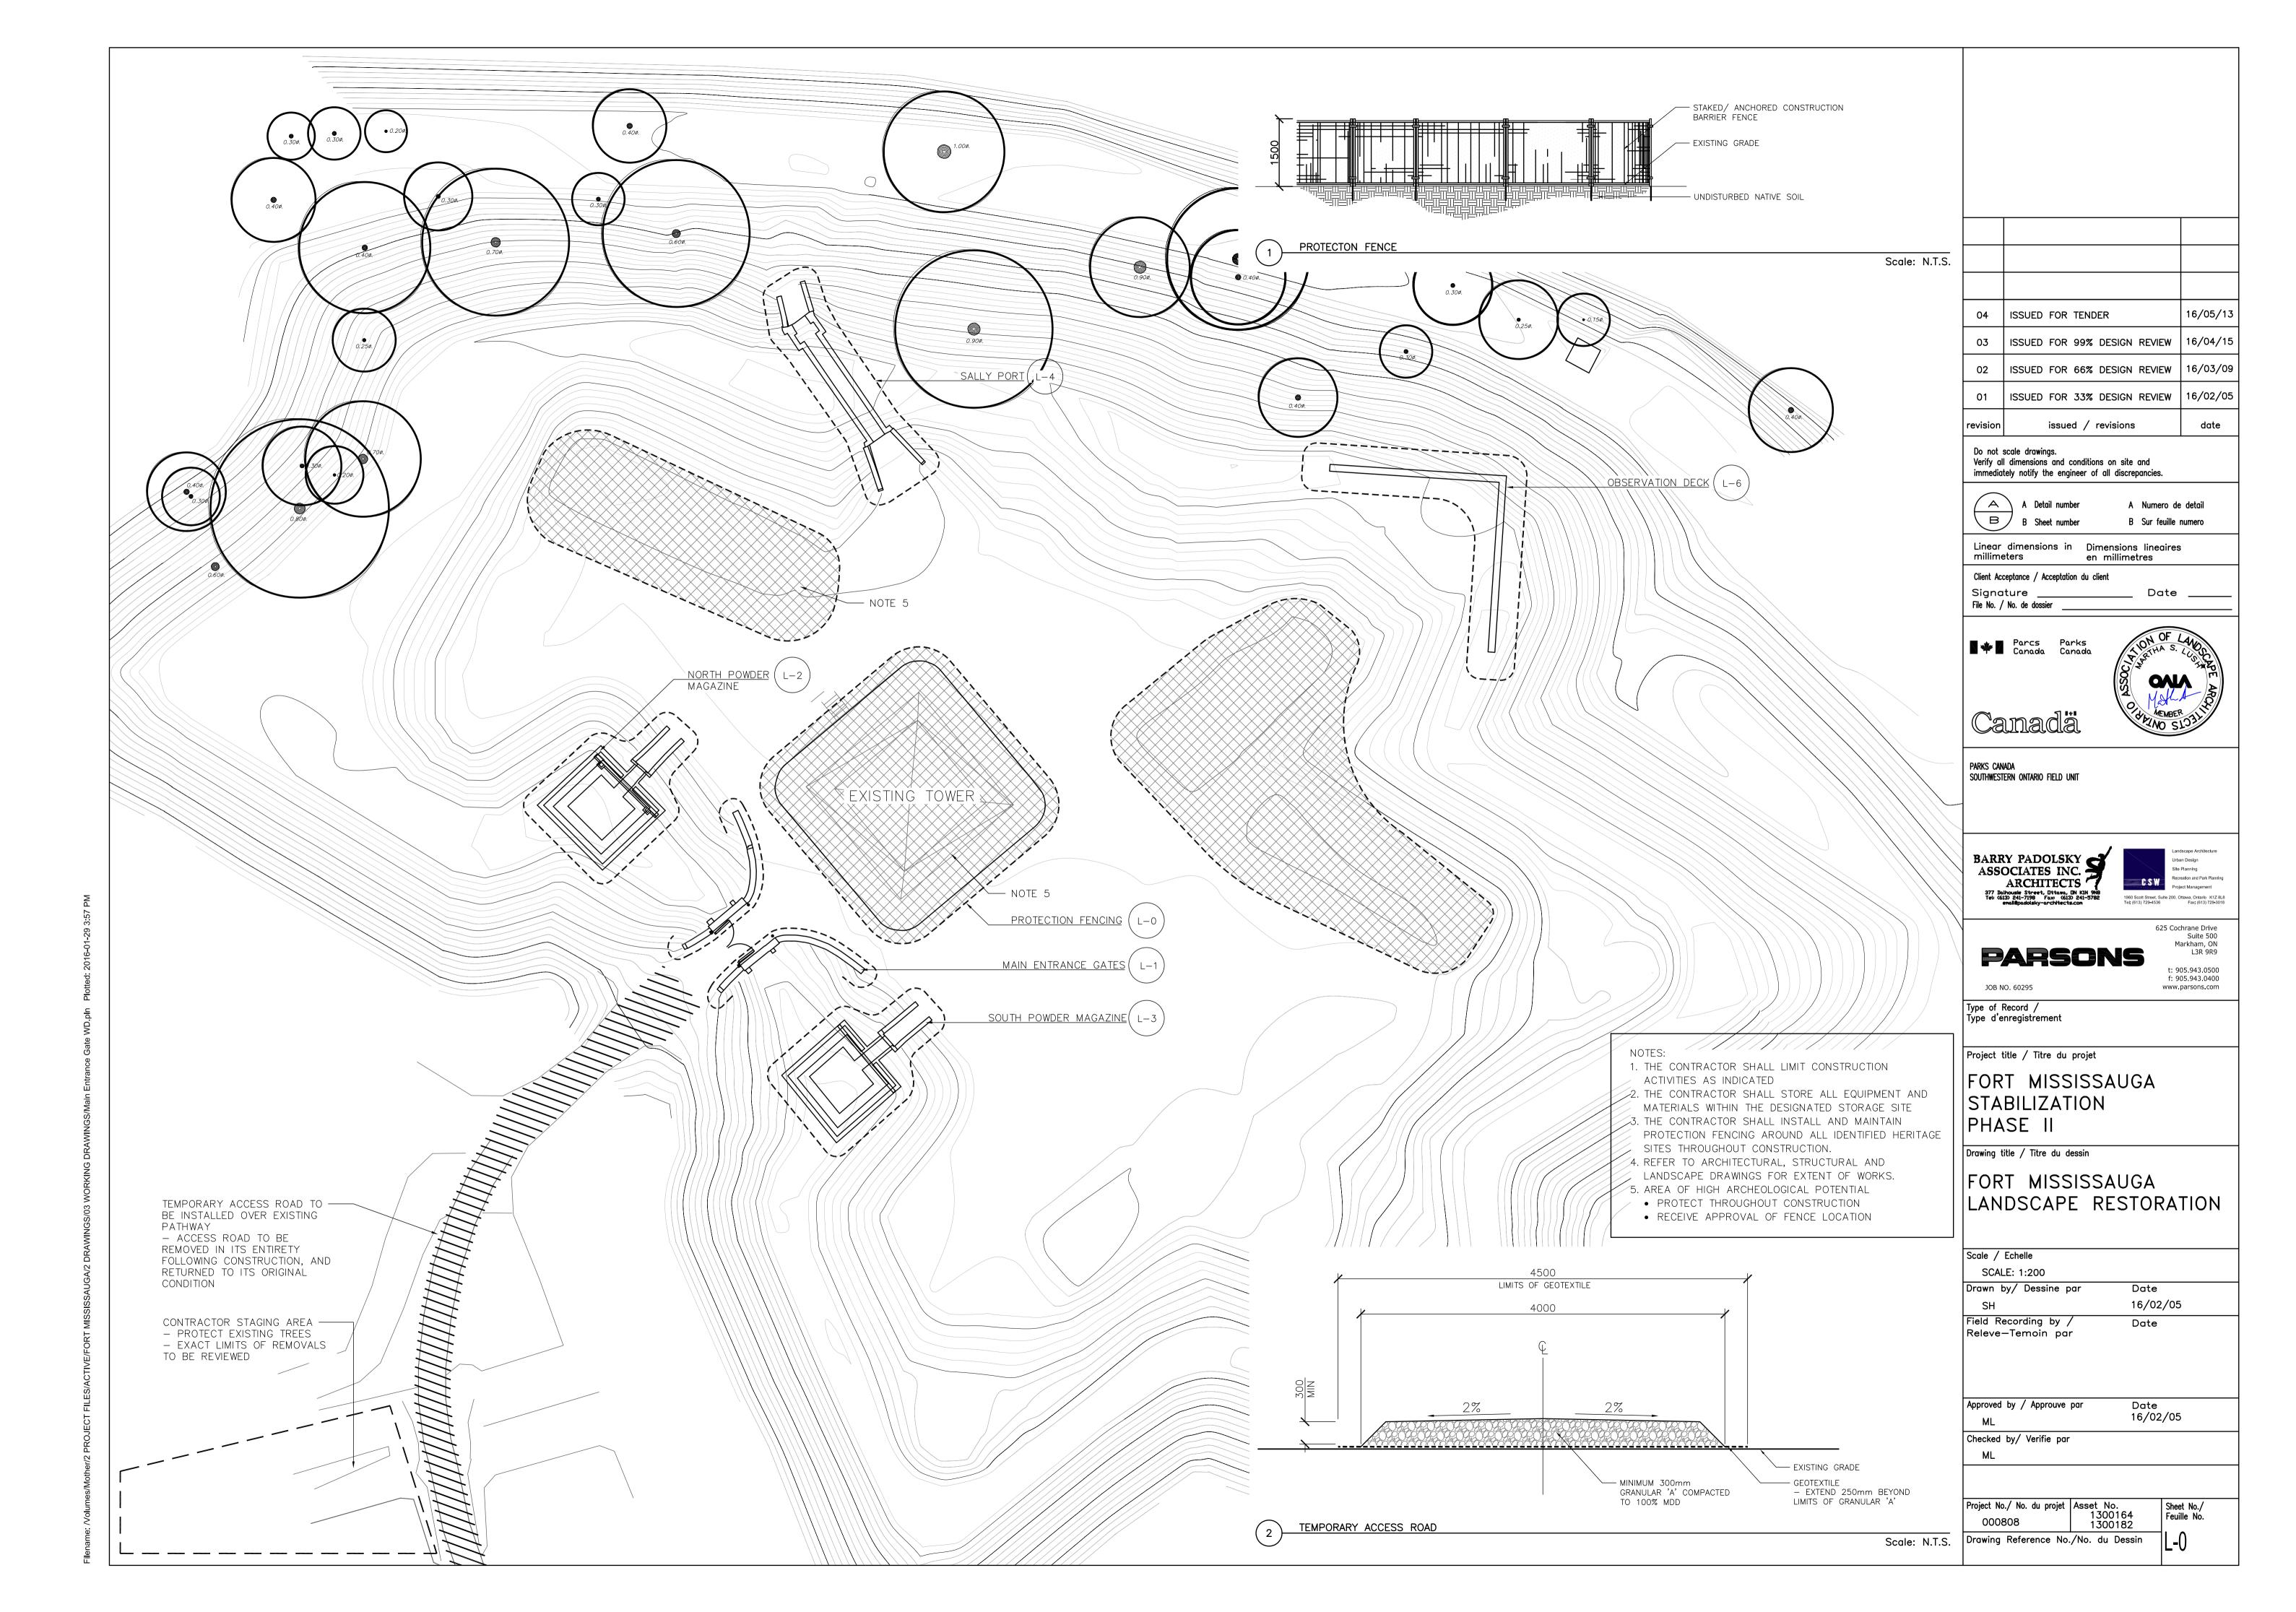

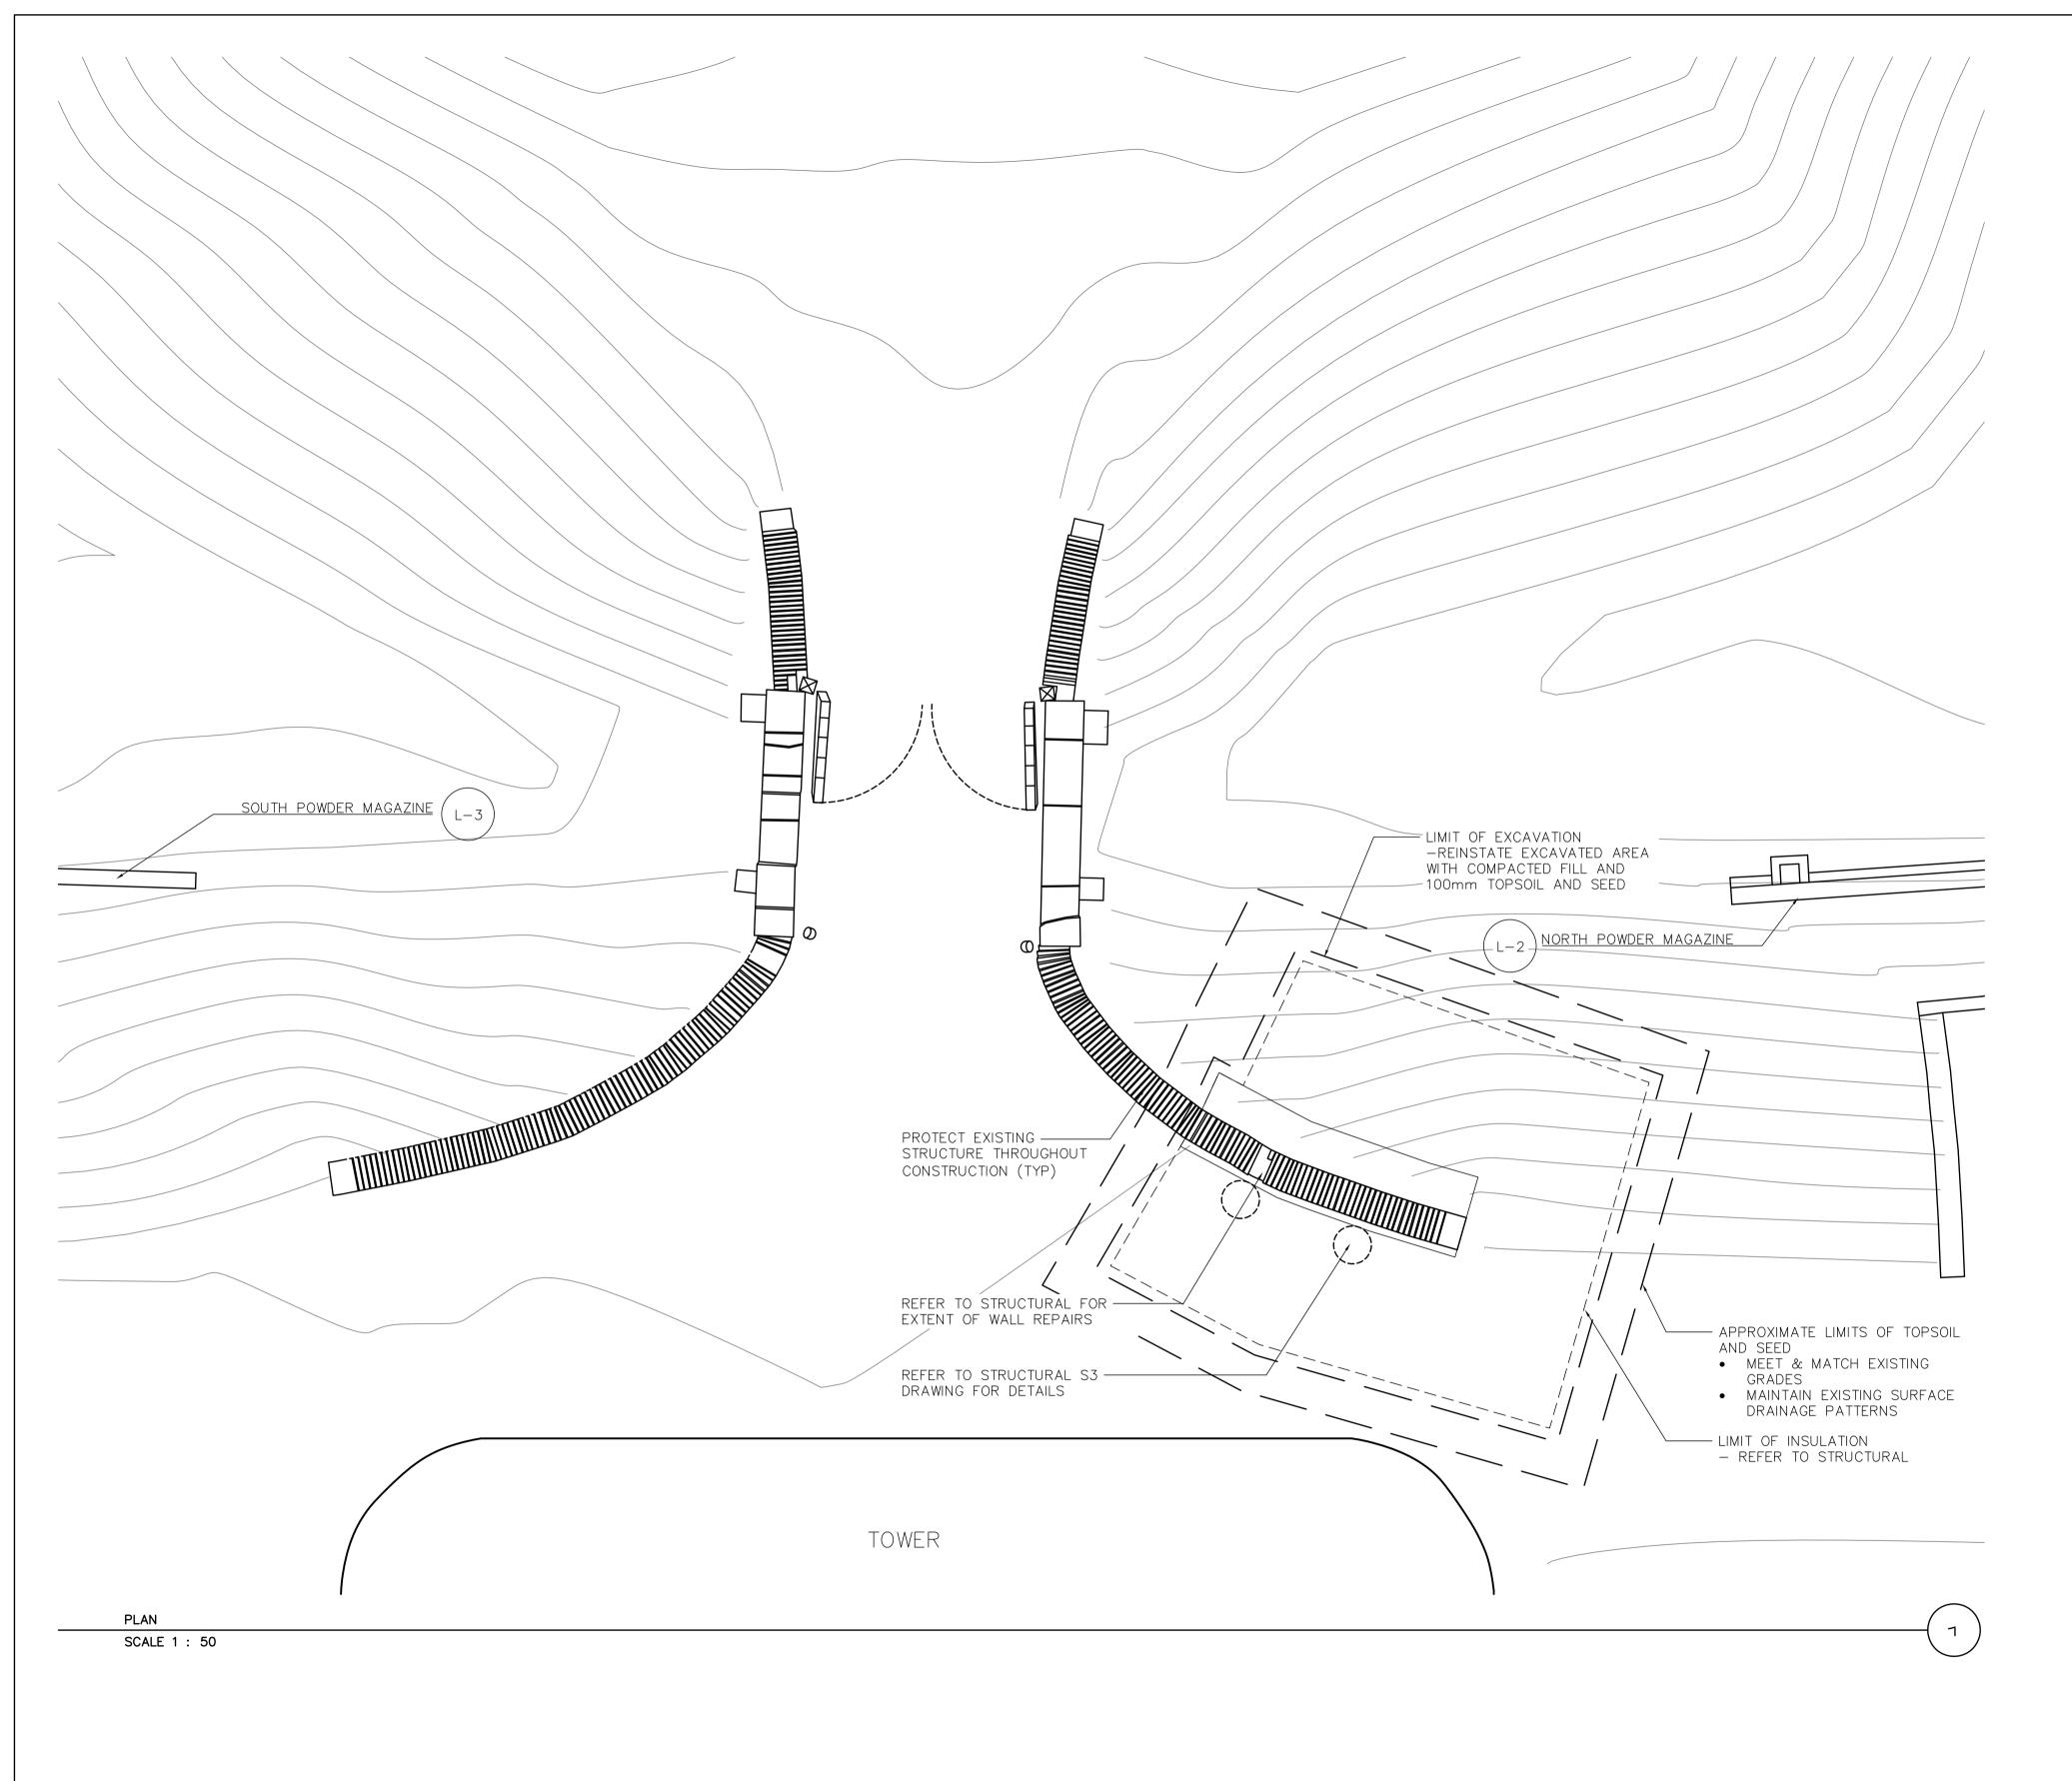

16/05/13 ISSUED FOR TENDER ISSUED FOR 99% DESIGN REVIEW 16/04/15 ISSUED FOR 66% DESIGN REVIEW 16/03/09 16/02/05 ISSUED FOR 33% DESIGN REVIEW issued / revisions

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 $\langle A \rangle$

A Detail number

A Numero de detail B Sur feuille numero

Linear dimensions in Dimensions lineaires en millimetres

Client Acceptance / Acceptation du client Signature

File No. / No. de dossier

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Canadä

PARKS CANADA SOUTHWESTERN ONTARIO FIELD UNIT

BARRY PADOLSKY
ASSOCIATES INC.

ARCHITECTS

377 Dalhousie Street, Dttawa, DN KIN 9N8
Teli (613) 241-7198 Fax: (613) 241-5782
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Landscape Architecture
Urban Design
Site Planning
Recreation and Park Planning
Project Management

1960 Scott Street, Sulle 200, Ottawa, Ontario K12 8L8
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FORT MISSISSAUGA STABILIZATION PHASE II


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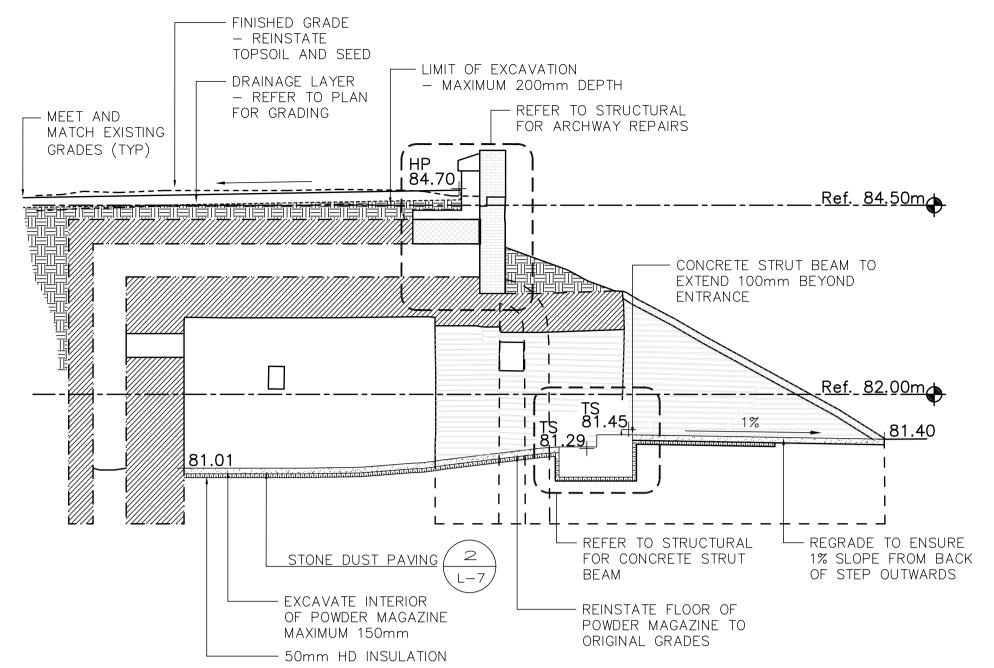
MAIN ENTRANCE GATE LANDSCAPE RESTORATION

Scale / Echelle SCALE: AS NOTED Drawn by/ Dessine par Date 16/02/05 Field Recording by / Releve—Temoin par Date

Approved by / Approuve par 16/02/05 Checked by/ Verifie par

Sheet No./ Feuille No. Project No./ No. du projet | Asset No. 808000 1300164 Drawing Reference No./No. du Dessin



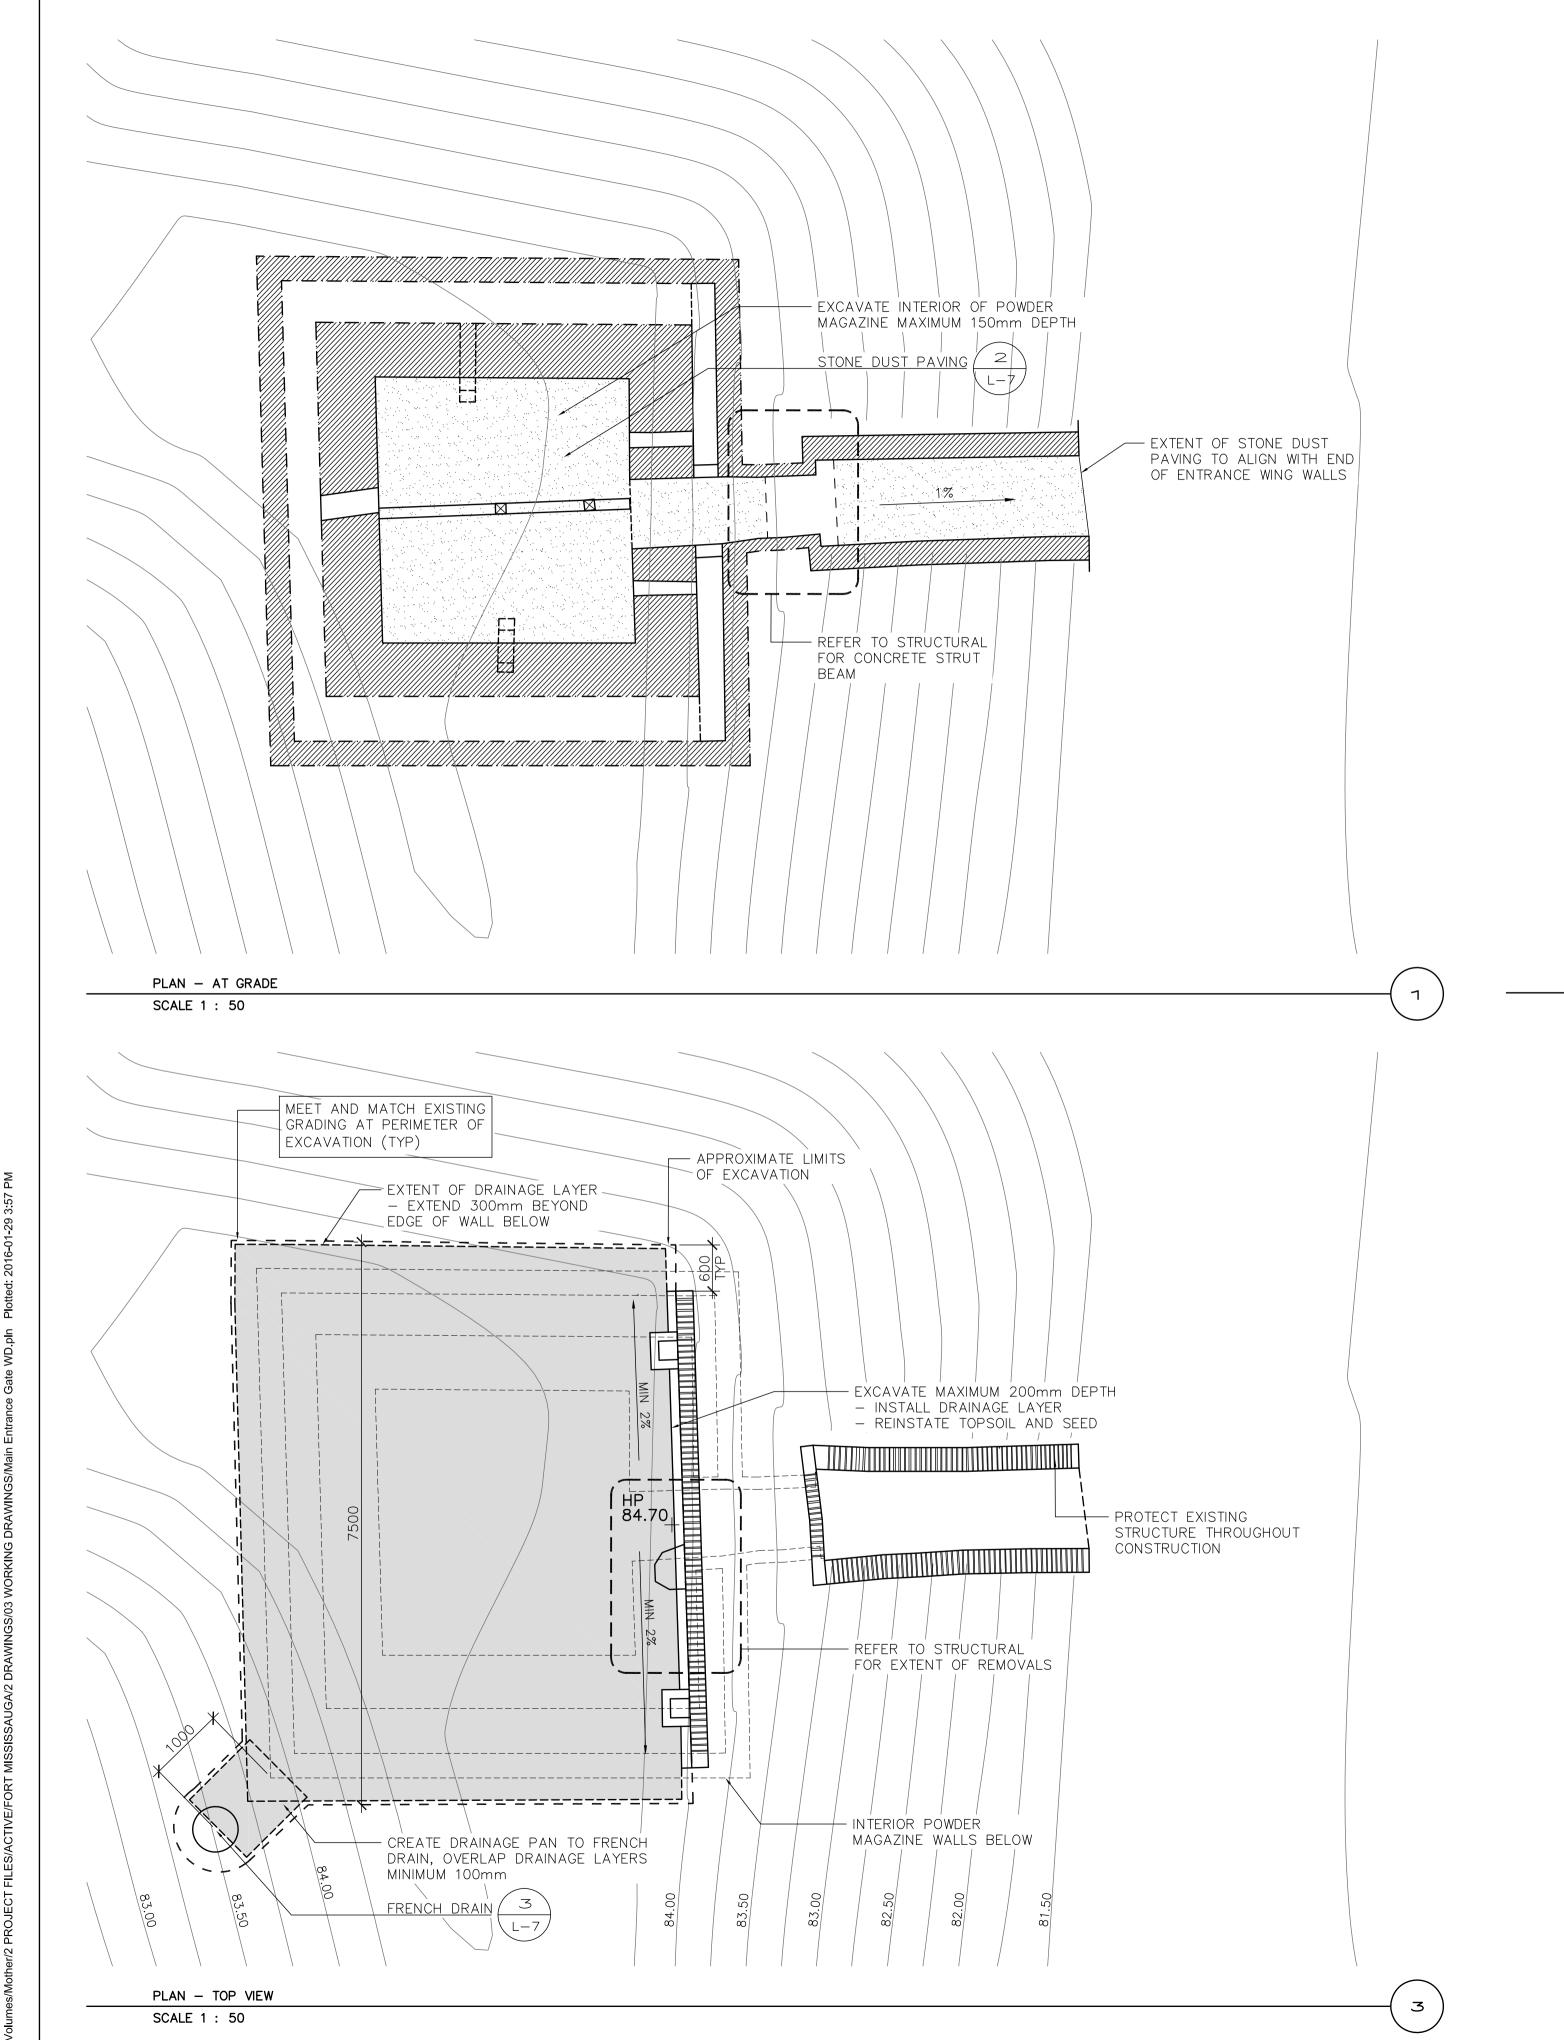

SECTION

SCALE 1 : 50

ISSUED FOR TENDER 16/05/13 04 16/04/15 ISSUED FOR 99% DESIGN REVIEW 16/03/09 02 ISSUED FOR 66% DESIGN REVIEW 16/02/05 01 ISSUED FOR 33% DESIGN REVIEW revision issued / revisions

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A Detail number (B)

A Numero de detail B Sur feuille numero

Linear dimensions in Dimensions lineaires millimeters en millimetres

Client Acceptance / Acceptation du client

Signature File No. / No. de dossier

Parcs Parks
Canada Canada

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Parks Canada Southwestern ontario field unit

BARRY PADOLSKY
ASSOCIATES INC.
ARCHITECTS

377 Dalhousie Street, Ottawa, DN KIN ONE
Tel: (512) 257 377 Dalhousie Street, Ottawa, DN KIN 9N8 Teli (613) 241–7198 Faxi (613) 241–5782 email@padolsky-architects.com

PARSONS

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625 Cochrane Drive Suite 500 Markham, ON

Type of Record /
Type d'enregistrement

JOB NO. 60295

Project title / Titre du projet

FORT MISSISSAUGA STABILIZATION PHASE II


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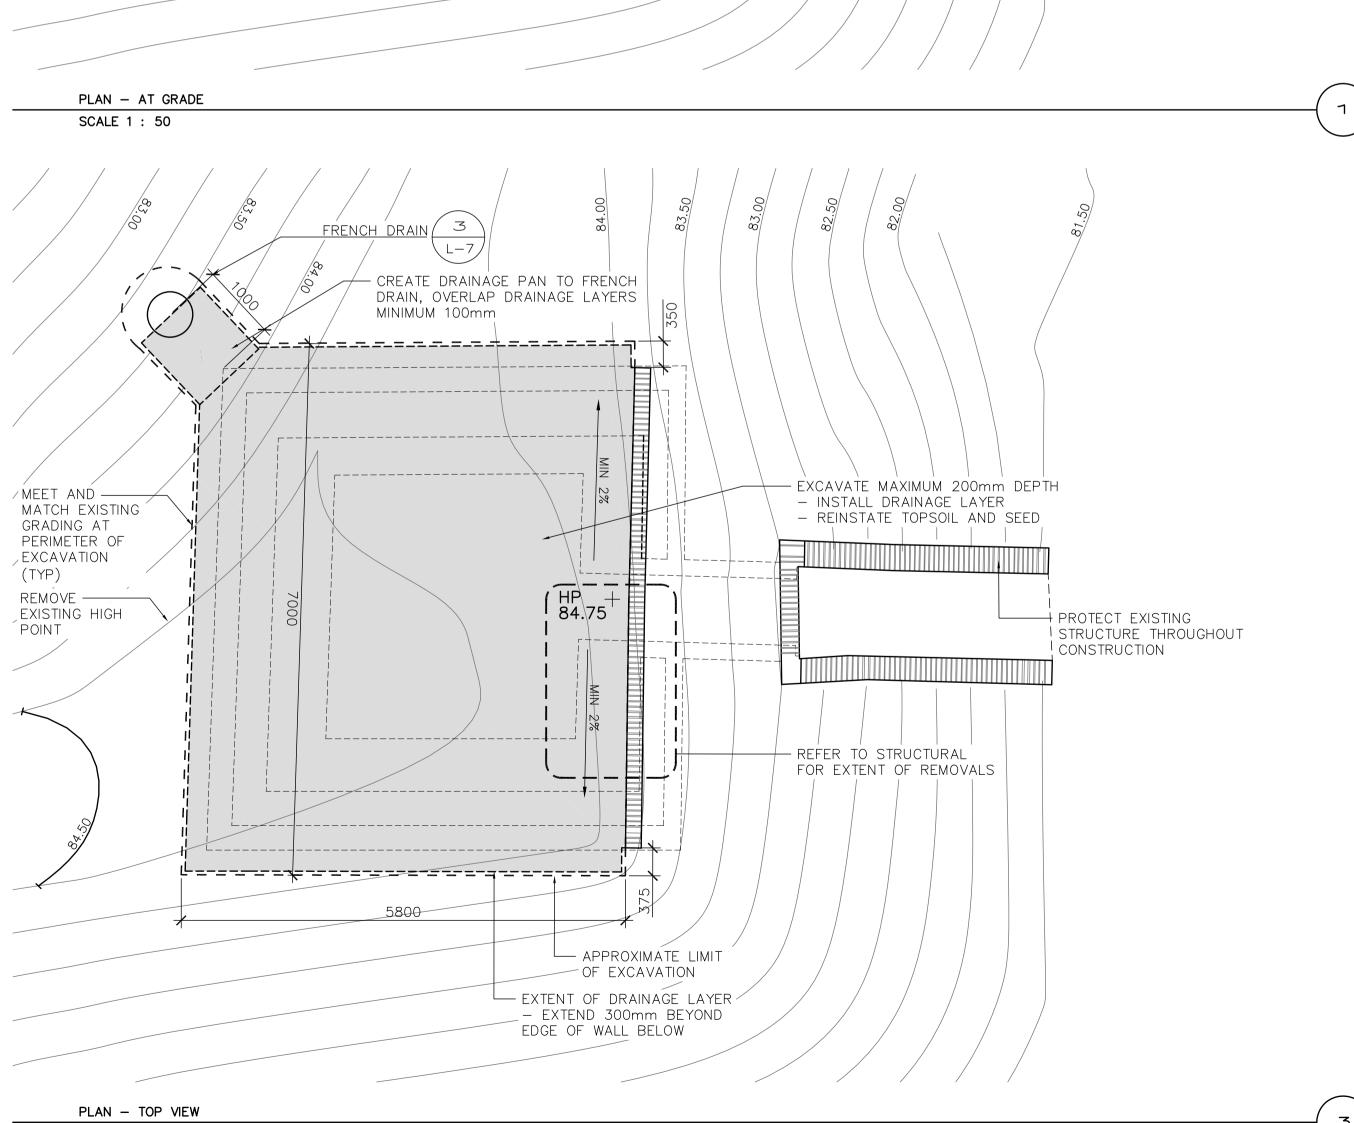
NORTH POWDER MAGAZINE LANDSCAPE RESTORATION

Scale / Echelle SCALE: AS NOTED Drawn by/ Dessine par Date 16/02/05 Field Recording by / Releve—Temoin par Date

Approved by / Approuve par 16/02/05 Checked by/ Verifie par

Sheet No./ Feuille No. Project No./ No. du projet | Asset No. 808000 1300164



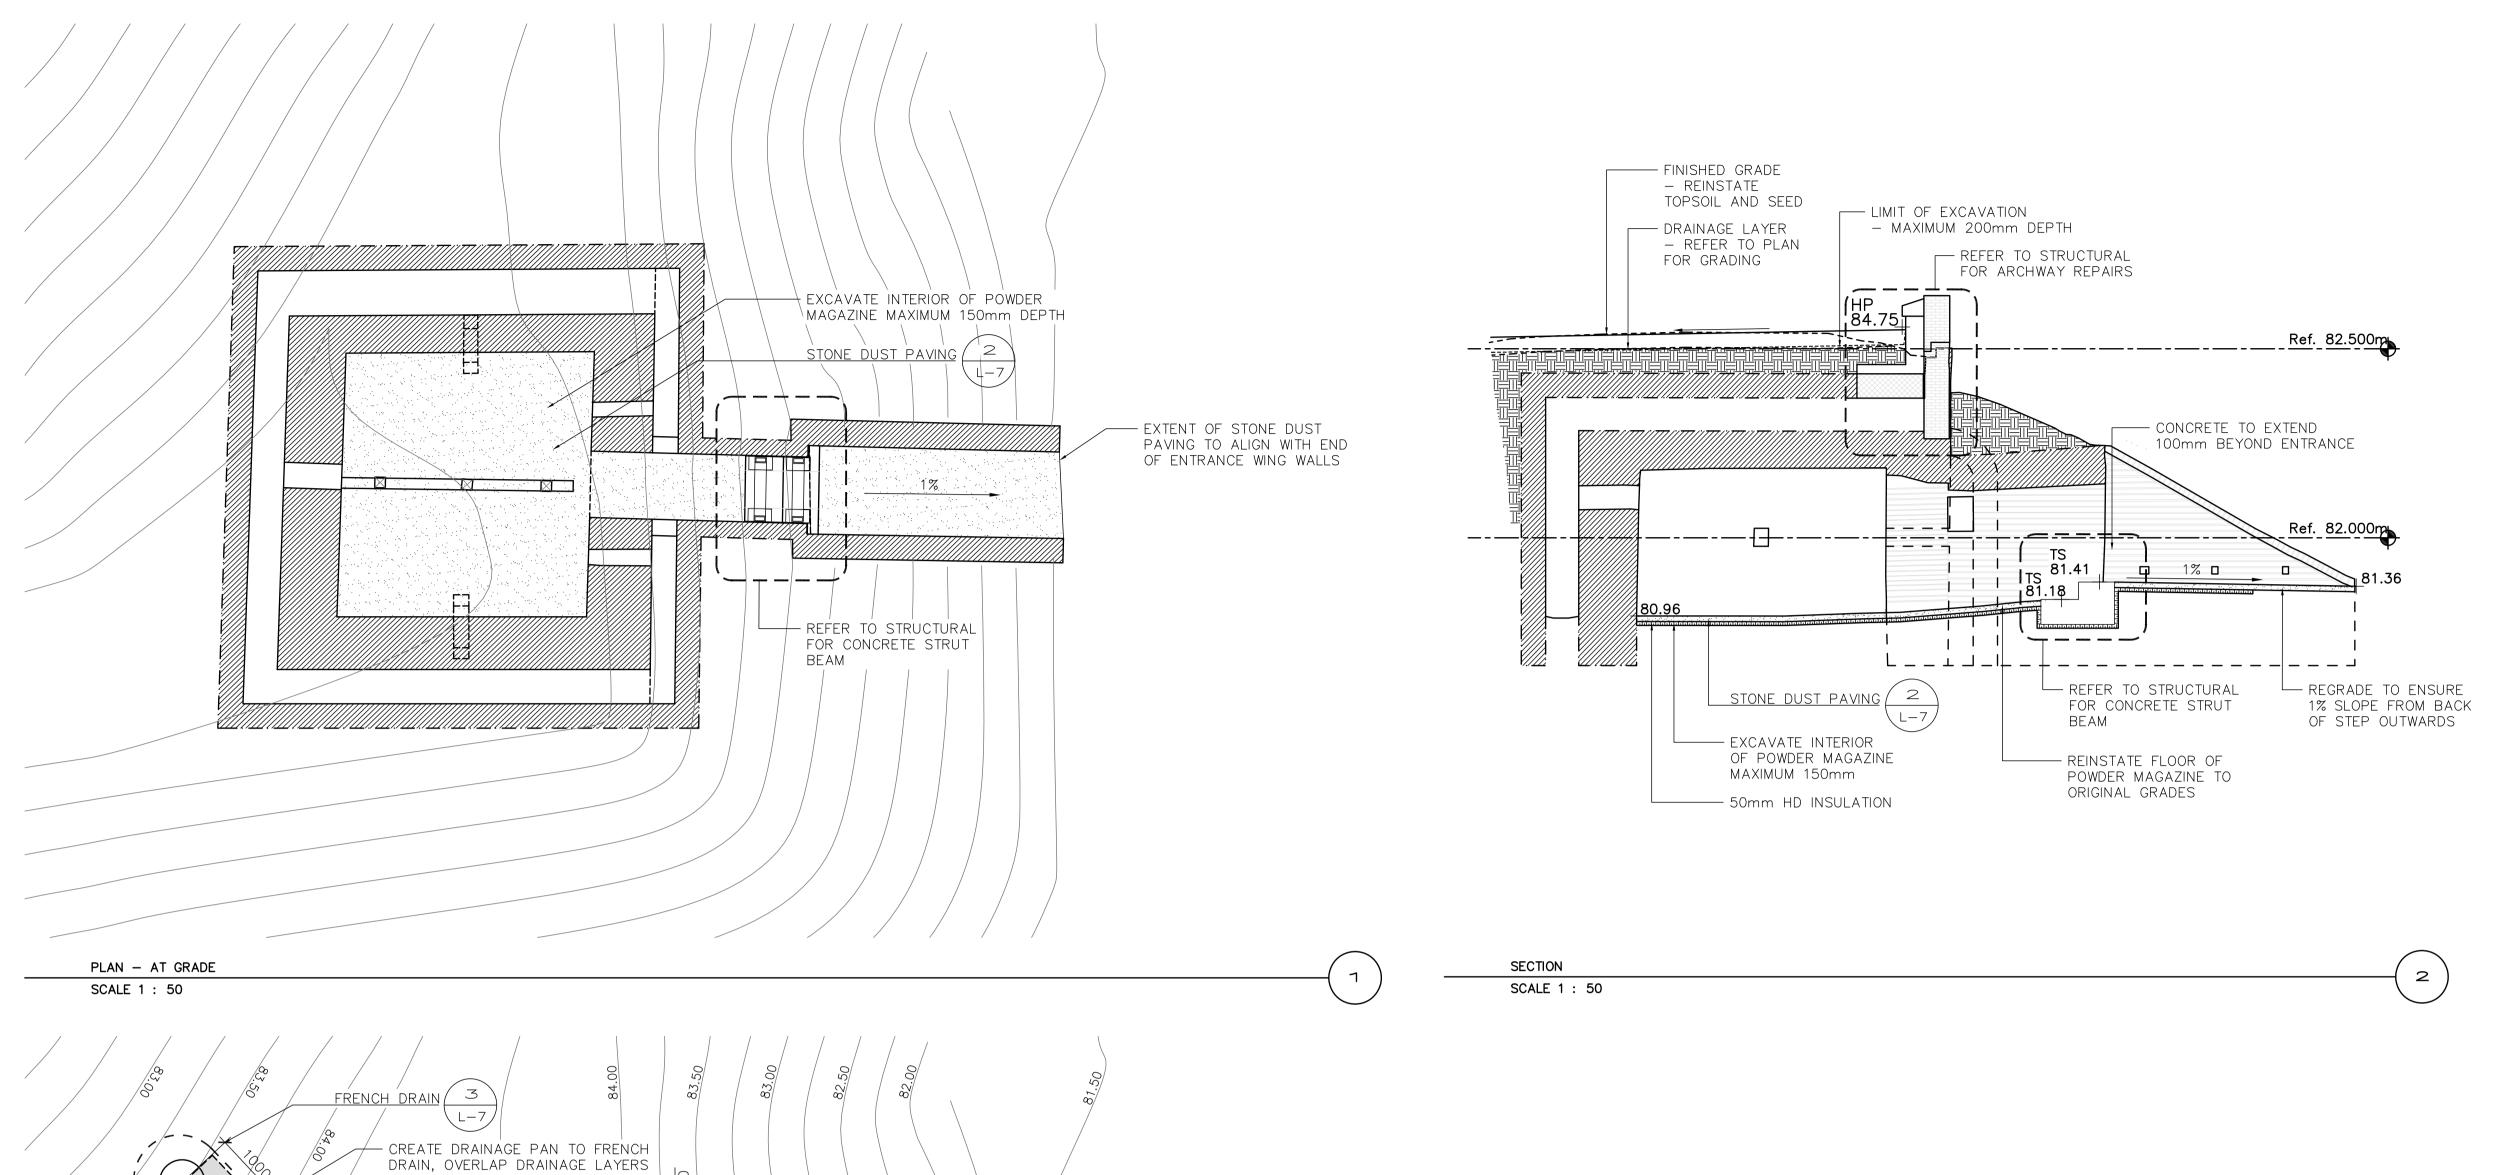

SCALE 1 : 50

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ISSUED FOR TENDER

ISSUED FOR 99% DESIGN REVIEW

ISSUED FOR 66% DESIGN REVIEW

ISSUED FOR 33% DESIGN REVIEW

issued / revisions

Client Acceptance / Acceptation du client Signature File No. / No. de dossier

Parcs Parks
Canada Canada

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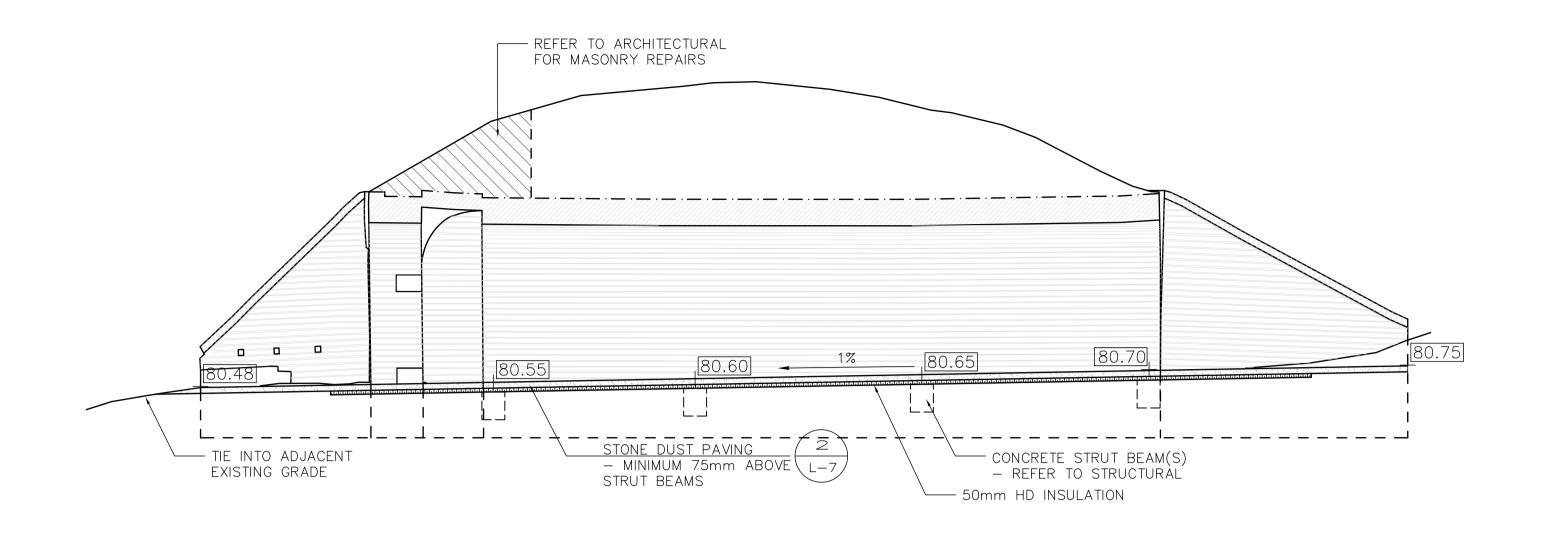
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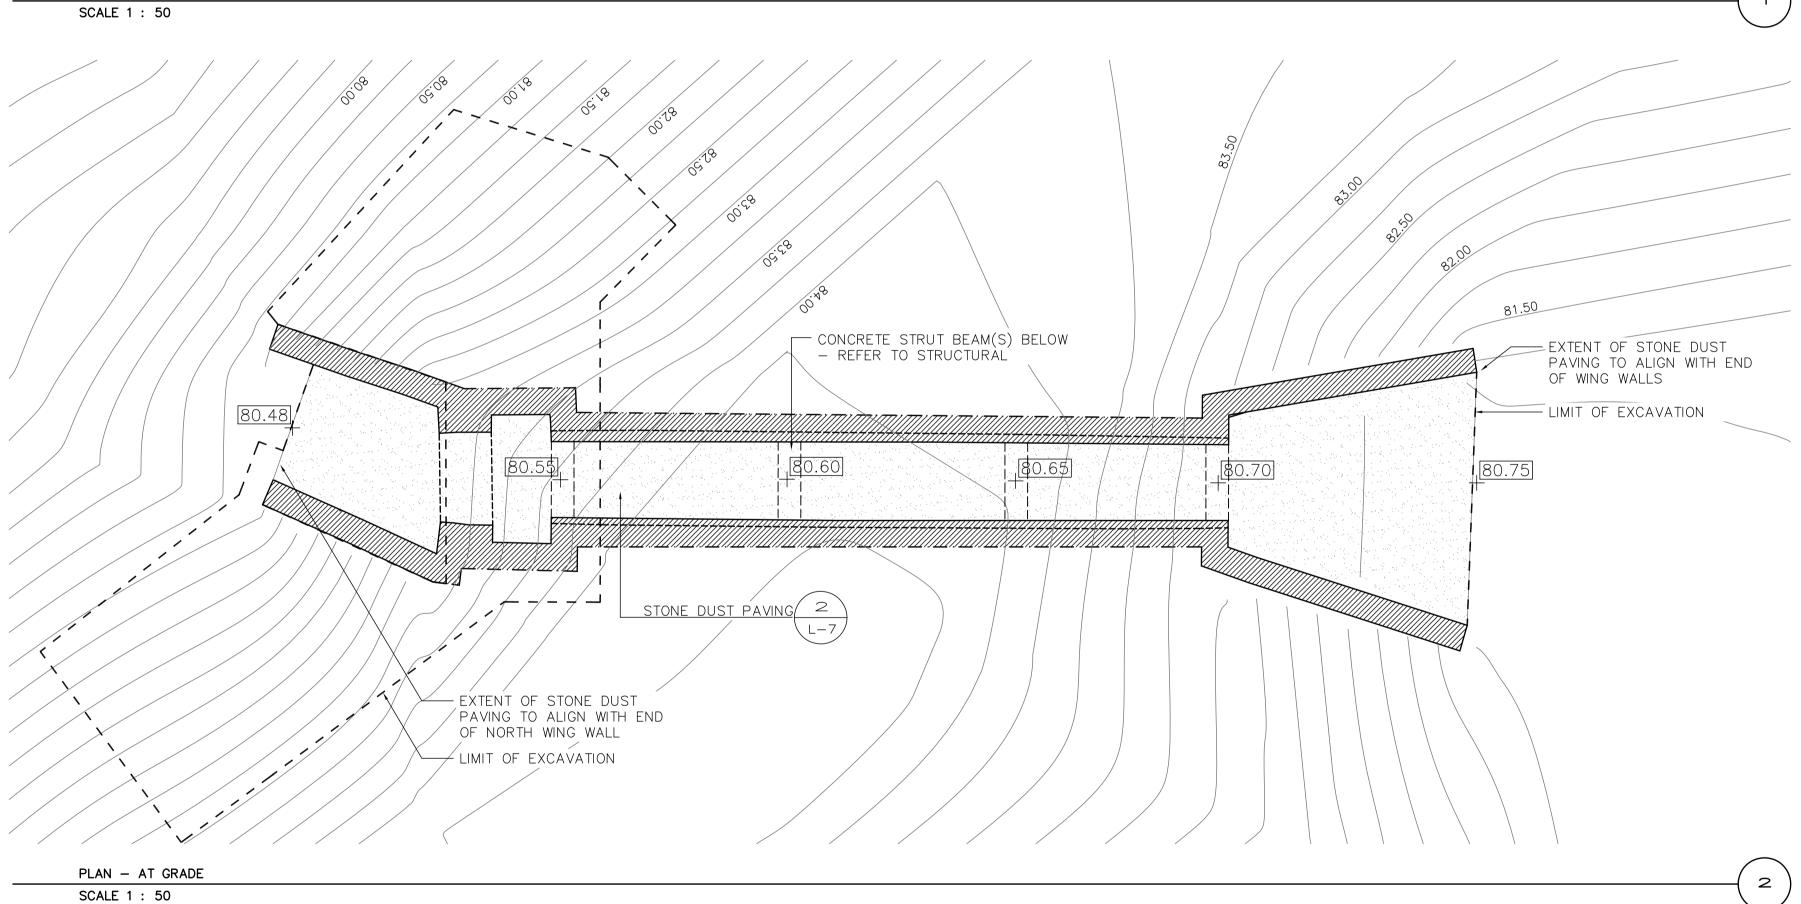
SOUTH POWDER MAGAZINE LANDSCAPE RESTORATION


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PARKS CANADA SOUTHWESTERN ONTARIO FIELD UNIT

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JOB NO. 60295

Project title / Titre du projet

FORT MISSISSAUGA STABILIZATION PHASE II

Drawing title / Titre du dessin

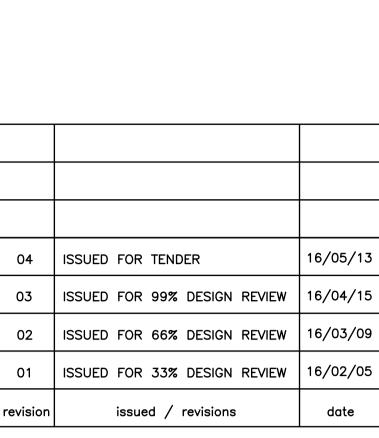
SALLY PORT LANDSCAPE RESTORATION

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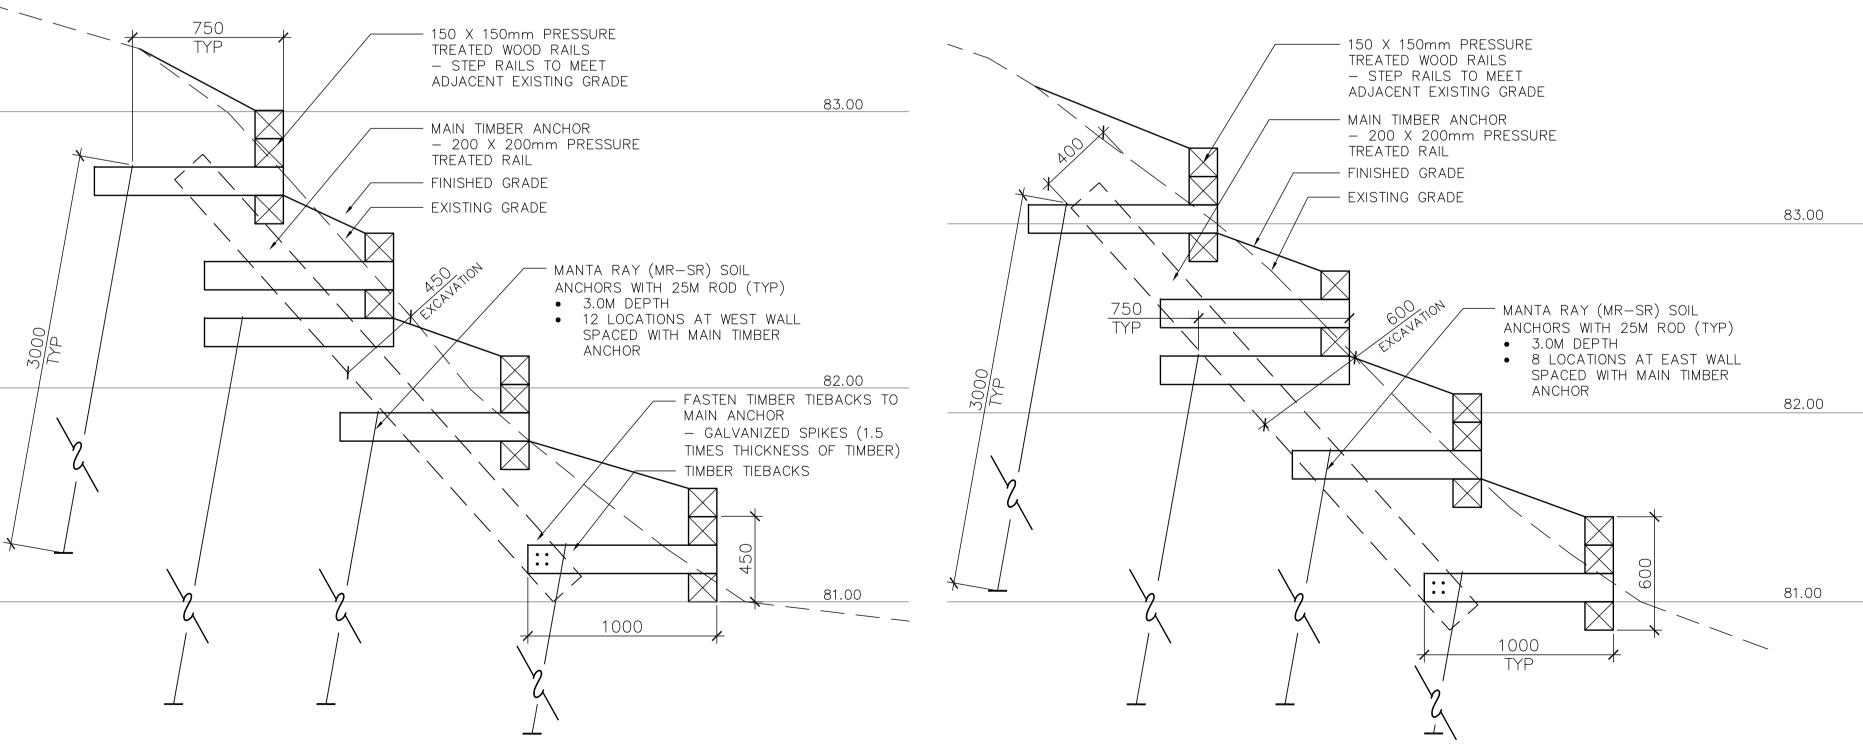
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ELEVATION



SCALE 1 : 50

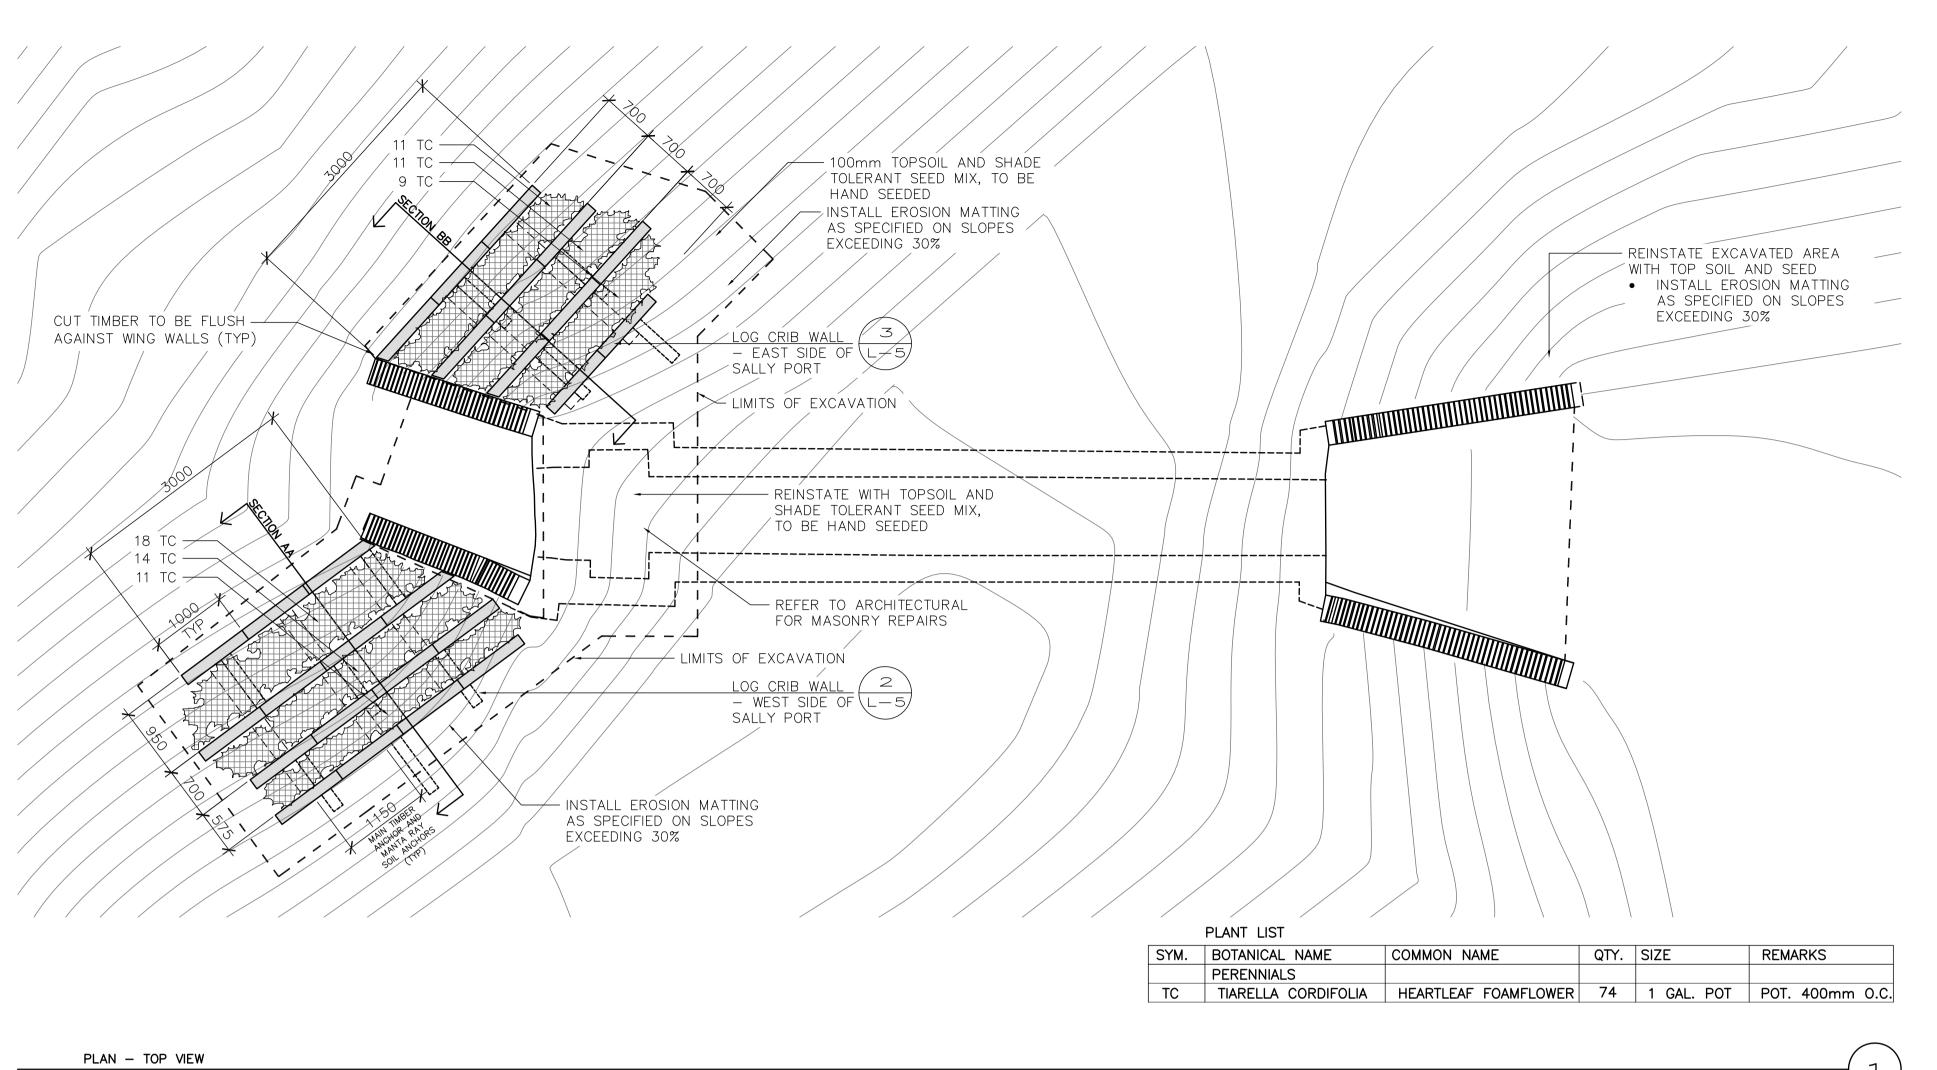

— 25M STEEL ROD - NUT, WASHER AND SPACER AS PER MANUFACTURER RECOMMENDATION — 50 X 50 X 6mm STEEL PLATE MAIN TIMBER ANCHOR

> MANTA RAY CONNECTION WITH TIMBER ANCHOR SCALE 1:5

16/05/13 04 ISSUED FOR TENDER 03 16/04/15 ISSUED FOR 99% DESIGN REVIEW 02 ISSUED FOR 66% DESIGN REVIEW 16/03/09 16/02/05 01 ISSUED FOR 33% DESIGN REVIEW issued / revisions

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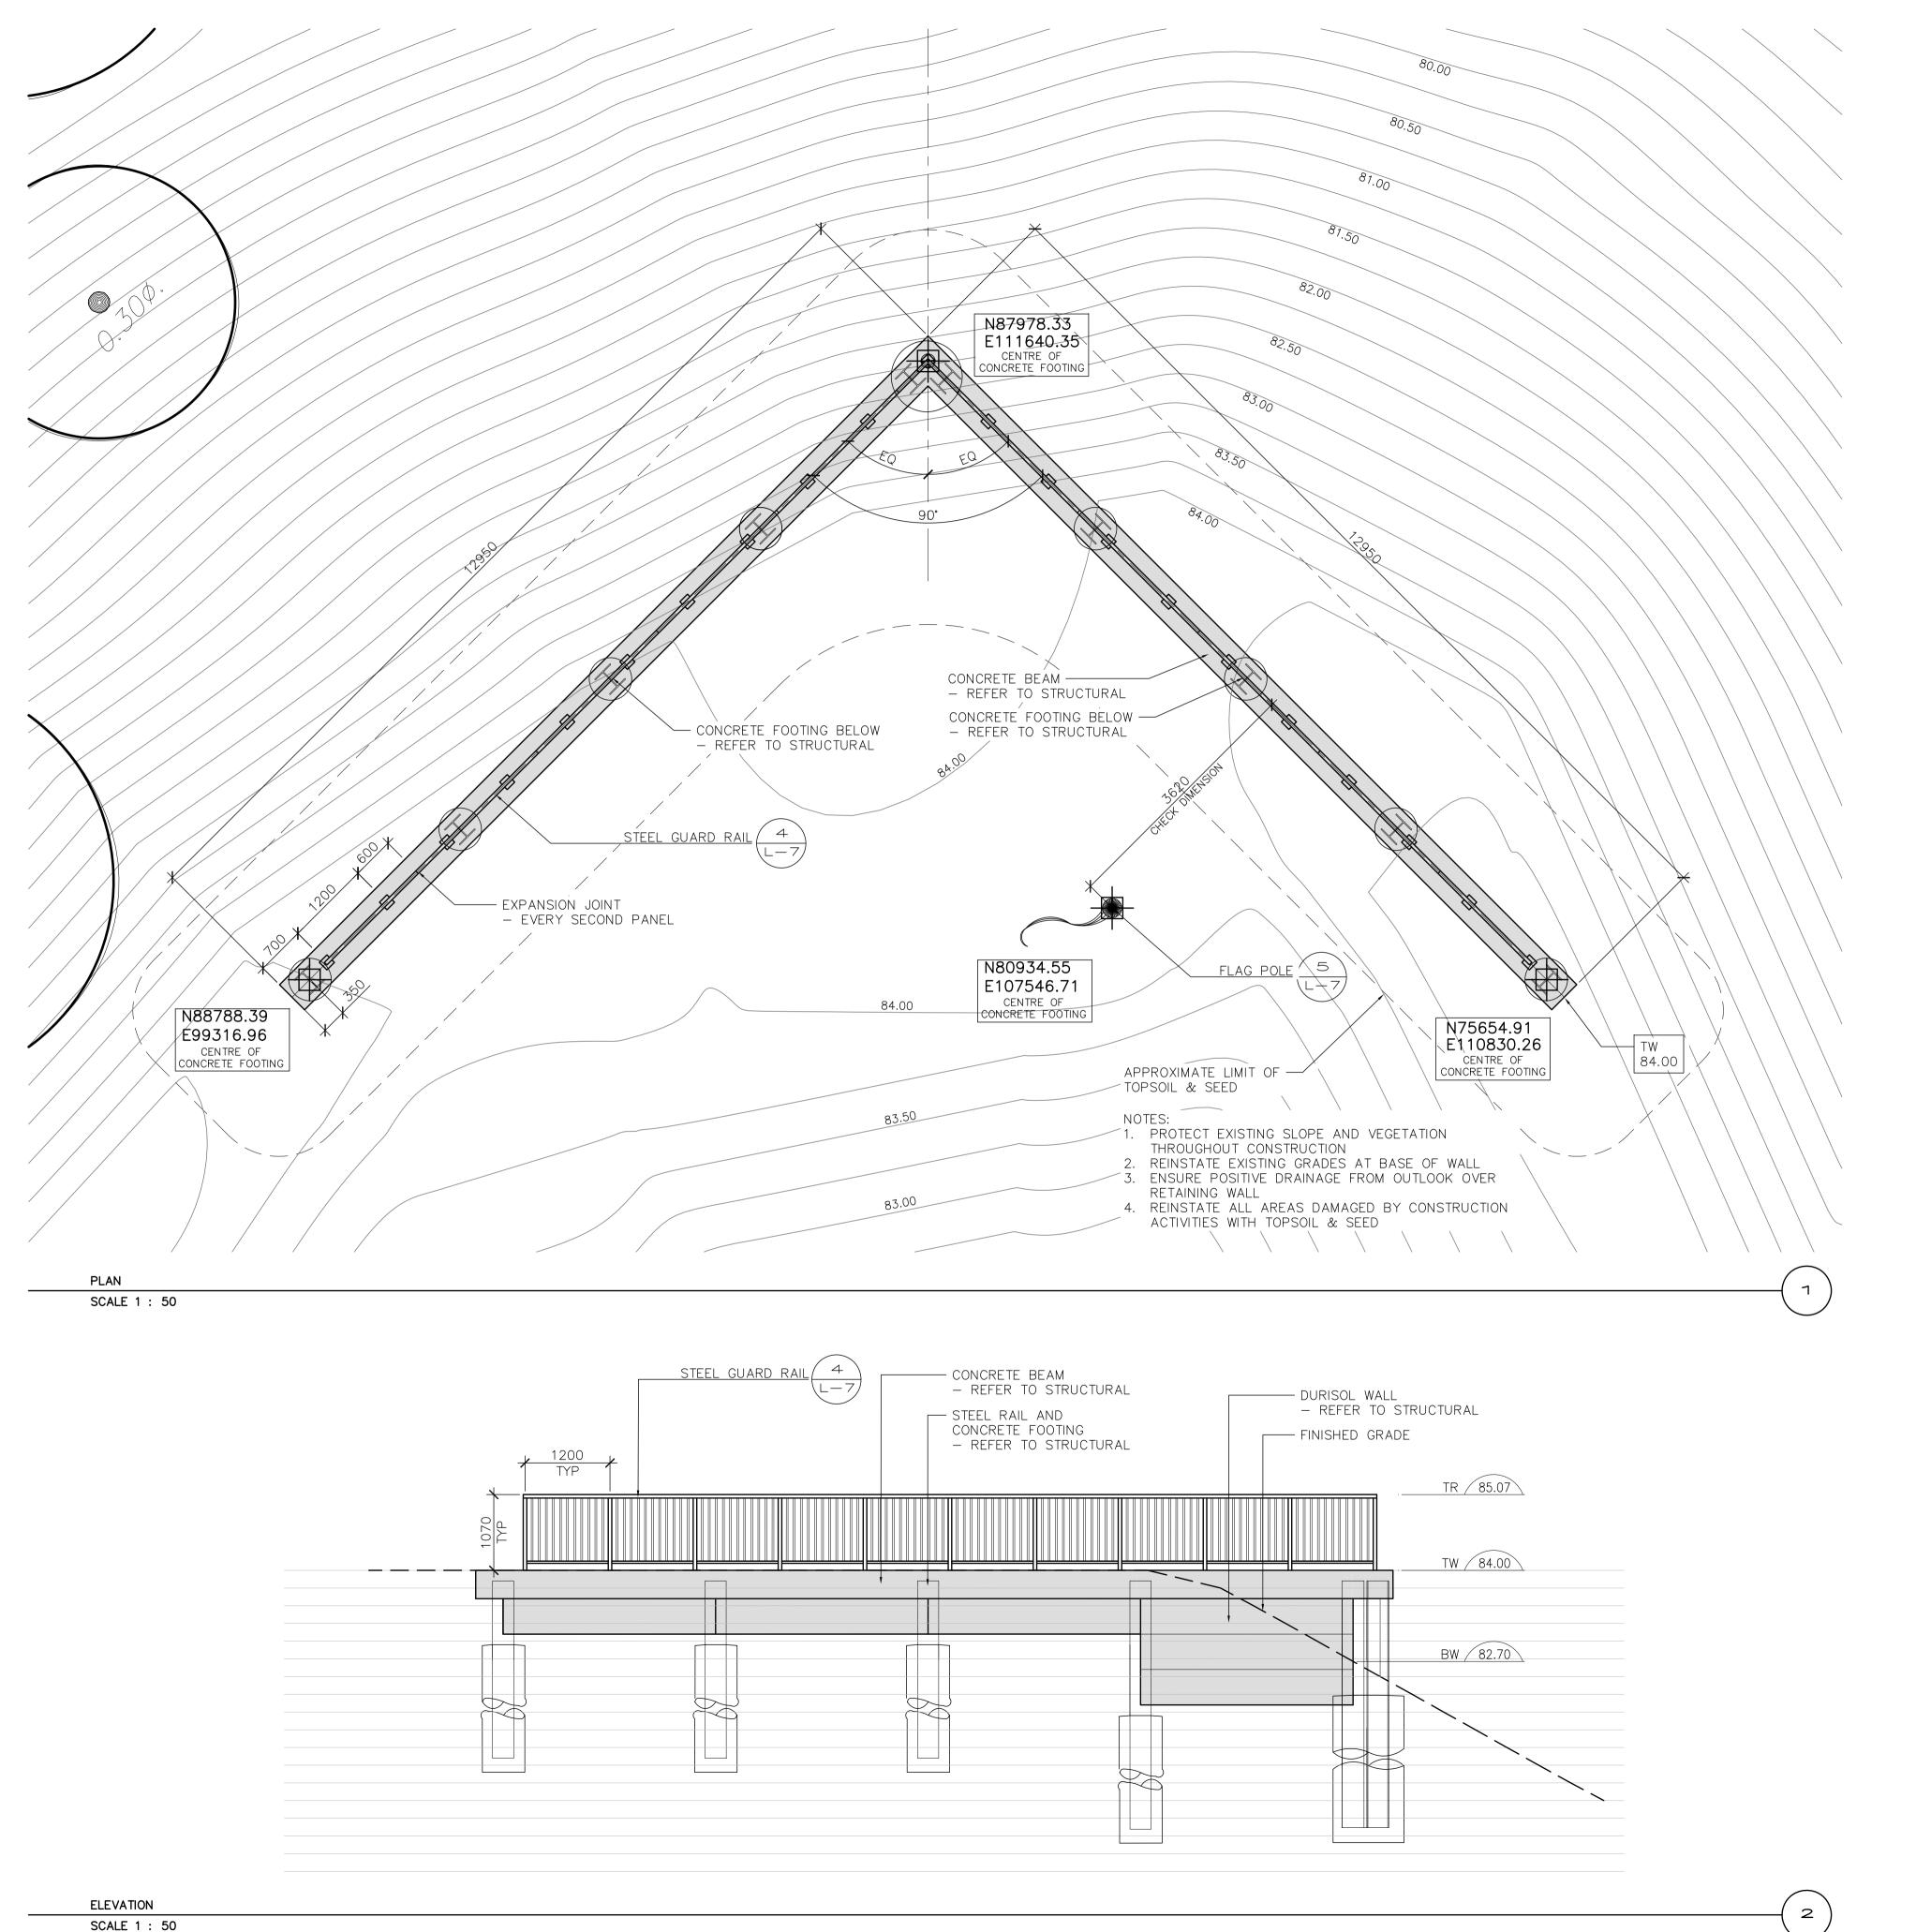
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AA LOG CRIB WALL - WEST

SCALE 1 : 20

BB LOG CRIB WALL - EAST

SCALE 1 : 20



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FORT MISSISSAUGA STABILIZATION PHASE II


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OBSERVATION DECK LANDSCAPE PLAN

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FORT MISSISSAUGA STABILIZATION PHASE II

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DETAILS

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A. GENERAL NOTES:

- 1. READ STRUCTURAL DRAWINGS IN CONJUNCTION WITH SPECIFICATIONS AND OTHER CONTRACT DOCUMENTS. ALL DISCREPANCIES AND/OR CONFLICTS SHALL BE BROUGHT TO THE ATTENTION OF THE DEPARTMENTAL REPRESENTATIVE OR DESIGNATE FOR REVIEW AND CLARIFICATION.
- 2. ALL DIMENSIONS, LOCATIONS AND ELEVATIONS OF EXISTING STRUCTURES SHOWN ON THE CONTRACT DRAWINGS SHALL BE VERIFIED BY THE CONTRACTOR IN THE FIELD. THE CONSULTANT SHALL BE NOTIFIED BY THE CONTRACTOR OF ANY DISCREPANCIES BEFORE COMMENCING WORK.
- 3. PRIOR TO COMMENCEMENT OF WORK VERIFY ALL DIMENSIONS AND ELEVATIONS SHOWN ON THE STRUCTURAL DRAWINGS WITH THE ARCHITECTURAL AND LANDSCAPE DRAWINGS AND REPORT
- DISCREPANCIES TO THE DEPARTMENTAL REPRESENTATIVE OR DESIGNATE.

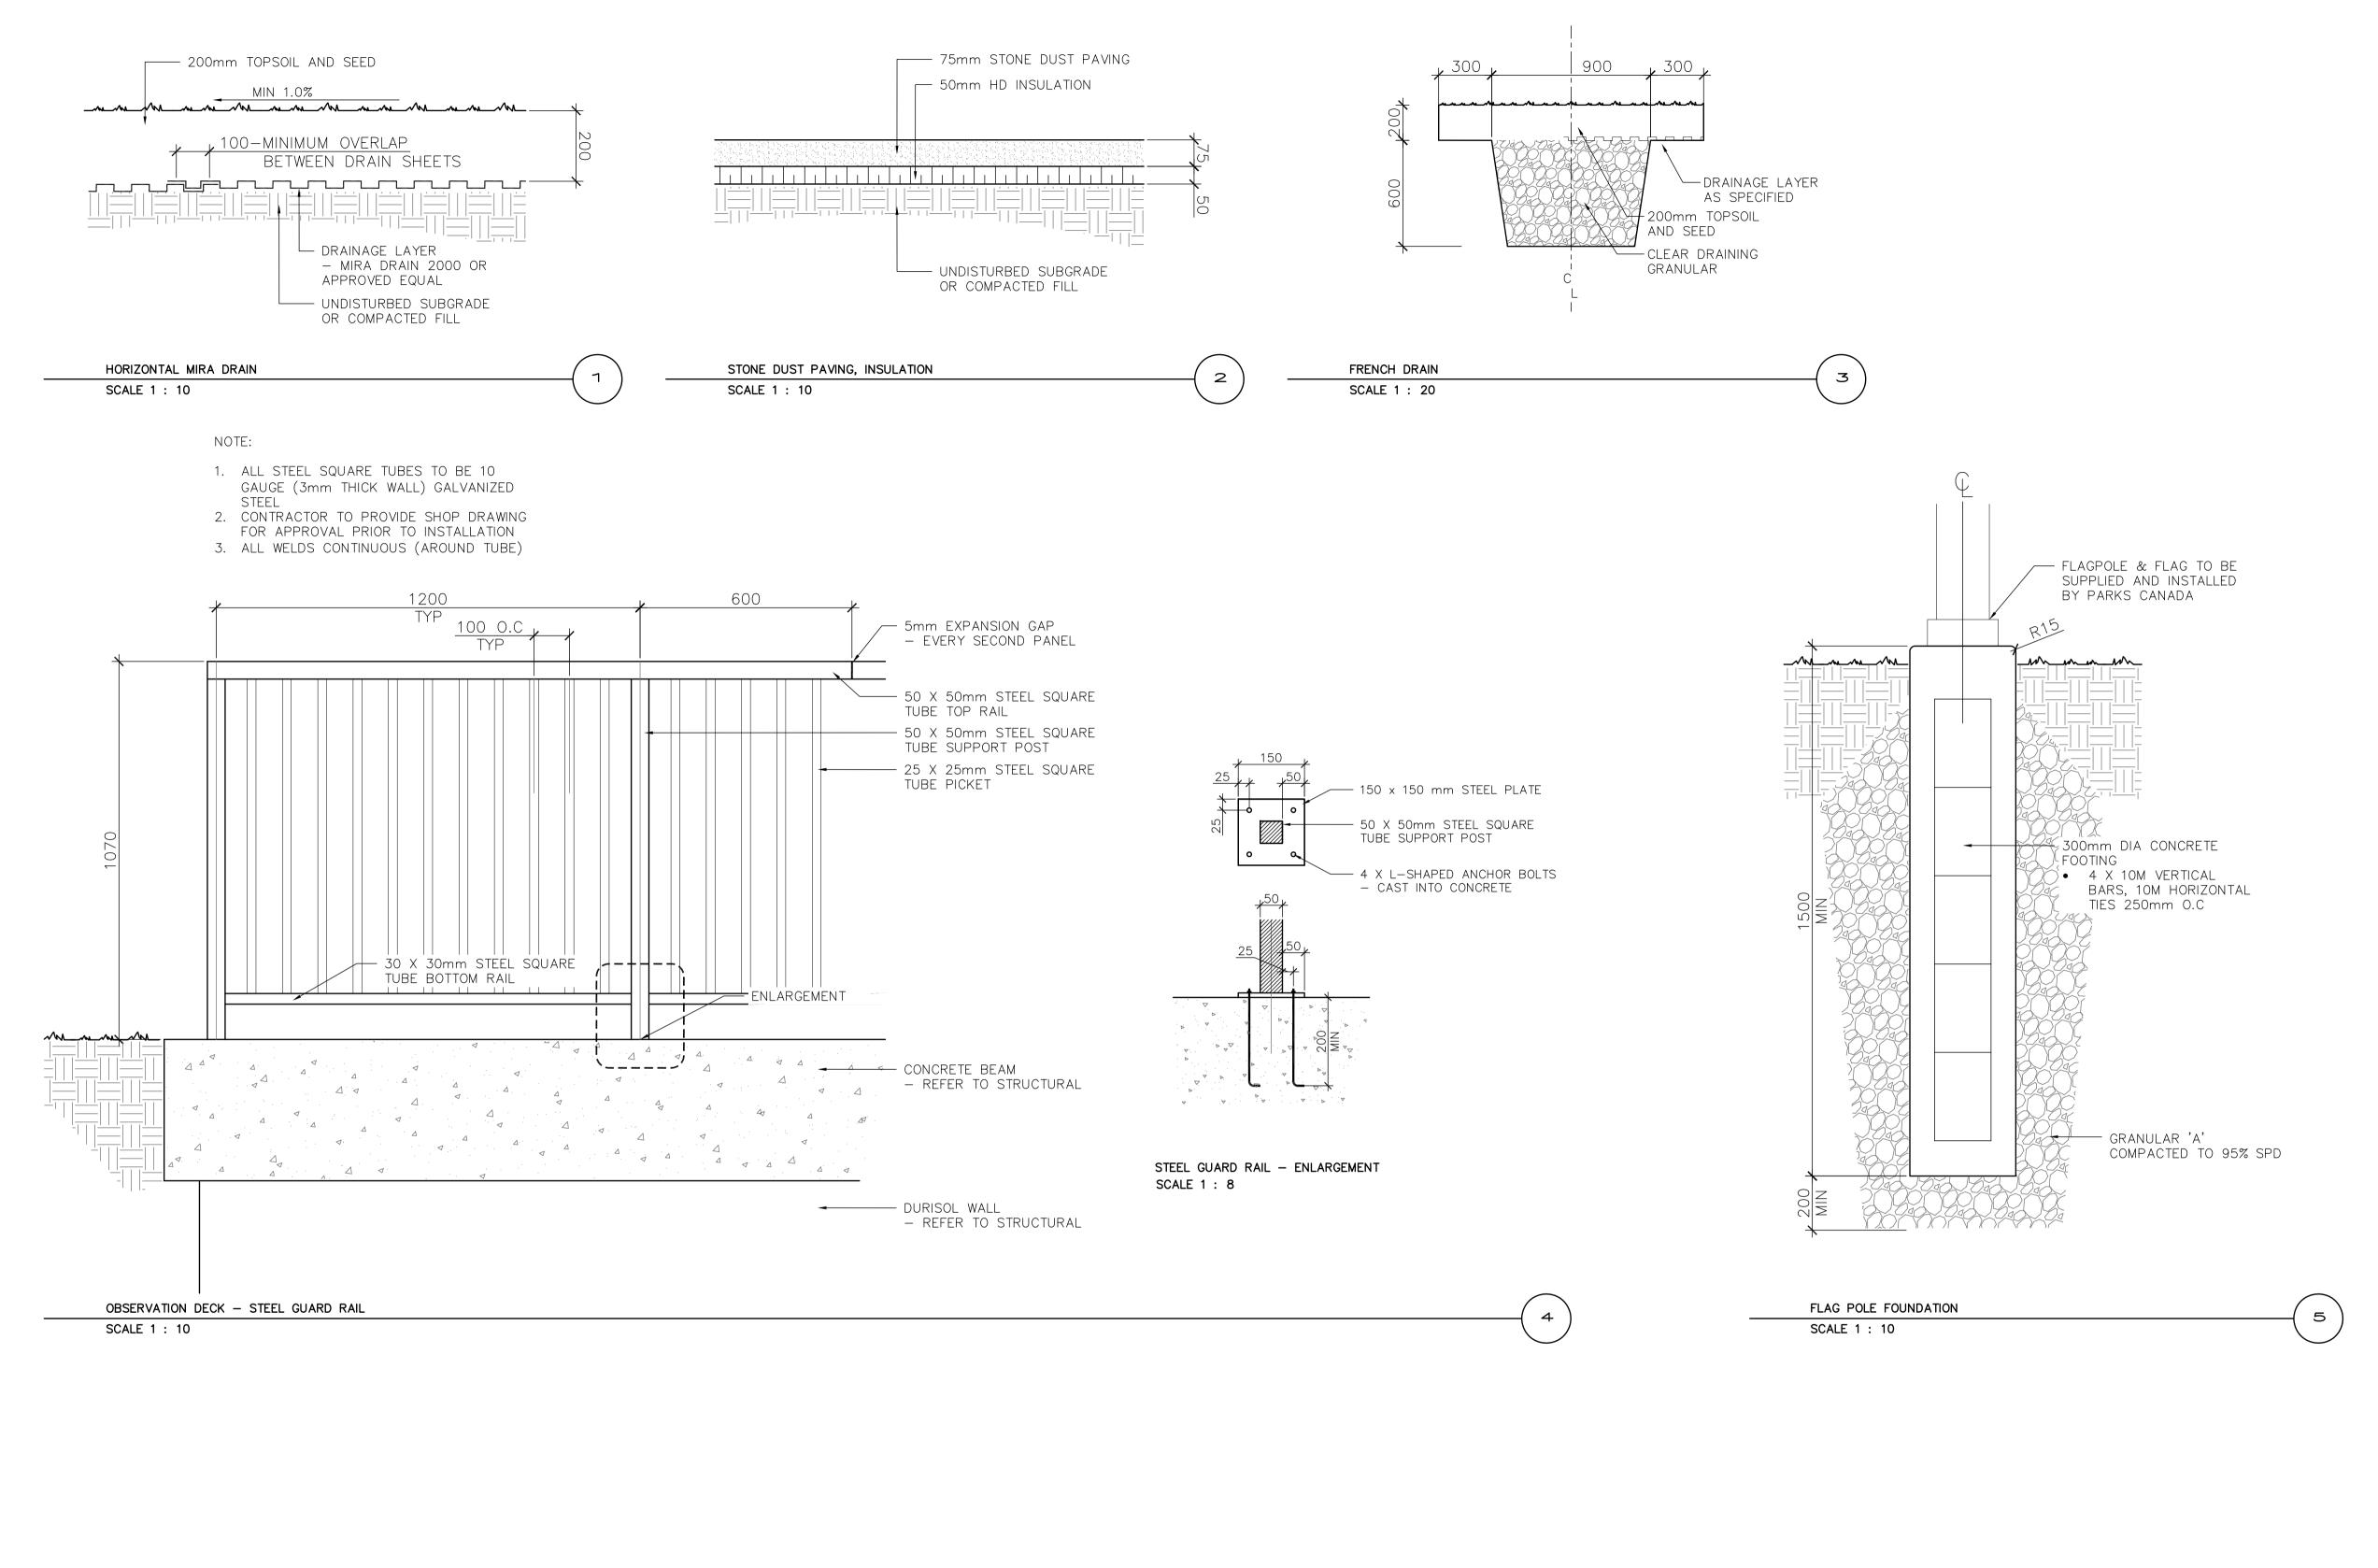 4. NO OPENINGS OTHER THAN THOSE SHOWN ON THE DRAWINGS SHALL BE MADE WITHOUT PRIOR APPROVAL FROM THE DEPARTMENTAL REPRESENTATIVE OR DESIGNATE.
- 5. ALL DIMENSIONS ARE IN MILLIMETERS, ELEVATIONS IN METERS, UNLESS OTHERWISE NOTED.
- 6. DO NOT SCALE DRAWINGS

B. TEMPORARY WORKS:


- 1. THE CONTRACTOR SHALL DESIGN, PROVIDE, ERECT, MAINTAIN, REMOVE AND ASSUME FULL AND SOLE RESPONSIBILITY FOR ALL TEMPORARY WORKS REQUIRED FOR THE SAFE AND COMPLETE EXECUTION OF THE WORKS.
- 2. IN THE EXECUTION OF THE TEMPORARY WORKS AND FOR THE DURATION OF THE CONTRACT, THE CONTRACTOR SHALL MARK ADEQUATE PROVISION FOR ALL LIKELY CONSTRUCTION LOADING AND PROVIDE SUFFICIENT BRACING AND PRIORS TO KEEP THE WORKS IN PLUMB AND ALIGNMENT AND FREE EXCESSIVE DEFLECTION.
- 3. COSTS OF ALL TEMPORARY WORKS ARE DEEMED TO HAVE BEEN INCLUDED IN THE CONTRACT PRICE.
- 4. SUBMIT SHOP DRAWINGS FOR ALL TEMPORARY WORKS FOR REVIEW BEFORE FABRICATION COMMENCES. SHOP DRAWINGS SHALL BE SEALED BY A PROFESSIONAL ENGINEER REGISTERED IN THE PROVINCE OF ONTARIO.
- 5. ANY CONSTRUCTION SEQUENCES SHOWN ON THE DRAWINGS SHALL BE PART OF TEMPORARY WORKS AND ARE FOR THE CONTRACTOR'S CONSIDERATION ONLY. THE CONTRACTOR IS AT LIBERTY TO USE ANY OTHER SEQUENCE AS HE DEEMS APPROPRIATE, BUT AT NO TIME SHALL THE SAFETY AND INTEGRITY OF THE WORKS BE COMPROMISED. IF THE CONTRACTOR ADAPTS THE SUGGESTED SEQUENCE, SUCH SEQUENCE SHALL BE DEEMS AS THE CONTRACTOR'S OWN SELECTION OF METHOD, AND THE CONTRACTOR SHALL ASSUME FULL AND SOLE RESPONSIBILITY FOR IT, AS STARED IN (1) ABOVE. THE CONTRACTOR SHALL INFORM DEPARTMENTAL REPRESENTATIVE OR DESIGNATE IF HE WISHES TO DEVIATE FROM ANY SUGGESTED SEQUENCE.

C. UNDERPINNING NOTES:

- 1. CONCRETE SHALL HAVE A 28-DAY STRENGTH OF 35MPa AND A MAXIMUM SLUMP OF 75mm
- 2. UNDERPINNING SHALL BE DONE IN 750mm LENGTHS MAX.
- 3. NUMBERS ON PANELS INDICATE STAGES IN WHICH UNDERPINNING SHALL PROCEED, i.e. ALL SECTIONS MARKED #1 FOLLOWED BY ALL SECTIONS MARKED #2 FOLLOWED BY ALL SECTIONS MARKED #3 AND THEN #4. POUR CONCRETE IN PLACE AND LEAVE FOR 24 HOURS BEFORE DRYPACKING AND PROCEEDING WITH NEXT STAGE.
- 4. UNDERPINNING FOR EXISTING WALLS IS SHOWN FOR ASSUMED CONDITIONS. ANY VARIATIONS BETWEEN ACTUAL JOB CONDITIONS AND THE DETAILS SHOWN ON THIS DRAWING SHALL BE REPORTED TO THE DEPARTMENTAL REPRESENTATIVE OR DESIGNATE. DEPARTMENTAL REPRESENTATIVES TO CONTRACTOR WILL BE FOLLOWING THE STRUCTURAL CONSULTANTS RECOMMENDATIONS AS REQUIRED.
- 5. PROVIDE ALL NECESSARY SHORING OF EXISTING STRUCTURE REQUIRED TO CARRY OUT THIS
- 6. FOOTING AND UNDERPINNING EXCAVATIONS SHALL BE INSPECTED BY A GEOTECHNICAL ENGINEER PRIOR TO POURING CONCRETE TO CONFIRM ADEQUACY OF SUB-GRADE.
- 7. MAX. HEIGHT OF UNDERPINNING SHALL NOT BE MORE THAN 1200mm TYPICAL.

D. PROPOSED UNDERPINNING PROCEDURES:

- 1. EXCAVATE FOR UNDERPINNING IN 750mm LONG SECTIONS MAX.
- 2. EXCAVATE FOR ALL SECTIONS 1 REFER TO ELEVATION.
- 3. CLEAN UNDERSIDE OF EXISTING FOOTING/WALL.
- 4. POUR CONCRETE SAME WIDTH AS EXISTING FOOTING/WALL UP TO 75mm BELOW FOOTING/WALL.
- 5. LEAVE CONCRETE TO CURE FOR AT LEAST 24 HOURS BEFORE DRYPACKING TIGHT TO UNDERSIDE OF FOTING/WALL.
- 6. WHEN ALL SECTIONS MARKED (1) HAVE BEEN DRYPACKED REPEAT FOR SECTIONS MARKED (2)
- 7. WHEN ALL SECTIONS MARKED ② HAVE BEEN DRYPACKED REPEAT FOR SECTIONS MARKED ③
- 8. WHEN ALL SECTIONS MARKED ③ HAVE BEEN DRYPACKED REPEAT FOR SECTIONS MARKED ④

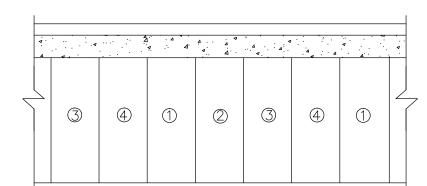

UNDERPINNING ELEVATION

E. CONCRETE:

- 1. CONCRETE MATERIALS AND METHODS OF CONSTRUCTION SHALL CONFORM TO CAN/CSA-A23.1-09, A23.2-09, A23.3-04 AND A23.5-05
- 2. CONCRETE PROPERTIES FOR STRUCTURAL ELEMENTS ARE AS FOLLOWS:

| ELEMENT | MIN STRENGTH (MPa) | MAX W/C RATIO | AIR CONTENT (%) | MAX AGGREGATE (MM) | EXPOSURE CLASS | COLOUR |
|-------------------|--------------------------|---------------------|-----------------------|--------------------------|-------------------|--------|
| FOUNDATIONS | 35 at 28 d | .48 | 5-8 | 20 | C-1 | _ |
| OTHER CONCRETE | 35 at 28 d | .48 | 5-8 | 20 | C-1 | _ |

- 3. DOWELS SHALL BE PLACED BEFORE CONCRETE IS PLACED, TEMPLATES SHALL BE USED TO ENSURE CORRECT PLACEMENT OF DOWELS.
- 4. GROUT SHALL BE NON-SHRINK CEMENT GROUT WITH A MINIMUM STRENGTH OF 35MPa

F. CONCRETE REINFORCING:

1. CONCRETED REINFORCING BARS SHALL CONFORM TO THE FOLLOWING STANDARDS.

| CSA G30.18W-M | GRADE 400 W | -DEFORMED BARS |
|---------------|-------------|----------------------------------|
| CSA G30.5-M | GRADE 400 | -WELDED WIRE FABRIC (GLAVANIZED) |

2. UNLESS OTHERWISE NOTED CONCRETE COVER TO REINFORCEMENT SHALL BE: FOUNDATION BEAM — 75mm

- 3. UNLESS SHOWN OTHERWISE, TENSION LAP LENGTHS NOT INDICATED ON CONTRACT DRAWINGS SHALL BE CLASS "B"
- 4. BAR BENDS SHALL BE MINIMUM LENGTH AND STIRRUPS SHALL HAVE MINIMUM HOOKS, UNLESS NOTED OTHERWISE.

G. STRUCTURAL STEEL:

- 1. ALL STRUCTURAL STEEL SHALL CONFORM TO STANDARD CAN/CSA-G40.21-M GRADE 300W. HSS SHALL BE GRADE 350W CLASS H.
- 2. ALL STRUCTURAL STEEL ENCASED IN CONCRETE SHALL BE HOT DIPPED GLAVANIZED. HOT DIP GLAVANIZING SHALL BE ACCORDING TO CAN/CSA G 164M PROVIDING A MINIMUM ZINC MASS OF 610 g/m²
- 3. DESIGN CONNECTIONS IN ACCORDANCE WITH REQUIREMENTS OF CAN/CSA S16.1-M FOR THE LOADS SHOWN OR IMPLIED.
- 4. FABRICATION AND ERECTION OF STEEL SHALL CONFIRM TO CAN/CSA S16-01. NO SPLICING WILL BE PERMITTED UNLESS OTHERWISE NOTED ON THE STRUCTURAL DRAWINGS.
- 5. ALL BOLTS SHALL CONFORM TO ASTM A325M-97 IN BEARING TYPE CONNECTIONS.
- 6. ANCHORE BOLTS, FIELD BOLTS AND BEARING PLATES SHALL BE GLAVANIZED IN ACCORDANCE WITH STANDARD CAN/CSA-G164-M92 UNLESS OTHERWISE NOTED.
- 7. WELDING ELECTRODES TO CONFORM TO CSA W48 SERIES.
- 8. ALL BOLTED CONNECTIONS SHALL HAVE A MINIMUM OF TWO BOLTS UNLESS OTHERWISE NOTED.
- 9. ALL BEAM-TO-BEAM CONNECTIONS AND BEAM-TO-COLUMN CONNECTIONS SHALL HAVE DOUBLE ANGLE CONNECTIONS UNLESS OTHERWISE NOTED.
- 10. ALL WELDING SHALL BE DONE IN ACCORDANCE WITH CSA STANDARD W59-M.
- 11. ELEVATIONS AND DIMENSIONS TO BE VERIFIED IN FIELD BEFORE FABRICATION.
- 12. BASE PLATES ARE TO BE SET AND LEVELED BY THE STRUCTURAL STEEL CONTRACTOR. ALL ANCHOR BOLTS AND TEMPLATES TO BE SUPPLIED BY THE STEEL CONTRACTOR AND SET BY THE CONCRETE / MASONRY CONTRACTOR.
- 13. CONTRACTOR SHALL CONFIRM GEOMETRY OF STEEL FRAMES ON SITE PRIOR TO FABRICATION.

H. WATERPROOFING:

WATERPROOFING FOR POWDER MAGAZINE ROOF (REPAIRED AREA ONLY) SHALL BE SELF ADHERING SHEET WATERPROOFING BELOW GRADE WATERPROOFING MEL-ROL BY W.R. MEADOWS OR APPROVED EQUIVALENT. INSTALL IN ACCORDANCE WITH MANUFACTURE'S INSTRUCTIONS.

I. INSULATION:

INSULATION SHALL BE FOAMULAR 600 BY OWENS CORNING. INSTALL IN ACCORDANCE WITH MANUFACTURE'S INSTRUCTIONS. THICKNESS SHALL BE AS SHOWN ON THE DRAWING.

J RETAINING WALL - OBSERVATION DECK

UNLESS OTHERWISE NOTED RETAINING WALL AT THE OBSERVATION DECK SHALL BE DURISOL NARROW FOOTPRINT RETAINING WALL SYSTEM (NFRWS) OR APPROVED SYSTEM.

- THE RETAINING WALL SYSTEM SHALL HAVE THE FOLLOWING ATTRIBUTES PREORMANCE H
- APPEARANCE H
 SYSTEM POST AND PANEL
- REFER TO ARCHITECTURAL DRAWINGS FOR TEXTURE AND COLOUR OF PANELS

K. DESIGN NOTES:

- 1. THE DESIGN OF THE STRUCTURES MODIFICATION COMPLIES WITH THE ONTARIO BUILDING CODE 2006
- 2. ALL REINFORCED CONCRETE ELEMENTS ARE DESIGNED USING CAN/CSA A23.3-04 "DESIGN OF CONCRETE".
- 3. ALL STRUCTURAL STEEL ELEMENTS ARE DESIGNED USING CAN/CSA S16-09 "DESIGN OF STEEL STRUCTURES".

L. TIMBER

- 1. TIMBER SHALL BE COASTAL DOUGLAS FIR OR JACK PINE NO. 1 GRADE OR EQUIVALENT UNDER THE SAME SPECIES IDENTIFICATION IN ACCORDANCE WITH CSA STANDARD 086 FOR BEAM AND STRINGER, NLGA STANDARD GRADING RULES.
- 2. ALL WOOD SHALL BE PRESSURE PRESERVATIVE TREATED AS PER OPSS 1601.
- 3. ALL CUTS HOLES AND DAMAGE AFTER PRESSURE TREATMENT SHALL BE TREATED WITH PRESERVATIVES AS PER OPSS 1601.
- 4. ALL STEEL INCLUDING NUTS AND BOLTS SHALL BE HOT DIPPED GALVANIZED AS PER CSA STANDARD G164-M
- 5. STEEL USED FOR PLATES SHALL BE STRUCTURAL STEEL IN ACCORDANCE WITH CSA STANDARD CAN3—G40.21—M GRADE 300W.
- 6. BOLTS AND NUTS SHALL BE IN ACCORDANCE WITH ASTM SPECIFICATIONS A325M.

SCOPE OF WORK

'THE SCOPE OF WORK OF FORT MISSISSAUGA STABILIZATION - PHASE II INCLUDES BUT IT IS NOT LIMITED TO:

ENTRANCE GATE:

REMOVAL AND REBUILDING OF THE END PORTION OF THE INTERIOR NORTH WING WALL, CONSTRUCTION OF NEW CONCRETE FOOTINGS AND CONCRETE CAISSONS, INSTALLATION OF INSULATION, LANDSCAPING REPAIRS.

NORTH AND SOUTH POWDER MAGAZINES:

INSTALLATION OF STEEL FRAMES IN PASSAGEWAYS, CONCRETE STRUT BEAMS,
INSTALLATION OF INSULATION, STONE DUST IN MAGAZINES AND ACCESS TO MAGAZINES,
INCREASE THE HEIGHT OF THE PARAPET WALLS AND INTRODUCE NEW VENT HOLES IN
FRONT FACE OF PARAPET WALLS, MASONRY REPAIRS, REPOINTING, CLEANING
AND STRUCTURAL CRACK REPAIRS OF VARIOUS EXPOSED EXTERIOR MASONRY WALLS,
REPAIRS AND REINSTALLATION OF METAL GATES AT ENTRY WALLS, INSTALLATION OF
MOISTURE BARRIER AND WATERPROOFING OVER POWDER MAGAZINES, LANDSCAPING
REPAIRS, REGARDING ACCESS PATH TO THE MAGAZINES.

SALLY PORT:

REPAIRS OF FOOTING OF NORTH EXTERIOR WING WALL, CONSTRUCTION OF LOG CRIB WALL WITH ANCHORING SYSTEM AT LAKE THE SIDE ENTRANCE, EXCAVATION ABOVE ALCOVE AND REPAIRS TO MASONRY WORK AT ALCOVE FROM INSIDE AND OUTSIDE, INJECT EPOXY GROUT IN THE LONGITUDINAL CRACK IN THE CEILING FROM INSIDE OF THE SALLY PORT, INSTALL REINFORCED CONCRETE STRUT BEAMS BETWEEN WALL FOUNDATIONS, INSTALL INSULATION AND STONE DUST AT FLOOR.

CONSTRUCTION OF NEW OBSERVATION DECK:

CONSTRUCT NEW OBSERVATION DECK USING DURISOL RETAINING WALL SYSTEM,
INSTALL HAND RAIL, FLAG POLE, LANDSCAPING REPAIRS.

<u>LIMITATIONS OF PROPOSED IMPROVEMENTS</u>

THIS SET OF DRAWINGS DEPICTS TEMPORARY MEASURES TO MAINTAIN THE STABILITY AND STRUCTURAL INTEGRITY OF THE EXISTING STRUCTURES INCLUDING BUT NOT LIMITED TO THE MAIN ENTRANCE GATE WALLS, NORTH AND SOUTH POWDER MAGAZINE AND SALLY PORT.

THE PROPOSED TEMPORARY MEASURES (IN CONJUNCTION WITH ANNUAL MONITORING BY A PROFESSIONAL ENGINEER) ARE INTENDED TO LAST BETWEEN ONE YEAR AND THREE YEARS. BEYOND THIS PERIOD IT IS RECOMMENDED THAT CLIENT IMPLEMENT NEW MEASURES TO MAINTAIN STRUCTURAL STABILITY, SAFETY AND STRUCTURAL INTEGRITY OF THE WORKS.

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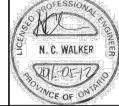
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FORT MISSISSAUGA STABILIZATION PHASE II

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GENERAL NOTES

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Approved by / Approuve par Date

NW 2016/04/08

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RG 2016/04/08

