
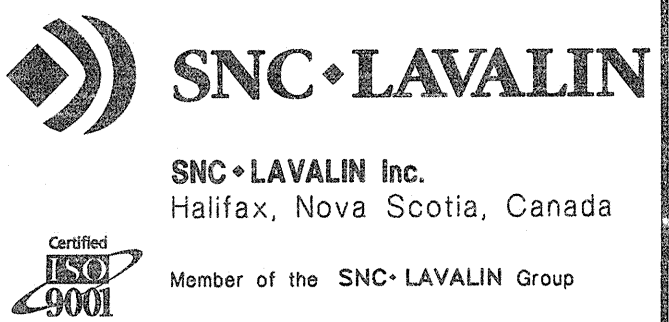


NOTES:

1. ALL CONNECTIONS SHALL BE TERMINATED ON TERMINALS. NO PRESSURE WIRE CONNECTIONS ARE ALLOWED.
2. PROVIDE MECHANICAL PROTECTION FOR ALL TRANSITION TO UNDERGROUND, AS PER CSA REQUIREMENTS.

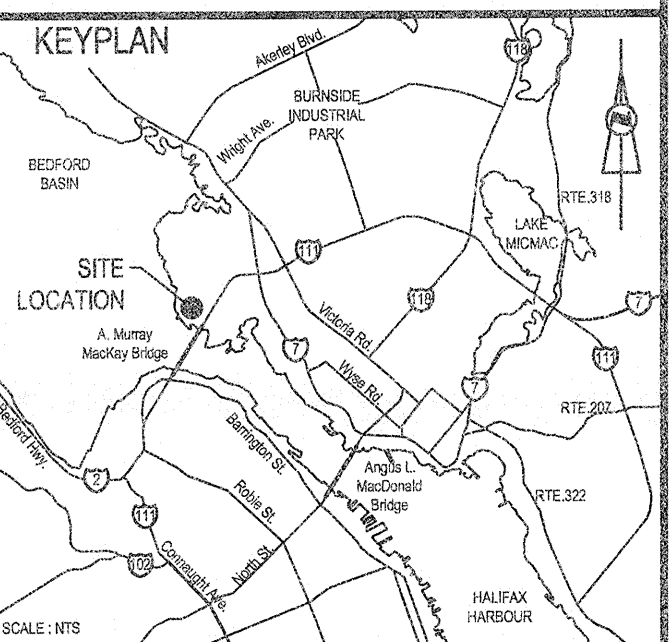


CO1 ISSUED FOR TENDER *advc* JULY 24 2017
 revisions date
 project
BEDFORD INSTITUTE OF OCEANOGRAPHY WATER UPGRADES DARTMOUTH, NOVA SCOTIA


drawing dessin
MARINA ELECTRICAL BUILDING LAYOUT

designed D.C. conçu
 date
 drawn S.M. dessiné
 date
 approved approuvé
 date
 Tender *[Signature]* Soumission
 PWGSC Project Manager Administrateur de projets TPSGC
 project number no. du projet
R.0812155.001
 drawing no. no. du dessin
E02

LEGEND	
SYMBOL	DESCRIPTION
[R]	RTD JUNCTION BOX
[T]	TEE KIT
[E]	END TERMINATION KIT
[P]	POWER CONNECTION KIT
[R1]	TEMPERATURE CONTROL RTD
[R2]	HIGH TEMPERATURE CUTOFF RTD
[]	BREAKER
[]	N.O. CONTACT
LINE TYPE	DESCRIPTION
----	UNDER GROUND CONDUIT

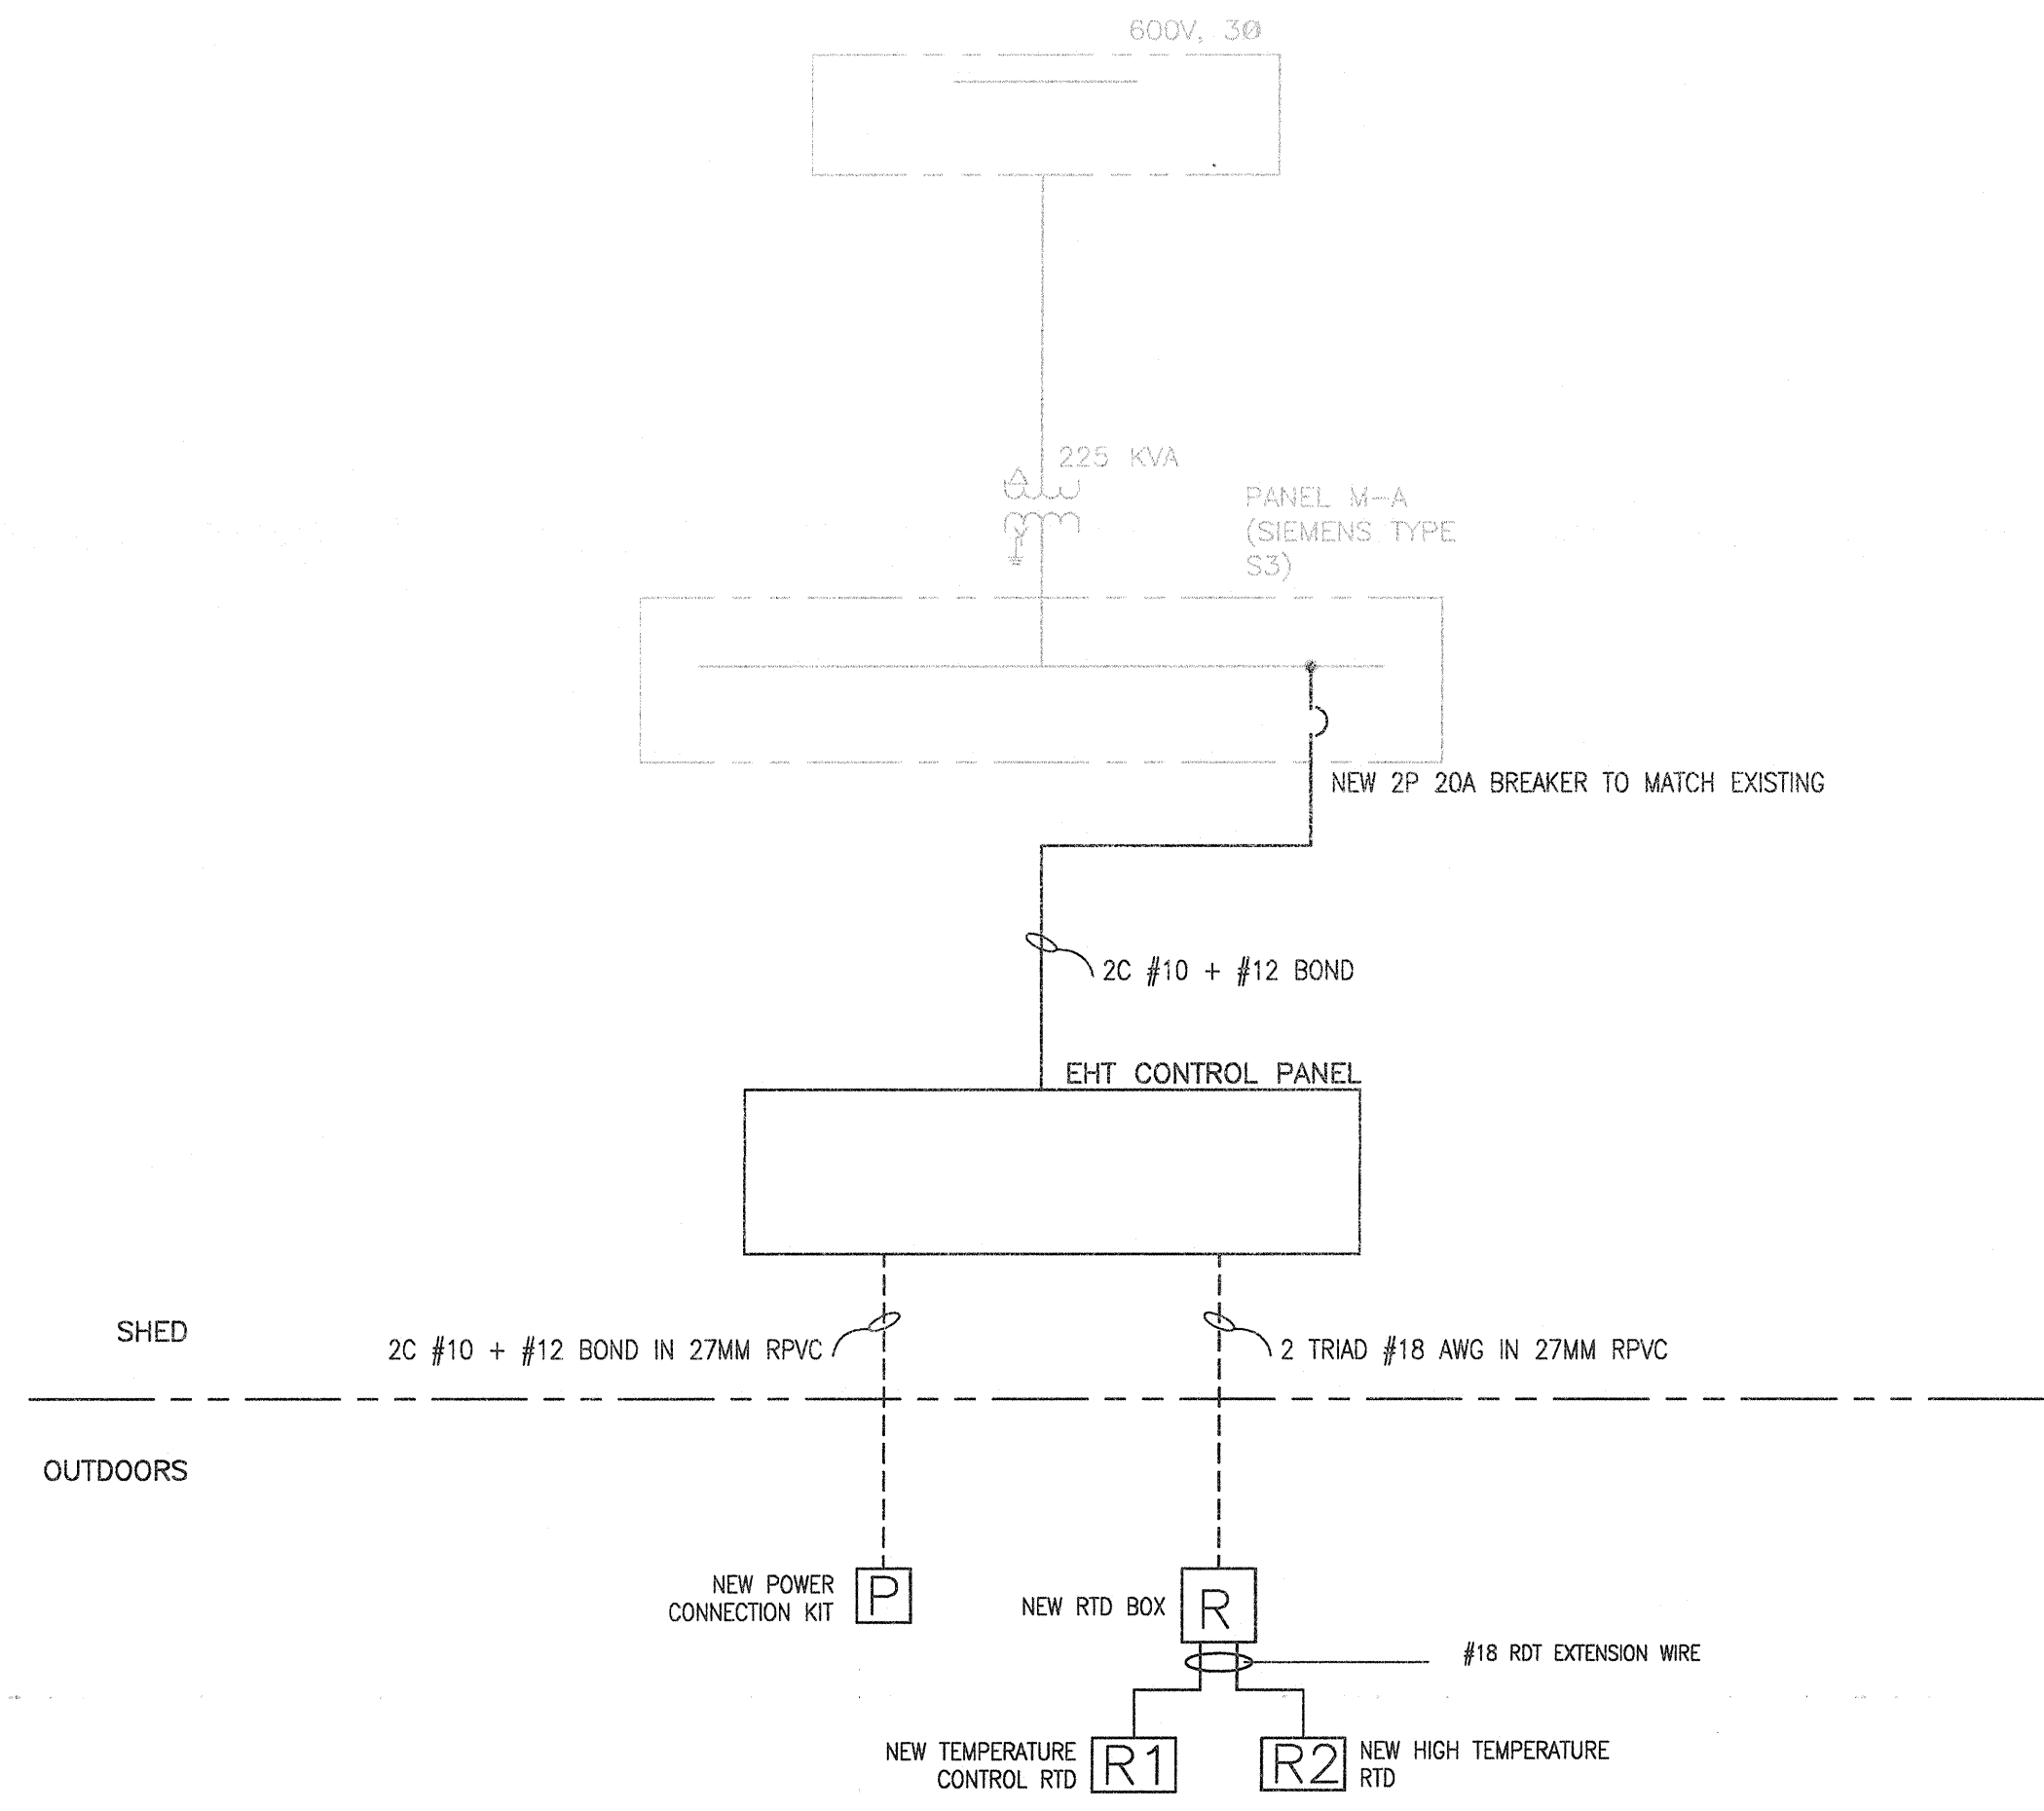

EXISTING PARTIAL SINGLE LINE DIAGRAM 12
 SCALE : N.T.S.

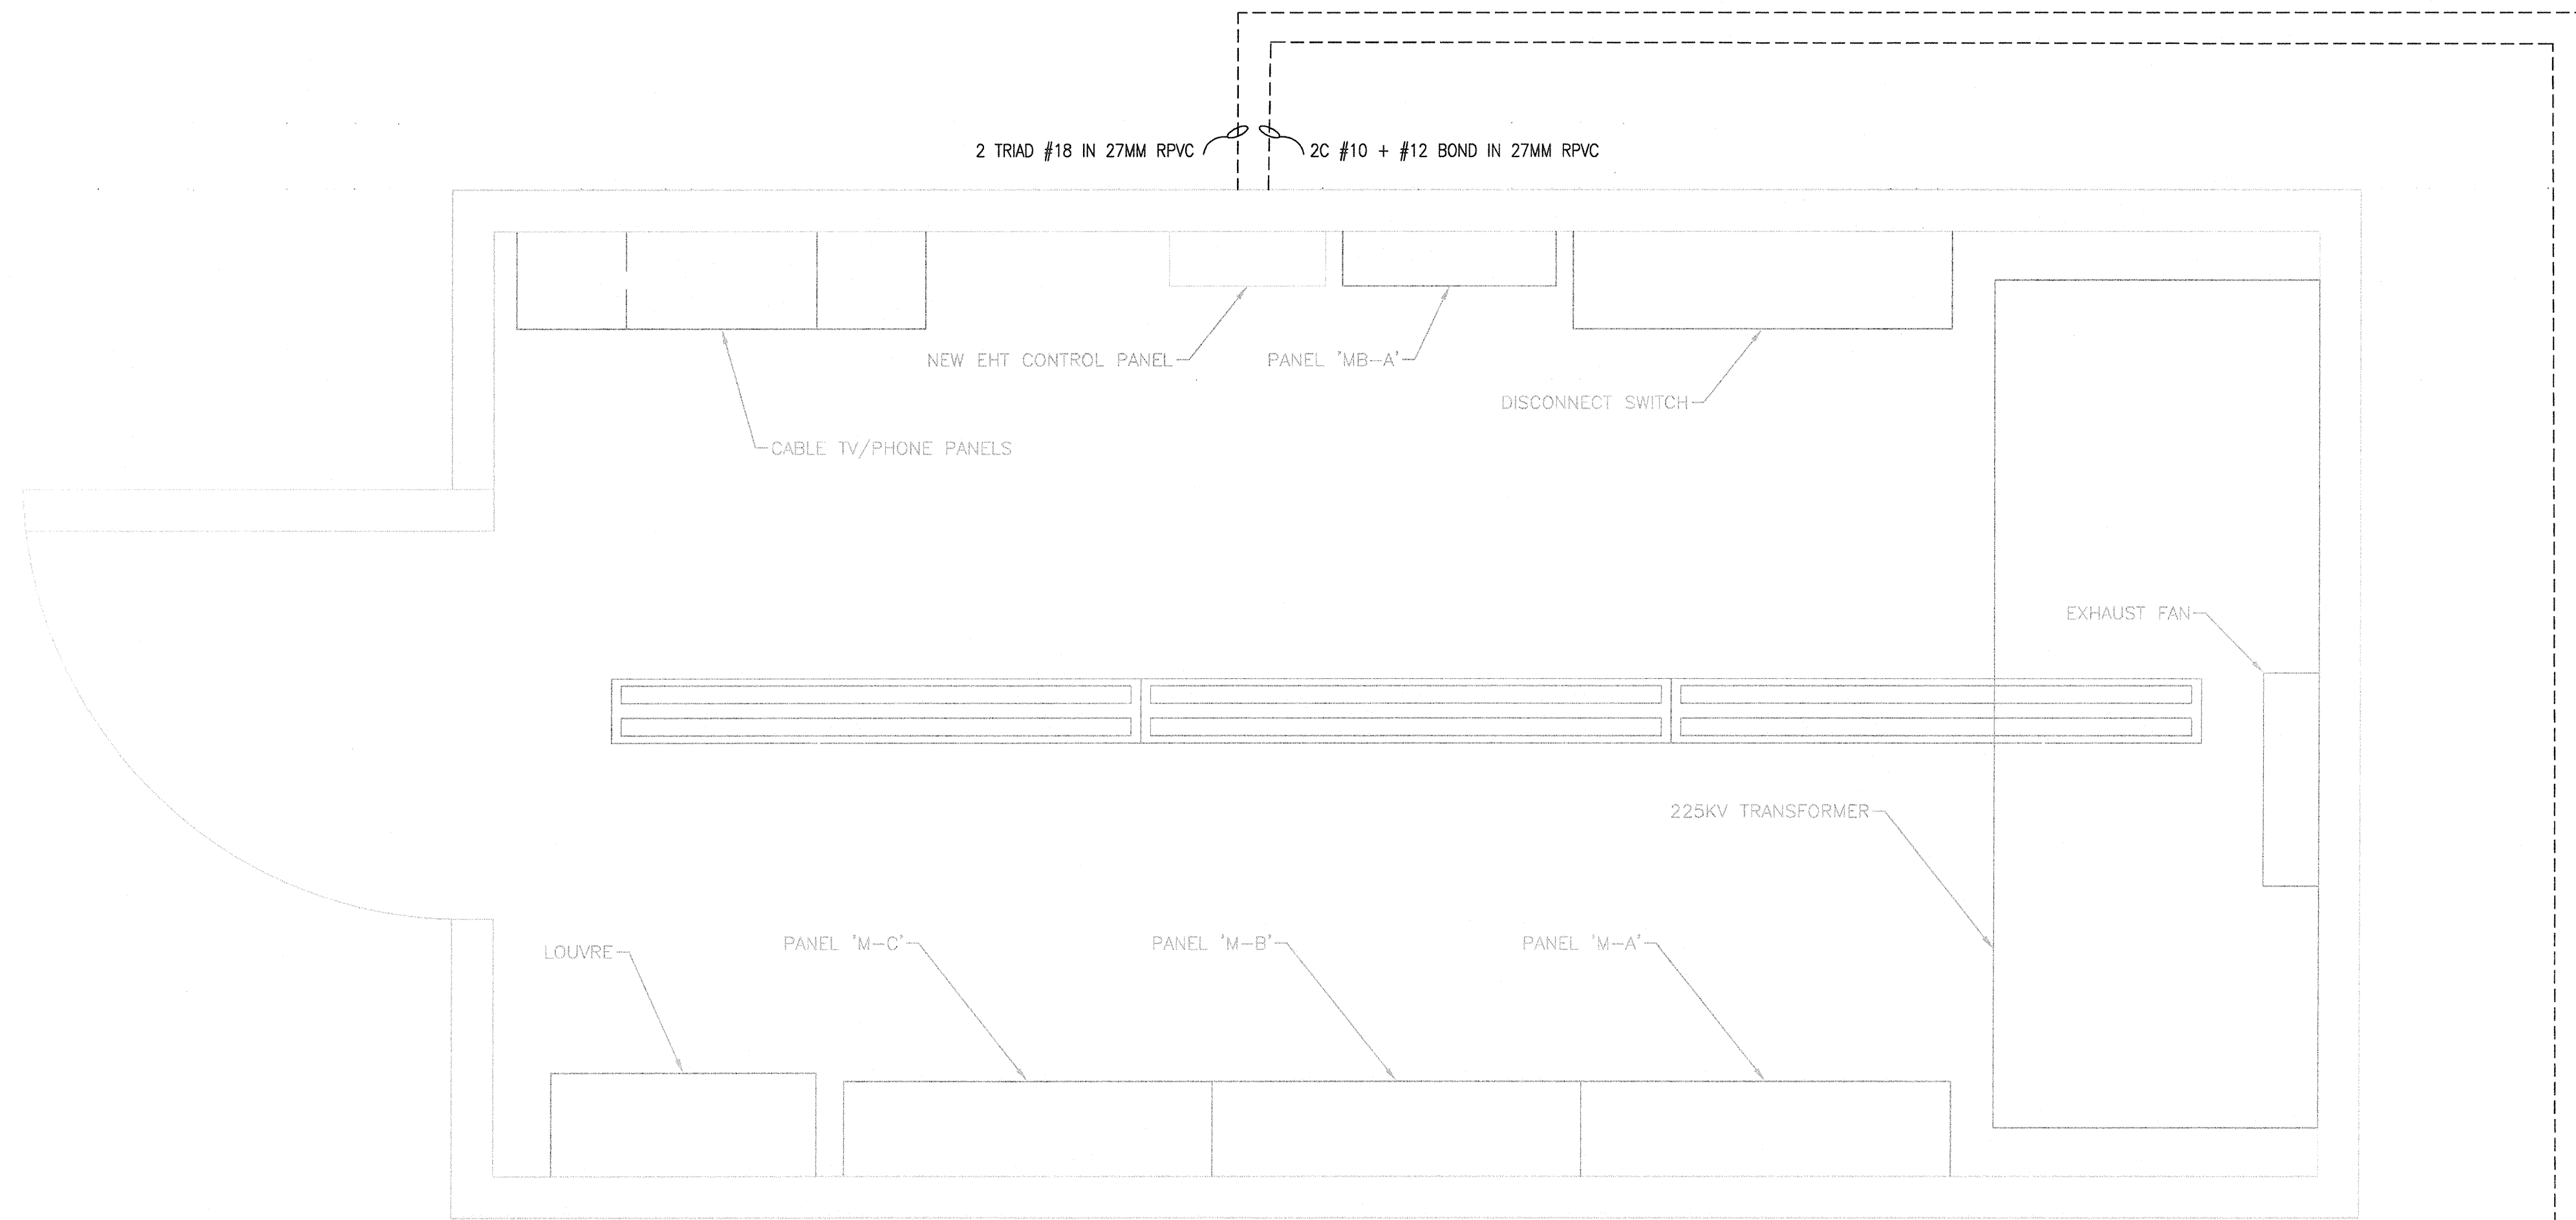

EXISTING MARINA ELECTRICAL BUILDING 13
 SCALE : N.T.S.

TO PIPE. REFER TO ELECTRICAL SITE PLAN ON DWG E01