
ROYAL CANADIAN MOUNTED POLICE INTERIOR / EXTERIOR RENOVATIONS FALCON LAKE, MANITOBA CONSTRUCTION




THE GENERAL CONTRACTOR SHALL VERIFY ALL DIMENSIONS, DATUMS AND LEVELS PRIOR TO COMMENCEMENT OF WORK AND IS HELD RESPONSIBLE FOR REPORTING ANY DISCREPANCY OR OMISSION TO CAN-TEC SERVICES LID. IMMEDIATELY.

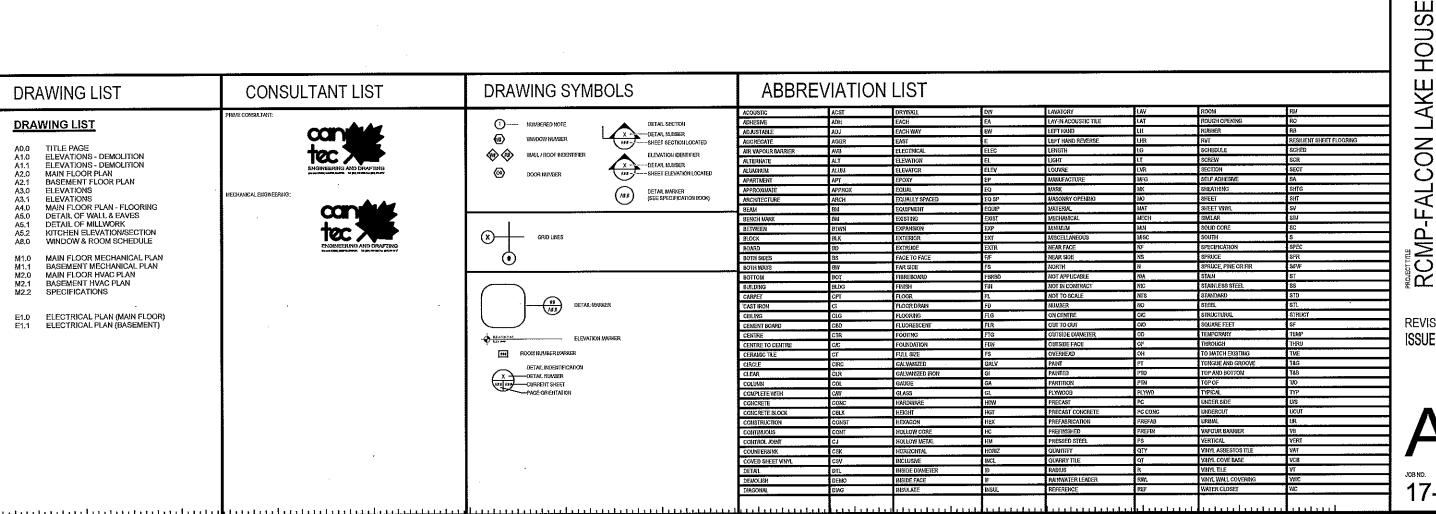


SHEET TIME COVER

REVISION NO. ISSUED FOR CONSTRUCTION

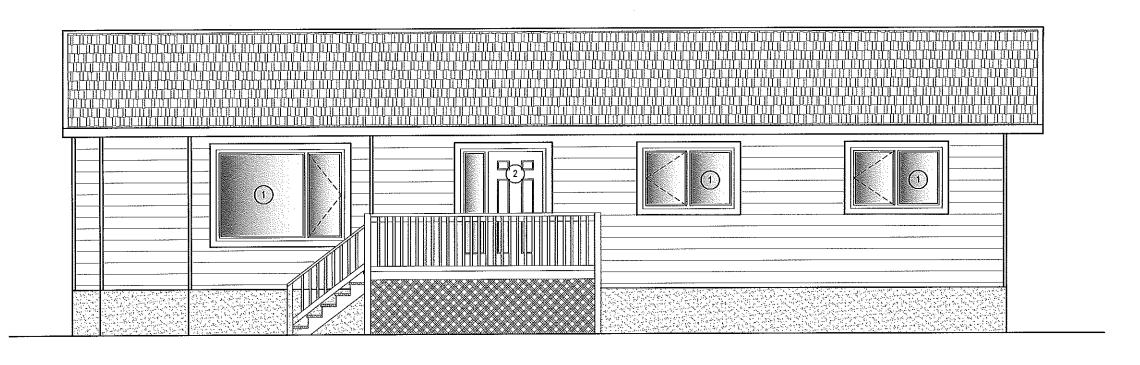

1 FRONT ELEVATION
SCALE: 3/16'=1'-0'

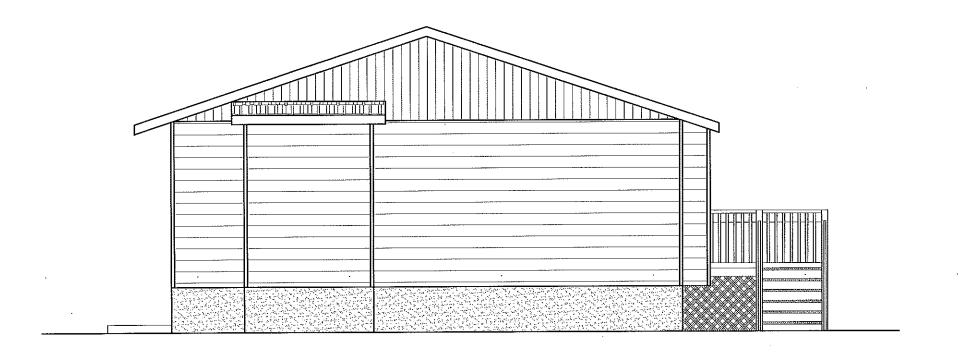

DRAWING NOTES: (#)

. REMOVE WINDOWS

2. REMOVE DOOR

REVISION NO. 01
ISSUED FOR CONSTRUCTION

ELEVATIONS-DEMOLITION

SCALE AS NOTED

_{рате} 17-07-11 LICOATION 17 FALCON BV, FALCON LAKE, MB

RCMP-FALCON LAKE HOUSE

THIS DRAWING MUST NOT BE SCALED.


ENGINEERING AND DRAFTING

A1.0


17-037-01-11

LEFT SIDE ELEVATION

SCALE: 3/16'=1'-0'

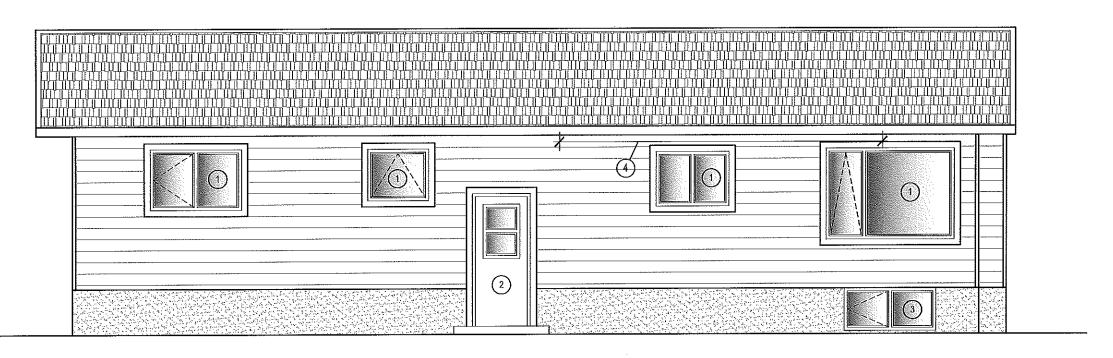

REAR ELEVATION SCALE: 3/16'=1'-0'

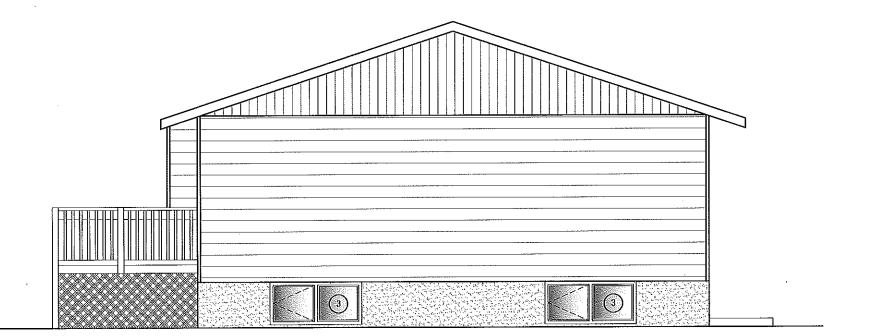


DRAWING NOTES: (#)

1. REMOVE WINDOWS

2. REMOVE DOOR

BASEMENT WINDOW TO REMAIN

REMOVE DAMAGED SOFFIT APPROXIMATELY 25'-0"

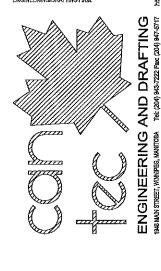

ELEVATIONS-DEMOLITION

RCMP-FALCON LAKE HOUSE

SCALE AS NOTED


17 FALCON BV, FALCON LAKE,

_{оате} 17-07-11

REVISION NO. 01
ISSUED FOR CONSTRUCTION

17-037-01-11

RIGHT SIDE ELEVATION

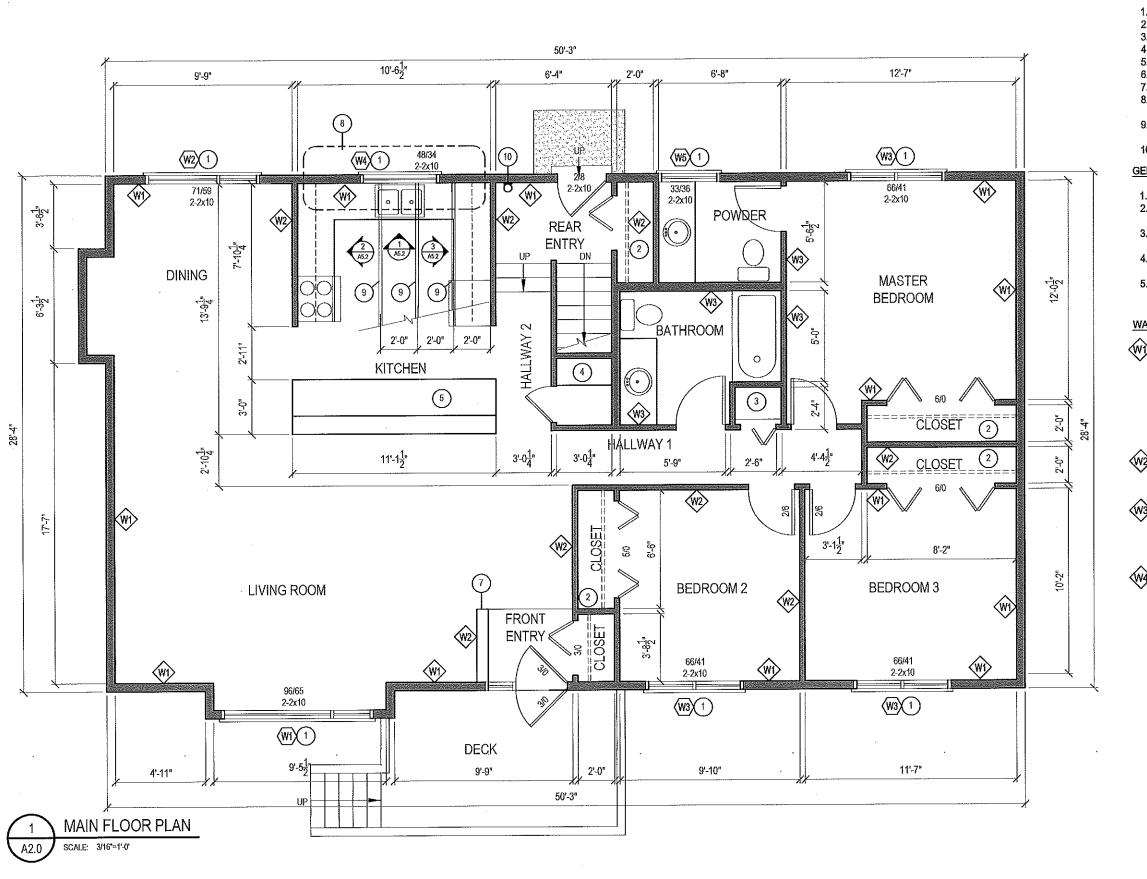

DRAWING NOTES: (#)

- REMOVE AND REPLACE WINDOW
- INSTALL NEW SHELF AND ROD
- INSTALL LAUNDRY SHELVES @ 30" O.C.
- ADD FOUR SHELVES SPACED EVENLY
- **NEW ISLAND 2-LEVEL**
- NEW KITCHEN MILLWORK
- 42" HIGH HALF WALL C/W 1" BIRCH CAP
- REMOVE, CLEARED STUD AND REPLACE AT REAR OF KITCHEN
- SISTER 3 ROOF TRUSSES EACH SIDE WITH 2x4x8'-0"
- NEW 10 LBS. ABC FIRE EXTINGUISHER

GENERAL NOTES:

- INSTALL ALL NEW TRIM THROUGHOUT THE HOUSE.
- INSTALL NEW DRYWALL AND REPAINT **THROUGHOUT**
- INSTALL NEW ATTIC INSULATION AND INSULATION
- INSTALL NEW FLOORING THROUGHOUT MAIN FLOOR AND LOWER LANDING
- ALL DRYWALL IN BATHROOM AND KITCHEN TO BE 1/2" AQUA BOARD

WALL TYPES:

EXISTING SIDING EXISTING AIR BARRIER EXISTING 3/8" SHEATHING **EXISTING 2x6 STUDS** NEW R-22 ROXUL INSULATION NEW 6MIL AUB NEW 1/2" DRYWALL FINISH PAINT



NEW 1/2" DRYWALL 2x4 OR 2x6 STUDS @ 16" O.C. **NEW 1/2" MOISTURE RESISTANT** DRYWALL IN BATHROOMS

EXISTING 8" CONCRETE WALL NEW 1" AIR SPACE NEW 2x4 NO.2 SPRUCE STUDS @ 16" O.C. NEW R-22 ROXUL INSULATION **NEW 6MIL AUB** NEW 1/2" DRYWALL FINISH PAINT

THIS DRAWING MUST NOT BE SCALED.

THE GENERAL CONTRACTOR SHALL VERIFY ALL DIMENSIONS, DATIJUS AND LEVELS PRIOR TO COMMENCEMENT OF WORK AND IS HELD RESPONSIBLE FOR REPORTING ANY DISCREPANCY OR CAUSSION TO CAN-TEC SERVICES LTD, IMMEDIATELY.

THIS DRAWING IS THE EXCLUSIVE PROPERTY OF CANTEC SERVICES LTD. AND CAN BE REPRODUCED ONLY WITH THE PERUSSION OF CANTEC SERVICES LTD. IN WHICH CASE THE REPRODUCTION MUST BEAR THEIR NAME AS THE ENGINEERING/DRAFTING FIRM.



FLOOR PLAN

RCMP-FALCON LAKE HOUSE

Š

_{рате} 17-07-11


17 FALCON I

REVISION NO. ISSUED FOR CONSTRUCTION

MAIN

17-037-01-11

Last Save:2017-07-11 3:45 PM

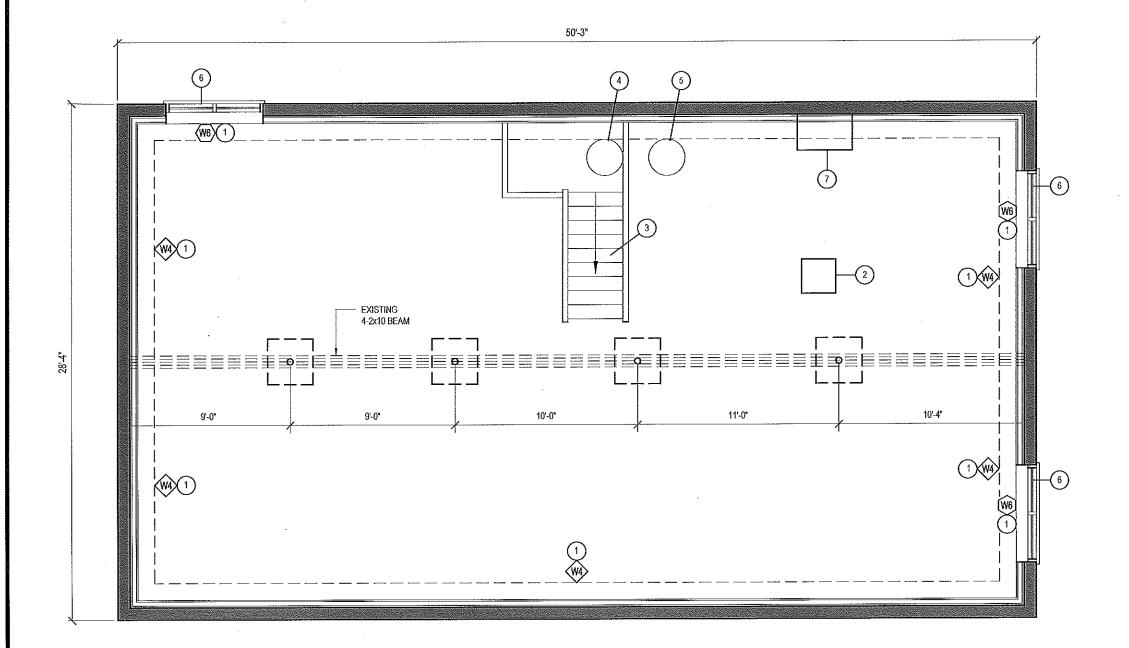

DRAWING NOTES: (#)


- NEW INTERIOR WALLS
- NEW FURNACE SEE MECHANICAL DRAWING
- EXISTING STAIRS C/W NEW FLOOR COVERINGS
- EXISTING SUMP PIT (NEW PUMP)
- NEW HOT WATER TANK
- EXISTING BASEMENT WINDOWS TO REMAIN
- NEW HRV SEE MECHANICAL DRAWING

GENERAL NOTES:

- INSTALL ALL NEW TRIM THROUGHOUT THE HOUSE.
- INSTALL NEW DRYWALL AND REPAINT THROUGHOUT
- INSTALL NEW ATTIC INSULATION AND INSULATION STOPS
- INSTALL NEW FLOORING THROUGHOUT MAIN FLOOR AND LOWER LANDING

WALL TYPES:

W1 EXISTING SIDING EXISTING AIR BARRIER EXISTING 3/8" SHEATHING **EXISTING 2x6 STUDS** NEW R-22 ROXUL INSULATION NEW 6MIL AUB NEW 1/2" DRYWALL FINISH PAINT

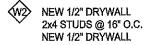

NEW 1/2" DRYWALL 2x4 OR 2x6 STUDS @ 16" O.C. NEW 1/2" MOISTURE RESISTANT DRYWALL IN BATHROOMS

EXISTING 8" CONCRETE WALL NEW 1" AIR SPACE NEW 2x4 NO.2 SPRUCE STUDS @ 16" O.C. NEW R-22 ROXUL INSULATION **NEW 6MIL AUB** NEW 1/2" DRYWALL FINISH PAINT

THIS DRAWING MUST NOT BE SCALED.

THE GENERAL CONTRACTOR SHALL VERIFY ALL DIMENSIONS, DATIJAS AND LEVELS PRIOR TO COMMENCEMENT OF WORK AND IS HELD RESPONSIBLE FOR REPORTING ANY DISCREPANCY OR OMISSION TO CAN-TEC SERVICES LTD. MAJEDIMEN.

THIS DRAWING IS THE EXCLUSIVE PROPERTY OF CAN-TEG SERVICES LTD., AND CAN BE REPRODUCED ONLY WITH THE PERMISSION OF CAN-TEG SERVICES LTD. IN WHICH CASE THE REPRODUCTON HAUST BEAR THEIR NAME AS THE ENGINEERING/DRAFTING FIRM.



BASEMENT FLOOR PLAN

RCMP-FALCON LAKE HOUSE


олте 17-07-11

LOCATION 17 FALCON E


REVISION NO. ISSUED FOR CONSTRUCTION

17-037-01-11

BASEMENT FLOOR PLAN

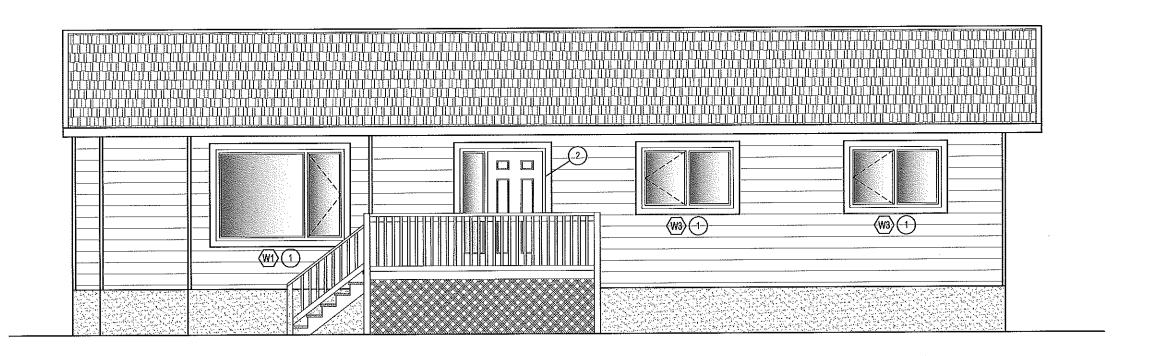


FRONT ELEVATION

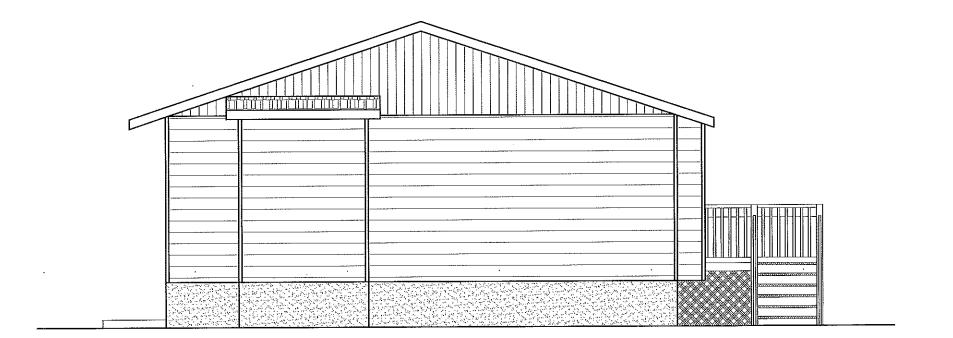

DRAWING NOTES: (#)

 INSTALL NEW WINDOWS
 INSTALL NEW EXTERIOR DOOR AND SIDE LIGHT. DOOR TO BE C/W WITH STORM DOOR

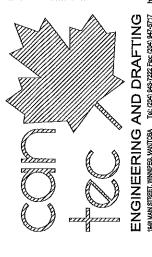

DRAWN BY RQS

RCMP-FALCON LAKE HOUSE

ELEVATIONS


17 FALCON BV, FALCON LAKE,

DATE 17-07-11


REVISION NO. ISSUED FOR CONSTRUCTION

A3.0
17-037-01-11

LEFT SIDE ELEVATION SCALE: 3/16'=1'-0'

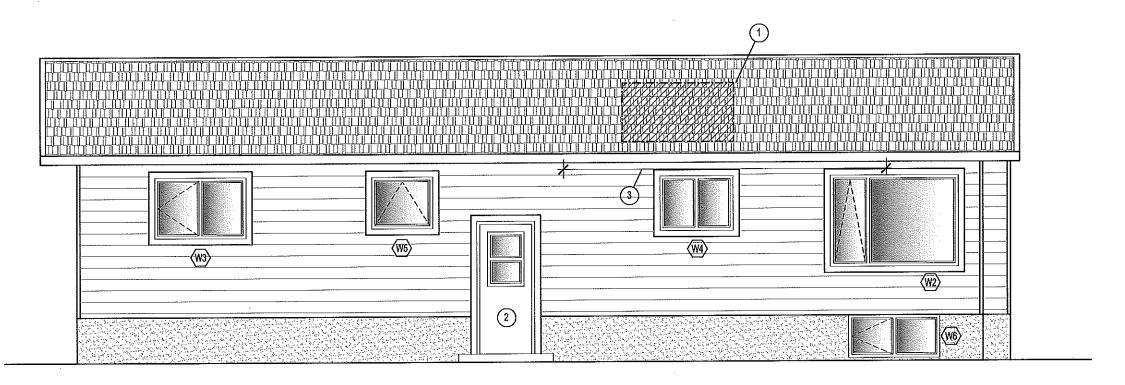




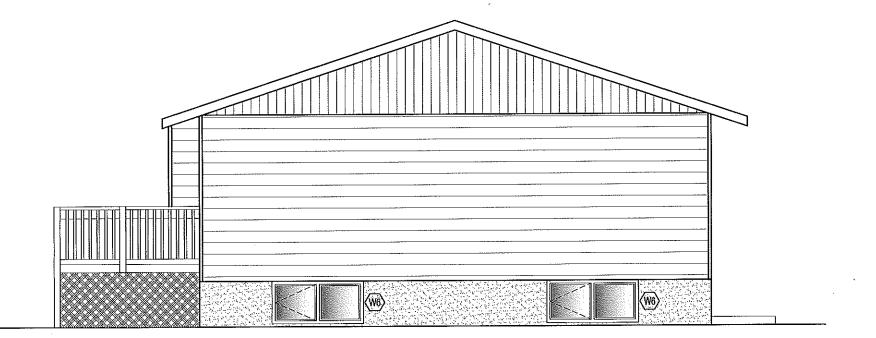

DRAWING NOTES: (#)

- FIXED DAMAGED ROOF WITH 3/8" PLYWOOD NEW UNDERLAYMENT AND SHINGLES TO MATCH EXISTING APPROXIMATELY AREA 4'x6' HOLE.
- 2. INSTALL NEW EXTERIOR DOOR AND STORM DOOR
- REMOVE DAMAGED SOFFIT AND RE-INSTALL. COLOR AND TYPE TO MATCH EXISTING (APPROXIMATELY 25'-0")

THE GENERAL CONTRACTOR SHALL VERIFY ALL DIVERSIONS, DATIMS AND LEVELS PRIOR TO COMMENCEMENT OF WORK AND IS HELD RESPONSIBLE FOR REPORTING MY DISCREPANCY OR CAUSSION TO CAN-TEC SERVICES LTD. IMMEDIATELY.

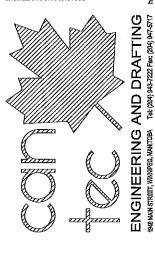

RS S

DRAWN BY RQS

RCMP-FALCON LAKE HOUSE

ELEVATIONS

LICCATION 17 FALCON BV, FALCON LAKE,


_{рате} 17-07-11

REVISION NO. ISSUED FOR CONSTRUCTION

A3.1

17-037-01-11


RIGHT SIDE ELEVATION SCALE: 3/16"=1'-0'

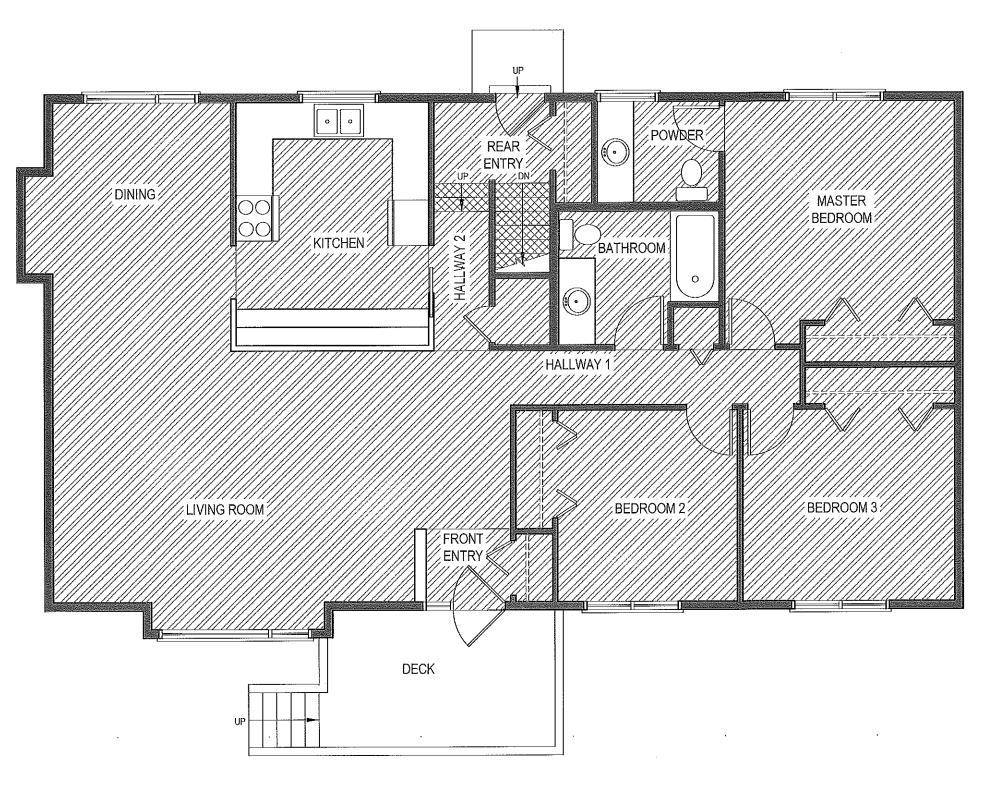

LEGEND:

VINYL PLANK FLOORING (VP-1) STAIR TREADS

HOUSE TO HAVE 1/4" UNDERLAYMENT INSTALLED THROUGHOUT.

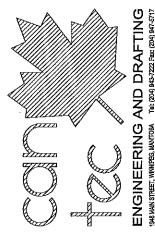

MAIN FLOOR PLAN-FLOORING RCMP-FALCON LAKE HOUSE

SCALE AS NOTED


DRAWN BY RQS


17 FALCON BV, FALCON LAKE, MB рате 17-07-11

REVISION NO. 01
ISSUED FOR CONSTRUCTION

17-037-01-11


MAIN FLOOR PLAN-FLOORING

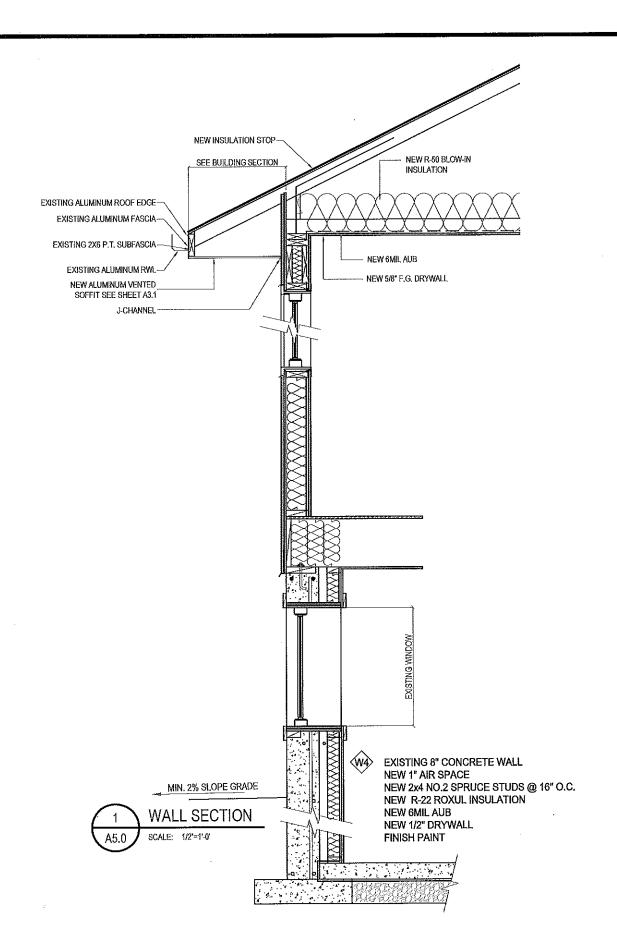

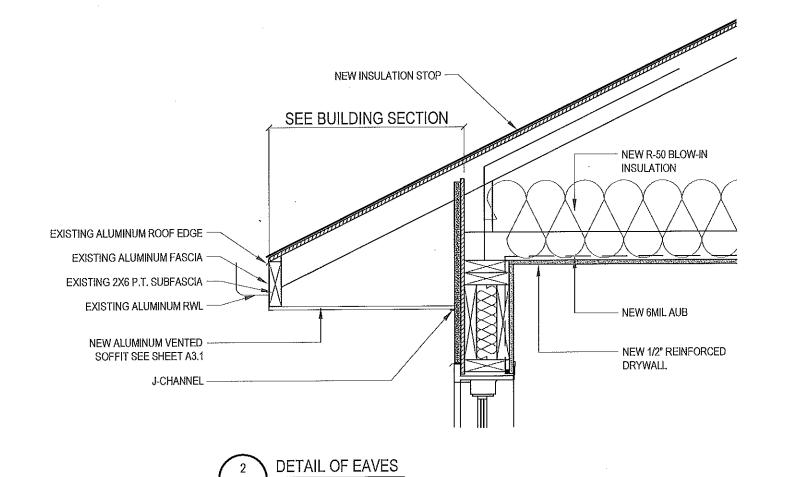

THIS DRAWING MUST NOT BE SCALED.

THIS DRAWING IS THE EXCLUSIVE PROPERTY OF CAN-TEC SERVICES LTD. AND CAN BE SERVICES LTD. AND CAN BE SERVICES LTD. AVITH THE PERMISSION OF CAN-TEC SERVICES LTD. AVITHCH CASE: THE REPRODUCTION MAST BEAR THEIR NAME AS THE ENGINEERINGDRAFTING FOR

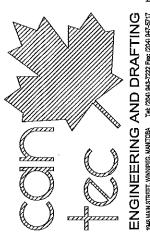

RCMP-FALCON LAKE HOUSE


& EAVES DRAWN BY RQS OF WALL

17 FALCON BV, F _{рате} 17-07-11


REVISION NO. ISSUED FOR CONSTRUCTION

DETAIL

A5.0

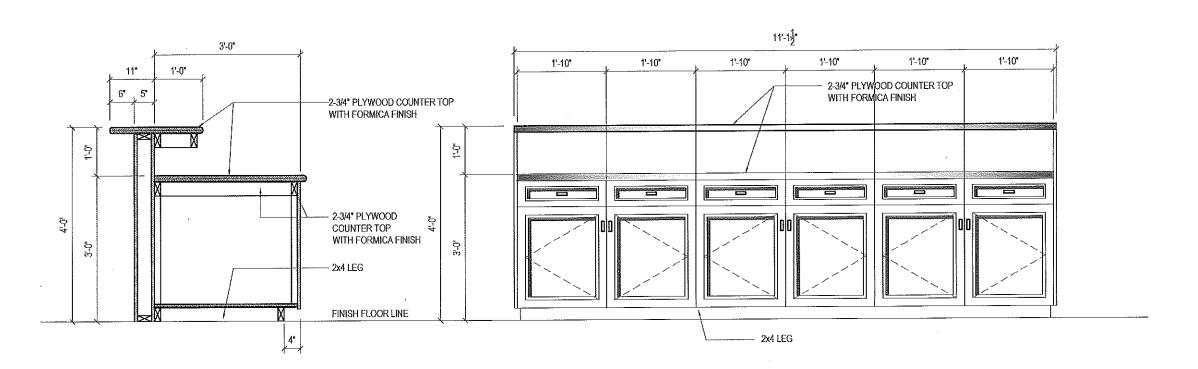



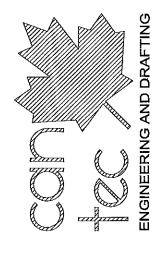

RCMP-FALCON LAKE HOUSE


DETAIL OF MILLWORK

_{рате} 17-07-11


LOCATION 17 FALCON BV, FALCON LAKE, MB

REVISION NO. 01
ISSUED FOR CONSTRUCTION

A5.1

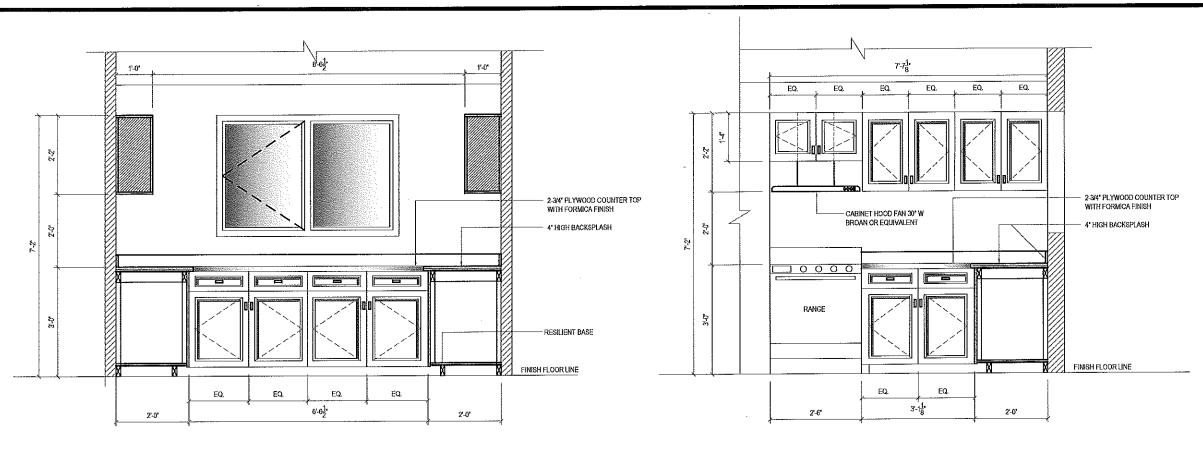

1 KITCHEN ELEVATION / SECTION
SCALE: 3/8"=1"-0"

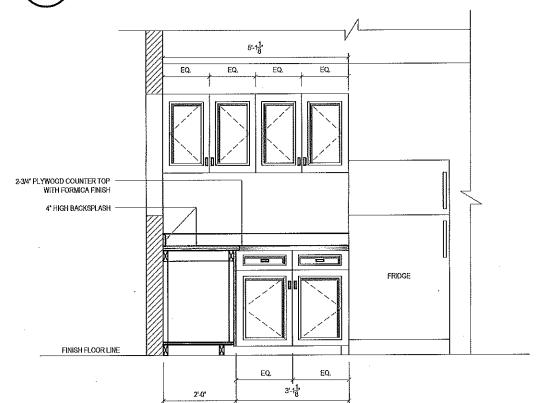


3 KITCHEN ELEVATION / SECTION
A5.2 SCALE: 3/8'=1'-0'

2 KITCHEN ELEVATION / SECTION
A5.2 SCALE: 3/8"=1"-0"

GENERAL CONTRACTOR SHALL VERIFY ALL NOSIONS, DATUMS AND LEVELS PRIOR TO WENCEMENT OF WORK AND IS HELD ONSBUE FOR REPORTING ANY REPANCY OR OWNSION TO CAN-TEC ICES LTD. IMMEDIATELY.

THIS DRAWING IS THE EXCLUSIVE PROPERTY (
CAN-TEC SERVICES LTD. AND CAN BE
REPRODUCED CALLY WITH THE PERMISSION OF
CAN-TEC SERVICES LTD. IN WHICH CASE THE
REPRODUCTION MUST BEAR THEIR NAME AS T
ENGINEER BING OR BEATING FROM

THIS DRAWING MUST NOT BE SCALED.

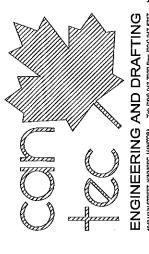

RCMP-FALCON LAKE HOUSE
SMETTING
KITCHEN ELEVATION / SECTION


REVISION NO. 01
ISSUED FOR CONSTRUCTION


LOCATION 17 FALCON BV, FALCON LAKE, MB


SCALE AS NOTED


рате 17-07-11


A5.2

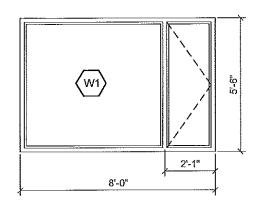


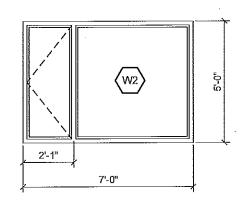

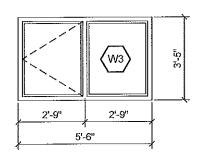

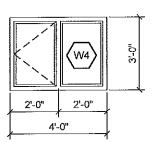

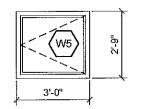

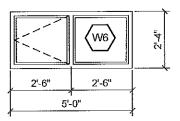



WINDOW ELEVATION

ROOM NAME	WALLS								CEILING		
	NORTH		SOUTH		EAST		WEST		OLILINO		REMARKS
	MATERIAL	FINISH	MATERIAL.	FINISH	MATERIAL	FINISH	MATERIAL	FINISH	MATERIAL	FINISH	
LIVING ROOM	DRYWALL	PAINT	DW	PAINT	DRYWALL	PAINT	DRYWALL	PAINT	DRYWALL		
DINING	DW	PAINT	DW	PAINT	DRYWALL	PAINT	DRYWALL	PAINT	DRYWALL		
KITCHEN	DW	PAINT	DW	PAINT	DRYWALL	PAINT	DRYWALL	PAINT	DRYWALL		
MASTER BEDROOM	DW	PAINT	DW	PAINT	DRYWALL	PAINT	DRYWALL	PAINT	DRYWALL		
BEDROOM 2	DW	PAINT	DW	PAINT	DRYWALL	PAINT	DRYWALL	PAINT	DRYWALL		
BEDROOM 3	DW	PAINT	DW	PAINT	DRYWALL	PAINT	DRYWALL	PAINT	DRYWALL		
HALLWAY 1	DW	PAINT	DW	PAINT	DRYWALL	PAINT	ORYWALL	PAINT	DRYWALL		
HALLWAY 2	DW	PAINT	D₩	PAINT	DRYWALL	PAINT	DRYWALL	PAINT	DRYWALL		
BATHROOM	DW	PAINT	DW	PAINT	DRYWALL	PAINT	DRYWALL	PAINT	DRYWALL		
POWDER ROOM	DW	PAINT	DW	PAINT	DRYWALL	PAINT	DRYWALL	- PAINT	DRYWALL.		

NOTES:


- . 6 MIL POLY RETURNED INTO ROUGH WINDOW OPENING AND SEALED TO WOOD FRAMING
- 2. AIR BARRIER RETURNED INTO ROUGH WINDOW OPENING AND SEALED TO WOOD FRAMING
- 3. SPRAY FOAM INSULATION INTO SPACES BETWEEN WINDOW AND ROUGH OPENING
- 4. PROVIDE PRE FINISHED POST FORMED GALVANIZED STEEL FLASHING FULL WIDTH OF WINDOW AT TOP OF WINDOW
- 5. BEDROOM WINDOWS MUST MEET NBC EGRESS REQUIREMENTS AS PER 9.7.1.3.2
- 6. INSTALL NEW WINDOW AND DOOR CASING TO ALL UNITS BEING REPLACED.


WINDOW & ROOM SCHEDULE RCMP-FALCON LAKE HOUSE

REVISION NO. ISSUED FOR CONSTRUCTION

17-037-01-11

0.8A

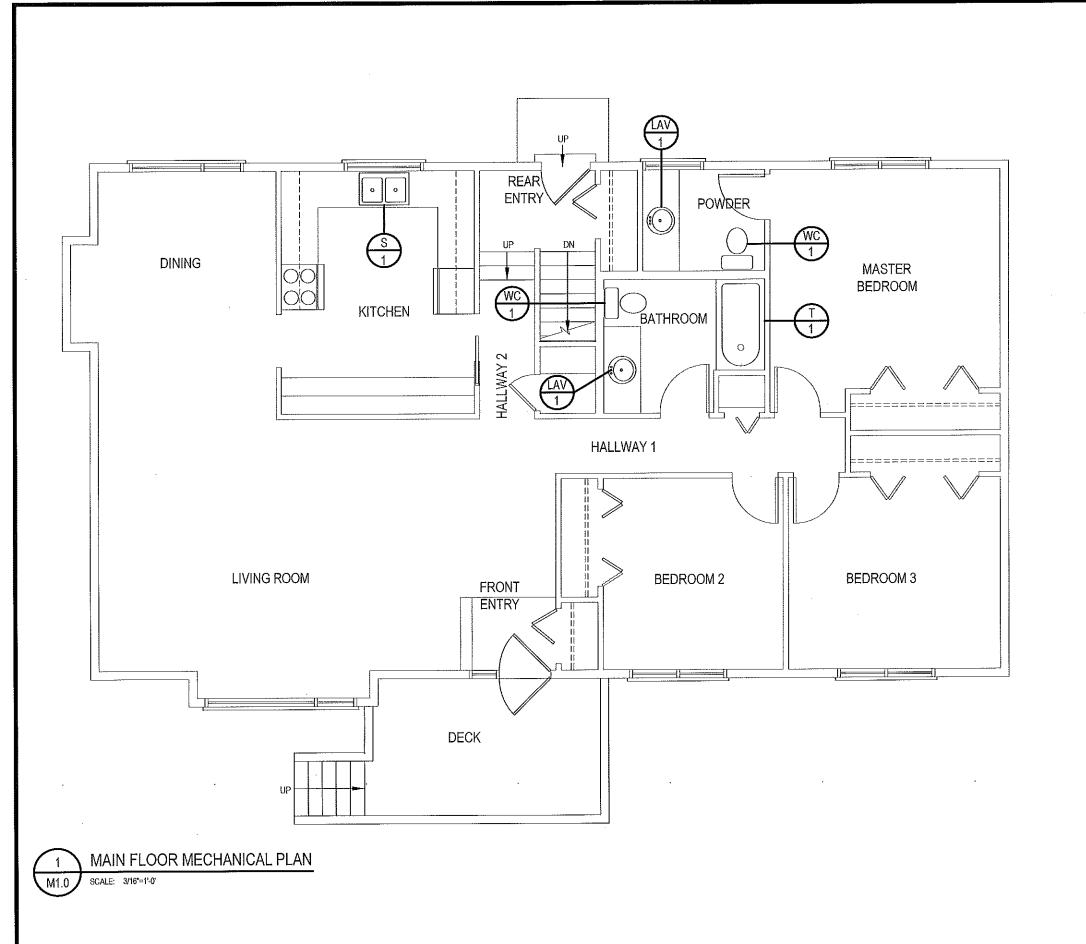

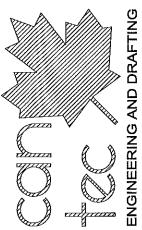

PLUMBING GENERAL NOTES:

- INSTALL NEW FIXTURES AND NEW DOMESTICE WATER AND SANITARY PIPING TO EXISTING PLUMBING STACK
- 2. INSTALL NEW HWT C/W SHUT OFF VALVE DRAIN PAN
- 3. RE-RUN ALL DOMESTIC HOT AND COLD WATER LINES BACK TO SERVICE ENTRY
- 4. INSTALL NEW SUMP PUMP 1/3 HP SUPPLY SHOP DRAWING

RCMP-FALCON LAKE HOUSE

MAIN FLOOR MECHANICAL PLAN


_{рате} 17-07-11

REVISION NO. ISSUED FOR CONSTRUCTION

M1.0

17-037-01-11


Last Save:2017-07-11 3:45 PM

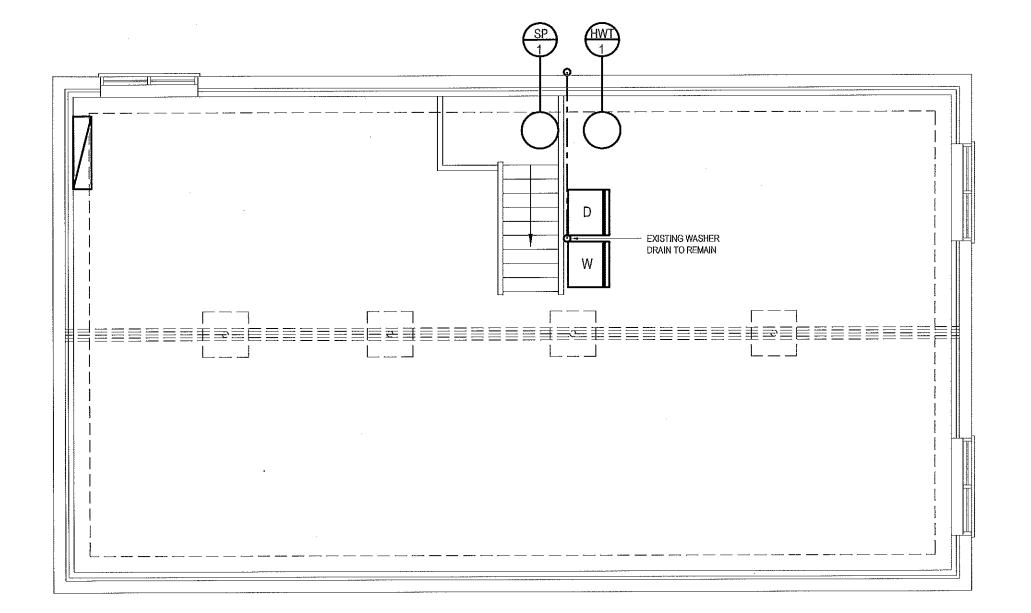

THIS DAMING MUST NOT BE SCALED

EGENERAL CONTRACTOR SHALL VERIFY ALL ENSIONS, DATUMS AND LEVELS PRIOR TO MAYENCEMENT OF WORK AND IS HELD SPONSIBLE FOR REPORTING ANY CREPANCY OR OMISSION TO CAN-TEC

THIS DRAWING IS THE EXCLUSIVE PROPERTY OF AN INCREMENT OF AN I

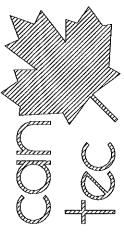

PLUMBING GENERAL NOTES:

- INSTALL NEW FIXTURES AND NEW DOMESTICE WATER AND SANITARY PIPING TO EXISTING PLUMBING STACK
- 2. INSTALL NEW HWT C/W SHUT OFF VALVE DRAIN PAN
- 3. RE-RUN ALL DOMESTIC HOT AND COLD WATER LINES BACK TO SERVICE ENTRY
- 4. INSTALL NEW SUMP PUMP 1/3 HP SUPPLY SHOP DRAWING

RCMP-FALCON LAKE HOUSE
SHETTINE
BASEMENT MECHANICAL PLAN

REVISION NO. 01
ISSUED FOR CONSTRUCTION


M1.1

17-037-01<u>-11</u>

BASEMENT MECHANICAL PLAN

E1.1 SCALE: 3/16*=1*-0*

Last Save:2017-07-11 3:45

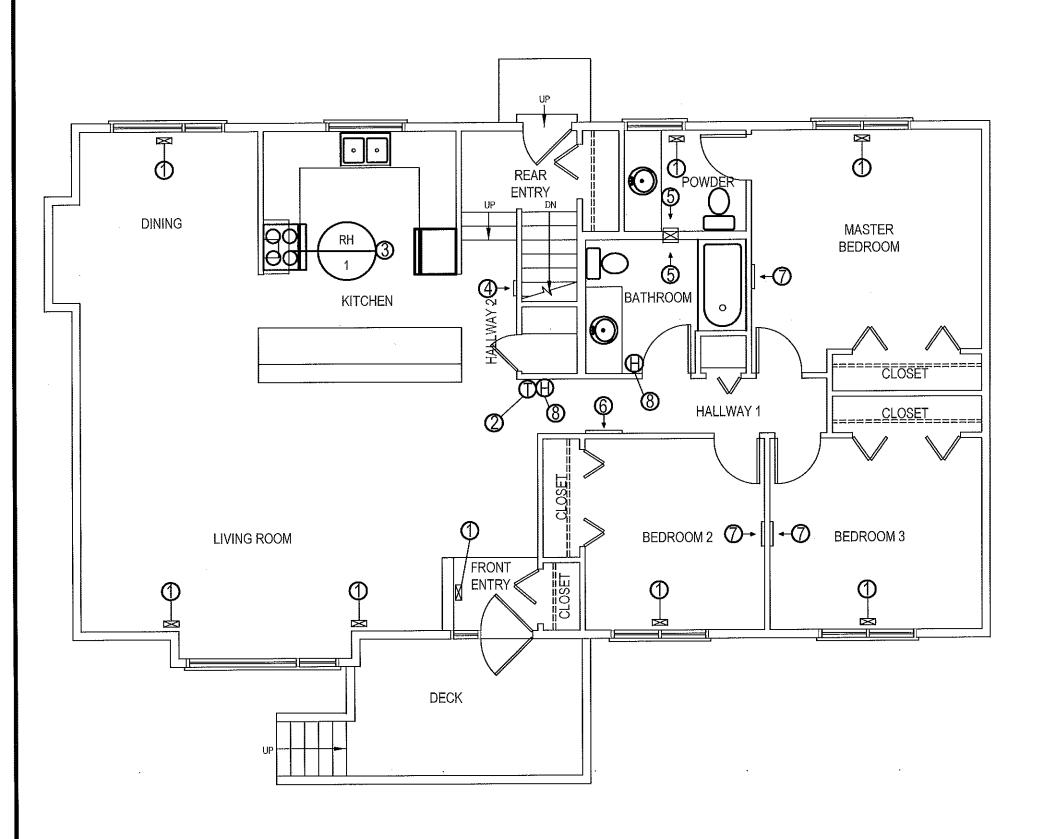

DRAWING NOTES (#):

- 1. INSTALL NEW IMPERIAL GRILLS 10" X 4".
- 2. NEW 7 DAYS PROGRAMMABLE THERMOSTAT.
- 3. NEW RANGE HOOD, EXHAUST DUCT THROUGH ROOF C/W GOOSE NECK.
- 4. RE-LOCATE KITCHEN EXHAUST 10" X 8" SIDE WALL C/W GREASE FILTER.
- 5. NEW SIDE WALL EXHAUST 10" X 8".
- 6. BASEBOARD GRILL 24" X 8".
- 7. BASEBOARD GRILL 16" X 8".
- 8. HRV CONTROLLER



WD MAIN FLOOR HVAC

RCMP-FALCON LAKE HOUSE


17 FALCON BV, FALCON LAKE,

REVISION NO. ISSUED FOR CONSTRUCTION

M2.0

17-037-01-11

MAIN FLOOR HVAC SCALE: 3/16*=1'-0'

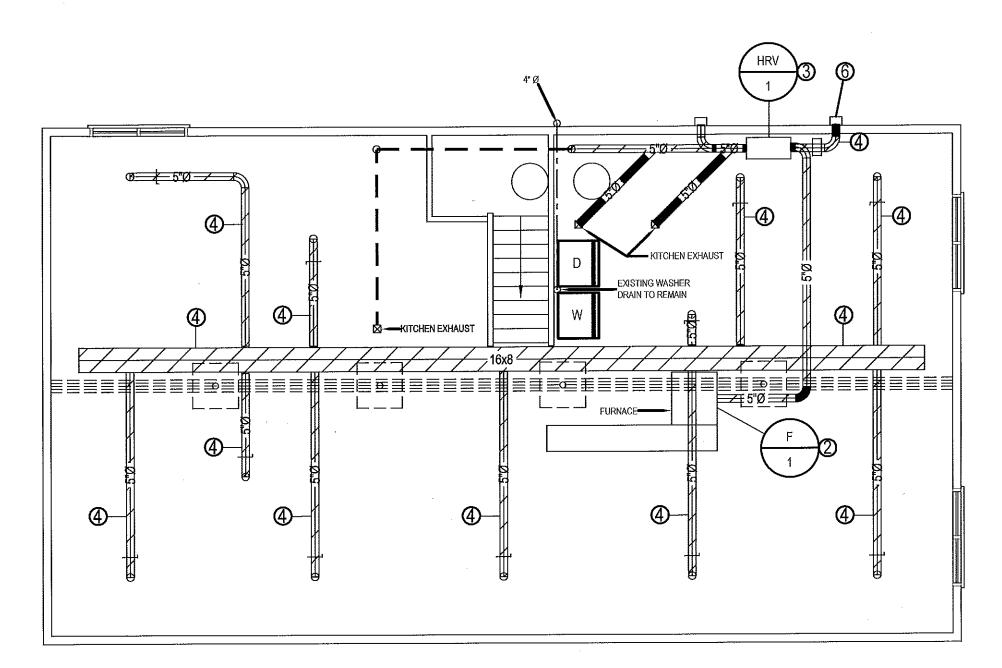

BASEMENT FLOOR HVAC M2.1 SCALE: 3/16"=1'-0"

DRAWING NOTES: Q

- 1. NOT USED
- NEW FURNACE MOUNT ON STAND 12" OFF FLOOR.
 NEW HRV ALL DUCTS TO HRV ARE TO BE RIGID NO FLEXIBLE DUCTS ARE PERMITTED. INSULATE SUPPLY AND EXHAUST LINES AS PER SPECIFICATION.

 4. POWER CLEAN ALL DUCTS.

 5. NEW DRYER EXHAUST 5"Ø C/W GALVANIZED
- FLAPPER VENT.
- 6. 3.0 KW DUCT HEATER C/W SCR



RCMP-FALCON LAKE HOUSE

BASEMENT FLOOR HVAC

рате 17-06-09

REVISION NO. ISSUED FOR CONSTRUCTION

M2.1

17-037-01-11

Last Save:2017-07-11 11:51 AM

MECHANICAL GENERAL SPECIFICATION

- 1. MECHANICAL CONTRACTOR SHALL EMPLOY ONLY CERTIFIED JOURNEYMEN NORMALLY ENGAGED IN THE SHEET METAL AND STEAM FITTING TRADES TO THE SATISFACTION OF THE AUTHORITY HAVING JURISDICTION AND/OR OWNER OR HIS REPRESENTATIVE.
- 2. PROVIDE A WRITTEN ONE YEAR WARRANTY ON ALL WORK DONE UNDER THIS CONTRACT FROM DATE OF ACCEPTANCE.
- 3. THE MANITOBA BUILDING/PLUMBING CODE 2010 SHALL GOVERN THIS PROJECT MECHANICALLY.
- 4 AU CHANGES AND ALTERATIONS REQUIRED BY THE AUTHORIZED INSPECTOR OF THE AUTHORITIES HAVING JURISDICTION SHALL BE CARRIED OUT WITHOUT CHARGE OR EXPENSES
- 5, EACH CONTRACTOR SHALL COORDINATE THE WORK WITH OTHER CONTRACTORS IN ORDER TO
- 6. CONTRACTOR SHALL VERIFY EXACT LOCATIONS, SIZES, INVERTS, ETC PRIOR TO TENDER CLOSE AND COMOMENCEMENT OF WORK.
- 7. COORDINATE THE EXACT LOCATION OF THE GRILLES AND DIFFUSERS ON SITE WITH THE ELECTRICAL CONTRACTOR, GENERAL CONTRACTOR, ARCHITECTURAL REFLECTED CEILING PLAN, LIGHTING LAYOUT, ETC. TO ENSURE THAT THERE ARE NO CONFLICTS DURING
- 8. AT THE COMPLETION OF THE INSTALLATION, PROVIDE TWO MARKED UP COPIES OF THE TENDER DRAWINGS FOR RECORD PURPOSES.
- 9. ALL PIPING, DUCTWORK, AND EQUIPMENT SHALL BE SECURELY SUPPORTED FROM THE BUILDING STRUCTURE TO ACCEPTABLE BUILDING DESIGN STANDARDS. PERFORATED STRAP HANGERS WILL NOT BE PERMITTED. ALL PIPE HANGERS SHALL BE OVERSIZED WITH BOTTOM SADDLE WHERE EXTERIOR PIPE INSULATION IS USED.
- PERMANENT SYSTEMS AND/OR EQUIPMENT SHALL NOT BE USED DURING THE CONSTRUCTION PERIOD WITHOUT WRITTEN PERMISSION FROM THE OWNER.
- PROVIDE INSTRUCTIONS TO OWNER ON ALL SYSTEMS AND ASSOCIATED EQUIPMENT.
- TESTING OF ALL SAFETY DEVICES SHALL BE CARRIED OUT BY THE MECHANICAL CONTRACTOR AND WITNESSED BY THE OWNER'S REPRESENTATIVE, SIGNED OFF AND FORWARDED TO THE O/M MANUAL.
- MEET SAFETY REQUIREMENTS OF PROVINCIAL DEPARTMENT OF LABOUR AND LOCAL AUTHORITIES HAVING JURISDICTION.
- A WRITTEN GUARANTEE COVERING ALL MATERIALS AND WORKMANSHIP FOR ONE (1) YEAR FROM DATE OF FINAL ACCEPTANCE OF THE ENTIRE CONTRACT, SHALL BE SUPPLIED BY THE CONTRACTOR, THIS GUARANTEE WILL NOT CANCEL LONGER WARRANTIES.
- UPON COMPLETION OF THE WORK, THE ENTIRE JOB SITE SHALL BE CLEARED UP AND LEFT IN GOOD OPERATING CONDITION, THOROUGHLY CLEAN PIPING, DUCTWORK, AND EQUIPMENT OF DIRT, CUTTINGS AND OTHER FOREIGN SUBSTANCES.
- ALL CUTTING AND PATCHING AND RELATED CONSTRUCTION WORK ARE TO BE PERFORMED BY THE GENERAL CONTRACTOR UPON INSTRUCTION FROM THE MECHANICAL CONTRACTOR.
- ALL GALVANIZED DUCTWORK IS TO BE MANUFACTURED IN ACCORDANCE WITH CURRENT S.M.A.C.N.A. SPECIFICATIONS. ALL DUCTWORK IS TO BE SEALED WITH HIGH VELOCITY BRUSHED
- ALL GALVANIZED DUCTWORK IS TO BE MANUFACTURED IN ACCORDANCE WITH CURRENT S.M.A.C.N.A. SPECIFICATIONS. ALL DUCTWORK IS TO BE SEALED WITH HIGH VELOCITY BRUSHED
- PERMITS: CONTRACTOR IS RESPONSIBLE FOR GIVING ALL NECESSARY NOTICES, OBTAINING ALL NECESSARY PERMITS AND PAYING ALL APPLICABLE FEES.
- ASSUME FULL RESPONSIBILITY FOR LAYING OUT ALL WORK AND ENSURE THAT NO DAMAGE IS CAUSED TO THE OWNERS EQUIPMENT AND PREMISES. PROTECT AND MAINTAIN ALL WORK UNTIL WORK HAS BEEN COMPLETED AND ACCEPTED BY THE OWNER AND ENGINEER.
- ALL WIRING AND THE SUPPLY AND INSTALLATION OF STARTERS AND/OR DISCONNECT SWITCHES FOR EQUIPMENT SHALL BE BY THE ELECTRICAL CONTRACTOR (DIV 16)
- SUPPLY AND INSTALL ULC FIRE DAMPERS/FIRE STOPS AT ALL FIRE RATED PENETRATIONS.
- ACCESS DOORS REQUIRED TO GAIN ACCESS TO BALANCING DAMPERS AT FIRE-RATED CEILING - SUPPLIED AND INSTALLED BY GENERAL CONTRACTOR.
- BALANCING CONTRACTOR WILL ENGAGE AN INDEPENDENT AIR BALANCING AGENCY.
- SYSTEM TO BE ADJUSTED TO DATA PROVIDED.
- BALANCING CONTRACTOR TO CONFIRM OPERATION OF COMPLETE MECHANICAL SYSTEM
- PROVIDE REPORT TO ENGINEER. (4 COPIES)

INSPECTION AND TESTING

- 1. THE WORK SHALL BE AT ALL TIMES AVAILABLE FOR INSPECTION BY AN OWNER REPRESENTATIVE. ALL WORK SHALL BE IN ACCORDANCE WITH AND SHALL BE INSPECTED TO MEET THE REQUIREMENTS OF THIS SPECIFICATION.
- 2. ALL START-UP AND TESTING SHALL BE PERFORMED IN THE PRESENCE OF THE OWNER. NOTICE

OF DATE WHEN TESTS SHALL BE PERFORMED MUST BE RECEIVED BY OWNER

- 3. WORK SHALL NOT BE INSULATED OR CONCEALED PRIOR TO BEING TESTED AND APPROVED.
- 4. OPERATE SYSTEM FOR A SUFFICIENT PERIOD OF TIME TO ENSURE COMPLETE ACCEPTANCE; DEFECTS SHALL BE REMEDIED AT CONTRACTOR'S EXPENSE.
- 5. AIR BALANCING SHALL BE PERFORMED BY AN INDEPENDENT CERTIFIED AIR BALANCING CONTRACTOR AND THE BALANCING REPORT SUBMITTED TO THE ENGINEER. COST FOR THIS WORK IS TO BE CARRIED BY THE MECHANICAL CONTRACTOR.

- 1. PROVIDE 1/2"(12mm) THICK, FOIL-FACED RIGID PRE-FORMED FIBREGLASS EXTERNAL THERMAL PIPE INSULATION ON ALL NEW NATURAL GAS PIPING FOR 10'(3000mm)ON THE WARM SIDE OF A PENETRATION THROUGH A WALL OR CEILING/ROOF TO A COLD SPACE.
- 2. PROVIDE 2"(50mm) THICK, FOIL-FACED RIGID(FIBREGLASS OR FIBREBOARD) OR FLEXIBLE FIBREGLASS EXTERNAL THERMAL INSULATION ON ALL NEW EXHAUST OR RELIEF DUCTWORK FOR 10'-0"(3.0M) ON THE WARM SIDE OF A PENETRATION THROUGH A WALL/FLOOR/CEILING/ROOF TO A COLD SPACE, WHERE A BACKDRAFT DAMPER IS PROVIDED AT THE PENETRATION TO THE COLD SPACE WHERE THE BACKDRAFT DAMPER IS PROVIDED IN THE DUCTWORK, INSULATION SHALL EXTEND FROM THE PENETRATION TO 10'-0" (3.0M) UPSTREAM OF THE BACK DRAFT
- 3. PROVIDE 1"(25mm) THICK, FOIL-FACED EXTERNAL THERMAL INSULATION ON ALL NEW SUPPLY AIR DUCT MAINS, EXCLUDING INDIVIDUAL RUN-OUTS TO DIFFUSERS. INSULATION SHALL BE FLEXIBLE FIBREGLASS, OR RIGID FIBREBOARD.
- 4. PROVED 2"(50mm) THICK, FOIL-FACED RIGID FIBREGLASS OR FIBREBOARD EXTERNAL THERMAL INSULATION ON ALL NEW OUTSIDE AIR INTAKE, MIXED AIR AND COMBUSTION AIR DUCTWORK, ROUND COMBUSTION AIR DUCTWORK MAY BE FLEXIBLE FIBREGLASS.
- 5. PROVIDE 3"(75mm) THICK, FOIL-FACED RIGID FIBREGLASS OR FIBREBOARD EXTERNAL THERMAL INSULATION ON ALL NEW DUCTWORK LOCATED OUTDOORS, PROVIDE WEATHERPROOFING
- .1 PROVIDE DIMPLE FINISH .016 ALUMINUM JACKET OR GALVANIZED SHEET.
- 6. PROVIDE 1"(25mm) THICK, BLACK CELLULAR FOAM RUBBER INSULATION ON ALL REFRIGERATION PIPING, INSTALL USING PLASTIC WIRE TIES.
- 7. ALL JOINTS AND ELBOWS SHALL BE COMPLETELY INSULATED EXCEPT JOINTS AND ELBOWS MAY BE LEFT UNCOVERED ON HOT PIPING IN CONCEALED SPACES.
- 8. ALL VALVES AND UNIONS SHALL BE COMPLETELY INSULATED, EXCEPT VALVES AND UNIONS MAY BE LEFT UNCOVERED ON HOT PIPING IN CONCEALED SPACES.
- 9. SEAMS OF FOIL-FACED THERMAL INSULATION SHALL BE SEALED WITH ALUMINUM DUCT TAPE.
- COVER BUTT JOINTS WITH A STRIP OF THE SAME MATERIAL AS THE JACKET.
- FLEXIBLE INSULATION SHALL BE INSTALLED IN A MANNER THAT DOES NOT REDUCE ITS THICKNESS.

- 1. ALL DUCT DIMENSIONS DENOTE INTERNAL "FREE" AREA OF THE DUCT.
- 2. SHEET METAL DUCTWORK, HANGERS, FITTINGS, AND COMPONENTS SHALL BE CONSTRUCTED AND INSTALLED IN ACCORDANCE WITH "SMACNA" HVAC DUCT CONSTRUCTION STANDARDS LATEST EDITION AND "ASHRAE" EQUIPMENT GUIDE.
- 3. ALL DUCTWORK SHALL BE INSTALLED ACCORDING TO SMACNA STATIC PRESSURE CLASS + 500
- 4. ALL 90 DEGREE SQUARE TURN ELBOWS (WHICH HAVE NO CHANGE IN DIMENSIONS THROUGH TURN) SHALL HAVE DOUBLE THICKNESS TURNING VANES.
- 5, ROUND DUCT ELBOWS SHALL HAVE A RADIUS DIMENSION 1.5 TIMES THE WIDTH OF THE DUCT (IN THE PLANE OF THE TURN) TO THE CENTERLINE OF THE DUCT.
- 6. ALL EXHAUST AIR DUCTWORK SHALL BE INSULATED WITH 2" THICK FOIL FACED FIBERGLASS DUCT INSULATION FROM THE EXTERIOR WALL OR ROOF SURFACE TO A DISTANCE OF 6'-0" (MIN.) INTO THE BUILDING SPACE, EXCEPT AS INDICATED.
- 7. MECHANICAL CONTRACTOR SHALL INSTALL 4" (MIN.) FLEXIBLE CONNECTORS ON INLET AND DISCHARGE DUCTWORK OF EQUIPMENT.
- 8. ALL SUPPLY AIR DUCTWORK SHALL BE INTERIOR INSULATED WITH 1" ACOUSTIC INSULATION FOR THE FIRST 10' FROM THE FAN DISCHARGE, UNLESS INDICATED OTHERWISE. PROVIDE INTERIOR ACOUSTIC INSULATION FOR RETURN AIR DUCT FROM RETURN AIR GRILLE TO MIXING BOX.
- 9. PROVIDE BALANCING DAMPERS AS SHOWN AND AS REQUIRED TO ALLOW PROPER BALANCING OF THE SYSTEM. BALANCING DAMPERS SHALL BE PROVIDED FOR EACH SUPPLY AIR OUTLET AND RETURN/EXHAUST AIR INLET. DAMPERS MOUNTED AT GRILLES SHALL BE MULTI-BLADE TYPE. BUTTERFLY DAMPERS IN DUCTWORK SHALL BE CONSTRUCTED OF SHEET METAL TWO GAUGES HEAVIER THAHN THE DUCTWORK. DUCT DAMPERS SHALL HAVE LOCKING QUADRANTS
- SEAL JOINTS BETWEEN DUCTS, FITTINGS, ETC., WITH DURO-DYNE S-2 DUCT SEALER AND DURO-DYNE FIBERGLASS DUCT TAPE. APPLY IN ACCORDANCE WITH MANUFACTURER'S

MANUFACTURED BY UNITED, 90 DEGREE ELBOWS TO BE 5 PIECE MITRED, 8" DIA. OR LESS, 90 DEGREE ELBOWS CAN BE 1 PIECE MOLDED TYPE. USE CONICAL CONNECTIONS THROUGHOUT

ULC LISTED BLADE POCKETS OUT OF AIR STREAM, "FIRE BARRIER" OR EQUAL. CEILING FIRE DAMPERS SHALL BE 'CONTROLLED AIR' MODEL CFSR-1 c/w CK2000 THERMAL BLANKET, ULC

ACCESS DOORS

PROVIDE ACCESS DOORS AS REQUIRED TO ACCESS AND MAINTAIN ALL VENTILATION EQUIPMENT, INCLUDING COILS, MOTORIZED DAMPERS, AND FIRE DAMPERS.

REFRIGERANT PIPING TO BE INSULATED WITH 1/4" FLEXIBLE PIPE INSULATION AND WEATHER COATING WHERE REQUIRED.

- ALL PENETRATIONS IN FIRE RATED SURFACES ARE TO BE SEALED WITH ELECTROVERT CLK CAULKING MATERIAL OR APPROVED EQUAL.
- SUPPLY 4 SPARE FUSES AND LAMPS FOR ALL CONTROL PANELS.
- SUPPLY LAMACOID NAME TAGS FOR ALL AIR HANDLING EQUIPMENT, THERMOSTATS, MOTORIZED DAMPERS AND PUMPS.
- SUBMIT FOR ENGINEERS APPROVAL SHOP DRAWINGS OF ALL EQUIPMENT.
- SUPPLY O&M MANUALS FOR EQUIPMENT SUPPLIED AND INSTALLED.
- COMPLETE TRAINING TO BE SUPPLIED ON ALL THE EQUIPMENT SUPPLIED AND INSTALLED.

EQUIPMENT LIST

FURNACE

SUPREME ELECTRIC FURNACE, 1900 CFM @ .20 ESP IN.WC. 23 KW, 240V/I PH/60 HZ, BLOWER 1HP, 107AMP.

HEAT RECOVERY UNIT

VENMAR CONSTRUCTO 2.0. 189 @ 0.4" ESP WG, C/W CONTROL AIR 15 CONTROLLER. TWO 6" WEATHER HOODS C/W 1/4" MESH SCREEN C/W 3KW ELECTRIC COIL ON THE OA AIR INTAKE COIL COMPLETE SCR, SAIL SWITCH AND DUCT THERMOSTAT.

RANGE HOOD

BROAN BP124BLN, 180 CFM @ 7.5 SONE C/W 7" GALVANIZED OR ALUMINUM EXHAUST TO BROAN 634 ROOF CAP.

47KBTUH (13.8KW) BUILDING HEAT LOSS: VENTILATION HEAT: 18.8KBTUH (5.5KW)

OUTSIDE AIR REQUIREMENTS AS PER ASHRAE STANDARD 62.1-2010 VENTILATION ACCEPTABLE AIR QUALITY

AREA PEOPLE 2800 SQ.FT. @ 0.06 CFM/SQ.FT. 4 @ 5 CFM/PERSON

168 CFM 20 CFM 188 CFM THIS DRAWING MUST NOT BE SCALED

THE GENERAL CONTRACTOR SHALL VERIEY ALL DIMENSIONS, DATUMS AND LEVELS PRIOR TO COMPARICEMENT OF WORK AND IS HELD RESPONSIBLE FOR REPORTING ANY DISCREPANCY OR OMISSION TO CAN-TEC

THIS DRAWING IS THE EXCLUSIVE PROPERTY OF CAN-TEC SERVICES LTD. AND CAN BE REPRODUCED ONLY WITH THE PERMISSION OF CAN-TEC SERVICES LTD. IN WHICH CASE THE REPRODUCTION MUST BEAR THEIR NAIVE AS THE



FALCON


ISSUED FOR CONSTRUCTION

17-037-01-11


CMP-FALCON LAKE HOUSE

SPECIFICATION

REVISION NO.

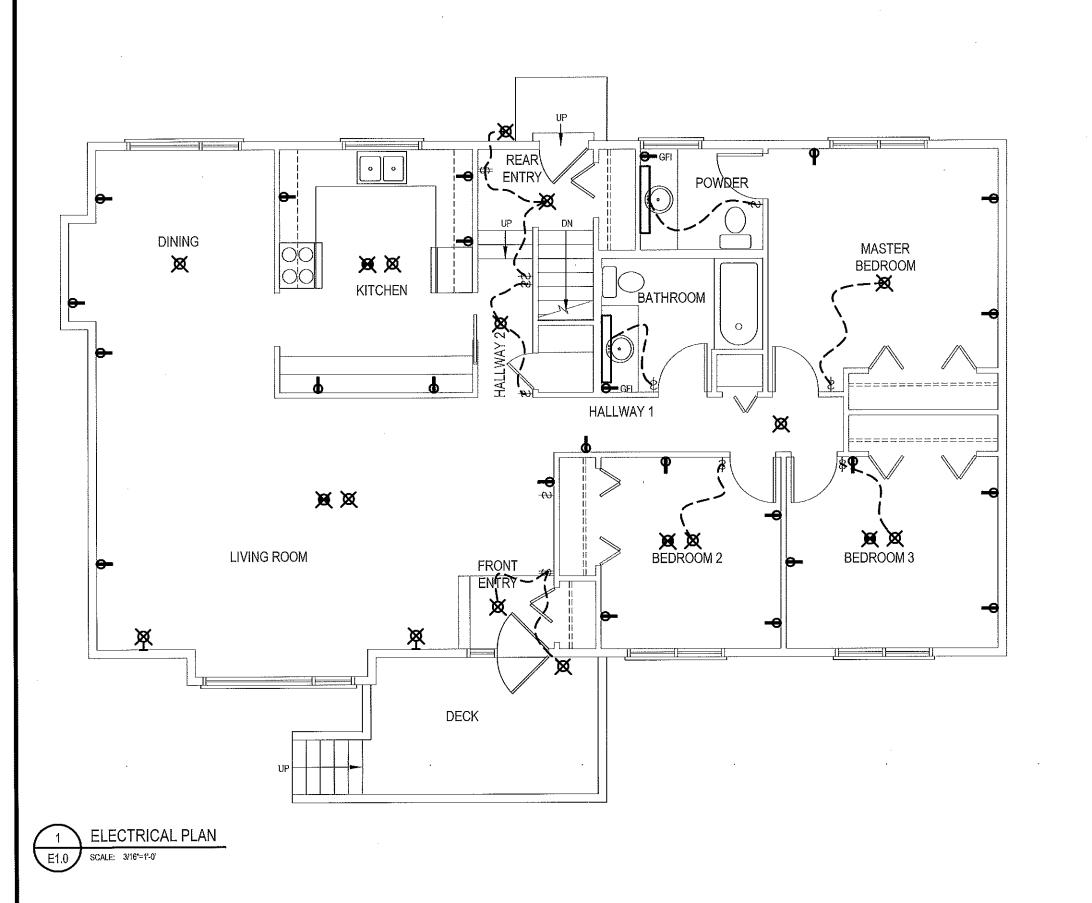

ELECTRICAL LEGEND:

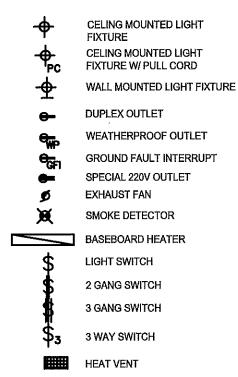




RCMP-FALCON LAKE HOUSE


ELECTRICAL PLAN

17 FALCON BV, FALCON LAKE, _{рате} 17-07-11

REVISION NO. ISSUED FOR CONSTRUCTION

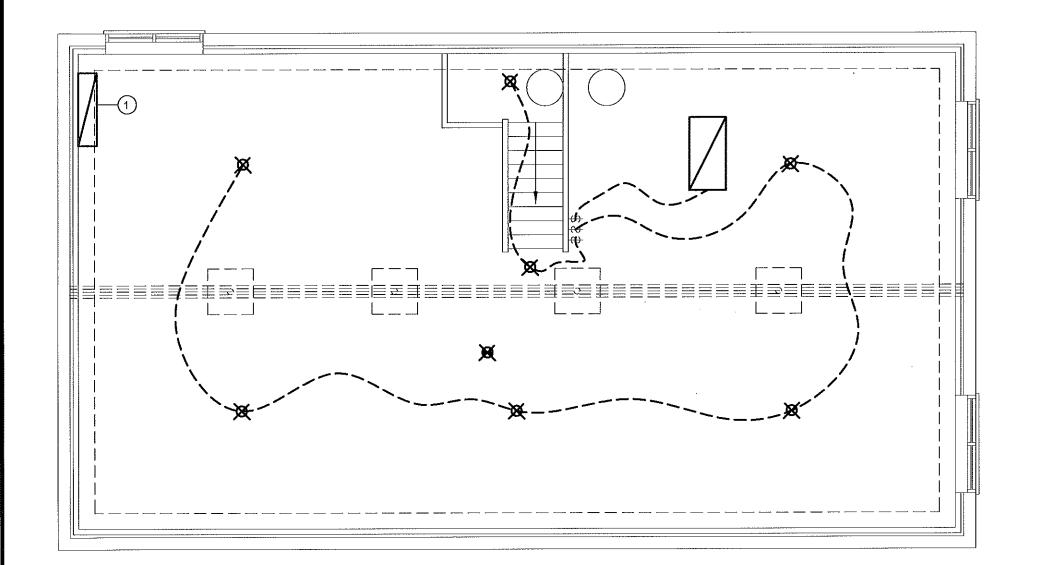


ELECTRICAL LEGEND:

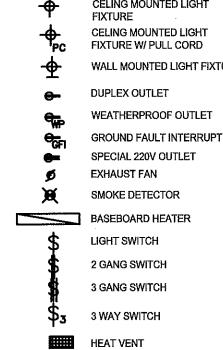

DRAWING NOTES: (#)

- ELECTRICAL CODE LATEST EDITION

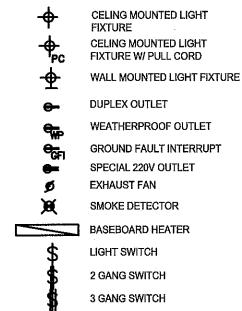

INSTALL NEW SERVICE 200A. (REMOVE & REPLACE)
 EXISTING SERVICE AND PANEL
 ALL ELECTRICAL WORK TO BE DONE AS PER CANADIAN



RCMP-FALCON LAKE HOUSE

17 FALCON BV, FALCON LAKE, ELECTRICAL DATE 17-07-11

REVISION NO. ISSUED FOR CONSTRUCTION

