



NOTES:
1. SEE NOTE 6.

1 METERING STATION ELECTRICAL LAYOUT
SCALE: N.T.S.

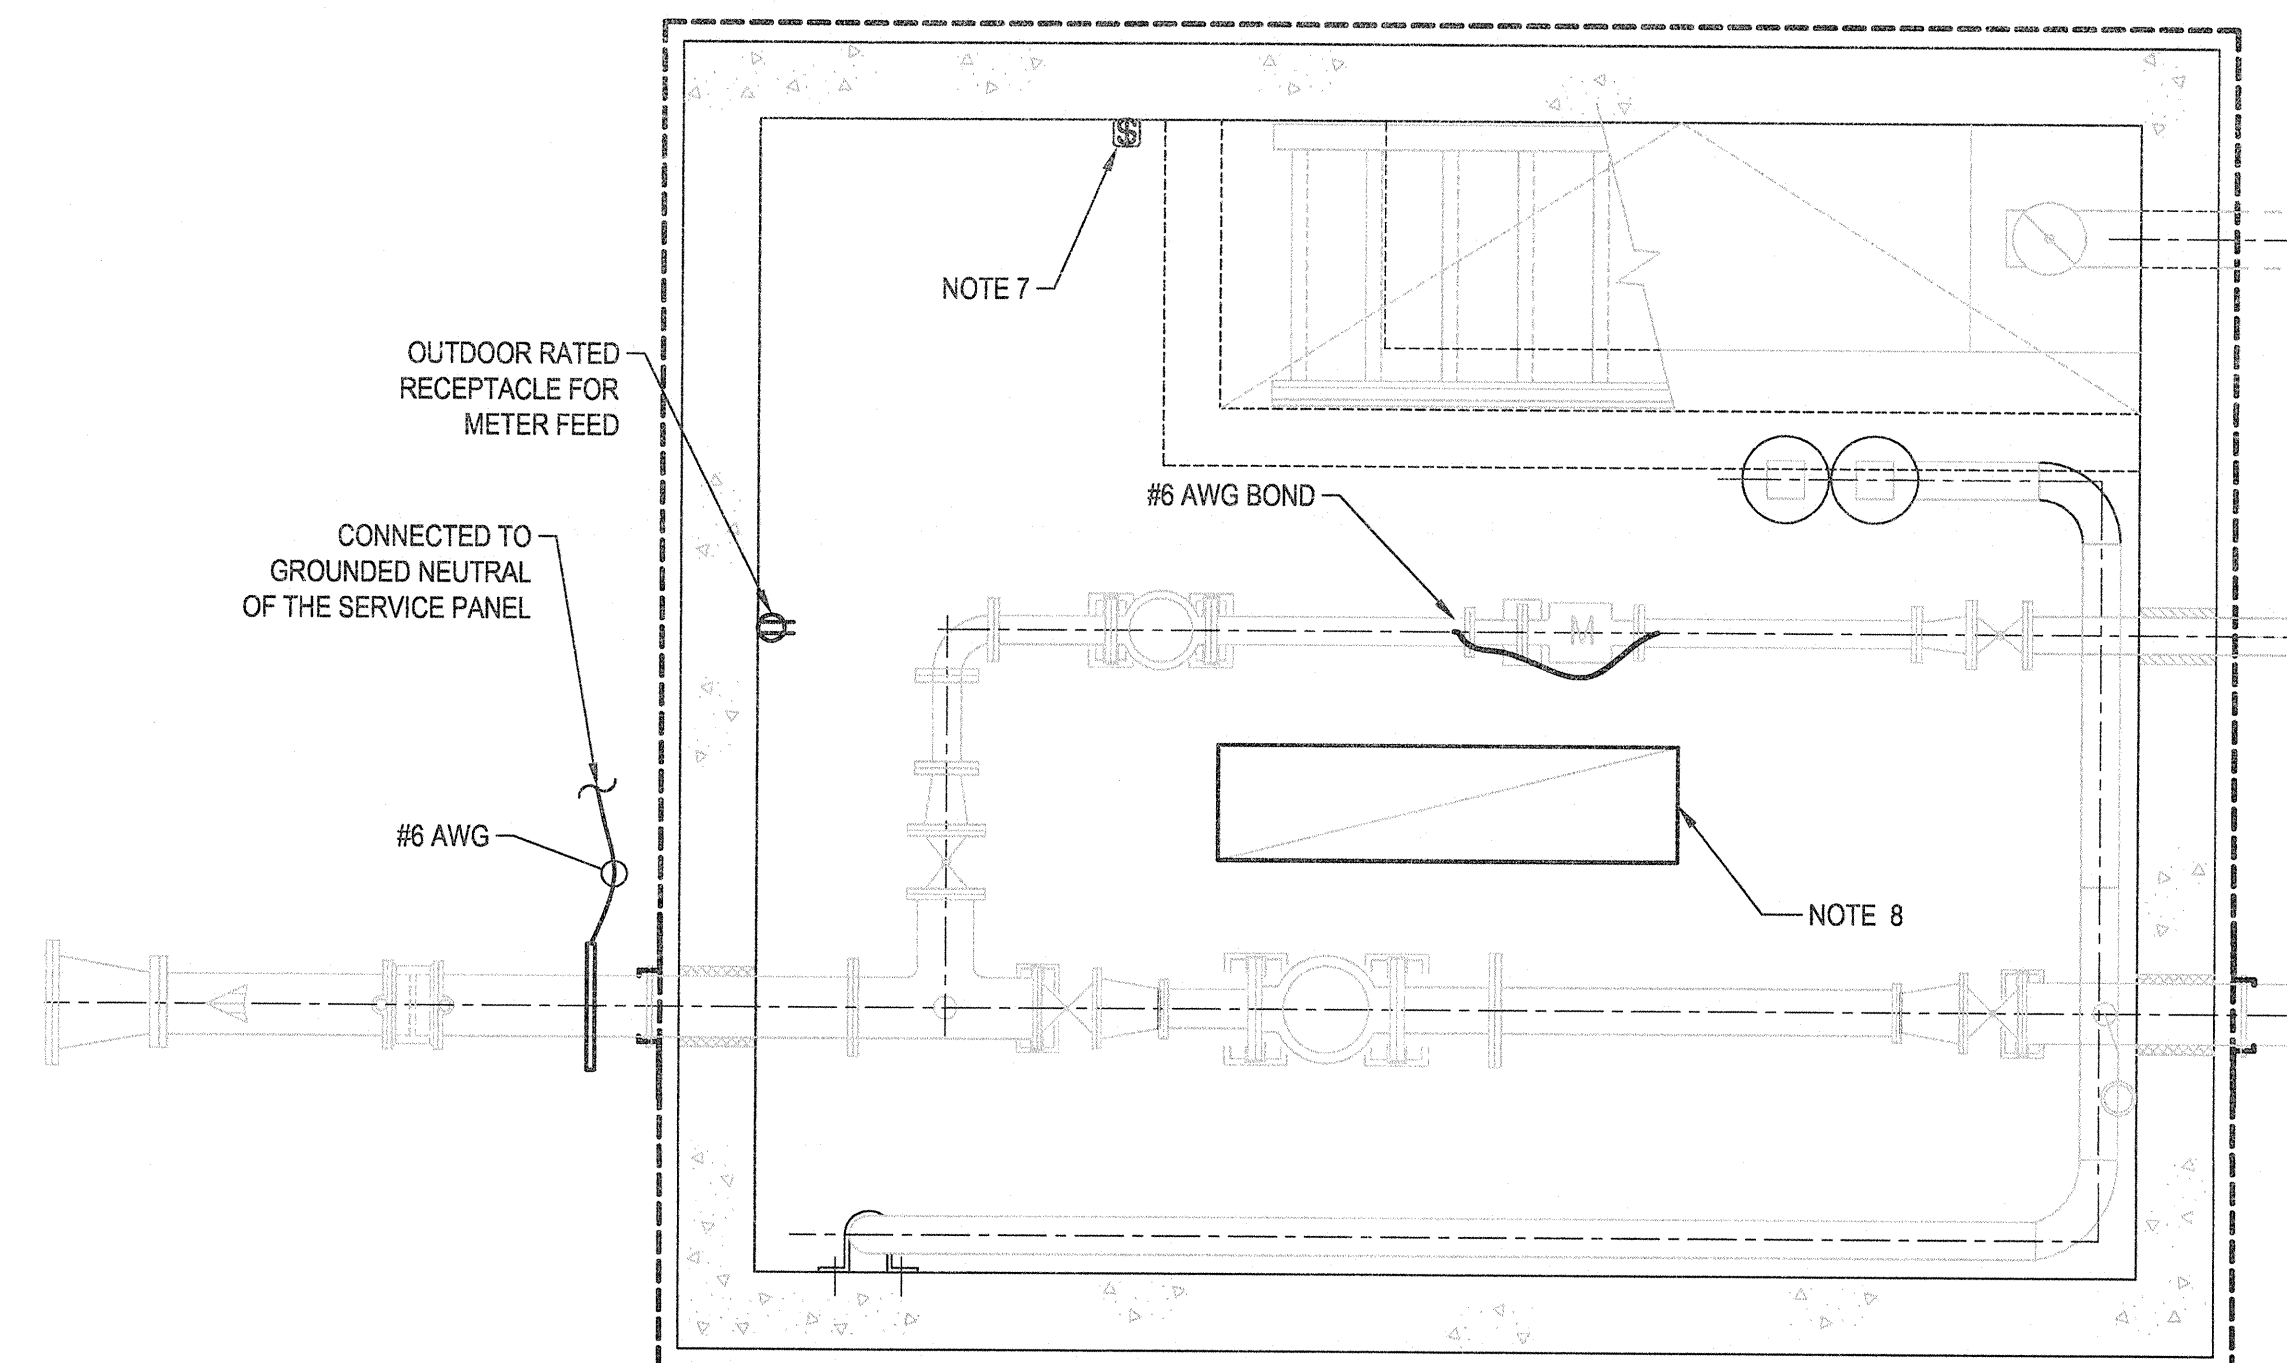


NOTES:
1. SEE NOTE 6.


2 METERING STATION ELECTRICAL LAYOUT
SCALE: N.T.S.

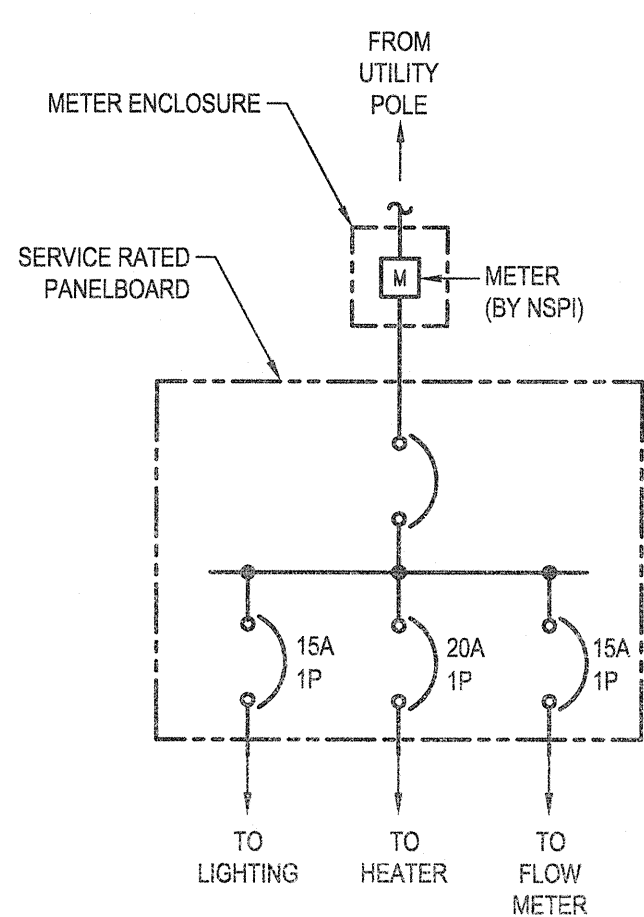


3 SINGLE LINE DIAGRAM
SCALE: N.T.S.

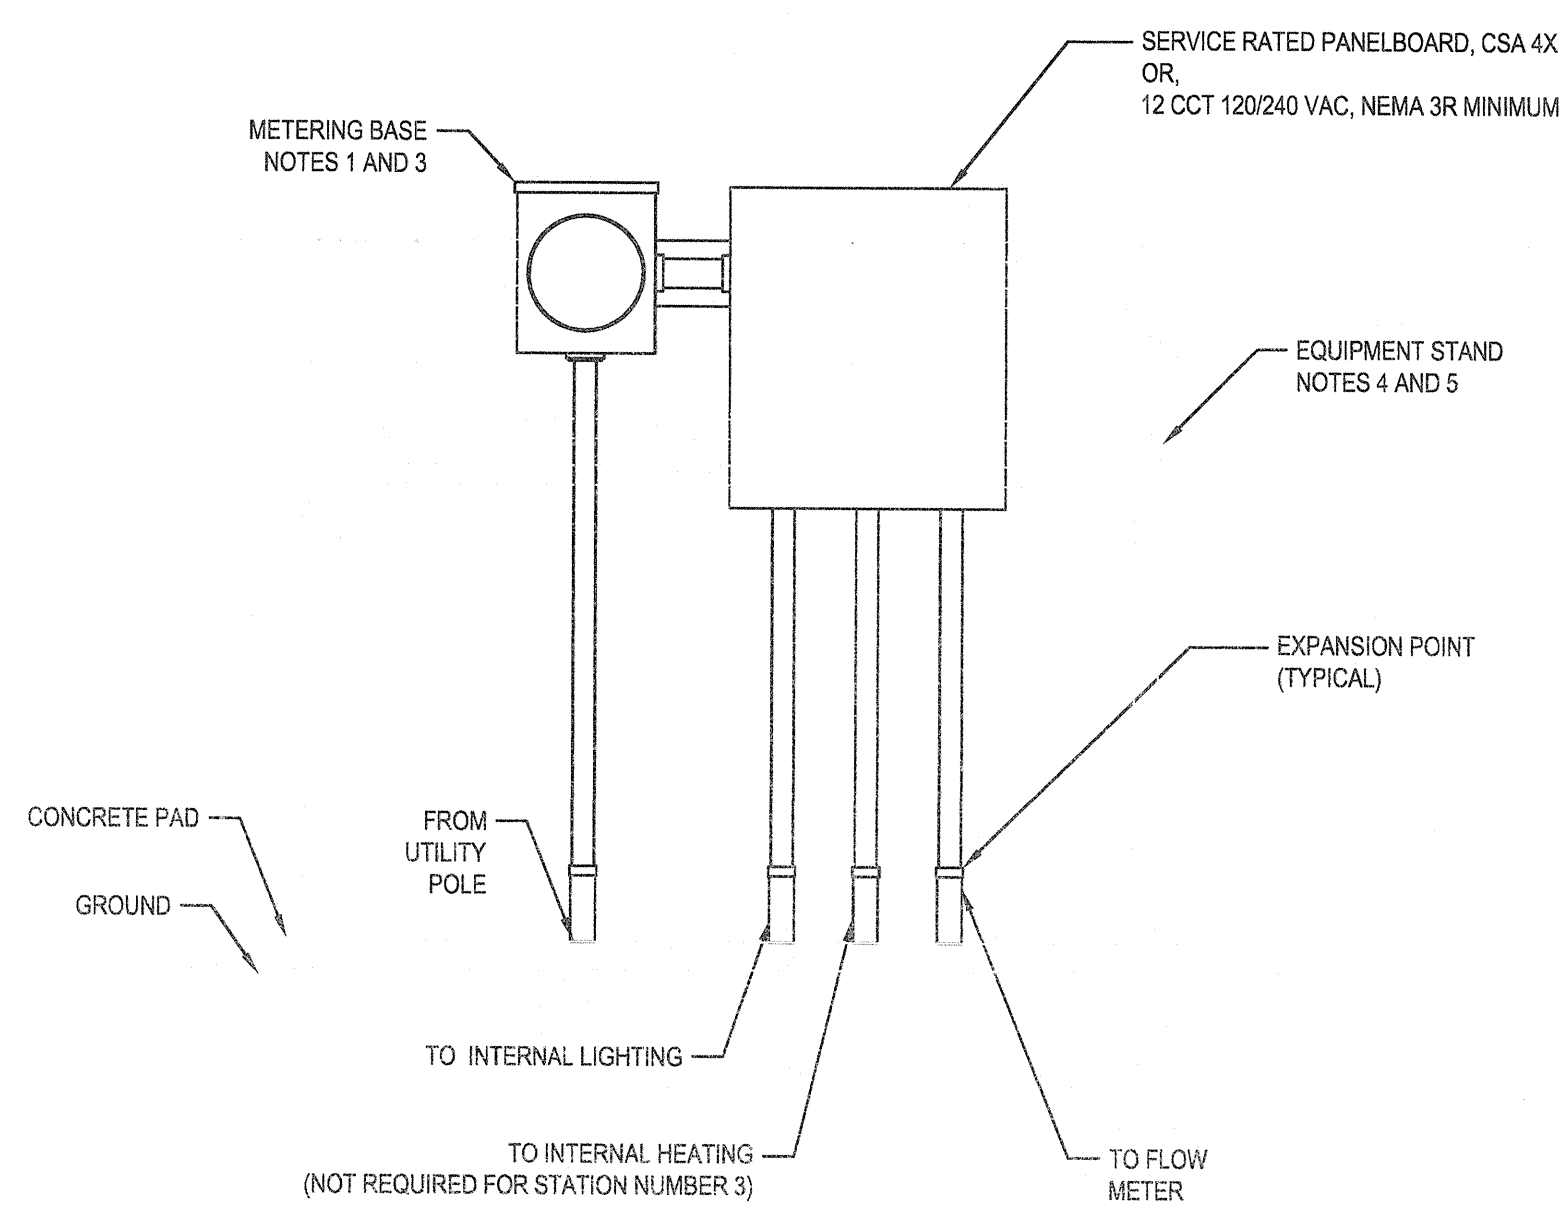


4 ELECTRICAL METER DETAILS
SCALE: N.T.S.

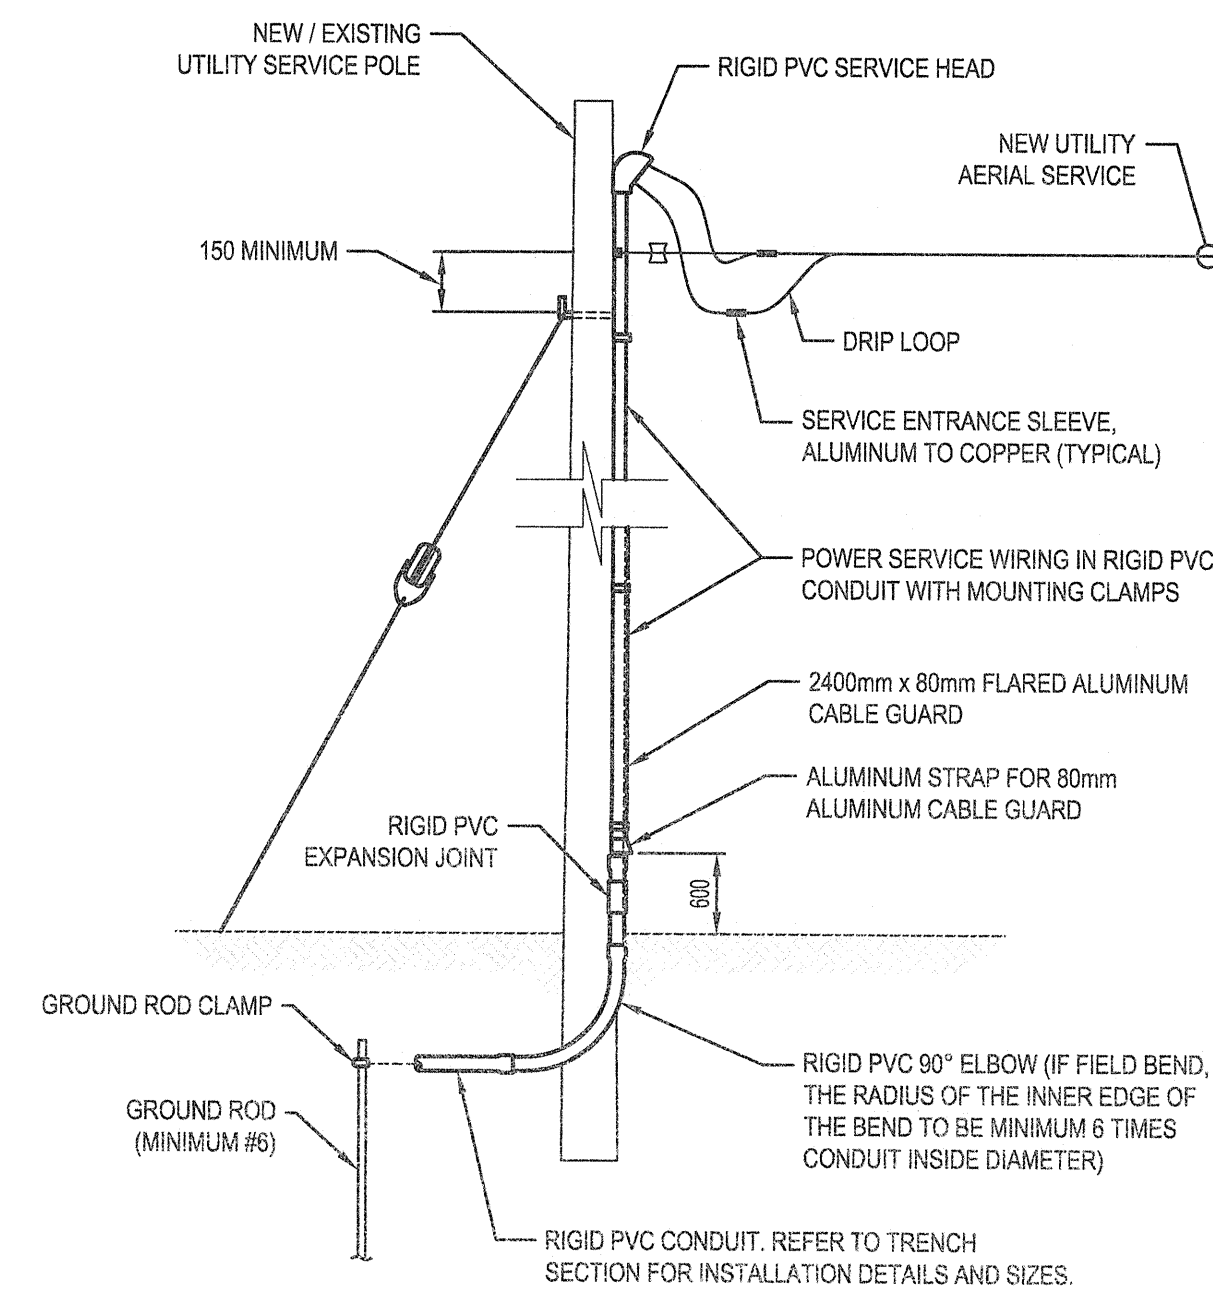

5 UTILITY SERVICE POLE
SCALE: N.T.S.

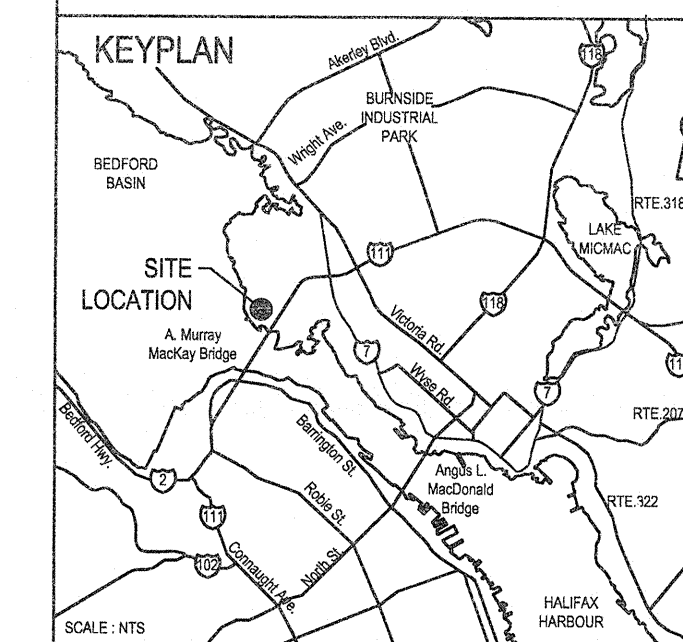

- NOTES:
- COORDINATE WITH NSPI FOR NEW UTILITY METER.
 - ELECTRIC HEAT DESIGN TO MAINTAIN 10 °C.
 - METERING BASE 100A, 4 JAWS, 10, 3W, MINIMUM 3R.
 - EQUIPMENT STAND TO BE FENCED IN.
 - EQUIPMENT STAND AND CONCRETE PAD PROVIDED BY OTHERS.
 - LIGHTING, HEATING (WHERE REQUIRED), AND RECEPTACLE FINISHED BY HOT-BOX MANUFACTURER.
 - PROVIDE OUTDOOR RATED LIGHT SWITCH.
 - PROVIDE OUTDOOR RATED FIXTURE LED, 120VAC, TO MAINTAIN 50 LUX MINIMUM.

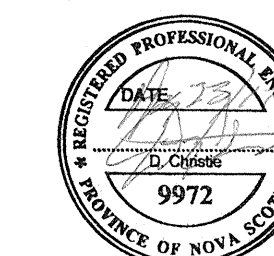

C02	ISSUED FOR TENDER	AUG 23 2017
revisions		date
project	BEDFORD INSTITUTE OF OCEANOGRAPHY DARTMOUTH, NS	
drawing	SECOND ACCESS ROAD	

**METERING STATION LAYOUT
SINGLE LINE DIAGRAM,
POLE AND INSTALLATION
DETAILS**

designed	D.C.	conçu
date		
drawn	D.S.	dessiné
date		
approved	M.E.	approuvé
date		
Tender		Soumission
PWGSC Project Manager		Administrateur de projets TPSCG
project number		no. du projet
	R.073592.001	
drawing no.		no. du dessin
	E4	