



LEGEND:

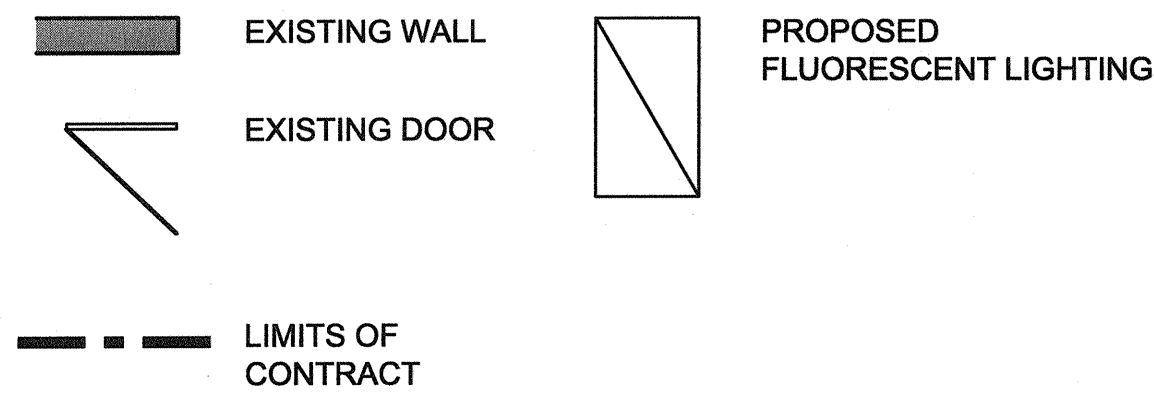

SHEET NOTES:

- NEW 610 x 610mm [2' x 2'] FLAT CEILING SUPRAFINE GRID AND TILES.
- EXTEND EXISTING BULKHEAD TO MEET LENGTH OF NEW MILLWORK. TO BE MADE GOOD, PATCHED AND PAINTED NEW COLOUR TO BE DETERMINED BY DEPARTMENTAL REPRESENTATIVE.
- NEW LIGHTING TO CO-ORDINATE WITH CEILING GRID, SEE ELECTRICAL.
- REINSTATE EXISTING CEILING SYSTEM. REPLACE ALL DAMAGED ACOUSTIC TILES WITH NEW TO MATCH EXISTING. SEE MECHANICAL DRAWINGS FOR AREA OF WORK.
- EXISTING SPRINKLER HEADS TO REMAIN, TO BE SUPPORTED AND PROTECTED DURING WORK.
- EXISTING SPEAKER TO REMAIN. ADJUST LOCATION OF SPEAKER TO FIT INTO NEW GRID LAYOUT, TO BE SUPPORTED AND PROTECTED DURING WORK.
- EXISTING ELECTRICAL DEVICE TO REMAIN. ADJUST LOCATION OF ELECTRICAL DEVICE TO FIT INTO NEW GRID LAYOUT, TO BE SUPPORTED AND PROTECTED DURING WORK, SEE ELECTRICAL.
- LOCATION OF EXISTING LIGHTING.
- ORIGINAL LOCATION OF EXISTING SPEAKER.
- ORIGINAL LOCATION OF EXISTING ELECTRICAL DEVICE.
- PROPOSED 200mm DIAMETER OPENING TO ROOF, SEE DETAIL 1/A-2.5. COORDINATE WITH MECHANICAL AND ELECTRICAL FOR LOCATION AND DIAMETER. MAINTAIN EXISTING FIRE RESISTANCE AND SOUND TRANSMISSION RATING OF FLOOR ASSEMBLY.
- EXISTING OPENING TO ROOF, APPROXIMATE DIAMETER 200mm CONTRACTOR TO VERIFY DIMENSION.
- PROPOSED PENETRATION TO ABOVE FOR POWER AND CONTROLS WIRING. COORDINATE WITH MECHANICAL AND ELECTRICAL FOR LOCATION AND DIAMETER. ALL FIRE RESISTANCE AND SOUND TRANSMISSION RATINGS TO BE MAINTAINED.
- APPROXIMATE LOCATION OF PROPOSED ROOF TOP UNIT, AC-1. CO-ORDINATE WITH MECHANICAL.
- EXISTING SPEAKER TO BE TEMPORARILY SUPPORTED AND PROTECTED DURING WORK, RE-INSTATE ONCE CEILING IS REPLACED.
- APPROXIMATE LOCATION OF EXISTING SPRINKLER TO BE TEMPORARILY SUPPORTED AND PROTECTED DURING WORK, RE-INSTATE ONCE CEILING IS REPLACED, SEE MECHANICAL.
- EXISTING LIGHTING TO BE TEMPORARILY SUPPORTED AND PROTECTED DURING WORK. METAL INFILL PANELS TO BE CAREFULLY REMOVED AND SAFELY STORED DURING CONSTRUCTION. RE-INSTATE LIGHTING AND INFILL PANELS ONCE CEILING IS REPLACED, SEE ELECTRICAL.
- EXISTING MOTION DETECTOR TO BE TEMPORARILY SUPPORTED AND PROTECTED DURING WORK. RE-INSTATE ONCE CEILING IS REPLACED.
- PROPOSED SUPPLY AIR DIFFUSERS, SEE MECHANICAL.
- PROPOSED RETURN AIR GRILLE, SEE MECHANICAL.

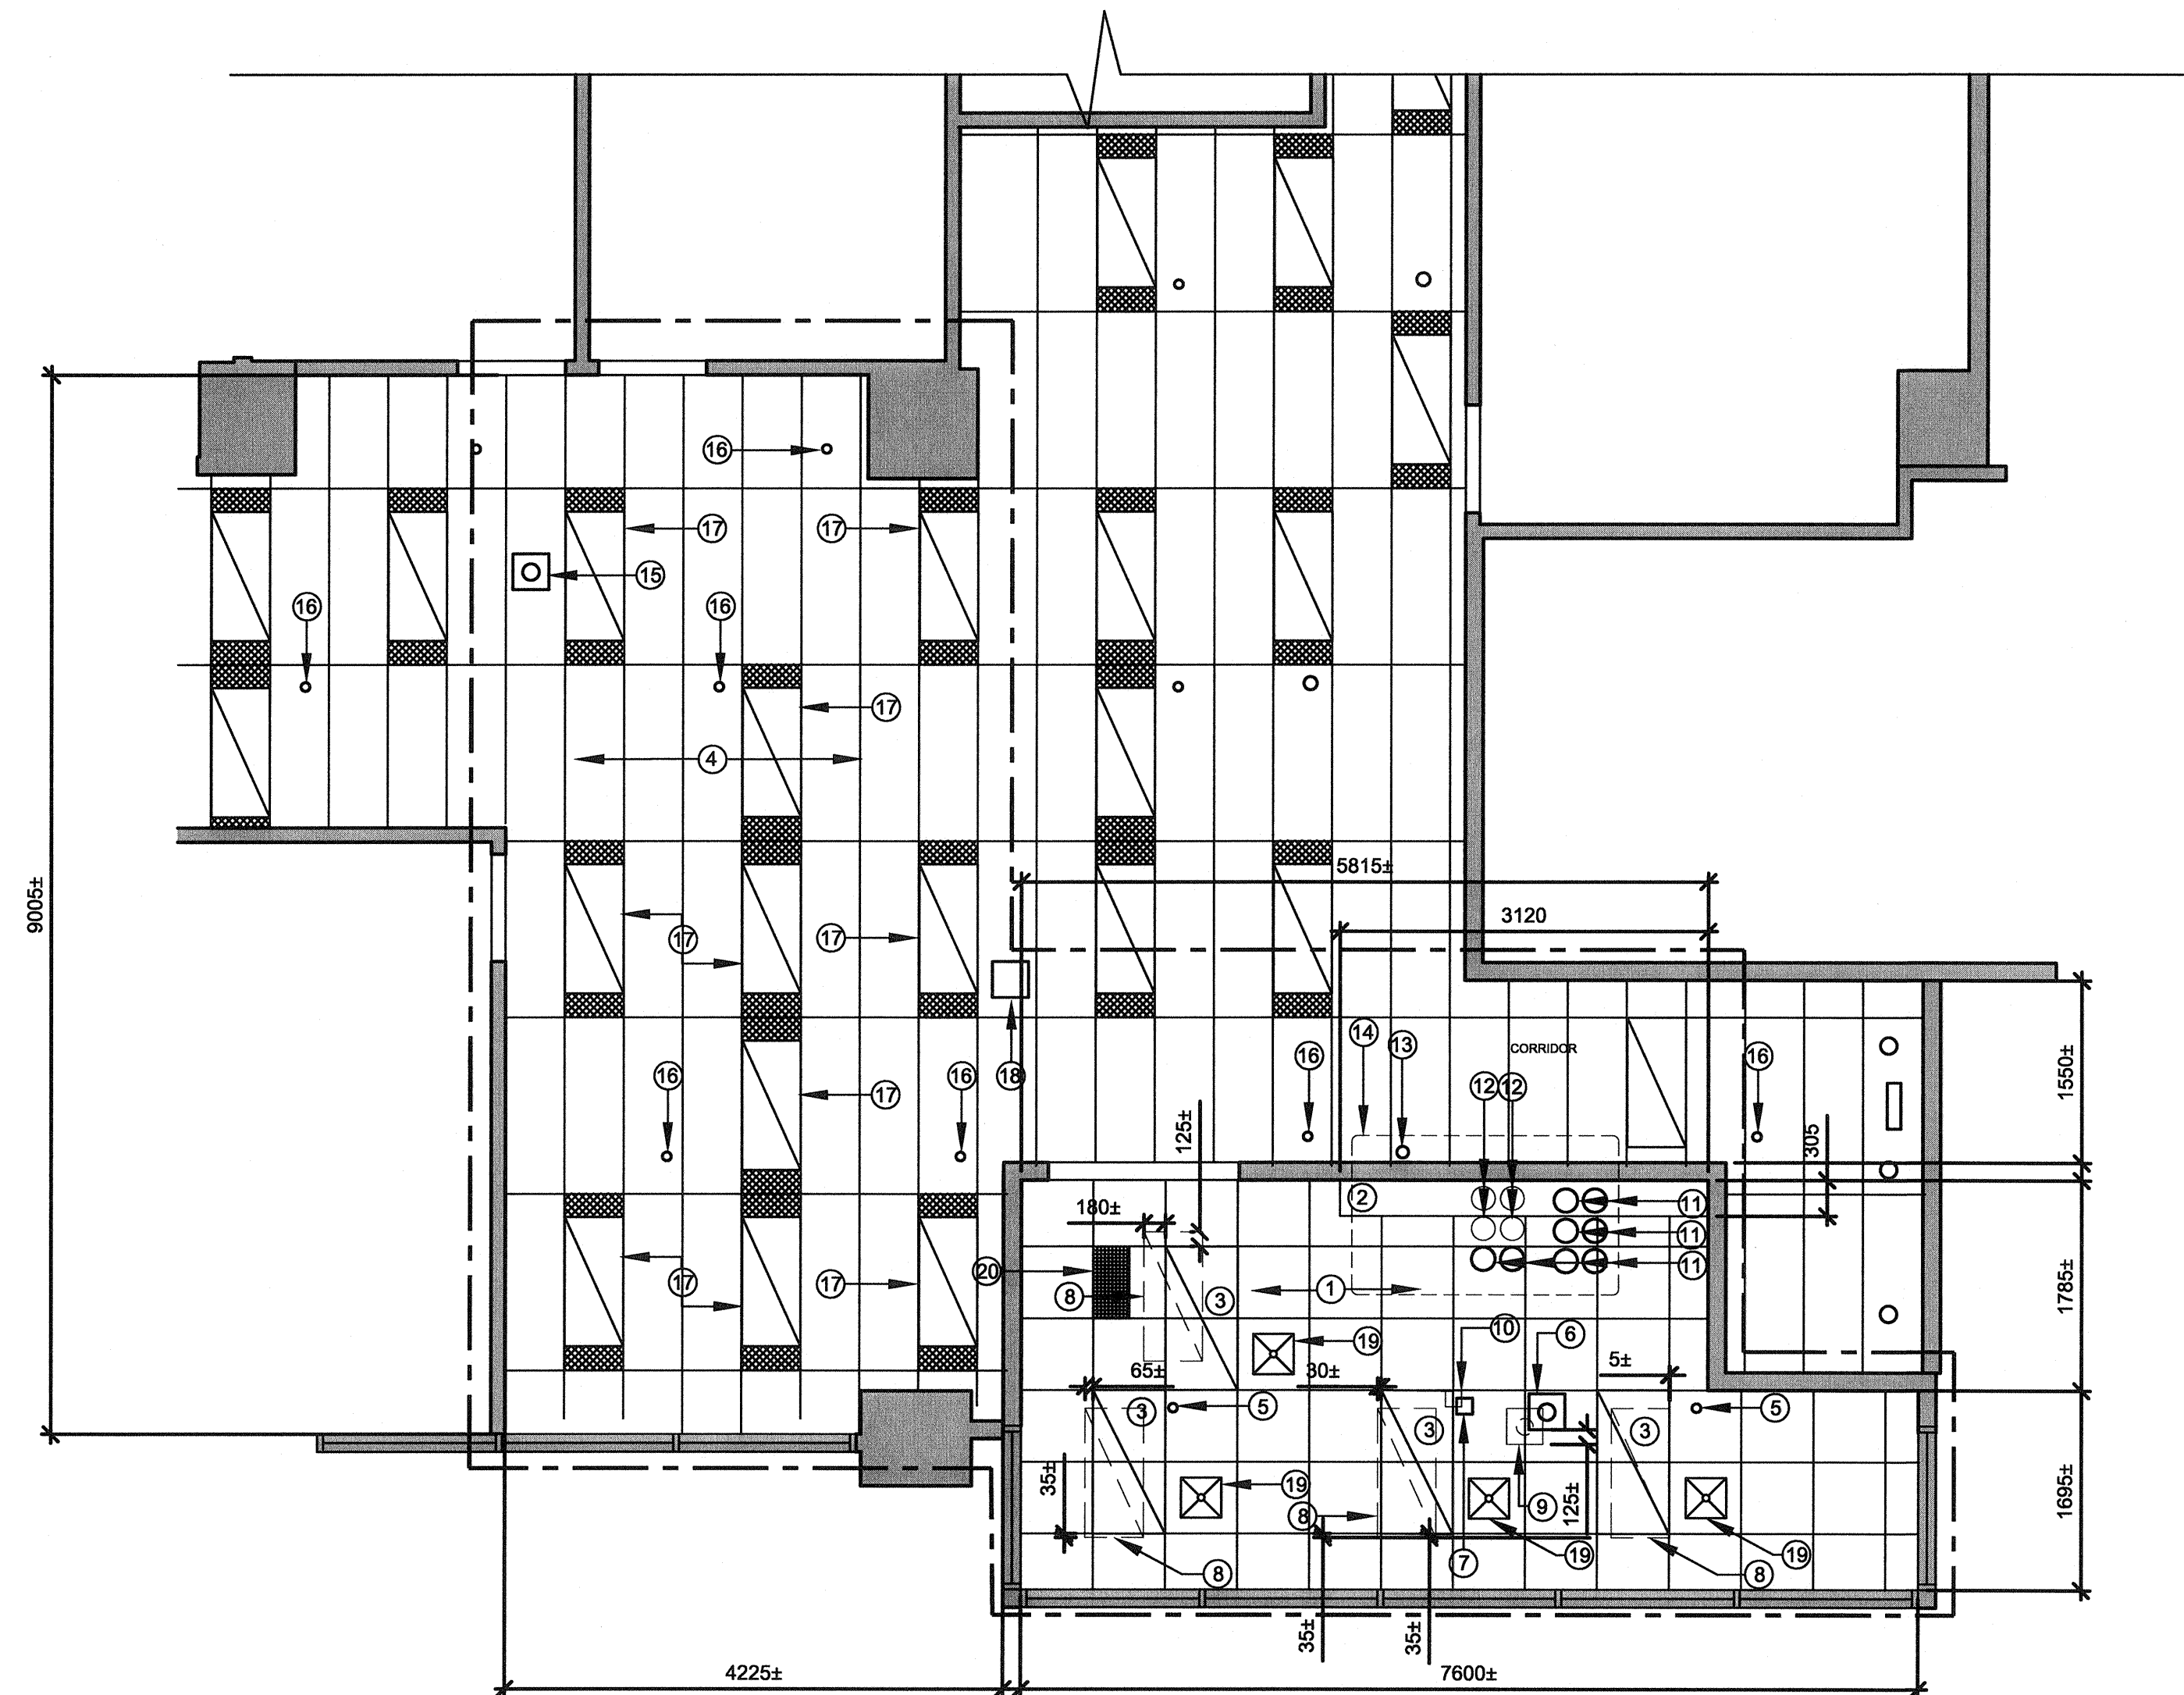

PROPOSED REFLECTED CEILING PLAN
SCALE 1:50 (1:100 WHEN PRINTED ON 11X17)



PRIME CONSULTANT, MECHANICAL & ELECTRICAL




ANTARES ENGINEERING GROUP INC.

ARCHITECTURAL



STAMP

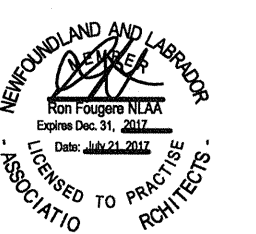

GENERAL NOTES:

- CONTRACTOR MUST VERIFY ALL DIMENSIONS ON SITE BEFORE PROCEEDING WITH ANY PORTION OF THIS WORK. DO NOT SCALE DRAWING.

revisions	title	date
B	Issued for Tender	07.21.17
A	Issued for 90% Review	05.06.17

project project
District Office Infrastructure
John Cabot Building
St. John's, NL
Building ID: GOC00047

drawing dessin

PROPOSED REFLECTED CEILING PLAN

designed	EC/RF	conçu
date	MAY 2017	
drawn	EC	dessiné
date	MAY 2017	
approved	RF	approuvé
date	MAY 2017	
Tender	2017/07/31	Soumission
project number	R.090120.001	no. du projet
drawing no.	A-2.2	no. du dessin

1
A-2.2

