# CANADIAN FOOD INSPECTION AGENCY

## AIR HANDLING UNIT/ EXHAUST MANIFOLD REPLACEMENT

## 3155 WILLINGDON GREEN, BURNABY, B.C. V5G 4P2

#### DRAWING LIST

#### **ARCHITECTURAL**

A100 - COVER SHEET, SITE LOCATION AND PROJECT INFORMATION

A101 - NEW SITE PLAN

A102 - CRAWL SPACE DEMOLITION PLAN
A103 - PARTIAL MAIN FLOOR DEMOLITION PLAN

A104 - PARTIAL CRAWL SPACE NEW PLAN

A105 - PARTIAL MAIN FLOOR NEW PLAN

A106 - PARTIAL SECOND FLOOR PLAN

A107 - MAIN ROOF DEMOLITION AND NEW PLAN

A108 - NORTH AND EAST ELEVATIONS

A109 - SOUTH AND WEST ELEVATIONS

A110 - PLAN DETAILS - AHU 101 / 102

A111 - PLAN DETAILS - AHU 103 DUCTS SCREEN

A112 - DETAILS A113 - DETAILS

A201 - SITE PLAN

A202 - EXISTING MAIN FLOOR HOOD EXHAUST LOCATIONS AND PHASING PLAN

A203 - EXISTING SECOND FLOOR PLAN HOOD EXHAUST LOCATIONS AND PHASING PLAN

A204 - EXISTING & DEMOLITION - MAIN ROOF PLAN
A204.1 - EXISTING AND DEMOLITION - PENTHOUSE ROOF PLAN

A205 - NEW MAIN ROOF PLAN

A206 - NORTH PENTHOUSE EXISTING/DEMOLITION AND NEW PLANS

A207 - CENTRE PENTHOUSE EXISTING/DEMOLITION AND NEW PLANS

A208 - SOUTH PENTHOUSE EXISTING/DEMOLITION AND NEW PLANS

A209 - NEW NORTH AND EAST ELEVATIONS

A210 - NEW SOUTH AND WEST ELEVATIONS
A211 - SOUTH/CENTER/NORTH PENTHOUSE ELEVATIONS

(SHOWING DUCT SLEEVES THROUGH WALL)

A212 - SOUTH/CENTER/NORTH PENTHOUSE ELEVATIONS (SHOWING DUCT WORK INFRONT)

A213 - ELEVATION, SECTION AND PLAN DETAILS

A214 - SECTION DETAILS

A215 - SECTION DETAILS

A216 - CROSS OVER STAIRS PLANS SECTIONS AND DETAILS

A217 - STAINLESS STEEL SLEEVE AND PLATE SCHEDULE

#### STRUCTURAL

S101 - GENERAL NOTES AND TYPICAL DETAILS

S102 - AHU 101 & 102 FRAMING PLANS, CONCRETE PAD PLAN AND DETAILS

S103 - AHU 101 & 102 FRAMING ELEVATION, SECTIONS AND DETAILS

S104 - AHU 103 ROOF FRAMING PLAN AND DETAILS S201 - GENERAL NOTES AND TYPICAL DETAILS

S202 - GENERAL NOTES AND TYPICAL DETAILS

#### **GENERAL DEMOLITION NOTES**

- 1. DEMOLITION DRAWING ONLY SHOWS THE GENERAL SCOPE OF DEMOLITION. ALSO REFER TO OTHER ARCHITECTURAL DETAIL DRAWINGS, MECHANICAL & ELECTRICAL DRAWINGS FOR FULL SCOPE OF DEMOLITION WORKS REQUIRED TO PRODUCE NEW LAYOUT.
- 2. ALL DEMOLISHED MATERIAL AND DEBRIS TO BE REMOVED PROMPTLY FROM SITE AND DISPOSED OF IN A LEGAL MANNER.
- 3. SELLING OF ANY MATERIALS ON SITE IS NOT PERMITTED.
- 4. MAKE GOOD DAMAGED AREA AND FIXTURES OR REPLACED WITH NEW WHICH ARE TO BE RETAINED AS SHOWN IN DRAWING.
- 5. DEMOLISH ALL EXPOSED & HIDDEN ELECTRICAL, MECHANICAL & PLUMBING FIXTURES, ENCLOSED CONDUITS AND PIPINGS, & OTHER FIXTURES AND FINISHES ASSOCIATED WITH DEMOLITION OF WALLS.
- REMOVE ALL EXISTING FINISHES WHICH ARE NOT INDICATED AS EXISTING TO STAY. MAKE GOOD SUBSTRATE TO RECEIVE NEW FINISHES.

#### **MECHANICAL**

M101 - COVER PAGE

M102 - CRAWL SPACE DEMOLITION PLAN - MECHANICAL

M103 - PARTIAL MAIN FLOOR DEMOLITION PLAN - HVAC

M104 - PARTIAL MAIN FLOOR DEMOLITION PLAN - PIPING LAYOUT

M105 - PARTIAL MAIN FLOOR PLAN - HVAC

M106 - CRAWL SPACE FLOOR PLAN - MECHANICAL

M107 - PARTIAL MAIN FLOOR PLAN - PIPING LAYOUT

M108 - PARTIAL SECOND FLOOR PLAN - MECHANICAL

M109 - ROOF PLAN - MECHANICAL M110 - SECTIONS - MECHANICAL

M111 - SECTIONS AND ELEVATIONS

M112 - SECTIONS, ELEVATIONS AND DETAILS

M113 - AIR HANDLING UNIT DETAILS, HYDRONIC SCHEMATIC

M-201 - EXISTING EXHAUST FAN INFORMATION, MECHANICAL LEGEND, GENERAL NOTES, AND DRAWING LIST

M202 - ROOF PLAN - DEMOLITION

M203 - ROOF PLAN - NEW CONSTRUCTION

M204 - NORTH PENTHOUSE AND PARTIAL ROOF PLAN AND SCHEMATIC -

M205 - NORTH PENTHOUSE AND PARTIAL ROOF PLAN AND SCHEMATIC -

NEW CONSTRUCTION
M206 - CENTRE PENTHOUSE SOUTHEAST AND PARTIAL ROOF PLAN AND

SCHEMATIC - DEMOLITION
M207 - CENTRE PENTHOUSE SOUTHEAST AND PARTIAL ROOF PLAN AND

SCHEMATIC, - NEW CONSTRUCTION

M208 - CENTRE PENTHOUSE NORTHWEST AND PARTIAL ROOF PLAN AND SCHEMATIC, - DEMOLITION

M209 - CENTRE PENTHOUSE NORTHWEST AND PARTIAL ROOF PLAN AND

SCHEMATIC, - NEW CONSTRUCTION
M210 - SOUTH PENTHOUSE AND PARTIAL ROOF PLAN AND SCHEMATIC -

M210 - SOUTH PENTHOUSE AND PARTIAL ROOF PLAN AND SCHEMATIC DEMOLITION

M211 - SOUTH PENTHOUSE AND PARTIAL ROOF PLAN AND SCHEMATIC -

NEW CONSTRUCTION

M212 - TYPICAL INSTALLATION DETAILS

#### ELECTRICAL

E.0.01 - ELECTRICAL GENERAL NOTES, LEGENDS AND DETAILS

E.1.01 - GROUND FLOOR DEMOLITION LAYOUT

E.1.02 - GROUND FLOOR POWER LAYOUT E.1.03 - CRAWL SPACE POWER LAYOUT

E.1.04 - PENTHOUSE PLAN DEMOLITION LAYOUT

E.1.05 - PENTHOUSE POWER LAYOUT E.2.01 - MCC AND E-ROOM ELEVATION

E.2.02 - PANEL SCHEDULE

E.5.01 - SINGLE LINE DIAGRAM


## CIVIL

C101 - CIVIL SITE PLAN

C102 - CIVIL CONSTRUCTION DETAILS

#### **GENERAL CONSTRUCTION NOTES**

- 1. THESE NOTES APPLY TO ALL DRAWINGS.
- 2. THIS IS A COPYRIGHT DRAWING AND DESIGN, AND SHALL NOT BE USED, REPRODUCED OR REVISED WITHOUT WRITTEN PERMISSION.
- 3. CHECK AND VERIFY ALL DIMENSIONS ON SITE AND REPORT ALL ERRORS AND OMISSIONS TO THE DEPARTMENTAL REPRESENTATIVES PRIOR TO COMMENCING WORK.
- 4. THESE DRAWINGS ARE NOT TO BE SCALED.
- 5. ALL DIMENSIONS, UNLESS OTHERWISE NOTED, ARE METRIC.
- 6. ALL WALL DIMENSIONS ARE TO THE CENTRE LINE OF STUD UNLESS OTHERWISE NOTED.
- TOUCH UP AND MAKE GOOD ALL EXISTING WALLS TO REMAIN SUITABLE TO RECEIVE NEW PAINT FINISH.
- 10. FIRESTOP ALL EXISTING AND NEW SERVICE PENETRATIONS THROUGH FLOOR SLAB AND VERTICAL FIRE SEPARATION
- 11. PROVIDE X-RAY TO EXISTING FLOOR SLAB PRIOR TO CORING FOR NEW SERVICE PENETRATION

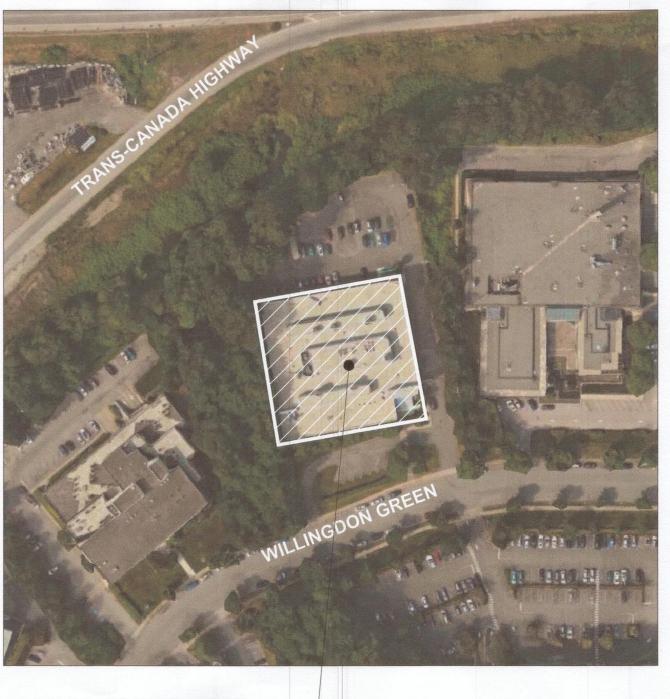

AREA OF CONSTRUCTION



## PLAN NTS PROJECT NORTH

#### PROJECT TEAM

ARCHITECTURAL
CHERNOFF THOMPSON ARCHITECTS
1340-1075 WEST GERGIA ST.
VANCOUVER, BC V6E 3C9
PH. 604 669-9460
CONTACT: RUSS CHERNOFF

STRUCTURAL READ JONES CHRISTOFFERSEN LTD. 1285 W BROADWAY #300 VANCOUVER, BC V6H 3X8 PH. 604 738-0048 CONTACT: JEFF COBETT

MECHANICAL
INTEGRAL GROUP
200 GRANVILLE ST
VANCOUVER, BC V6C 1S4
PH. (604) 687-1800
CONTACT: MLADEN MARKOVIC

ELECTRICAL
MORRISON HERSHFIELD
4321 STILL CREEK DR #310
BURNABY, BC V5C 6S7
PH. 604 687 1800
CONTACT: BORIANA ARGUIROVA

CIVIL URBAN SYSTEMS 1250-13401 108 AVE SURREY BC, V3T 5T3 PH. 604 235-1701 CONTACT: MARK DOWNING

## PROJ

LOT 54, DISTRICT LOT 70, GROUP 1, 65869, NEW WESTMINSTER DISTRICT

BUILDING CODE ANALYSIS

LEGAL DESCRIPTION

#### BOILDING CODE ANALIS

BLDG FLOOR AREA: 2282.4m²
FIRST FLOOR AREA: 2277.6m²
2ND FLOOR AREA: 2252.0m²
BUILDING HEIGHT: 2 STOREY

MAJOR OCCUPANCY - F2

SUBSIDIARY OCCUPANCY - D NUMBER OF STREETS - 3

APPLICABLE CODE: 2010 NBC
THE BUILDING WAS DESIGNED UNDER PART 3



REAL PROPERTY SERVICES
Pacific Region
SERVICES IMMOBILIERS
Région de Pacifique

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3	ISSUED FOR TENDER	2017-07-13
2	ISSUED FOR 100% CD	2017-05-09
1	PRE-TENDER CD FOR CLIENT REVIEW	2017-04-05
0	50% CD REVIEW	2017-03-03
Revision/ Revision	Description/Description	Date/Date
Client/client		

CANADIAN FOOD INSPECTION AGENCY

Project title/Titre du projet

3155 WILLINGDON GREEN
BURNABY, BC

CFIA AHU REPLACEMENT

Consultant Signature Only

Designed by/Concept par

Drawn by/Dessine par
LM 2016-03-09

PWGSC Project Manager/Administrateur de Projets TPSGC

Regional Manager, Architectural and Engineering Services Gestionnaire régionale, Services d'architectural et de génie, TPSGC

Drawing title/Titre du dessin


COVER SHEET, SITE LOCATION AND PROJECT INFORMATION

Project No./No. du projet
39903-150591

A100
Revision no.


Revision no.


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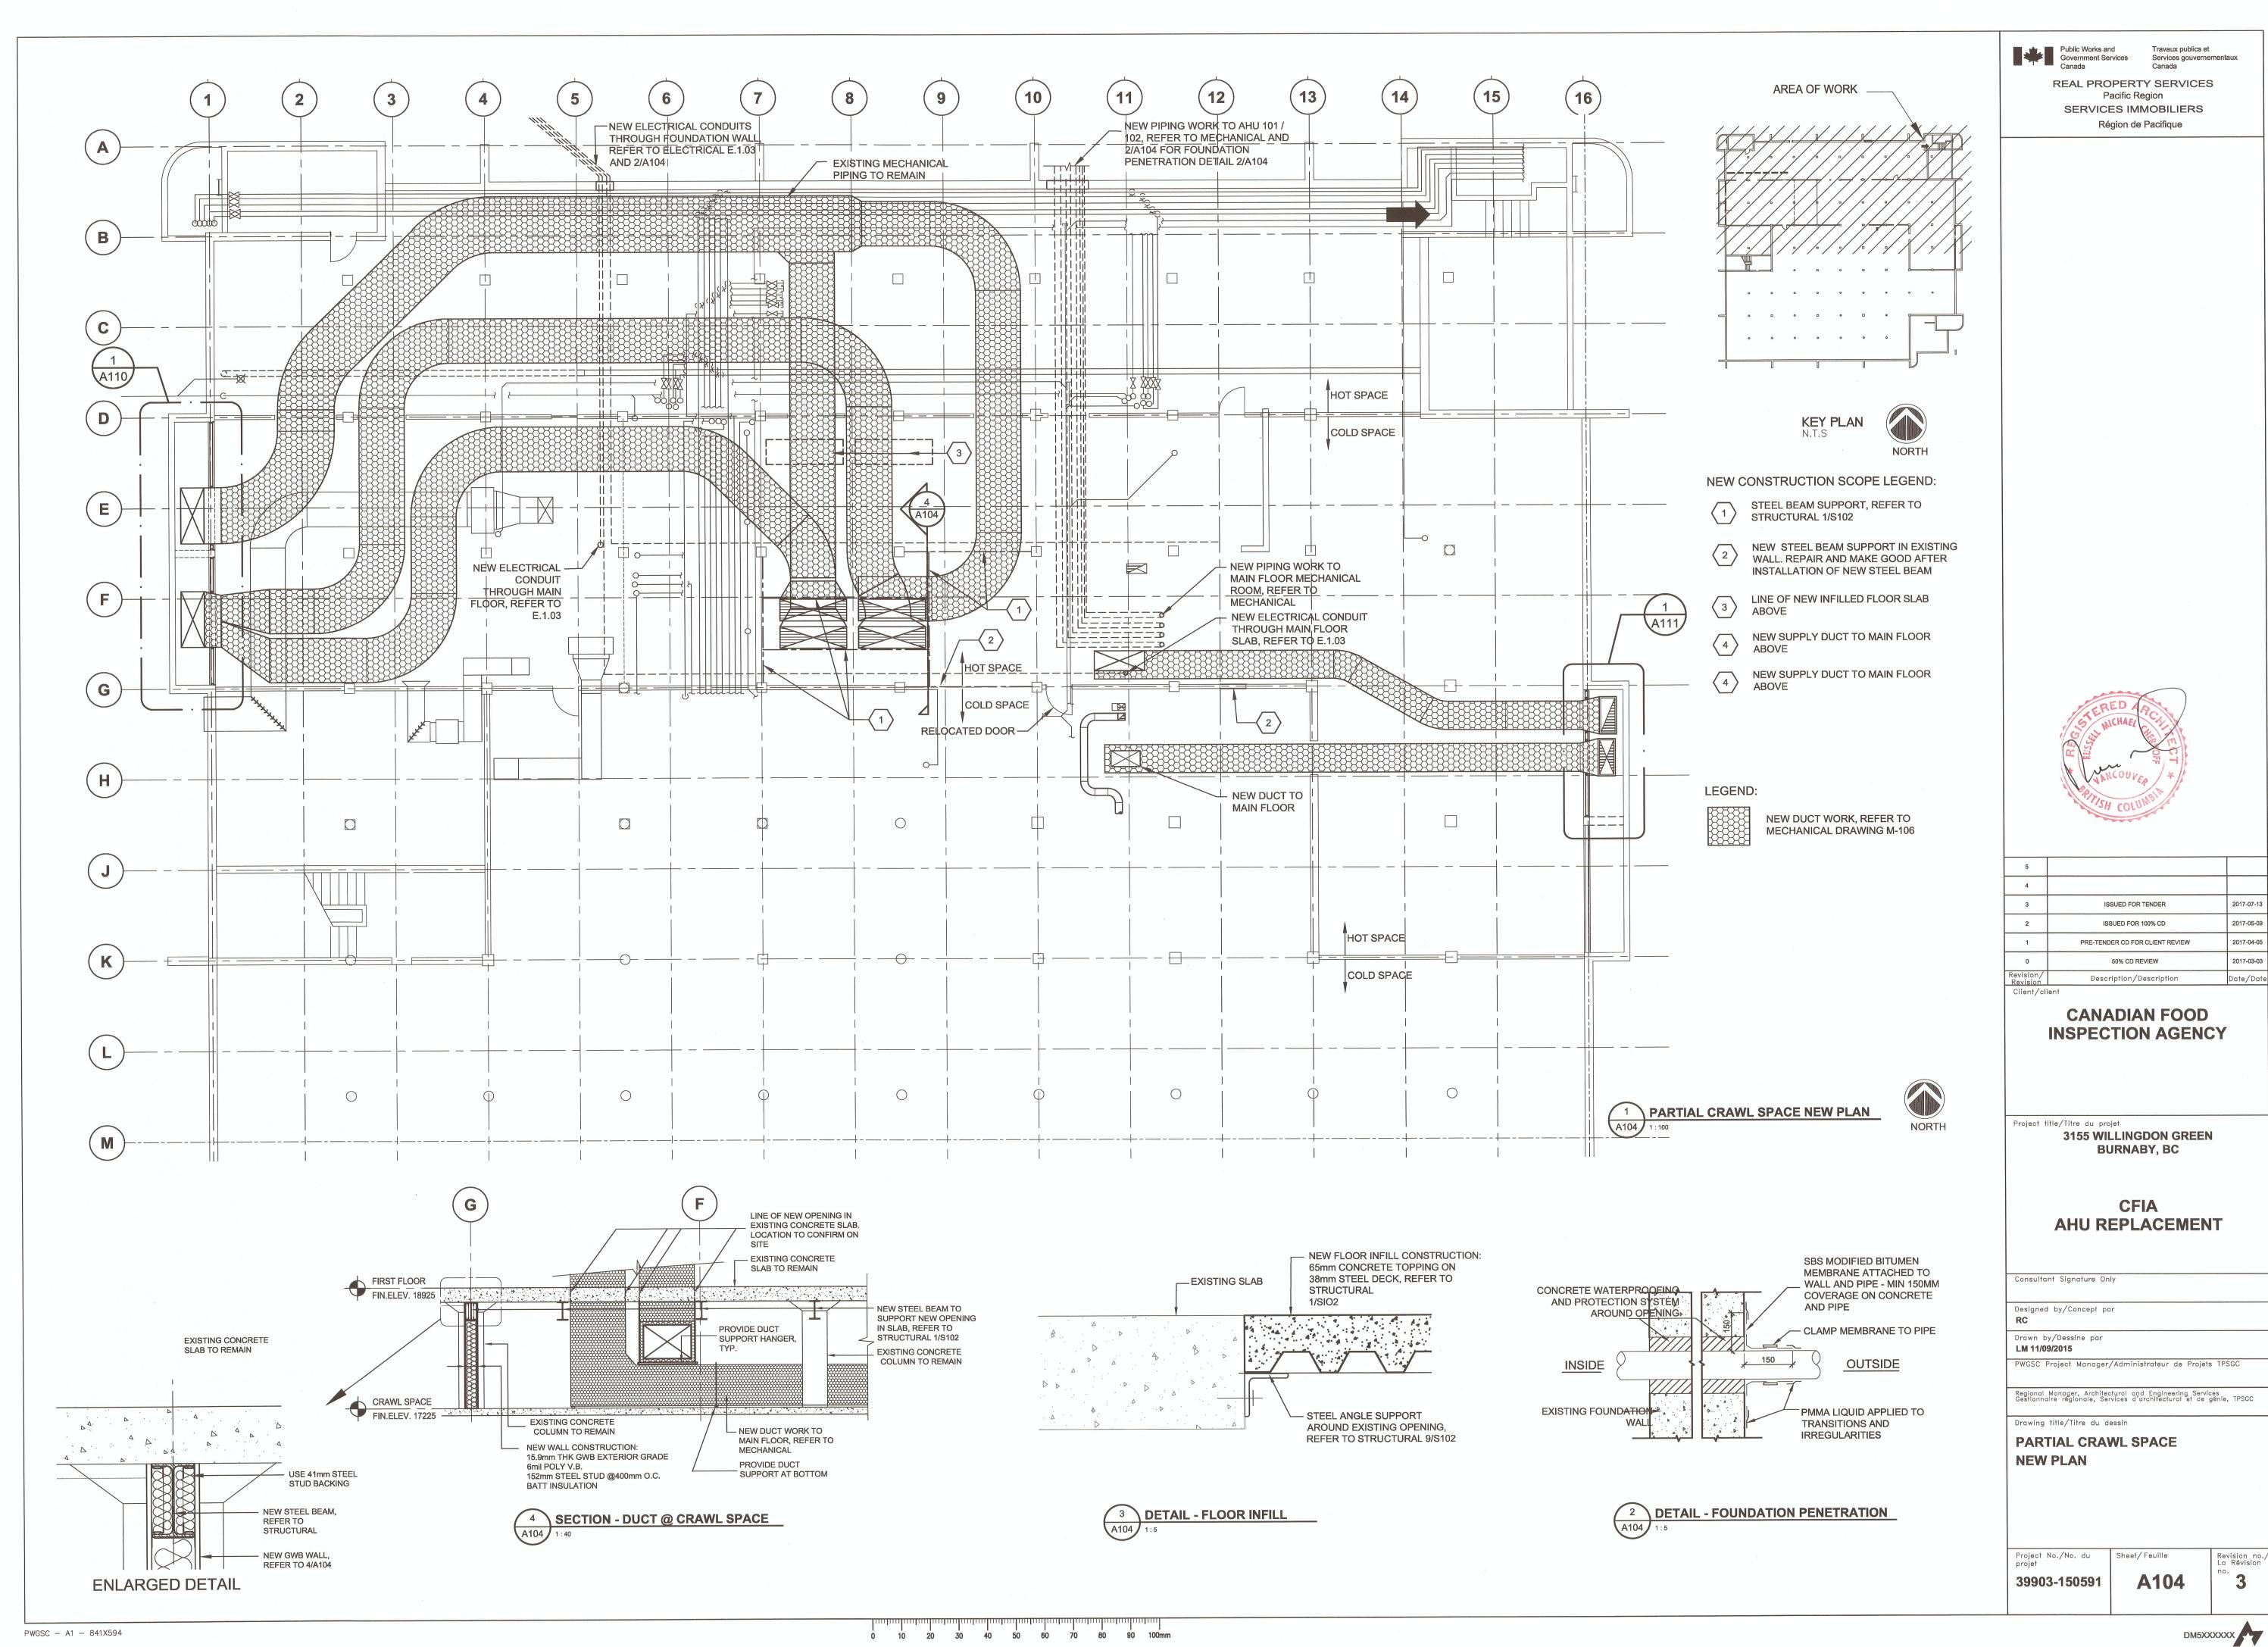


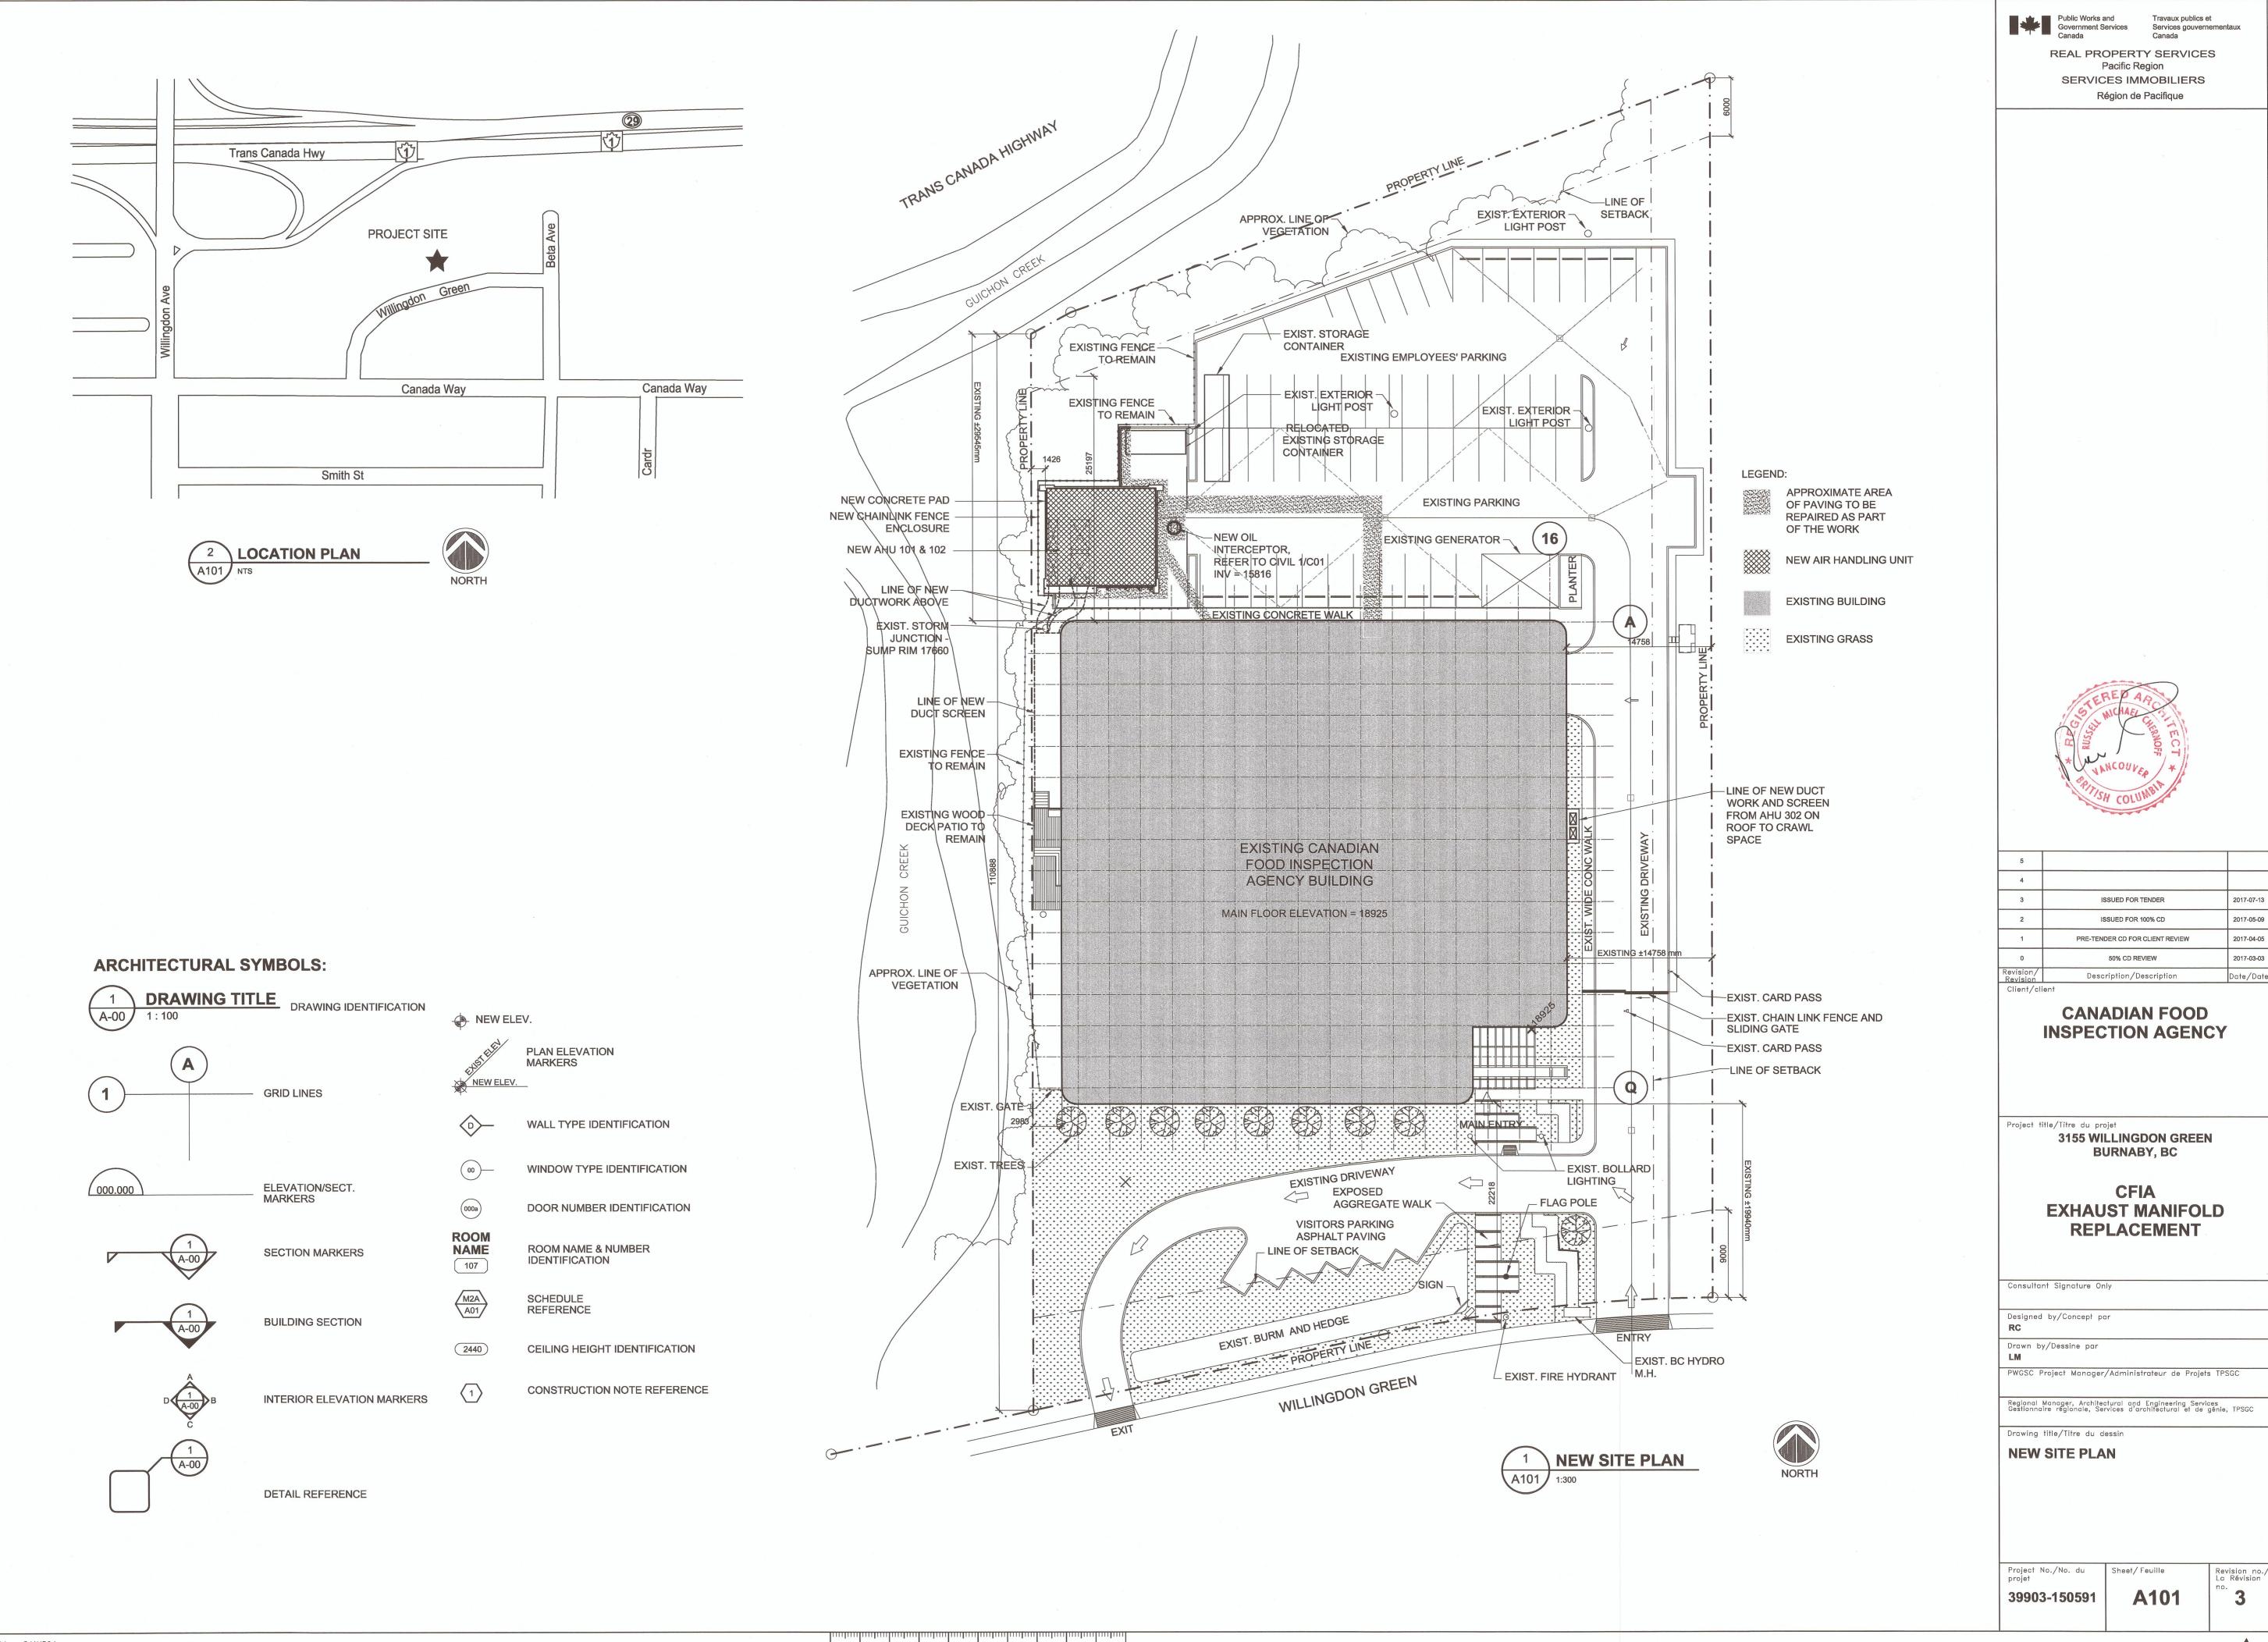
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3	ISSUED FOR TENDER	2017-07-1
2	ISSUED FOR 100% CD	2017-05-0
1	PRE-TENDER CD FOR CLIENT REVIEW	2017-04-0
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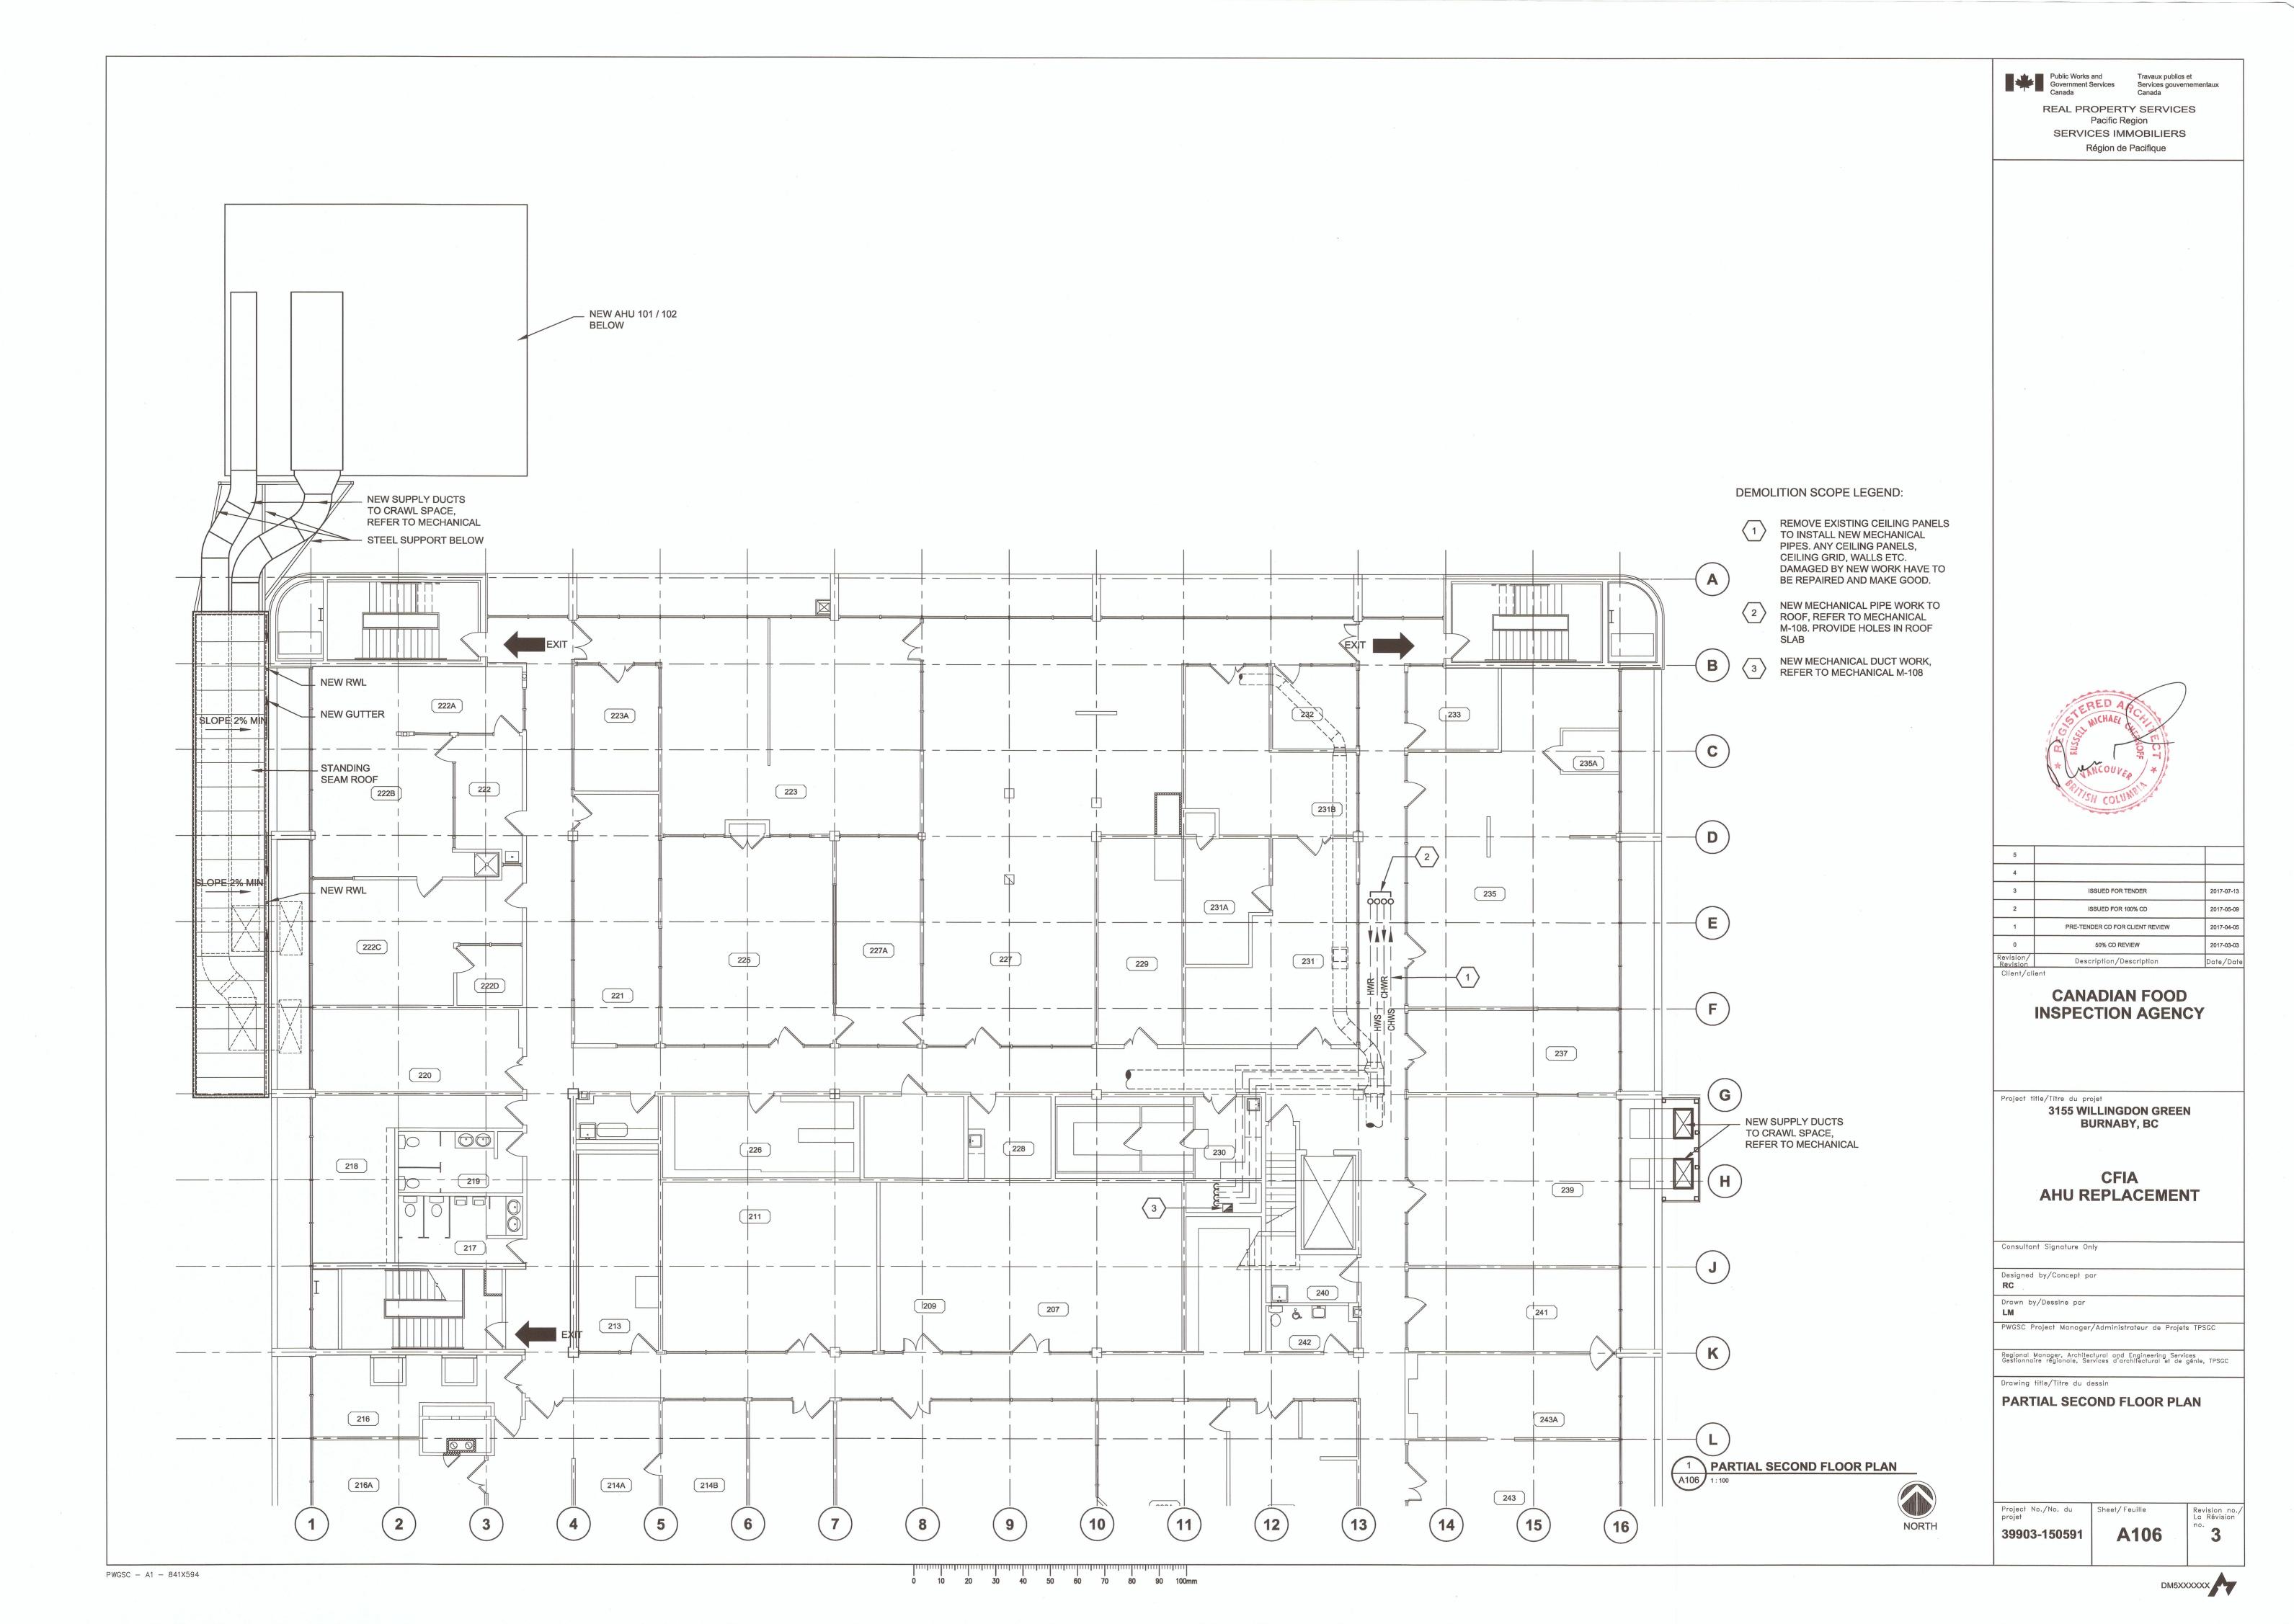
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RC		
Drawn by/I	essine par	
LM		







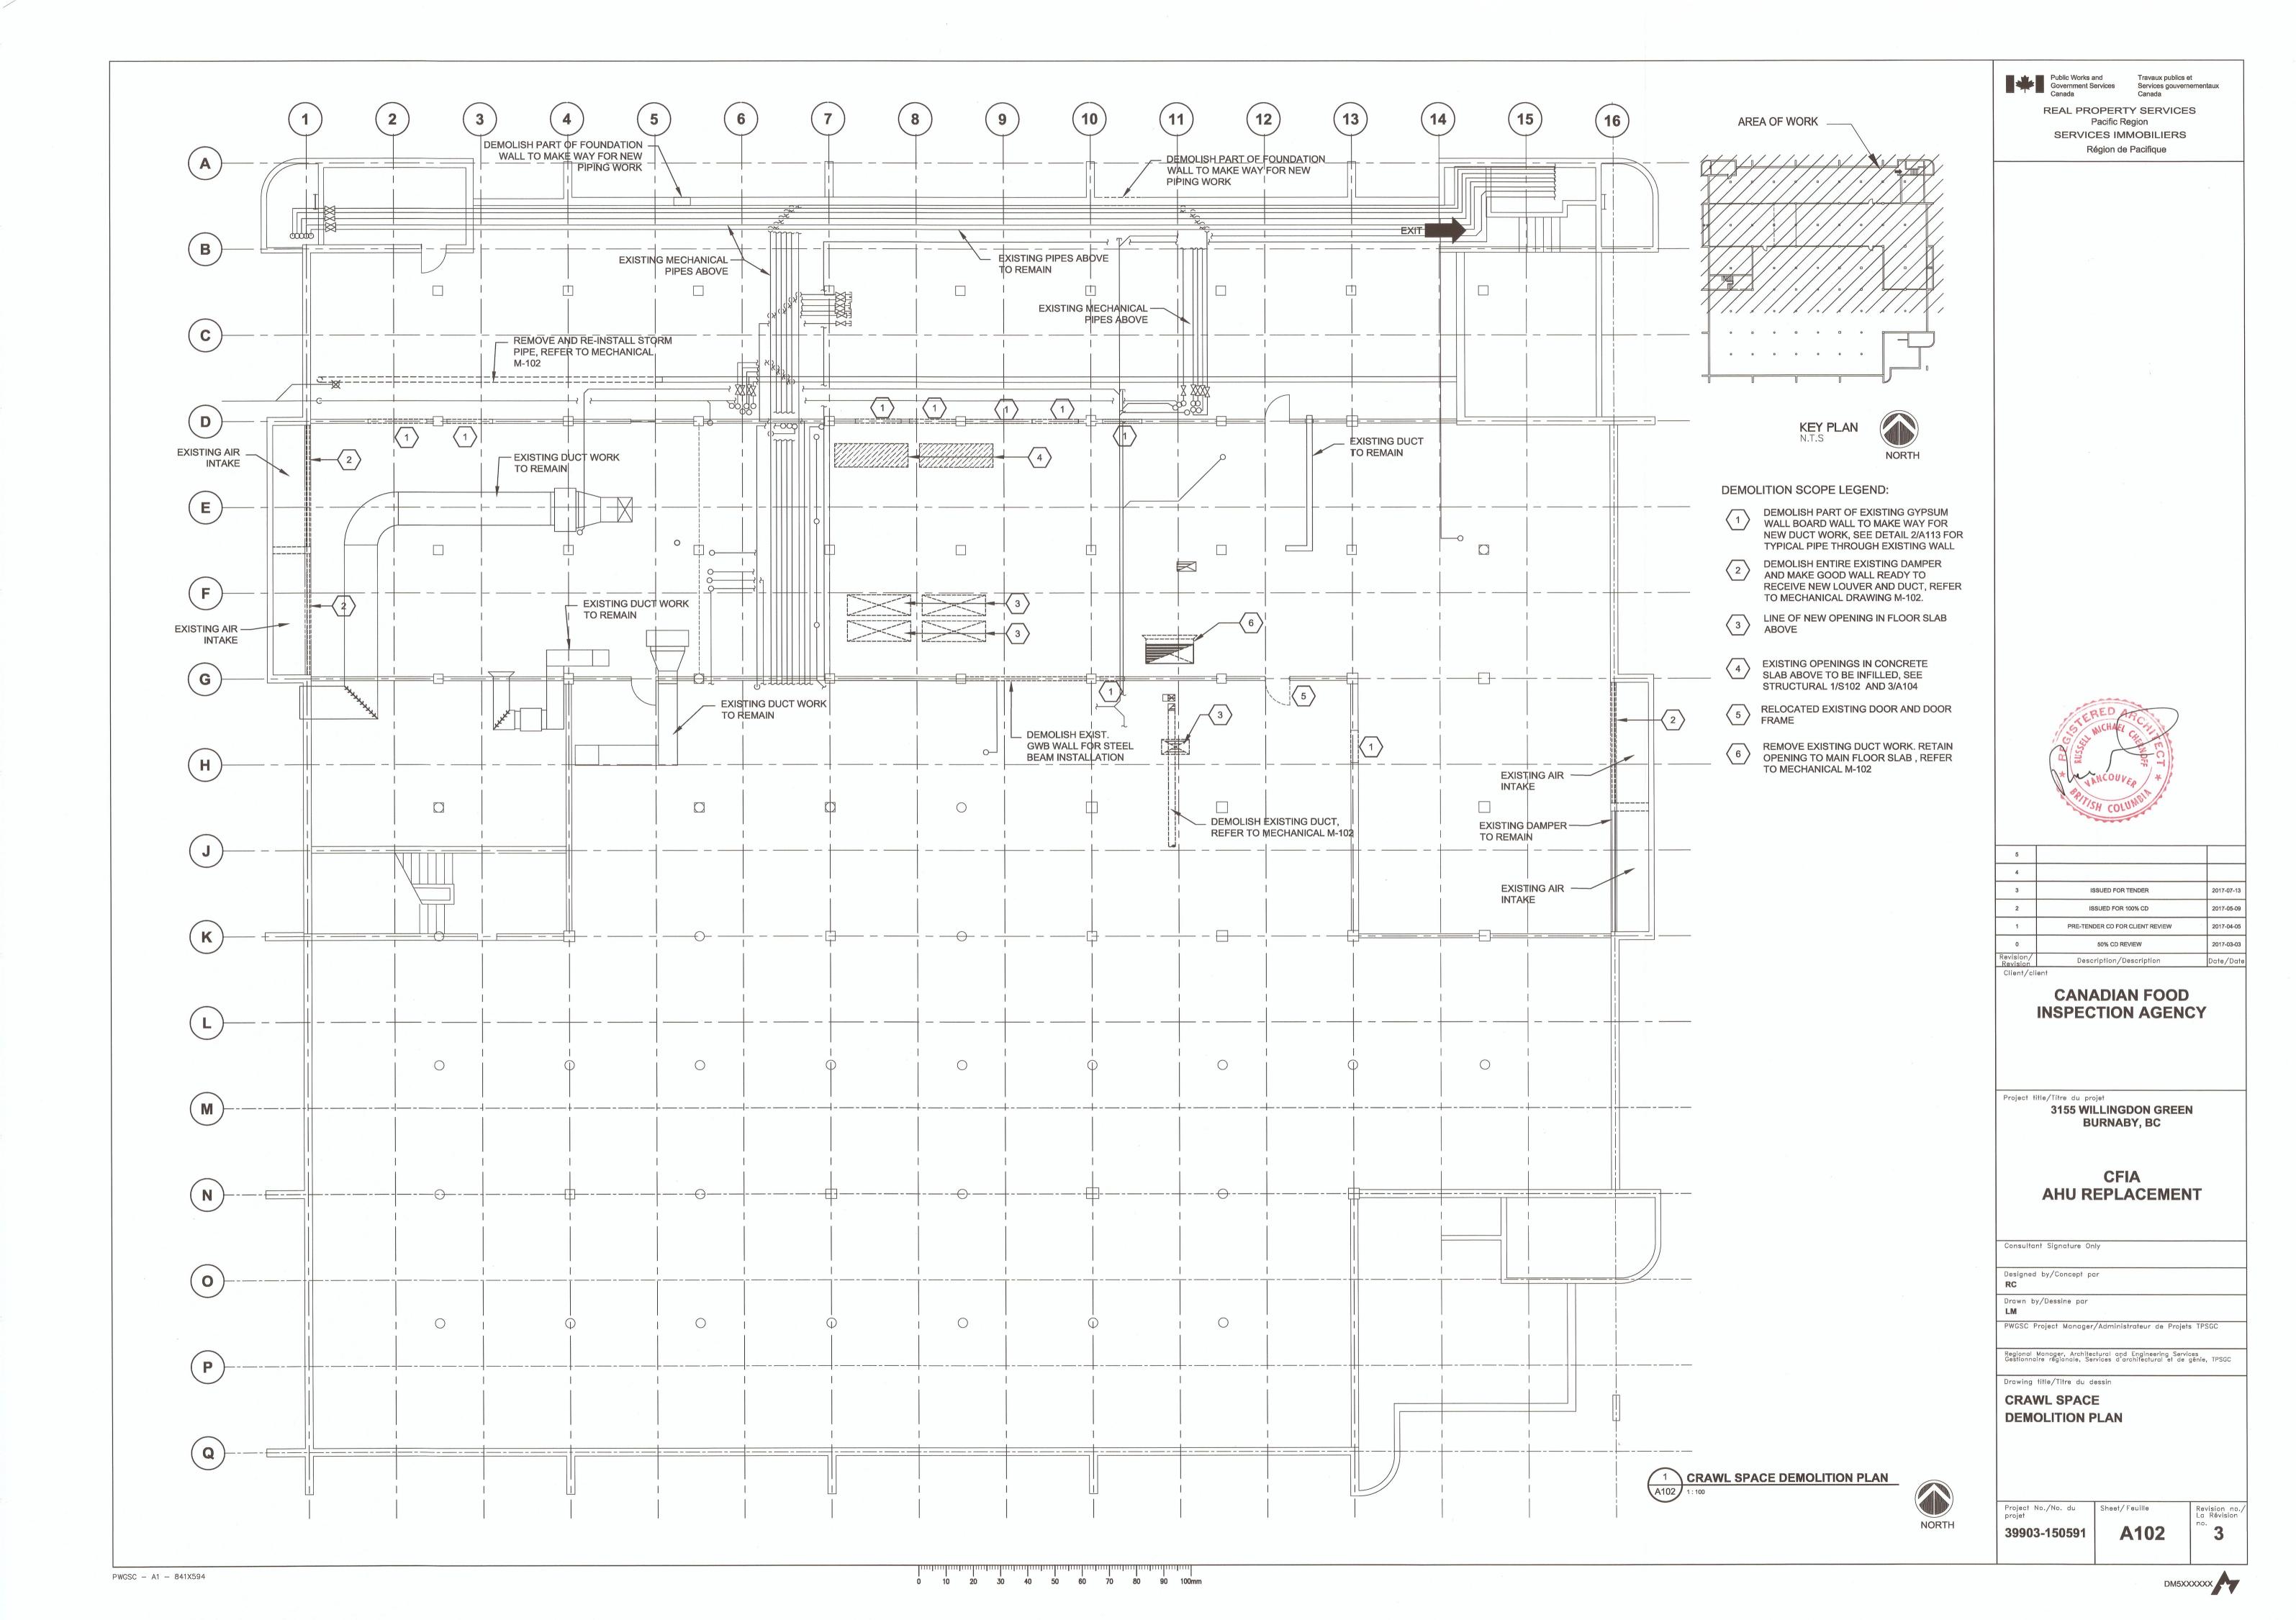


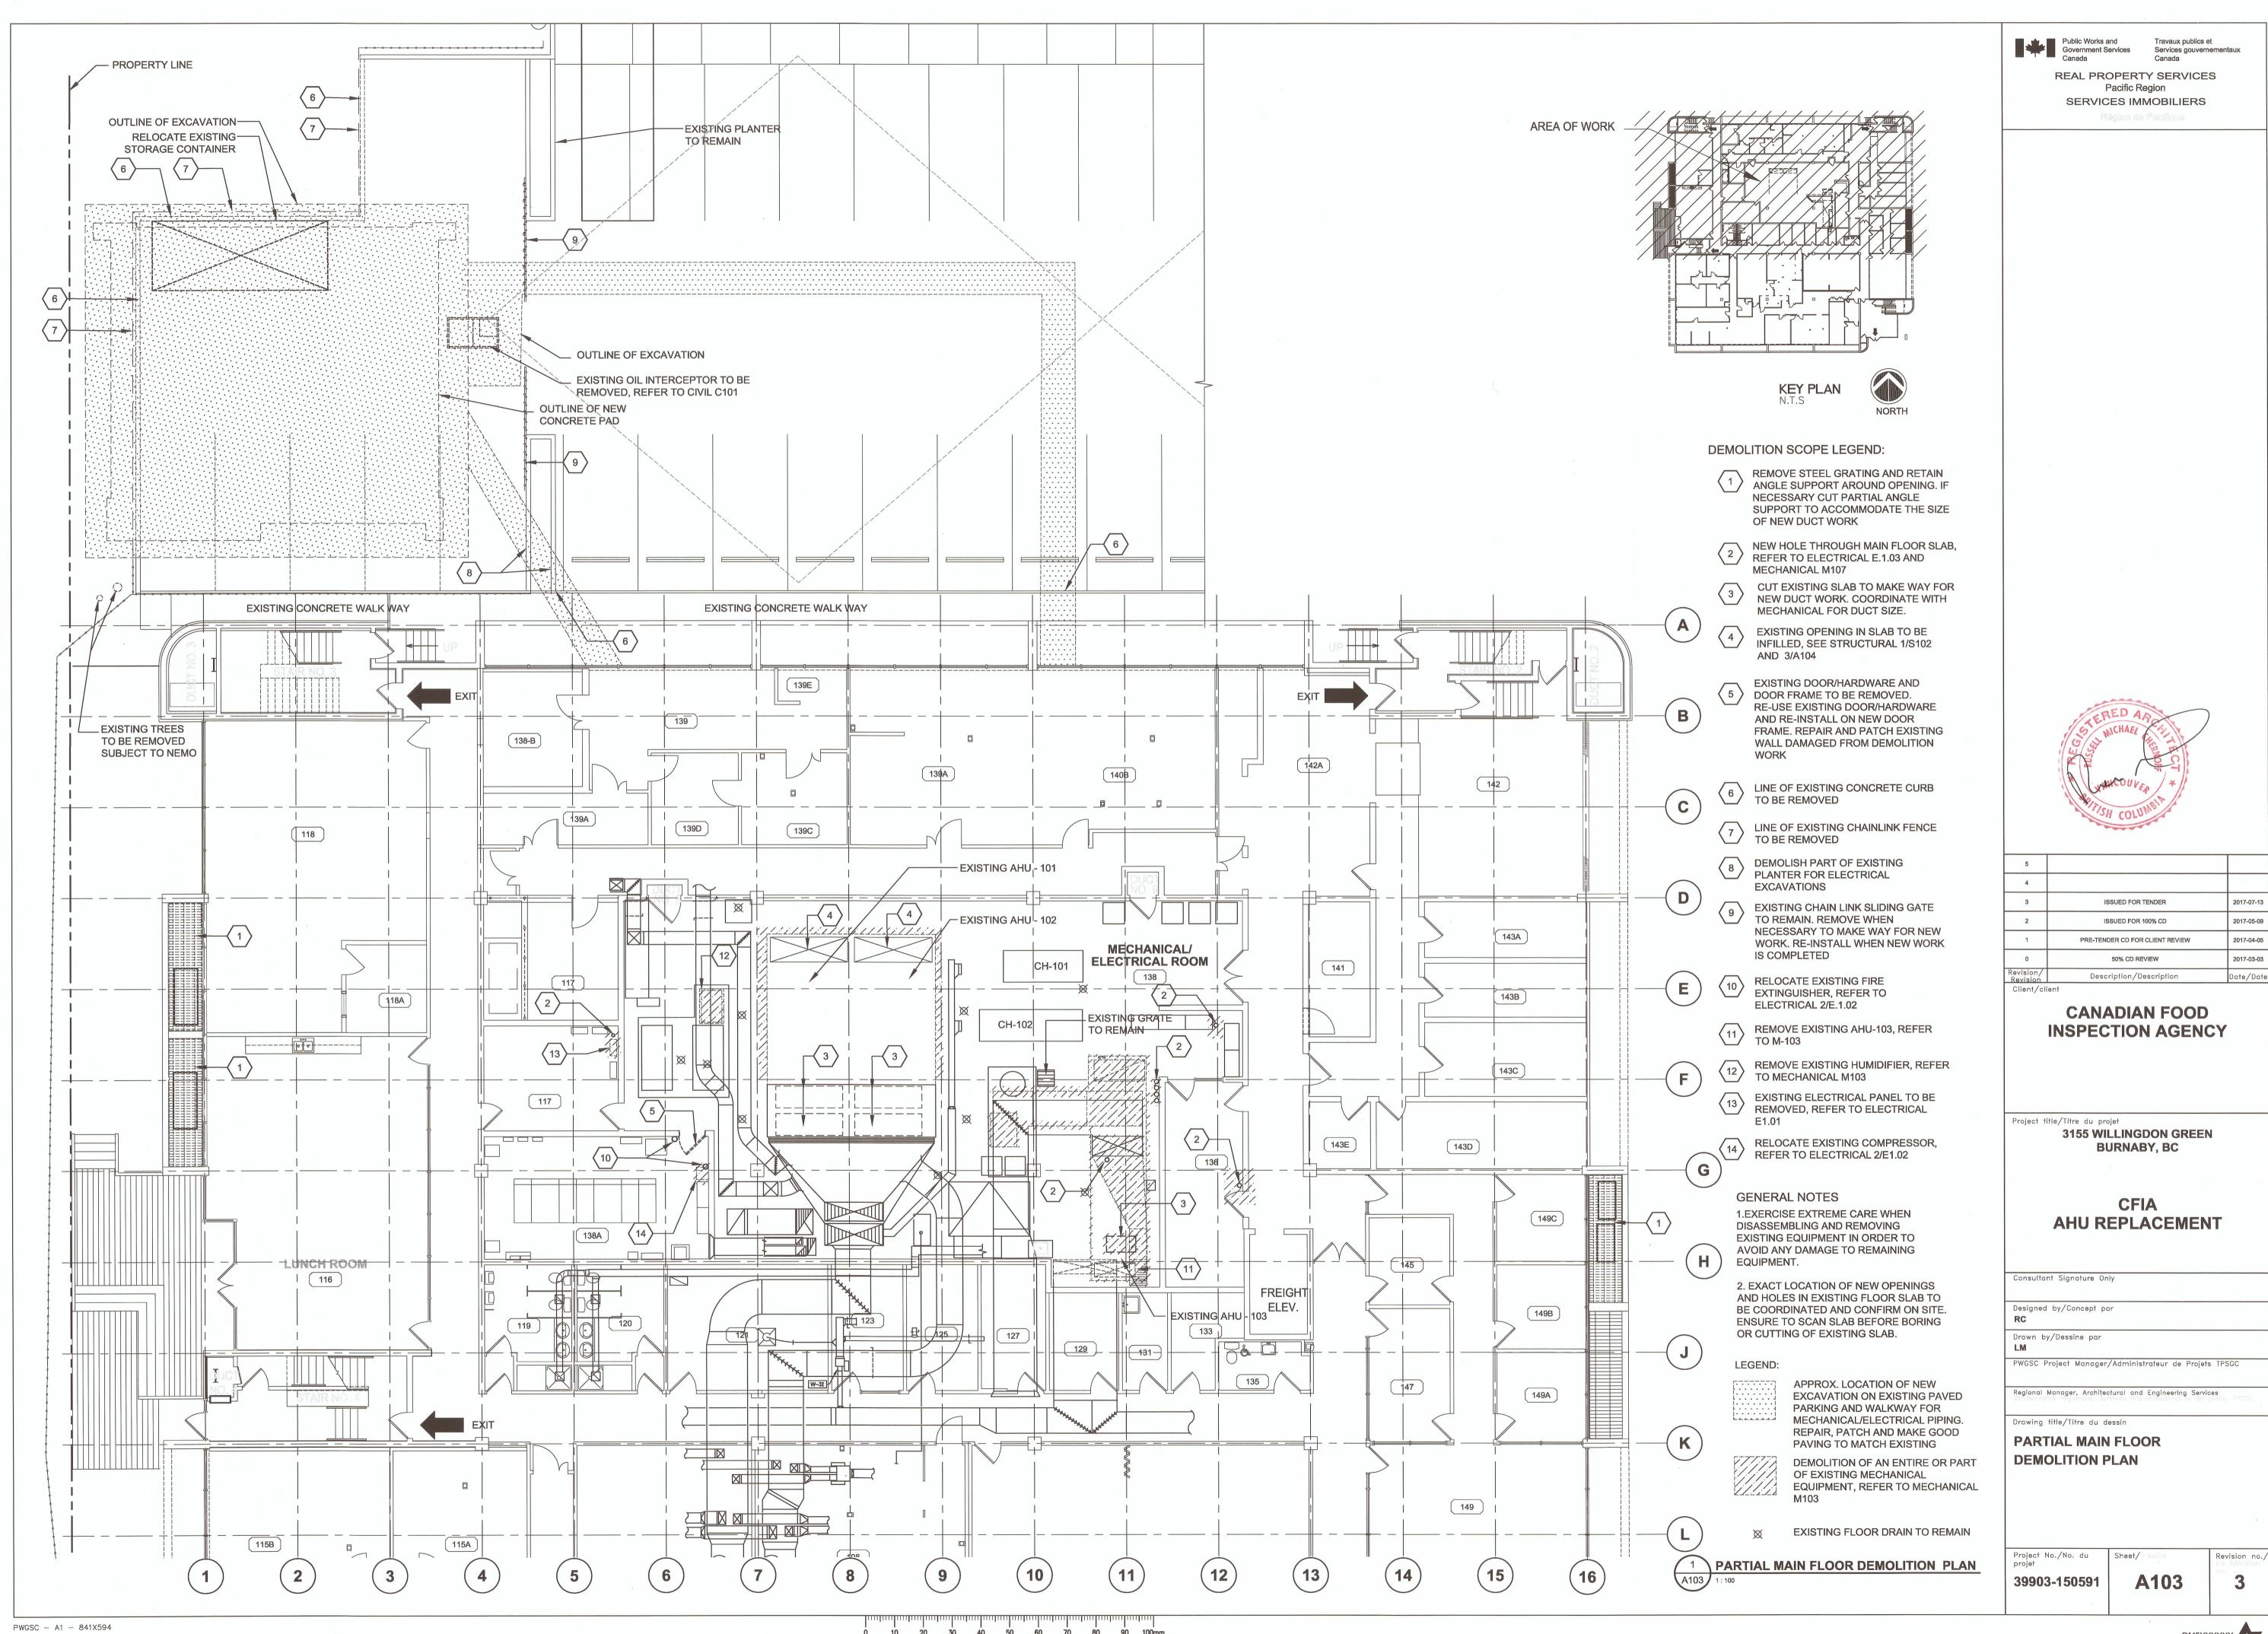

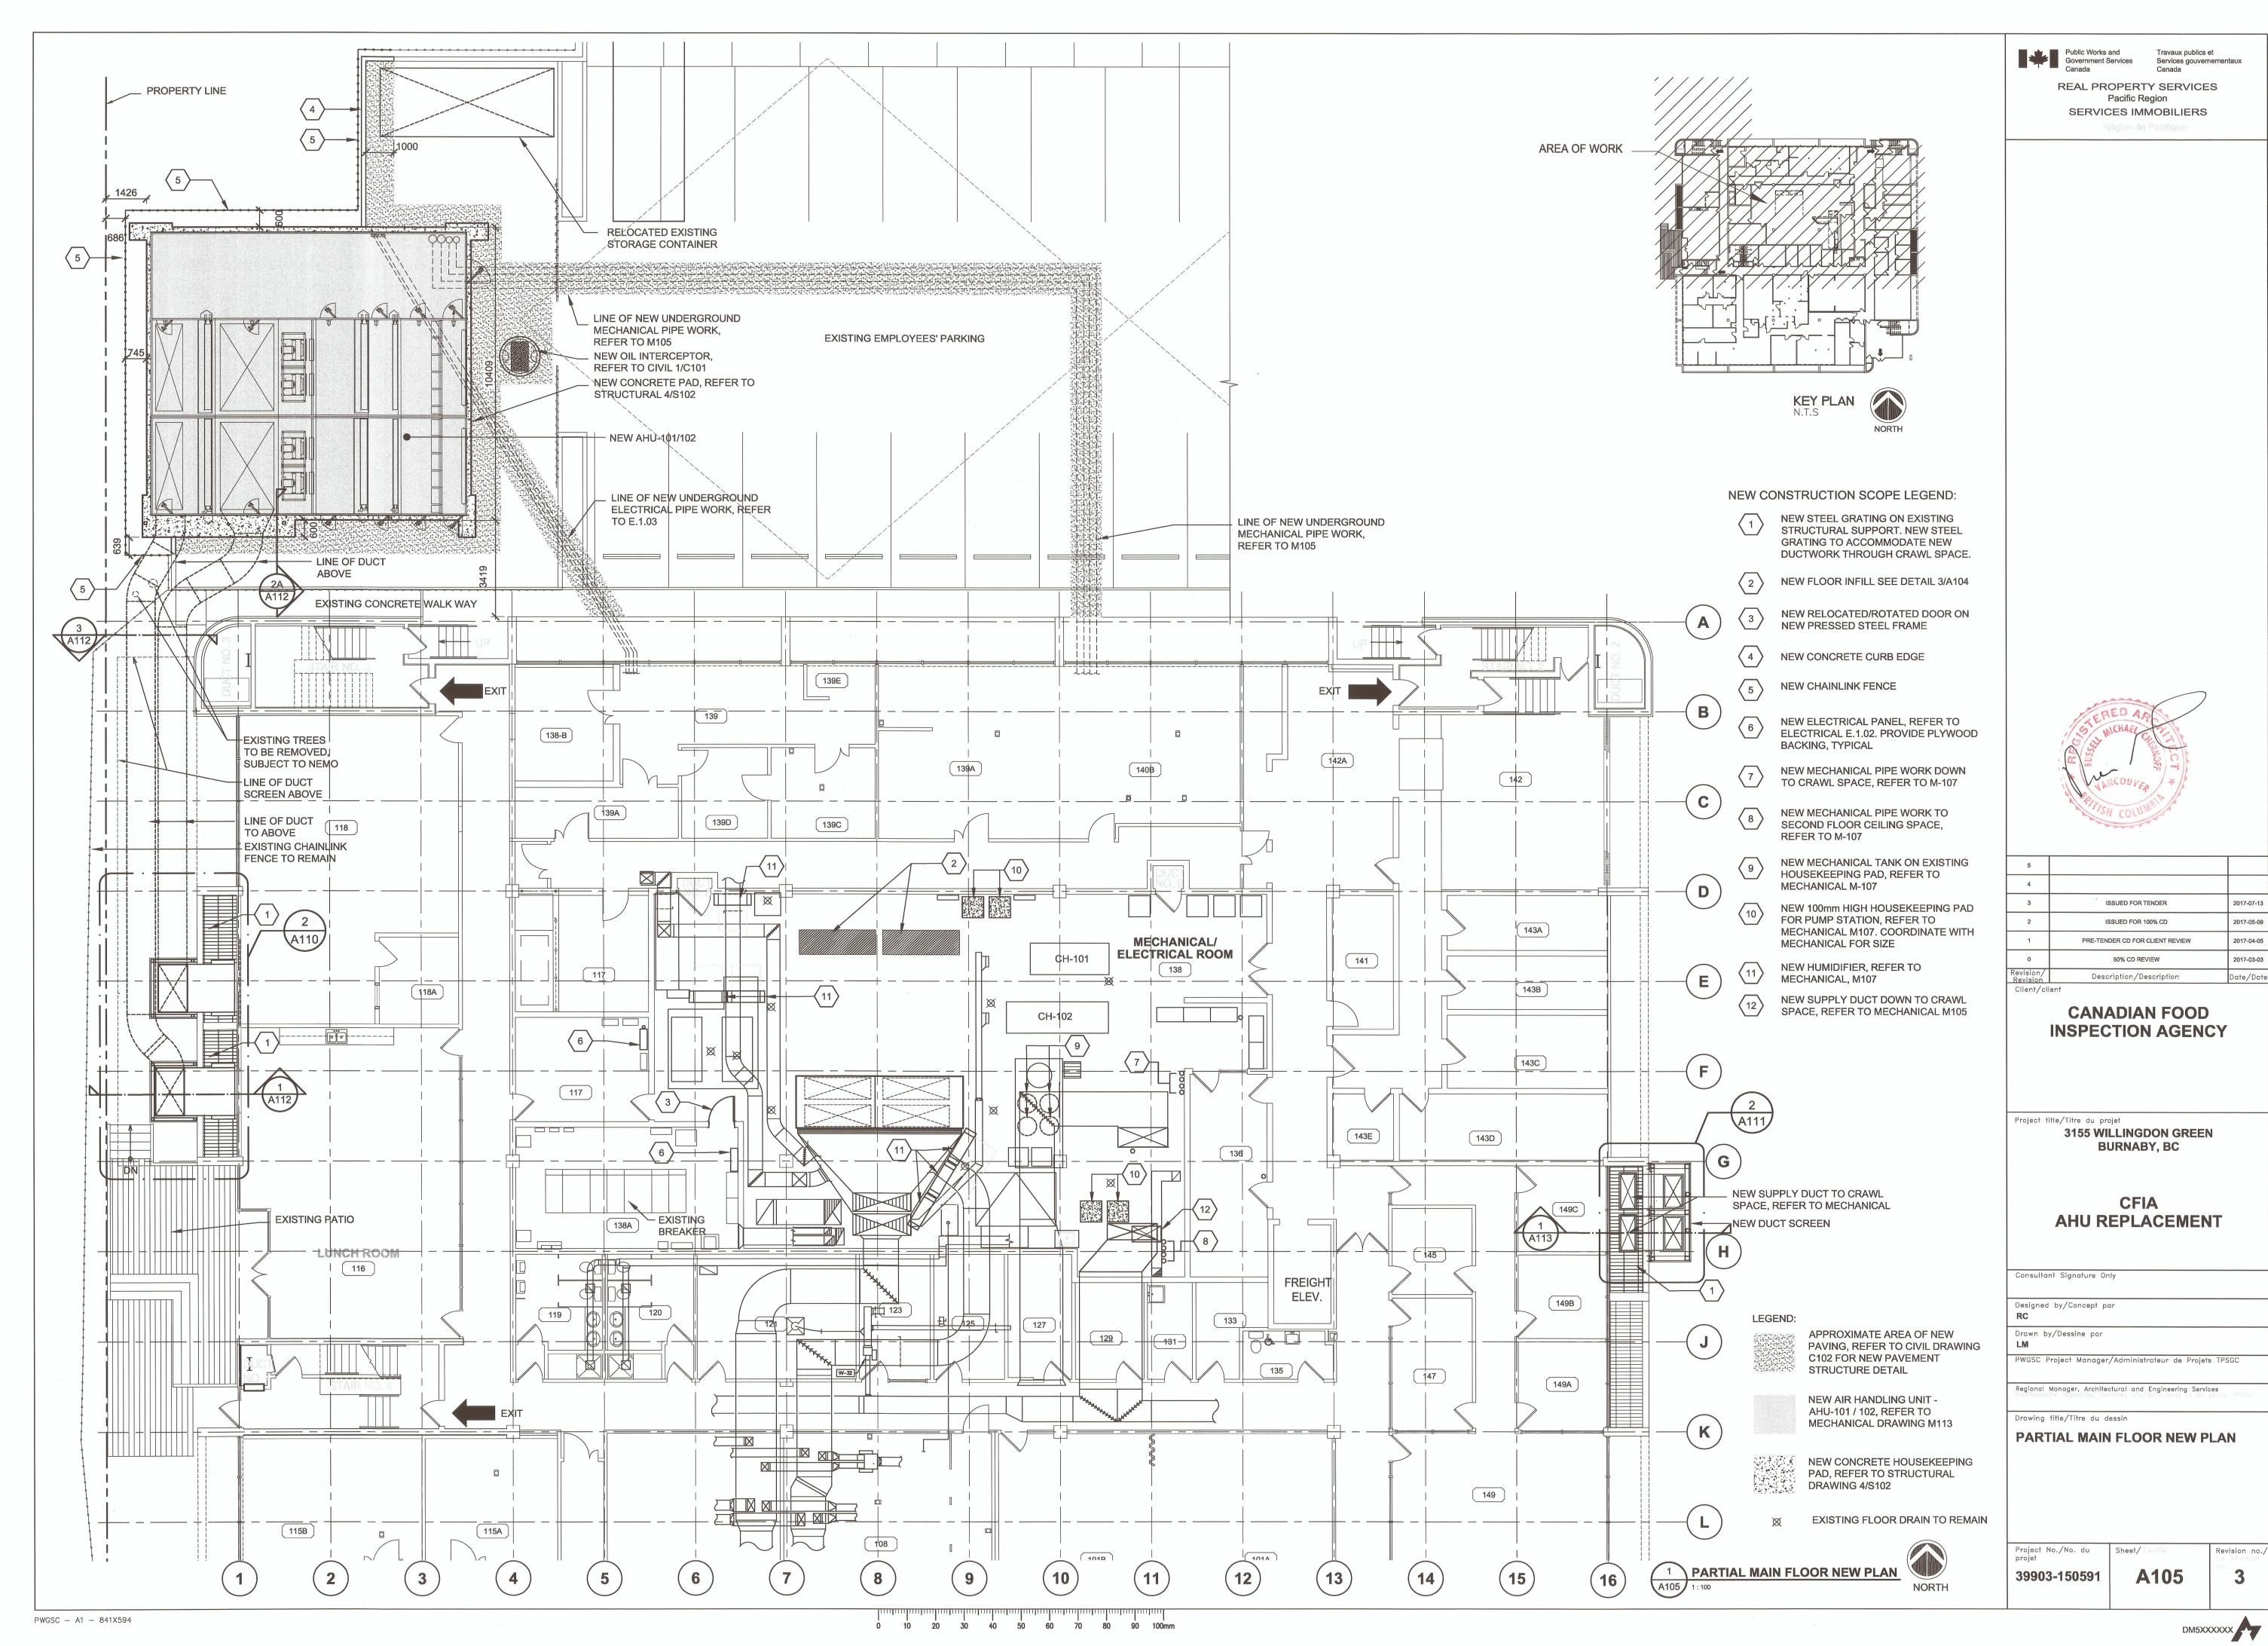

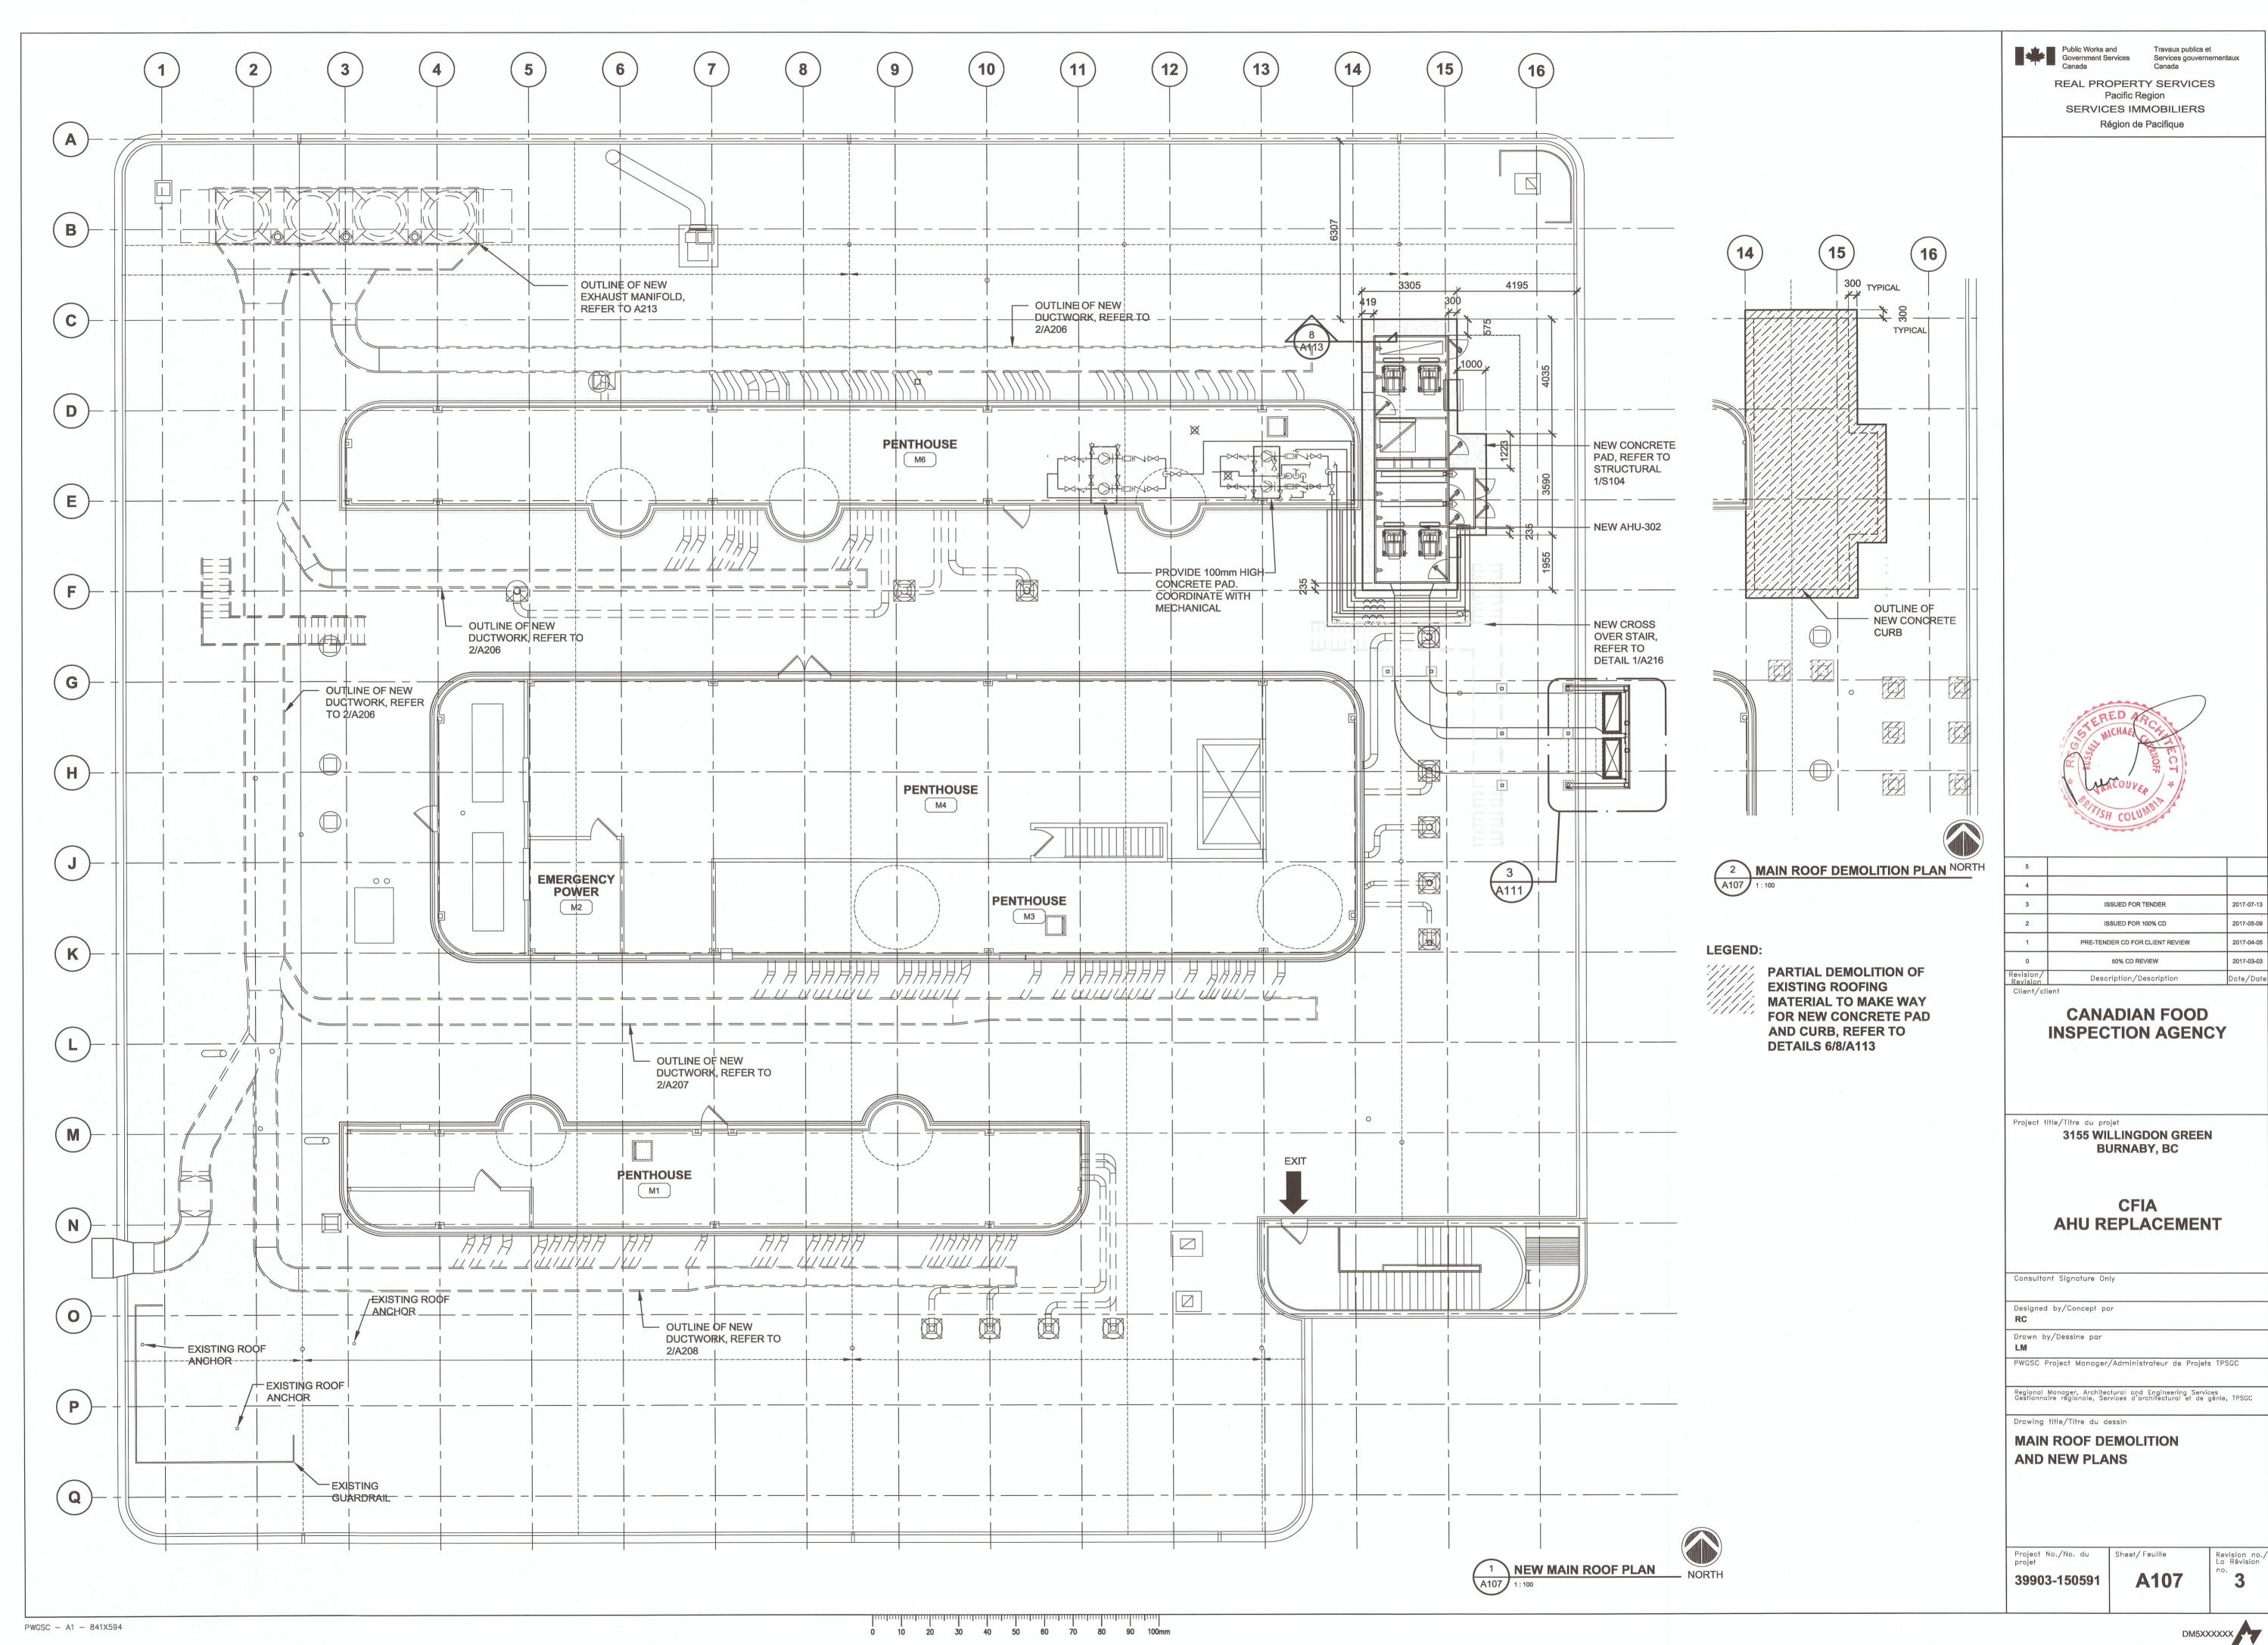

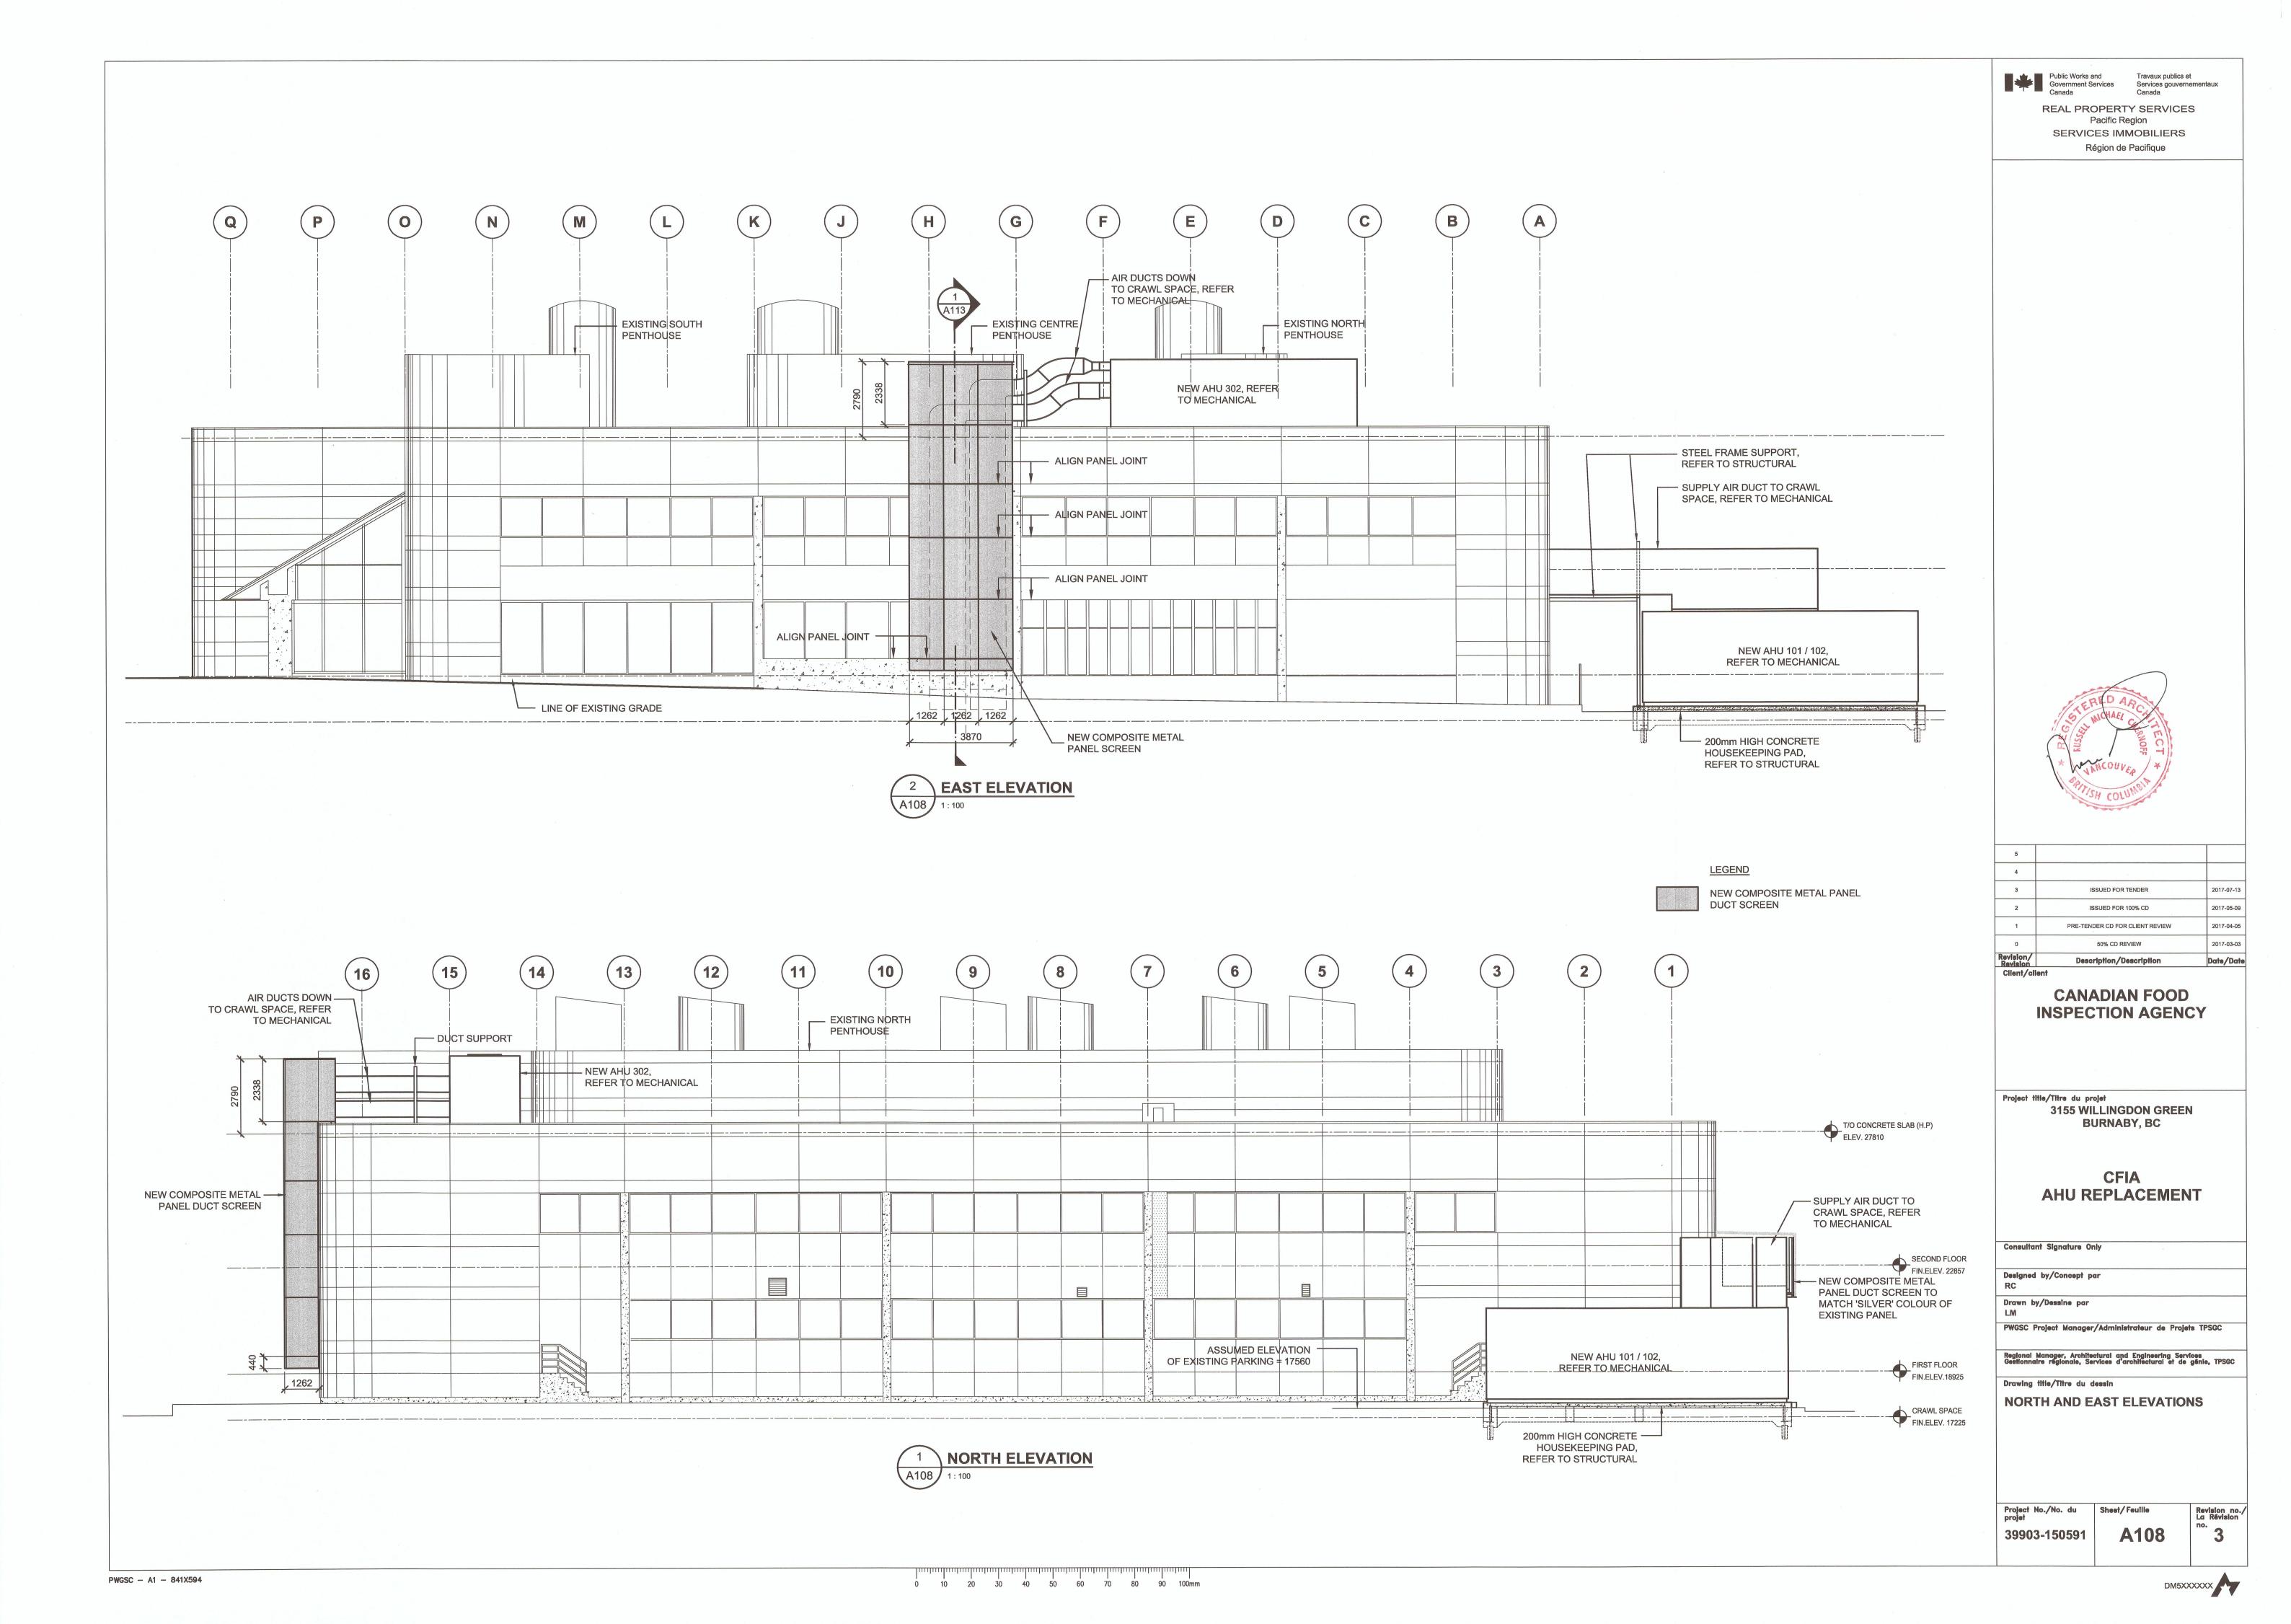

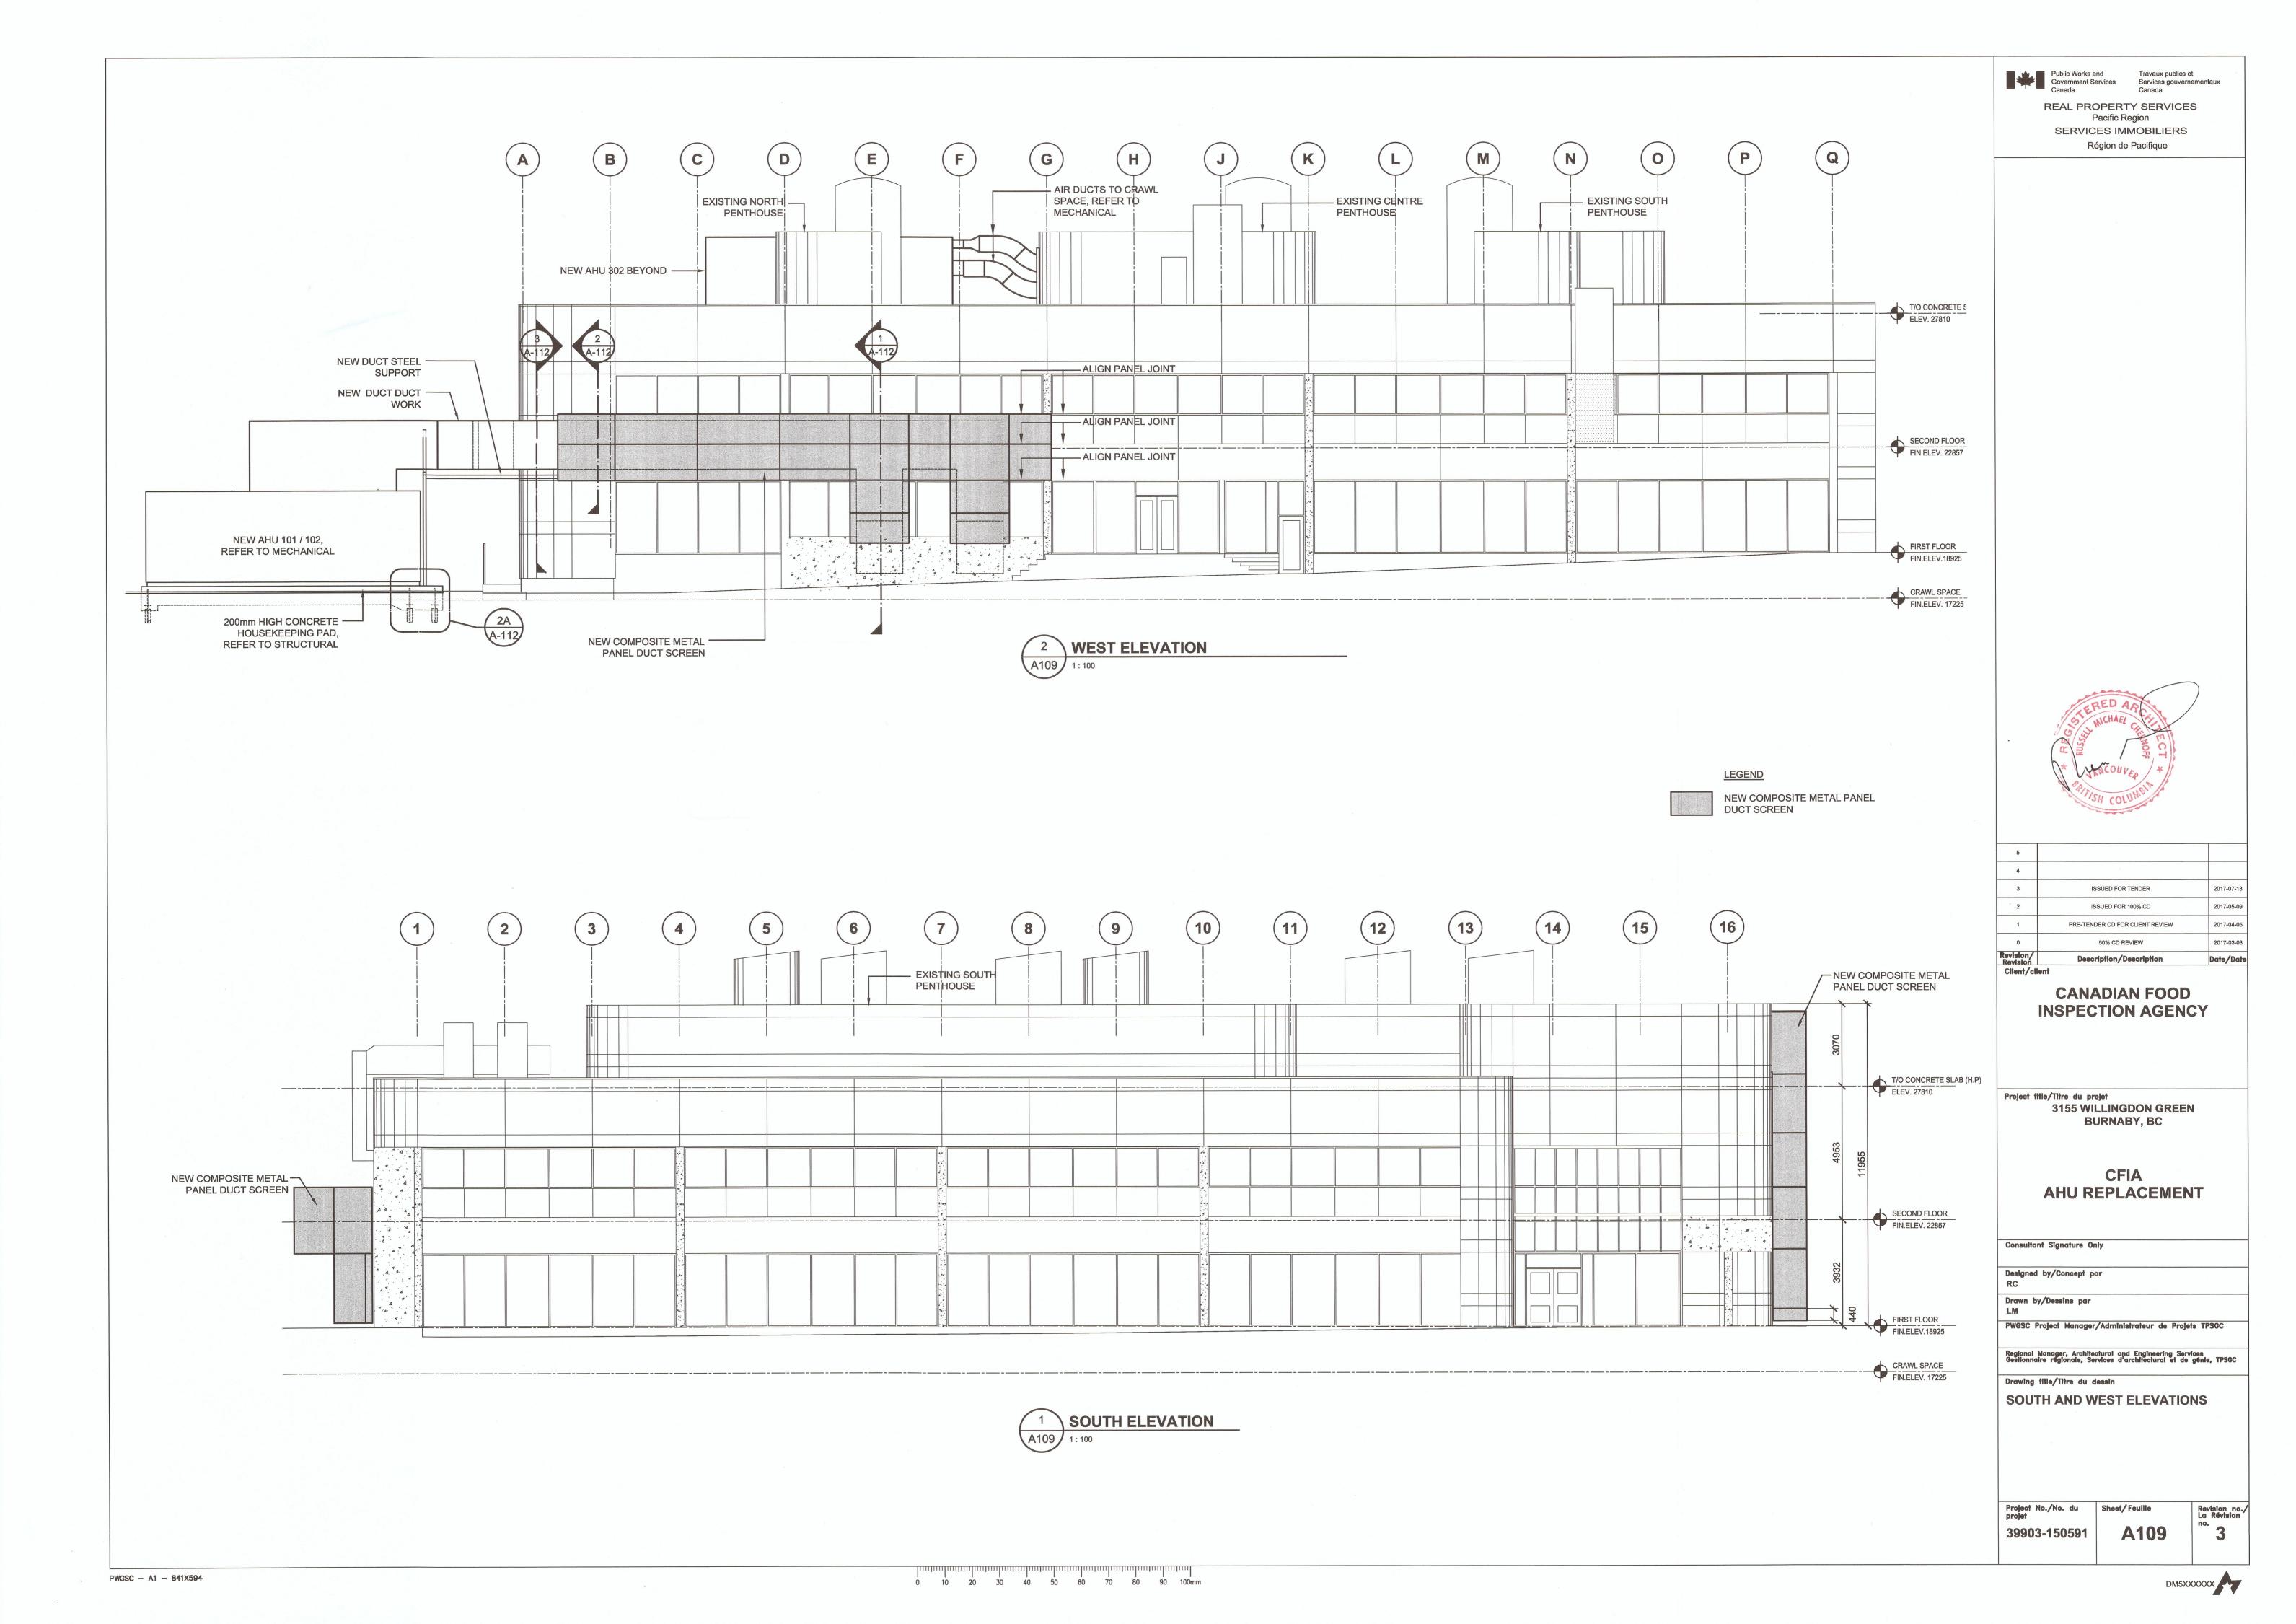

**EXISTING** 

CONCRETE

EXISTING STEEL GRATING TO BE

COLUMN

REMOVED

APPLY FILM ON EXISTING

WINDOW, TYPICAL TO ALL

WINDOWS INFRONT OF

LINE OF DUCT DOWN TO EXISTING AIR

NEW DUCT/SCREEN

EX. ALUMINIUM


CLADDING BAND?


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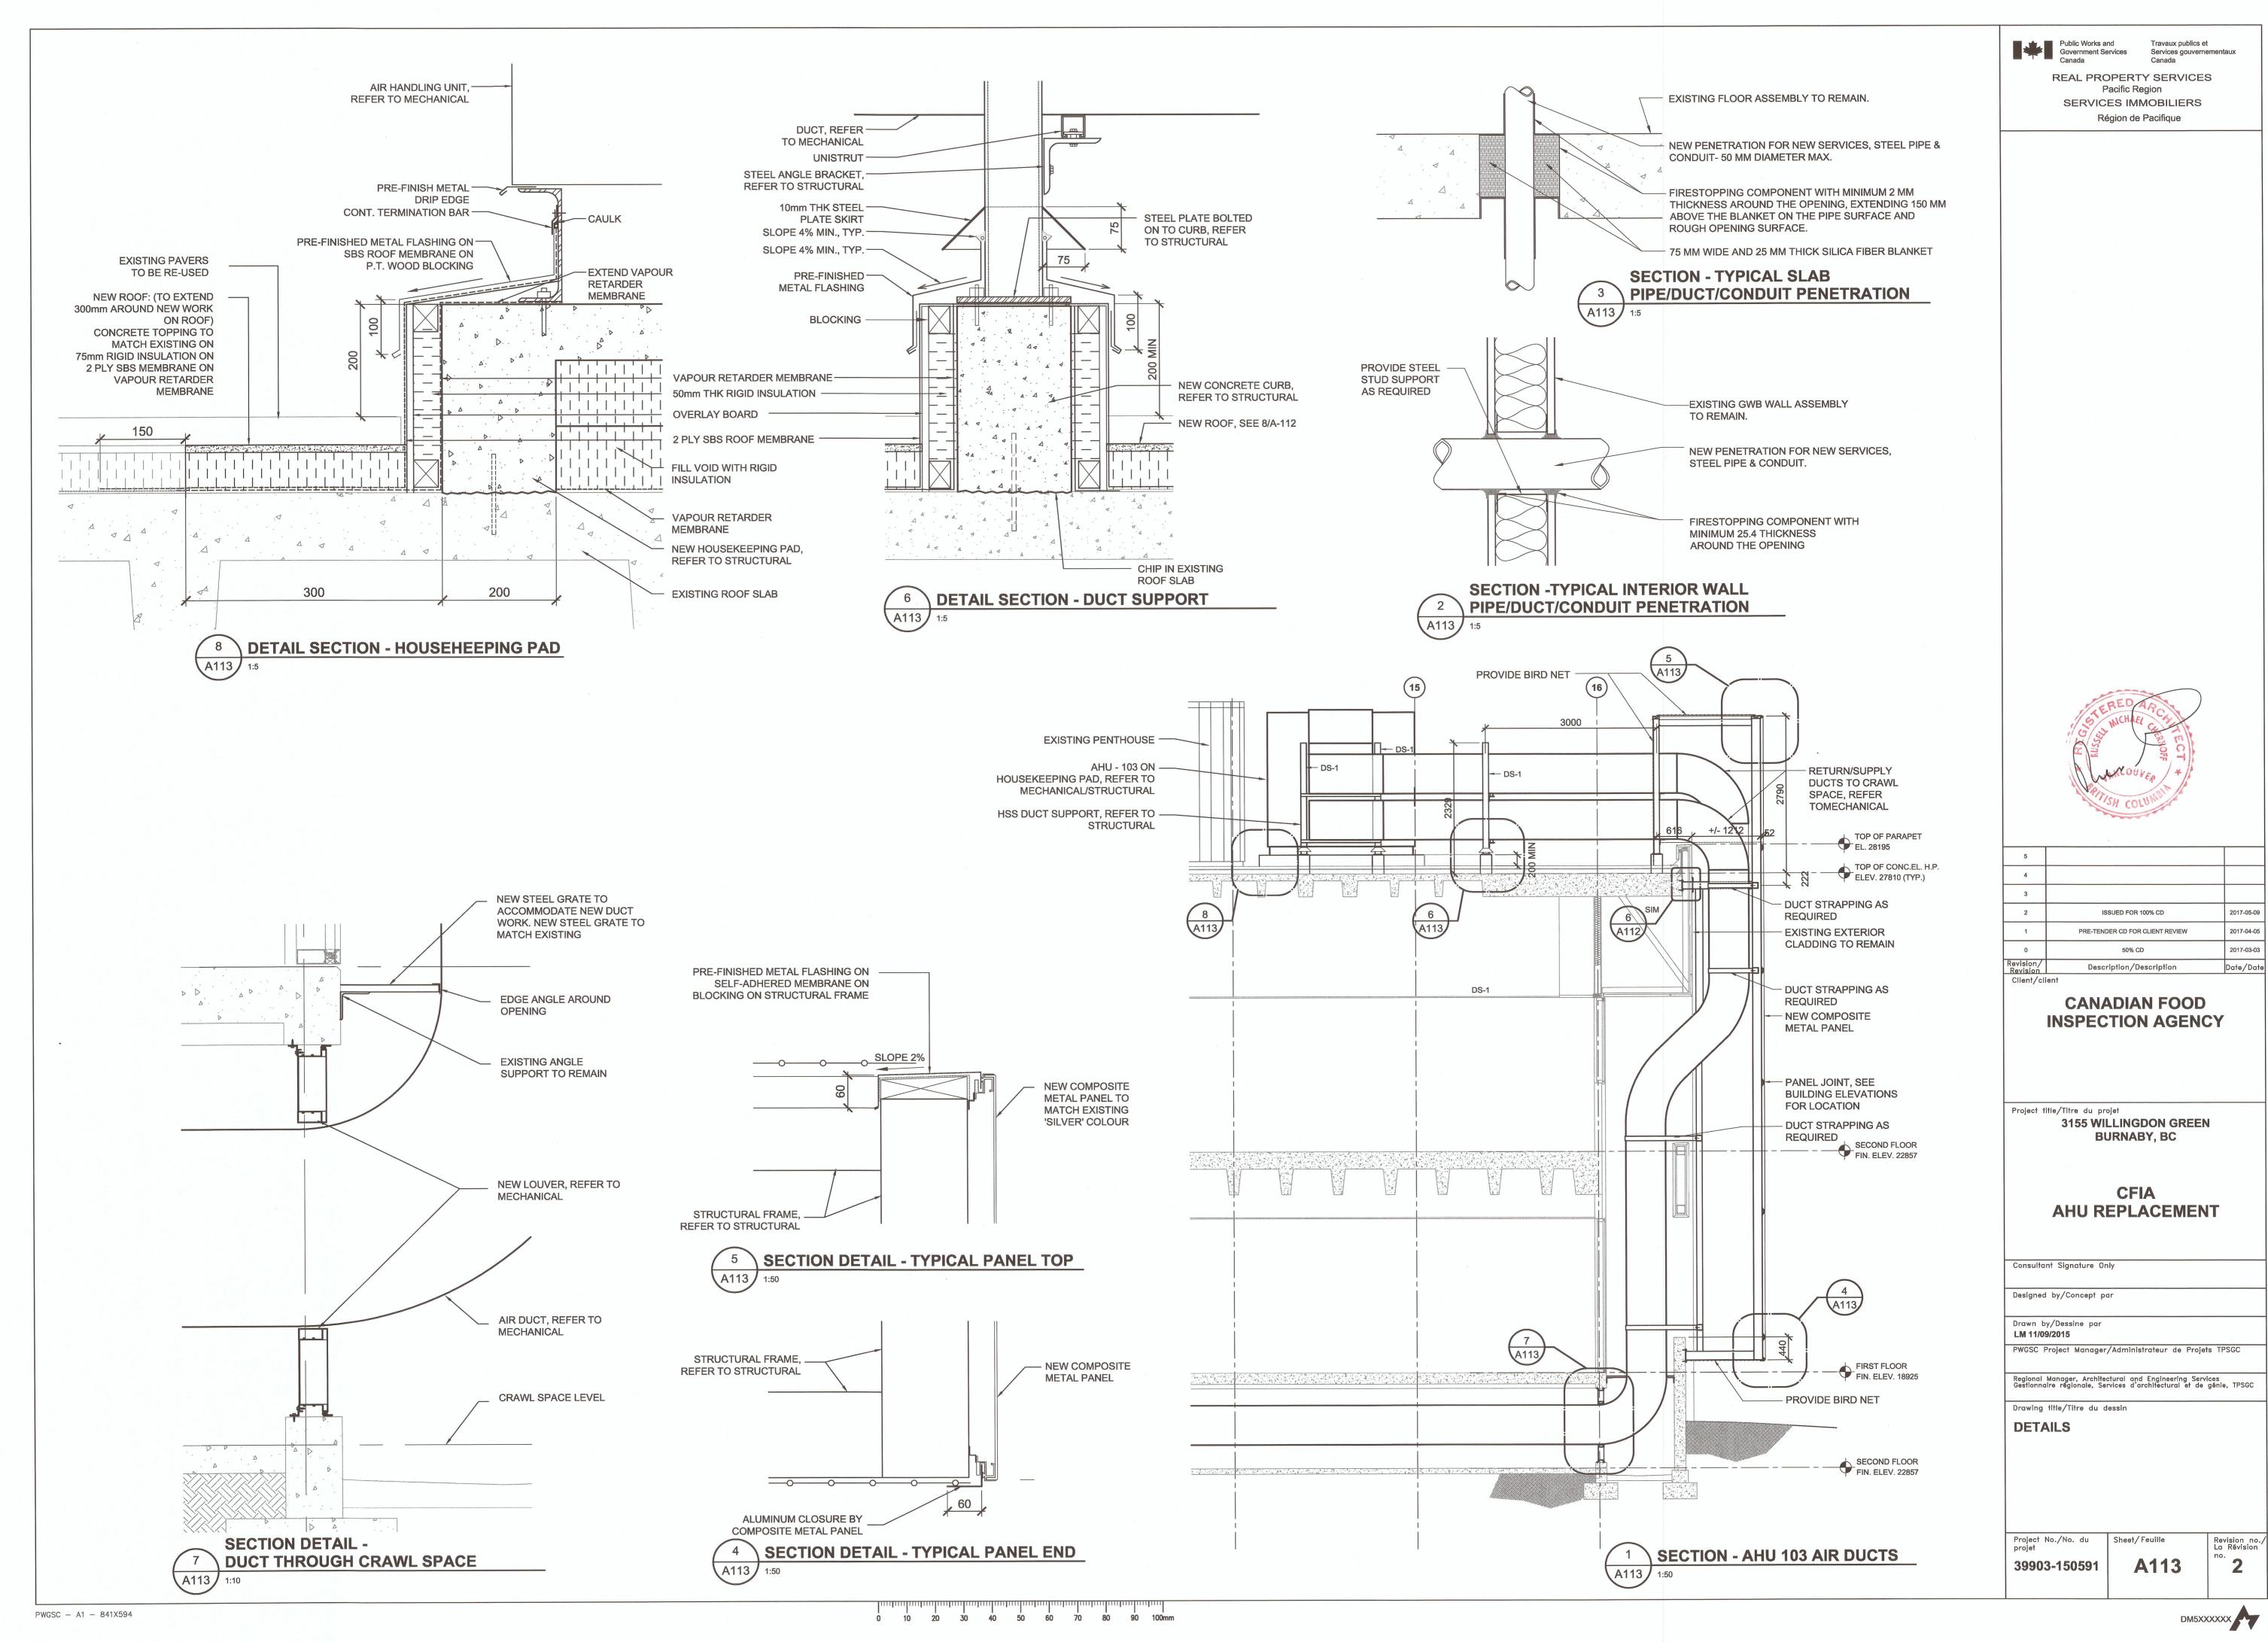
Public Works and
Government Services
Canada


Canada


Travaux publics et
Services gouvernementaux
Canada REAL PROPERTY SERVICES Pacific Region SERVICES IMMOBILIERS Région de Pacifique




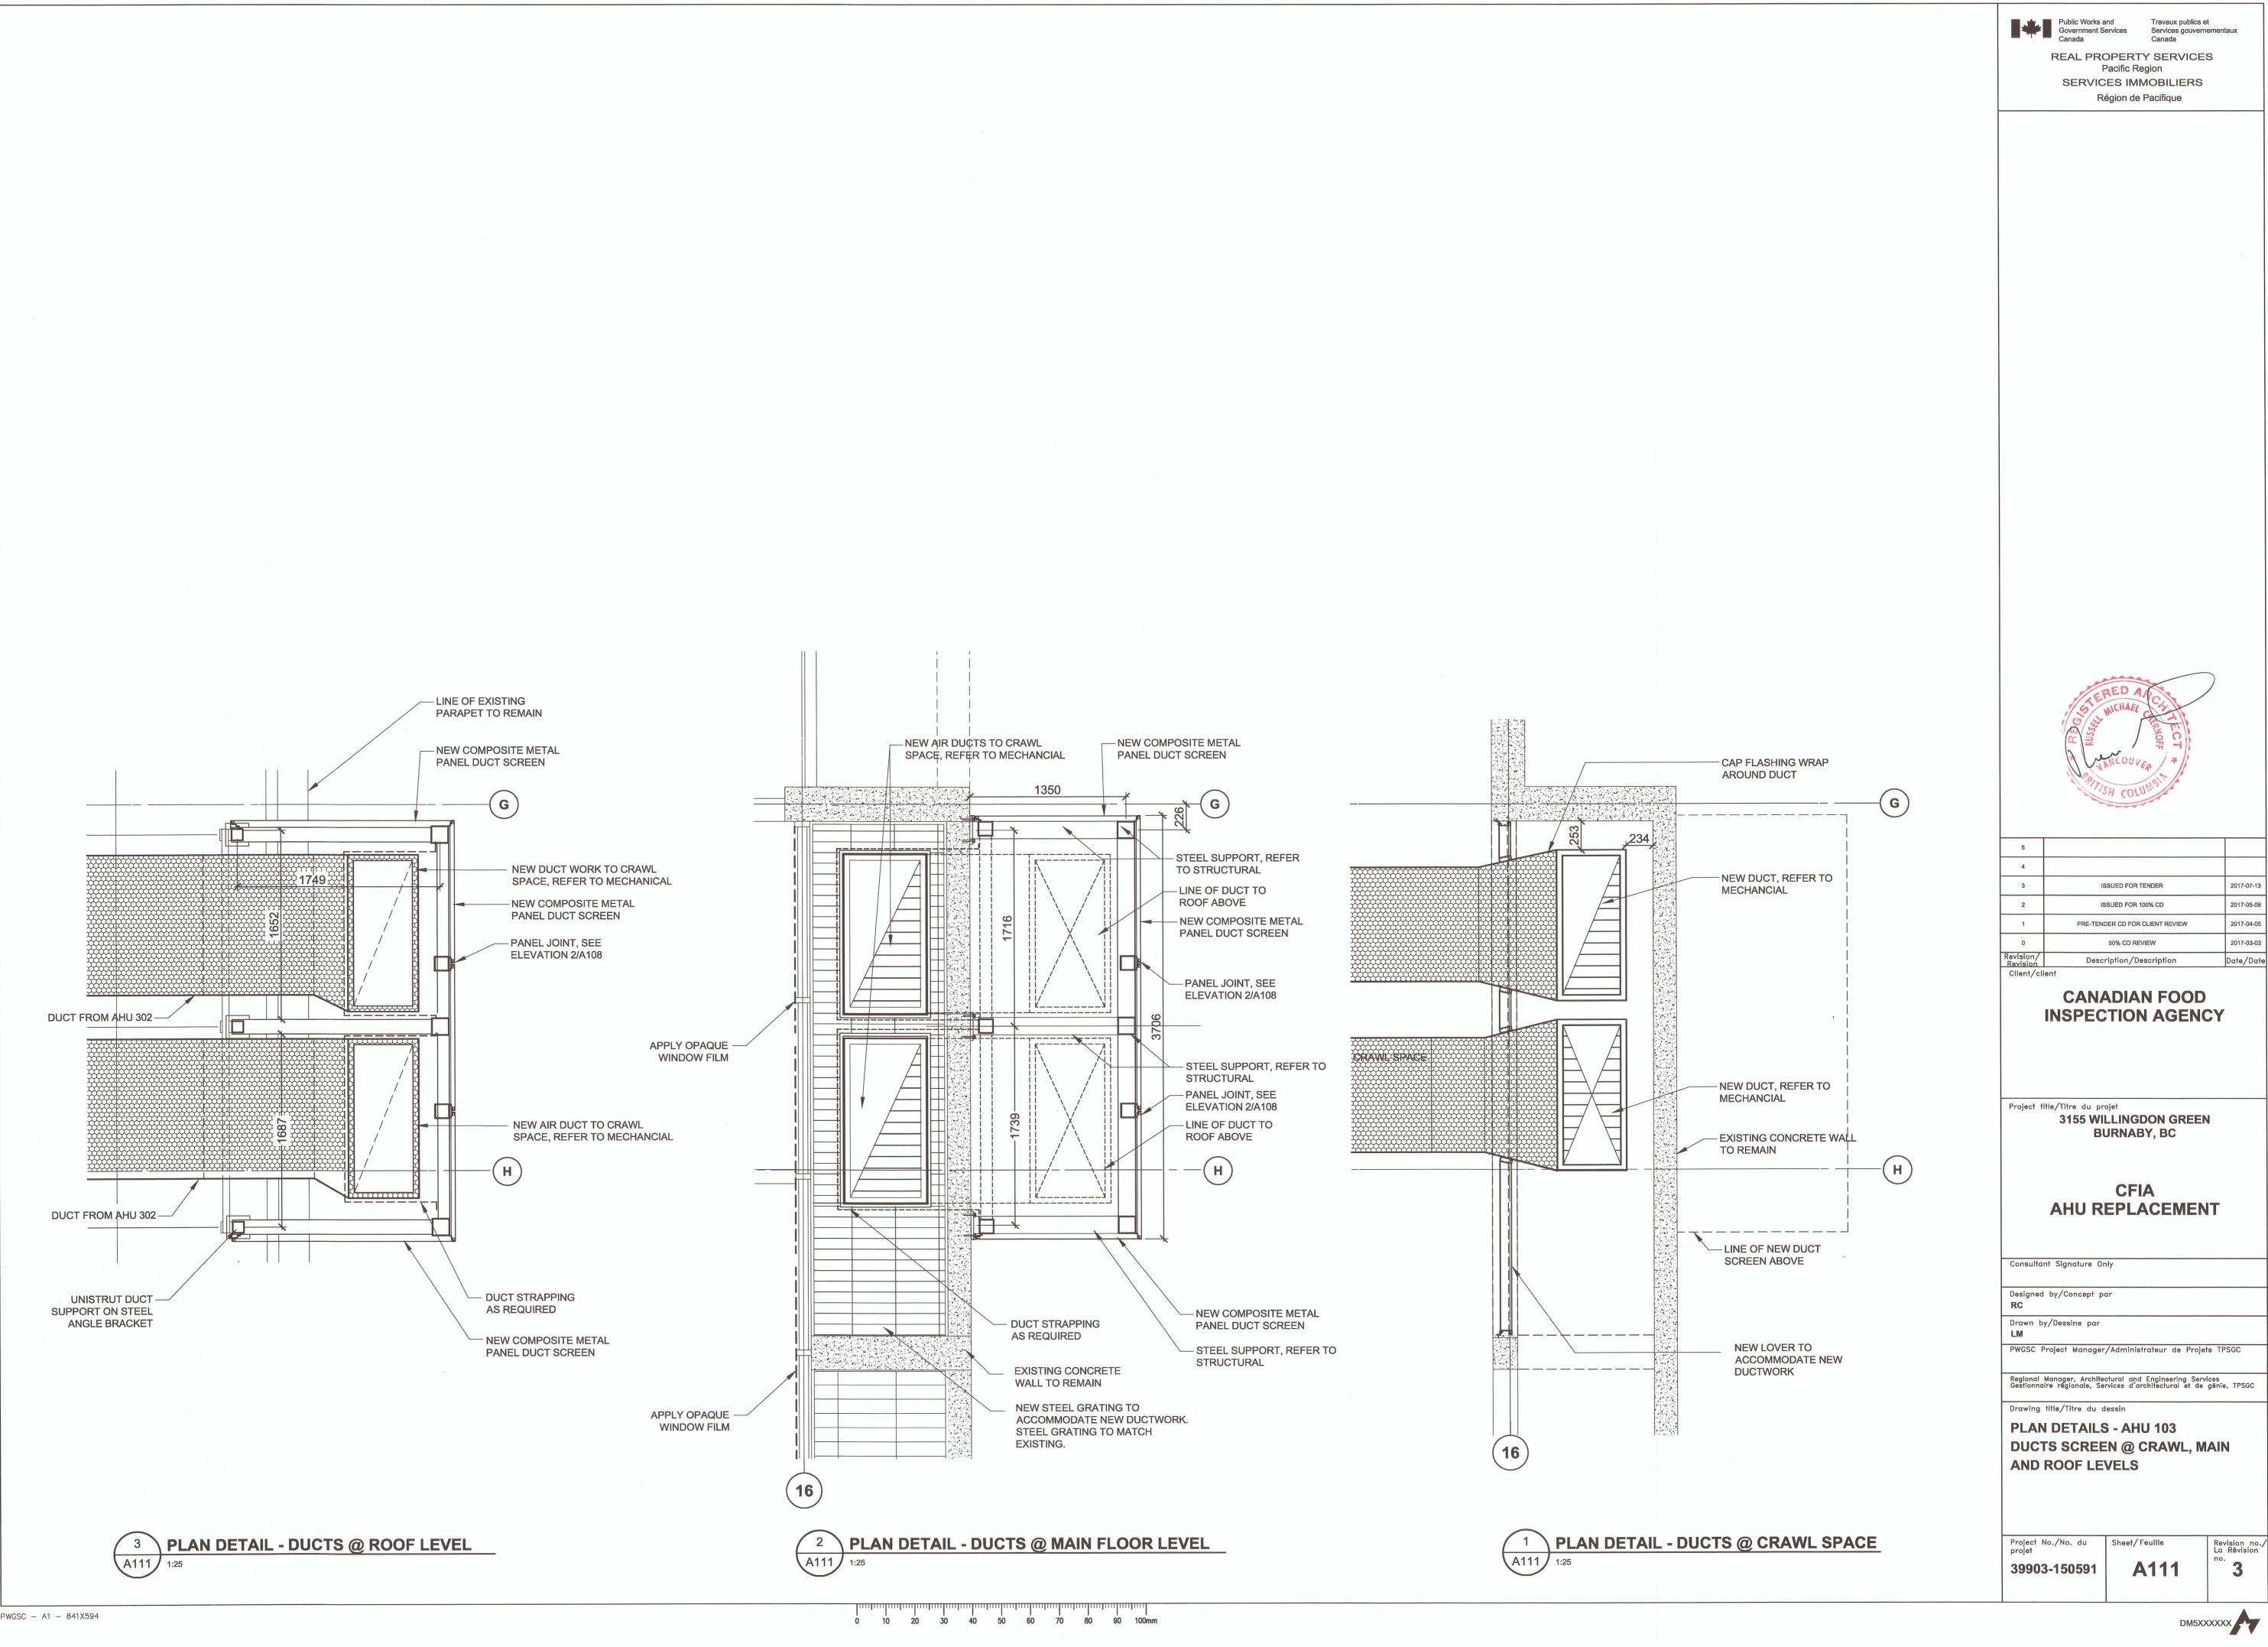


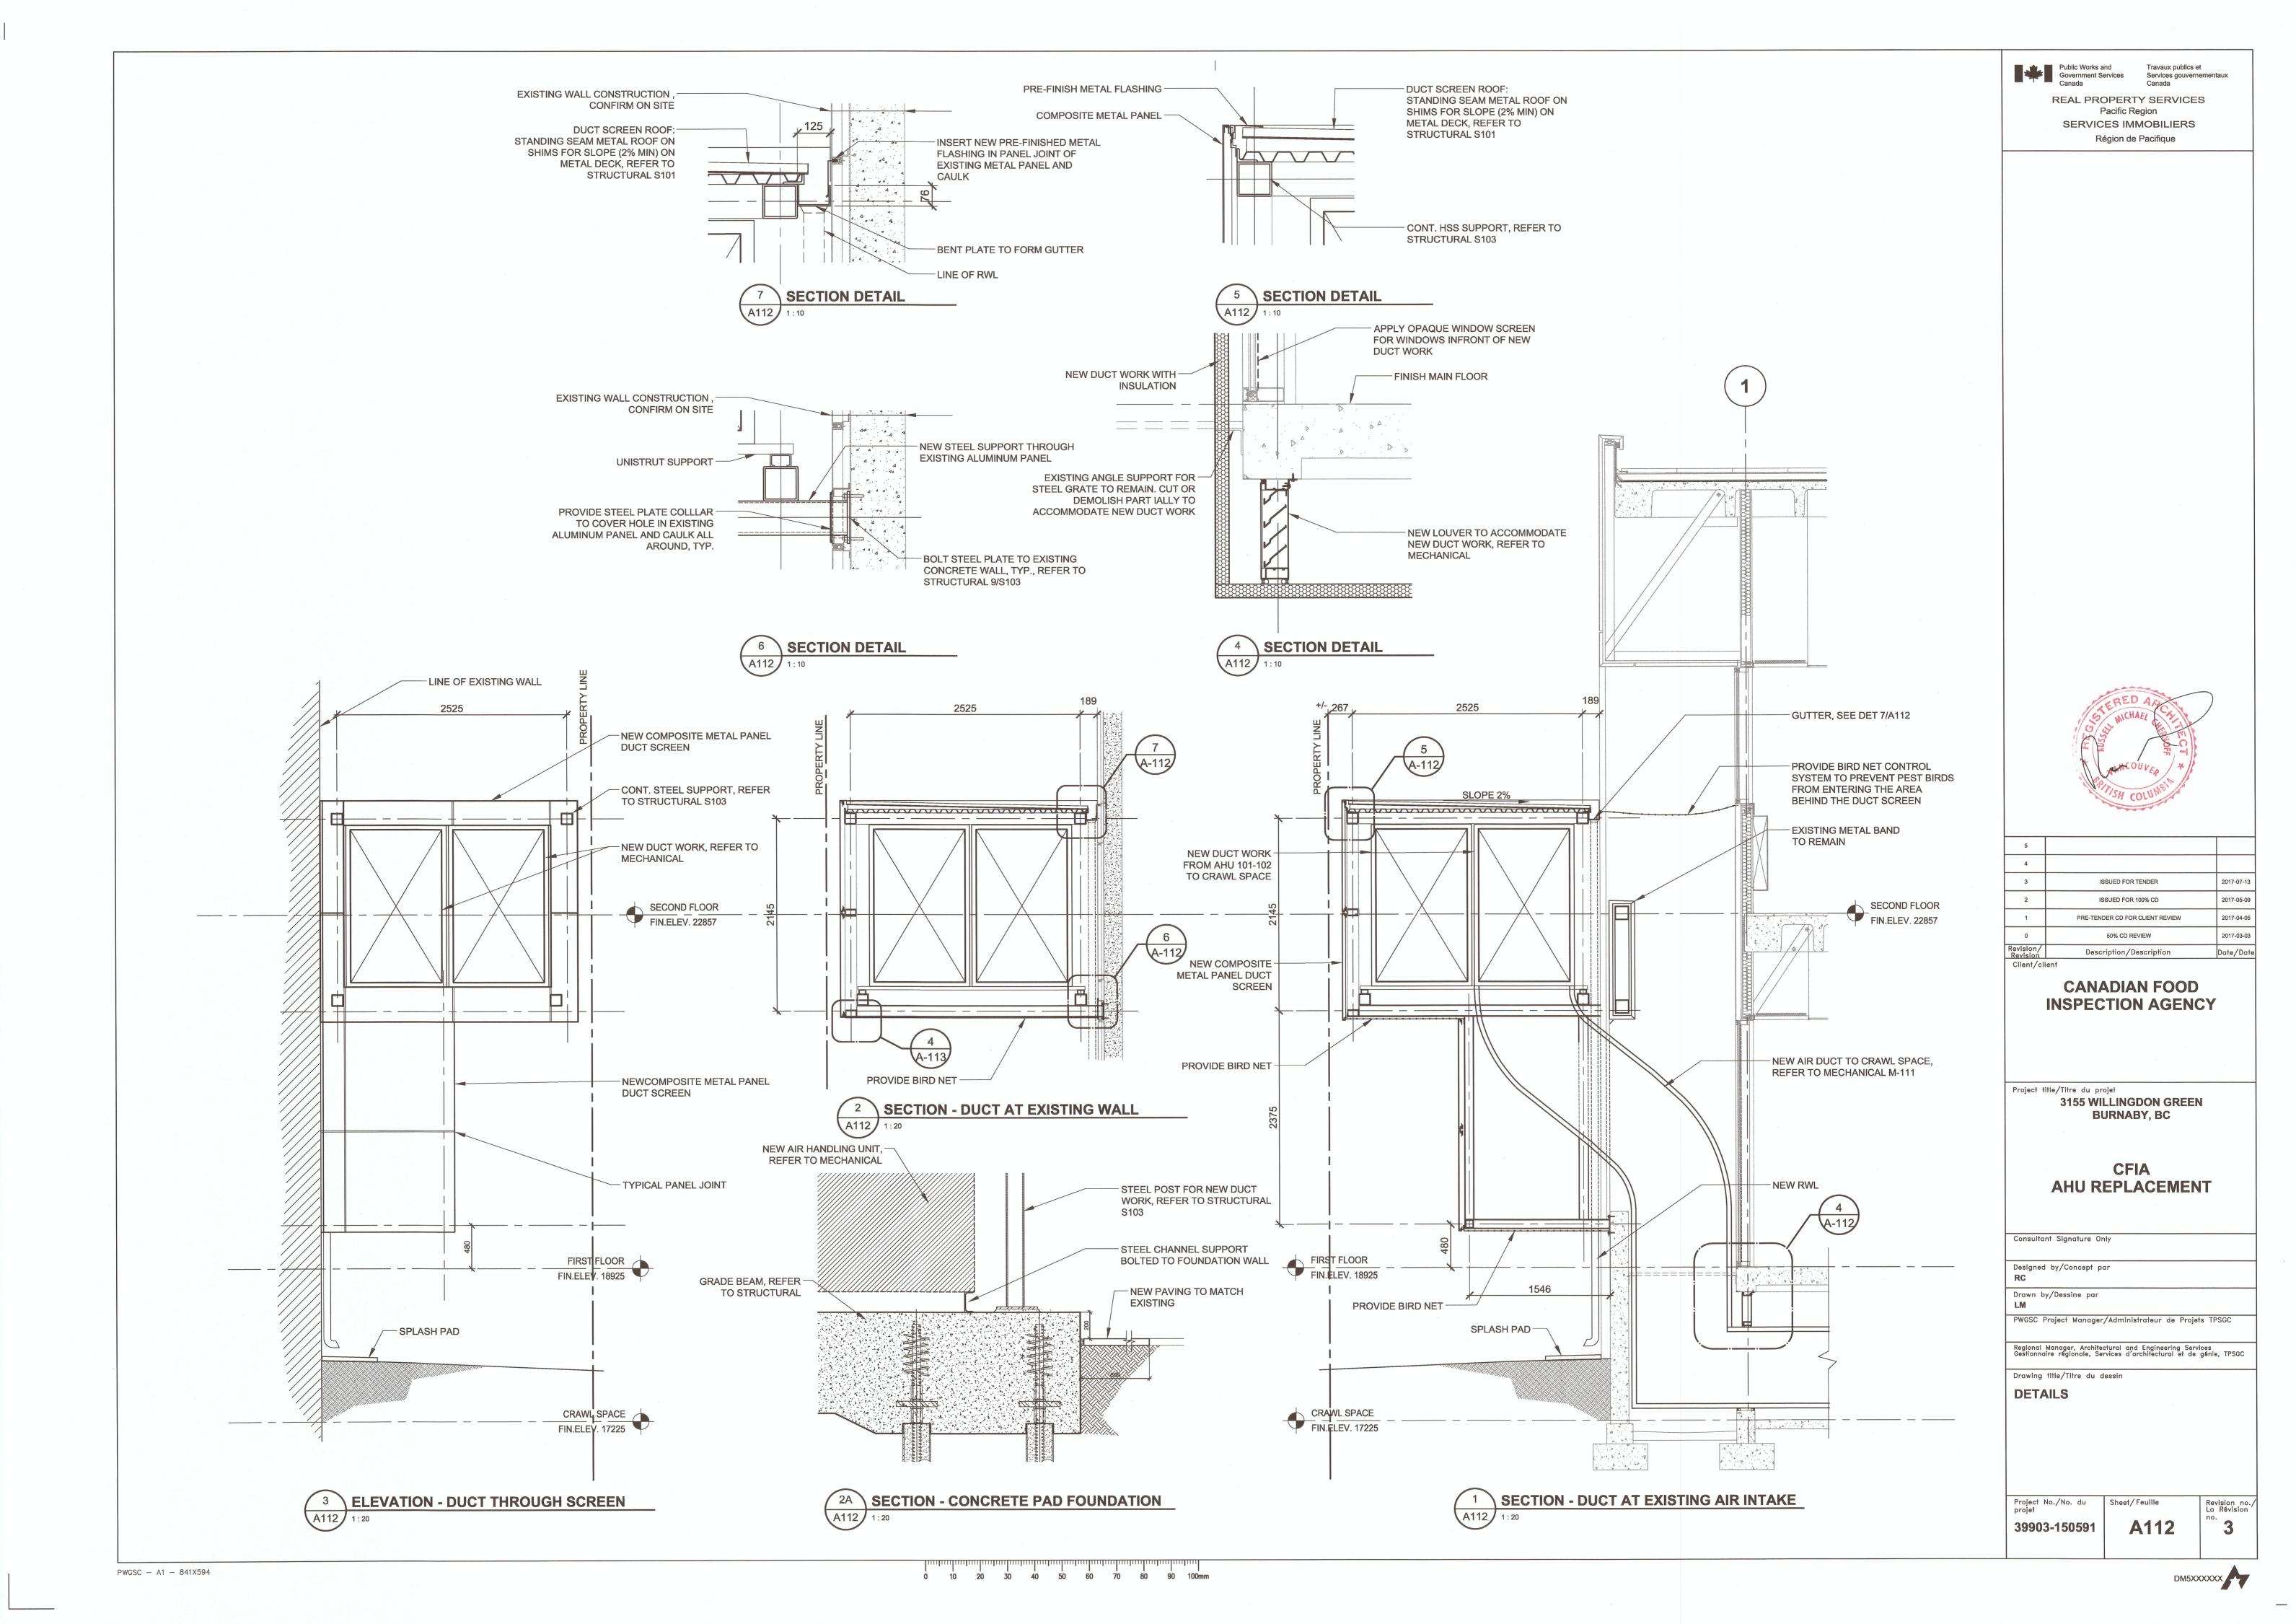


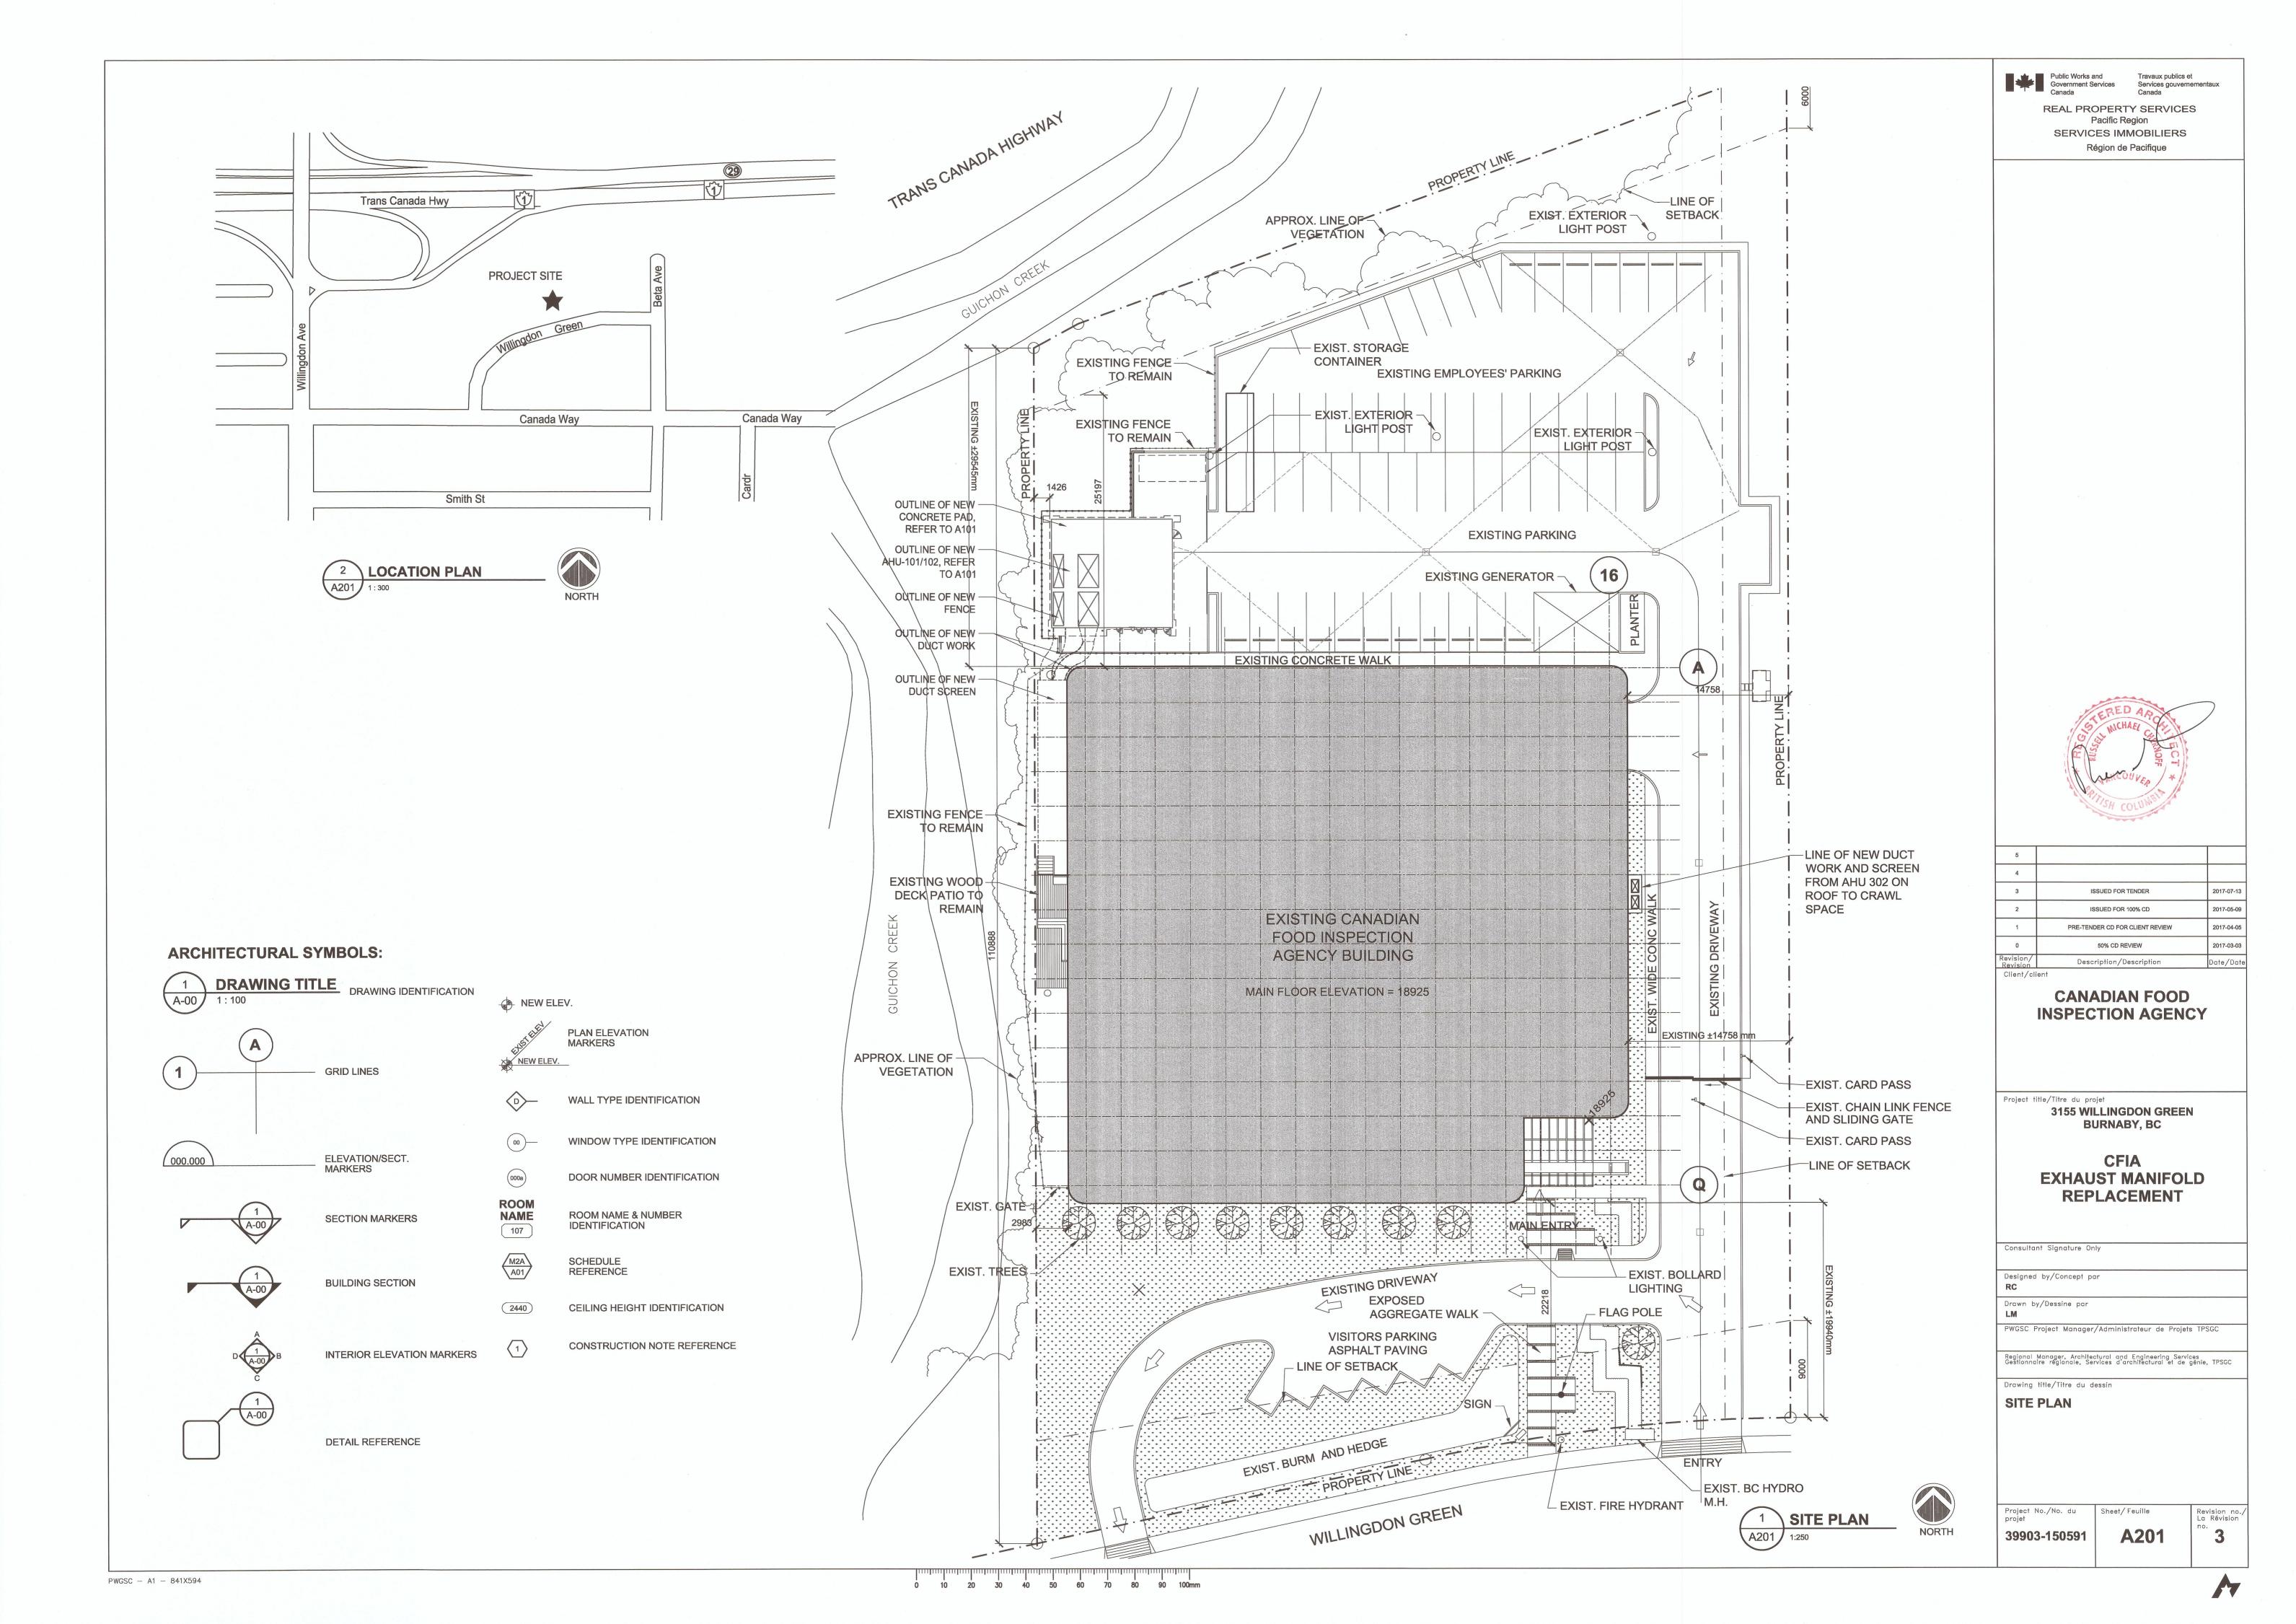


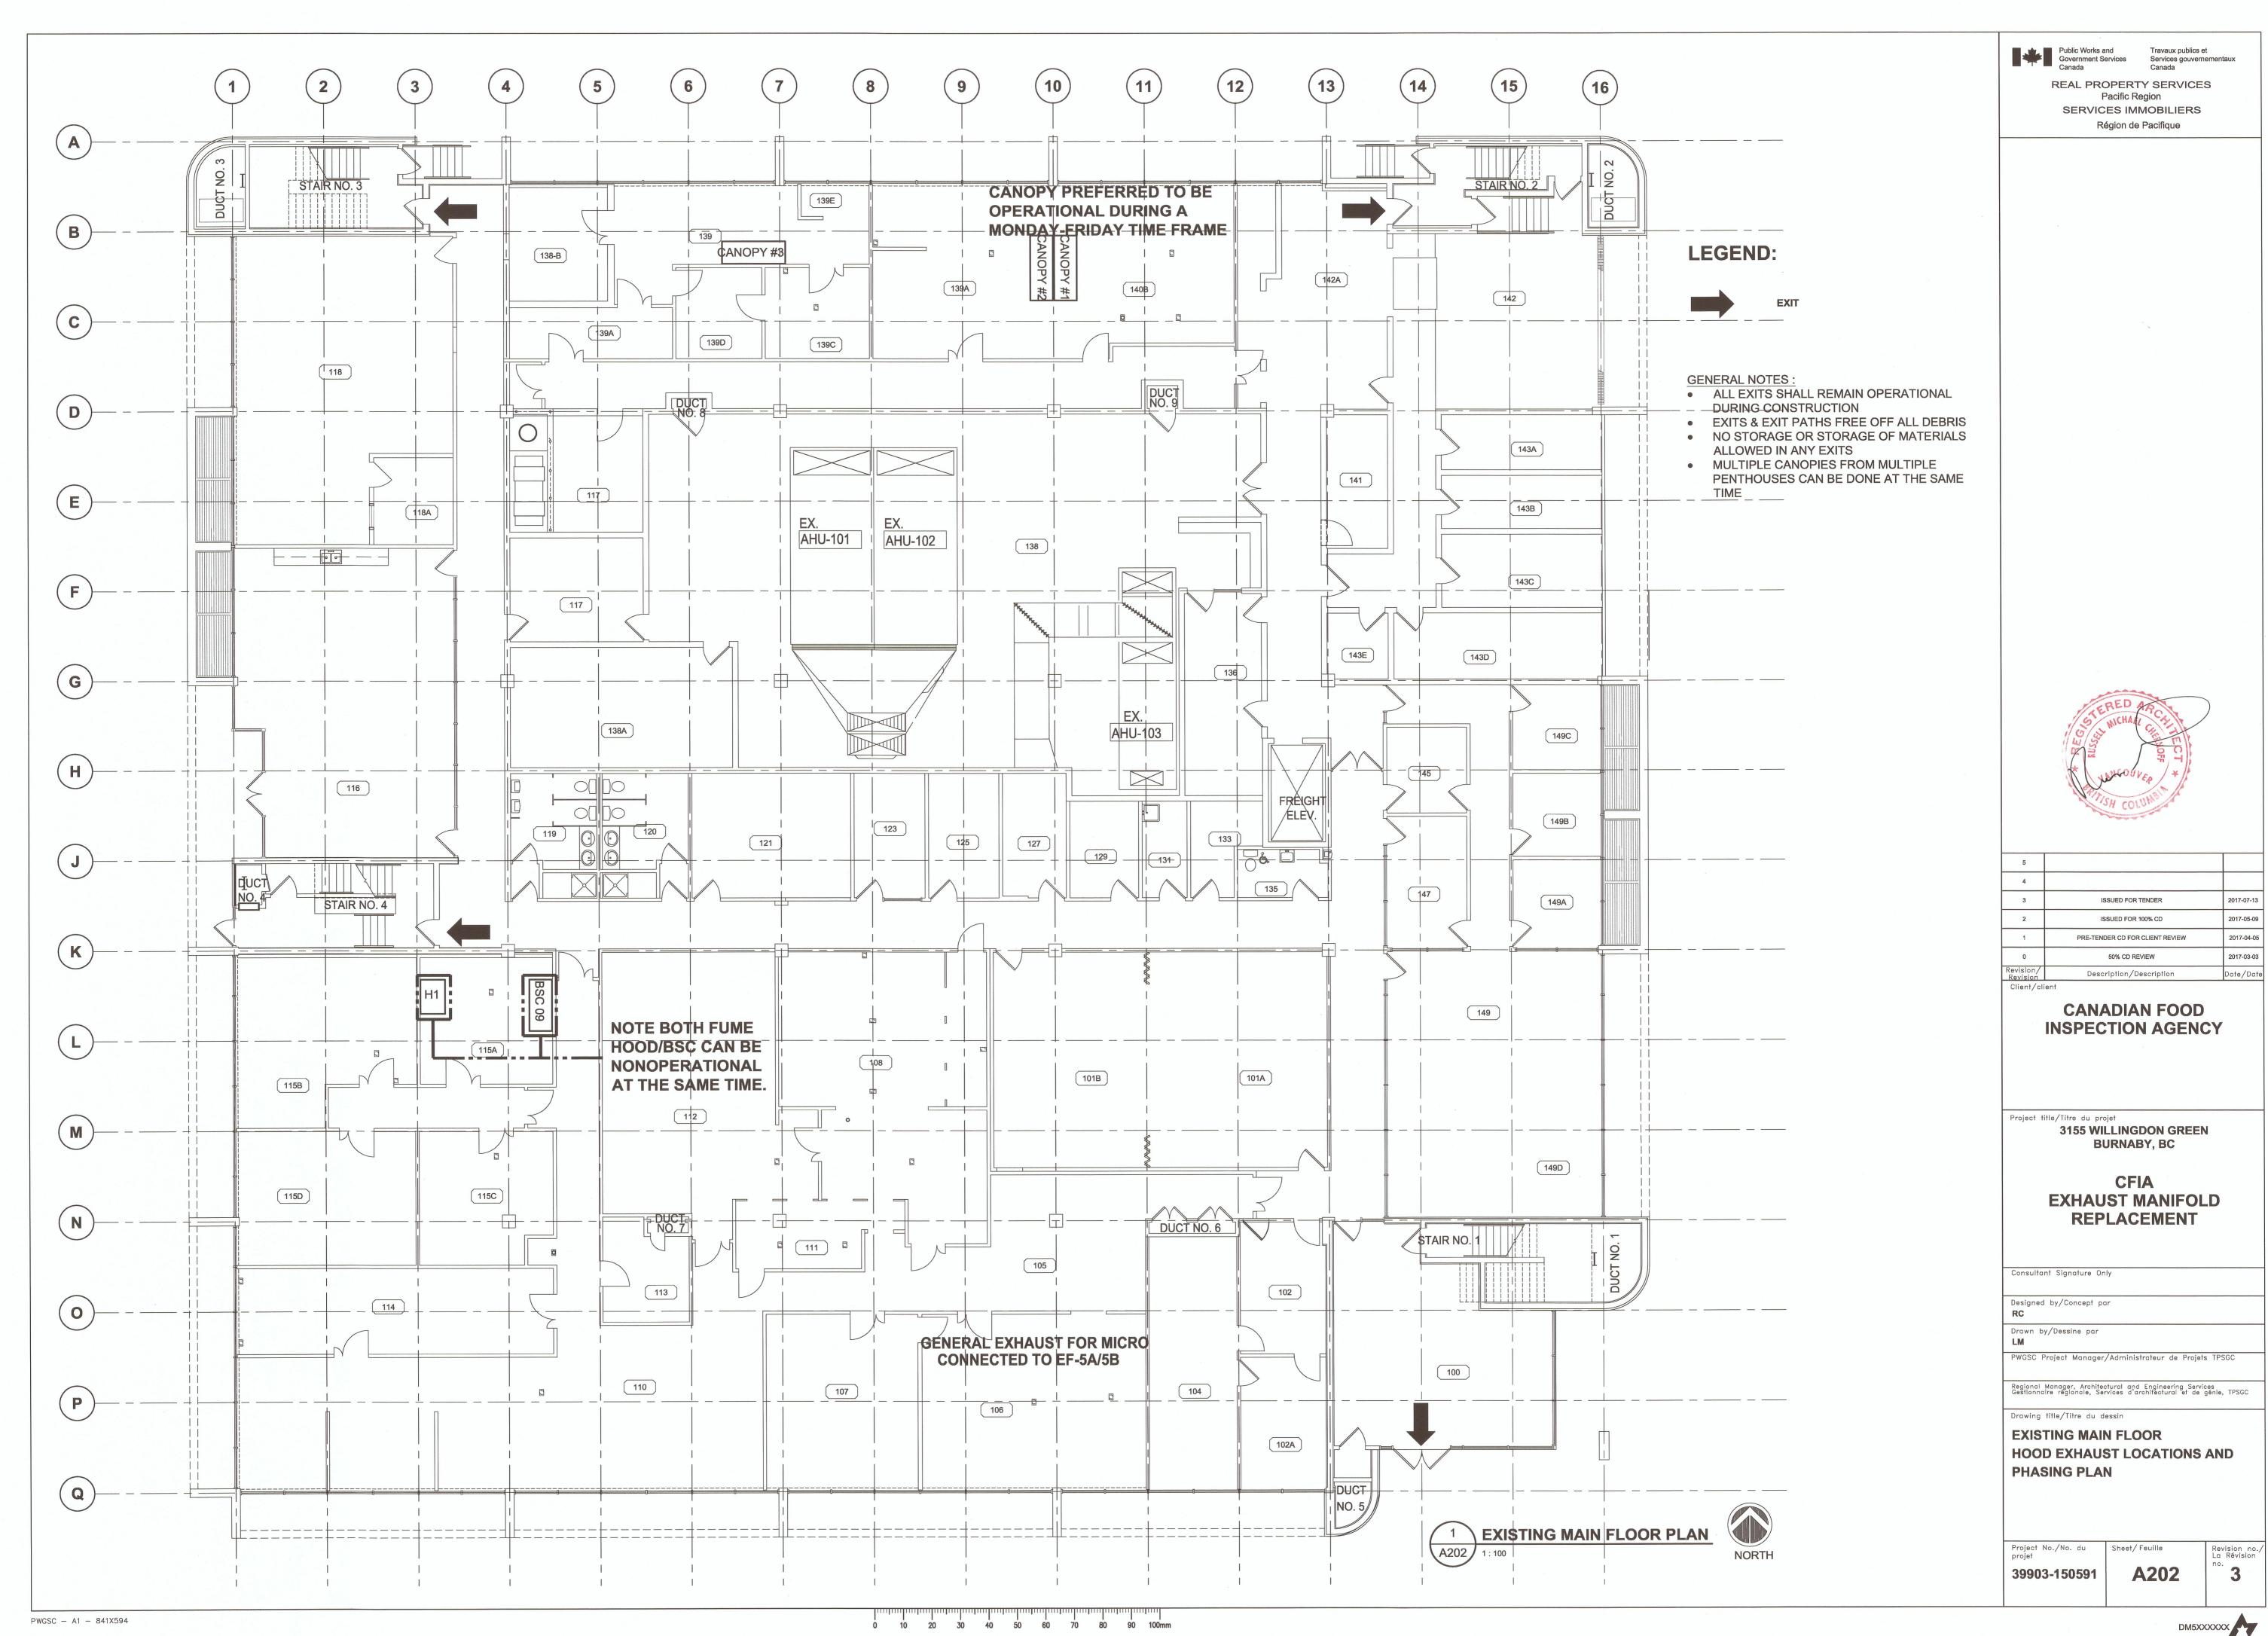

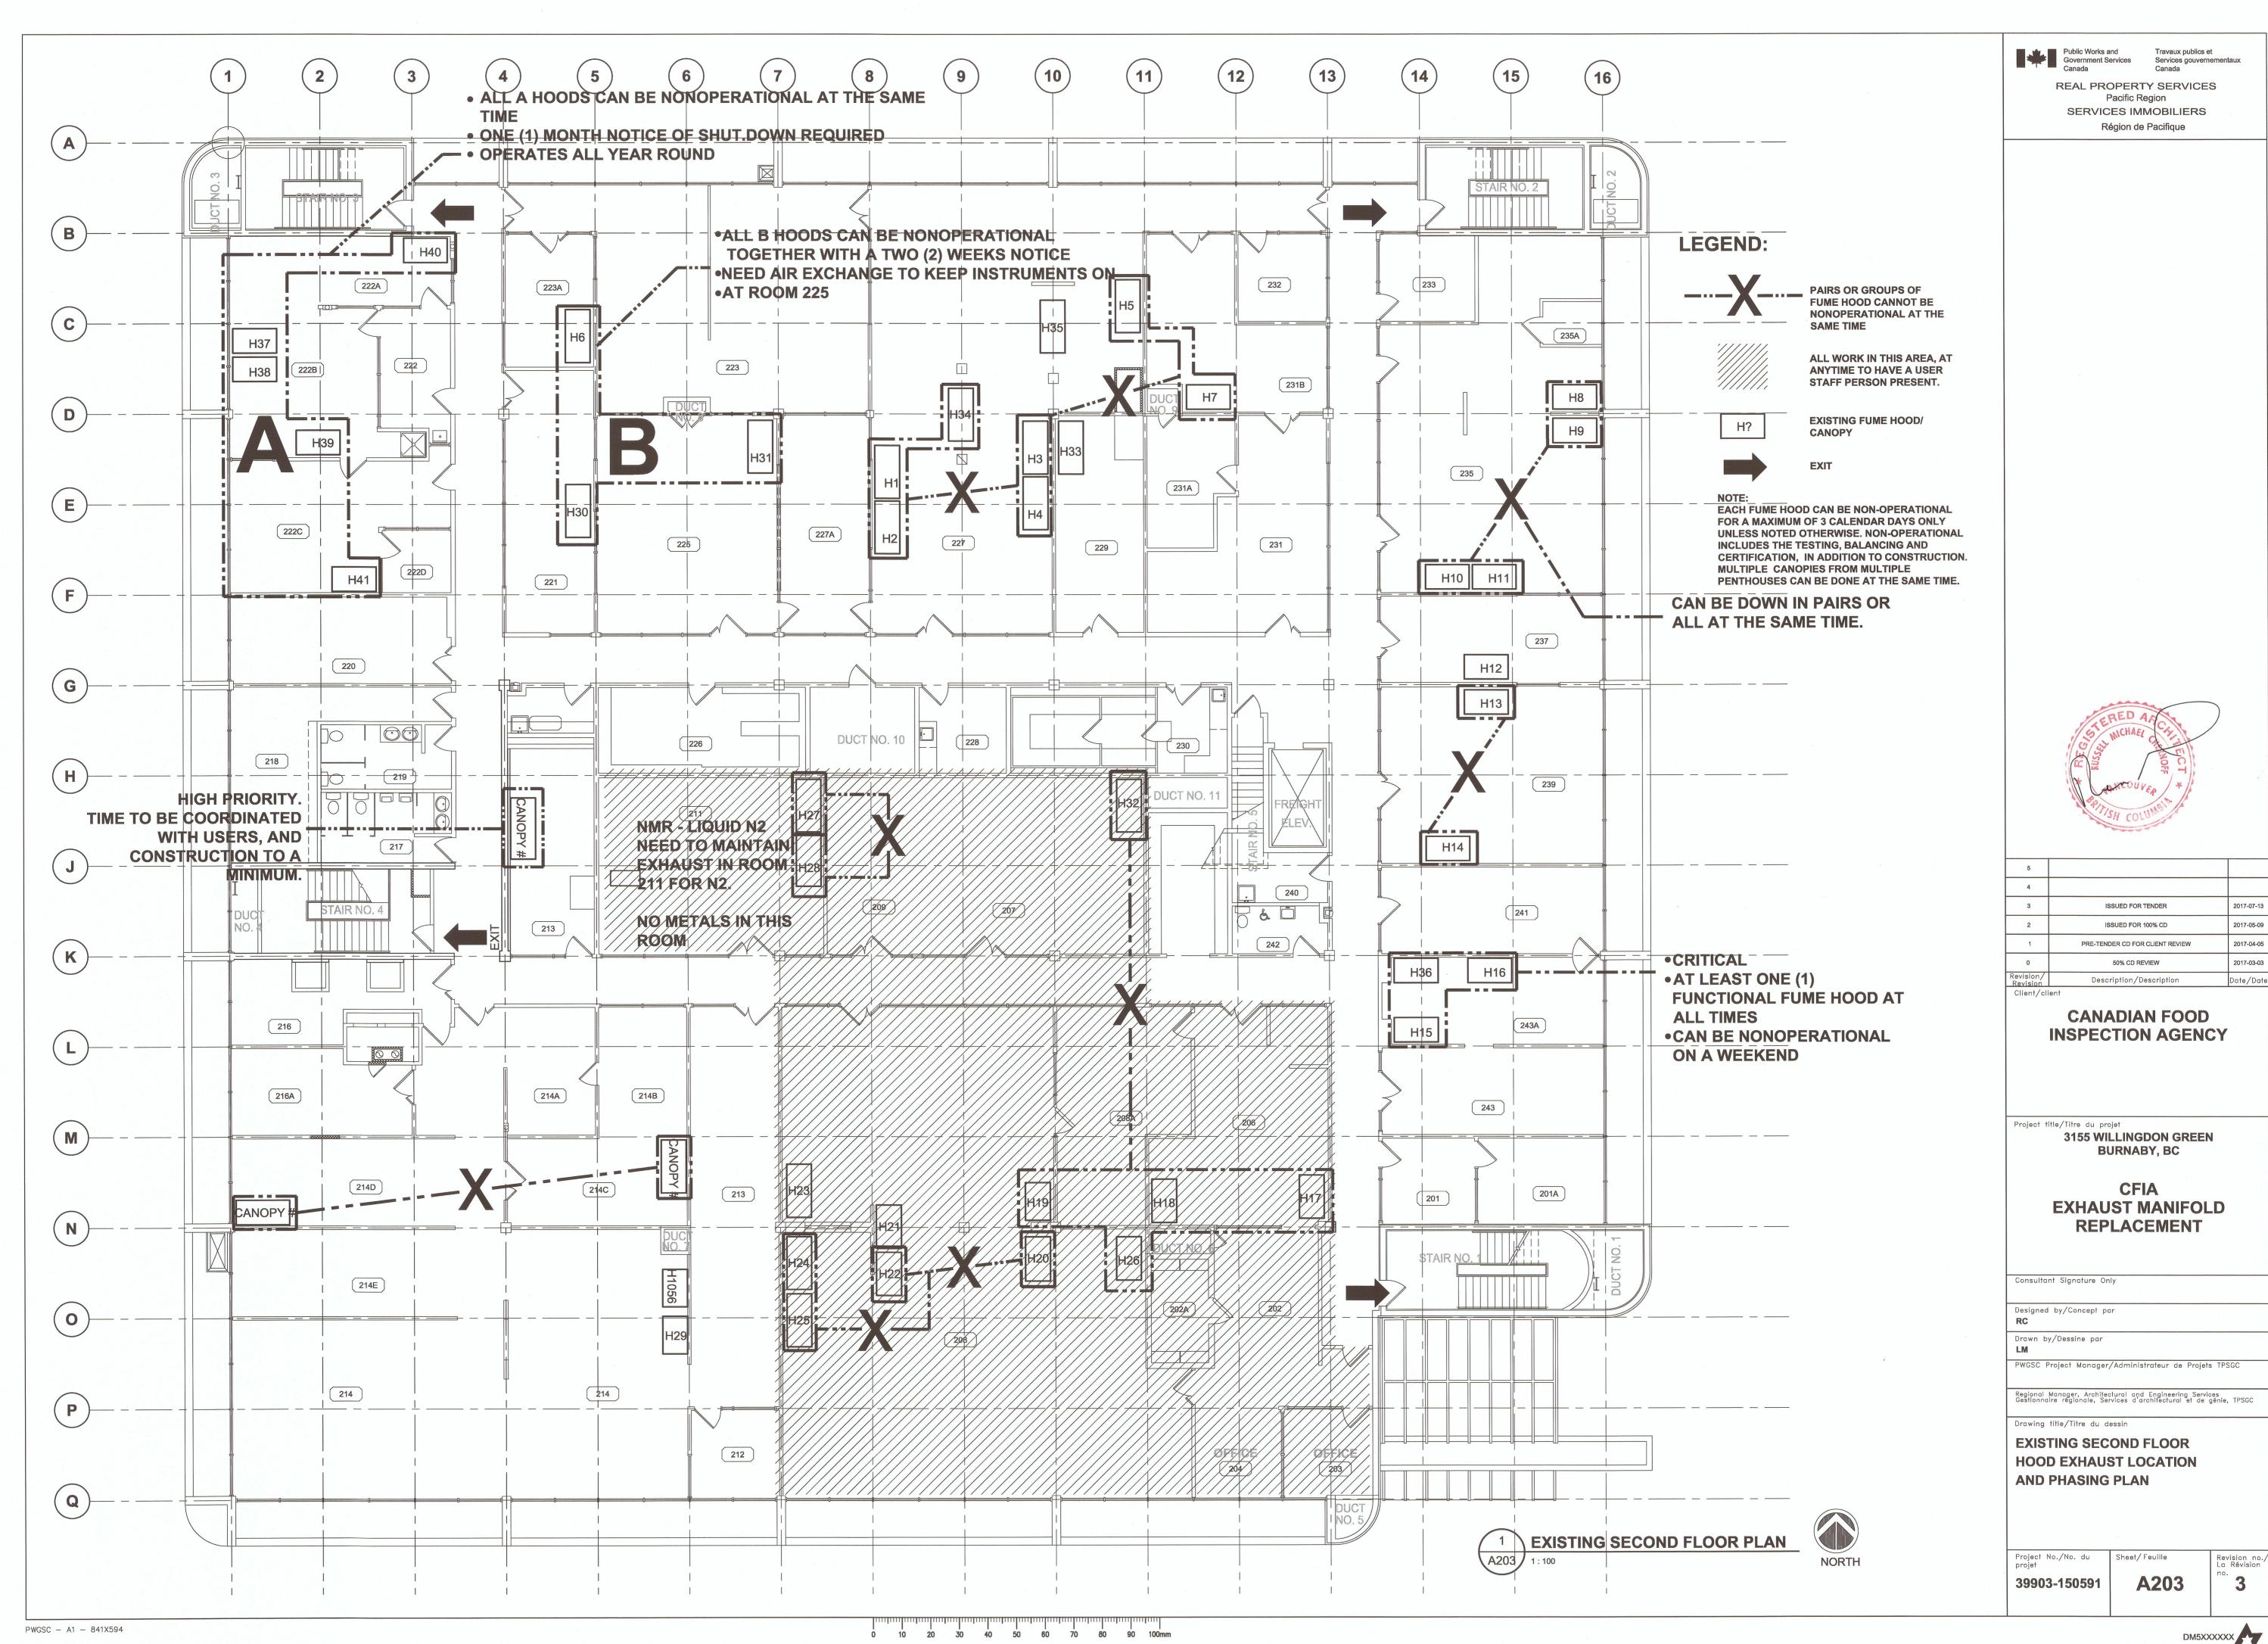

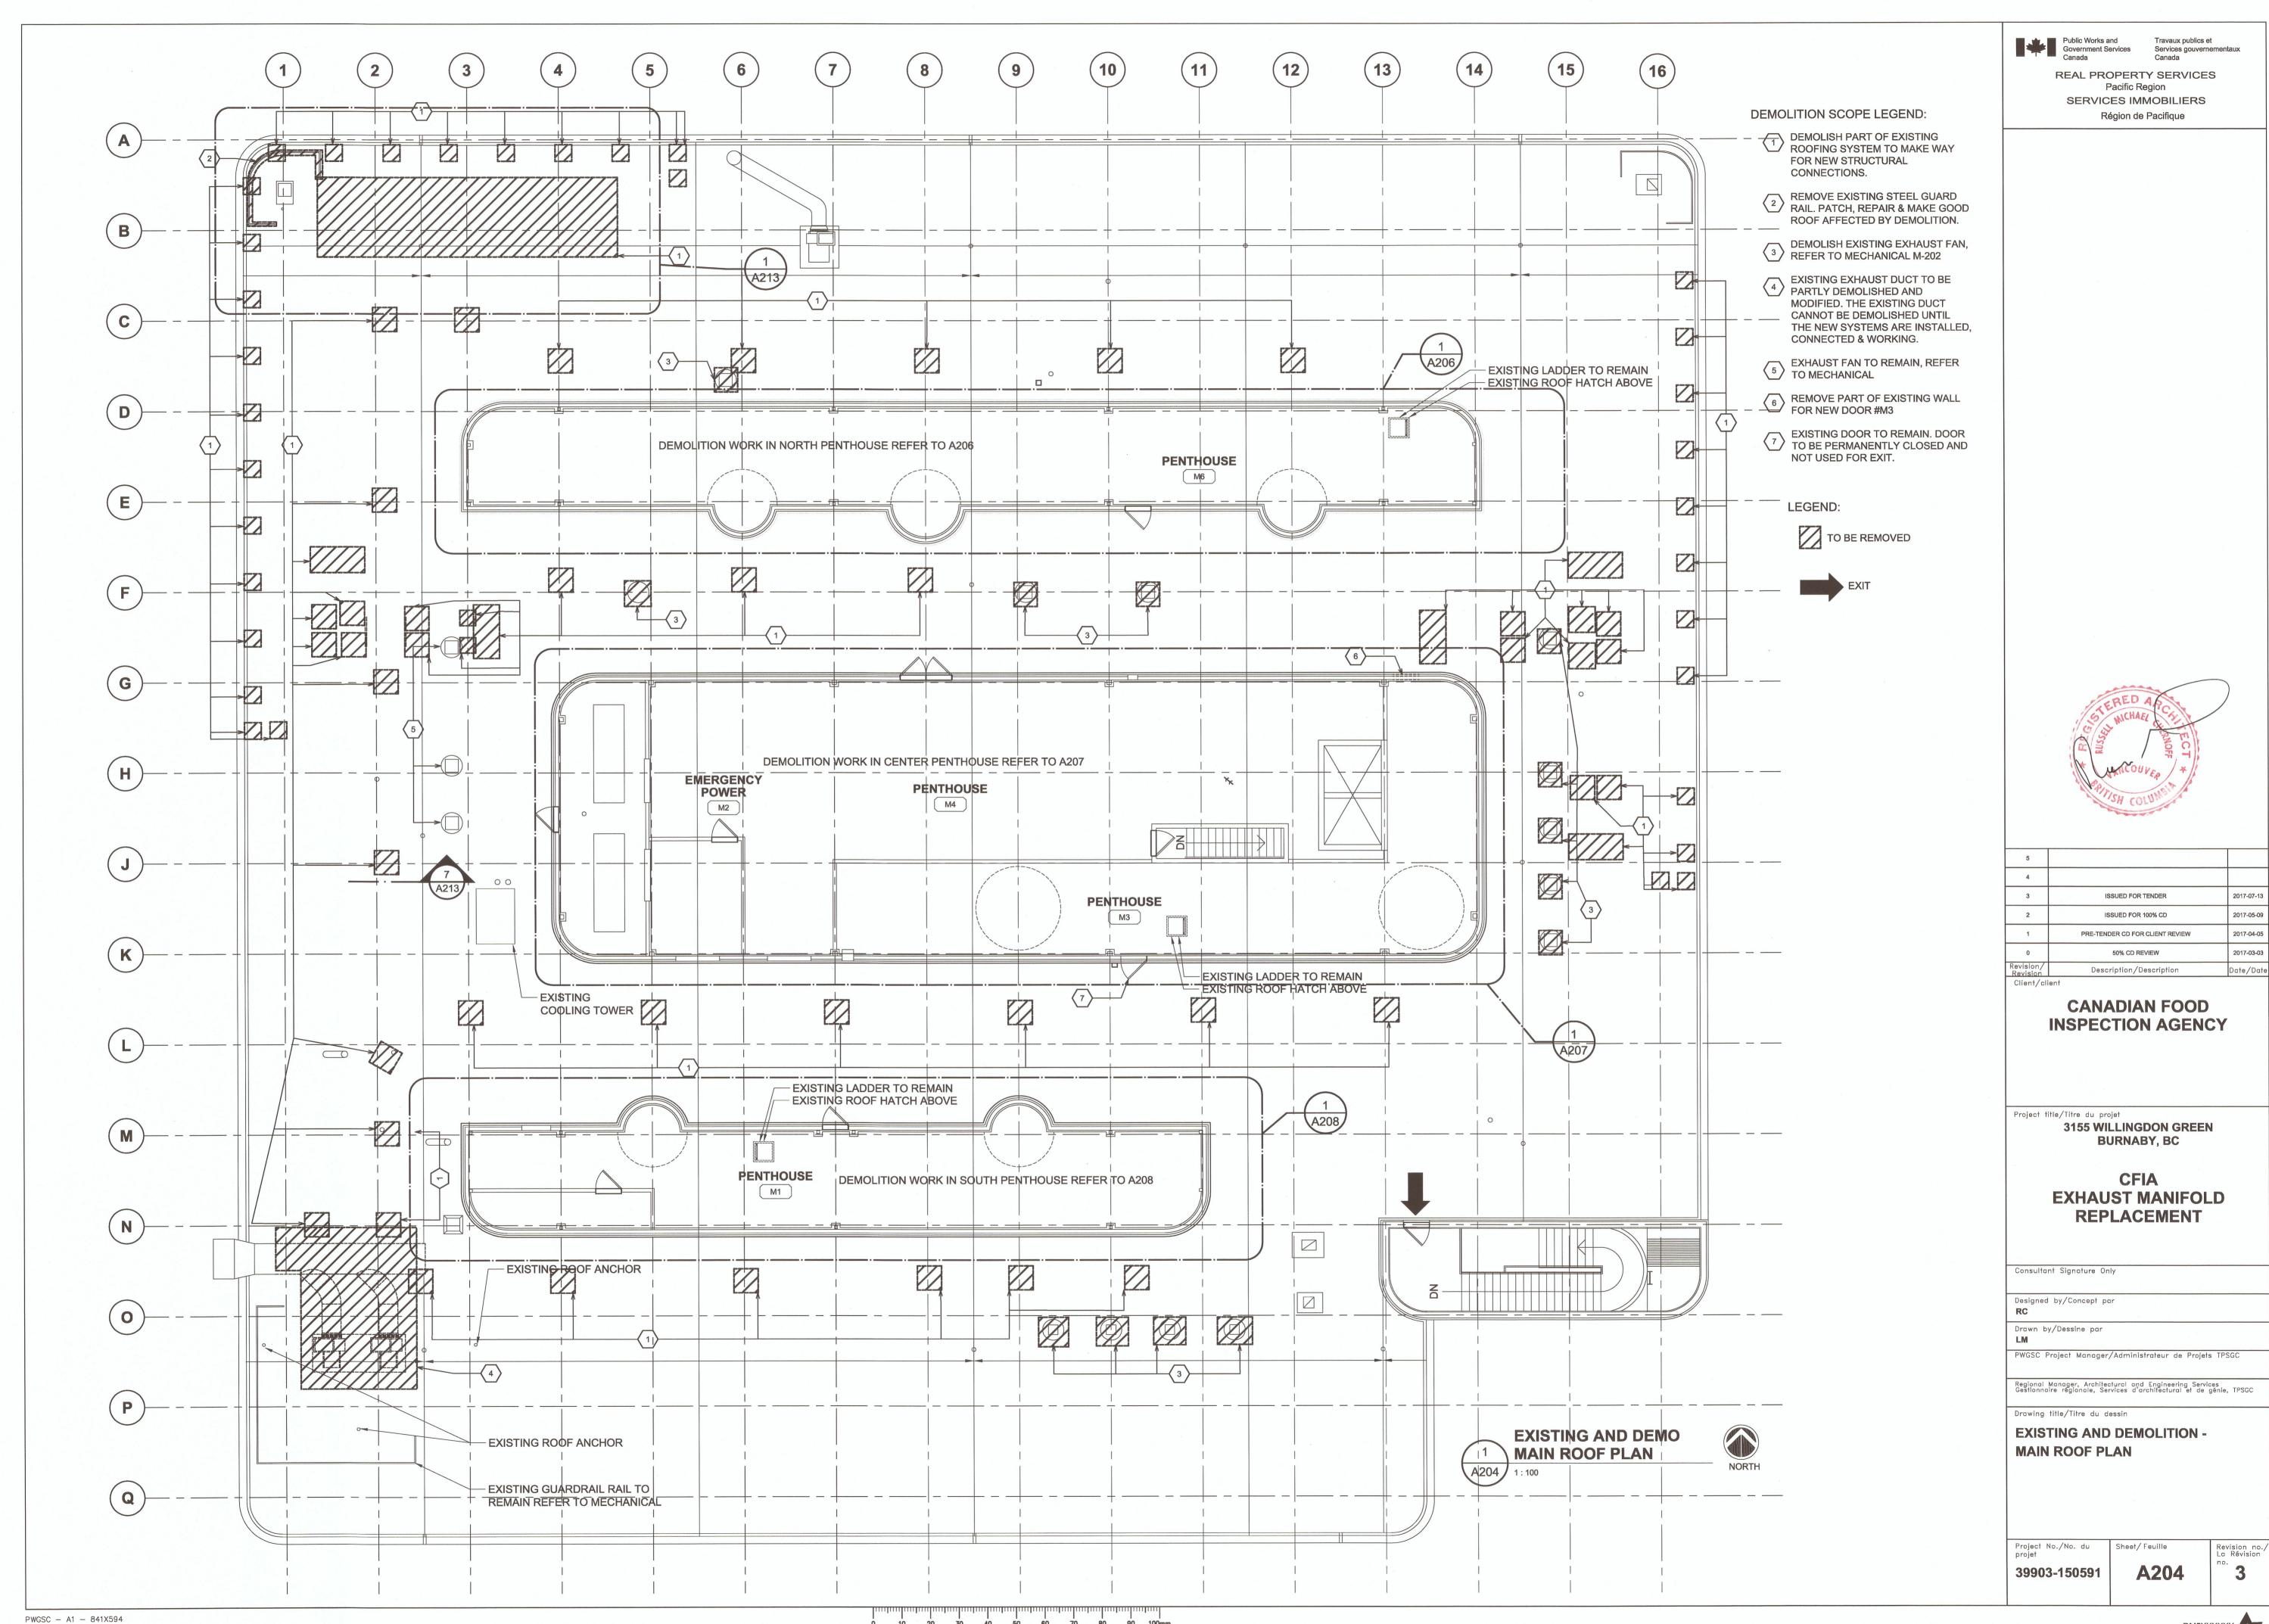

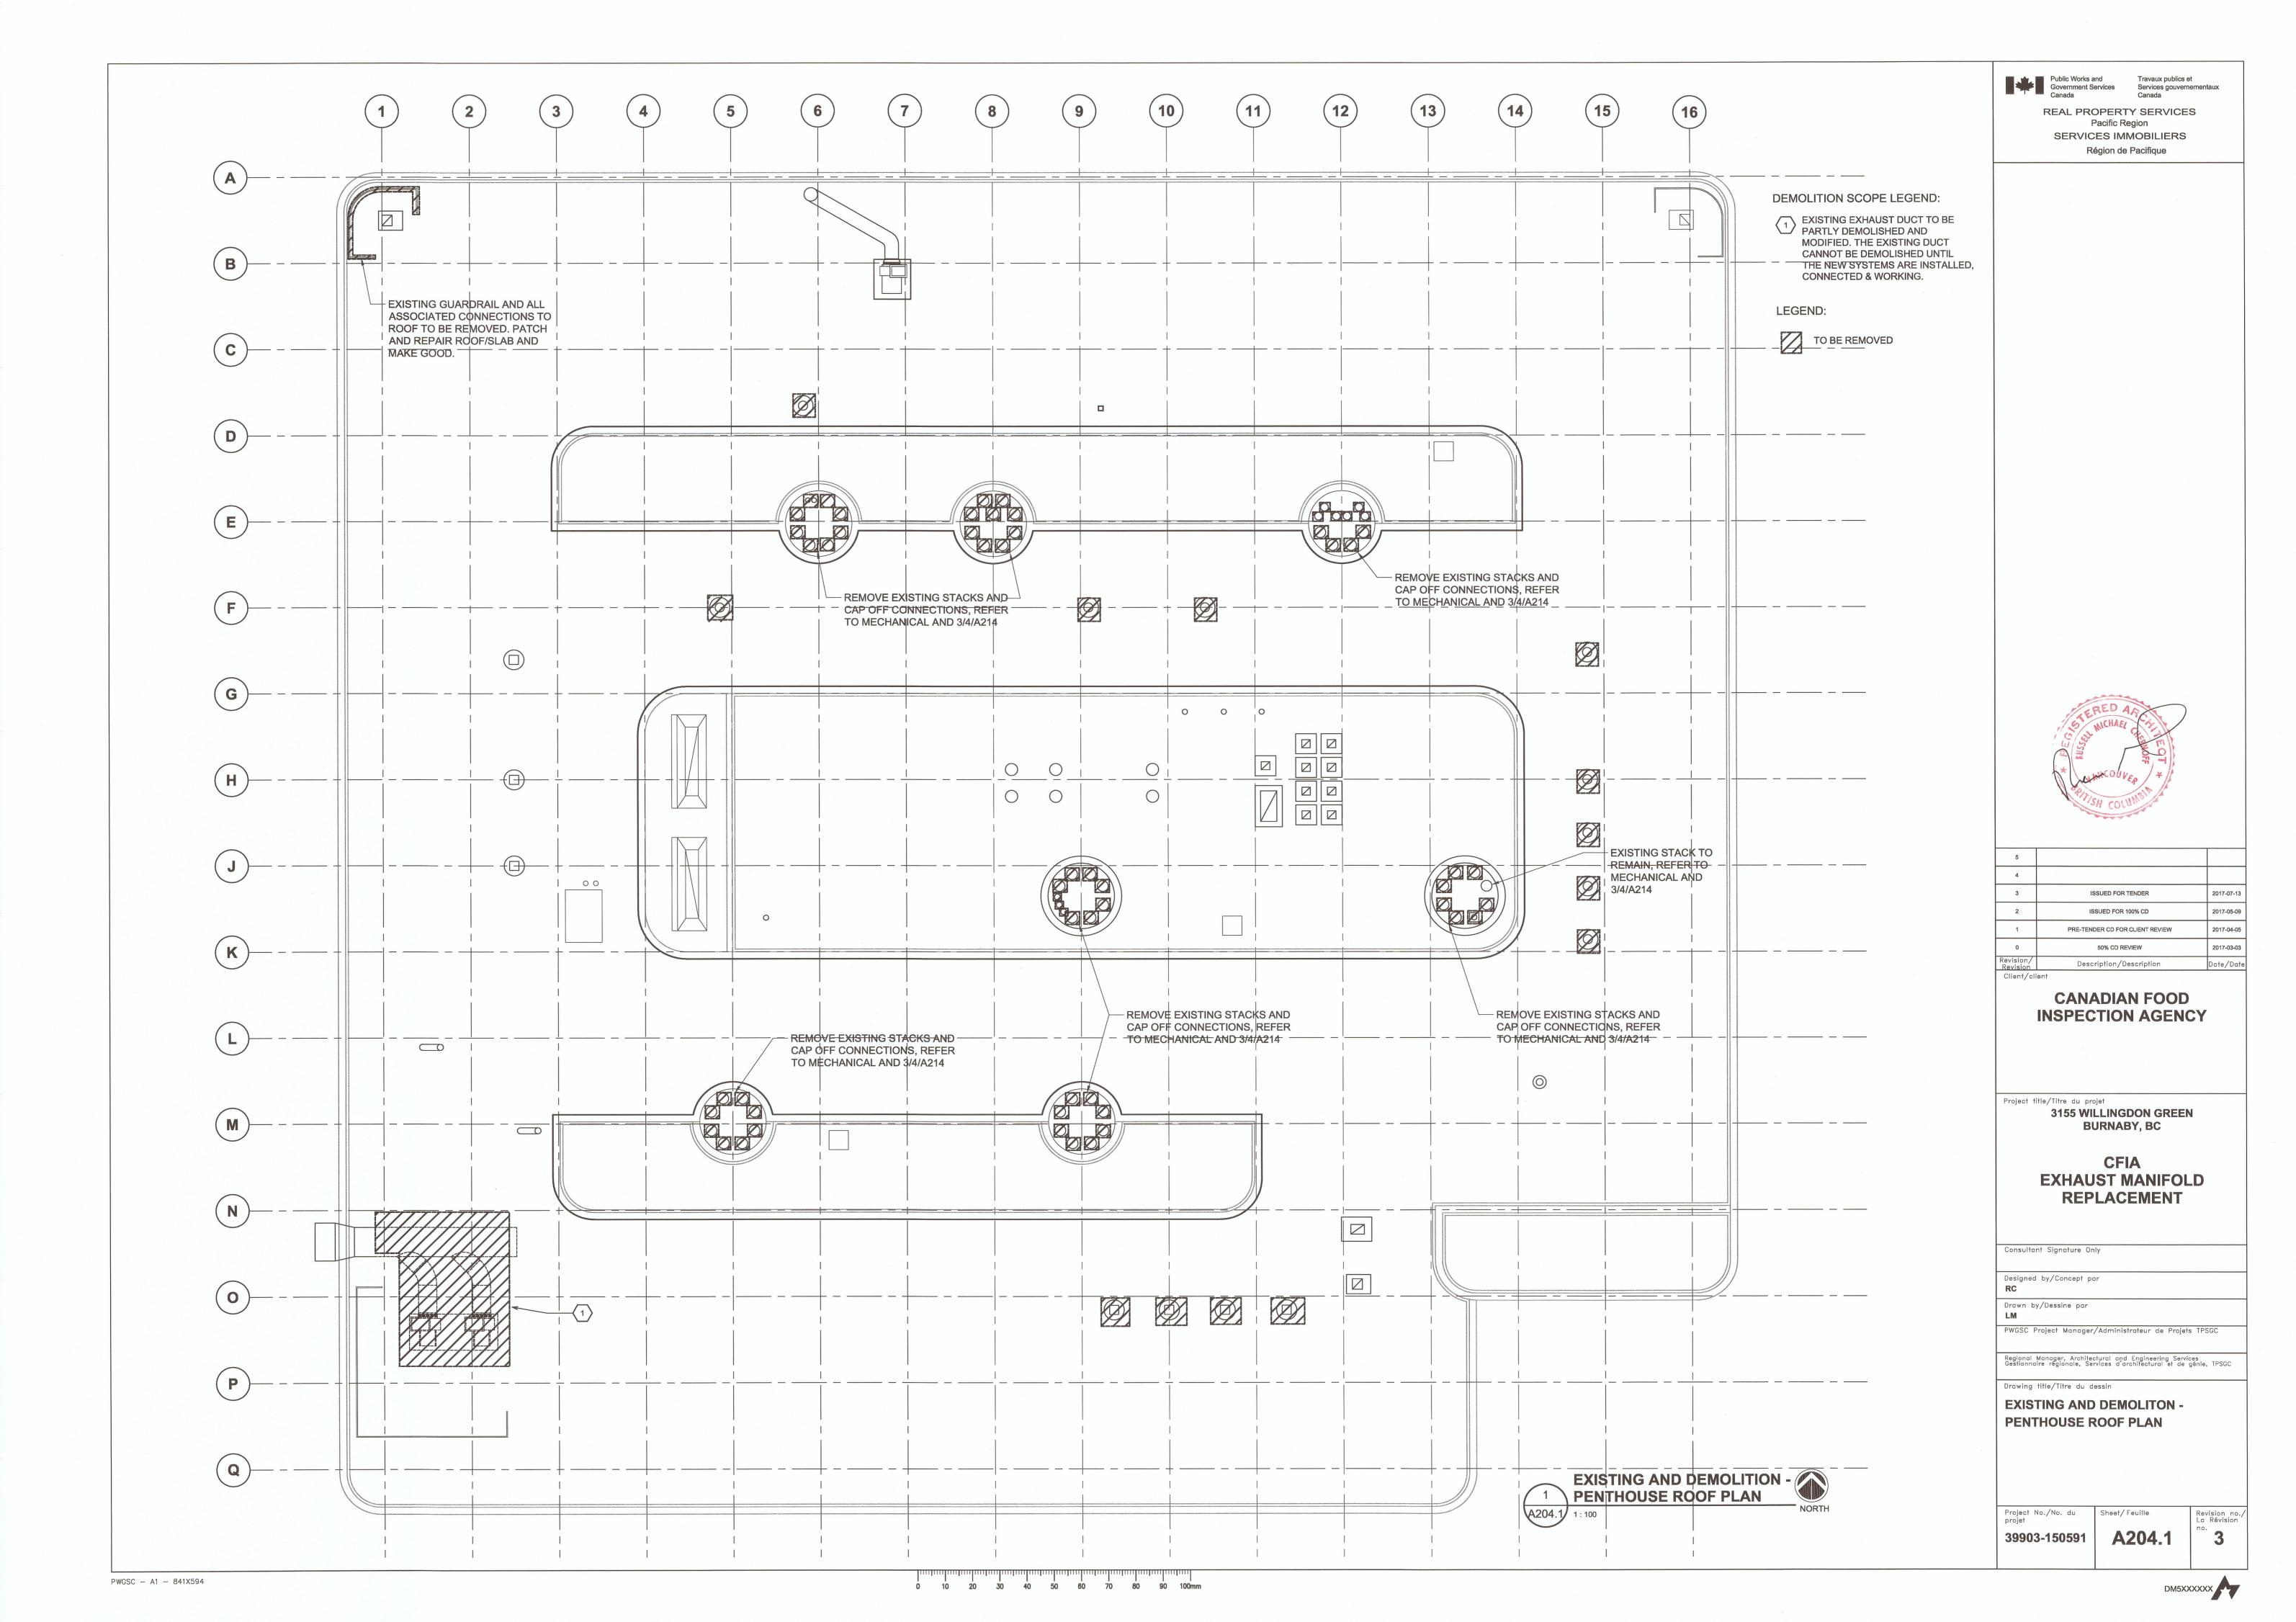

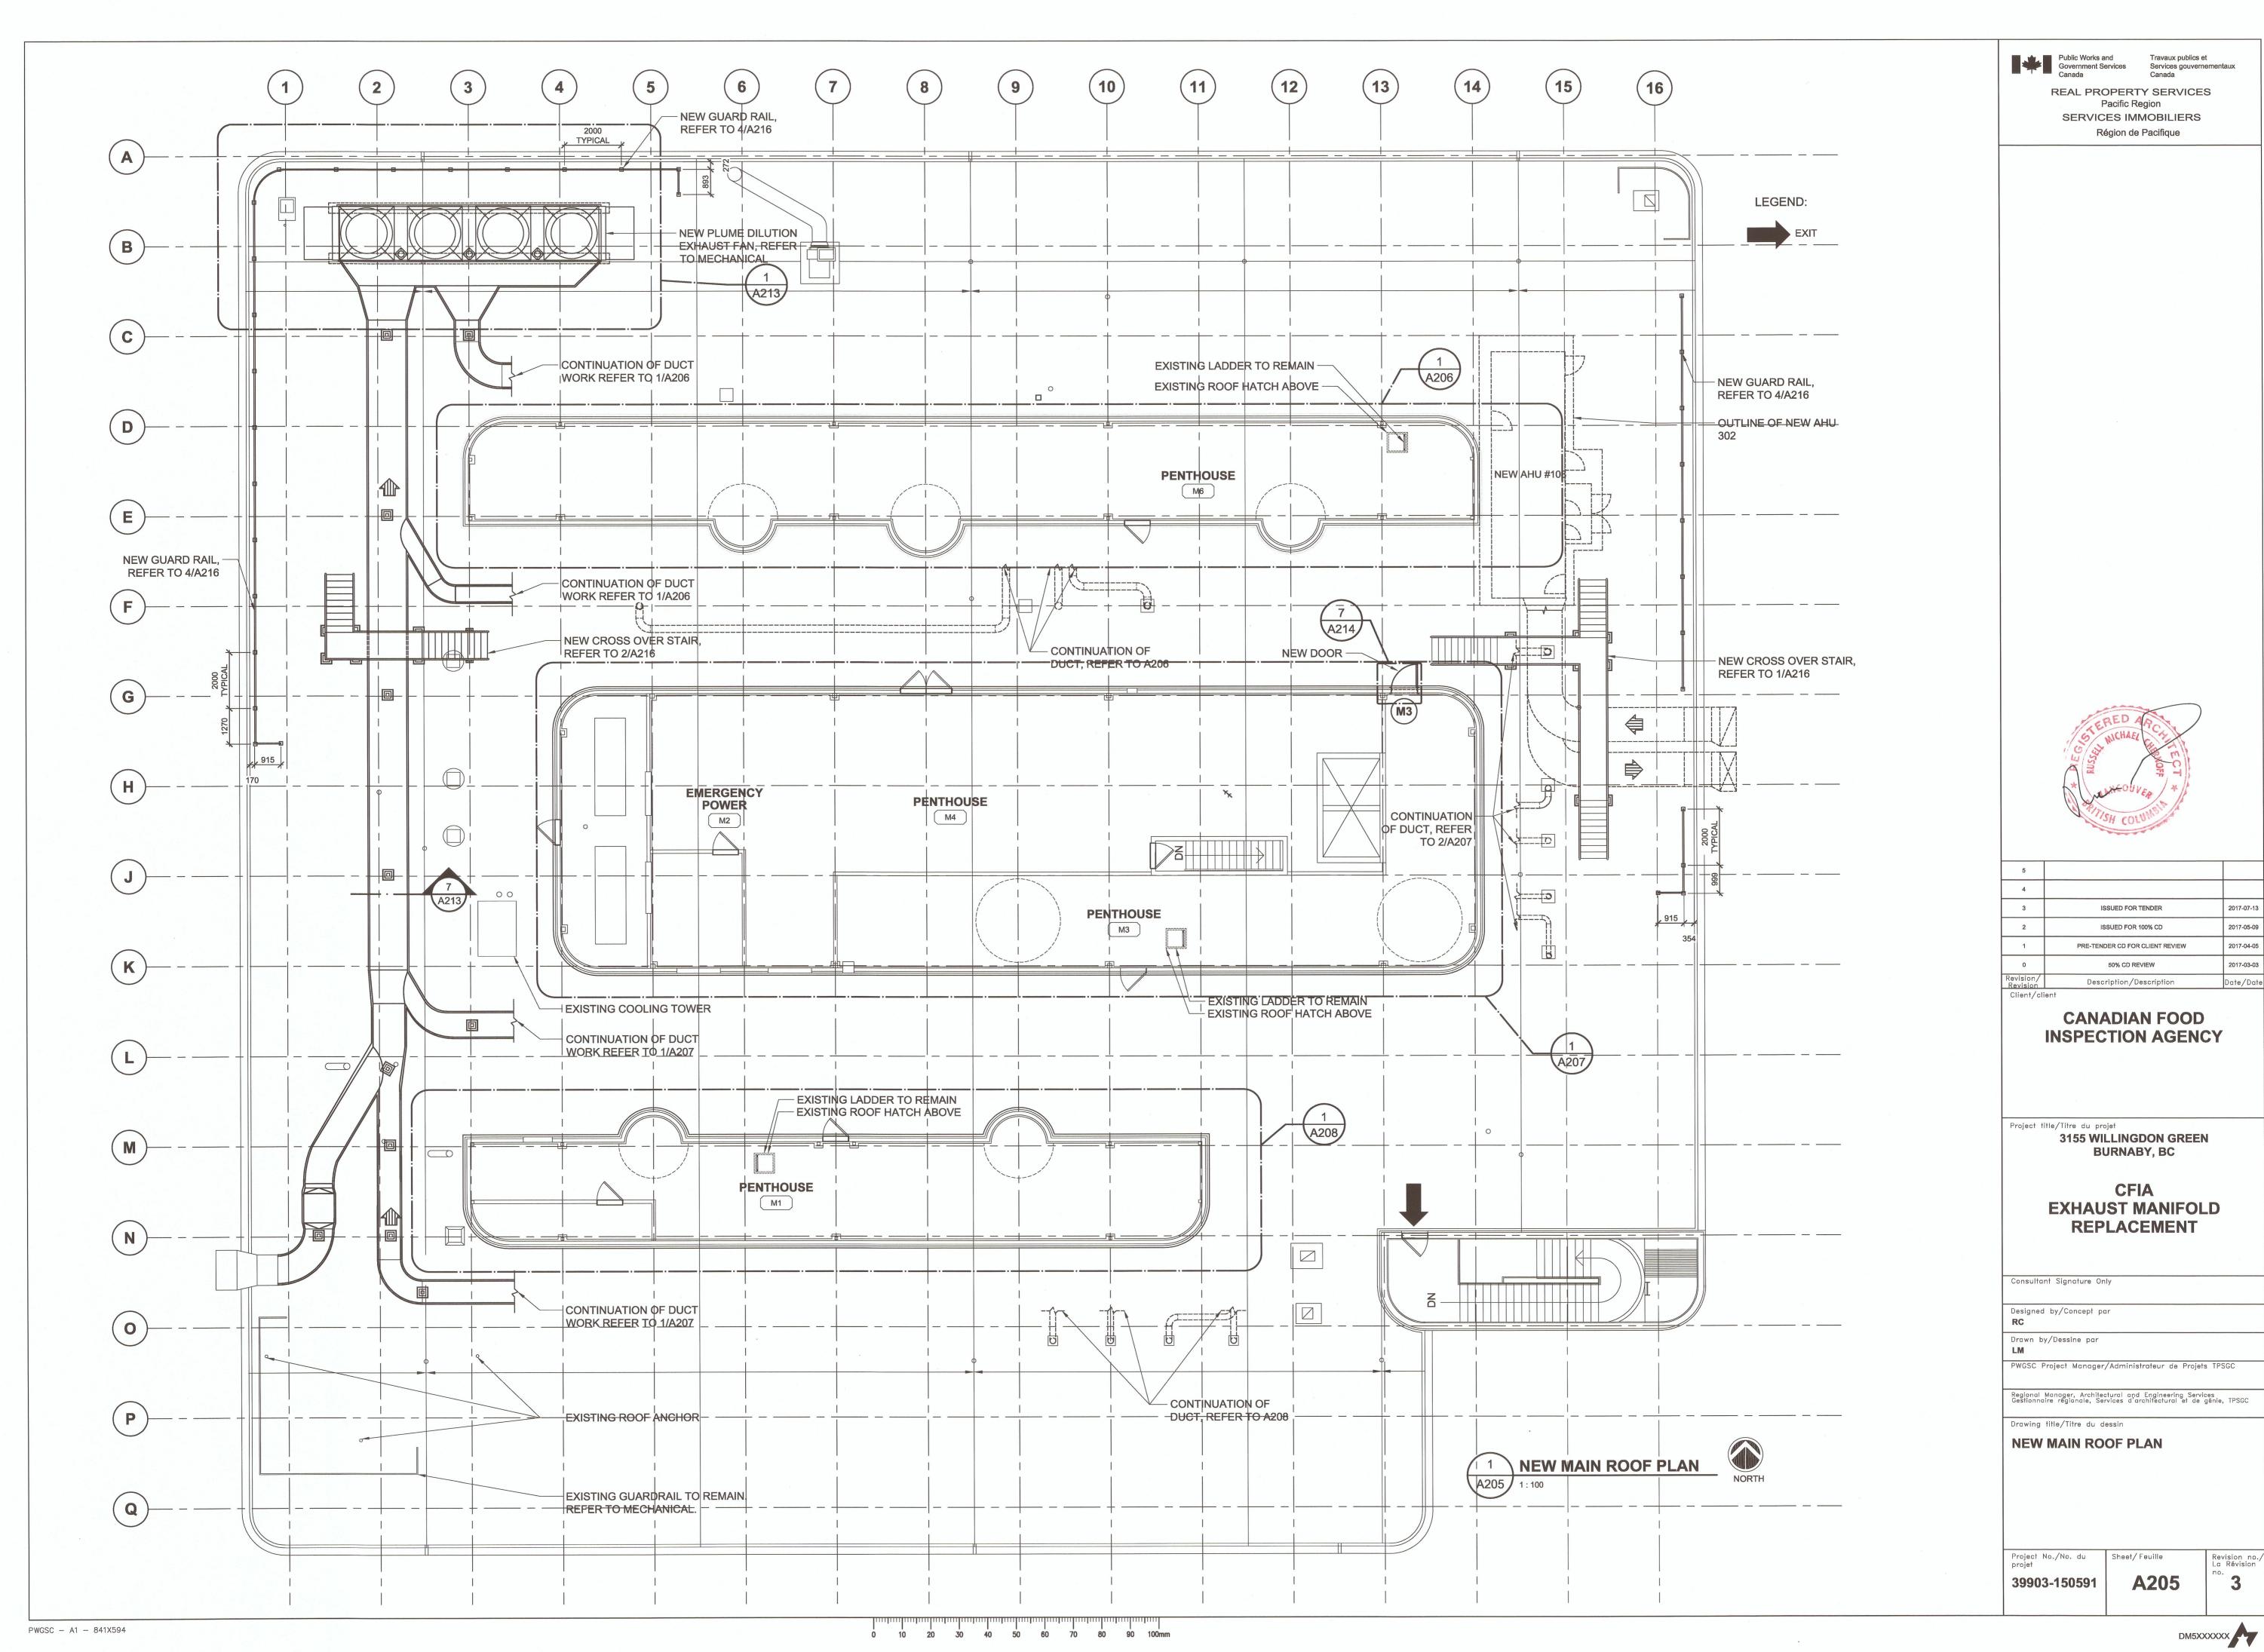


### CHERNOFF THOMPSON RCHITECTS

#### **DEMOLITION NOTES:**

CUT THROUGH EXISTING ALUMINUM CLADDING, FELT PAPER, GWB SHEATHING, BATT INSULATION AND POLY VAPOUR BARRIER TO FIT IN NEW STAINLESS SLEEVES. COORDINATE LOCATION WITH MECHANICAL


> LEGEND: TO BE DEMOLISHED TO REMAIN

> > TO BE REMOVED

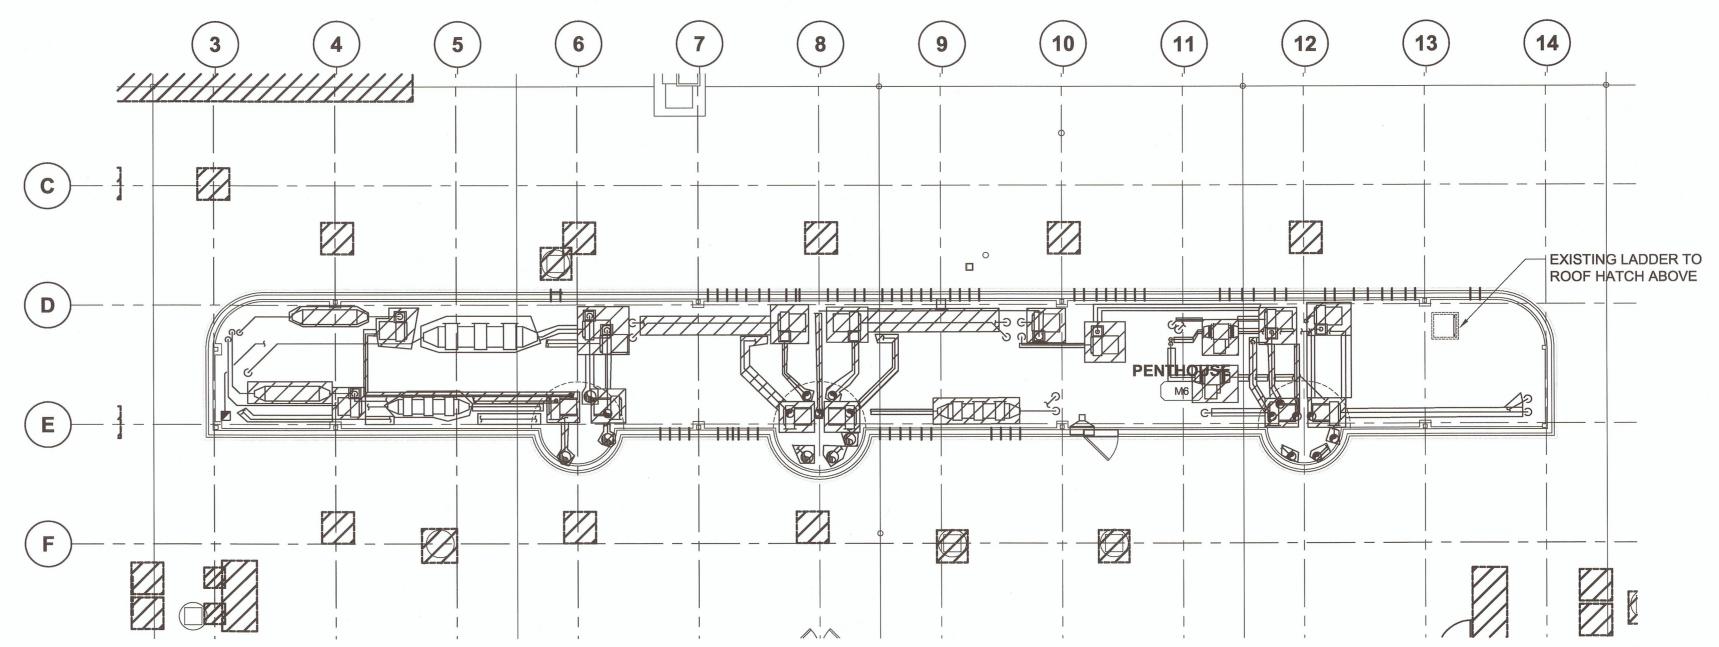





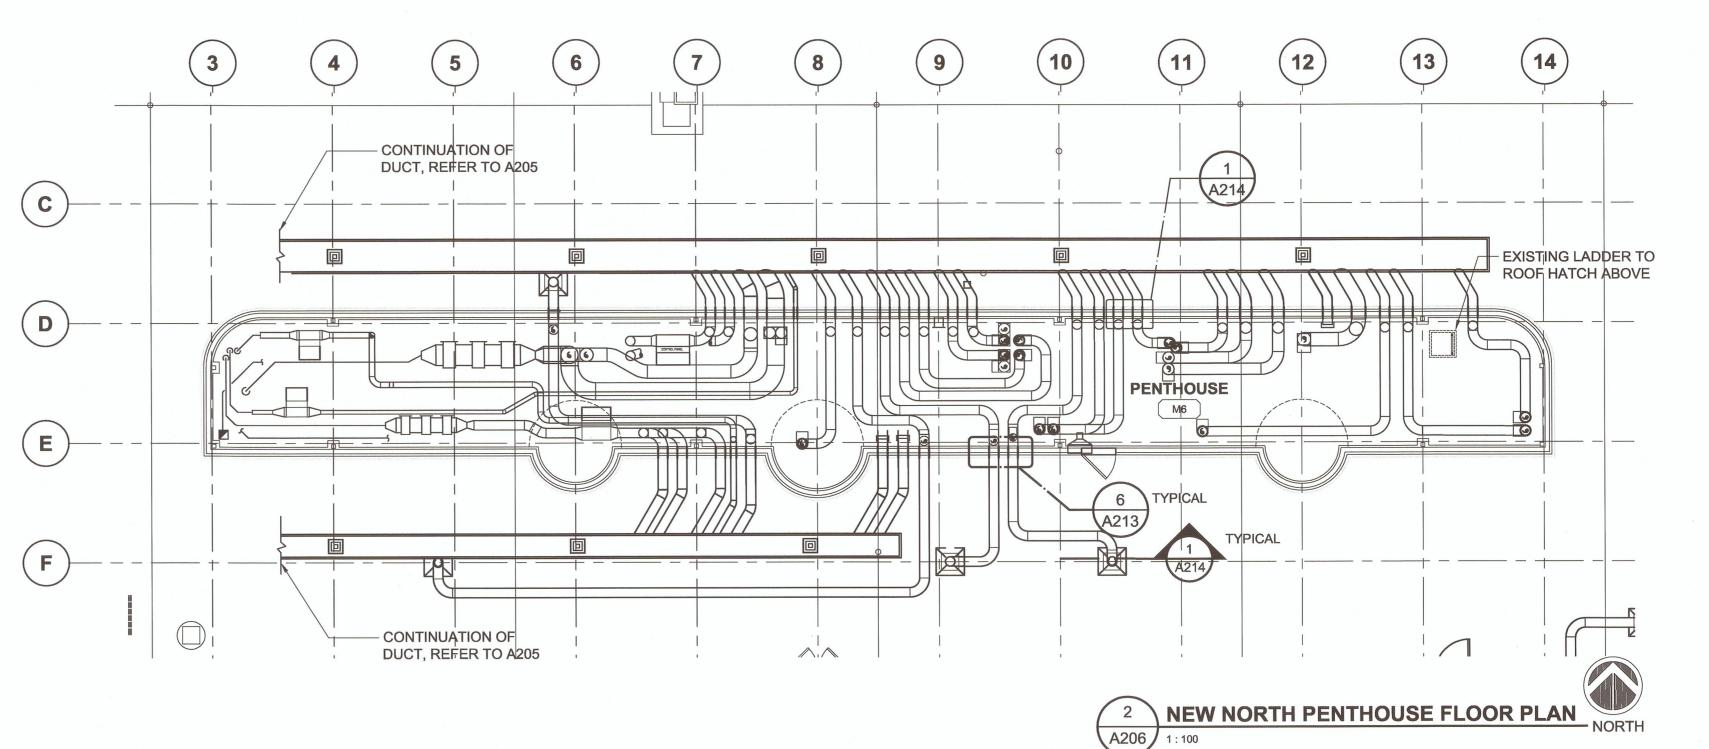



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3	ISSUED FOR TENDER	2017-07-13
2	ISSUED FOR 100% CD	2017-05-09
1	PRE-TENDER CD FOR CLIENT REVIEW	2017-04-05
0	50% CD REVIEW	2017-03-03
Revision/ Revision	Description/Description	Date/Date
Client/client		

### **CANADIAN FOOD INSPECTION AGENCY**

Project title/Titre du projet 3155 WILLINGDON GREEN BURNABY, BC

#### **CFIA EXHAUST MANIFOLD REPLACEMENT**

Consultant Signature Only

Designed by/Concept par Drawn by/Dessine par PWGSC Project Manager/Administrateur de Projets TPSGC

Regional Manager, Architectural and Engineering Services Gestionnaire régionale, Services d'architectural et de génie, TPSGC

Drawing title/Titre du dessin **NORTH PENTHOUSE EXISTING/DEMOLITION** 

**AND NEW PLANS** 

Project No./No. du projet

**A206** 39903-150591

Revision no., La Révision

Public Works and Government Services Canada Travaux publics et Services gouvernementaux Canada

REAL PROPERTY SERVICES Pacific Region SERVICES IMMOBILIERS Région de Pacifique

#### DEMOLITION AND CONSTRUCTION SCOPE LEGEND:

**CUT THROUGH EXISTING** ALUMINUM CLADDING, FELT PAPER, GWB SHEATHING, BATT INSULATION AND POLY VAPOUR BARRIER TO FIT IN NEW STAINLESS SLEEVES. COORDINATE LOCATION WITH **MECHANICAL** 

BORE HOLES IN EXISTING SLAB TO MAKE WAY FOR NEW PIPE WORK, REFER TO ELECTRICAL E.1.05

BORE HOLES IN EXISTING SLAB TO MAKE WAY FOR NEW PIPE WORK, REFER TO ELECTRICAL E.1.05

NEW ELECTRICL PANEL, REFER TO **ELECTRICAL E1.05** 


NEW MCC, REFER TO ELECTRICAL E1.05


NEW TRANSFORMER, REFER TO **ELECTRICAL E1.05** 

LEGEND:

TO BE DEMOLISHED TO REMAIN

TO BE REMOVED

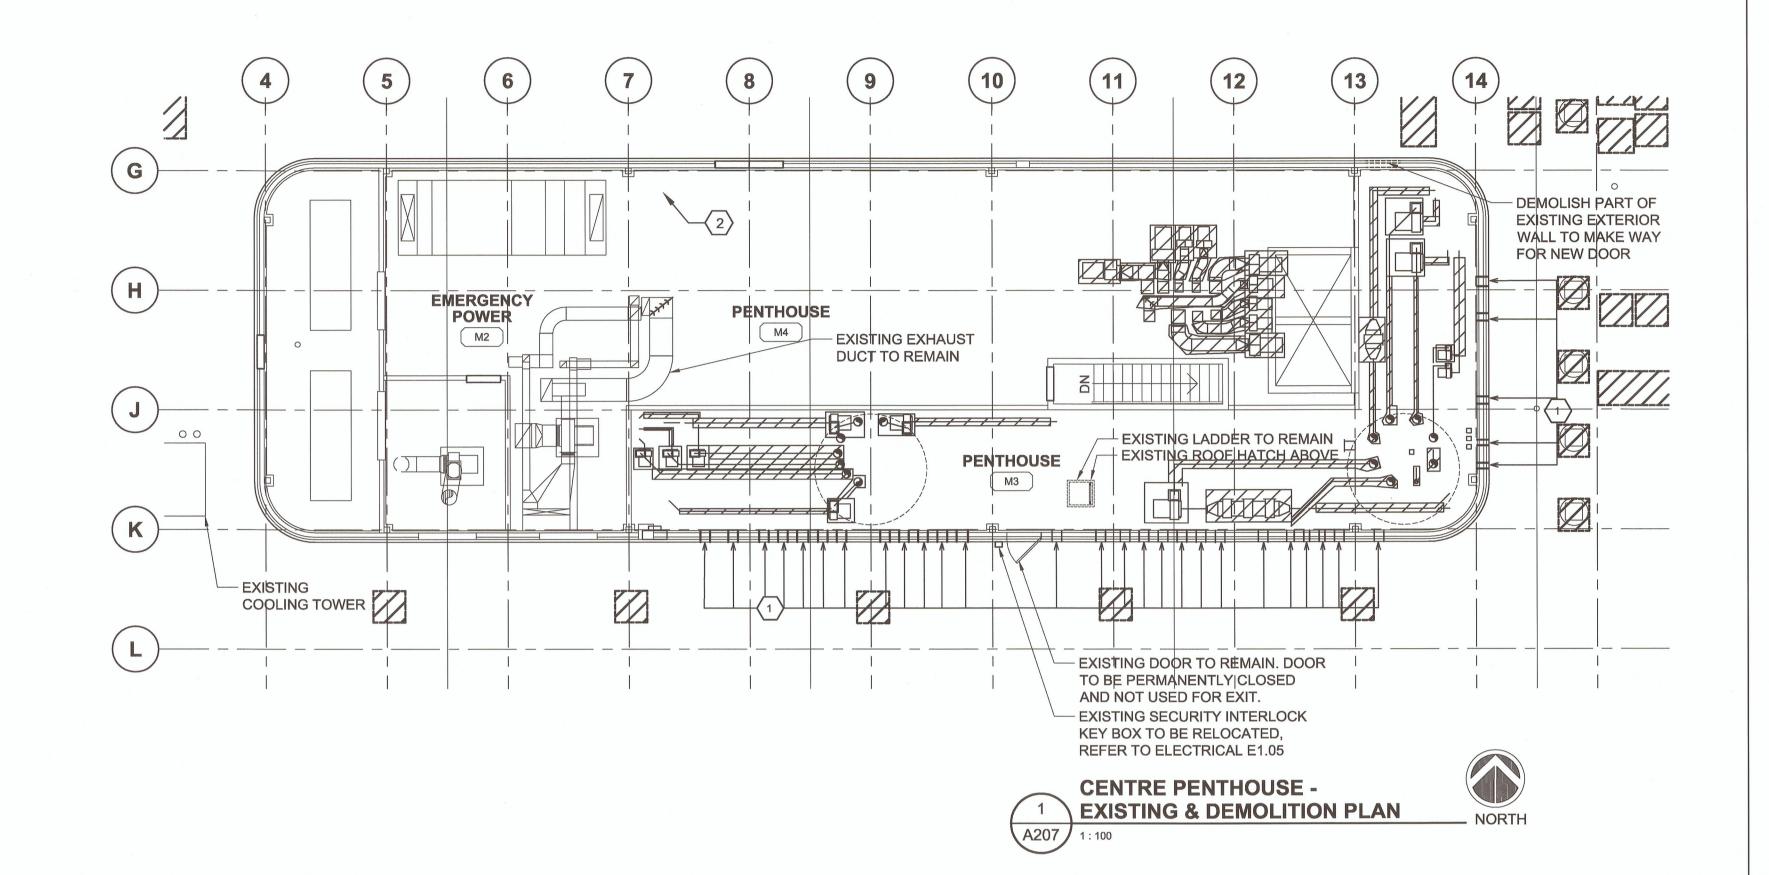

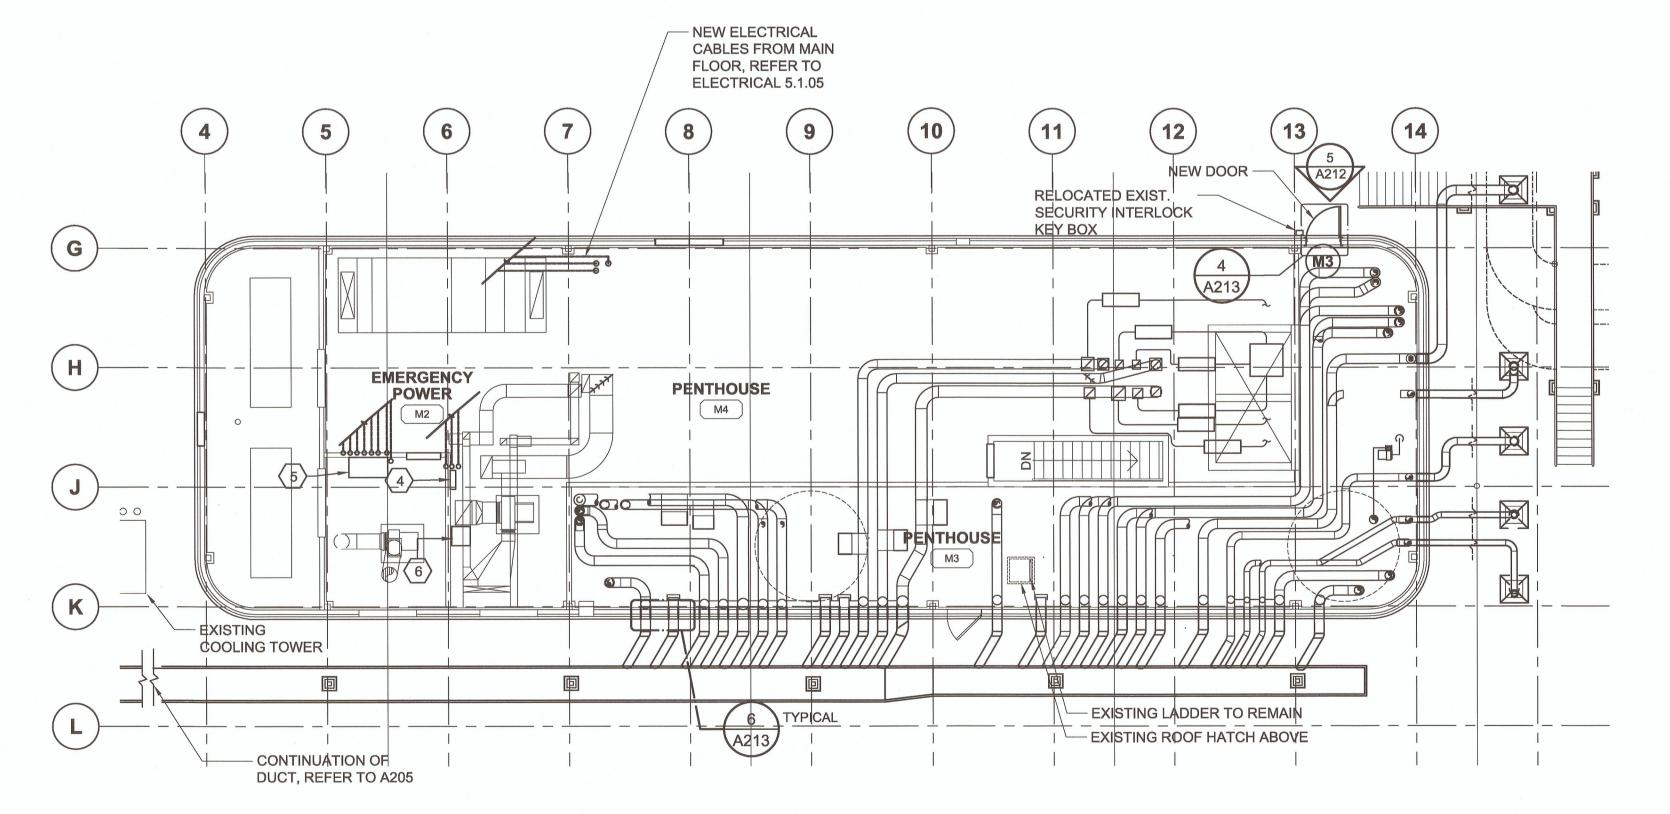





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3	ISSUED FOR TENDER	2017-07-1
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0	50% CD REVIEW	2017-03-0
Revision/ Revision	Description/Description	Date/Do
Client /elient		

#### **CANADIAN FOOD INSPECTION AGENCY**

3155 WILLINGDON GREEN **BURNABY, BC** 

#### **CFIA EXHAUST MANIFOLD** REPLACEMENT

Consultant Signature Only Designed by/Concept par Drawn by/Dessine par PWGSC Project Manager/Administrateur de Projets TPSGC

Regional Manager, Architectural and Engineering Services Gestionnaire régionale, Services d'architectural et de génie, TPSGC Drawing title/Titre du dessin

**CENTRE PENTHOUSE EXISTING/ DEMOLITION AND NEW PLANS** 

Project No./No. du projet 39903-150591

Revision no., La Révision Sheet/Feuille **A207** 


## SERVICES IMMOBILIERS Région de Pacifique

#### **DEMOLITION NOTES:**


- CUT THROUGH EXISTING ALUMINUM CLADDING, FELT PAPER, GWB SHEATHING, BATT INSULATION AND POLY VAPOUR BARRIER TO FIT IN NEW STAINLESS SLEEVES. COORDINATE LOCATION WITH **MECHANICAL**
- EXISTING FUME EXHAUST FILTER IN (FEF-7) TO BE RELOCATED, REFER TO 2/A208 AND MECHANICAL DRAWINGS M-210/M-211



TO BE REMOVED

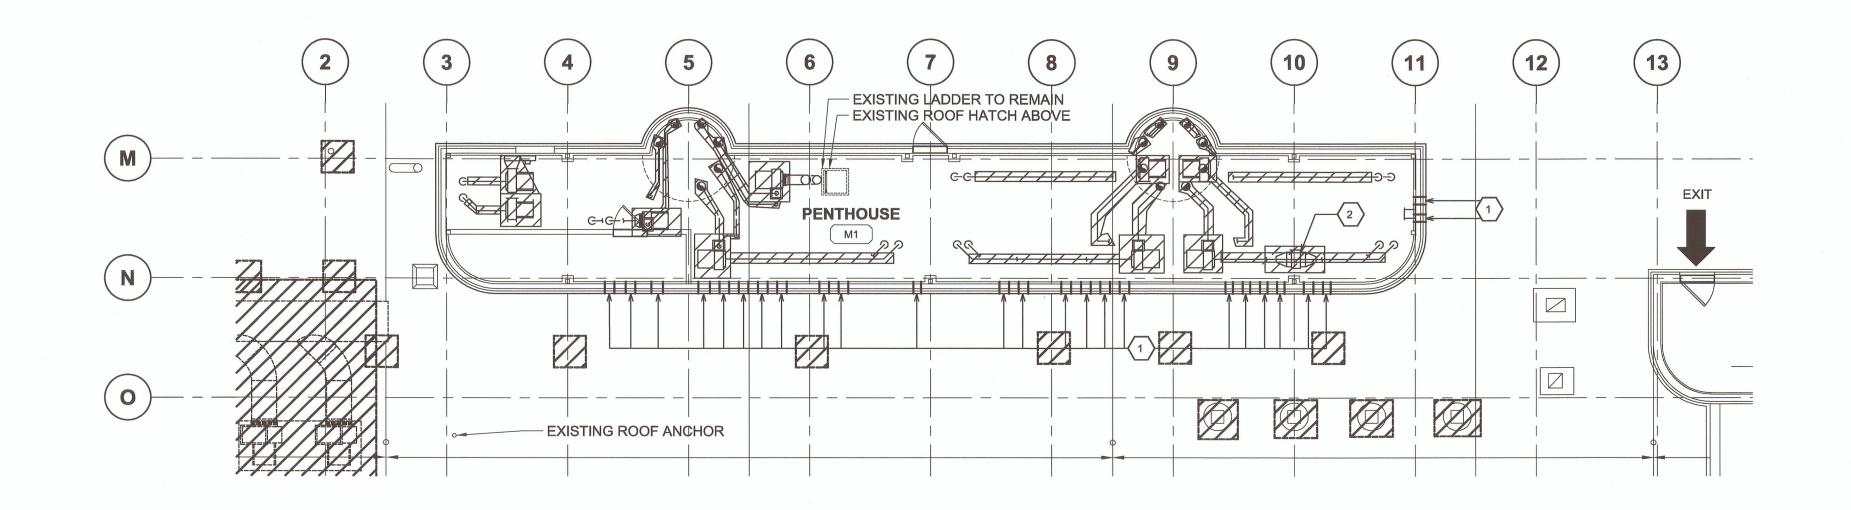



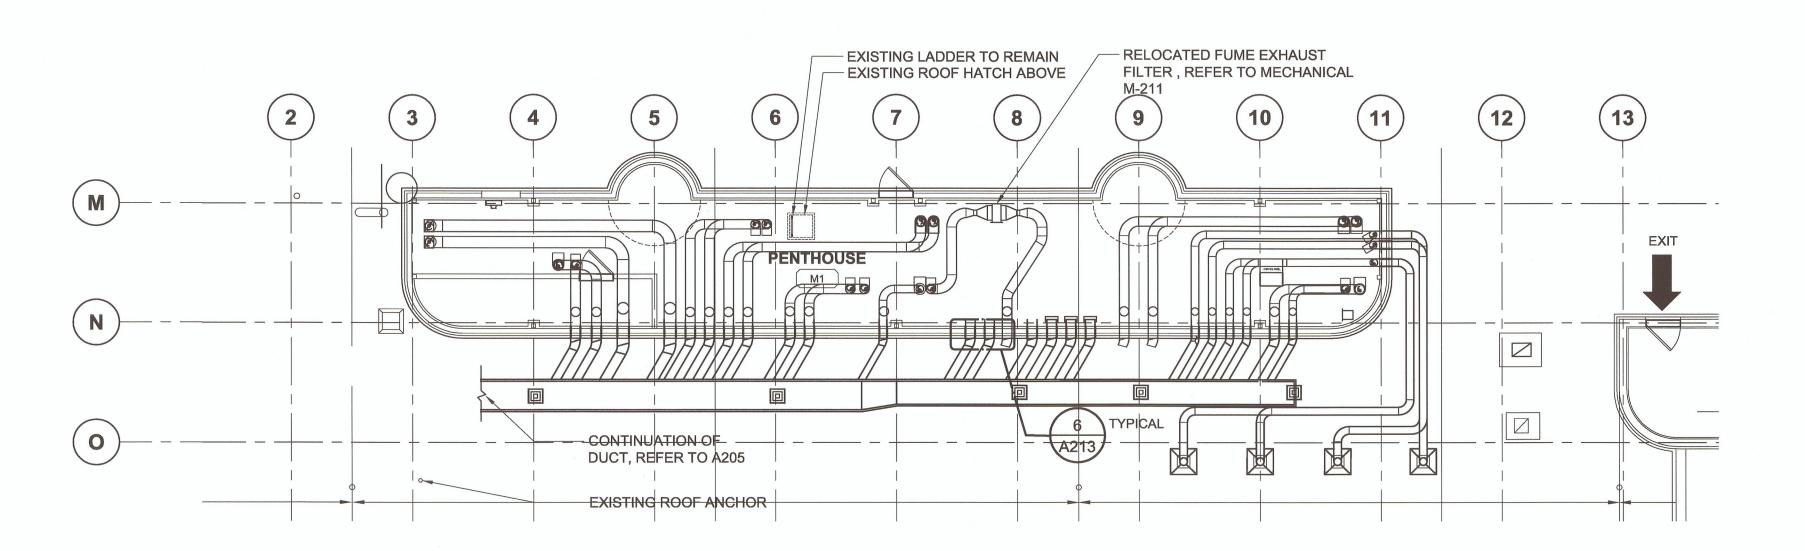





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3	ISSUED FOR TENDER	2017-07-13
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Project title/Titre du projet 3155 WILLINGDON GREEN BURNABY, BC

#### **CFIA EXHAUST MANIFOLD** REPLACEMENT

Consultant	Signature	Only

awn by/Dessine par
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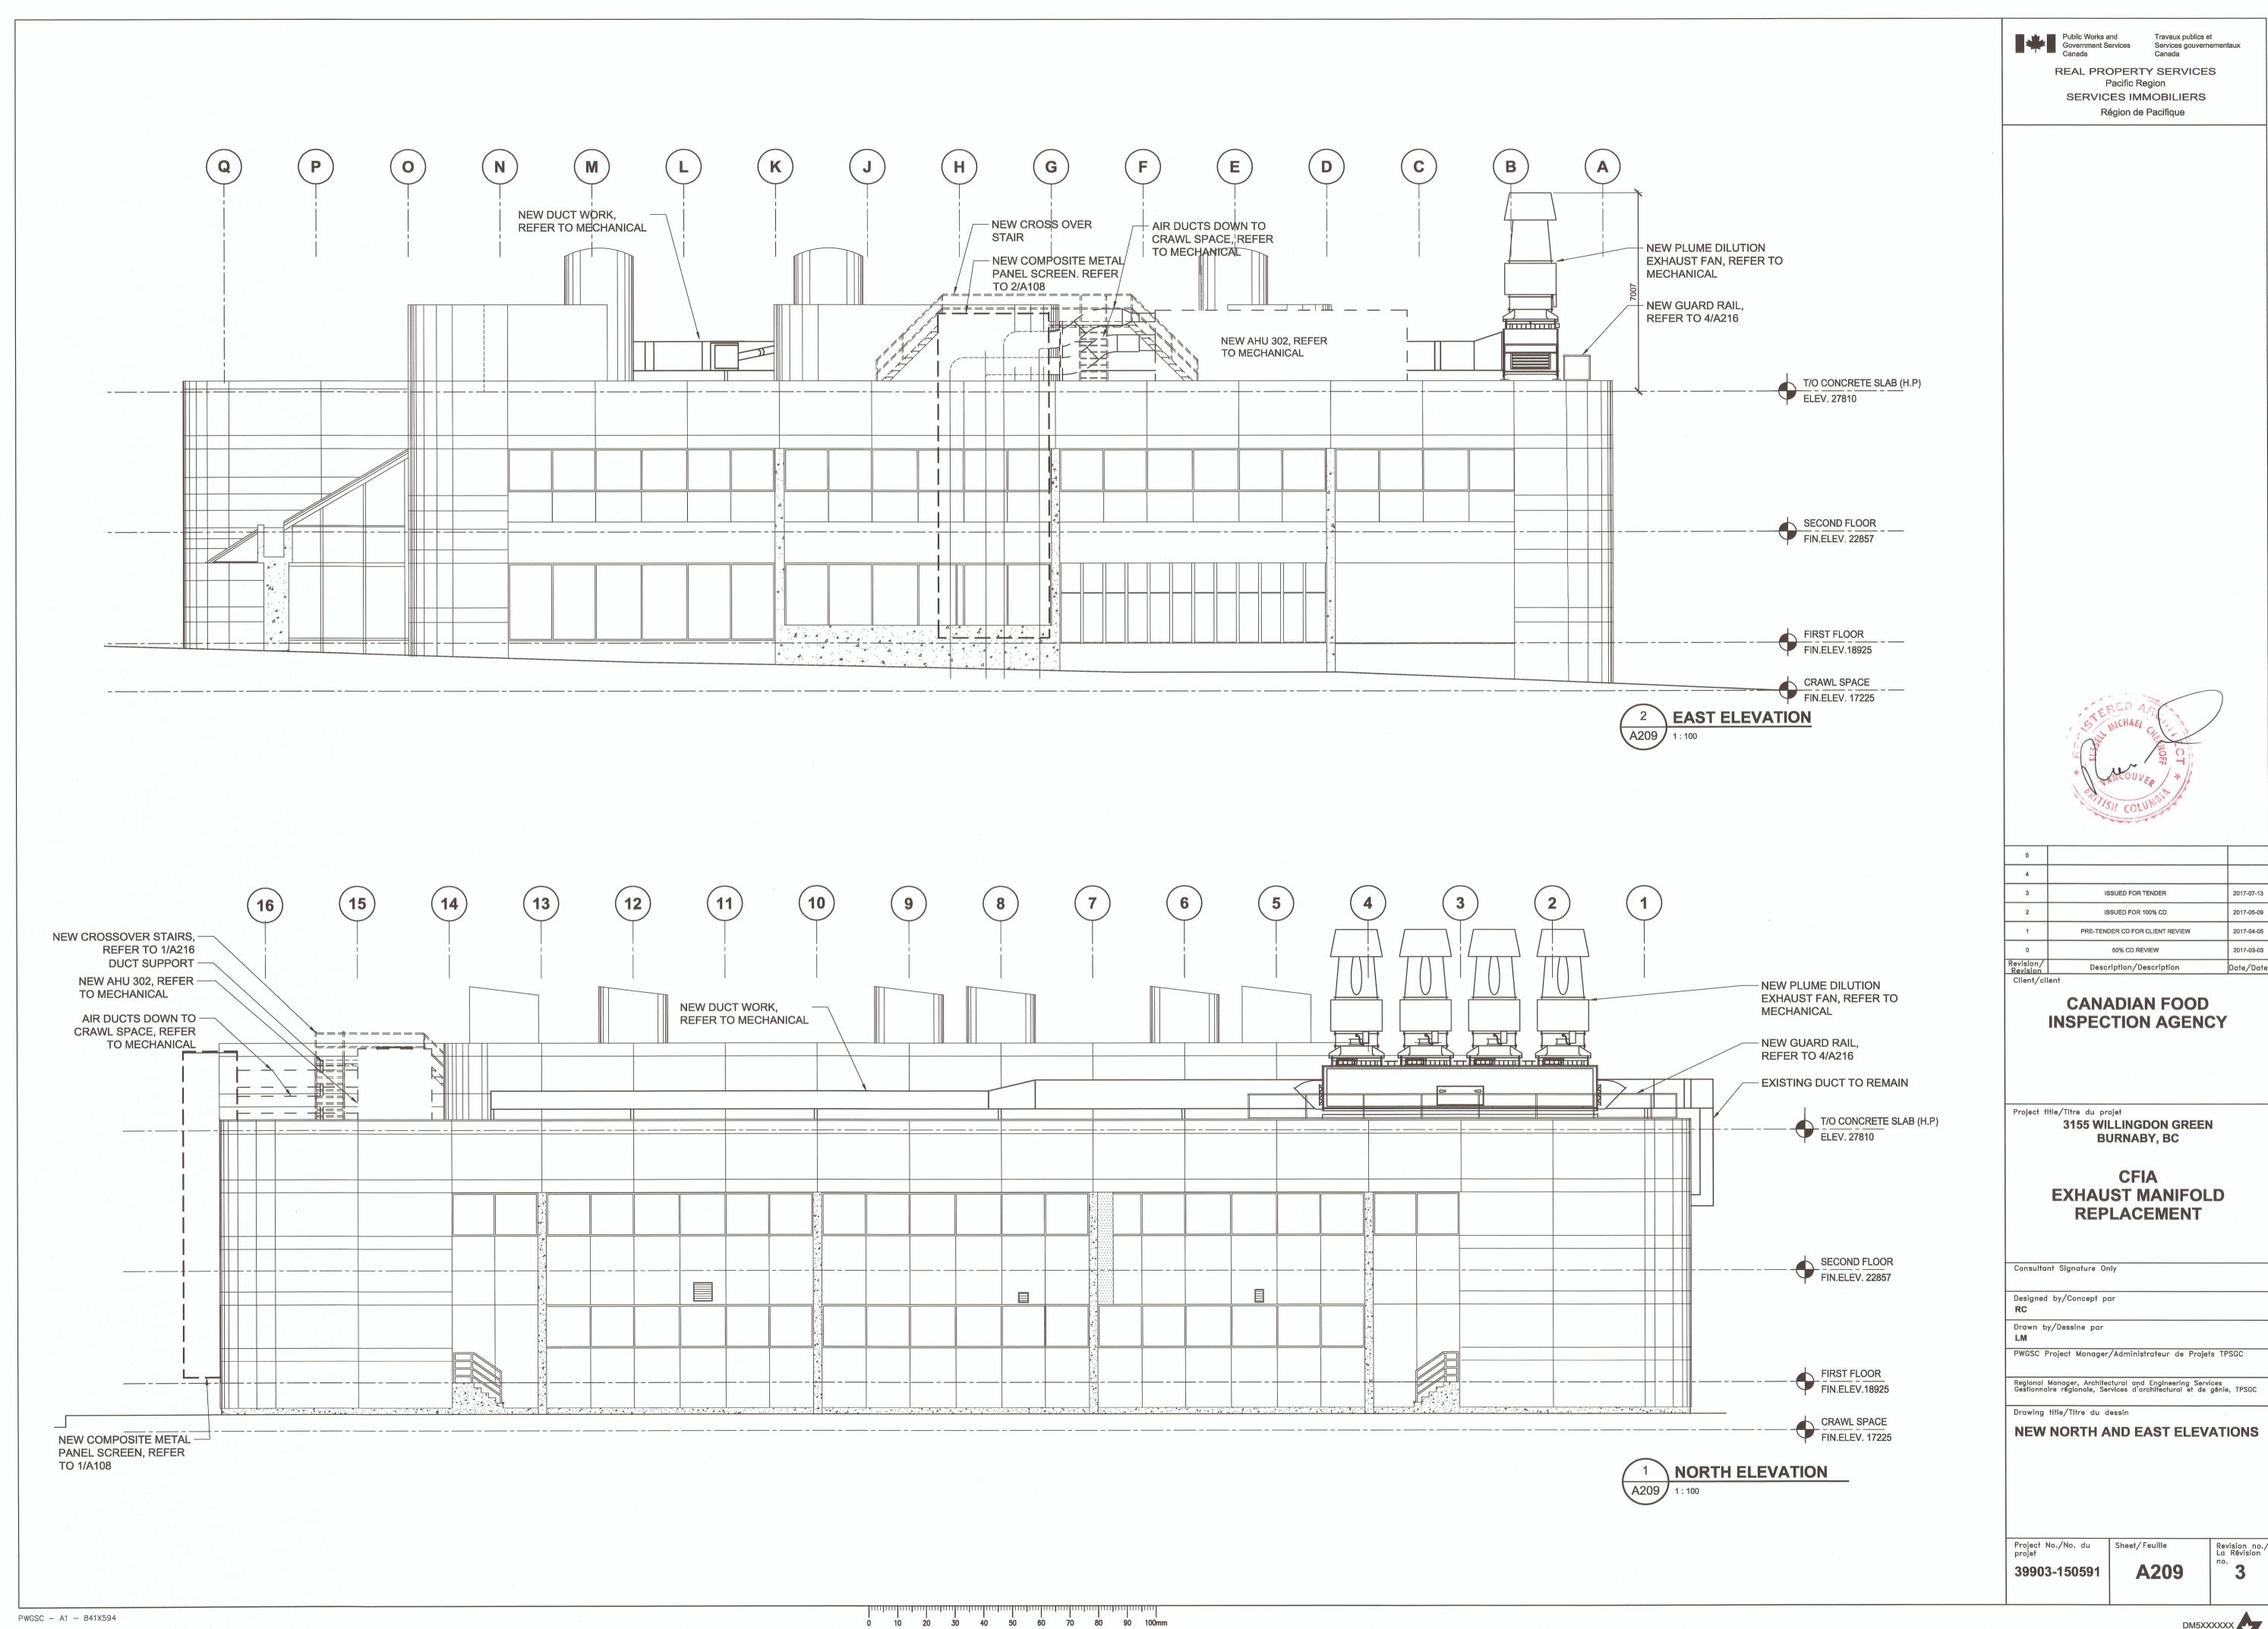
Regional Manager, Architectural and Engineering Services Gestionnaire régionale, Services d'architectural et de génie, TPSGC

Drawing title/Titre du dessin


**SOUTH PENTHOUSE EXISTING/DEMOLITION AND NEW PLANS** 


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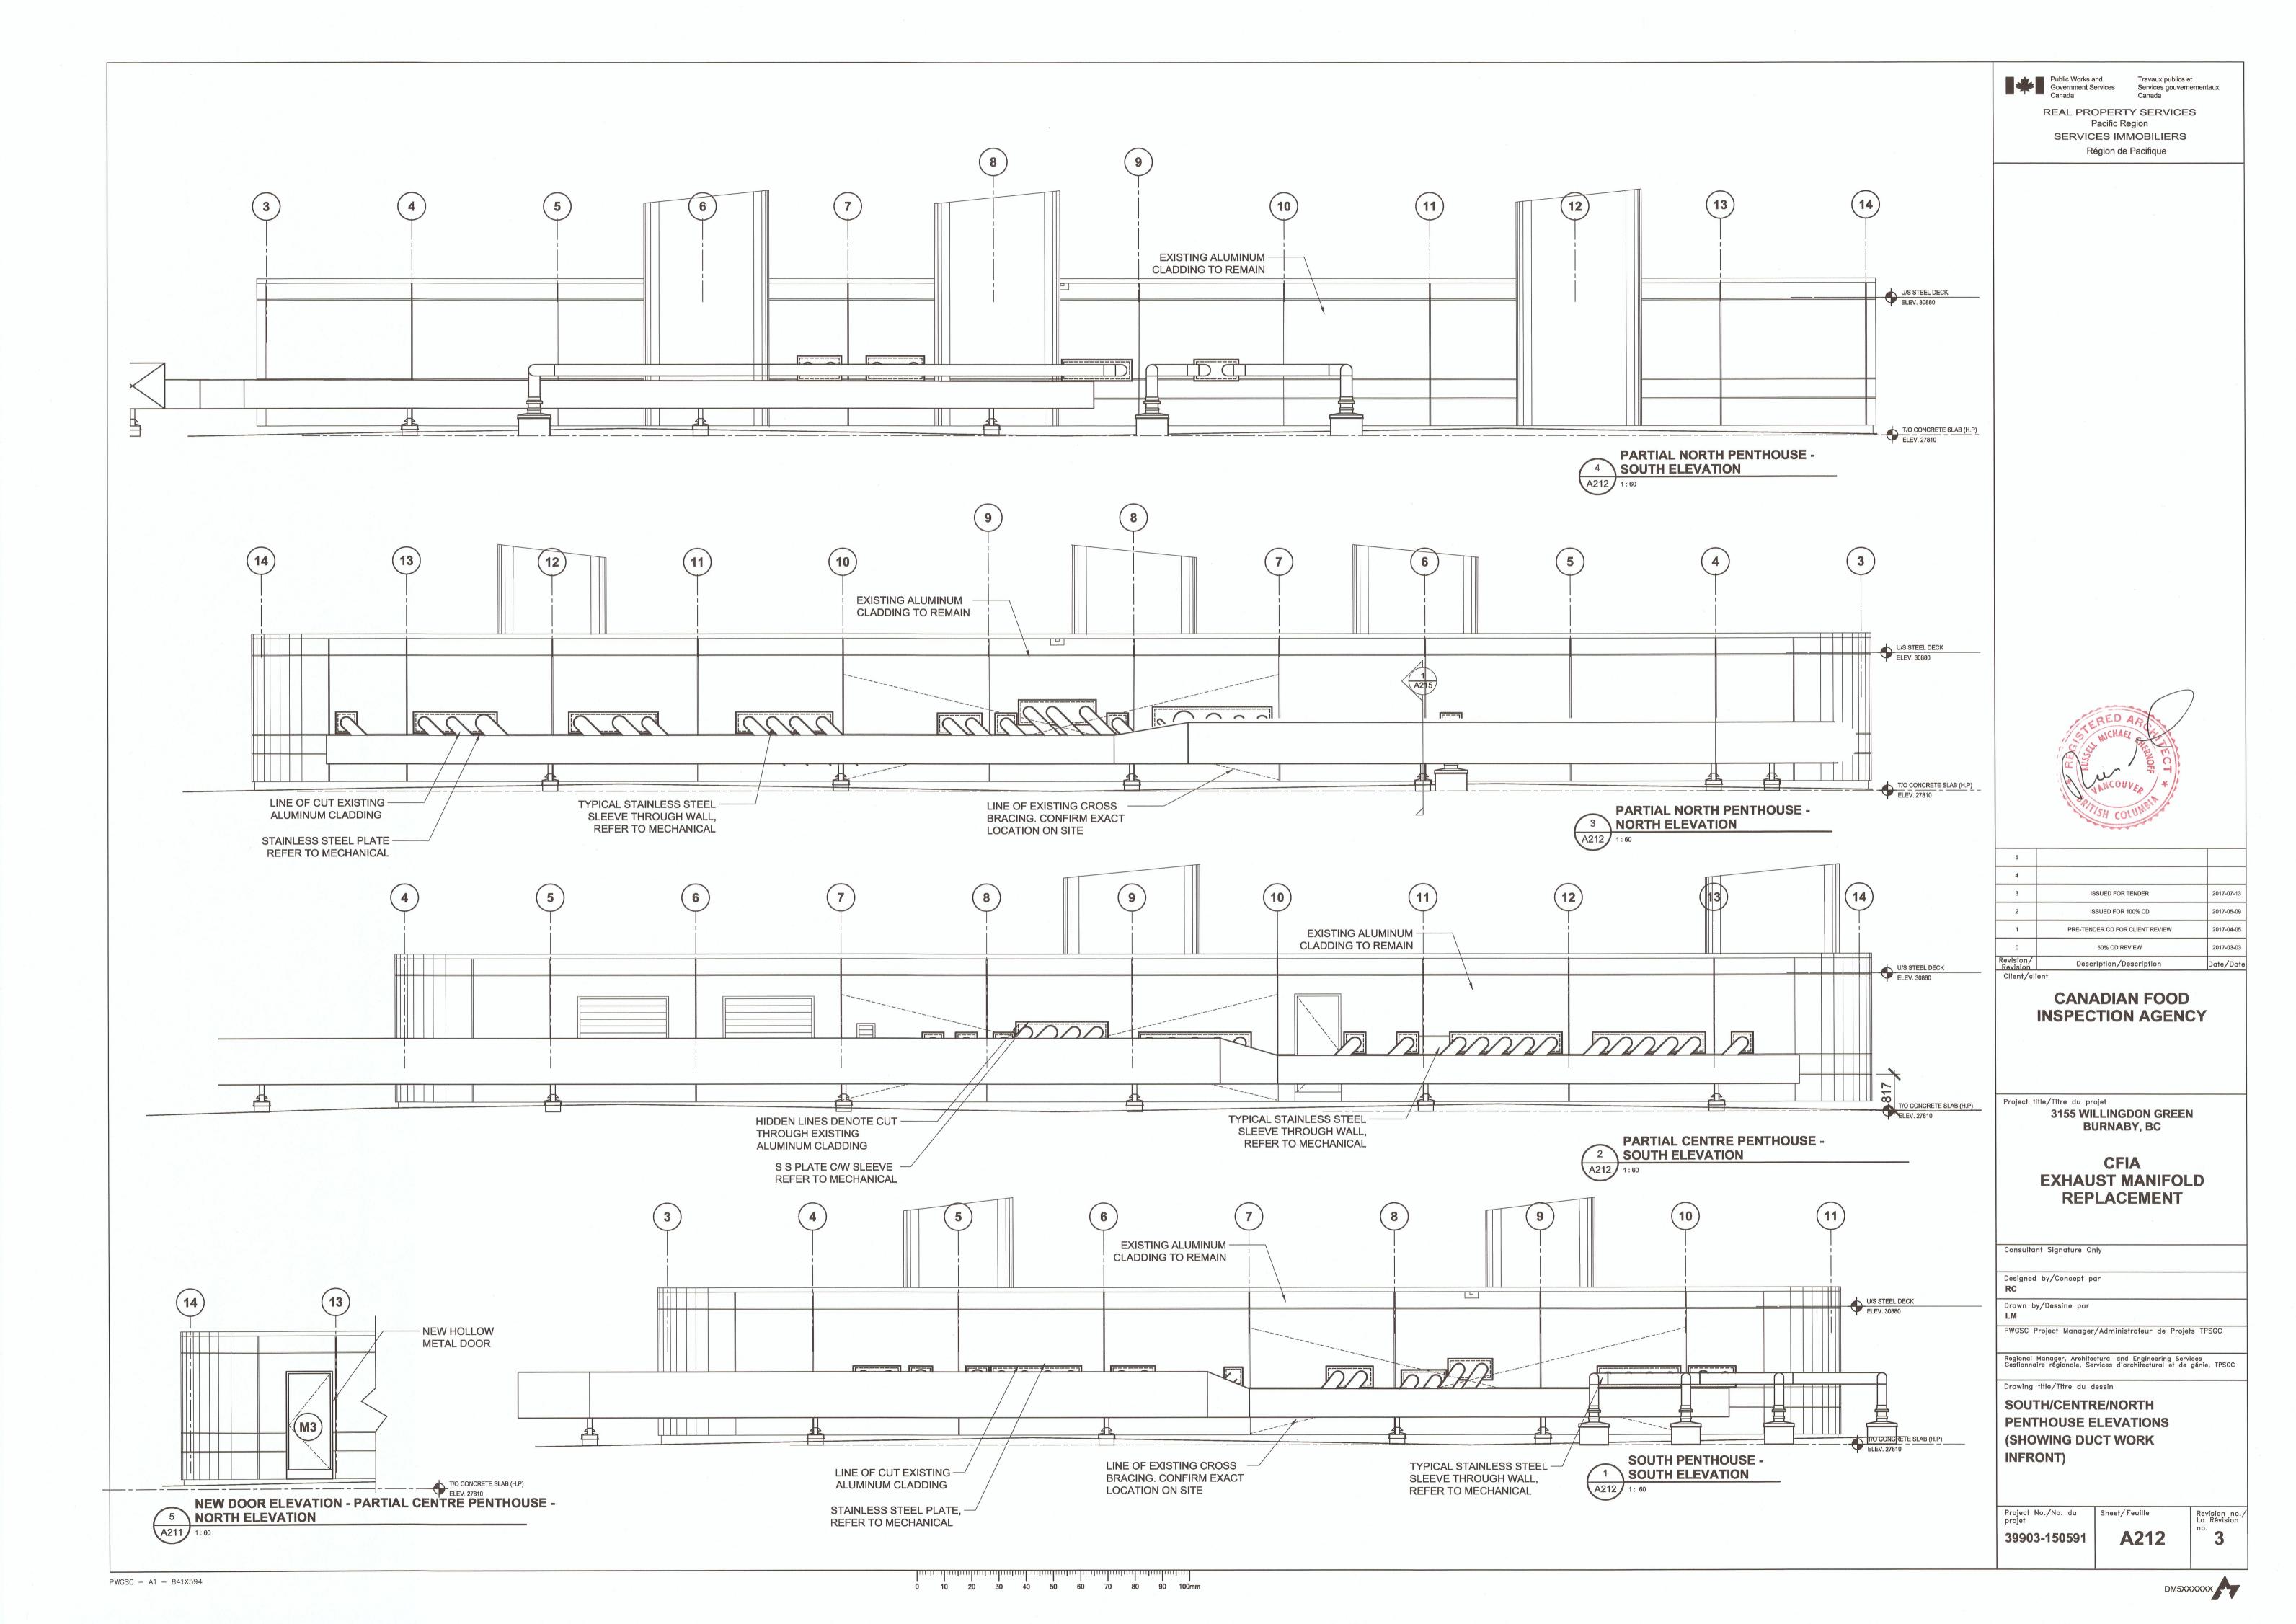
Revision no. La Révision





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Client /elient		




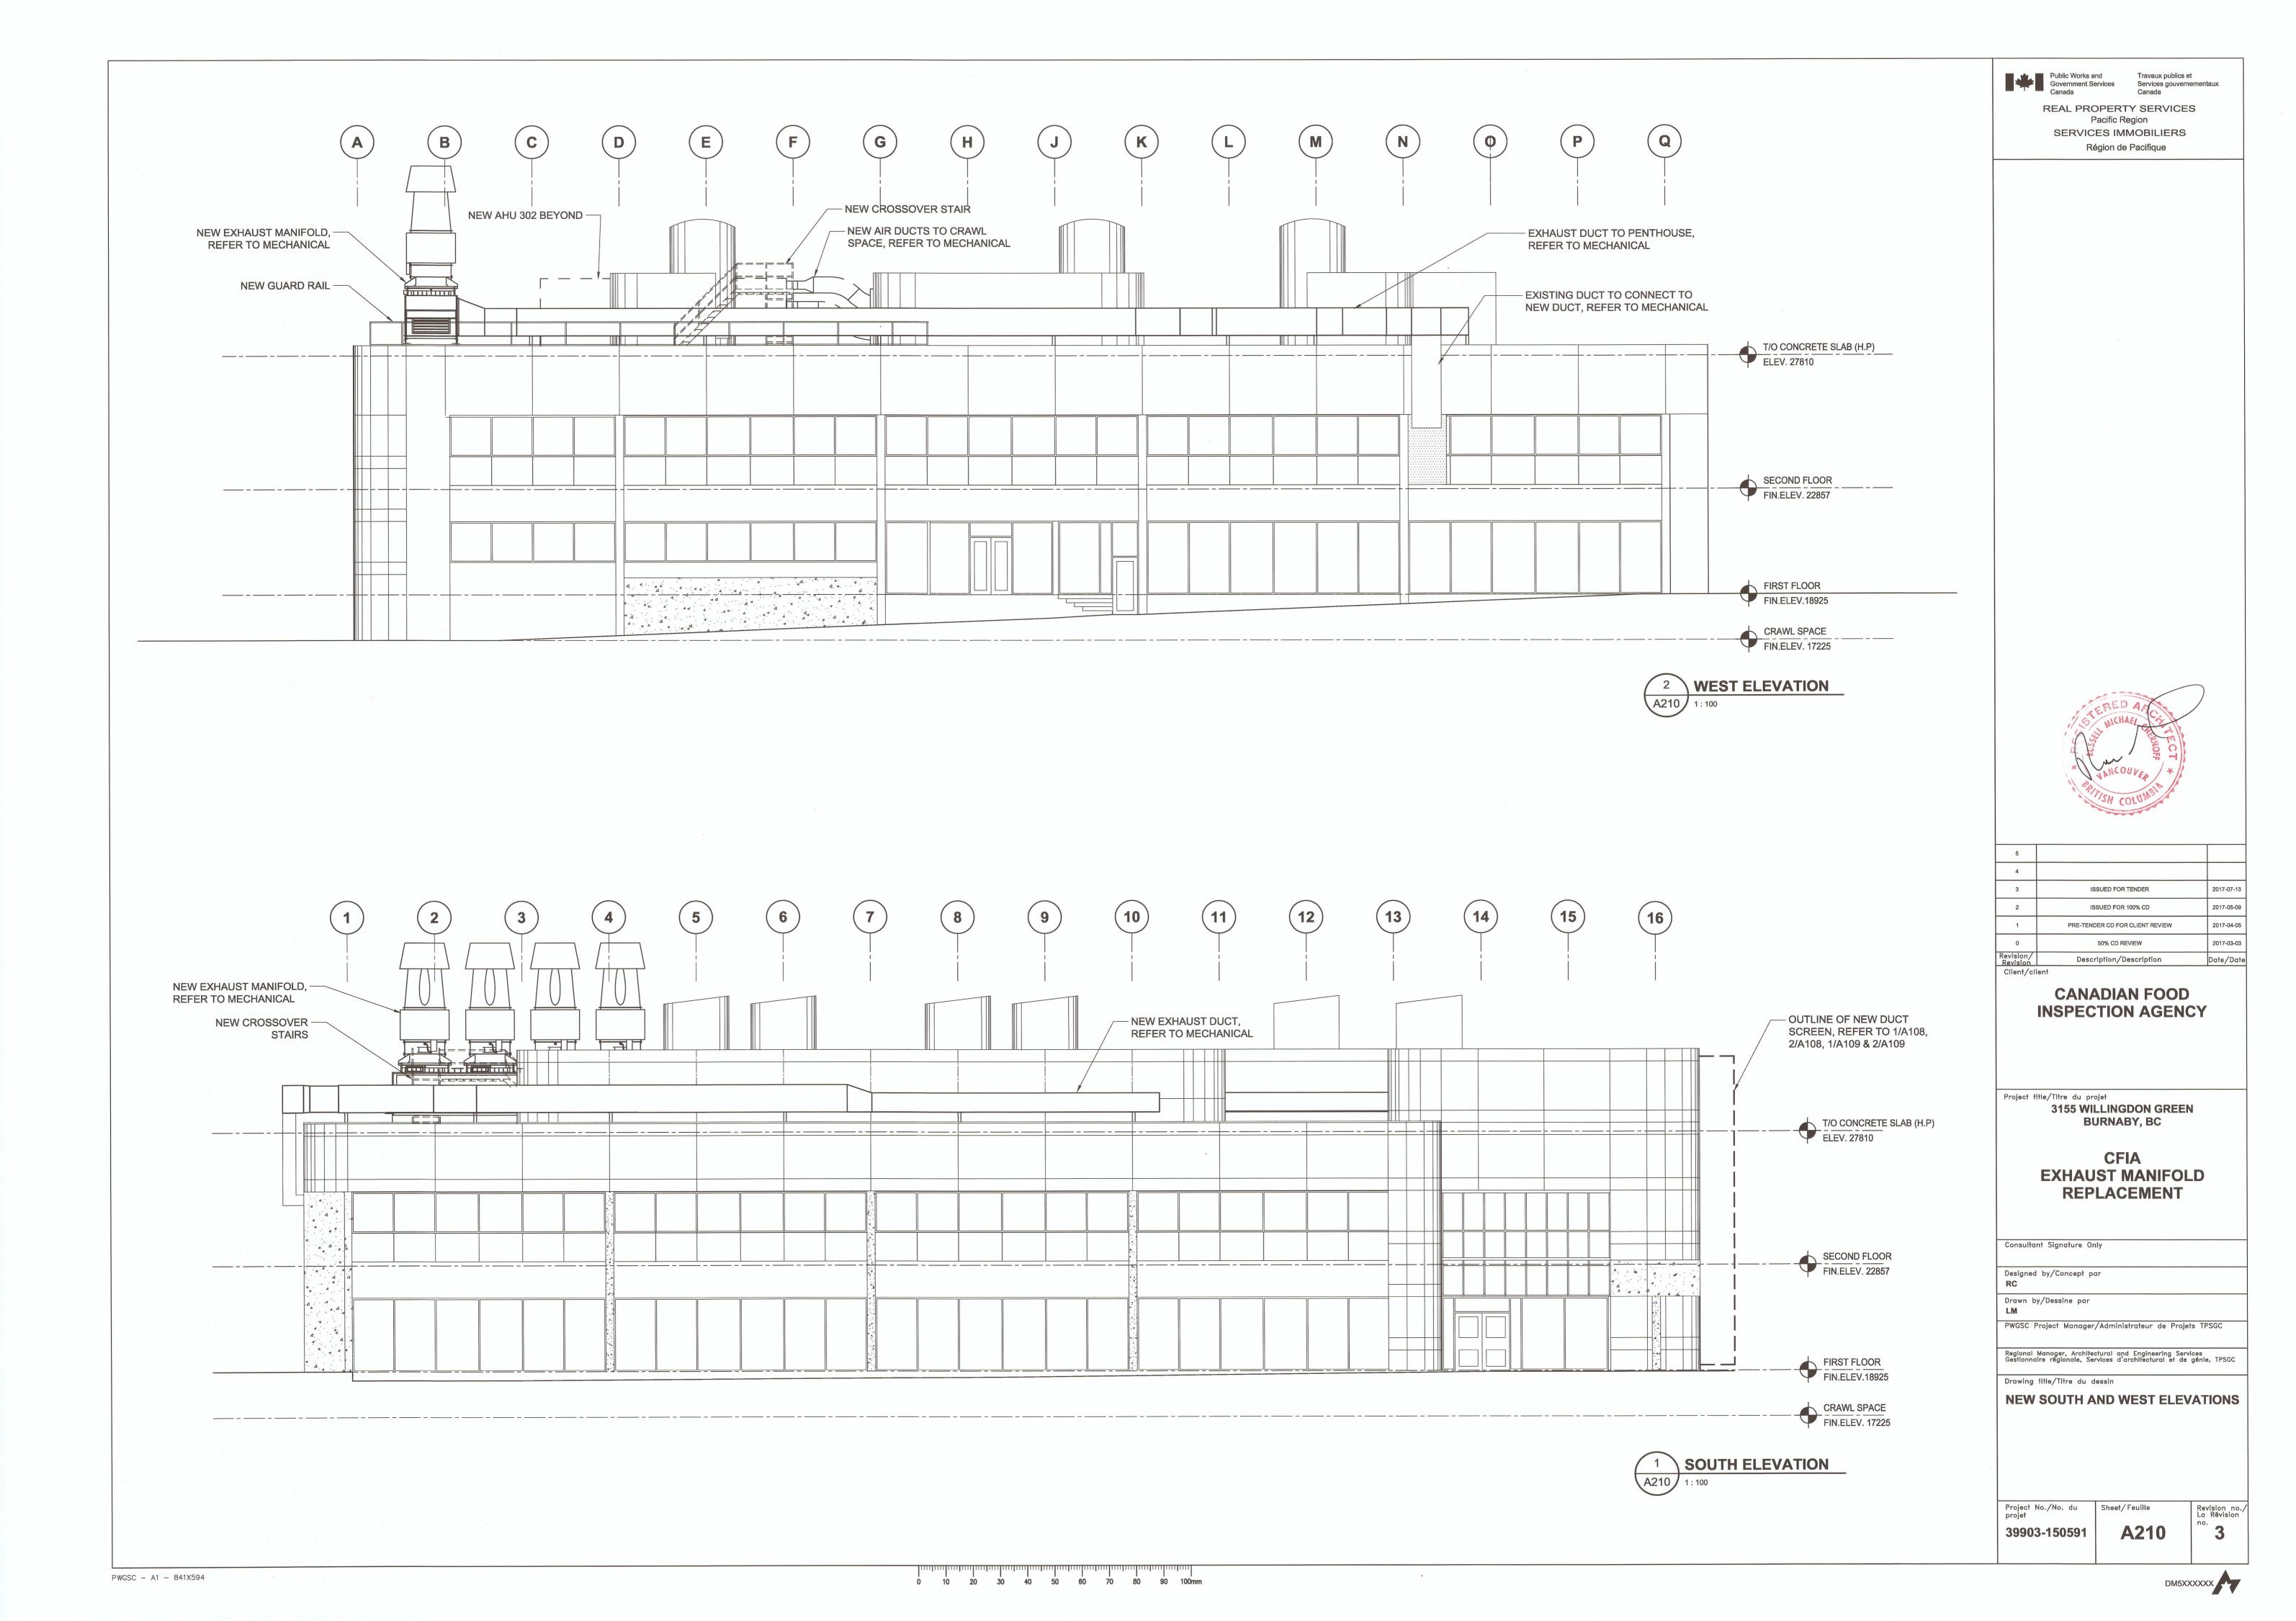

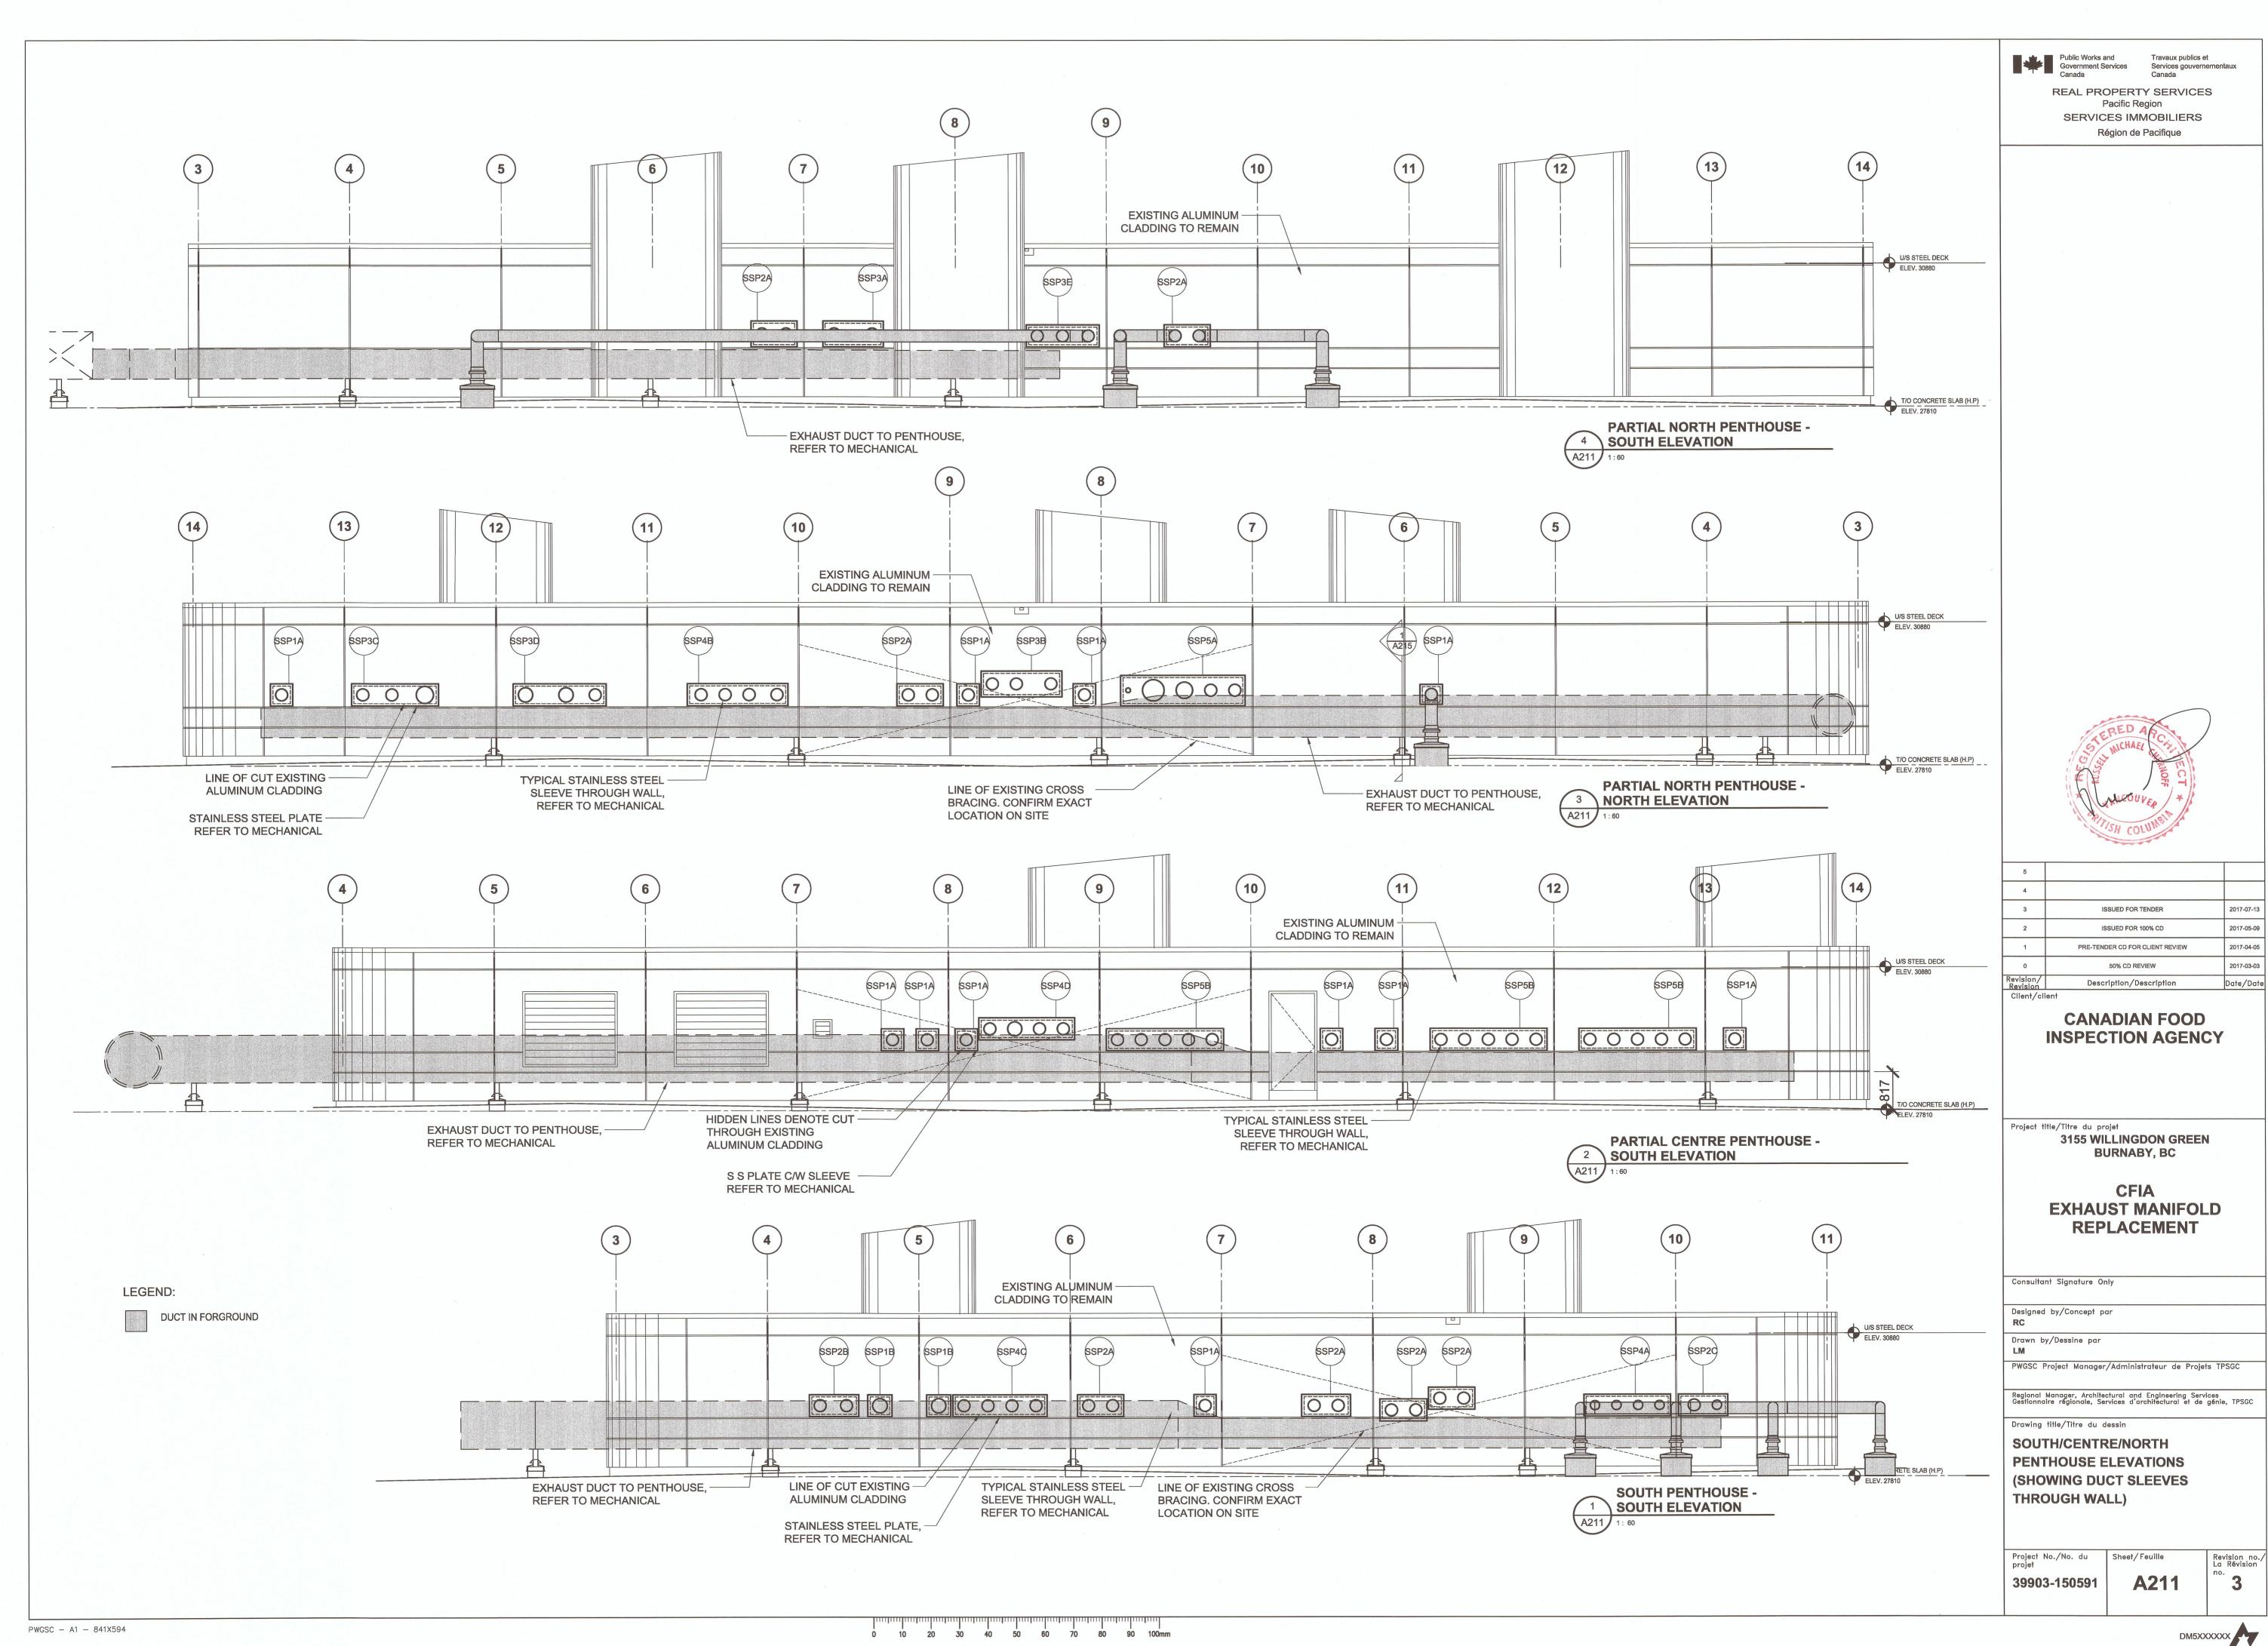

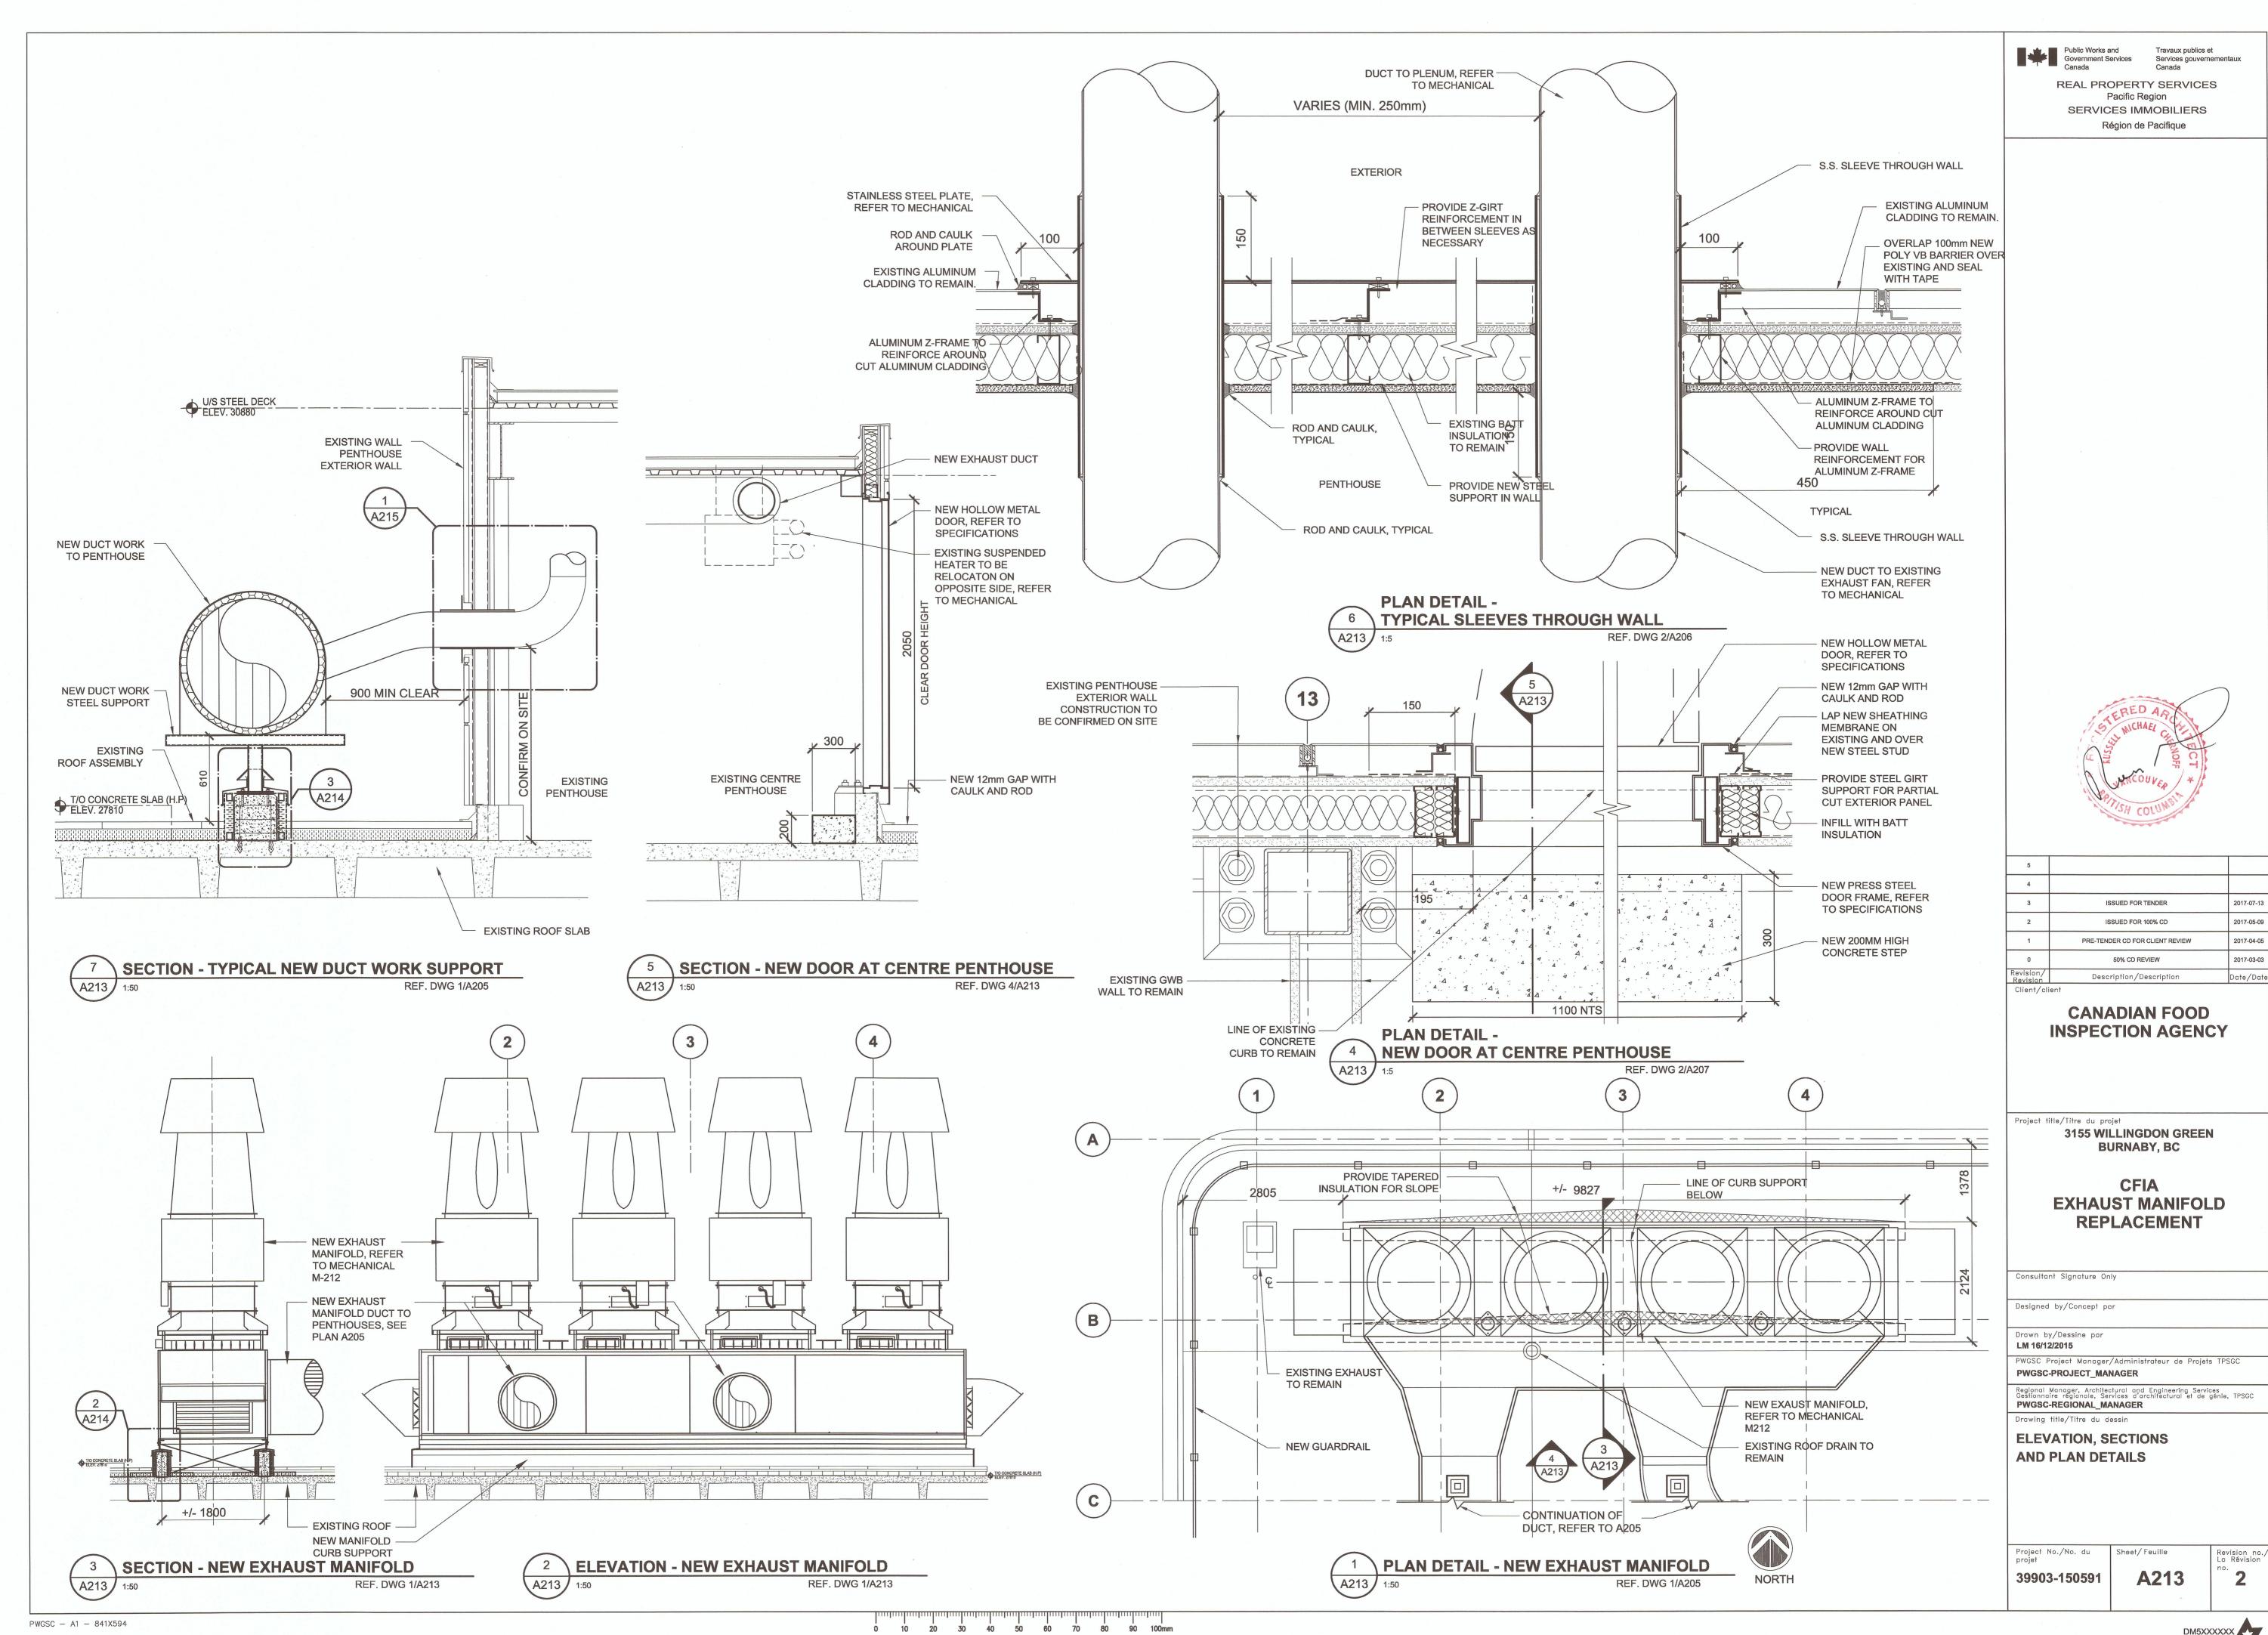

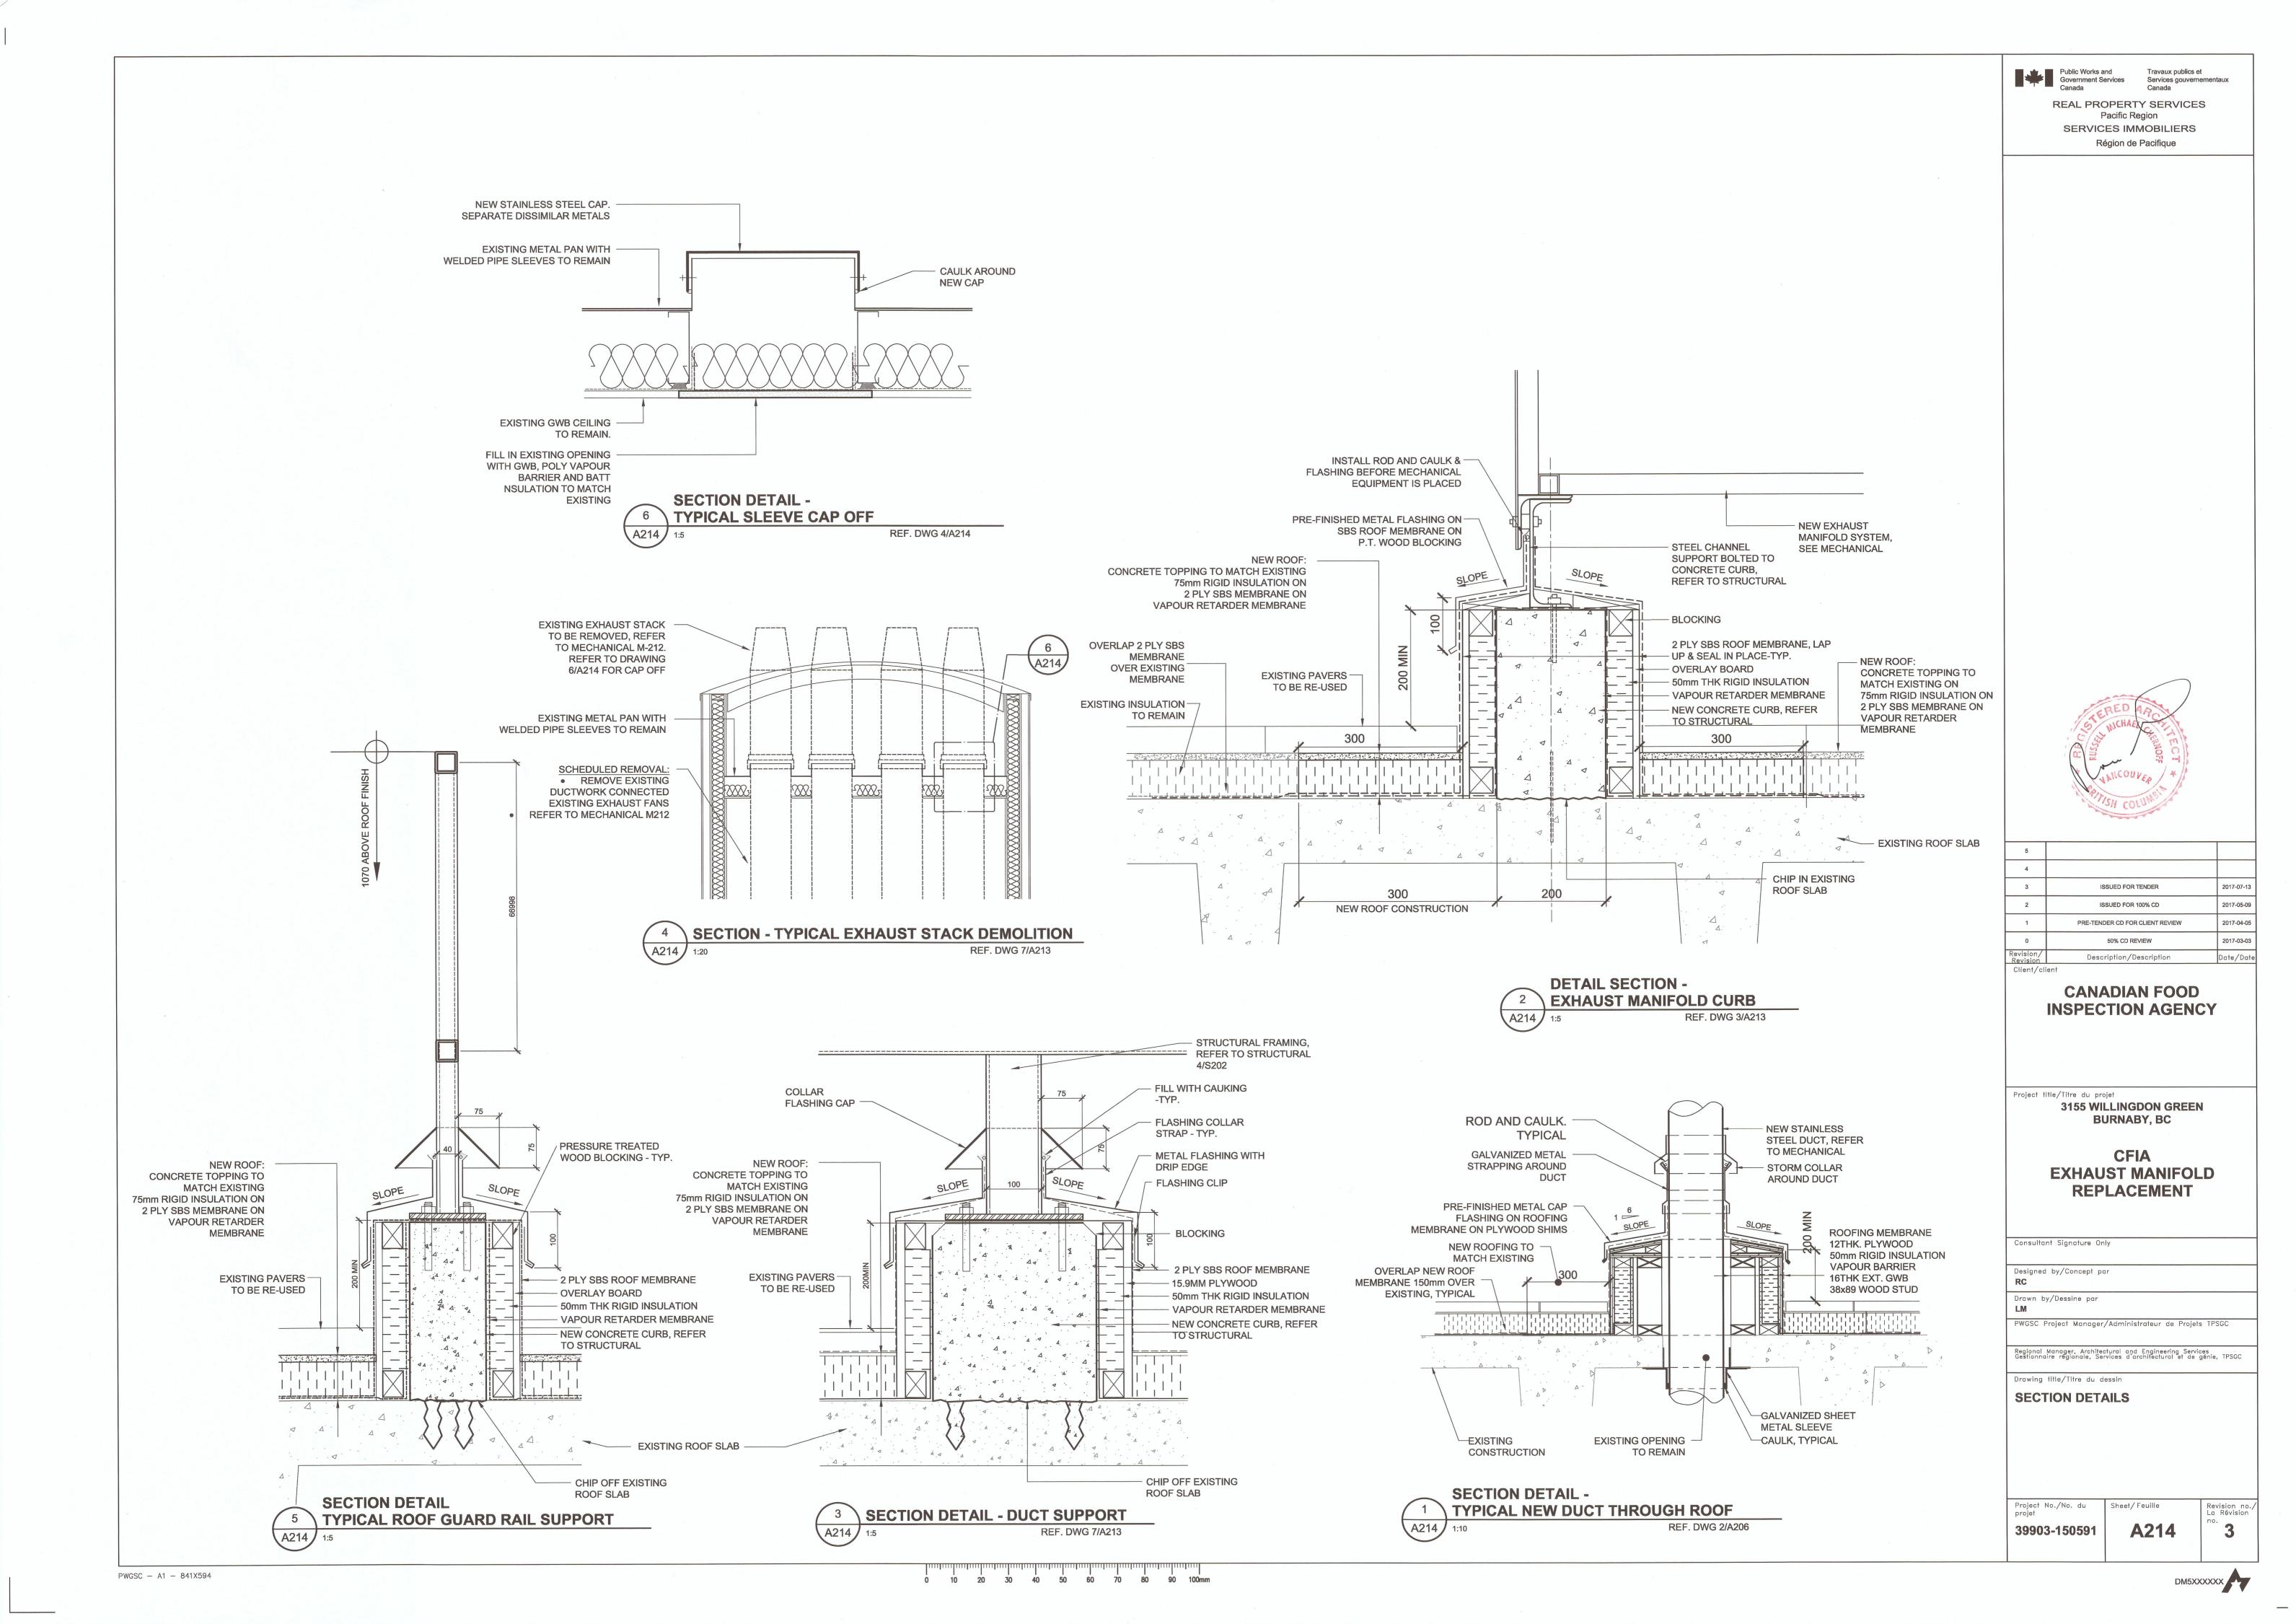

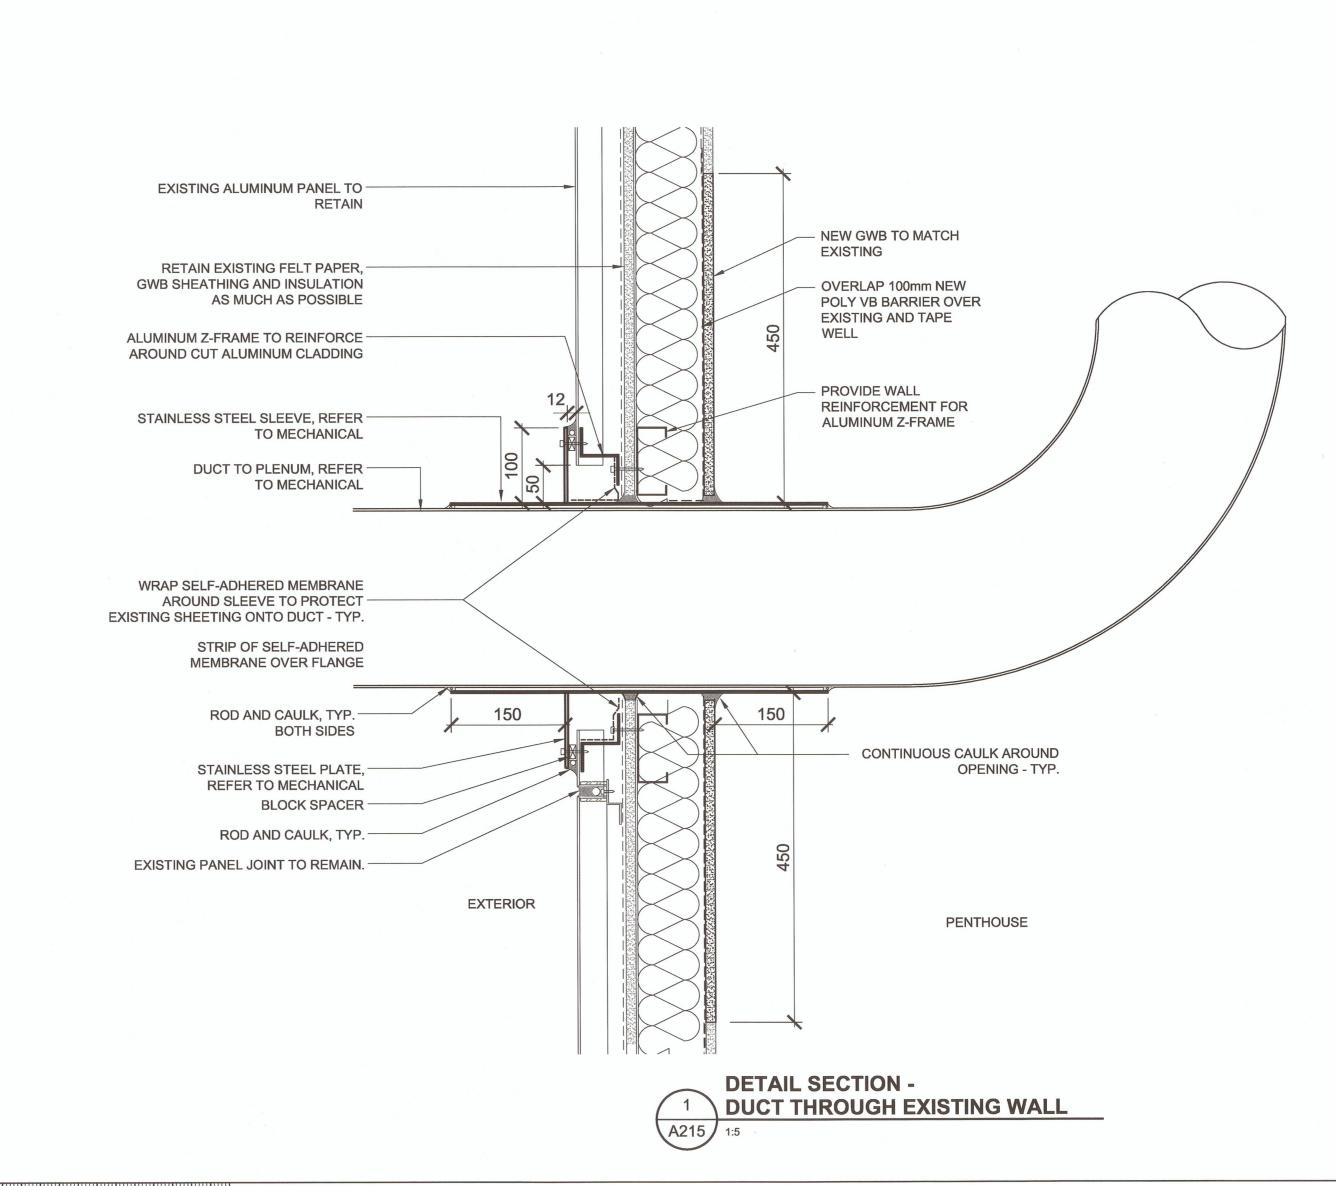



Public Works and
Government Services
Canada

Canada

Travaux publics et
Services gouvernementaux
Canada

REAL PROPERTY SERVICES Pacific Region SERVICES IMMOBILIERS Région de Pacifique



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4	
3 ISSUED FOR TENDER 20	017-07-1
2 ISSUED FOR 100% CD 26	017-05-0
1 PRE-TENDER CD FOR CLIENT REVIEW 20	017-04-0
0 50% CD REVIEW 20	017-03-0
Revision/ Description/Description Do	ate/Da

Client/client

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3155 WILLINGDON GREEN **BURNABY, BC** 

**CFIA EXHAUST MANIFOLD REPLACEMENT** 

Consultant Signature Only

Designed by/Concept par Drawn by/Dessine par

PWGSC Project Manager/Administrateur de Projets TPSGC PWGSC-PROJECT\_MANAGER

Regional Manager, Architectural and Engineering Services Gestionnaire régionale, Services d'architectural et de génie, TPSGC PWGSC-REGIONAL\_MANAGER


**SECTION DETAILS** 


Drawing title/Titre du dessin

Project No./No. du projet

Revision no./ La Révision

A215 39903-150591

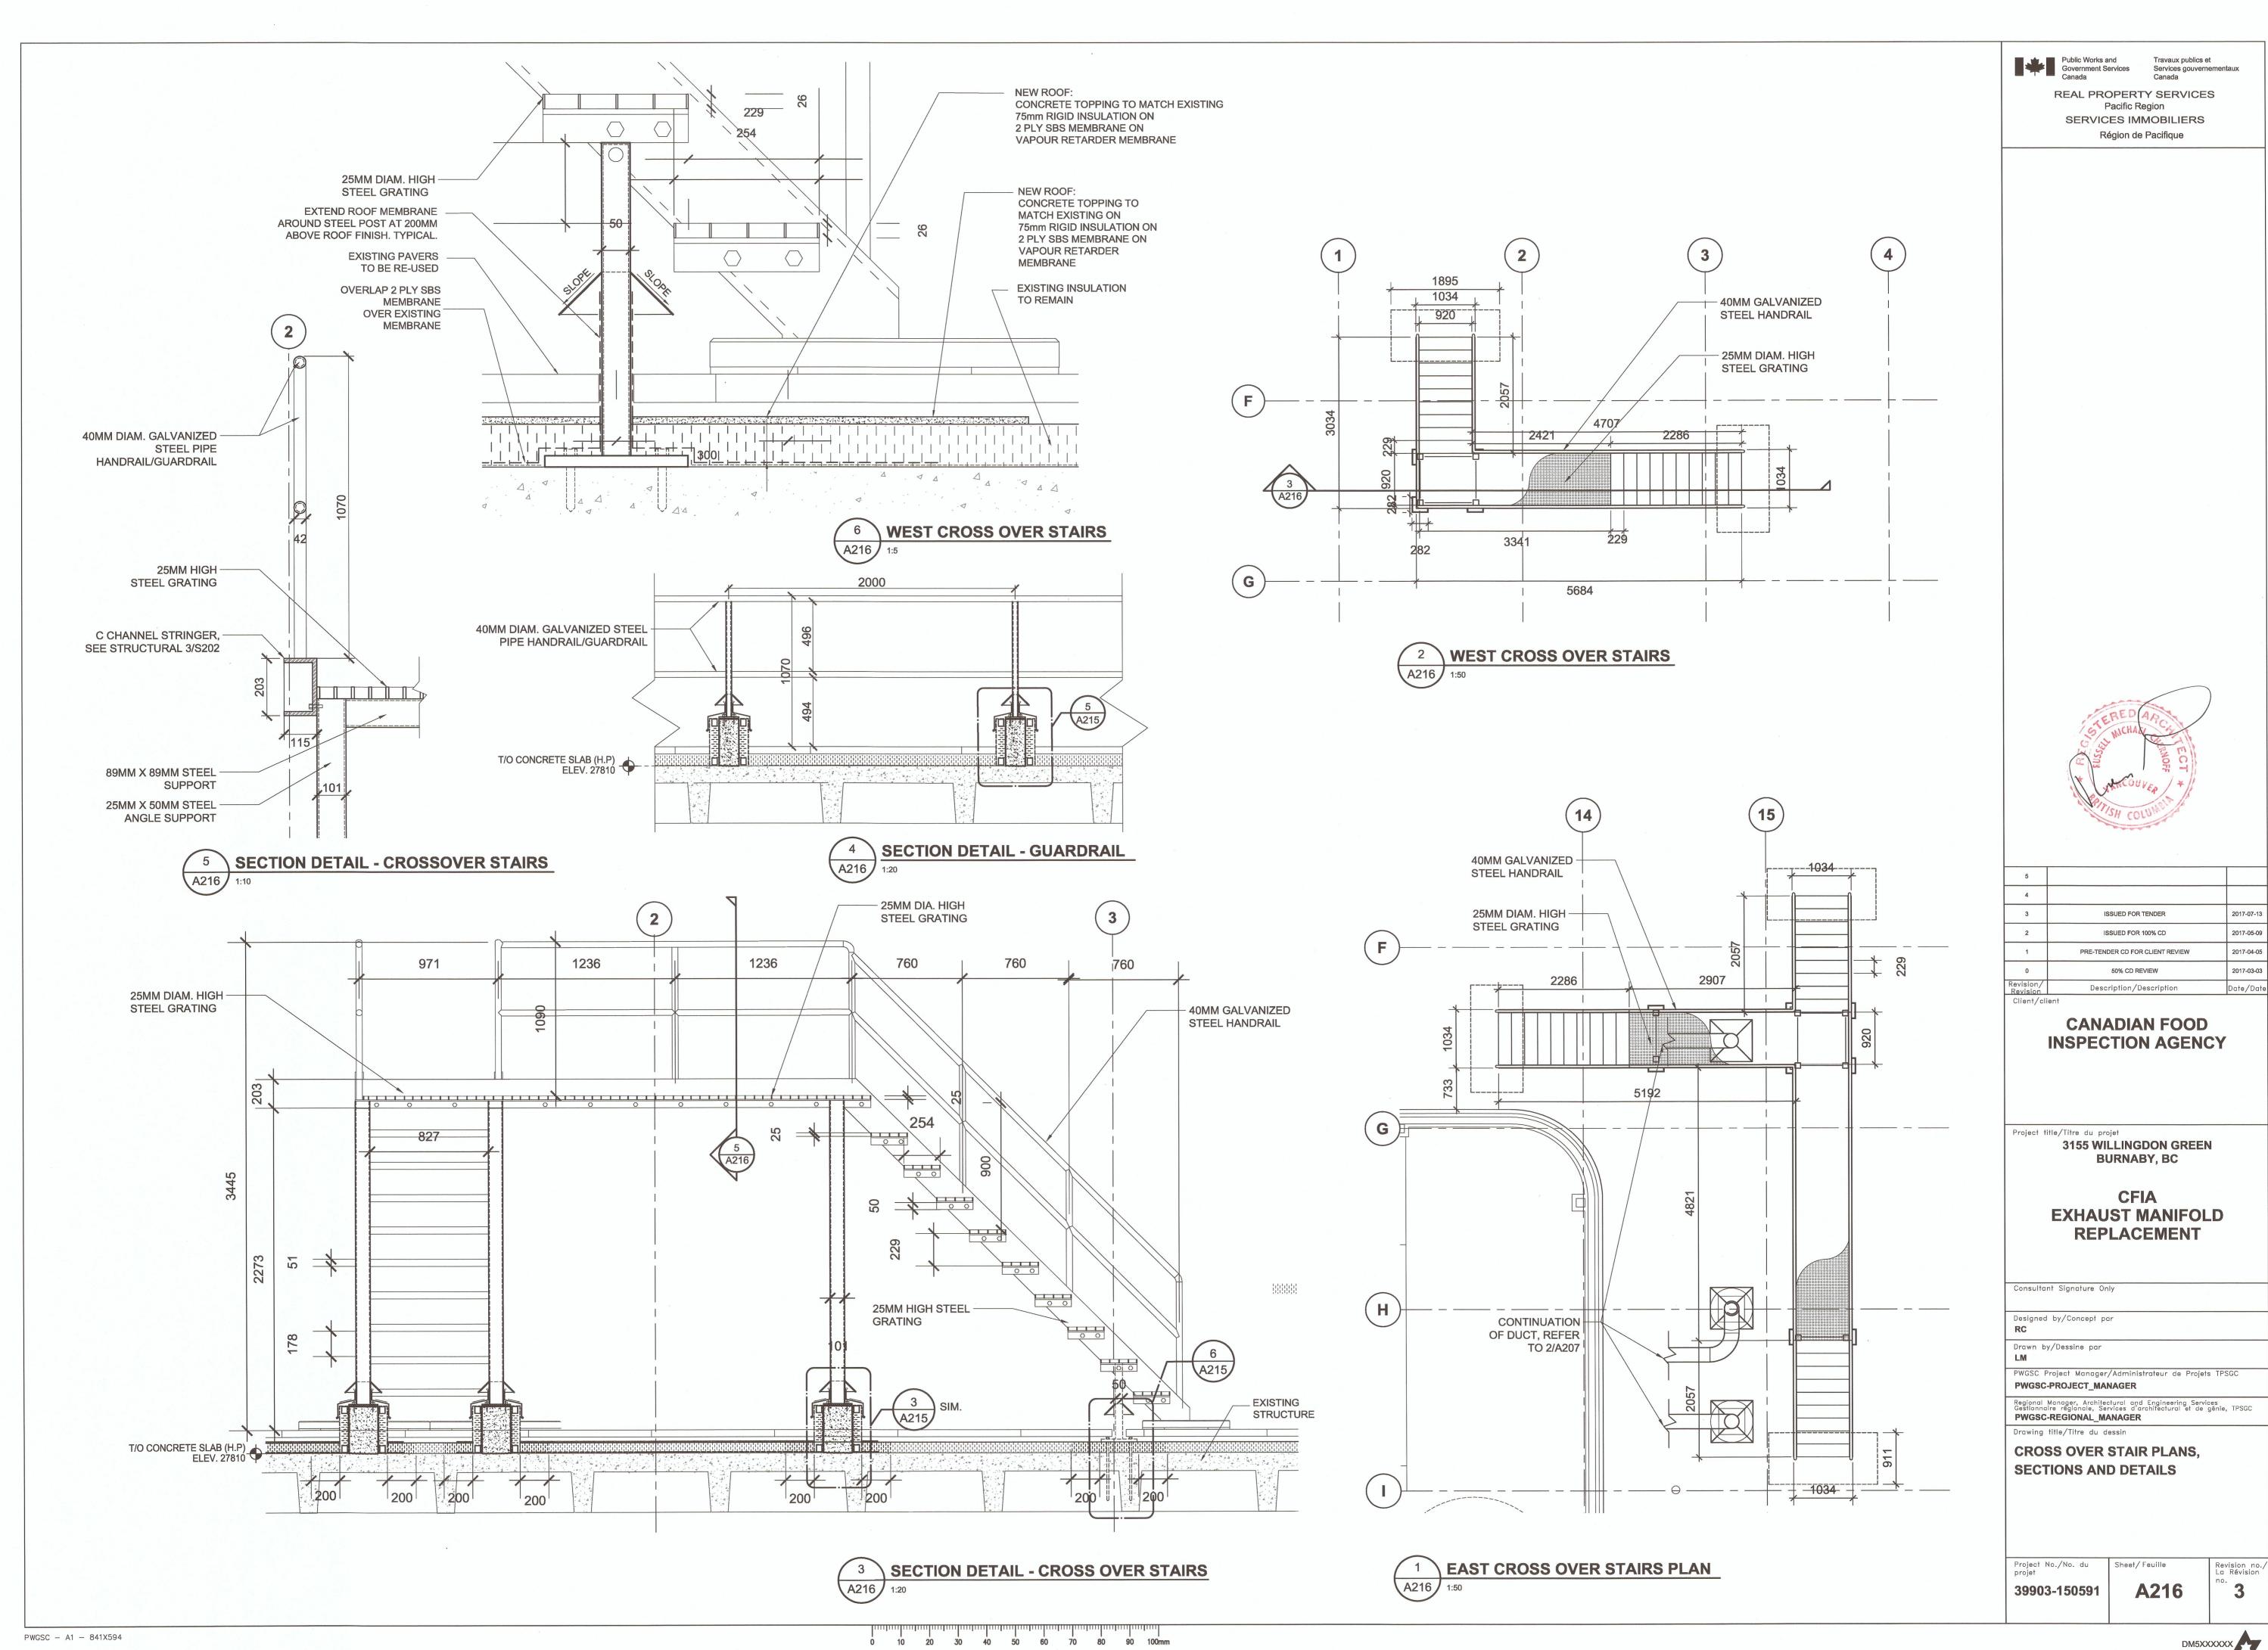

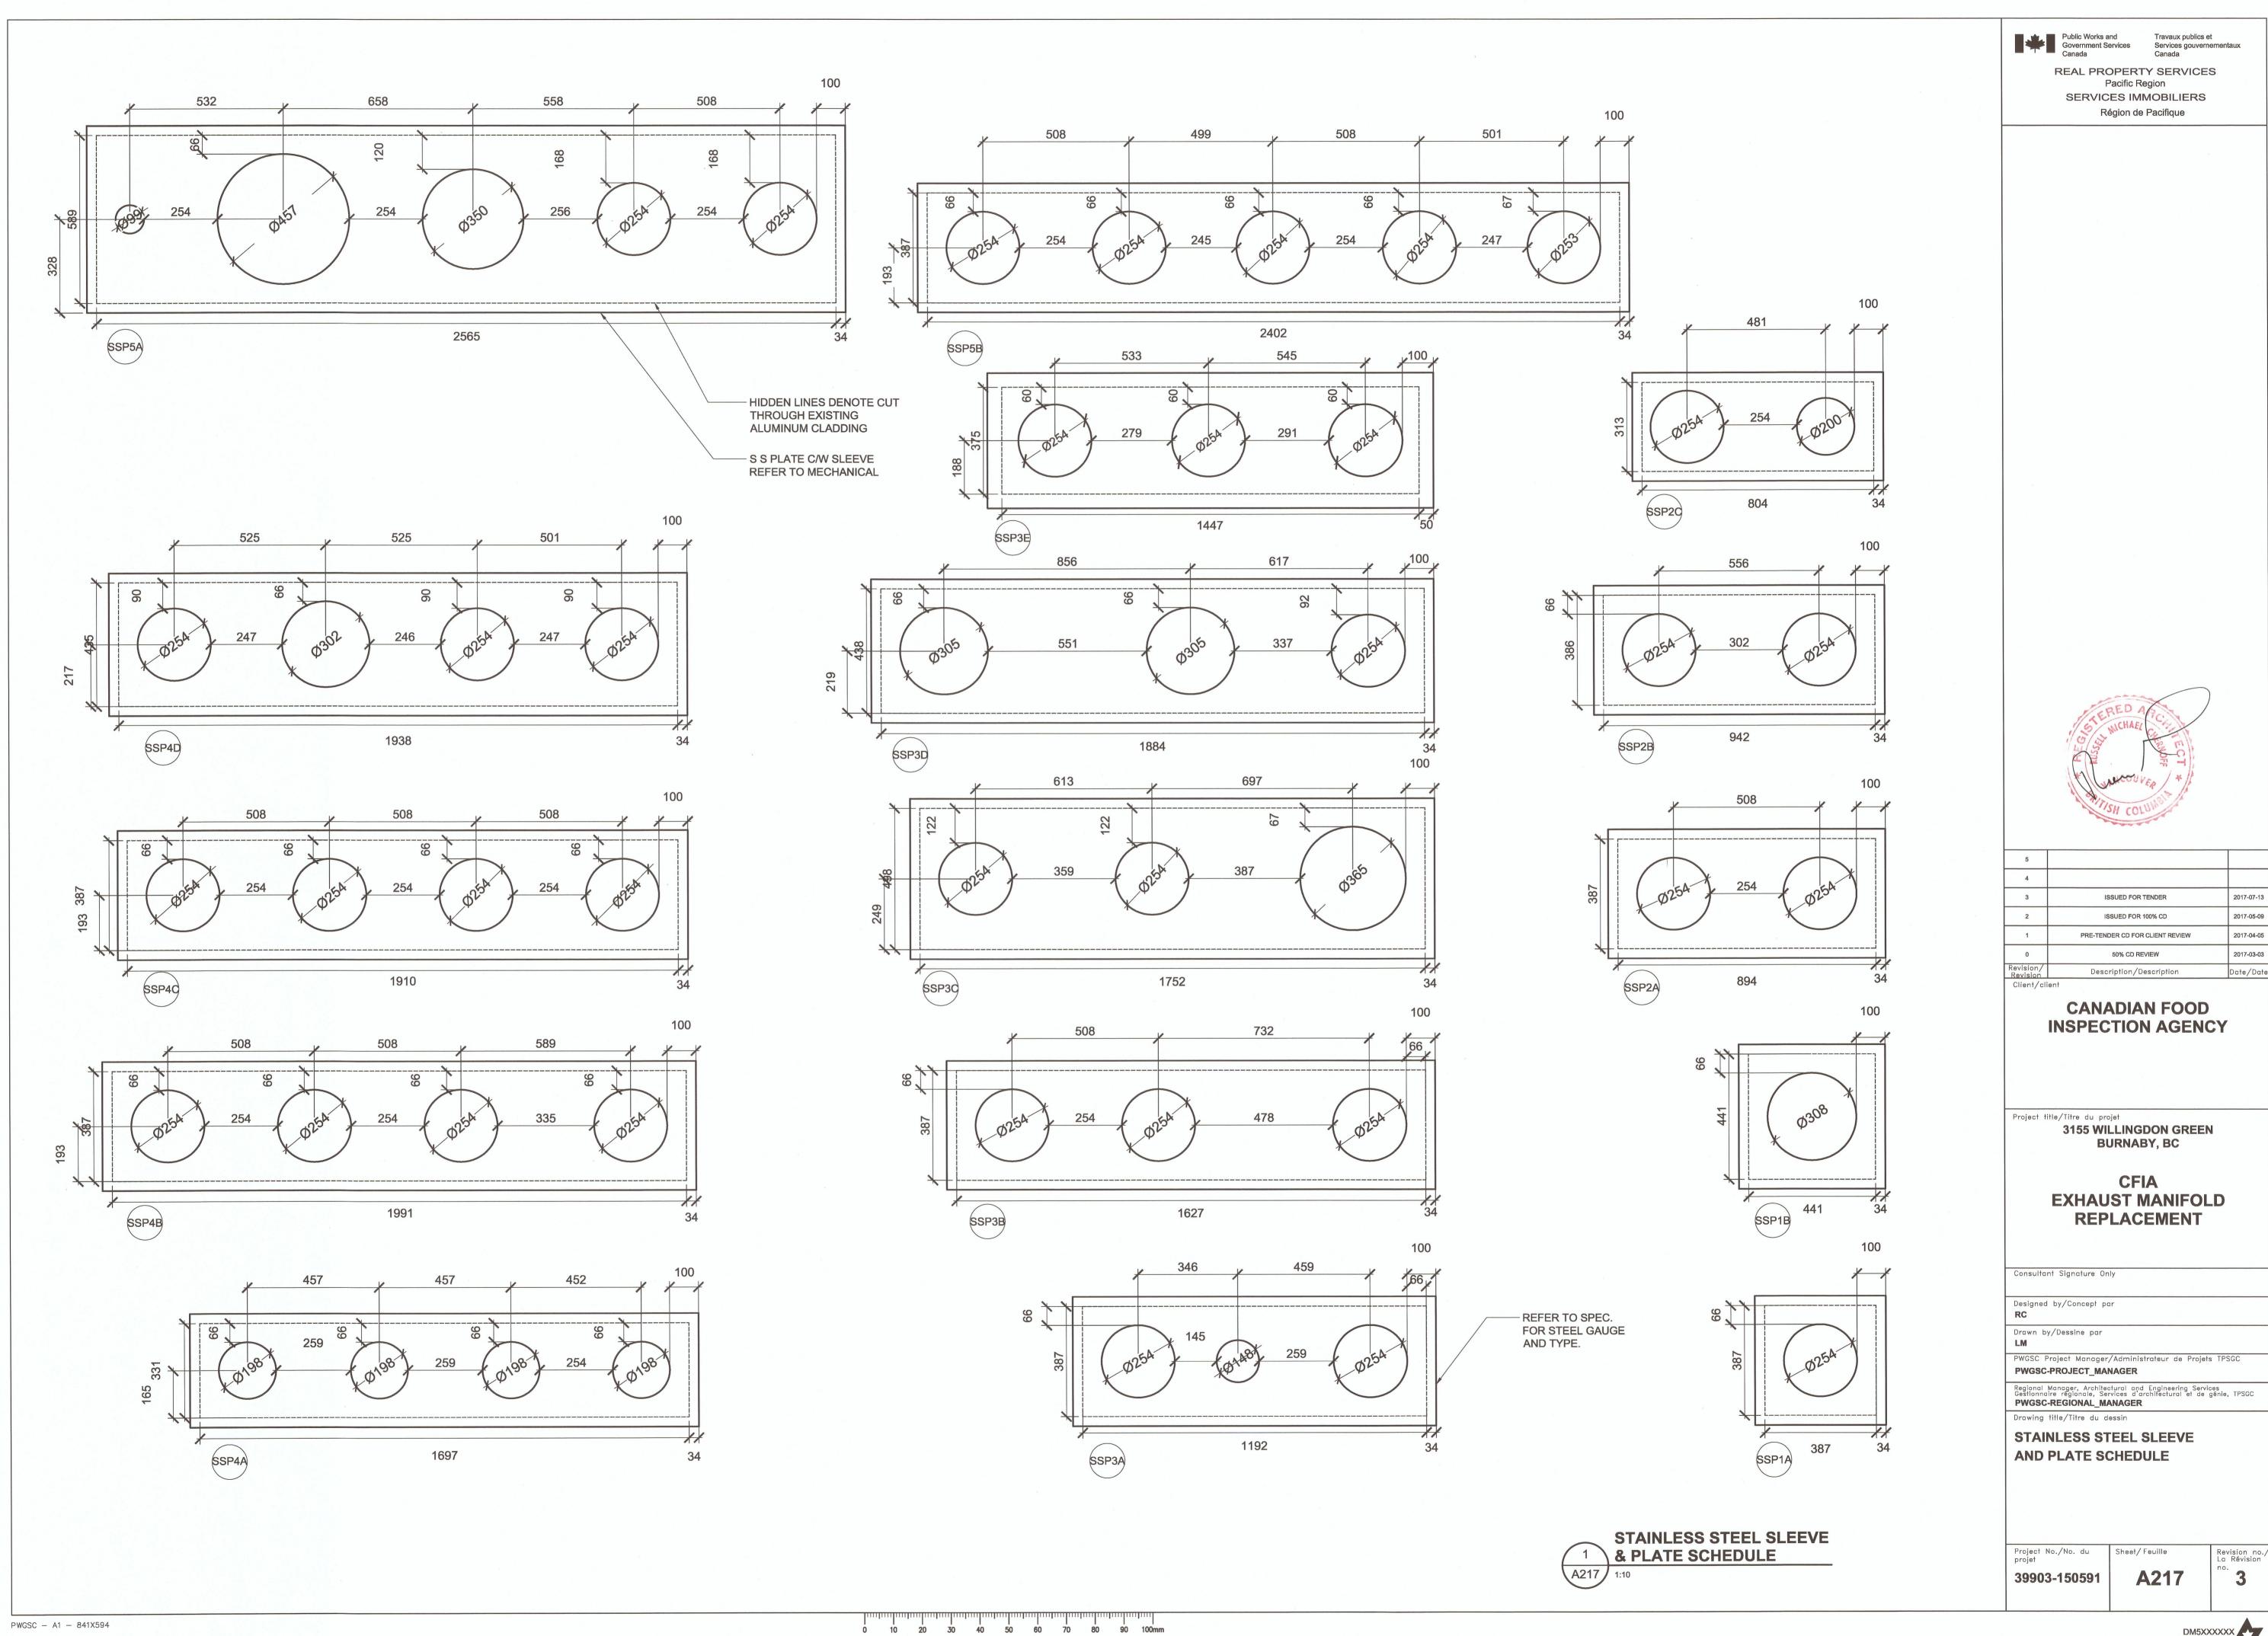

**DESIGN CODE** 1. THE STRUCTURAL WORK SHOWN ON THE STRUCTURAL DRAWINGS HAS BEEN DESIGNED IN SUBSTANTIAL ACCORDANCE WITH THE BRITISH COLUMBIA BUILDING CODE 2012 WHICH IS BASED ON THE NATIONAL BUILDING CODE OF CANADA 2010. FIELD REVIEW 1. FIELD REVIEW IS PROVIDED FOR THE WORK SHOWN ON THESE STRUCTURAL DRAWINGS. THIS REVIEW IS NOT A "FULL TIME" REVIEW BUT IS CONDUCTED WITH SUCH FREQUENCY AS IS DEEMED APPROPRIATE TO OBSERVE VARIOUS STAGES OF THE WORK AND TO ASCERTAIN THAT THE WORK IS IN GENERAL CONFORMANCE WITH THE PLANS AND SUPPORTING DOCUMENTS. FIELD REVIEW IS NOT CARRIED OUT FOR THE CONTRACTOR'S BENEFIT. IT REMAINS THE CONTRACTOR'S RESPONSIBILITY TO BUILD THE WORK IN CONFORMANCE WITH THE CONTRACT DOCUMENTS. WE WILL REVIEW SHOP DRAWINGS PERTAINING TO WORK SHOWN ON THESE DRAWINGS. THE EXTENT OF THIS REVIEW IS AT OUR SOLE DISCRETION AND IS FOR THE SOLE PURPOSE OF ASCERTAINING GENERAL CONFORMANCE WITH THE STRUCTURAL DESIGN CONCEPT. THE REVIEW IS NOT AN APPROVAL OF THE DESIGN, DETAILS, AND DIMENSIONS INHERENT IN THE SHOP DRAWINGS, RESPONSIBILITY FOR WHICH SHALL REMAIN WITH THE CONTRACTOR OR SUBCONTRACTOR SUBMITTING THEM. SUCH REVIEW SHALL NOT RELIEVE THE CONTRACTOR OR SUBCONTRACTOR OF HIS OR HER RESPONSIBILITY FOR ERRORS AND OMISSIONS IN THE SHOP DRAWINGS OR FOR MEETING ALL REQUIREMENTS OF THE CONTRACT DOCUMENTS. PROVIDE 24 HOURS ADVANCE NOTICE OF EACH REQUIRED FIELD REVIEW. FIELD REVIEWS SHALL BE SCHEDULED TO BE CARRIED OUT DURING NORMAL BUSINESS HOURS UNLESS SPECIAL ARRANGEMENTS ARE MADE. THE WORK TO BE REVIEWED SHALL BE GENERALLY COMPLETE. MICRO PILES 1) MICRO PILE FOUNDATION DESIGN IS BASED ON THE GEOTECHNICAL REPORT WSP CANADA INC. DATED: MARCH 29, 2017 2) ENSURE THAT THE REQUIREMENTS OUTLINED IN THE GEOTECHNICAL REPORT AND SHOWN ON THE STRUCTURAL DRAWINGS AND IN THE SPECIFICATION ARE UNDERSTOOD PRIOR TO COMMENCING WITH FOUNDATION WORK. 3) ALL MICRO PILES TO BE #18 REINFORCING STEEL BARS, DOUBLE CORROSION PROTECTED, Fy = 75 ksi, IN MINIMUM 200mm DIAMETER DRILLED HOLES COMPLETED WITH CASED HOLES, HIGH PRESSURE GROUTED (200-300 PSI). DO NOT WELD TO MINI-PILE BARS. 4) SEE GEOTECHNICAL REPORT FOR SPEICFIC REQUIREMENTS ON MATERIALS, INSTALLATION PROCEDURES, TESTING, ETC. 5) SEE GEOTECHNICAL REPORT FOR CASING REQUIREMENTS. 6) SEE FOR LOCATIONS OF ALL MICRO PILES ON PLAN. 7) SEE MICRO PILE DETAIL FOR TYPICAL MICRO PILE CONFIGURATION AT PILECAP. CONCRETE CONCRETE PROPERTIES: GENERAL (AREAS NOT INCLUDING PARKING) ELEMENT COMPRESSIVE EXPOSURE COMMENTS CLASS 28 DAYS U.N.O. ALL CONCRETE 25 MPa F-2

LIST OF STRUCTURAL DRAWINGS

S101 - AHUR GENERAL NOTES AND TYPICAL DETAILS

S102 - AHUR 101 & 102 FRAMING PLANS, CONCRETE PAD PLAN AND DETAILS

S103 - AHUR 101 & 102 FRAMING ELEVATION, SECTIONS AND DETAILS

S104 - AHUR 302 ROOF FRAMING PLAN AND DETAILS

#### DRAWINGS

- THIS SET OF DRAWINGS SHOWS THE COMPLETED PROJECT. THE DRAWINGS DO NOT SHOW COMPONENTS THAT MAY BE NECESSARY FOR CONSTRUCTION SAFETY. THE GENERAL CONTRACTOR IS RESPONSIBLE FOR SAFETY IN AND ABOUT THE JOB SITE DURING CONSTRUCTION, AND THE DESIGN AND ERECTION OF ALL TEMPORARY STRUCTURES, FORMWORK, FALSE WORK, SHORING, ETC. REQUIRED TO COMPLETE
- THE USE OF THESE DRAWINGS IS LIMITED TO THAT IDENTIFIED IN THE REVISIONS COLUMN. DO NOT CONSTRUCT FROM THESE DRAWINGS UNLESS MARKED "ISSUED FOR CONSTRUCTION" IN THE REVISIONS COLUMN, BY READ JONES CHRISTOFFERSEN LTD. THE DRAWINGS SHALL NOT BE USED FOR PRICING, COSTING, OR TENDER UNLESS SO INDICATED IN THE REVISION COLUMN. PRICING OR COSTING DRAWINGS ARE NOT COMPLETE AND ANY PRICES BASED ON PRICING OR COSTING DRAWINGS MUST INCLUDE ALLOWANCES FOR THIS.
- THE INFORMATION ON THESE DRAWINGS SHALL NOT BE USED FOR ANY OTHER PROJECT OR WORKS. THE INFORMATION ON THESE DRAWINGS APPLIES SOLELY TO

#### **GENERAL**

1. SECTION MARK SHOWN THUS (4) MEANS SECTION #4 ON DRAWING S103. SEE ARCHITECTURAL, MECHANICAL AND ELECTRICAL DRAWINGS FOR SLEEVES, NAILERS, INSERTS, ETC., TO BE ENCASED IN CONCRETE.

SEE ARCHITECTURAL DRAWINGS FOR FLOOR AND ROOF ELEVATIONS, RECESSES, DRAINAGE SLOPES, ETC.

4. THE GENERAL CONTRACTOR SHALL REVIEW ALL THE DRAWINGS AND CHECK DIMENSIONS BEFORE CONSTRUCTION. REPORT DISCREPANCIES BETWEEN STRUCTURAL AND OTHER DISCIPLINES DRAWINGS FOR CLARIFICATION.

CONCRETE WORK
SHALL CONFORM TO CSA A23.1, CSA A23.2, CSA A23.3 AND REFERENCED DOCUMENTS.

STRUCTURAL STEEL WORK
SHALL CONFORM TO CSA S16 AND REFERENCED DOCUMENTS.

FIRE RESISTANCE RATINGS
SEE ARCHITECTURAL DRAWINGS AND SPECIFICATIONS FOR PRECISE LOCATION OF

REQUIRED FIRE RESISTANCE RATINGS.

DO NOT CUT OR DRILL ANY OPENINGS IN STRUCTURAL MEMBERS WITHOUT WRITTEN

REFER TO ARCHITECTURAL, MECHANICAL, ELECTRICAL, AND LANDSCAPE DRAWINGS FOR LOCATIONS, CONFIGURATIONS, EXTENT, AND SIZES OF ALL CURBS, UPSTANDS, DOWNTURNS: AND FOR OPENINGS THROUGH FLOORS AND WALLS FOR DUCTS, CONDUIT AND PIPING. PROVIDE FOR SAME.

10. ABBREVIATIONS:

A.B. — ANCHOR BOLT L.L.H. --- LONG LEG HORIZONTAL L.L.V. — LONG LEG VERTICAL ALT. ——— ALTERNATE ARCH. —— ARCHITECTURAL LS.H. — LONG SIDE HORIZONTAL B.C.E. —— BOTTOM CHORD EXTENSION L.S.V. —— LONG SIDE VERTICAL B.L.L.—— BOTTOM LOWER LAYER L.T.S.—— LENGTH TO SUIT BM. — BEAM L.V. --- LENGTH VARIES BOT. — BOTTOM L.W. ——— LONG WAY B.U.L.—— BOTTOM UPPER LAYER MAX.—— MAXIMUM B.W. — BOTH WAYS MECH. — MECHANICAL CANTIL. --- CANTILEVER MIN. — MINIMUM N.F. --- NEAR FACE C.I.P. --- CAST IN PLACE C.J. — CONTROL JOINT N.I.C. NOT IN CONTRACT CL. — CENTER LINE N.S. --- NEAR SIDE CLR. ---- CLEAR N.T.S. --- NOT TO SCALE CONC. — CONCRETE CONT. — CONTINUOUS C. — ON CENTRE O/C --- ON CENTRE O.F. — OUTSIDE FACE C.P. — COMPLETE PENETRATION CTRS. — CENTRES C/W --- COMPLETE WITH O.W.S.J. -- OPEN WEB STEEL JOIST DET. ---- DETAIL P.P. — PARTIAL PENETRATION P/T — POST-TENSIONING D.L. — DEAD LOAD D.O. — DO OVER - (DITTO) R'D ----- ROOF DRAIN DP. — DEEP (I.E. DEPTH OF BEAM) R.O. — ROUGH OPENING D.T.S. — DEPTH TO SUIT RTN. — RETURN R/W --- REINFORCED WITH DWG. ---- DRAWING DWLS. --- DOWELS

S.D.L. —— SUPERIMPOSED DEAD LOAD FA. — FACH SIM. ——— SIMILAR E.E. — EACH END S.L. ——— SNOW LOAD E.F. — EACH FACE S.L.B.B. - SHORT LEGS BACK TO BACK . ----- ELEVATION SLS - SERVICEABILITY LIMIT STATE S.O.G. - SLAB ON GRADE ELEV. --- ELEVATION ELEC. — ELECTRICAL SPEC. —— SPECIFICATIONS SST - STAINLESS STEEL EQ. — EQUAL STAG - STAGGER E.S. — EACH SIDE E.WAY ---- EACH WAY STIR. — STIRRUP E.W. — EACH WAY STL. — STEEL EXIST. — EXISTING S.W. ---- SHORT WAY EXT. --- EXTERIOR SYM. ——— SYMMETRICAL F.D. ---- FLOOR DRAIN T & B - TOP AND BOTTOM T & C --- TENSION AND COMPRESSION F F ----- FAR FACE F.S. — FAR SIDE T & G --- TONGUE AND GROOVE FTG.—— FOOTING THK. ——— THICK GA. — GAUGE THRU ---- THROUGH T.J. TIE JOIST GALV. — GALVANIZED T.L.L. — TOP LOWER LAYER G.L. --- GRID LINE GR. BM. GRADE BEAM T.O. — TOP OF T.O.C. — TOP OF CONCRETE H.1.E. --- HOOK ONE END T.O.F.— TOP OF FOOTING H.2.E. — HOOK TWO ENDS H & V — HORIZONTAL AND VERTICAL T.O.S. — TOP OF SLAB/STEEL T.O.W. TOP OF WALL HORL. --- HORIZONTAL TR. ---- TRANSFER HORZ. --- HORIZONTAL HORIZ. ---- HORIZONTAL T.U.L. — TOP UPPER LAYER TYP. --- TYPICAL HT. ——— HEIGHT

L.L.B.B. — LONG LEGS BACK TO BACK WT. — WEIGHT 11. <u>DEFINITIONS</u>:

I.F. ---- INSIDE FACE INT. — INTERIOR

L.L. ---- LIVE LOAD

JT. — JOINT

LG. — LONG

SPECIALTY STRUCTURAL ENGINEER: A STRUCTURAL ENGINEER REGISTERED IND LICENSED TO PRACTICE BY THE PROFESSIONAL ENGINEERING ASSOCIATION HAVING JURISDICTION IN THE AREA WHERE THE STRUCTURE IS TO BE BUILT AND WHO IS RESPONSIBLE FOR THE DESIGN AND FIELD

ULS ---- ULTIMATE LIMIT STATE

U/S --- UNDERSIDE

W.P. --- WORK POINT

U.N.O. — UNLESS NOTED OTHERWISE

- STRUCTURAL ELEMENTS DESIGNED BY THE CONTRACTOR OR SUBCONTRACTORS, SUCH AS OPEN WEB STEEL JOISTS, PRECAST DOUBLE TEES, PRECAST PLANKS, STRUCTURAL STEEL CONNECTIONS, LIGHT WOOD FRAME ROOF TRUSSES, ETC.
- SECONDARY STRUCTURAL ELEMENTS AND NON-STRUCTURAL ELEMENTS.
- SEE ALSO "NON-STRUCTURAL ELEMENTS" GENERAL NOTES. C. <u>CONTINUOUS</u>: FULL TENSION SPLICE AND TENSION DEVELOPMENT LENGTH.
- EMBEDMENT: UNLESS NOTED OTHERWISE COMPRESSION EMBEDMENT MEANS A COMPRESSION DEVELOPMENT LENGTH AND TENSION EMBEDMENT MEANS A TENSION DEVELOPMENT LENGTH AS PER CAN/CSA-A23.3 AND AS SHOWN ON THESE GENERAL NOTES DRAWINGS.
- GENERAL CONTRACTOR: FOR THE PURPOSES OF THESE DRAWINGS, THE USE OF THE TERM "CONTRACTOR" OR "GENERAL CONTRACTOR" SHALL REFER TO THE PRIME PERSON OR COMPANY RESPONSIBLE FOR CONSTRUCTION OF THE PROJECT AND THE COORDINATION OF TRADES AND SUBCONTRACTORS. THIS MAY BE THE GENERAL CONTRACTOR, OR A CONSTRUCTION MANAGER.

Public Works and Government Services Canada

Public Works and Services Governmentaux Canada

Travaux publics et Services gouvernementaux Canada

REAL PROPERTY SERVICES Pacific Region SERVICES IMMOBILIERS Région de Pacifique



Revision/ Revision	Description/Description	Date/D
0	PRE-TENDER CD FOR CLIENT REVIEW	2017.04
1	ISSUED FOR 100% CD	2017.05
2	ISSUED FOR TENDER	2017.07
3		
4		
5		

### CANADIAN FOOD **INSPECTION AGENCY**

Project title/Titre du projet 3155 WILLINGDON GREEN BURNABY, BC

### CFIA AHU REPLACEMENT

Consultant Signature Only

Designed by/Concept par

Drawn by/Dessine par

Client/client

PWGSC Project Manager/Administrateur de Projets TPSGC

Regional Manager, Architectural and Engineering Services Gestionnaire régionale, Services d'architectural et de génie, TPSGC

Drawing title/Titre du dessin

**GENERAL NOTES** AND TYPICAL DETAILS


Project No./No. du 39903-150591


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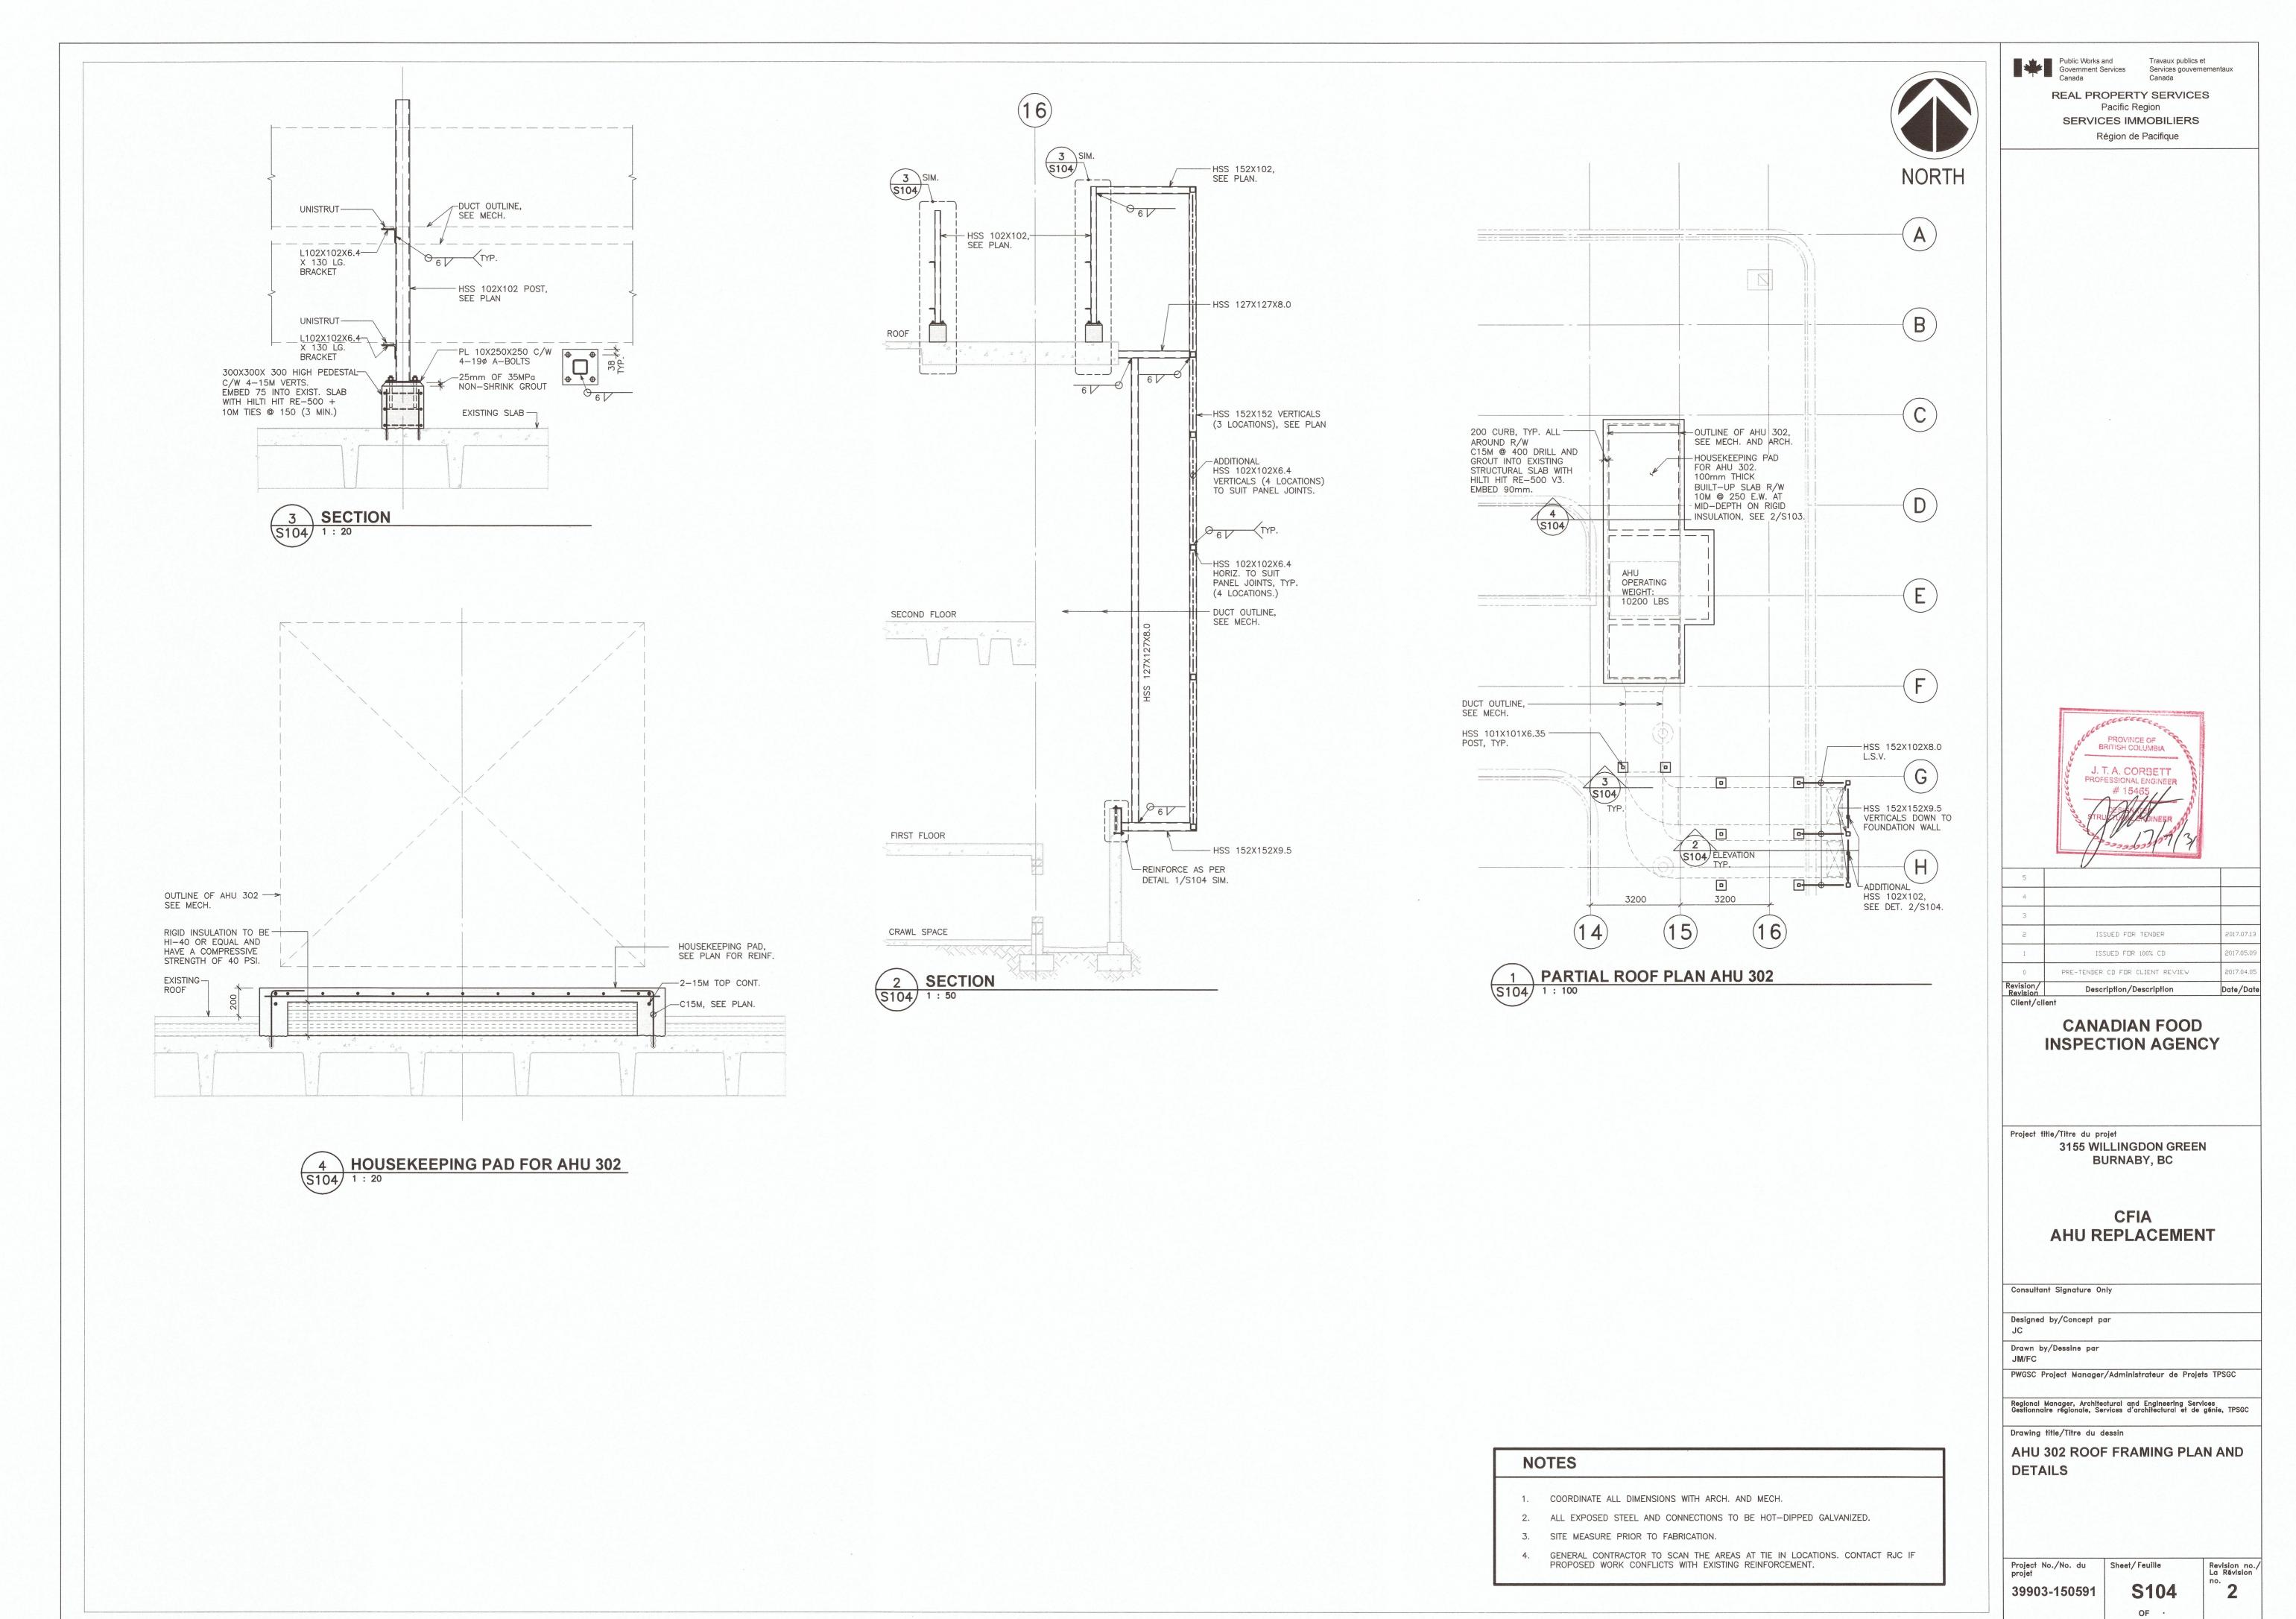
Revision no. La Révision

DM5XXXXXX

PWGSC - A1 - 841X594



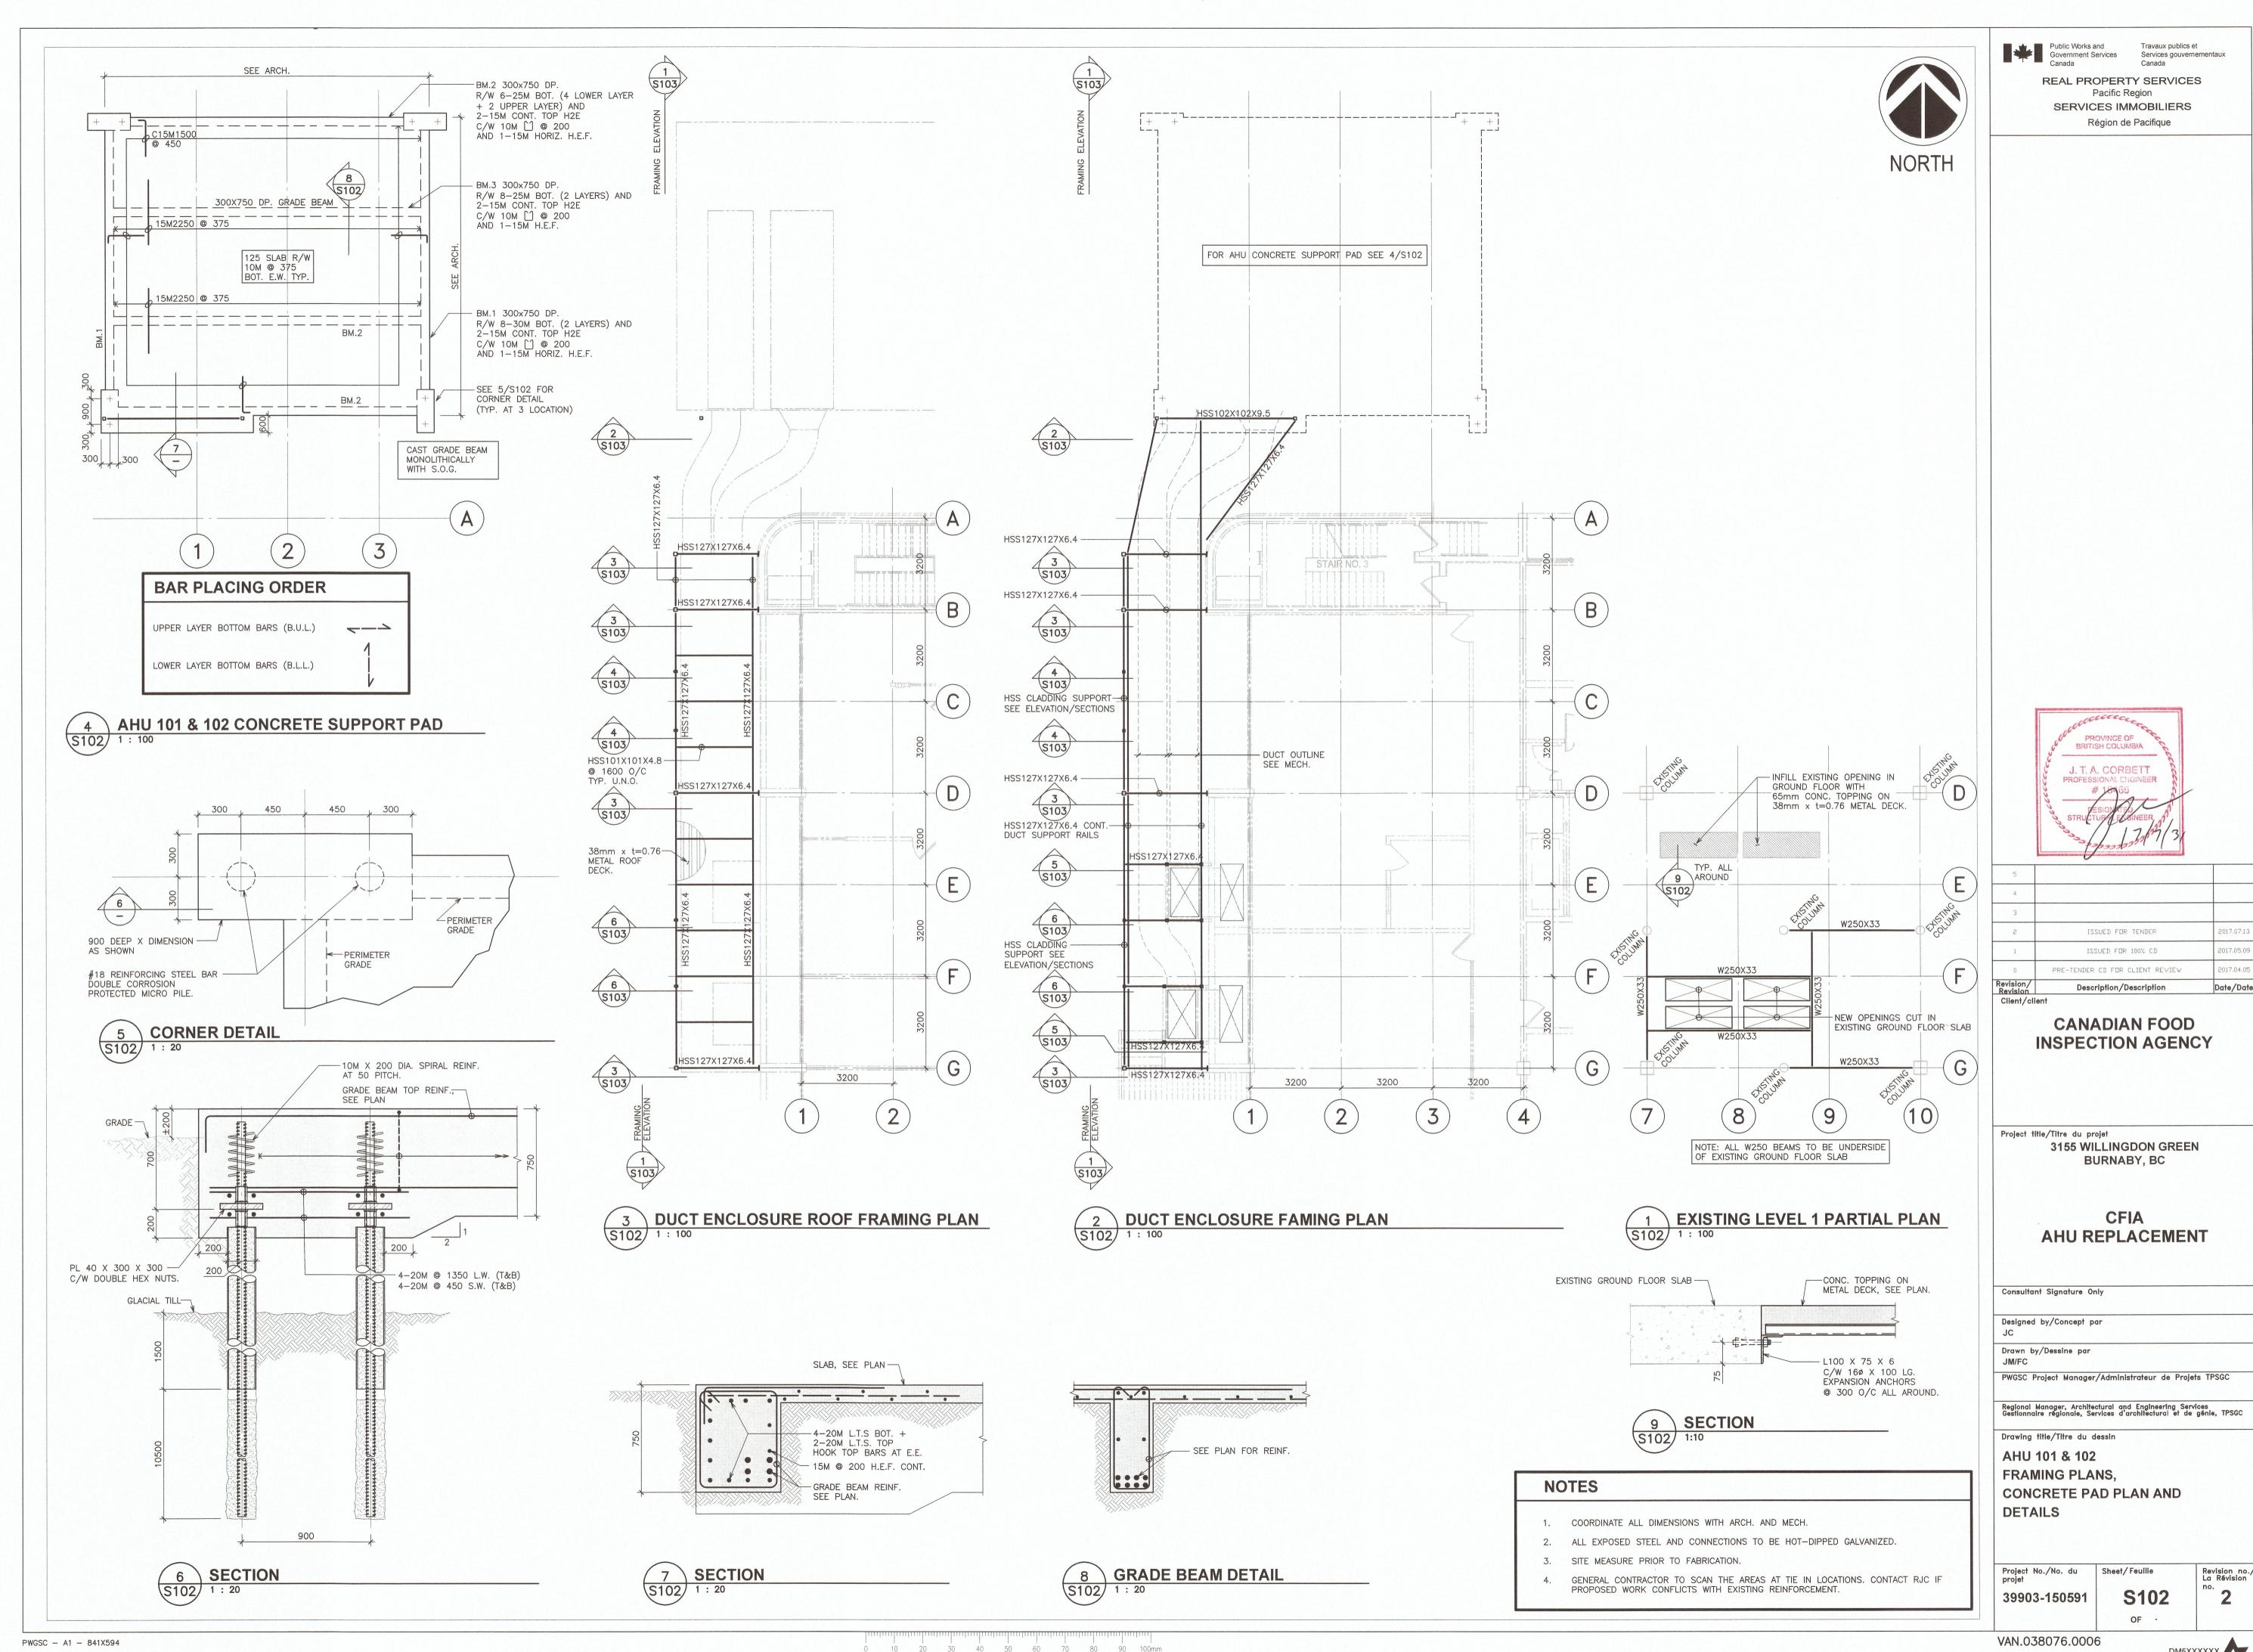

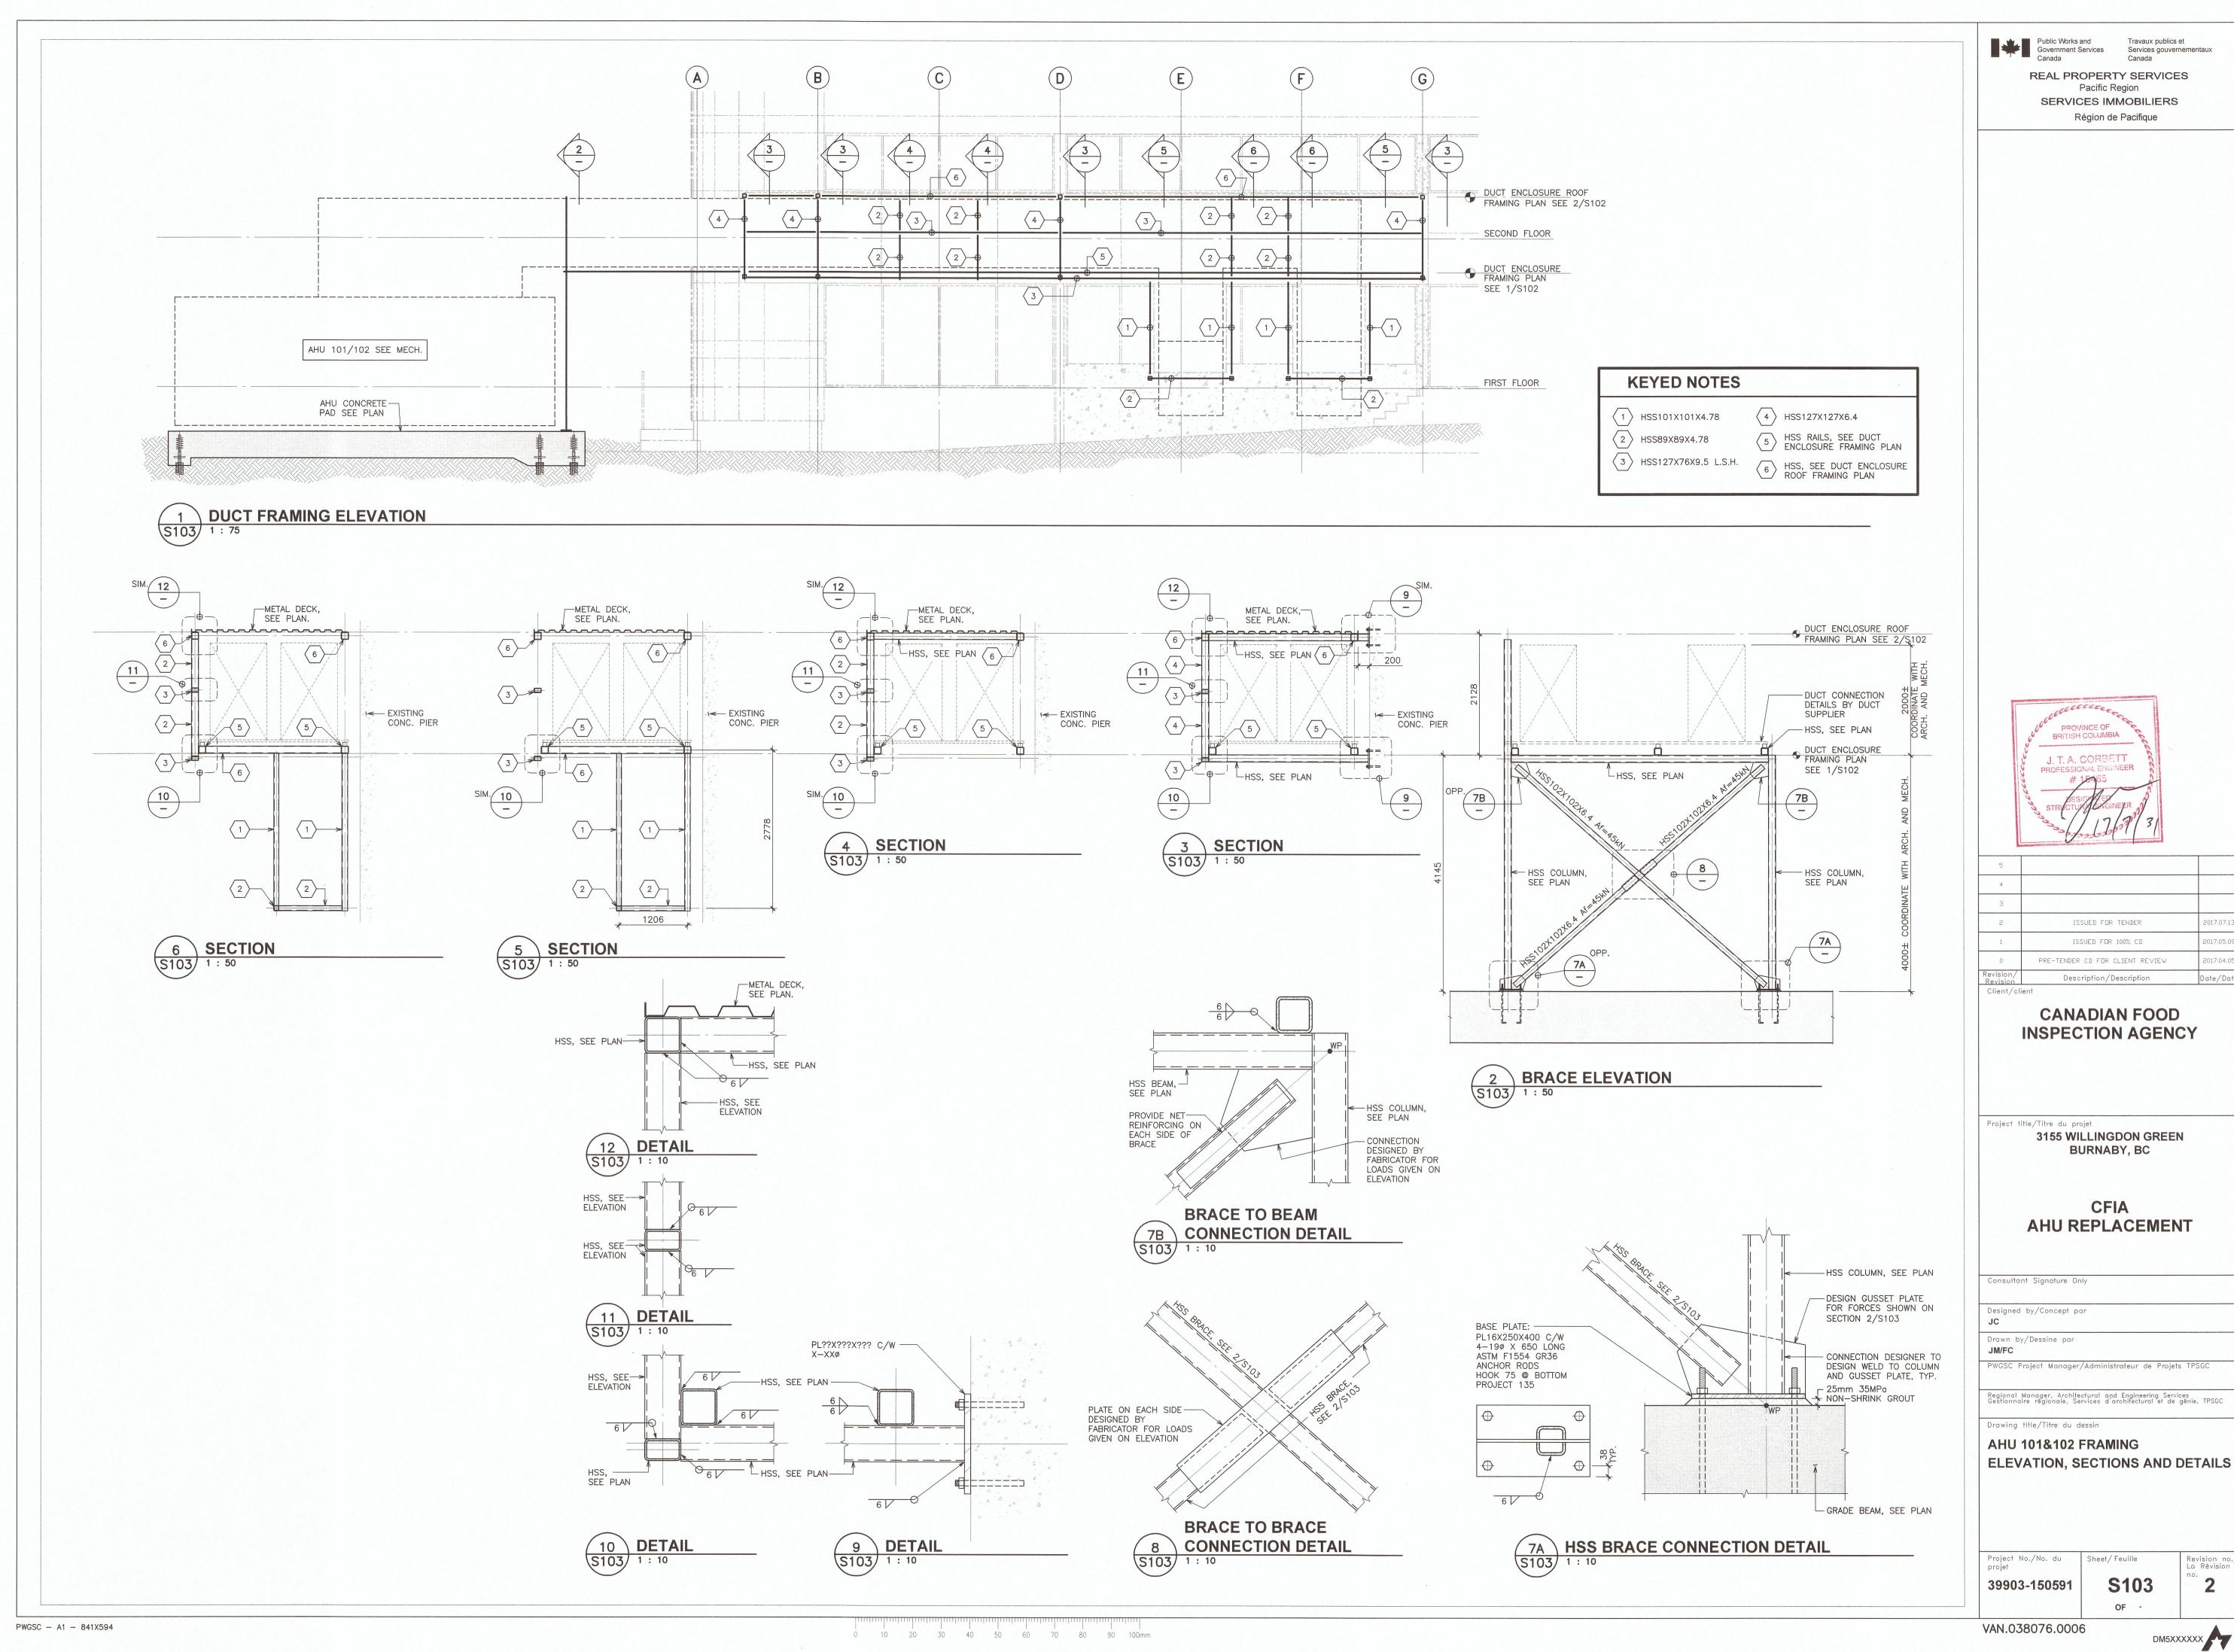

0 10 20 30 40 50 60 70 80 90 100mm

PWGSC - A1 - 841X594

**DESIGN CODE** FIELD REVIEW CONCRETE CONCRETE PROPERTIES: GENERAL (AREAS NOT INCLUDING PARKING) ELEMENT SLAB ON GRADE (INTERIOR) ALL CONCRETE

LIST OF STRUCTURAL DRAWINGS

THE STRUCTURAL WORK SHOWN ON THE STRUCTURAL DRAWINGS HAS BEEN DESIGNED IN SUBSTANTIAL ACCORDANCE WITH THE BRITISH COLUMBIA BUILDING CODE 2012 WHICH IS BASED ON THE NATIONAL BUILDING CODE OF CANADA 2010. S201 - GENERAL NOTES AND TYPICAL DETAILS S202 - EMR PLANS AND DETAILS

FIELD REVIEW IS PROVIDED FOR THE WORK SHOWN ON THESE STRUCTURAL DRAWINGS. THIS REVIEW IS NOT A "FULL TIME" REVIEW BUT IS CONDUCTED WITH SUCH FREQUENCY AS IS DEEMED APPROPRIATE TO OBSERVE VARIOUS STAGES OF THE WORK AND TO ASCERTAIN THAT THE WORK IS IN GENERAL CONFORMANCE WITH THE PLANS AND SUPPORTING DOCUMENTS. FIELD REVIEW IS NOT CARRIED OUT FOR THE CONTRACTOR'S BENEFIT. IT REMAINS THE CONTRACTOR'S RESPONSIBILITY TO BUILD THE WORK IN CONFORMANCE WITH THE CONTRACT DOCUMENTS.

WE WILL REVIEW SHOP DRAWINGS PERTAINING TO WORK SHOWN ON THESE DRAWINGS. THE EXTENT OF THIS REVIEW IS AT OUR SOLE DISCRETION AND IS FOR THE SOLE PURPOSE OF ASCERTAINING GENERAL CONFORMANCE WITH THE STRUCTURAL DESIGN CONCEPT. THE REVIEW IS NOT AN APPROVAL OF THE DESIGN, DETAILS, AND DIMENSIONS INHERENT IN THE SHOP DRAWINGS, RESPONSIBILITY FOR WHICH SHALL REMAIN WITH THE CONTRACTOR OR SUBCONTRACTOR SUBMITTING THEM. SUCH REVIEW SHALL NOT RELIEVE THE CONTRACTOR OR SUBCONTRACTOR OF HIS OR HER RESPONSIBILITY FOR ERRORS AND OMISSIONS IN THE SHOP DRAWINGS OR FOR MEETING ALL REQUIREMENTS OF THE CONTRACT DOCUMENTS.

COMPRESSIVE | EXPOSURE |

N

F-2

STRENGTH (MPa) CLASS

28 DAYS U.N.O.

20 MPa

25 MPa

- 2. PROVIDE 24 HOURS ADVANCE NOTICE OF EACH REQUIRED FIELD REVIEW. FIELD REVIEWS SHALL BE SCHEDULED TO BE CARRIED OUT DURING NORMAL BUSINESS HOURS UNLESS SPECIAL ARRANGEMENTS ARE MADE.
- THE WORK TO BE REVIEWED SHALL BE GENERALLY COMPLETE.

#### **GENERAL**

COMMENTS

THIS PROJECT.

**DRAWINGS** 

MUST INCLUDE ALLOWANCES FOR THIS.

1. SECTION MARK SHOWN THUS 4 MEANS SECTION #4 ON DRAWING S202.

SEE ARCHITECTURAL, MECHANICAL AND ELECTRICAL DRAWINGS FOR SLEEVES, NAILERS, INSERTS, ETC., TO BE ENCASED IN CONCRETE.

THIS SET OF DRAWINGS SHOWS THE COMPLETED PROJECT. THE DRAWINGS DO NOT

GENERAL CONTRACTOR IS RESPONSIBLE FOR SAFETY IN AND ABOUT THE JOB SITE

SHOW COMPONENTS THAT MAY BE NECESSARY FOR CONSTRUCTION SAFETY. THE

STRUCTURES, FORMWORK, FALSE WORK, SHORING, ETC. REQUIRED TO COMPLETE

THE USE OF THESE DRAWINGS IS LIMITED TO THAT IDENTIFIED IN THE REVISIONS COLUMN. DO NOT CONSTRUCT FROM THESE DRAWINGS UNLESS MARKED "ISSUED

LTD. THE DRAWINGS SHALL NOT BE USED FOR PRICING, COSTING, OR TENDER

THE INFORMATION ON THESE DRAWINGS SHALL NOT BE USED FOR ANY OTHER

PROJECT OR WORKS. THE INFORMATION ON THESE DRAWINGS APPLIES SOLELY TO

UNLESS SO INDICATED IN THE REVISION COLUMN. PRICING OR COSTING DRAWINGS ARE NOT COMPLETE AND ANY PRICES BASED ON PRICING OR COSTING DRAWINGS

FOR CONSTRUCTION" IN THE REVISIONS COLUMN, BY READ JONES CHRISTOFFERSEN

DURING CONSTRUCTION, AND THE DESIGN AND ERECTION OF ALL TEMPORARY

SEE ARCHITECTURAL DRAWINGS FOR FLOOR AND ROOF ELEVATIONS, RECESSES, DRAINAGE SLOPES, ETC. THE GENERAL CONTRACTOR SHALL REVIEW ALL THE DRAWINGS AND CHECK

DIMENSIONS BEFORE CONSTRUCTION. REPORT DISCREPANCIES BETWEEN

STRUCTURAL AND OTHER DISCIPLINES DRAWINGS FOR CLARIFICATION.

CONCRETE WORK SHALL CONFORM TO CSA A23.1, CSA A23.2, CSA A23.3 AND REFERENCED DOCUMENTS.

STRUCTURAL STEEL WORK
SHALL CONFORM TO CSA S16 AND REFERENCED DOCUMENTS.

FIRE RESISTANCE RATINGS SEE ARCHITECTURAL DRAWINGS AND SPECIFICATIONS FOR PRECISE LOCATION OF REQUIRED FIRE RESISTANCE RATINGS.

DO NOT CUT OR DRILL ANY OPENINGS IN STRUCTURAL MEMBERS WITHOUT WRITTEN

REFER TO ARCHITECTURAL, MECHANICAL, ELECTRICAL, AND LANDSCAPE DRAWINGS FOR LOCATIONS, CONFIGURATIONS, EXTENT, AND SIZES OF ALL CURBS, UPSTANDS, DOWNTURNS: AND FOR OPENINGS THROUGH FLOORS AND WALLS FOR DUCTS, CONDUIT AND PIPING. PROVIDE FOR SAME.

10. ABBREVIATIONS:

).	<b>ABBREVIATION</b>	<u>IS:</u>		
	Λ B	ANCHOR BOLT	L.L.H. ——	LONG LEG HORIZONTAL
	ALT. ——	ALTERNATE	I I V	LONG LEG VERTICAL
	ALI.		ISH	LONG SIDE HORIZONTAL
	ARCH.			LONG SIDE VERTICAL
	B.C.E. —		L.S.V.	LENGTH TO SUIT
			L.1.5.	LENGTH VARIES
	ВМ. ———	BEAM	L.V	LONG WAY
	BOT. ———	ВОТТОМ	L.W. ——— MAX. ———	LONG WAY
	B.U.L	BOTTOM UPPER LAYER BOTH WAYS	MAX. ———	MAXIMUM
	B.W. ———	BOTH WAYS	MECH.	MECHANICAL
	CANTII	CANTIL FVFR	MIN. ———	MINIMUM
	C.I.P	CAST IN PLACE	N.F. ——	NEAR FACE
	C.J. —	CONTROL JOINT	N.I.C.——	NOT IN CONTRACT NEAR SIDE
		CENTER LINE	N.S. ———	NEAR SIDE
	CLR. ——	CLEAR	NTS -	NOT TO SCALE
	CONC. —		O.C. ——	ON CENTRE
	CONT.	CONTINUOUS	0/C	
	CONT.	COMPLETE PENETRATION		OUTSIDE FACE
			OPP. ——	
	CTRS. —	COMPLETE WITH	0WS.I	OPEN WEB STEEL JOIST
	C/W	COMPLETE WITH		
	DEI.	DETAIL	D/T	POST_TENSIONING
	D.L. ——	DEAD LOAD	P/1	POST-TENSIONING ROOF DRAIN
	D.O. ———	DO OVER - (DITTO)	R.D. —	ROUP DRAIN
	DP. ——	DETAIL DEAD LOAD DO OVER — (DITTO) DEEP (I.E. DEPTH OF BEAM)	R.O. —	ROUGH OPENING
	D.T.S. ——	DEPTH TO SUIT	KIN.	RETURN
	DWG		R/W ——	REINFORCED WITH
	DWLS	DOWELS	S.D.L. ——	SUPERIMPOSED DEAD LOAD
	EA. ———— E.E. ———	EACH	SIM. ——	SIMILAR
	F.F	EACH END	S.L. ——	SNOW LOAD
	F.F	EACH FACE	S.L.B.B. —	SHORT LEGS BACK TO BAC
	FI	EACH FACE ELEVATION	SLS	SERVICEABILITY LIMIT STATE
	ELEV.		S.O.G. ——	SLAB ON GRADE SPECIFICATIONS STAINLESS STEEL
		ELECTRICAL	SPEC	SPECIFICATIONS
	EQ. ———	FOLIAL	SST -	STAINLESS STEEL
	E C	FACH SIDE	STAG. —	STAGGER
	E.S. ——— E.WAY ———	EACH WAY	STIR. —	STIRRUP
	E.WAT	EACH WAY	STL. —	
	E.W. ——— EXIST. ——	EACH WAI	S.W. ———	SHORT WAY
			SYM —	SYMMETRICAL
	EXT. ———		J 10. B	SYMMETRICAL TOP AND BOTTOM
	F.D. —	FLOOR DRAIN	T % C	TENSION AND COMPRESSION
	F.F. ———	FAR FACE		TONGUE AND GROOVE
	F.S. ——— FTG.———	FAR SIDE		
			THK.	
	GA		THRU	TIT JOICE
	GALV.	- GALVANIZED	T.J. ——	
	G.L	- GRID LINE	I.L.L.	TOP LOWER LAYER
	GR. BM	- GRADE BEAM	T.O. —	- TOP OF
	H.1.E	- HOOK ONE END	T.O.C. ——	TOP OF CONCRETE
	H2F	- HOOK TWO ENDS		TOP OF FOOTING
	H & V	- HORIZONTAL AND VERTICAL		- TOP OF SLAB/STEEL
	HORL. —	- HORIZONTAL	T.O.W <del></del>	- TOP OF WALL
		- HORIZONTAL	TR. ——	- TRANSFER
	HORIZ -	- HORIZONTAL	T.U.L	- TOP UPPER LAYER
	LIT	- HEIGHT	TYP. ——	- TYPICAL
	III.	- HEIGHT - INSIDE FACE	UIS -	- ULTIMATE LIMIT STATE
	INT.	- INTERIOR	UNO -	- UNLESS NOTED OTHERWISE
			11/5	- UNDERSIDE
	JT		VERT.	
	LG. ——	- LONG		
	L.L.	- LIVE LOAD - LONG LEGS BACK TO BACK	W.F.	- WEIGHT
	L.L.B.B. —	- LONG LEGS BACK TO BACK	WI	WEIGHT

#### 11. <u>DEFINITIONS</u>:

- A. SPECIALTY STRUCTURAL ENGINEER: A STRUCTURAL ENGINEER REGISTERED AND LICENSED TO PRACTICE BY THE PROFESSIONAL ENGINEERING ASSOCIATION HAVING JURISDICTION IN THE AREA WHERE THE STRUCTURE IS TO BE BUILT AND WHO IS RESPONSIBLE FOR THE DESIGN AND FIELD
  - STRUCTURAL ELEMENTS DESIGNED BY THE CONTRACTOR OR SUBCONTRACTORS, SUCH AS OPEN WEB STEEL JOISTS, PRECAST DOUBLE TEES, PRECAST PLANKS, STRUCTURAL STEEL CONNECTIONS, LIGHT WOOD FRAME ROOF TRUSSES, ETC.
  - SECONDARY STRUCTURAL ELEMENTS AND NON-STRUCTURAL ELEMENTS. SEE ALSO "NON-STRUCTURAL ELEMENTS" GENERAL NOTES.
- C. CONTINUOUS: FULL TENSION SPLICE AND TENSION DEVELOPMENT LENGTH.
- D. <u>EMBEDMENT</u>: UNLESS NOTED OTHERWISE COMPRESSION EMBEDMENT MEANS A COMPRESSION DEVELOPMENT LENGTH AND TENSION EMBEDMENT MEANS A TENSION DEVELOPMENT LENGTH AS PER CAN/CSA-A23.3 AND AS SHOWN ON THESE GENERAL NOTES DRAWINGS.
- GENERAL CONTRACTOR: FOR THE PURPOSES OF THESE DRAWINGS, THE USE OF THE TERM "CONTRACTOR" OR "GENERAL CONTRACTOR" SHALL REFER TO THE PRIME PERSON OR COMPANY RESPONSIBLE FOR CONSTRUCTION OF THE PROJECT AND THE COORDINATION OF TRADES AND SUBCONTRACTORS. THIS MAY BE THE GENERAL CONTRACTOR, OR A CONSTRUCTION MANAGER.

Public Works and Government Services Services gouvernementaux

REAL PROPERTY SERVICES Pacific Region SERVICES IMMOBILIERS Région de Pacifique



Revision/ Revision	Description/Description	Date/Date
0	PRE-TENDER CD FOR CLIENT REVIEW	2017.04.05
1	ISSUED FOR 100% CD	2017.05.09
2	ISSUED FOR TENDER	2017.07.13
3		
4		
5		

**CANADIAN FOOD INSPECTION AGENCY** 

Project title/Titre du projet 3155 WILLINGDON GREEN BURNABY, BC

> **EXHAUST MANIFOLD** REPLACEMENT

Consultant Signature Only

Designed by/Concept par

Drawn by/Dessine par

PWGSC Project Manager/Administrateur de Projets TPSGC

Regional Manager, Architectural and Engineering Services Gestionnaire régionale, Services d'architectural et de génie, TPSGC

Drawing title/Titre du dessin GENERAL NOTES

AND TYPICAL DETAILS

Project No./No. du Sheet/Feuille


39903-150591

**S201** 

Revision no./ La Révision

DM5XXXXXX

VAN.038076.0006

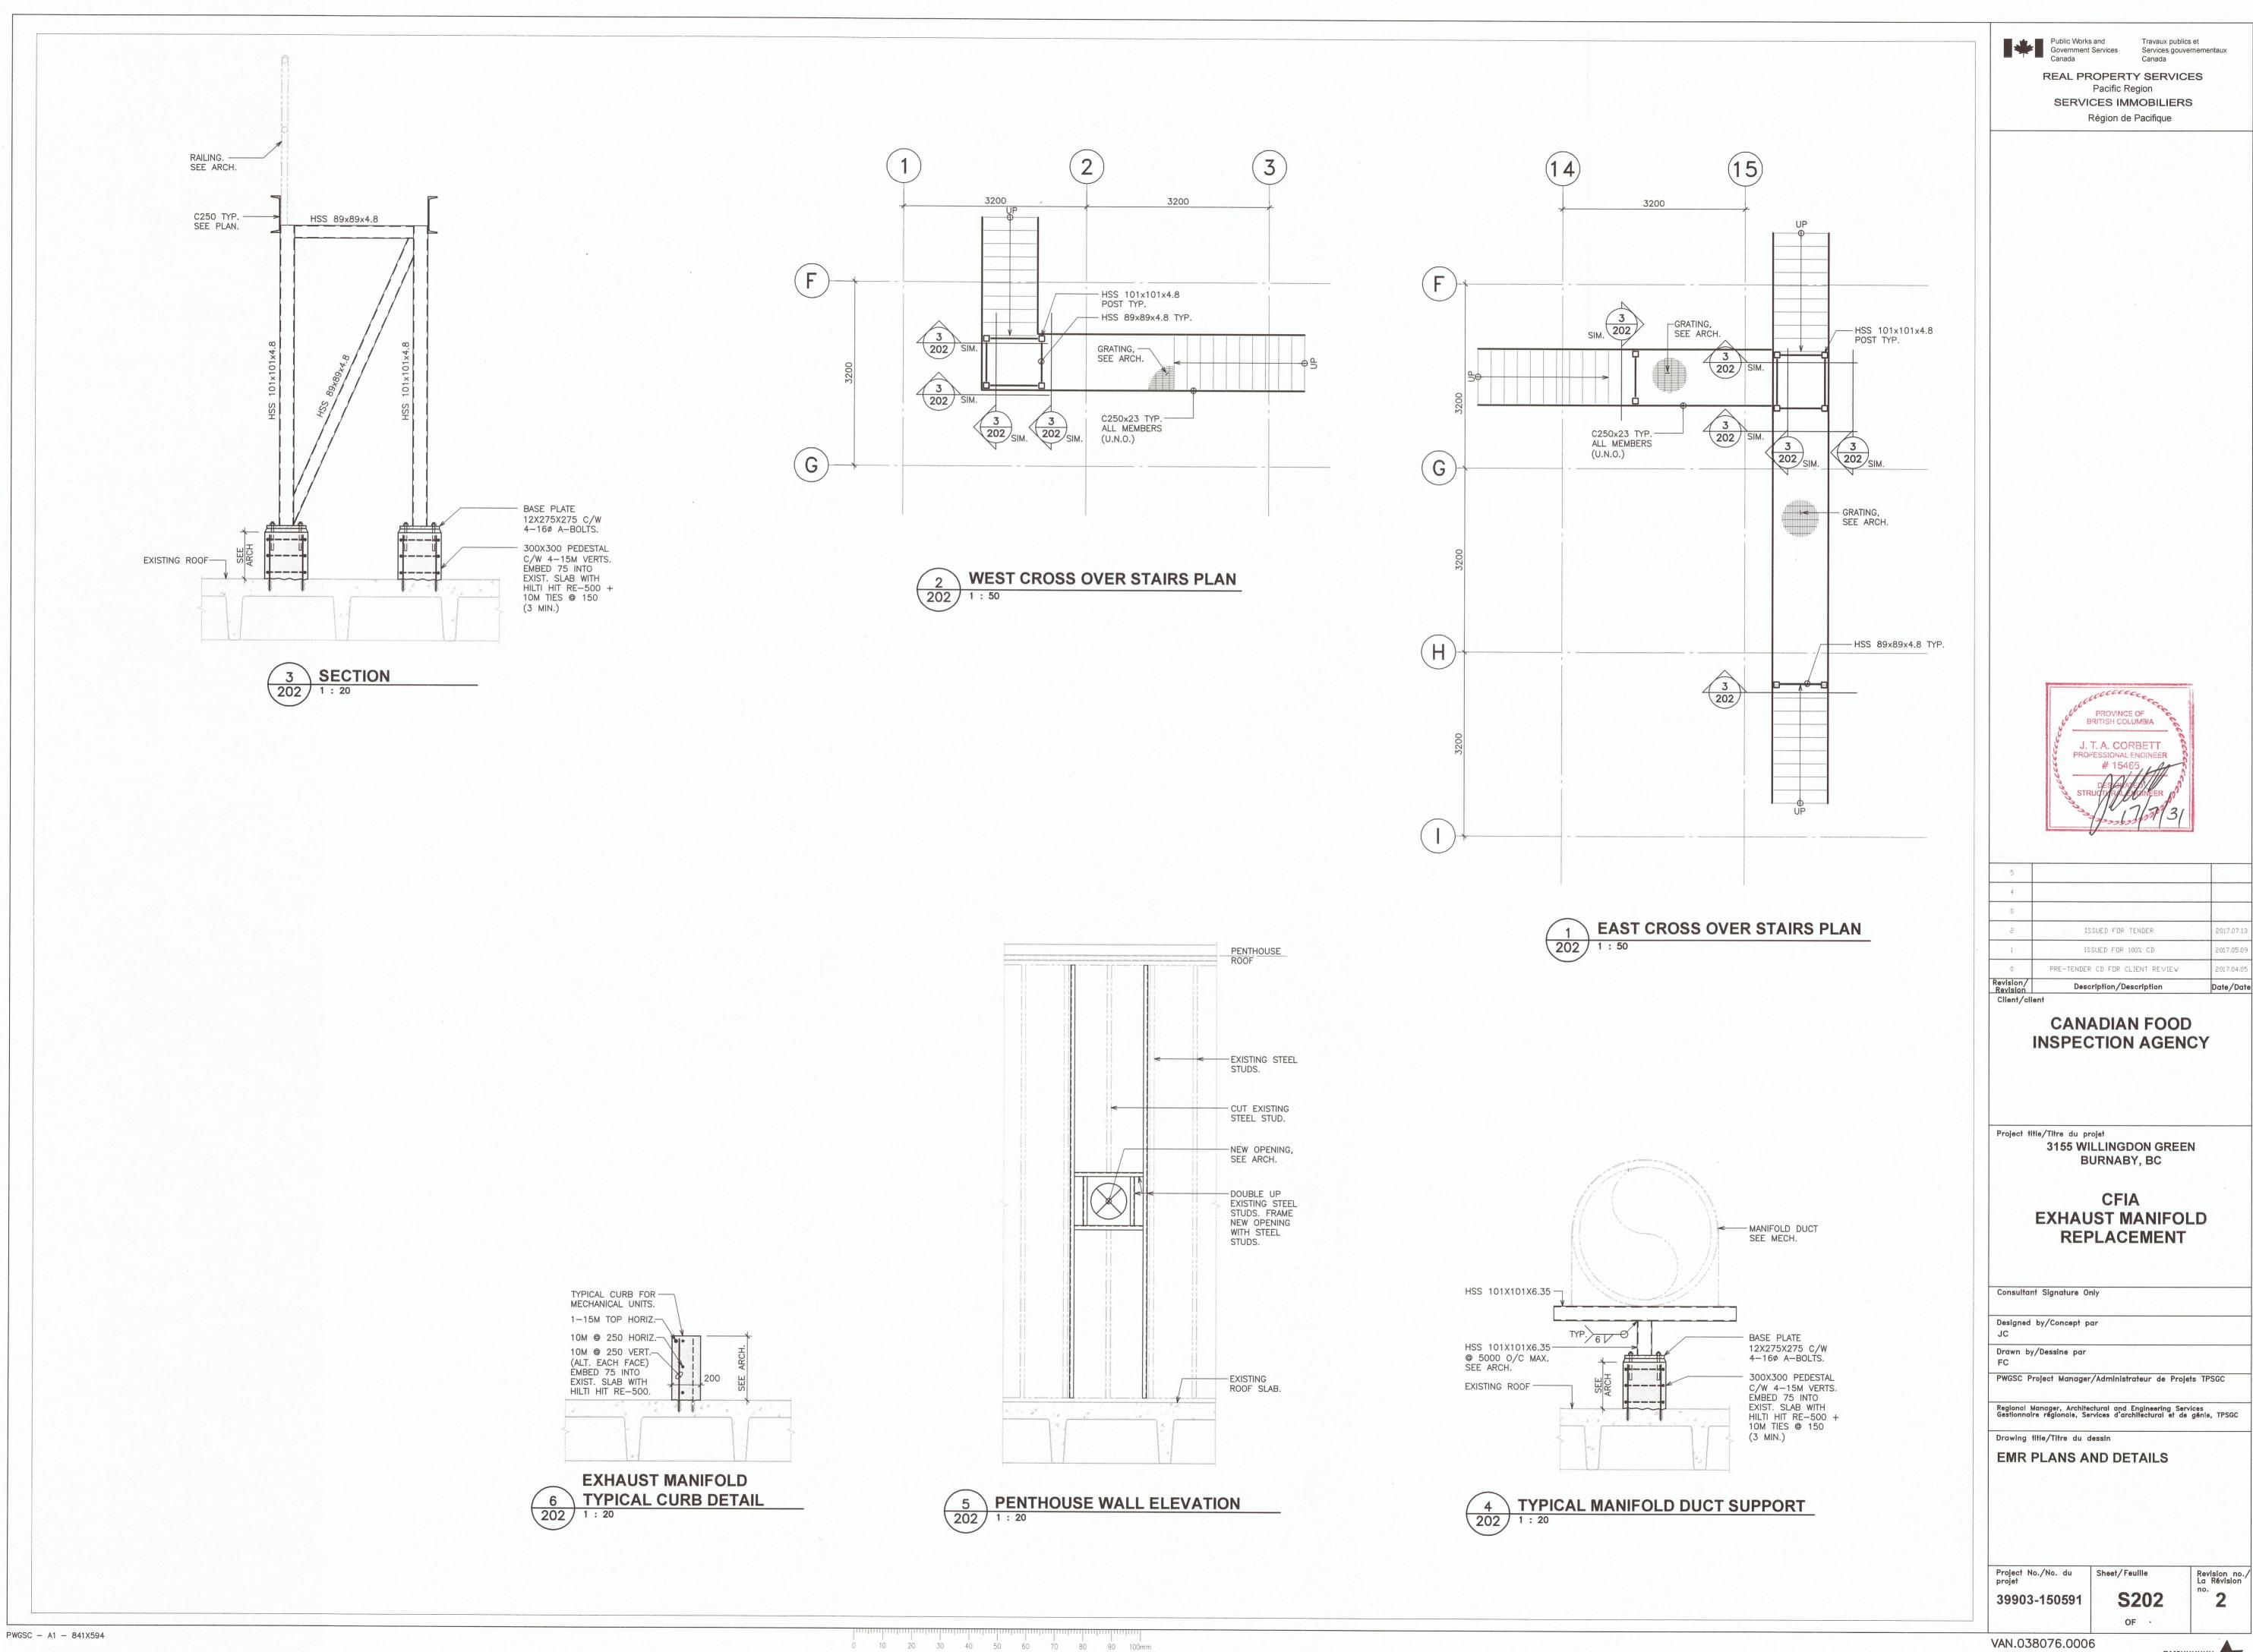

DM5XXXXXX

VAN.038076.0006

# CANADIAN FOOD INSPECTION AGENCY

## AIR HANDLING UNITS (AHUs) REPLACEMENT

	GENERAL NOTES
1	ALL NEW WORK WILL NEED TO BE INSTALLED IN PARALLEL WITH EXISTING SYSTEM (WHEN FEASIBLE) TO MINIMIZE DURATION OF SHUT-DOWNS. SHUT-DOWNS OF ANY AREAS WILL NEED TO BE COORDINATED AND APPROVED AHEAD OF TIME, IN COORDINATION WITH DEPARTMENTAL REPRESENTATIVE.
2.	ALL NEW WORK SHALL BE TESTED, BALANCED (AS NECESSARY) AND COMMISSIONED.
3.	CONTRACTOR IS RESPONSIBLE FOR REVIEWING AND VERIFYING ACTUAL ONSITE CONDITIONS AND EQUIPMENT LOCATIONS PRIOR TO ANY AND ALL DEMOLITION WORK AND/OR EQUIPMENT REMOVAL.
4.	THE MECHANICAL SYSTEM SHALL CONSIST OF ALL WORK SHOWN ON THE DRAWINGS, DIAGRAMS, SCHEMATICS AND AS DESCRIBED IN THE SPECIFICATIONS.
5.	THE MECHANICAL PLANS ARE DIAGRAMMATIC IN NATURE AND DO NOT ATTEMPT TO SHOW ALL REQUIRED OFFSETS. CONTRACTOR TO ALLOW FOR OFFSETS AS PART OF CONTRACT PRICE. EXISTING CONDITIONS AND PIPES ROUTINGS TO BE REVIEWED WITH TENDER.
6.	COORDINATE THE DRAWINGS WITH THE SPECIFICATIONS AND IN CASES WHERE CONFLICTS OCCUR, THE MOST STRINGENT REQUIREMENTS SHALL APPLY.
7.	CONTRACTOR TO COORDINATE ALL MECHANICAL WORK WITH THAT OF OTHER TRADES TO ENSURE PROPER AND ADEQUATE INTERFACE WITH THE WORK OUTLINED FOR THIS PROJECT.
8.	CONTRACTOR TO PROVIDE HORIZONTAL AND VERTICAL CLEARANCE FOR ALL INSTALLED EQUIPMENT AS DICTATED BY THE NATIONAL ELECTRICAL CODE. OFFSET MECHANICAL SYSTEMS AS REQUIRED.
9.	CONTRACTOR TO INCLUDE AS A PART OF THE BID, ALL COSTS ASSOCIATED WITH CUTTING AND PATCHING THAT IS REQUIRED TO INSTALL ALL NEW MECHANICAL SYSTEMS AS REQUIRED TO MEET THE SITE CONDITIONS AS SHOWN ON THE DRAWINGS. PATCHING SHALL MEET THE AESTHETIC CONDITIONS WHICH WAS THE CONDITION PRIOR TO ANY CUTTING BEING PERFORMED.
10.	DURING REMOVAL OF ITEMS SO INDICATED, CAUTION SHOULD BE USED TO PREVENT DAMAGE TO ANY EQUIPMENT HAVING SALVAGE VALUE. ALL REUSABLE SALVAGED MATERIAL SHALL REMAIN THE PROPERTY OF THE DEPARTMENTAL REPRESENTATIVE AND BE RETAINED FOR THEIR INSPECTION. ONLY ITEMS AGREED BY THE DEPARTMENTAL REPRESENTATIVE SHALL BE DISPOSED OF BY THE CONTRACTOR.
11.	CONTRACTOR TO PROPERLY SEAL AND REPAIR ANY AND ALL DAMAGE THAT IS A RESULT OF REMOVAL OR DEMOLITION OF MECHANICAL EQUIPMENT. THIS INCLUDES BUT IS NOT LIMITED TO WALL, DOOR, CEILINGS, ETC
12.	INSTALLING CONTRACTOR TO PROVIDE SEISMIC PIPE/DUCT SUPPORTS WITH A STRUCTURAL ENGINEERING STAMP AS REQUIRED BY BC BUILDING CODE.
13.	CONTRACTOR TO PROVIDE FIRE STOPPING AND SEALING AROUND ANY PIPING PENETRATING FULL HEIGHT WALLS, SHAFT FLOORS, AND CEILING.
14.	INSTALL ISOLATION VALVES ON EACH MAIN, BRANCH, AND FIXTURE LINE, REGARDLESS WHETHER THEY ARE SHOWN ON DRAWINGS OR NOT.
15.	PROVIDE VALVE IDENTIFICATION TAGS AND SECURE THOSE USING NON-FERROUS CHAIN BRAIDED BAND OR PLASTIC BAND (SUITABLE FOR TEMPERATURE). TAGS MAY BE OF BRASS, ALUMINUM, METAL PHOTO, LAMICOID OR FIBERGLASS, STAMPED OR ENGRAVED. OF 25mm MINIMUM DIAMETER. VALVES TO BE TAGGED ON ALL MAIN AND BRANCH LINES.
16.	SHUT DOWNS TO MAIN AIR HANDLING SYSTEMS ARE TO BE CONFINED TO OFF HOURS. THIS INCLUDES BUT IS NOT LIMITED TO FINAL CONNECTIONS, COIL REPLACEMENTS, DOWNSIZING AND REMOVAL OF EXISTING INTERIOR UNITS. 2 WEEK LEAD TIME IS TO BE GIVEN BEFORE ANY OFF HOURS WORK AND AND MUST BE CONFIRMED ONE WEEK PRIOR TO SHUT DOWN, NO EXCEPTIONS.
17.	ALL NEW EQUIPMENT, PIPING AND CONTROLS SHALL BE INSTALLED, PRE-TESTED, AND PRE-COMISSIONNED PRIOR TO TYING INTO EXISTING SYSTEM.
18.	THE AIR HANDLING UNIT MUST BE INSTALLED, COMMISSIONED, AND FULLY OPERATIONAL PRIOR TO CONSTRUCTION OF THE EXHAUST MANIFOLD SYSTEM.
19.	DUCT LINER, IN ANY FORM, IS UNACCEPTABLE FOR THIS PROJECT. NO DUCT LINER IS TO BE USED.

CENIE	DAI	DHACINO	MOTEC
GENE	RAL	<b>PHASING</b>	MOLES

REFER TO GENERAL NOTES 1, 2, 7, 16, AND 17 ON THIS SHEET FOR ITEMS RELATING TO COORDINATION WITH BUILDING OPERATIONS AND EXISTING

ALL EXTERIOR EQUIPMENT, DUCTWORK, AND PIPING (PARKING LOT AND ROOFTOP) IS TO BE INSTALLED PRIOR TO COMMENCING ANYWORK IN THE MECHANICAL ROOM OR CRAWLSPACE.

ALL CRAWLSPACE EQUIPMENT, DUCTWORK, AND PIPING IS TO BE INSTALLED PRIOR TO COMMENCING ANYWORK IN THE MECHANICAL ROOM WITH THE FOLLOWING EXCEPTIONS:

1. NO DUCTWORK FOR AHU101-102 IN AREAS ENCLOSED BY GRIDLINES D TO G AND 7 TO 9 IS TO BE INSTALLED TO ENSURE THE EXISTING UNITS' O/A 2. NO DUCTWORK FOR AHU-302 IN AREAS ENCLOSED BY GRIDLINES F TO H AND 10 TO 12 IS TO BE INSTALLED TO ENSURE THE EXISTING UNIT'S O/A

REFER TO SPECIFIC PHASING NOTES FOR ADDITIONAL INFORMATION.

INTAKES ARE NOT OBSTRUCTED.

	DRAWING LIST
M-101	COVER PAGE
M-102	CRAWL SPACE DEMOLITION PLAN - MECHANICAL
M-103	PARTIAL MAIN FLOOR DEMOLITION PLAN - HVAC
M-104	PARTIAL MAIN FLOOR DEMOLITION PLAN - PIPING LAYOUT
M-105	PARTIAL MAIN FLOOR PLAN - HVAC
M-106	CRAWL SPACE FLOOR PLAN - MECHANICAL
M-107	PARTIAL MAIN FLOOR PLAN - PIPING LAYOUT
M-108	PARTIAL SECOND FLOOR PLAN - MECHANICAL
M-109	ROOF PLAN - MECHANICAL
M-110	SECTIONS - MECHANICAL
M-111	SECTIONS AND ELEVATIONS
M-112	SECTIONS, ELEVATIONS, AND DETAILS
M-113	AIR HANDLING UNIT DETAILS & HYDRONIC SCHEMATIC

AND REPAIRED.	
INSTALL PIPING BETWEEN THE BASEMENT MECHANICAL ROOM AND THE ROOFTOP AHU-302. CONNECT TO THE EXISTING HEADERS IN THE BASEMENT MECROMS. INSTALL PUMPS FOR AHU-302.	HANICAL
TEST, BALANCE, AND COMMISSION PUMPS FOR AHU-302.	
PRE-TEST AND PRE-COMMISSION AHU-302.	
INSTALL REMAINDER OF AHU-302 S/A DUCTWORK IN CRAWLSPACE. SAWCUT FLOOR PENETRATION FOR S/A FOR AHU-302. CLOSE VOLUME DAMPER IDENTIFIED M6.18 IN ORDER TO ALLOW FOR CONTINUED OPERATION OF EX. AHU-103.	FIED IN NOTE
COORDINATE SHUTDOWN OF EX. AHU-103 WITH DEPARTMENTAL REPRESENTATIVE. SHUTDOWN AHU-103. AHUTDOWN IS TO BE FOR NO MORE THAN 48 HO	URS.
EXTEND AHU-302 R/A DUCTWORK AND CONNECT TO EX. AHU-103 O/A INTAKE.	
PARTIALLY DEMOLISH AHU-103 TO ALLOW FOR EXTENSION OF S/A AND R/A DUCTWORK TO CONNECT TO EXISTING SYSTEM AS NOTED ON SHEET M-107.	
TEST, BALANCE, AND COMMISSION AHU-302.	
COMPLETE DEMOLITION OF EX. AHU-103.	
INSTALL HEAT EXCHANGERS, PUMPS, PIPING, VFDS, DDC PANEL, AND HUMIDIFIERS IN BASEMENT MECHANICAL ROOM.	
TEST, BALANCE, AND COMMISSION PUMPS.	
COORDINATE SHUTDOWN OF EX. AHU-102 WITH DEPARTMENTAL REPRESENTATIVE. AHU-101 TO REMAIN OPERATIONAL FOR DURATION OF AHU-102 SHUTD ENSURE AHU-102 AUTOMATIC DAMPERS ARE CLOSED TO PREVENT BACKFLOW OF S/A FROM AHU-101 DURING WORK ON AHU-102 SYSTEM.	OWN.
DEMOLISH AHU-102.	
REMOVE EXISTING HUMIDIFIER SERVING AHU-102. REMOVE APPURTENANCES OF HUMIDIFIER SERVING AHU-102.	
INSTALL, AND PIPE, EXPANSION TANKS AND GLYCOL FILL TANKS.	
PRE-TEST AND PRE-COMMISSION AHU-102.	
COMPLETE INSTALLATION OF REMAINING CRAWLSPACE, AND MECHANICAL ROOM DUCTWORK, FOR NEW AHU-102.	
TEST, BALANCE, AND COMMISSION AHU-102.	
AHU-102 TO REMAIN AS DUTY AHU FOR REMAINDER OF INSTALL PROCESS.	
PRE-TEST AND PRE-COMMISSION AHU-101.	
COORDINATE SHUTDOWN OF AHU-101 WITH DEPARTMENTAL REPRESENTATIVE.	
DEMOLISH EX. AHU-101.	
COMPLETE INSTALLATION OF REMAINING CRAWLSPACE, AND MECHANICAL ROOM DUCTWORK, FOR NEW AHU-101.	
COMPLETE INSTALLATION OF REMAINING CRAWLSPACE, AND MECHANICAL ROOM DUCTWORK, FOR NEW AHU-101.	
TEST, BALANCE, AND COMMISSION AHU-101.	

SPECIFIC PHASING NOTES

COORDINATE TEMPORARY SHUTDOWN OF EX. AHU-103 WITH DEPARTMENTAL REPRESENTATIVE. SHUTDOWN IS TO BE FOR NO MORE THAN 48 HOURS. EX. AHU-103 RELIEF DUCT IS TO BE PARTIALLY DEMOLISHED AS NOTED IN THE DETAIL ON SHEET M-110. REACTIVATE EX. AHU-103 AFTER RELIEF DUCT IS PARTIALLY DEMOLISHED

AFTER THE GENERAL PHASING NOTES HAVE BEEN COMPLETED IMPLEMENT THE FOLLOWING PROJECT TASKS IN ORDER.

		H.V.	A.C. LEGEND		
ZX	DUCTWORK	П	THERMOMETER	₩	GATE VALVE
\$77777	DUCTWORK C/W 25mm ACOUSTIC INSULATION	(T)	THERMOSTAT/SENSOR	₩	GLOBE VALVE
	DUCTWORK C/W 50mm			**	ANGLE GLOBE VALVE
***************************************	ACOUSTIC INSULATION	R	FLOW SWITCH	₩;	STRAINER
x8888888888888888888888888888888888888	DUCTWORK C/W 50mm DUCT	+ <del>P</del> +	PETE'S PLUG	1	CHECK VALVE
<u>2000000</u>	INSULATION	+\$+	GAUGE COCK OR HOSE BIBB	11/101⊦	FLOW MEASUREMENT VALVE
<b>X</b>	VOLUME DAMPER	(P)	PRESSURE GAUGE	₩.	2 WAY MODULATING CONTROL VALVE
X X	FIRE DAMPER IN VERTICAL SEPARATION	XXXX	EQUIPMENT TAG	<b>☆</b>	THREE WAY CONTROL VALVE
	FIRE DAMPER IN HORIZONTAL SEPARATION	NO.@		Ż	AUTOMATIC AIR VENT & ISOLATION VALVE.
L/-	TIONIZONTAL GEL AIGHTON	SIZE	AIR DISTRIBUTION TAG		PRESSURE REDUCING VALVE
HWS	HOT WATER HEATING SUPPLY	TYPE	RADIANT PANEL & WALL FIN TAG	×	TEMPERATURE & PRESSURE RELIEF VALVE
HWR	HOT WATER HEATING RETURN	KW		•	POINT OF CONNECTION
G	GAS PIPING	V	VACUUM		POINT OF DISCONNECTION
CHWS	CHILLED WATER SUPPLY	—— CA——	COMPRESSED AIR	'///////	
CHWR	CHILLED WATER RETURN	— N—	NITROGEN		DENOTES REMOVAL
	CONDENSER WATER SUPPLY	— HPG—— ——AW——	HIGH PRESSURE GAS ACID WASTE		
cwr	CONDENSER WATER RETURN	——SAN——	SANITARY WASTE		EDECTE DOOTSONON OVOTEN
	PIPING FLEXIBLE CONNECTION	JAN	ONNITALL WAGIE	<del></del>	FREEZE PROTECTION SYSTEM

ABBREVIATIONS	DESCRIPTION	ABBREVIATION	DESCRIPTION
Ø	DIAMETER	kPa (g)	KILOPASCALS (GAUGE)
AC	AIR CONDITIONING UNIT	MIN	MINIMUM
AD	AIR DAMPER	MCC	MOTOR CONTROL CENTER
AFF	ABOVE FINISHED FLOOR	N.C.	NORMALLY CLOSED
AHU	AIR HANDLING UNIT	N.O.	NORMALLY OPEN
Al	ANALOG INPUT	OA, O/A	OUTDOOR AIR
CC	COOLING COIL	OD	OUTER DIAMETER
СН	CHILLER	PDEF	PLUME DILUTION EXHAUST FAN
CHWS/R	CHILLED WATER SUPPLY/RETURN	RA, R/A	RETURN AIR
CU	CONDENSING UNIT	RE & RE	REMOVE AND REINSTALL
C/W	COMPLETE WITH	REL/A	RELIEF AIR
CWS/R	CONDENSER WATER SUPPLY/RETURN	RF	RETURN FAN
DDC	DIRECT DIGITAL CONTROL	RH	ROOF HOOD
EA, E/A	EXHAUST AIR	SA, S/A	SUPPLY AIR
EBH	ELECTRIC BASEBOARD HEATER	SF	SUPPLY FAN
EF	EXHAUST FAN	SP	STATIC PRESSURE
EX.	EXISTING	TEMP	TEMPERATURE
FD	FIRE DAMPER	T/O	TOP OF
FEF	FUME EXHUAST FILTER	U/G	UNDERGROUND
FES	FUME EXHAUST SCRUBBER	UH	UNIT HEATER
HC	HEATING COIL	UTR	UP THROUGH ROOF
HWS/R	HOT WATER SUPPLY/RETURN	VAV	VARIABLE AIR VOLUME
HU	HUMIDIFIER	VD	VOLUME DAMPER



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REAL PROPERTY SERVICES SERVICES IMMOBILIERS Région de Pacifique



5		
4		
3	ISSUED FOR TENDER	2017-07-13
2	ISSUED FOR 100 % CD	2017-05-09
1	PRE-TENDER CD FOR CLIENT REVIEW	2017-04-05
0	50 % REVIEW	2017-03-03
Revision/ Revision	Description/Description	Date/Date
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**CANADIAN FOOD INSPECTION AGENCY** 

Project title/Titre du projet 3155 WILLINGDON GREEN **BURNABY, BC** 

AHU REPLACEMENT

Consultant Signature Only

Designed by/Concept par

Drawn by/Dessine par


PWGSC Project Manager/Administrateur de Projets TPSGC Regional Manager, Architectural and Engineering Services Gestionnaire régionale, Services d'architectural et de génie, TPSGC


Drawing title/Titre du dessin

COVER PAGE

39903-150591

M-101 OF 13

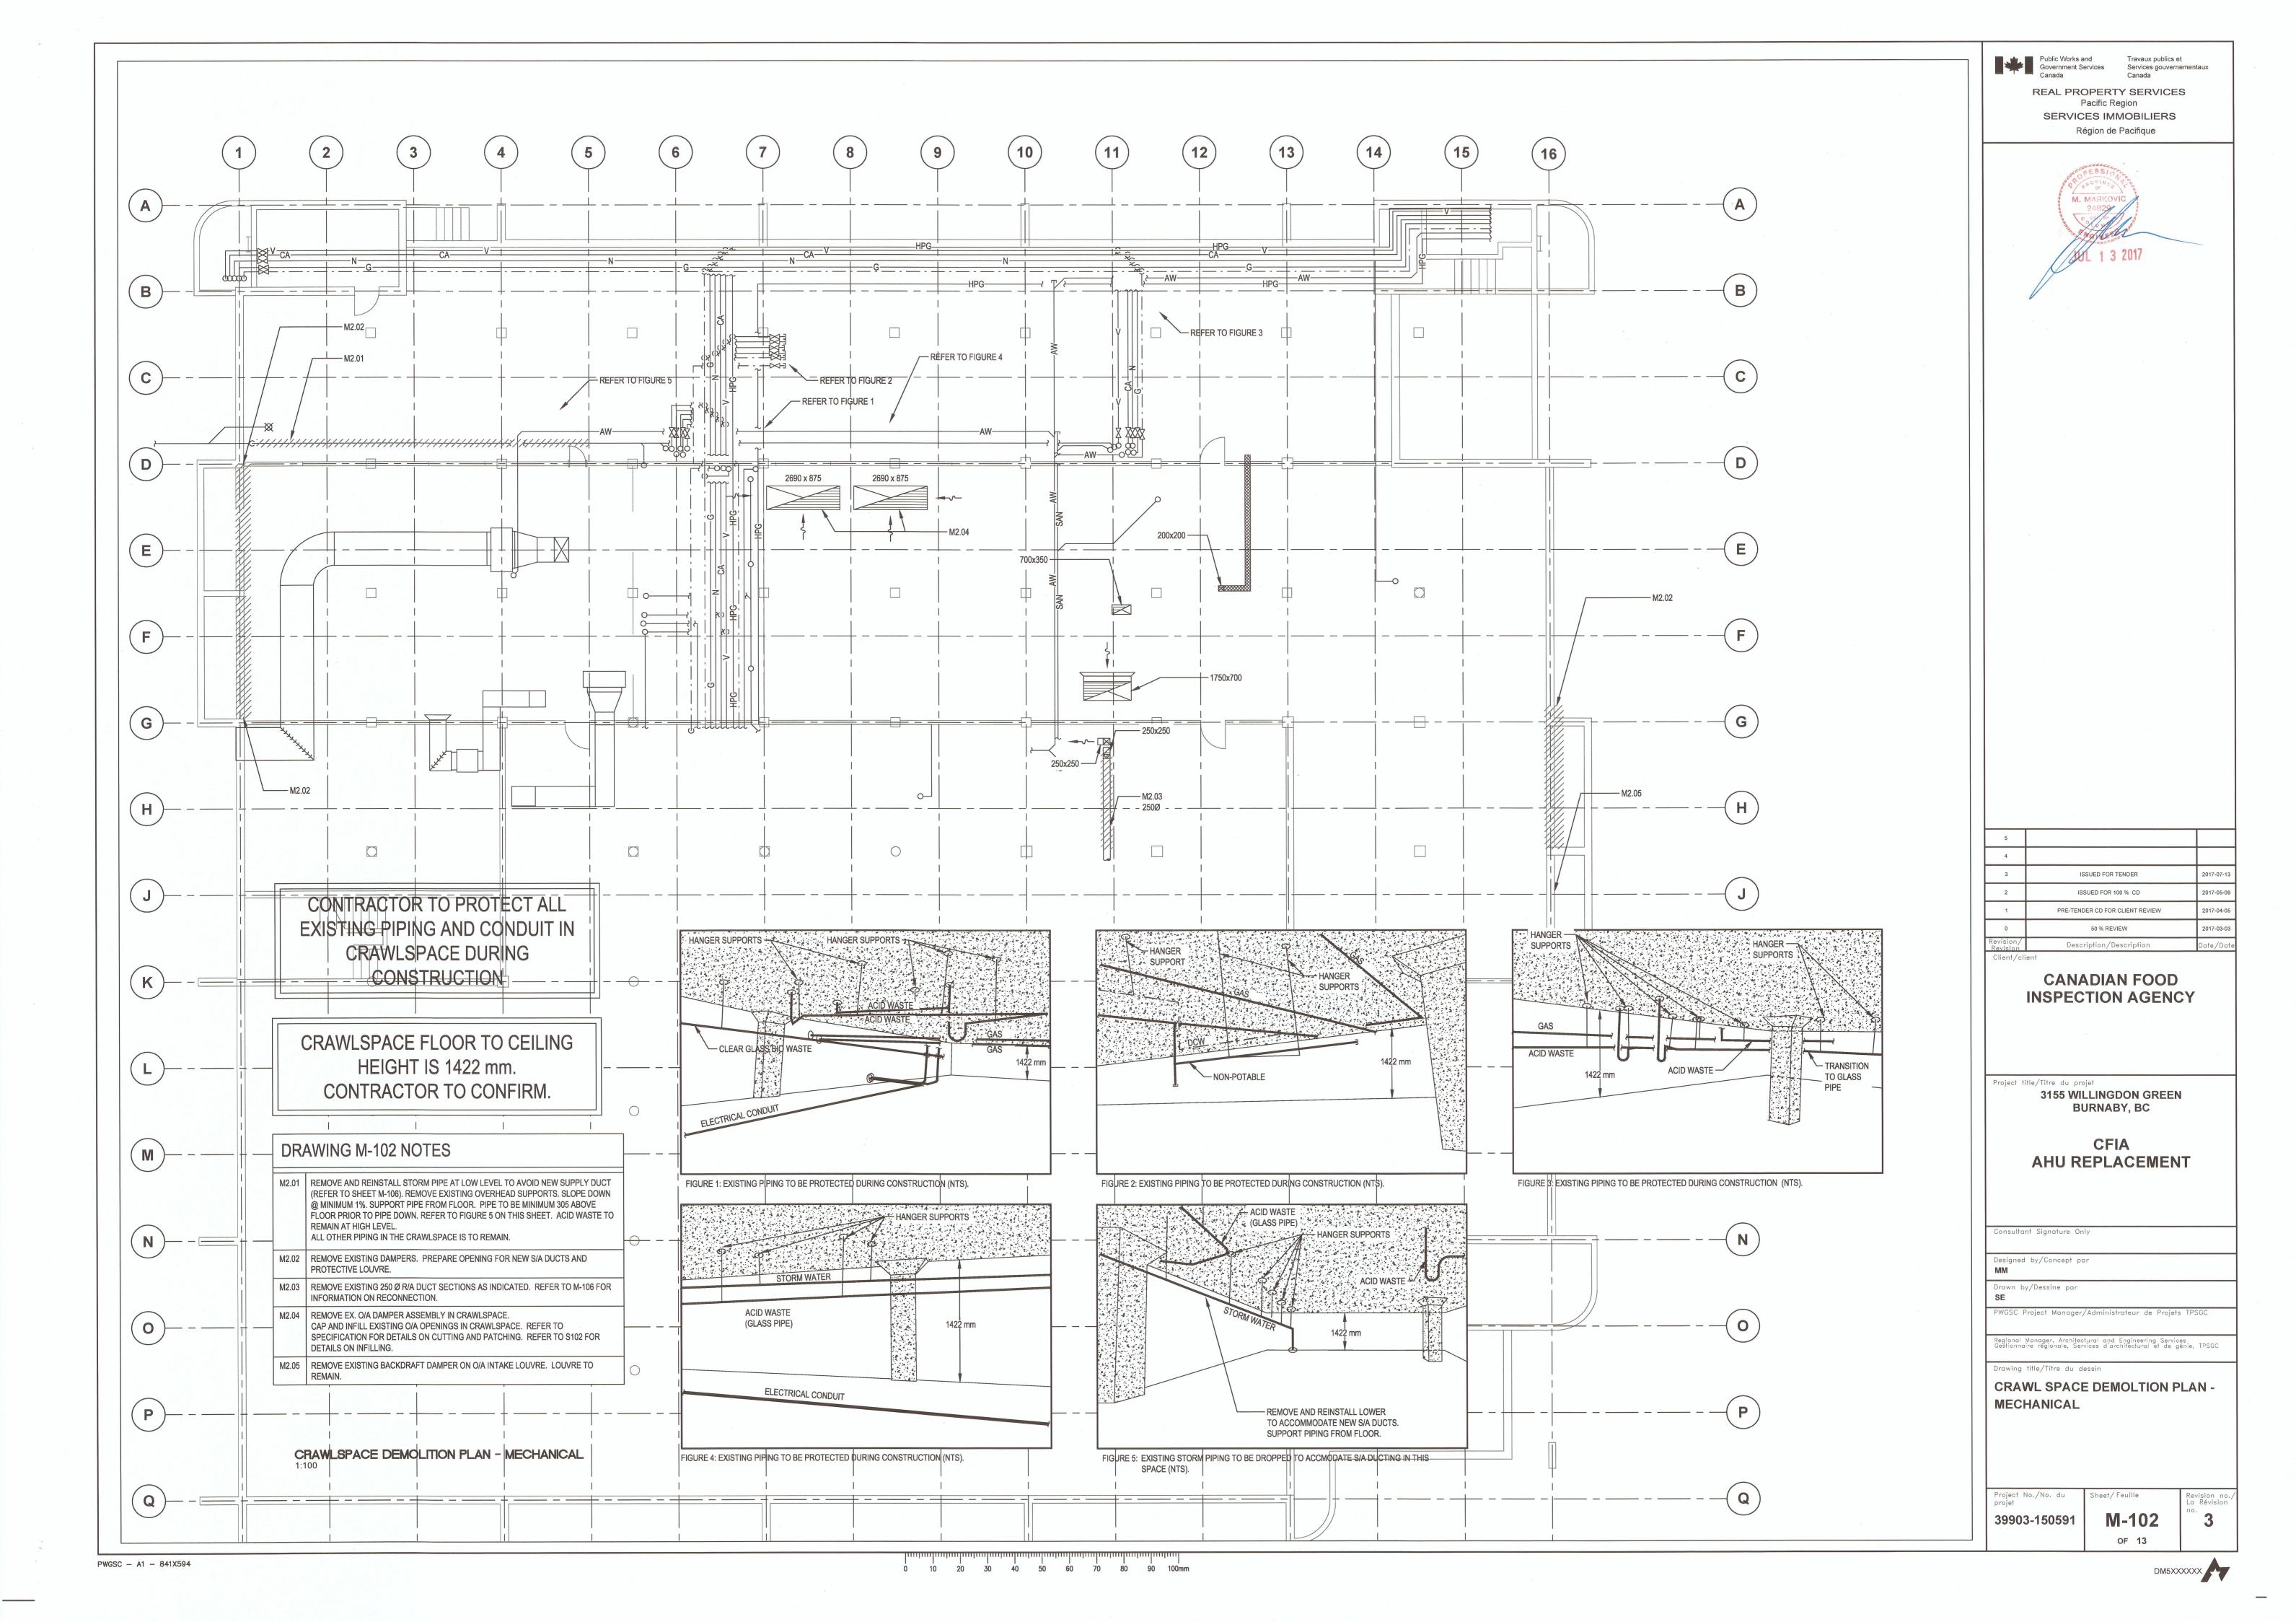

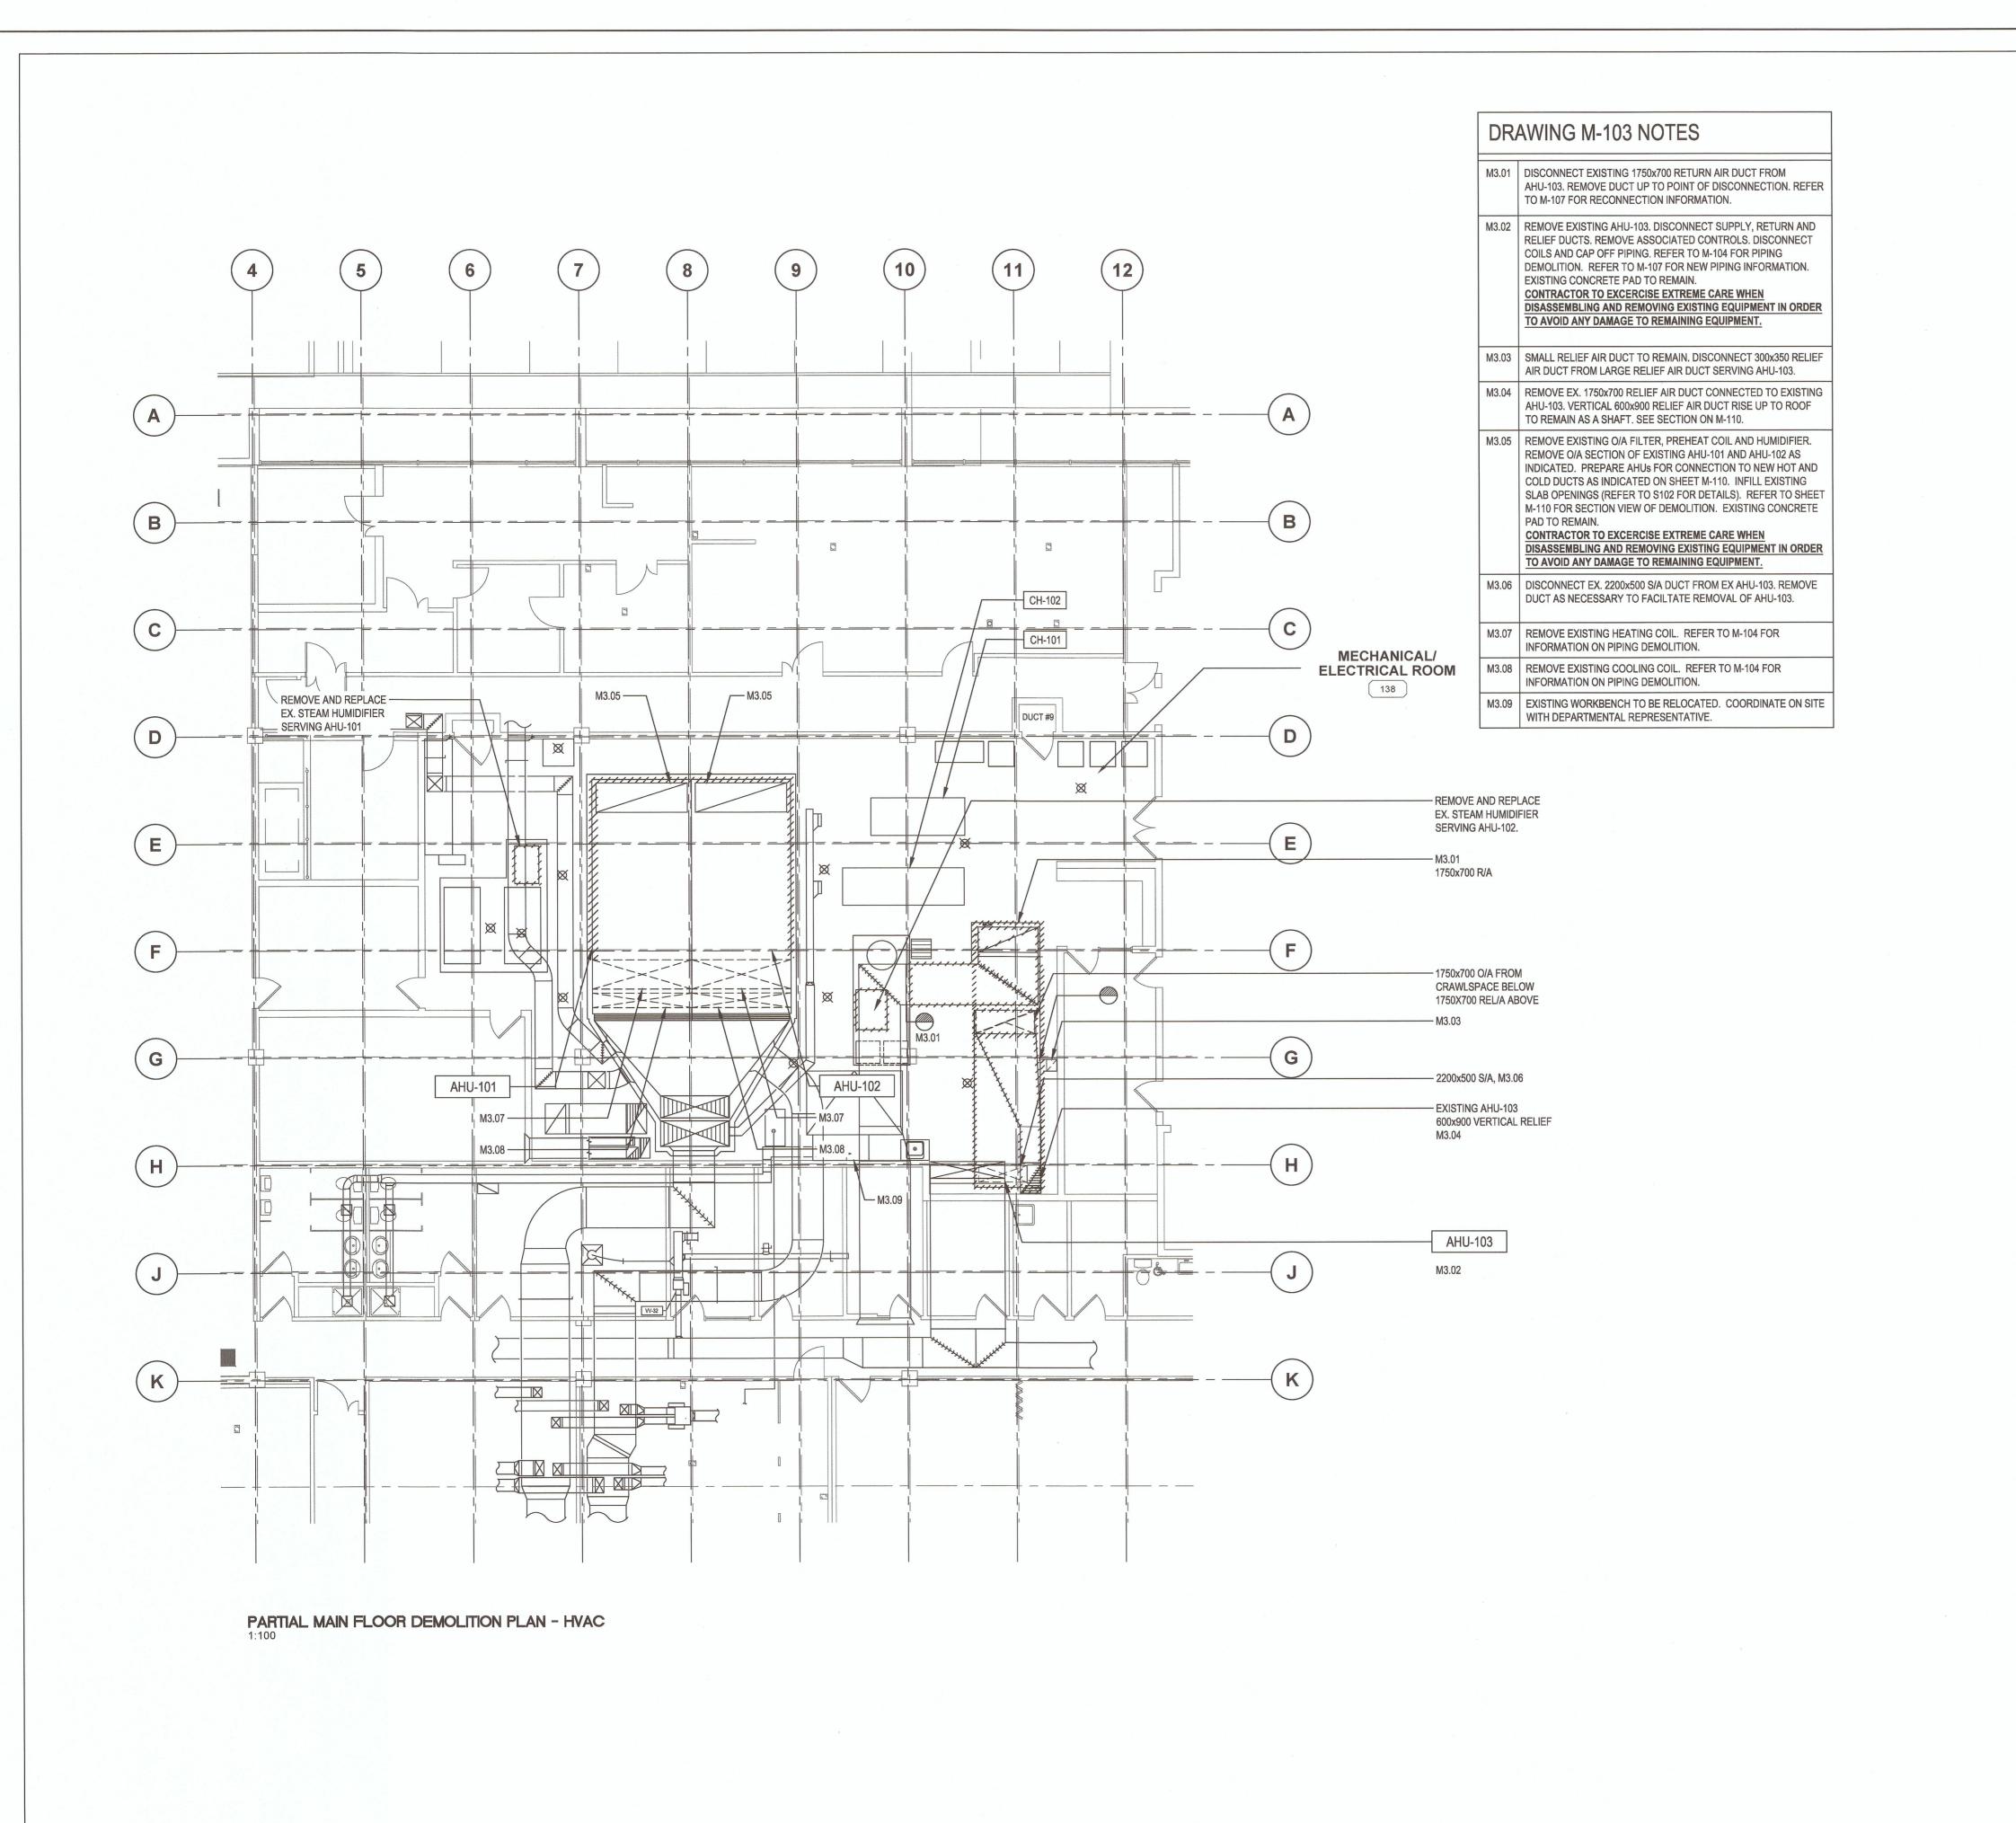


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REAL PROPERTY SERVICES Pacific Region SERVICES IMMOBILIERS Région de Pacifique





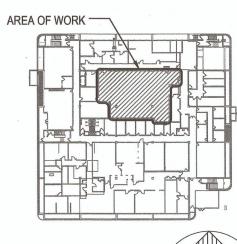

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	4 3 2 1	4  3 ISSUED FOR TENDER  2 ISSUED FOR 100 % CD  1 PRE-TENDER CD FOR CLIENT REVIEW  0 50 % REVIEW

**CANADIAN FOOD INSPECTION AGENCY** 

Project title/Titre du projet 3155 WILLINGDON GREEN BURNABY, BC

> **CFIA AHU REPLACEMENT**

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PWGSC Project Manager/Administrateur de Projets TPSGC


Regional Manager, Architectural and Engineering Services Gestionnaire régionale, Services d'architectural et de génie, TPSGC

Drawing title/Titre du dessin PARTIAL MAIN FLOOR DEMOLITION PLAN - HVAC

Project No./No. du projet M-103 39903-150591

OF 13

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REAL PROPERTY SERVICES Pacific Region SERVICES IMMOBILIERS Région de Pacifique

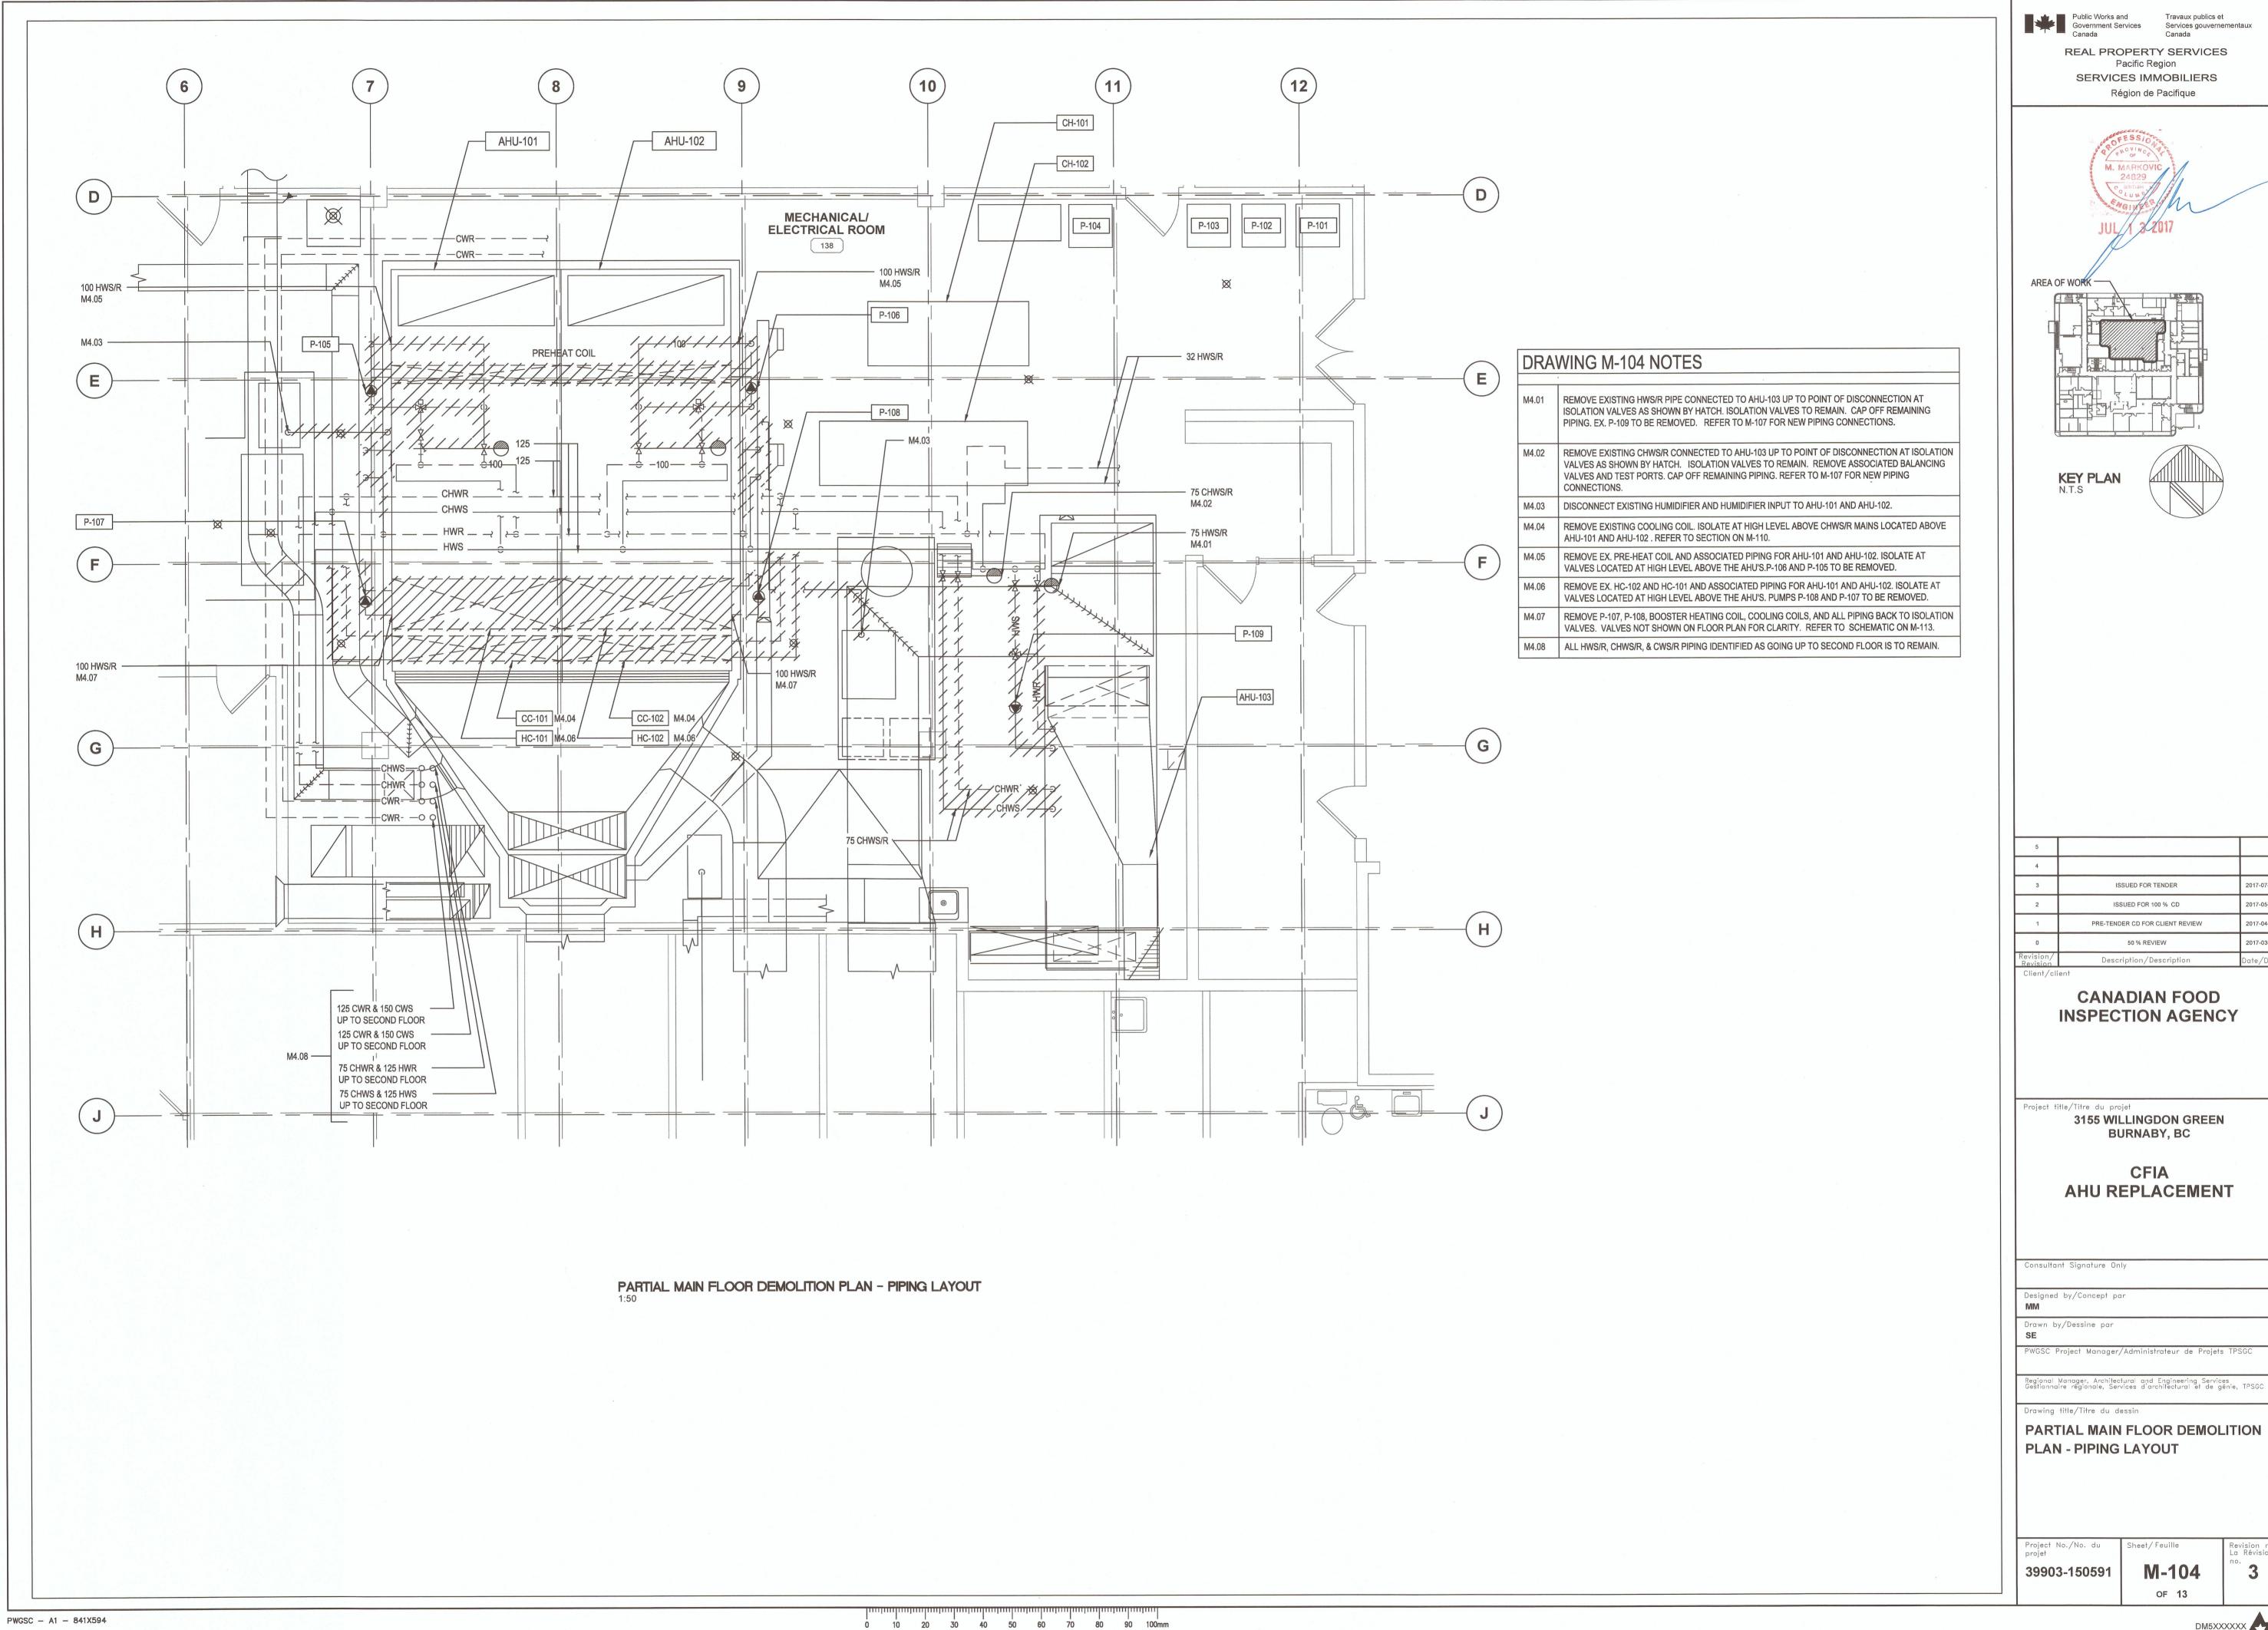




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2	ISSUED FOR 100 % CD	2017-05-09
1	PRE-TENDER CD FOR CLIENT REVIEW	2017-04-05
0	50 % REVIEW	2017-03-03
Revision/ Revision	Description/Description	Date/Date


#### **CANADIAN FOOD INSPECTION AGENCY**

3155 WILLINGDON GREEN BURNABY, BC

# AHU REPLACEMENT

M-104

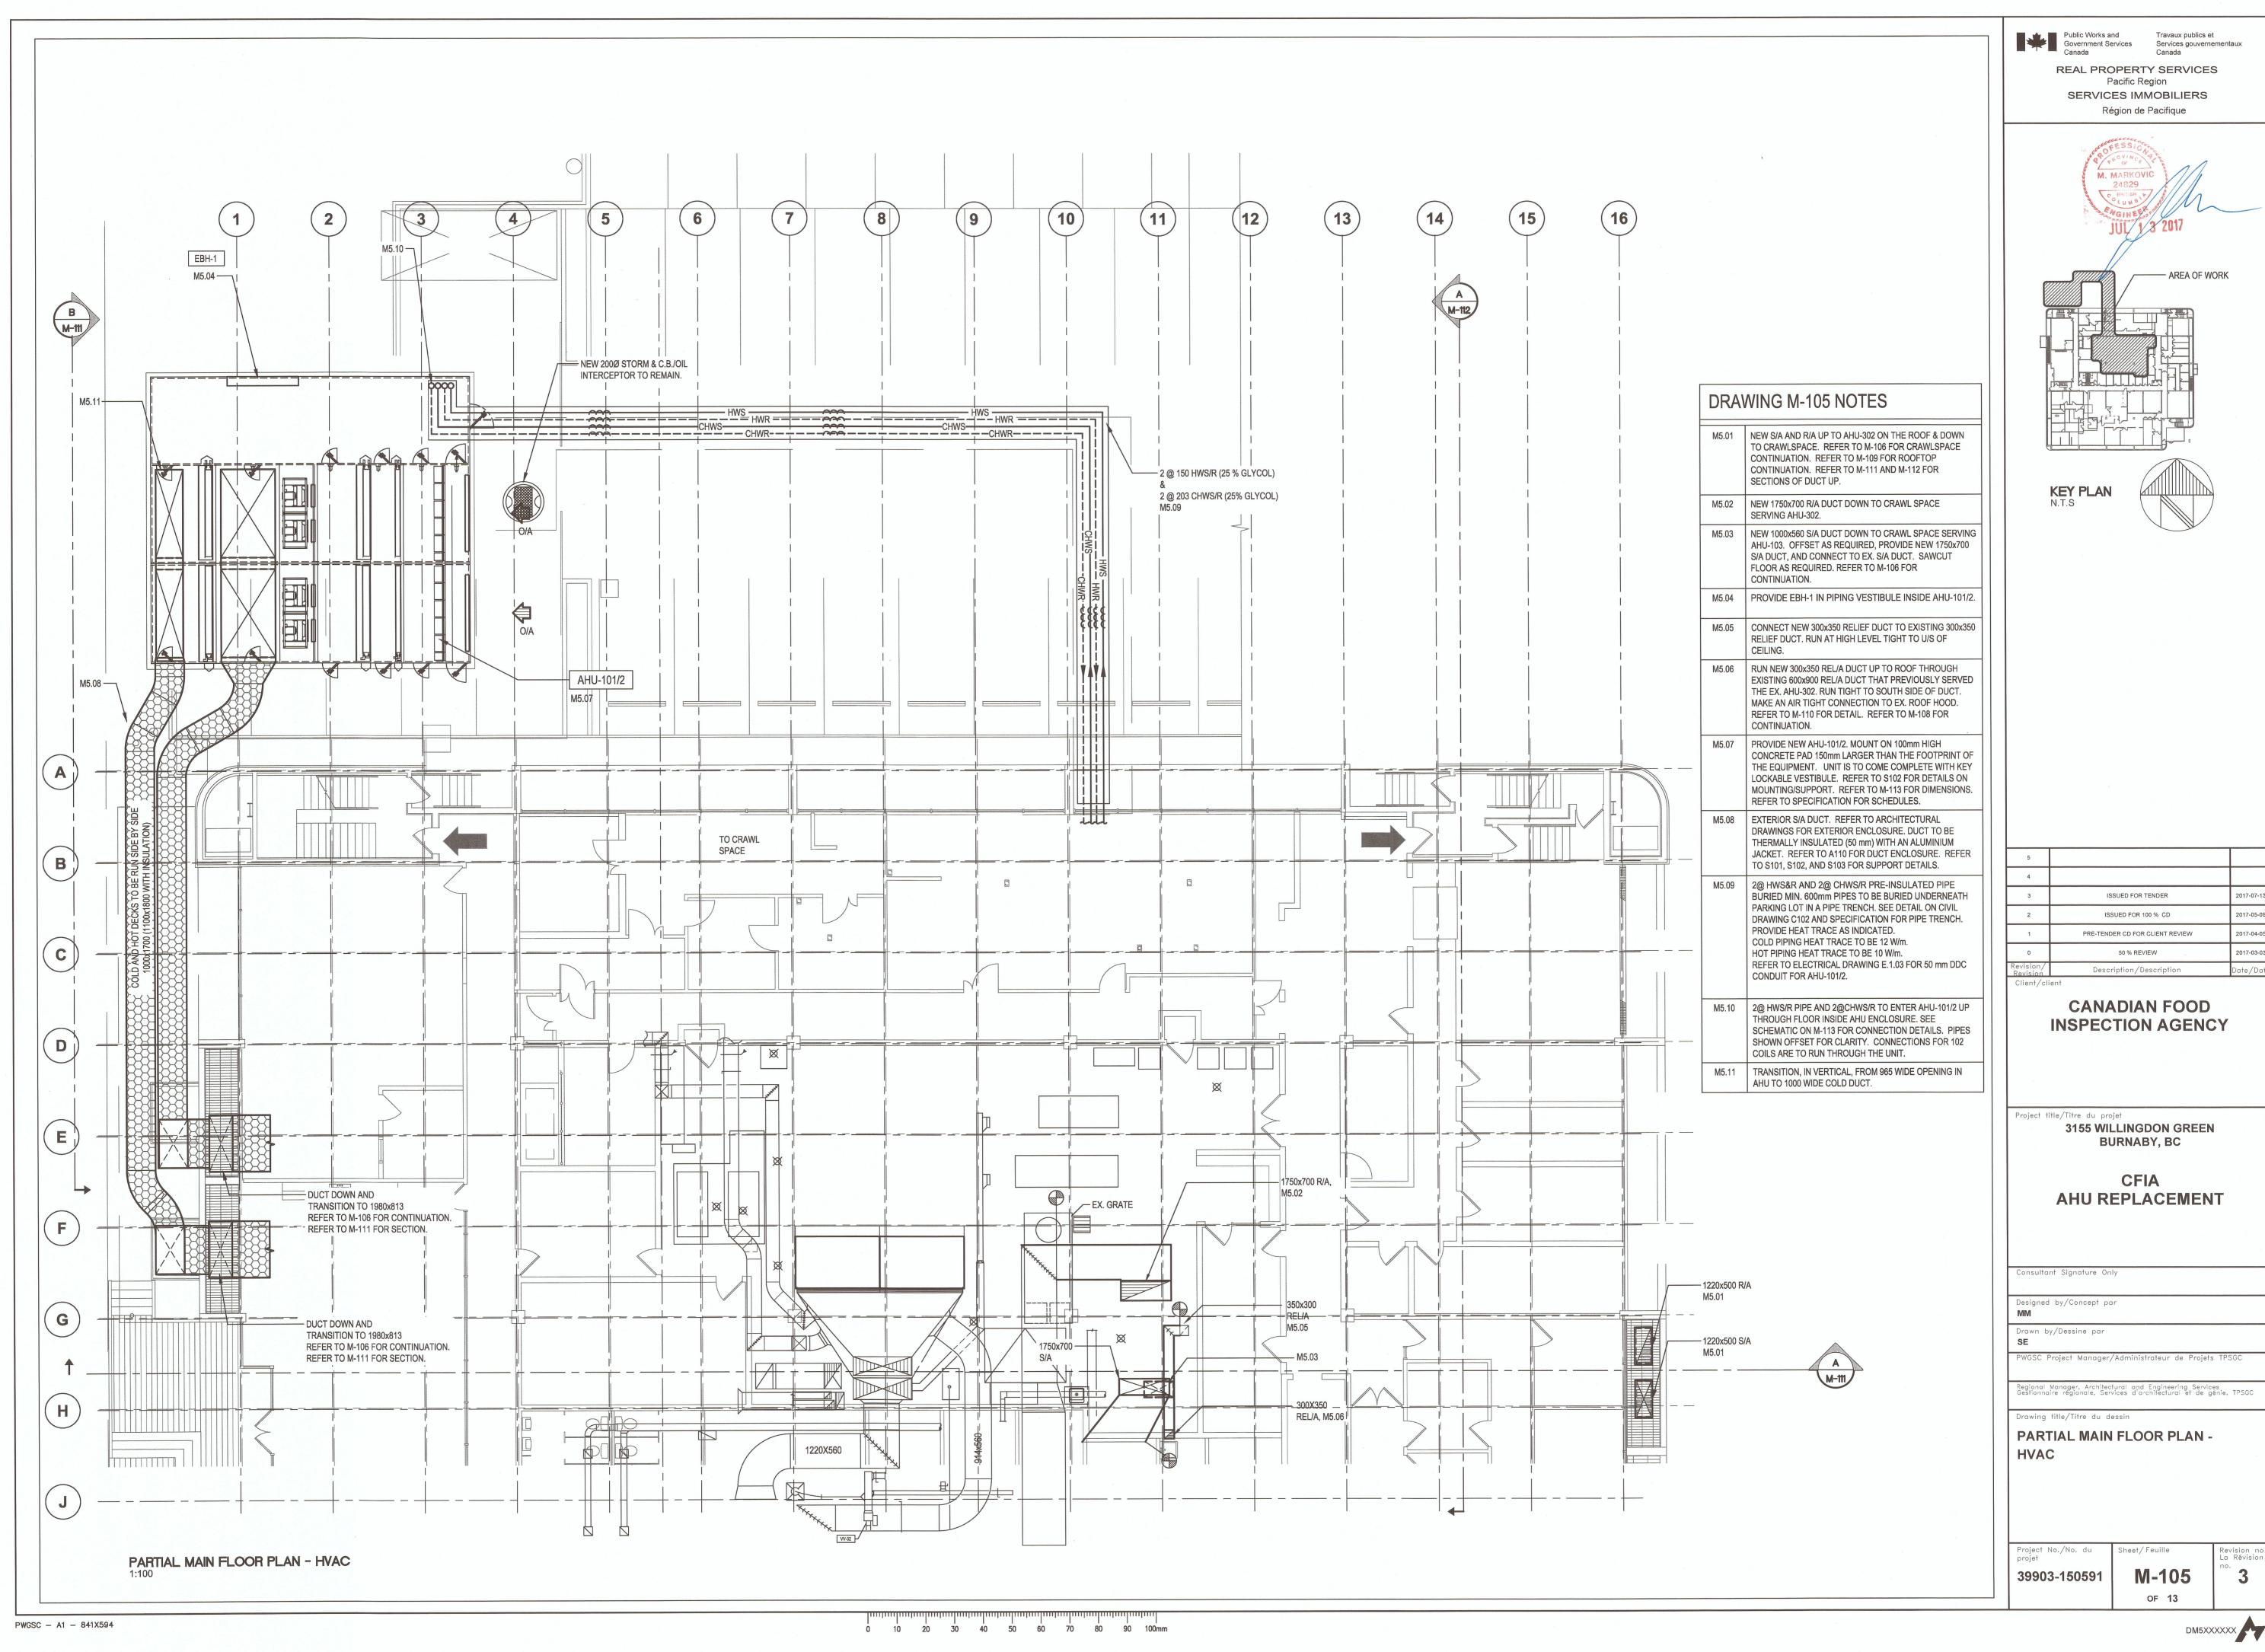

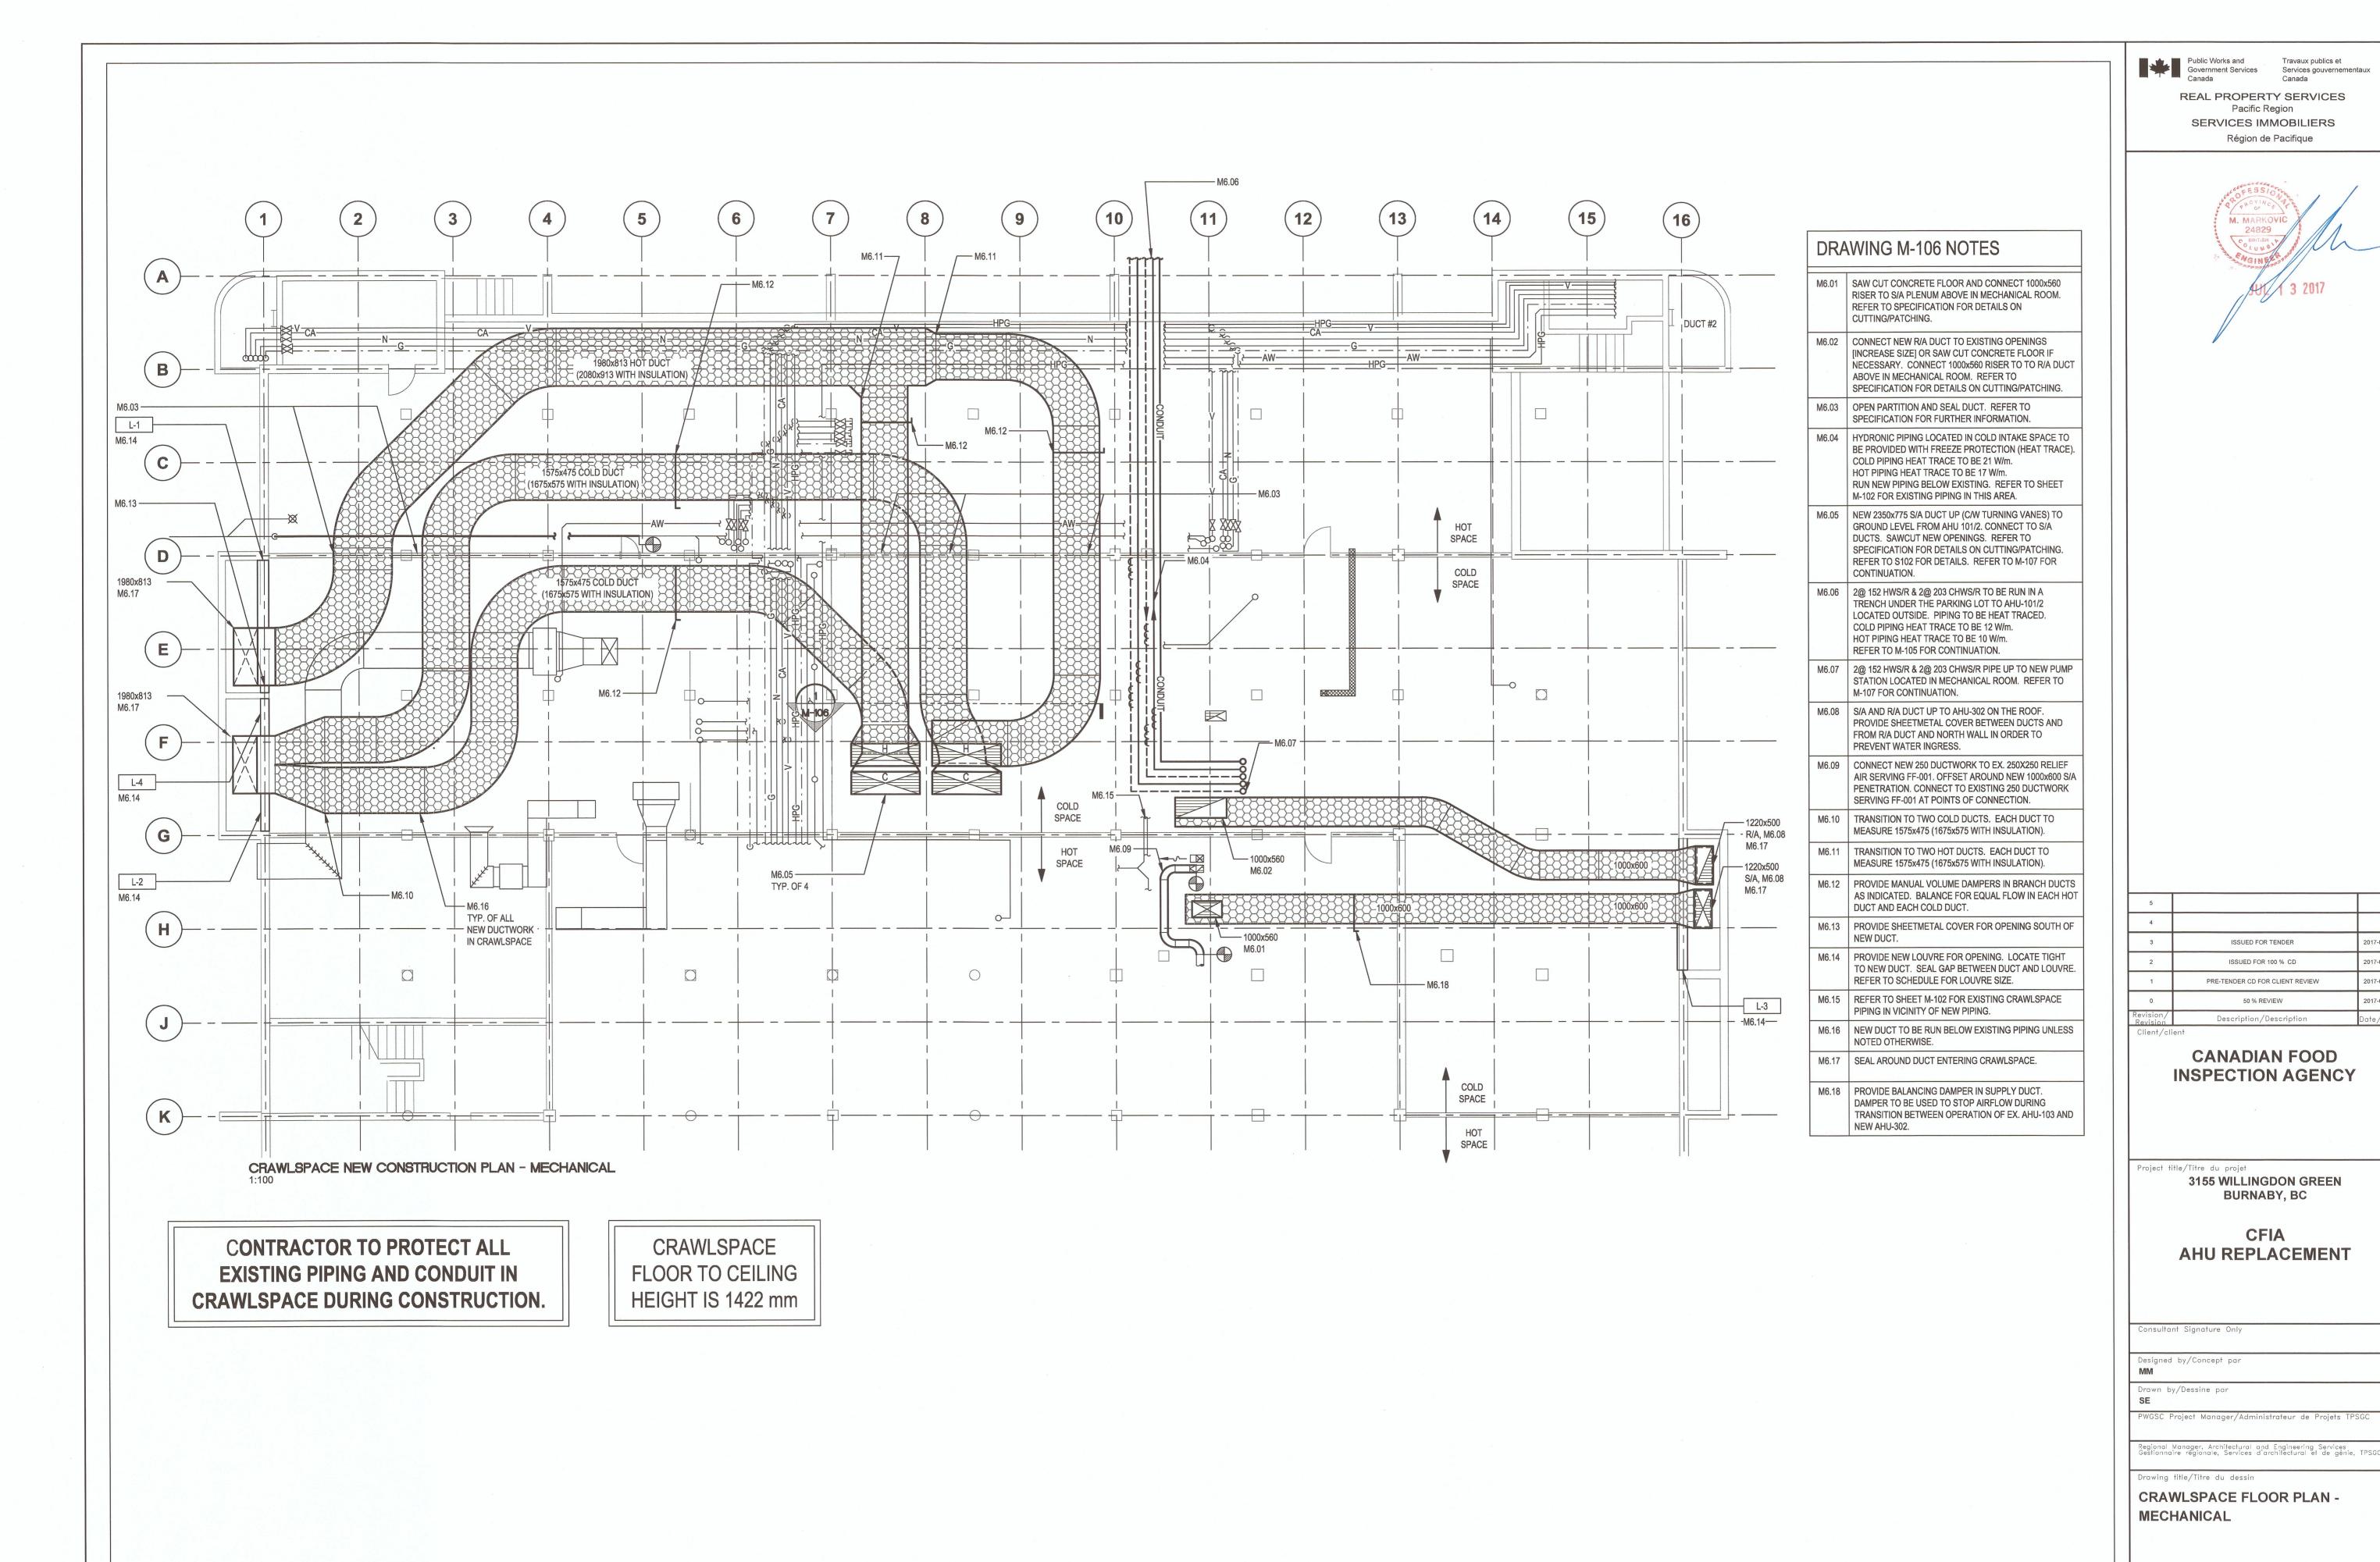



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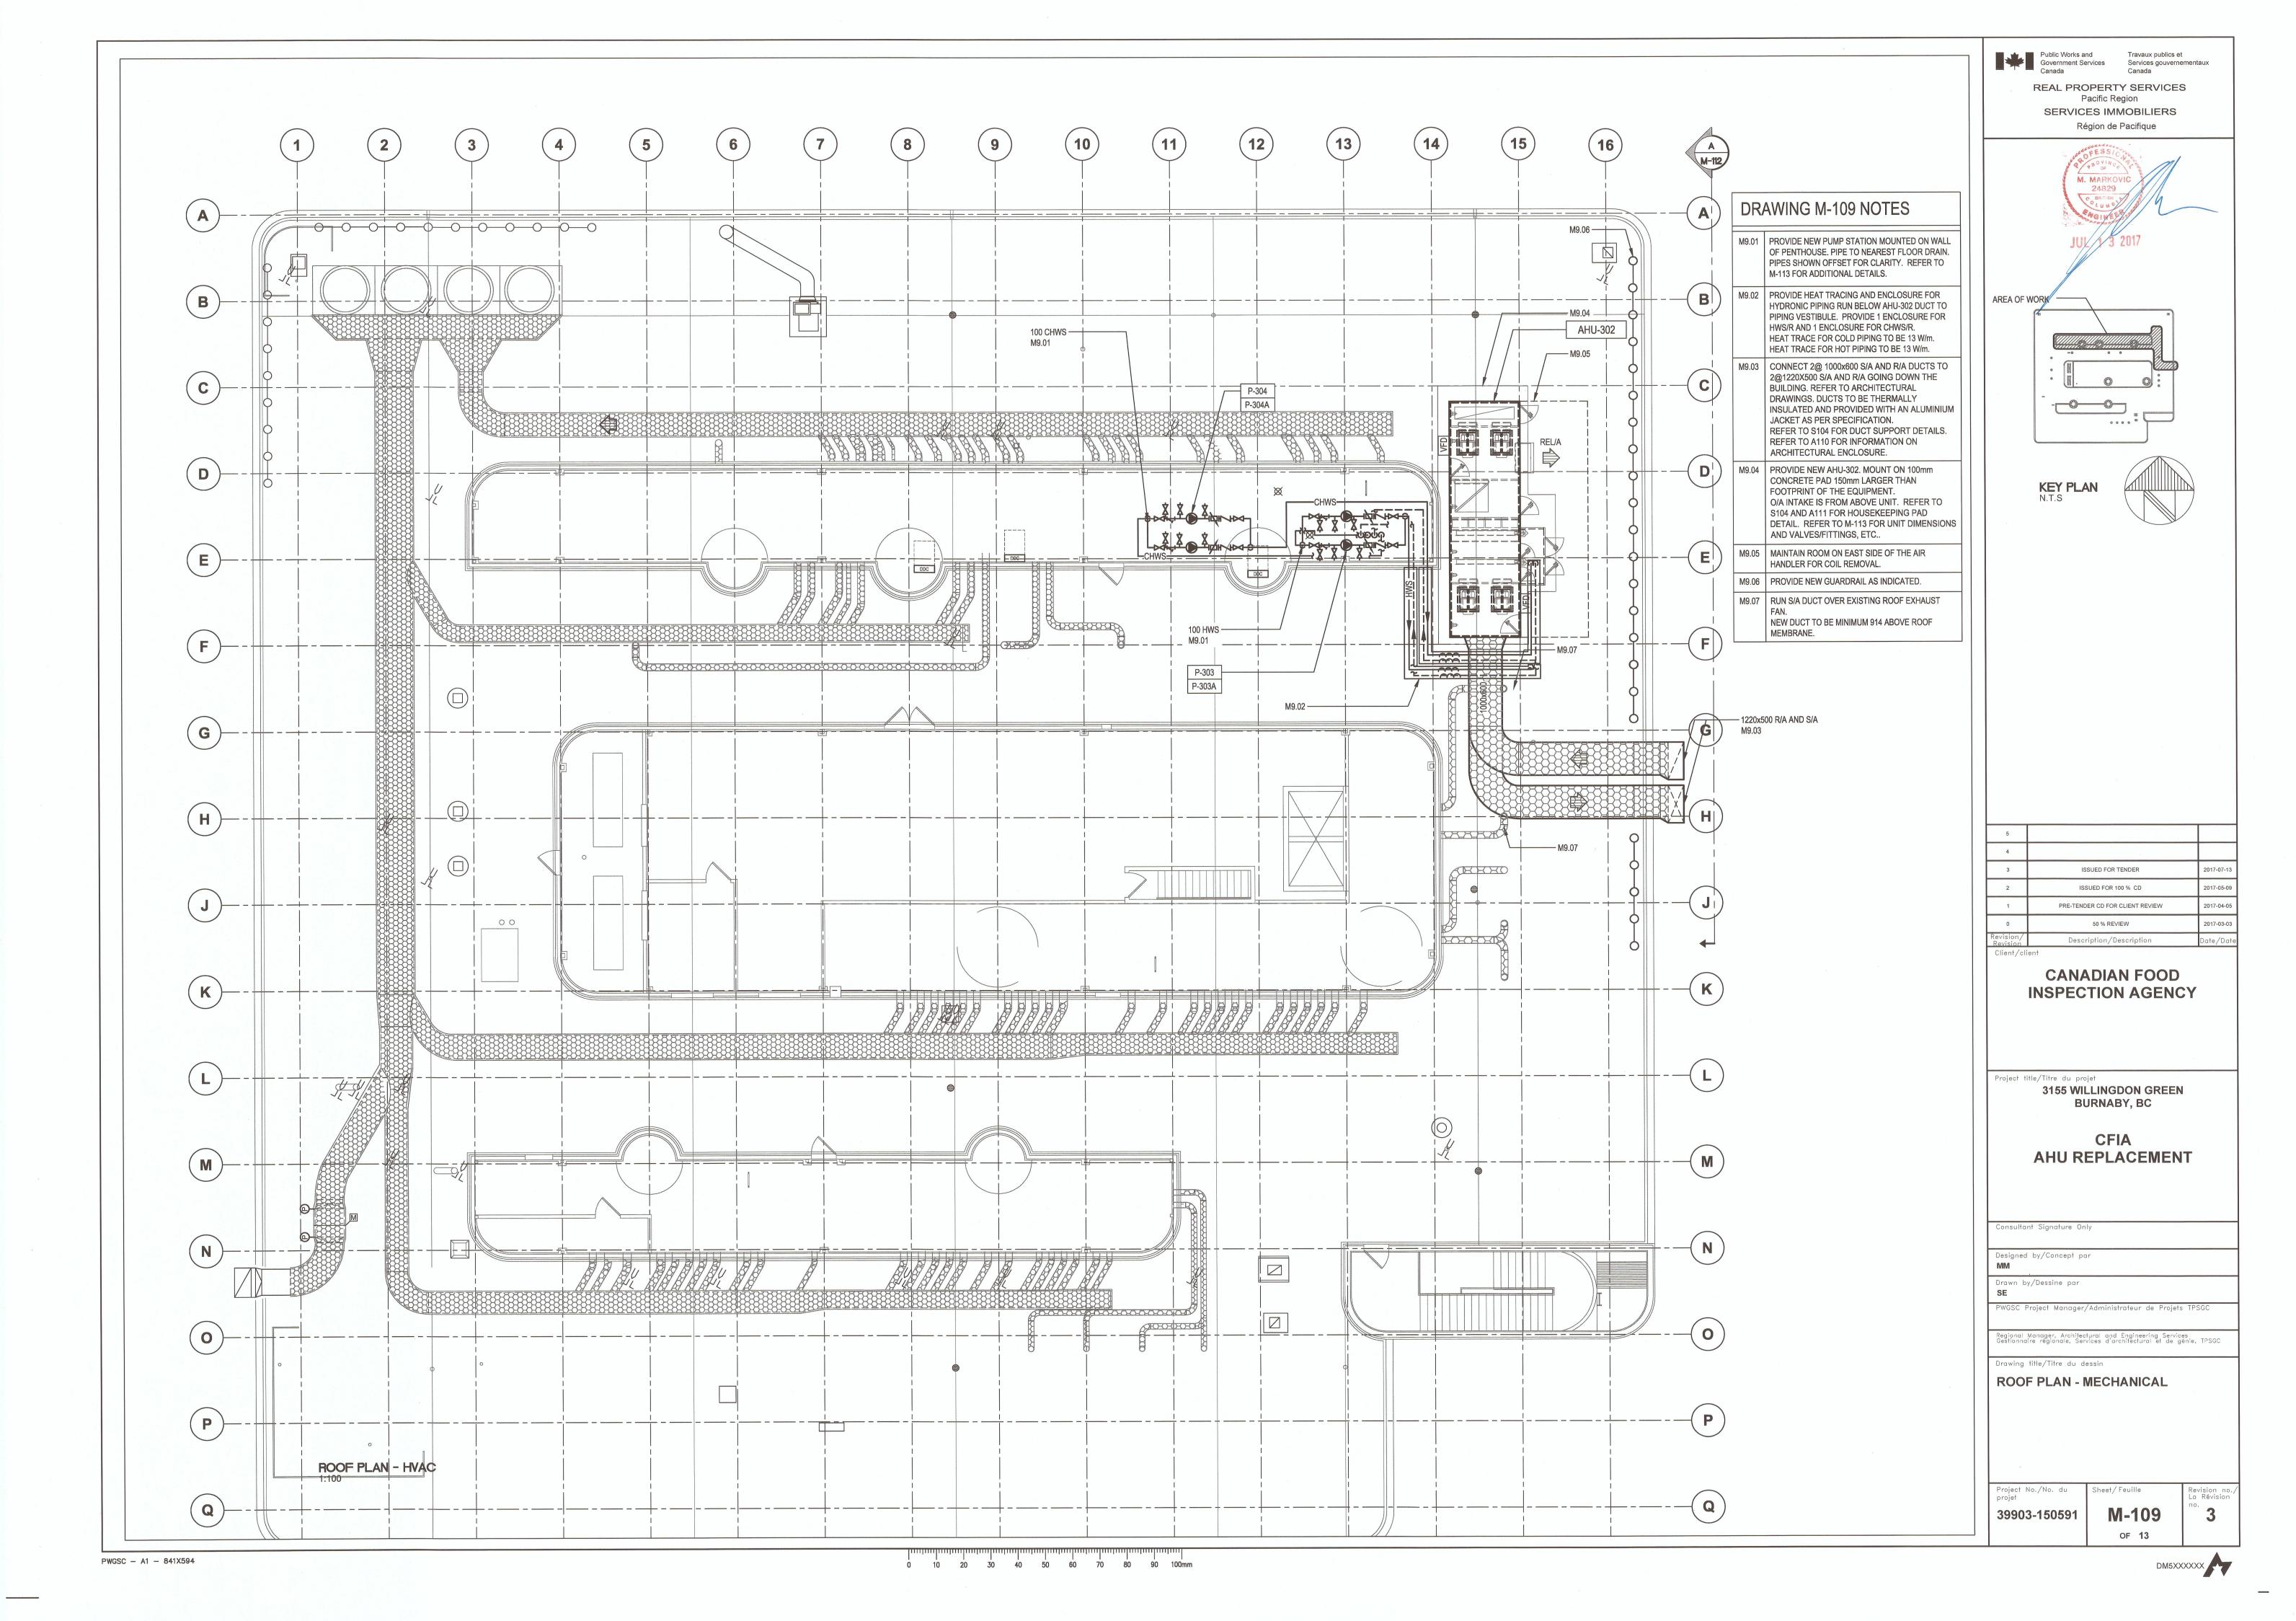
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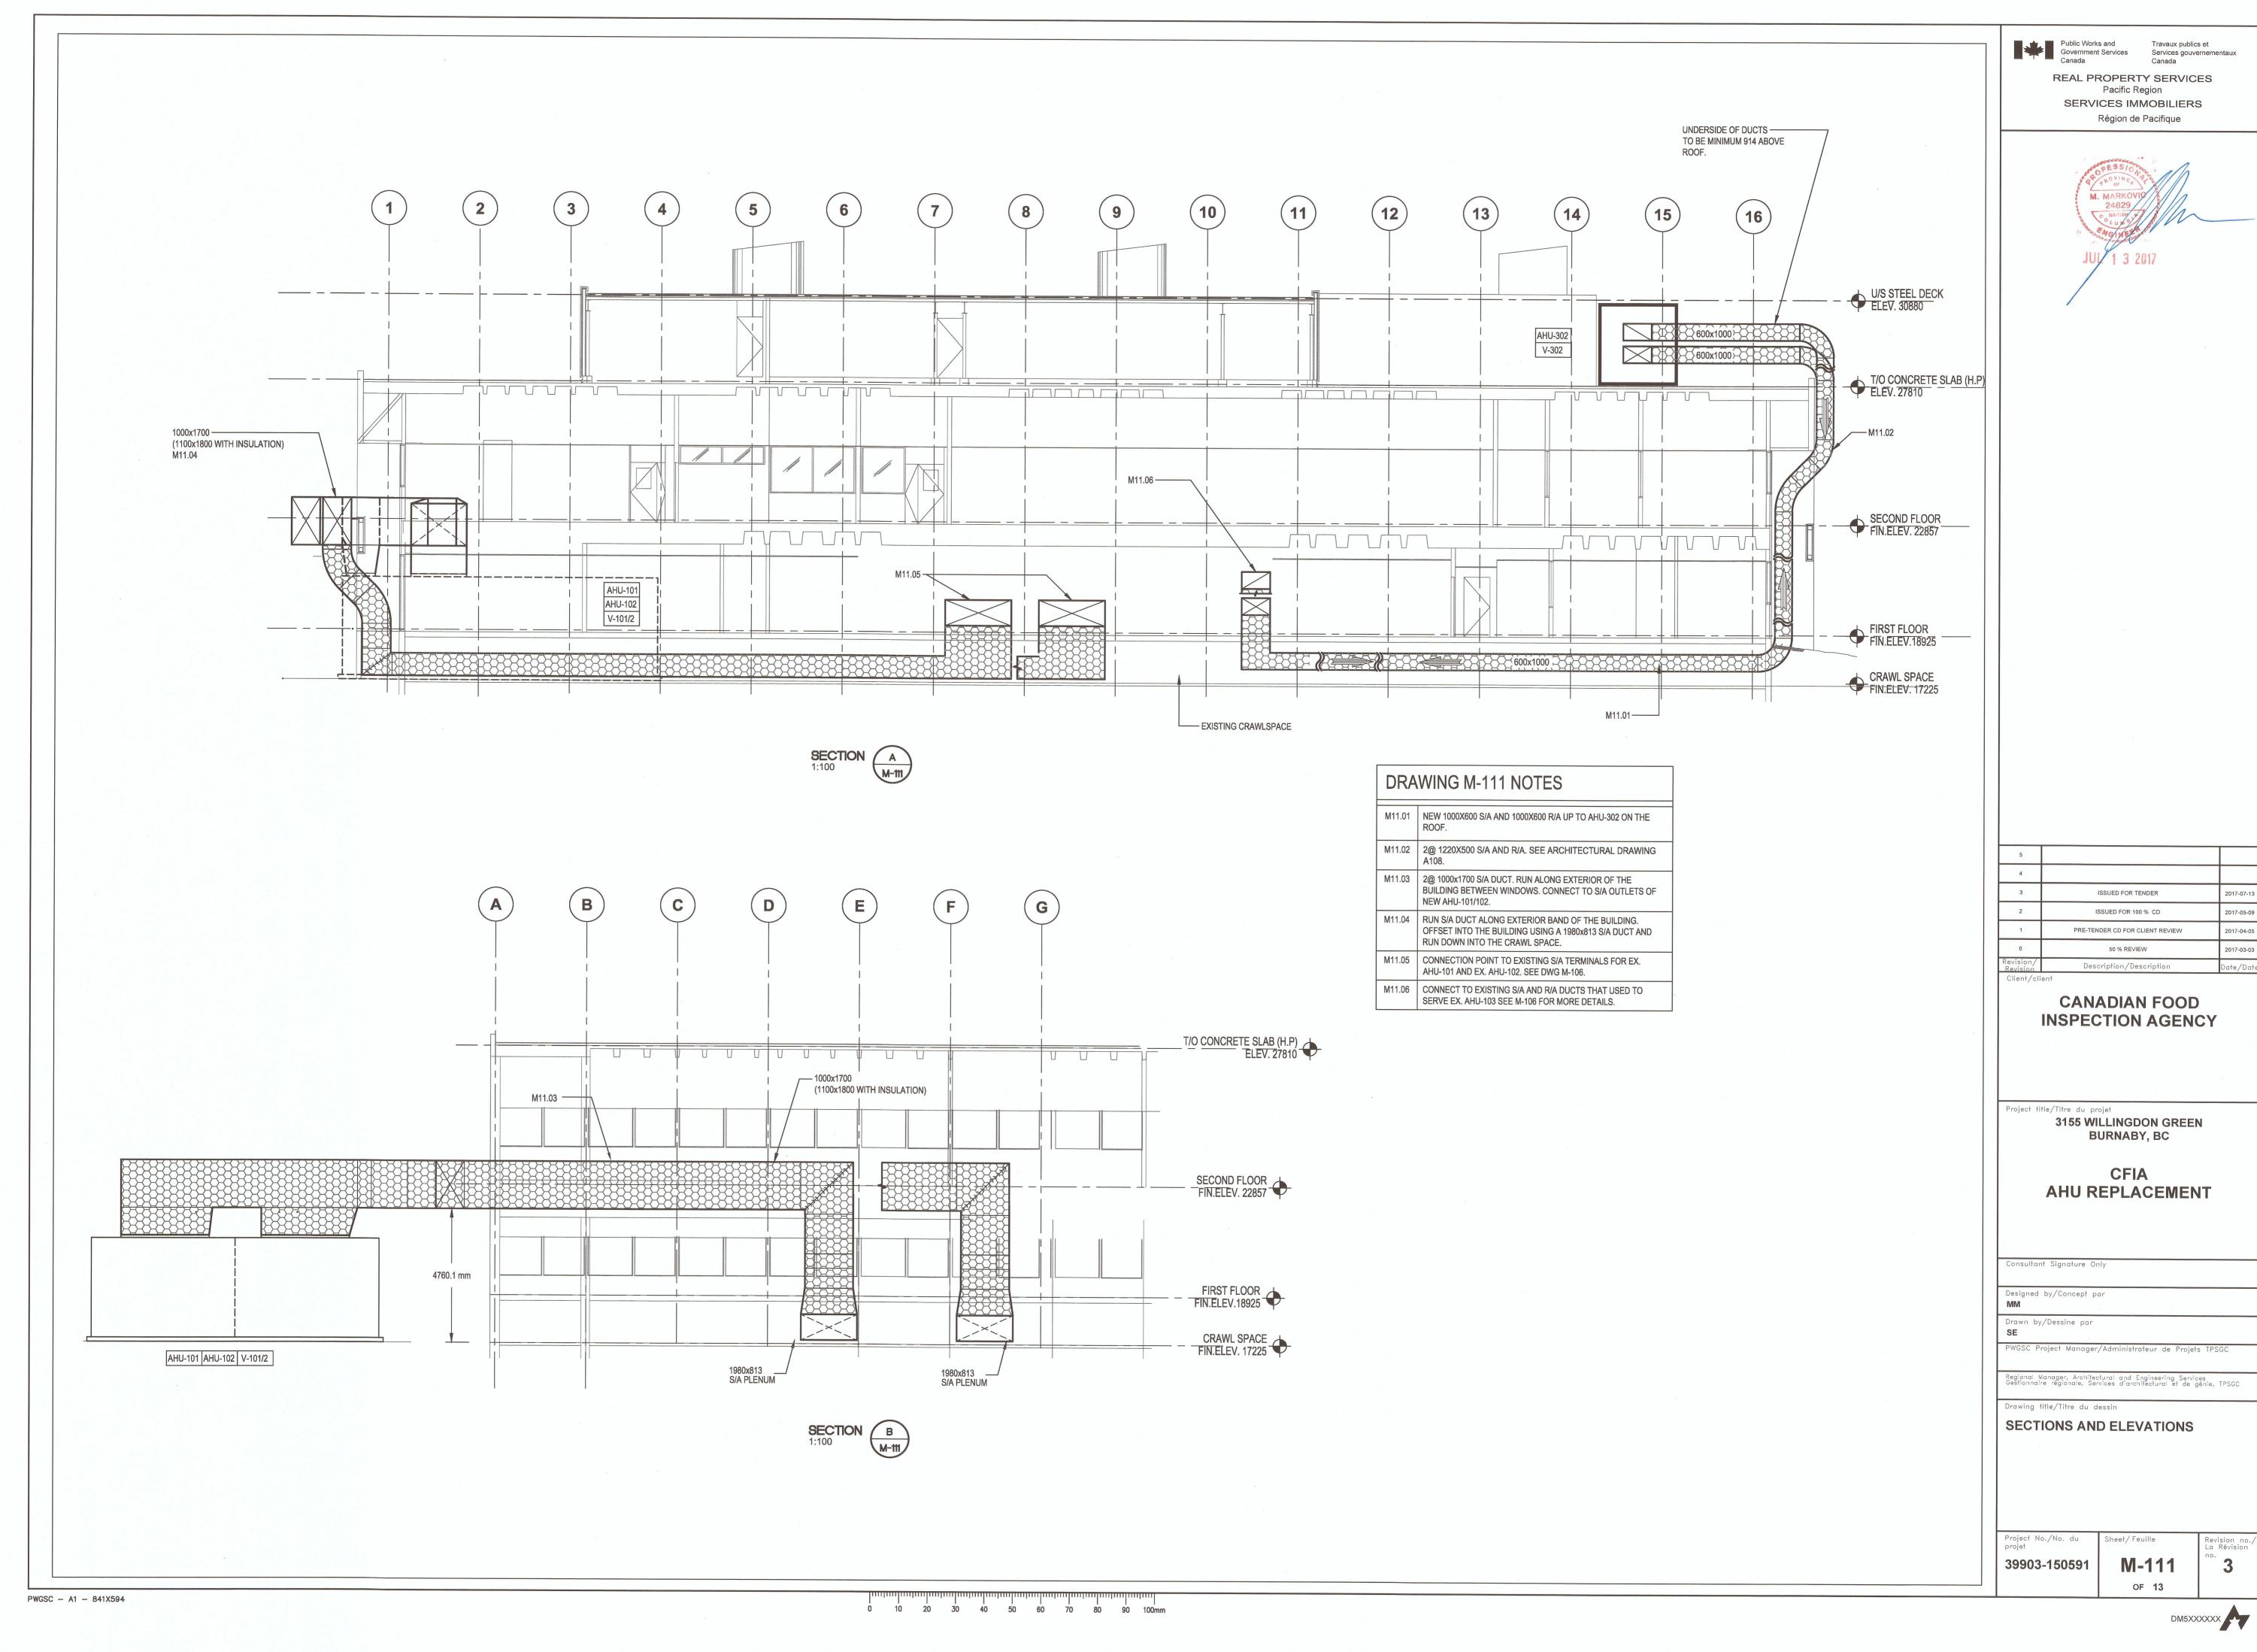
OF 13


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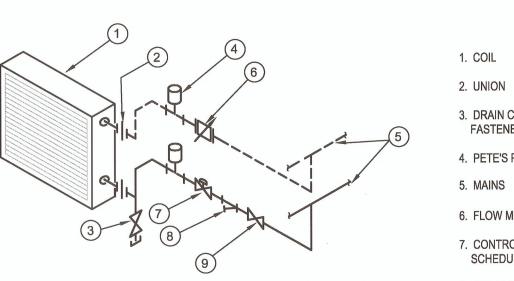
DRAWING M-112 NOTES

M12.01 CONNECT 1000x600 R/A DUCT TO 2814x604 R/A INPUT ON AHU-302. DUCT TO BE MINIMUM 914 ABOVE ROOF.

M12.02 | CONNECT 1000x600 S/A DUCT TO 560x2815 S/A OUTPUT ON AHU-302. DUCT TO BE MINIMUM 914 ABOVE ROOF.

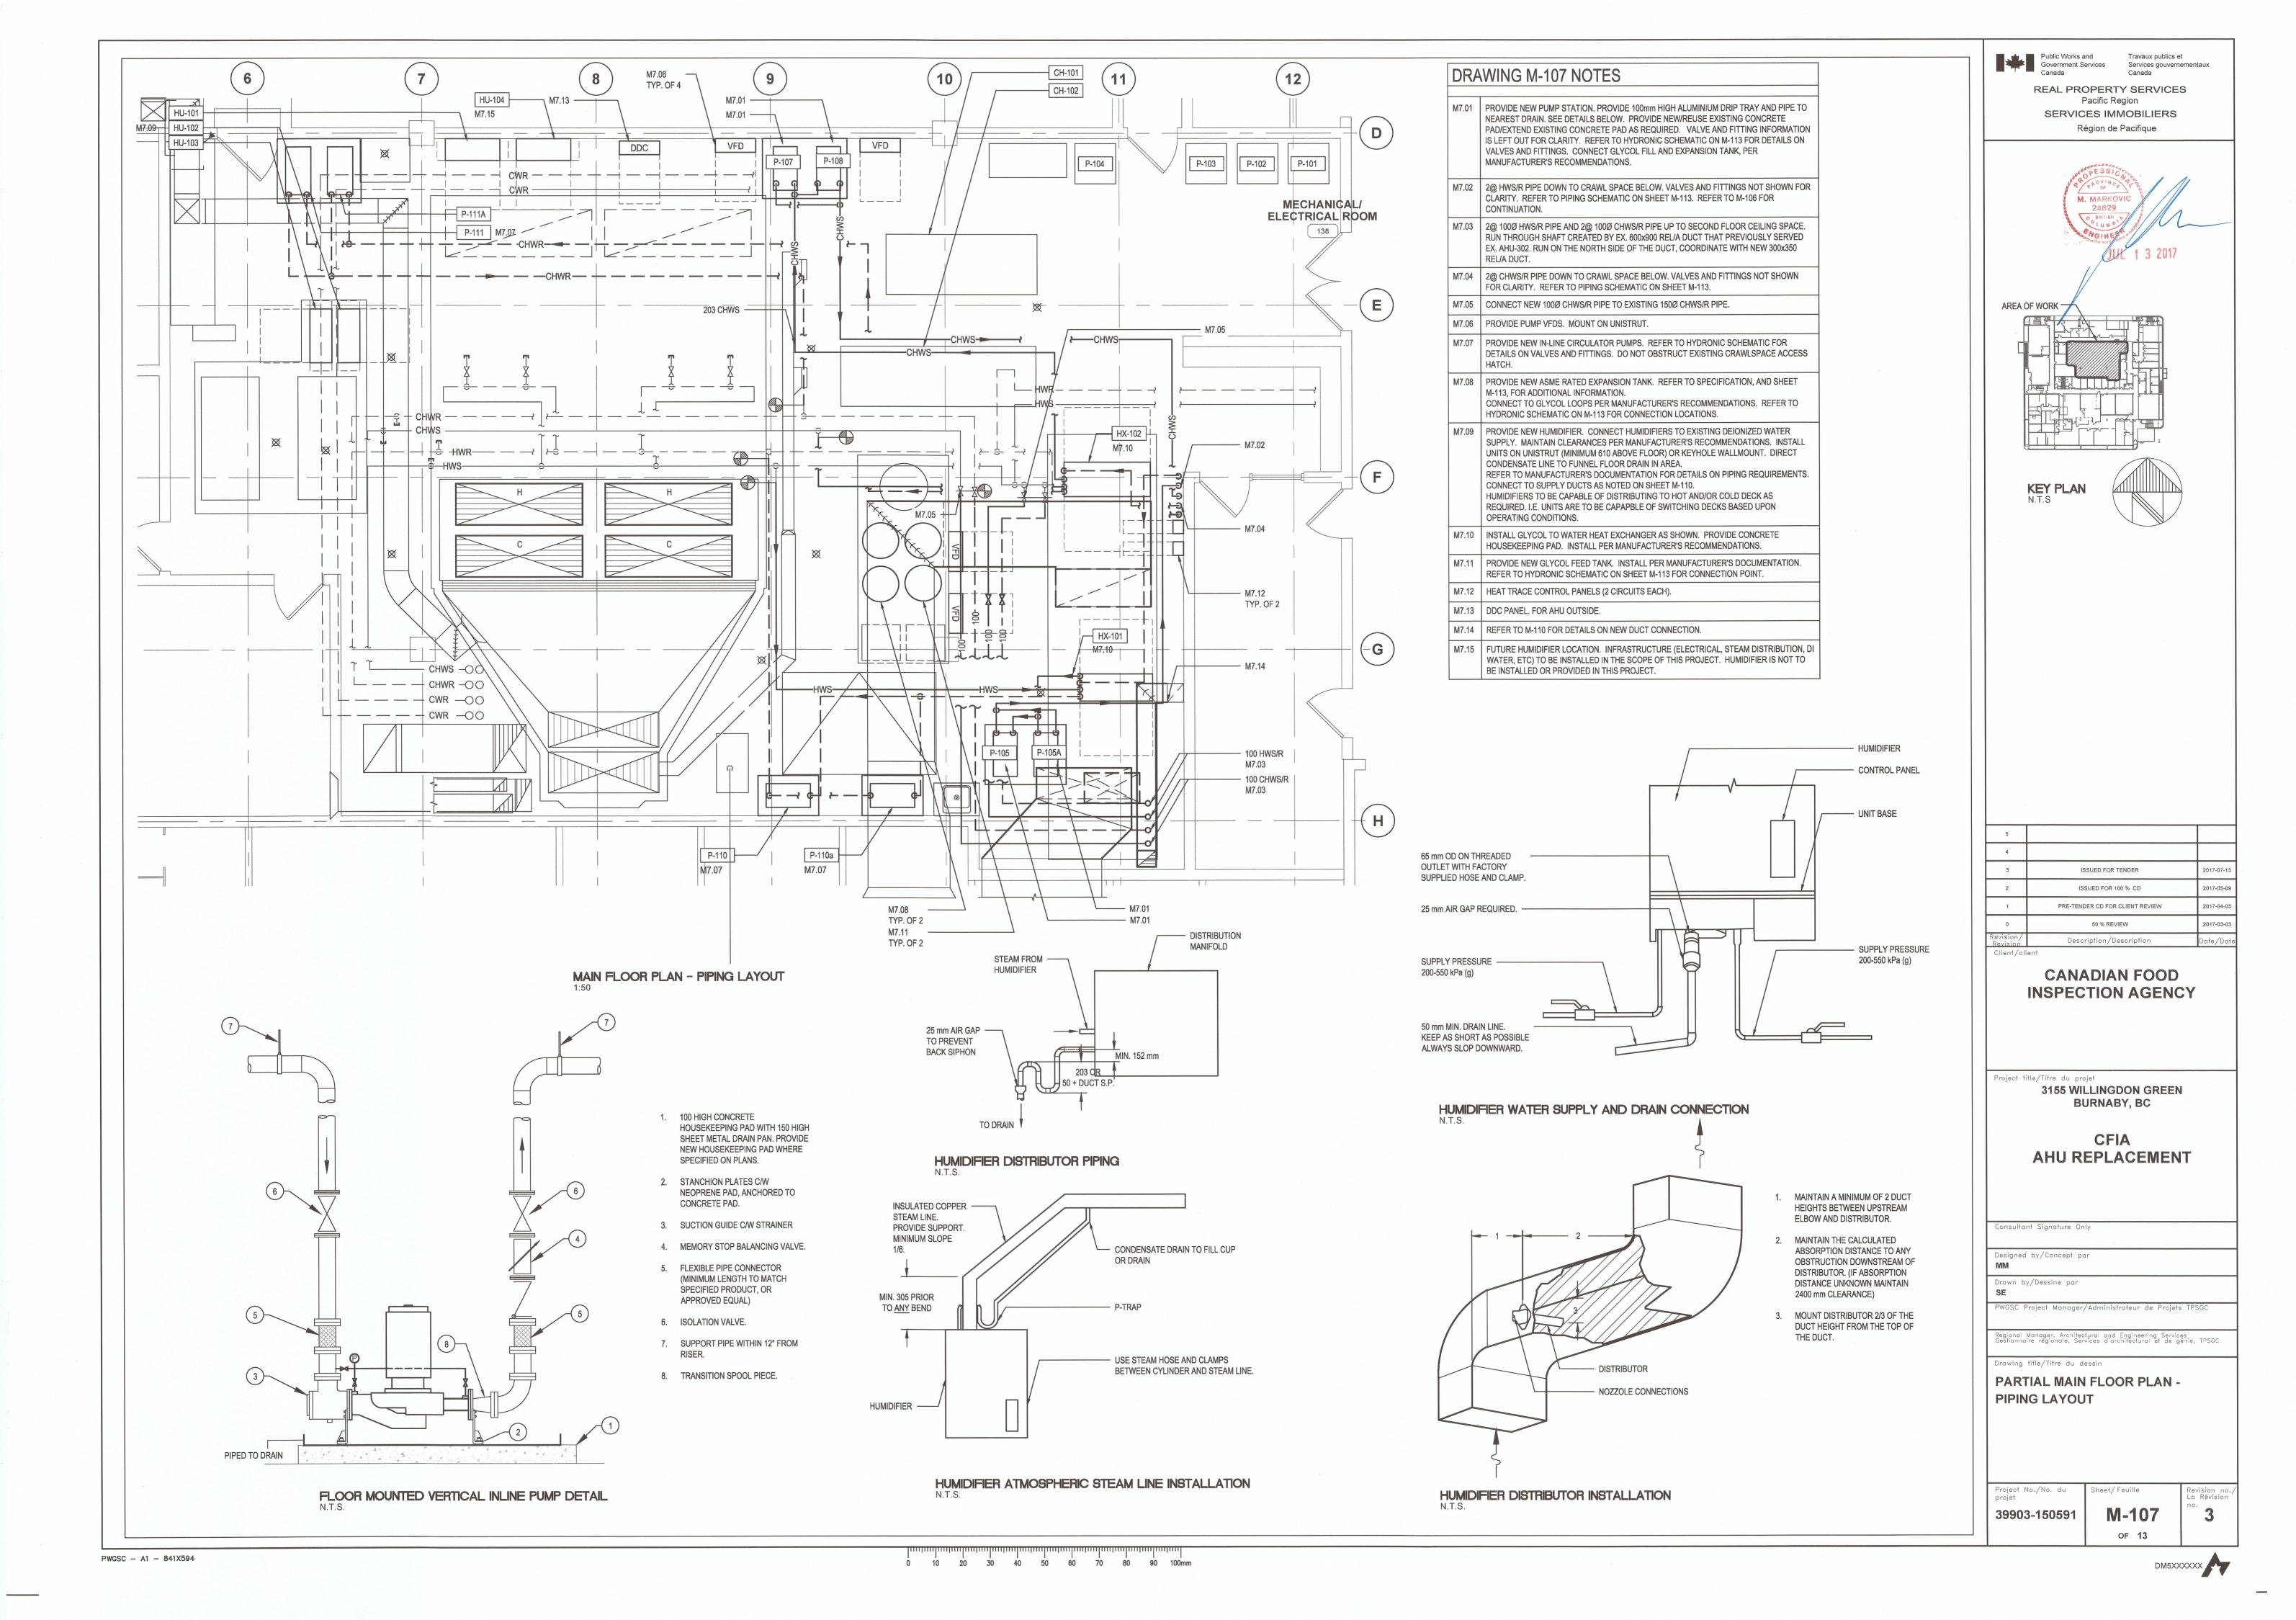1. COIL 2. UNION 3. AUTOMATIC AIR VENT PIPE TO FLOOR DRAIN PETE'S PLUG 5. MAINS 6. FLOW MEASUREMENT VALVE
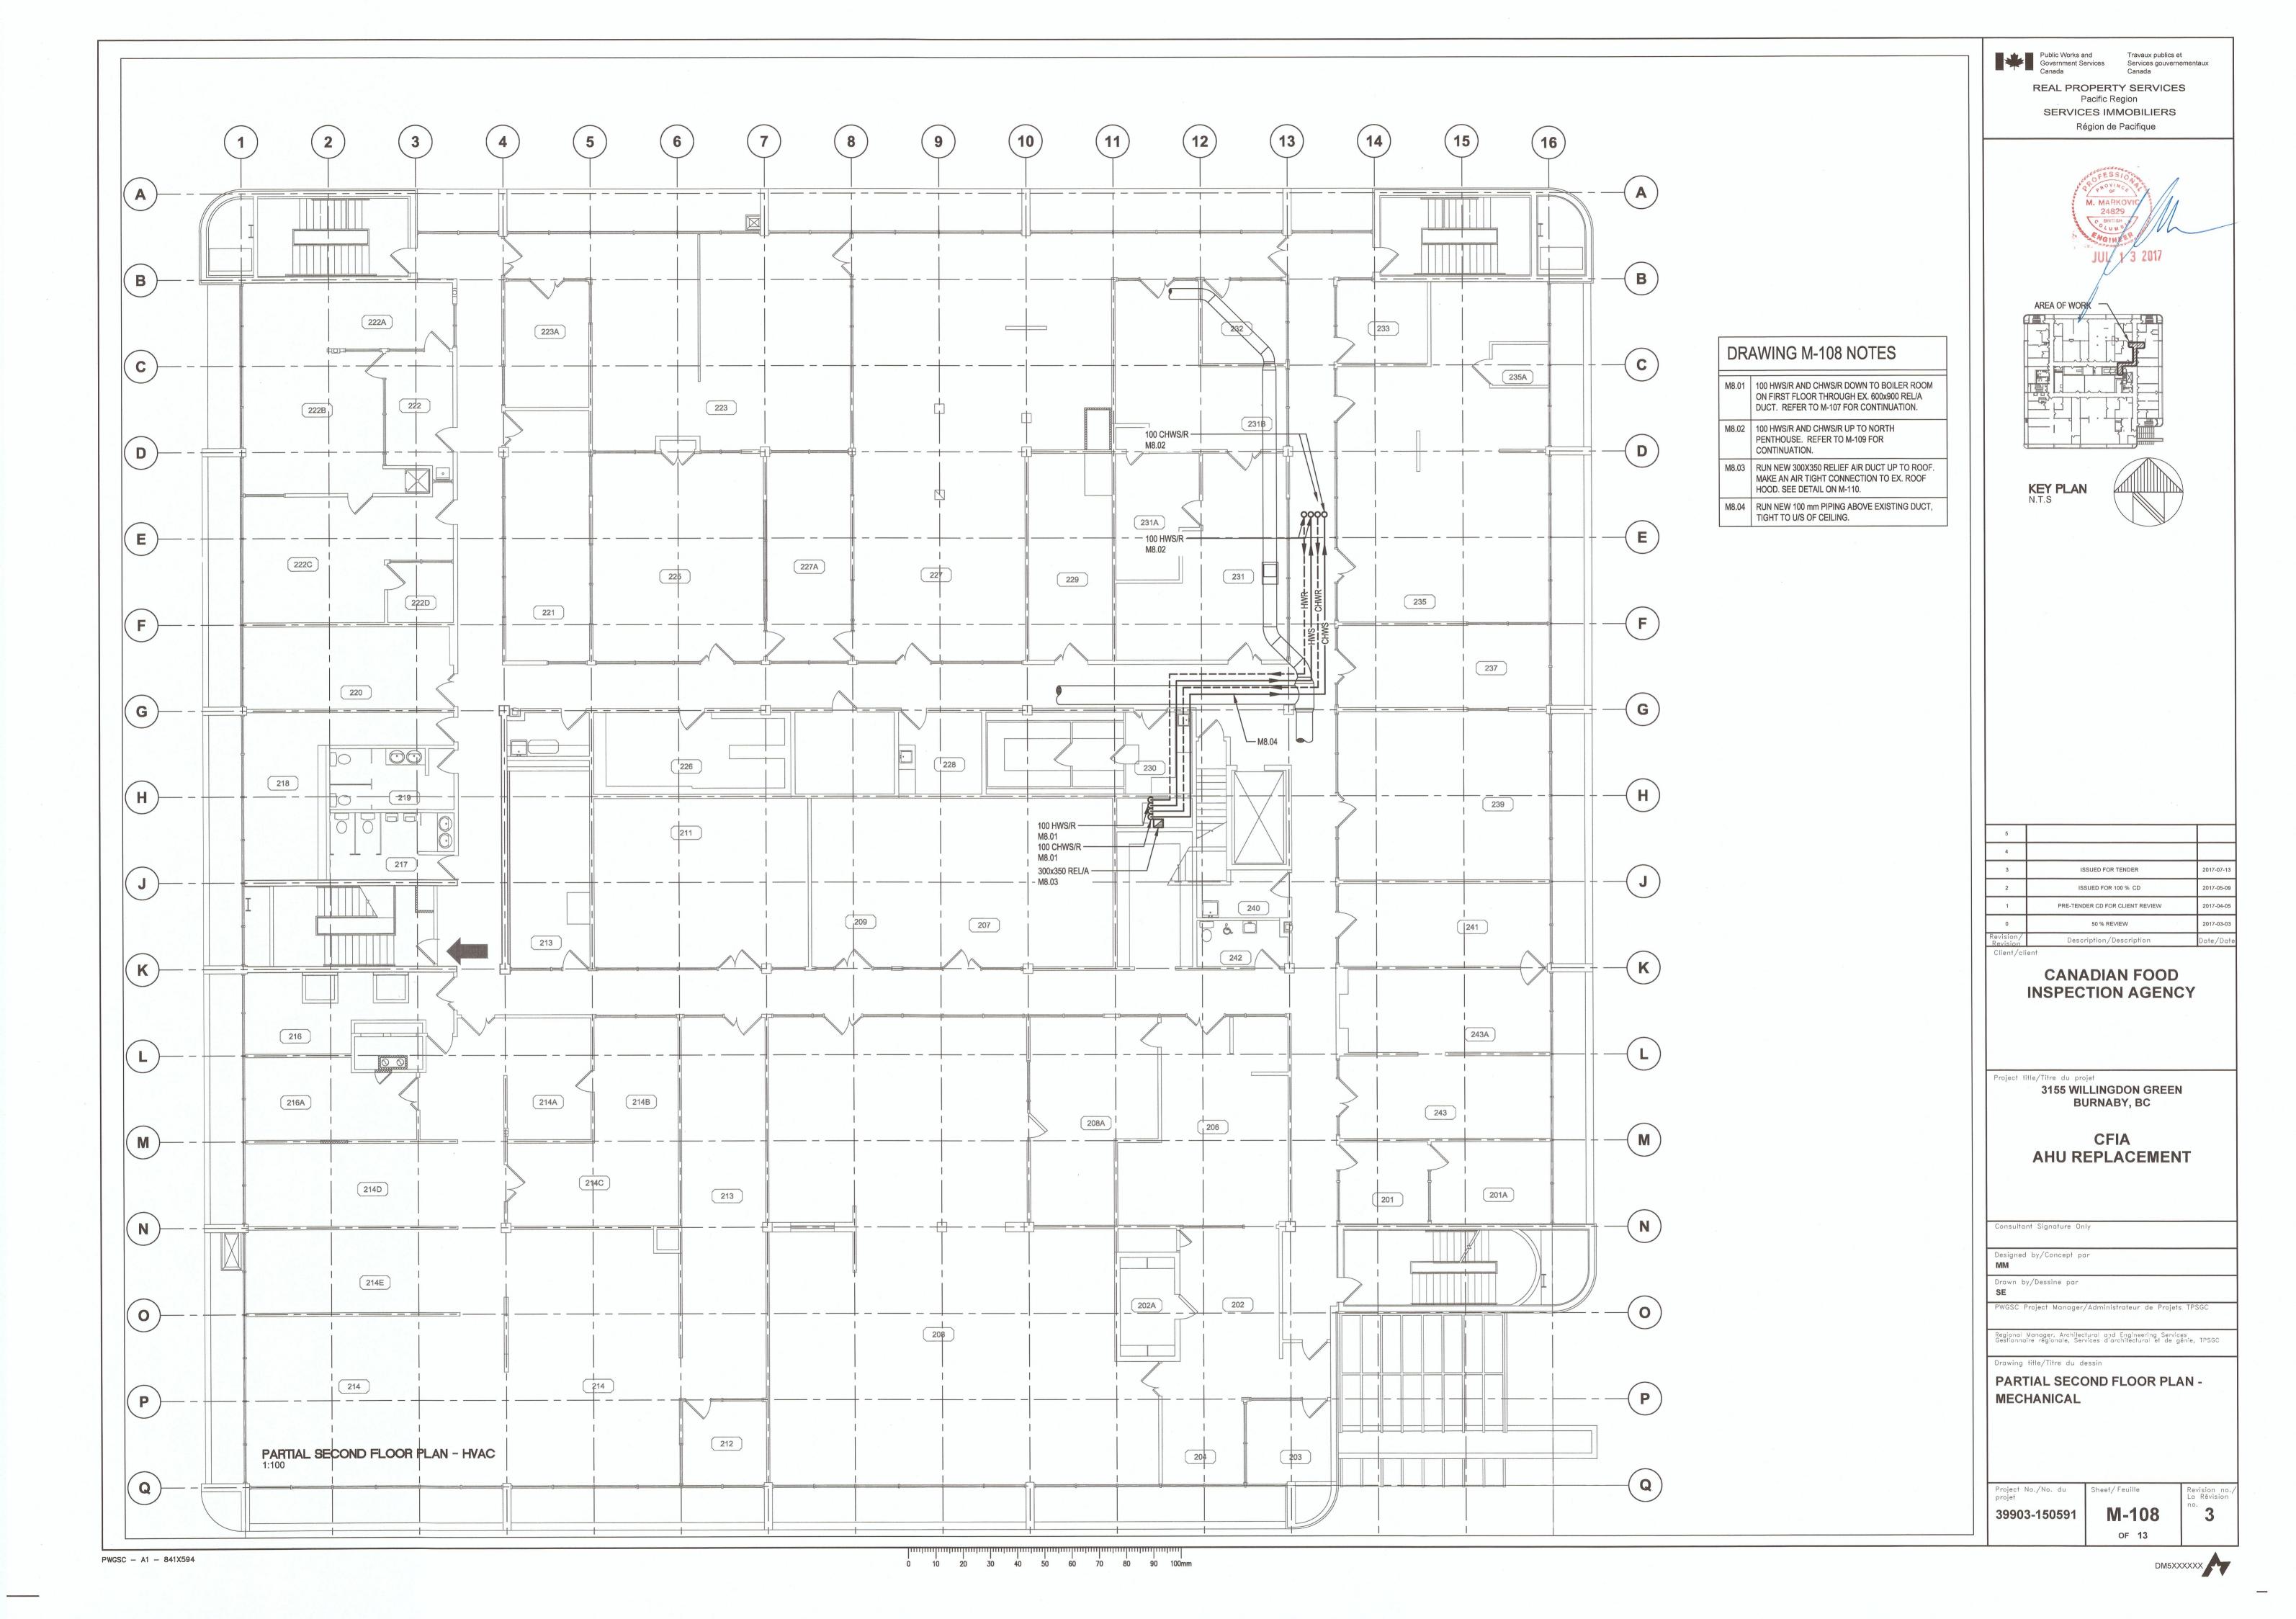
# ZONE COIL PIPING ABOVE MAINS N.T.S.

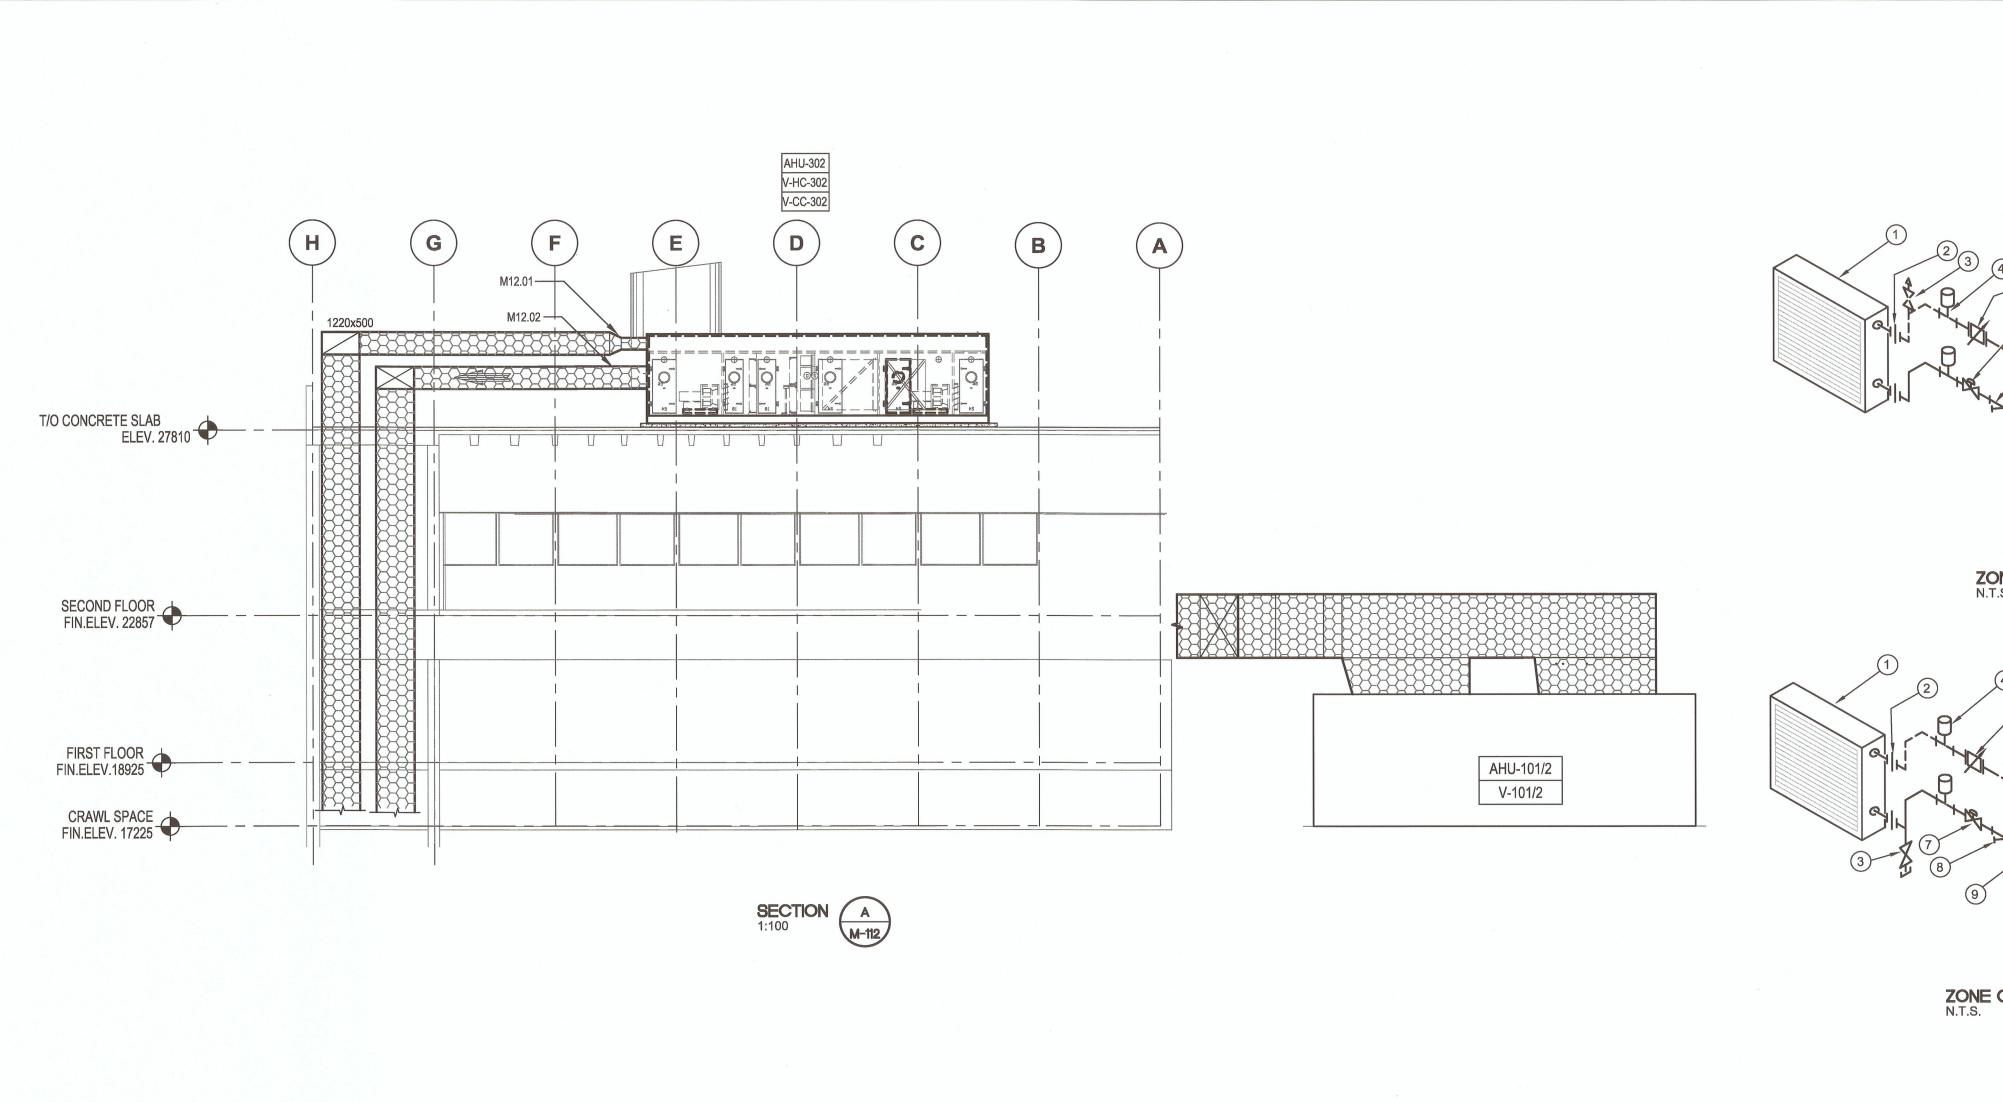

1. COIL

2. UNION

7. CONTROL VALVE AS SCHEDULED

9. ISOLATION VALVE

8. STRAINER

3. DRAIN COCK C/W CAP, CHAIN **FASTENED TO PIPING** 

4. PETE'S PLUG


6. FLOW MEASUREMENT VALVE

7. CONTROL VALVE AS SCHEDULED

8. STRAINER

9. ISOLATION VALVE

ZONE COIL PIPING BELOW MAINS N.T.S.

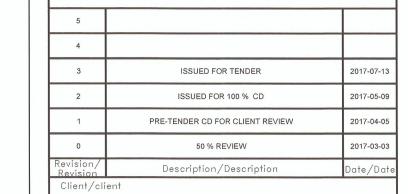

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### **CANADIAN FOOD INSPECTION AGENCY**

Project title/Titre du projet 3155 WILLINGDON GREEN **BURNABY, BC** 

#### **CFIA** AHU REPLACEMENT

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Drawn by/Dessine par

PWGSC Project Manager/Administrateur de Projets TPSGC

Regional Manager, Architectural and Engineering Services Gestionnaire régionale, Services d'architectural et de génie, TPSGC

Drawing title/Titre du dessin

SECTIONS, ELEVATIONS, AND DETAILS

39903-150591

M-112 OF 13

MIXING VALVE PIPED FOR DIVERTING ACTION N.T.S.

STRAINER

7. UNION

6. DRAIN COCK C/W CAP, CHAIN

**FASTENED TO PIPING** 

PETE'S PLUG

4. BALL VALVE


2. AUTOMATIC AIR VENT. IF COIL IS ABOVE MAINS, PIPE TO FLOOR DRAIN

A. REFER TO CONTROL VALVE SCHEDULE FOR CAPACITIES

B. REFER TO CONTROL CONTRACTORS SHOP DRAWINGS FOR CONTROL

3. FLOW MEASUREMENT VALVE

VALVE PIPING ARRANGEMENT.

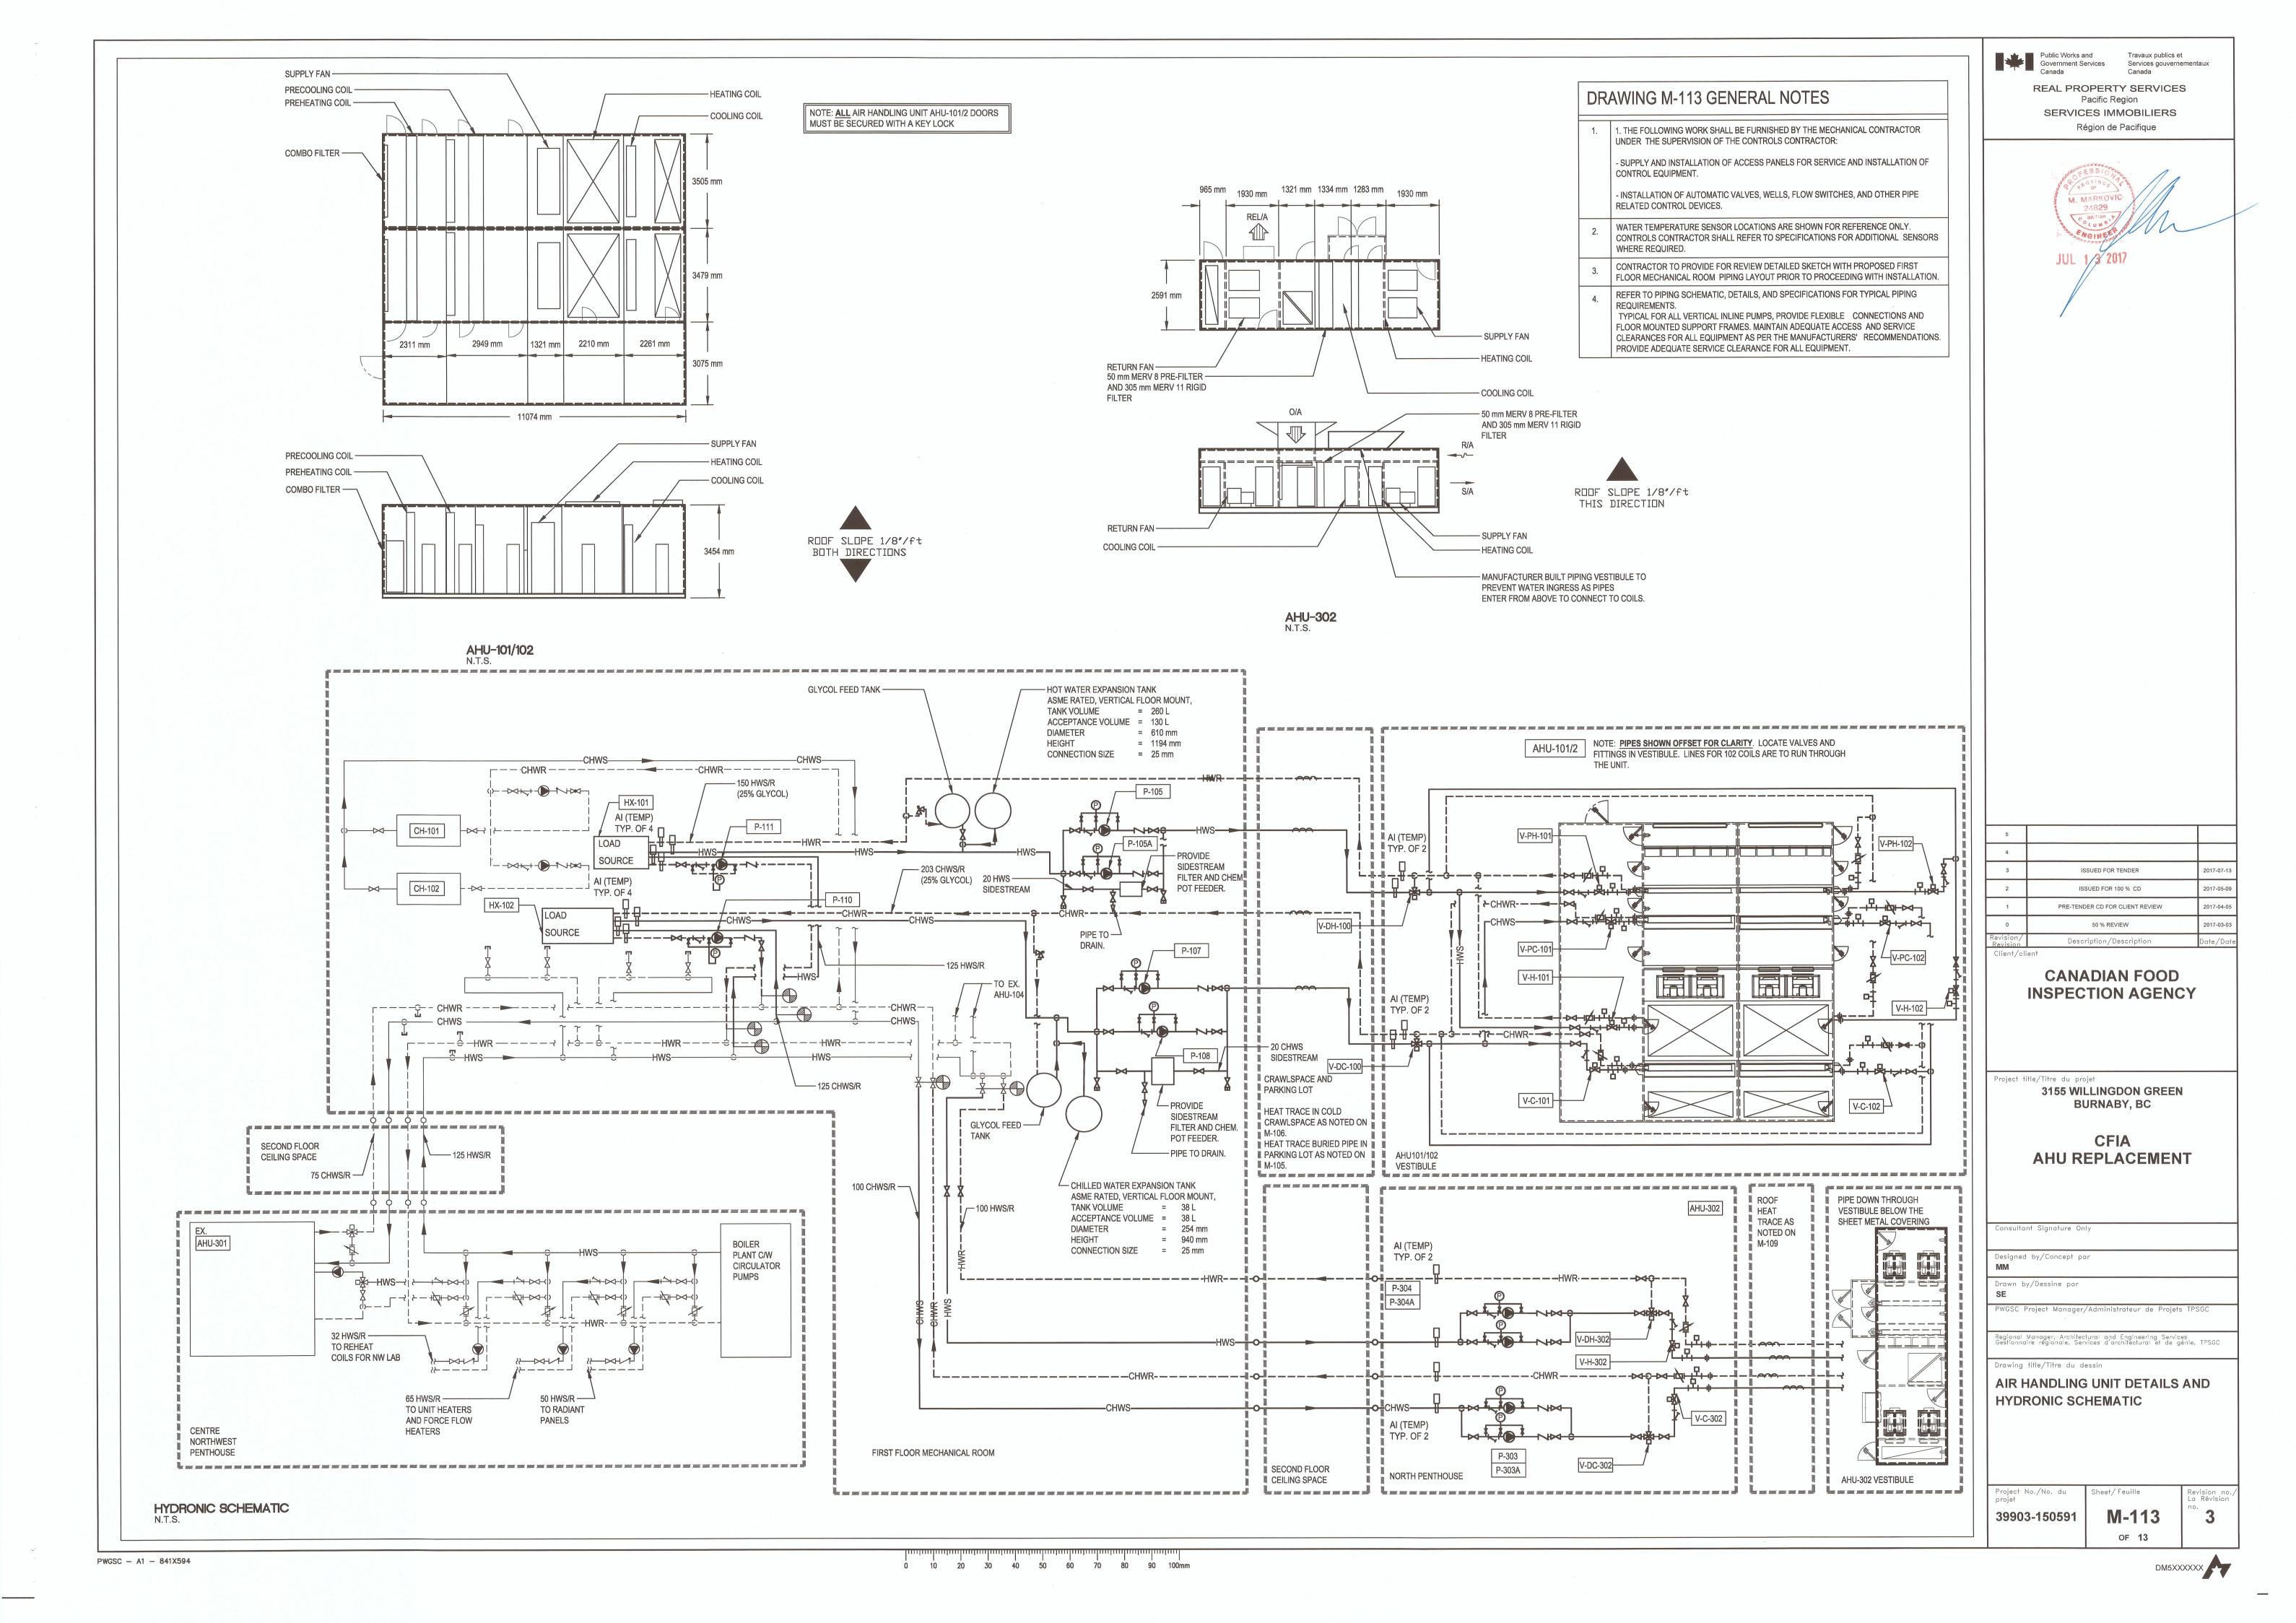

# CANADIAN FOOD INSPECTION AGENCY

EF-341

EF-342

EF-345

EF-347

EF-348

EF-350

EF-351

EF-352

EF-355

EF-356

EF-358

EF-359

EF-361

EF-363

EF-366

EF-367

EF-368

EF-369

EF-370

EF-372

EF-373

EF-374

EF-376

EF-377

EF-378

EF-379

EF-381

EF-383

EXHAUST MANIFOLD SYSTEM

#### CELA DUDALA DV EVILALICE FANIC

TAG	REMOVE OR REMAIN	LOCATION	INLET DUCT SIZE (mm)
EF-1	REMOVE	North Penthouse	279 Ø
EF-2	REMOVE	North Penthouse	279 Ø
EF-3	REMAIN	Roof - North	508 Ø
EF-4	REMOVE	Ceiling Space	N/A
EF-5A	REMOVE	Roof - South West	610 Ø
EF-5B	REMOVE	Roof- South West	610 Ø
EF-6	REMOVE	South Penthouse	229 Ø
EF-7	REMOVE	South Penthouse	229 Ø
EF-8	REMAIN	Centre Penthouse - NorthWest	406 Ø
EF-9	REMOVE	South Penthouse	229 Ø
EF-10	REMOVE	South Penthouse	229 Ø
EF-11	REMAIN	Centre Penthouse -	457x356
FF 204	DEMOVE	NorthWest	457 d
EF-301	REMOVE	North Penthouse	457 Ø
EF-302	REMOVE	North Penthouse	356 Ø
EF-303	REMOVE	North Penthouse	254 Ø
EF-304	REMOVE	North Penthouse	254 Ø
EF-305	REMOVE	North Penthouse	254 Ø
EF-306	REMOVE	North Penthouse	254 Ø
EF-307	REMOVE	North Penthouse	254 Ø
EF-308	REMOVE	North Penthouse	254 Ø
EF-309	REMOVE	North Penthouse	356 Ø
EF-310	REMOVE	North Penthouse	356 Ø
EF-311	REMOVE	North Penthouse	254 Ø
EF-312	REMOVE	North Penthouse	254 Ø
EF-313	REMOVE	North Penthouse	254 Ø
EF-314	REMOVE	North Penthouse	254 Ø
EF-315	REMOVE	North Penthouse	254 Ø
EF-316	REMOVE	North Penthouse	254 Ø
EF-317	REMOVE	North Penthouse	254 Ø
EF-318	REMOVE	North Penthouse	254 Ø
	KEWIOVE	Centre	2519
EF-319	REMOVE	Penthouse - SouthEastEast	254 Ø
EF-320	REMOVE	Centre Penthouse - SouthEast	254 Ø
EF-321	REMOVE	Centre Penthouse - SouthEast	254 Ø
EF-322	REMOVE	Centre Penthouse - SouthEast	254 Ø
EF-323	REMOVE	Centre Penthouse - SouthEast	254 Ø
EF-324	REMOVE	Centre Penthouse - SouthEast	254 Ø
EF-325	REMOVE	Centre Penthouse - SouthEast	254 Ø
EF-326	REMOVE	Centre Penthouse - SouthEast	254 Ø
EF-327	REMOVE	Centre Penthouse - SouthEast	254 Ø
		Southeast	
EF-328	REMOVE	Centre Penthouse - SouthEast	254 Ø
EF-328 EF-329	REMOVE	Centre Penthouse -	254 Ø 254 Ø
		Centre Penthouse - SouthEast Centre Penthouse -	
EF-329 EF-330	REMOVE	Centre Penthouse - SouthEast  Centre Penthouse - SouthEast  Centre Penthouse - SouthEast	254 Ø 254 Ø
EF-329 EF-330 EF-331	REMOVE REMOVE REMOVE	Centre Penthouse - SouthEast  Centre Penthouse - SouthEast  Centre Penthouse - SouthEast  SouthEast	254 Ø 254 Ø 254 Ø
EF-329 EF-330 EF-331 EF-332	REMOVE  REMOVE  REMOVE  REMOVE	Centre Penthouse - SouthEast  Centre Penthouse - SouthEast  Centre Penthouse - SouthEast  South Penthouse  South Penthouse	254 Ø 254 Ø 254 Ø 254 Ø
EF-329 EF-330 EF-331 EF-332 EF-333	REMOVE  REMOVE  REMOVE  REMOVE  REMOVE	Centre Penthouse - SouthEast  Centre Penthouse - SouthEast  Centre Penthouse - SouthEast  South Penthouse  South Penthouse  South Penthouse	254 Ø  254 Ø  254 Ø  254 Ø  254 Ø
EF-329  EF-330  EF-331  EF-332  EF-333  EF-334	REMOVE REMOVE REMOVE REMOVE REMOVE REMOVE	Centre Penthouse - SouthEast  Centre Penthouse - SouthEast  Centre Penthouse - SouthEast  South Penthouse  South Penthouse  South Penthouse  South Penthouse	254 Ø
EF-329  EF-330  EF-331  EF-332  EF-333  EF-334  EF-335	REMOVE  REMOVE  REMOVE  REMOVE  REMOVE  REMOVE  REMOVE	Centre Penthouse - SouthEast  Centre Penthouse - SouthEast  Centre Penthouse - SouthEast  South Penthouse  South Penthouse  South Penthouse  South Penthouse  South Penthouse  South Penthouse	254 Ø 203 Ø
EF-329  EF-330  EF-331  EF-332  EF-333  EF-334  EF-335  EF-336	REMOVE  REMOVE  REMOVE  REMOVE  REMOVE  REMOVE  REMOVE  REMOVE	Centre Penthouse - SouthEast  Centre Penthouse - SouthEast  Centre Penthouse - SouthEast  South Penthouse	254 Ø  203 Ø  254 Ø
EF-329  EF-330  EF-331  EF-332  EF-333  EF-334  EF-335  EF-336  EF-337	REMOVE  REMOVE  REMOVE  REMOVE  REMOVE  REMOVE  REMOVE  REMOVE  REMOVE	Centre Penthouse - SouthEast  Centre Penthouse - SouthEast  Centre Penthouse - SouthEast  South Penthouse  South Penthouse	254 Ø  203 Ø  254 Ø  254 Ø
EF-329  EF-330  EF-331  EF-332  EF-333  EF-334  EF-335  EF-336	REMOVE  REMOVE  REMOVE  REMOVE  REMOVE  REMOVE  REMOVE  REMOVE	Centre Penthouse - SouthEast  Centre Penthouse - SouthEast  Centre Penthouse - SouthEast  South Penthouse	254 Ø  203 Ø  254 Ø

#### CFIA BURNABY EXHAUST

**OR REMAIN** 

REMAIN

REMAIN

REMAIN

**REMOVE** 

**REMOVE** 

REMOVE

**REMOVE** 

**REMOVE** 

**REMOVE** 

**REMOVE** 

**REMOVE** 

**REMOVE** 

REMOVE

**REMOVE** 

REMOVE

REMOVE

REMOVE

REMAIN

REMAIN

REMAIN

REMAIN

REMAIN

REMOVE

REMOVE

REMAIN

Roof - South East

N/A

REMOVE Roof - South East

REMOVE Roof - South East

_	EXHAUST	INLET DUCT
	LOCATION	SIZE (mm)
	Centre Penthouse - NorthWest	356x356
	Centre Penthouse - NorthWest	610x305
	Centre Penthouse - NorthWest	254x254
	Centre Penthouse - NorthWest	N/A
	Centre Penthouse - SouthEast	203 Ø
	Centre Penthouse - SouthEast	203 Ø
	Centre Penthouse - SouthEast	305 Ø
	Centre Penthouse - NorthWest	305x305
	Centre Penthouse - NorthWest	356x254
	Centre Penthouse - NorthWest	254x254
	Centre Penthouse - NorthWest	152x152
	Centre Penthouse - NorthWest	406x356
	Centre Penthouse - NorthWest	305x203
	Centre Penthouse - NorthWest	356x203
	Centre Penthouse - NorthWest	203x152
	Centre Penthouse - NorthWest	356x203
	South Penthouse	325x254
	South Penthouse	325x254
	Centre Penthouse - SouthEast	Free inlet Free inlet
	South Penthouse	Free inlet
	Roof - North West	406x406
_	Roof - North East	406x406
_	Roof - West	287x287
	Roof - Centre	254 Ø
_	Roof - North	254 Ø
	Roof - Centre	254 Ø
_	Roof - Centre  North Penthouse	75 Ø 356x305
	Roof - East	152x152
-	Roof- West	287x287
	Roof - East	203 Ø
	Roof - East	203 Ø
	Roof - East	152 Ø
_	Roof - East	152 Ø
_	Roof - South East	203x203
_	Roof - South East	203x203
	Roof - South East	152x152
	Roof - South East	152 Ø
	Roof - South East	575x575
	Roof - South East	406x406
_	Roof - West	305x203
_	North Penthouse	152 Ø
_	North Penthouse	100 Ø
_	North Penthouse	254 Ø

HVAC LEGEND				
SYMBOL	DESCRIPTION			
* *	EX. DUCTWORK			
2 7	DUCTWORK			
	EX. FLEXIBLE DUCTWORK			
	FLEXIBLE DUCTWORK			
	SUPPLY DUCT RISER/SECTION			
	RETURN/EXHAUST DUCT RISER/SECTION			
	OUTDOOR AIR DUCT RISER/SECTION			
X R X	DUCT RISE			
X D X	DUCT DROP			
	ROUND DUCT RISER			
$\circ$	ROUND DUCT DROP			
_	SUPPLY AIRFLOW DIRECTION			
<b>→</b>	RETURN/EXHAUST AIRFLOW DIRECTION			
	AIRFLOW DIRECTION			
<del></del>	VOLUME DAMPER			
	FIRE DAMPER IN VERTICAL SEPERATION			
<i>x</i>	FIRE DAMPER IN HORIZONTAL SEPERATION			
X	DOOR GRILLE (SIZE AS SCHEDULED)			
XXXX	EQUIPMENT TAG			
	POINT OF DISCONNECTION			
	POINT OF CONNECTION			
NO.@ TYPE L/S SIZE	AIR DISTRIBUTION TAG			
	CONDENSATE DRAIN LINE			
1111,	DEMOLITION			

50 mm THERMAL INSULATION

ABBREVIATION		
ABBREV.	DESCRIPTION	
AHU	AIR HANDLING UNIT	
B/W	BETWEEN	
C/W	COMPLETE WITH	
СТ	COOLING TOWER	
EA, E/A	EXHAUST AIR	
EF	EXHAUST FAN	
EX.	EXISTING	
FD	FLOOR DRAIN	
FEF	FUME EXHAUST FILTER	
FES	FUME EXHAUST SCRUBBER	
HRC	HEAT RECOVERY COIL	
NA, N/A	NOT AVAILABLE/NOT APPLICABLE	
NTS	NOT TO SCALE	
PDEF	PLUME DILUTION EXHAUST FAN	
RA, R/A	RETURN AIR	
REL	RELIEF	
SA, S/A	SUPPLY AIR	
SF	SUPPLY FAN	
STOR.	STORAGE	
SOLV.	SOLVENT	
UH	UNIT HEATER	

#### PHASING REQUIREMENTS

ALL EXTERIOR EQUIPMENT AND DUCTWORK IS TO BE INSTALLED PRIOR TO COMMENCEMENT OF ANY WORK IN THE PENTHOUSES.

ALL PENTHOUSE PENETRATIONS ARE TO BE CORED AND MADE WATERTIGHT PRIOR TO COMMENCEMENT OF ANY WORK IN THE PENTHOUSES. CONNECTIONS ARE TO BE CAPPED UNTIL SUCH TIME AS REQUIRED FOR CONNECTION.

AFTER EACH CONSTANT VOLUME AIR VALVE IS INSTALLED THE BALANCING DAMPER ON THE RESPECTIVE MAIN LINE IS TO BE BALANCED AS REQUIRED TO MAINTAIN MINIMUM EXHAUST VELOCITY IN MAIN EXHAUST DUCT. IN ADDITION, THE ASSOCIATED FUMEHOOD IS TO BE COMMISSIONED AS REQUIRED.

NO DEMOLITION OF EXHAUST FANS IS TO TAKE PLACE UNTIL THE STROBIC UNIT HAS BEEN PRE-TESTED AND PRE-COMMISSIONED.

DUCTING, CONTROLS, REQUIRED DEMOLITION, ETC FOR EF-5A/EF-5B STREAM SHOULD BE INSTALLED PRIOR TO COMMENCEMENT OF ANY WORK IN THE PENTHOUSES.

FOR DETAILS ON THE PHASING REQUIREMENTS RELATING TO REMOVAL OF INDIVIDUAL EXHAUST FANS, REFER TO ARCHITECTURAL DRAWINGS, A202 & A203. IT IS MANDATORY TO STRICTLY FOLLOW THE ARCHITECTURAL PHASING PLAN AS IT RELATES TO THE SCOPE OF WORK DESCRIBED HEREIN AND IN THE SPECIFICATION. I.E. SELECT HOODS MAY NOT BE NON-OPERATIONAL AT THE SAME TIME/SELECT HOODS MAY ONLY BE DOWN FOR A SET PERIOD OF TIME. INFORMATION ON HOOD/CANOPY SERVICE FOR EXHAUST FANS CAN BE FOUND ON SHEETS M-202, M-204, M-206, M-208, AND M-210 FOR USE IN CONJUNCTION WITH THE INFORMATION PROVIDED ON THE ARCHITECTURAL DRAWINGS NOTED ABOVE.

#### **GENERAL NOTES**

- (WHEN FEASIBLE) TO MINIMIZE DURATION OF SHUT-DOWNS. SHUT-DOWNS OF ANY AREAS WILL NEED TO BE COORDINATED AND APPROVED AHEAD OF TIME, IN COORDINATION WITH THE DEPARTMENTAL REPRESENTATIVE. REFER TO
- 2. ALL NEW WORK SHALL BE TESTED, BALANCED (AS NECESSARY), AND
- ONSITE CONDITIONS AND EQUIPMENT LOCATIONS PRIOR TO ANY AND ALL DEMOLITION WORK AND/OR EQUIPMENT REMOVAL.
- 4. FOR CLARITY, THE MECHANICAL PLANS DO NOT ATTEMPT TO SHOW ALL
- THE DRAWINGS & SPECIFICATIONS ARE TO BE REVIEWED, EVALUATED, AND IMPLEMENTED CONCURRENTLY. IN CASES WHERE CONFLICTS OCCUR, THE MOST STRINGENT REQUIREMENTS SHALL APPLY.
- THE CONTRACTOR SHALL PROVIDE NEC (NATIONAL ELECTRICAL CODE) CLEARANCE HORIZONTAL AND VERTICAL REQUIREMENTS FOR ALL INSTALLED EQUIPMENT. OFFSET MECHANICAL SYSTEMS AS REQUIRED TO MEET THE SITE CONDITIONS AS SHOWN ON THE DRAWINGS & DESCRIBED IN THE
- CONTRACTOR SHALL INCLUDE, AS A PART OF THE BID, ALL COSTS ASSOCIATED WITH CUTTING AND PATCHING RELATED TO THE INSTALLATION OF ALL NEW MECHANICAL SYSTEMS. PATCHING SHALL MATCH, OR EXCEED, THE AESTHETIC
- DURING REMOVAL OF ITEMS SO INDICATED, CAUTION SHOULD BE USED TO PREVENT DAMAGE TO ANY EQUIPMENT HAVING SALVAGE VALUE. ALL REUSABLE SALVAGED MATERIAL SHALL REMAIN THE PROPERTY OF THE OWNER AND BE RETAINED FOR THEIR INSPECTION. ONLY ITEMS AGREED BY THE DEPARTMENTAL
- WITH A STRUCTURAL ENGINEERING STAMP AS REQUIRED BY THE NATIONAL BUILDING CODE (2015).
- 11. THE CONTRACTOR SHALL X-RAY FLOOR SLABS PRIOR TO CORING, THE

- NOTES, AND DRAWING LIST
- NORTH PENTHOUSE AND PARTIAL ROOF PLAN DEMOLITION
- NORTH PENTHOUSE AND PARTIAL ROOF PLAN NEW CONSTRUCTION
- CONSTRUCTION

- M-210 SOUTH PENTHOUSE AND PARTIAL ROOF PLAN DEMOLITION
- M-211 SOUTH PENTHOUSE AND PARTIAL ROOF PLAN NEW CONSTRUCTION
- M-212 TYPICAL INSTALLATION DETAILS

- ALL NEW WORK SHALL BE INSTALLED IN PARALLEL WITH EXISTING SYSTEMS ARCHITECTURAL DRAWINGS FOR MAXIMUM ALLOWABLE SHUTDOWN PERIODS.
- 3. THE CONTRACTOR IS RESPONSIBLE FOR REVIEWING AND VERIFYING ACTUAL
- REQUIRED OFFSETS. THE CONTRACTOR IS TO ALLOW FOR OFFSETS AS PART OF CONTRACT PRICING. EXISTING CONDITIONS AND PIPE ROUTING TO BE REVIEWED WITH TENDER.
- THE CONTRACTOR SHALL COORDINATE ALL MECHANICAL WORK WITH THAT OF OTHER TRADES TO ENSURE PROPER AND ADEQUATE INTERFACE WITH THE WORK OUTLINED FOR THIS PROJECT.
- SPECIFICATIONS.
- CONDITIONS WHICH EXISTED PRIOR TO ANY CUTTING BEING PERFORMED.
- REPRESENTATIVE SHALL BE DISPOSED OF BY THE CONTRACTOR.
- 10. THE INSTALLING CONTRACTOR SHALL PROVIDE SEISMIC PIPE/DUCT SUPPORTS
- CONTRACTOR IS TO AVOID ANY IN SLAB IMBEDDED OBJECTS.
- 12. PROVIDE VALVE IDENTIFICATION TAGS AND SECURE THOSE USING NON-FERROUS CHAIN BRAIDED BAND OR PLASTIC BAND (SUITABLE FOR TEMPERATURE). TAGS MAY BE OF BRASS, ALUMINUM, METAL PHOTO, LAMICOID OR FIBERGLASS, STAMPED OR ENGRAVED. OF 25mm MINIMUM DIAMETER. VALVES TO BE TAGGED ON ALL MAIN AND BRANCH LINES.
- THICK INSULATION AND PROVIDED WITH ALUMINUM JACKETING PER SPECIFICATION. JACKETING TO BE SEALED WITH POLYURETHANE CAULKING.
- 14. REFER TO ARCHITECTURAL DRAWING A214 FOR DETAILS RELATING TO DEMOLITION OF EXHAUST STACKS.
- 15. REFER TO ARCHITECTURAL DRAWING A214 FOR DETAILS ON NEW ROOFTOP DUCTWORK CONNECTIONS
- 16. REFER TO ARCHITECTURAL DRAWINGS A214 AND A215 AND STRUCTURAL DRAWING S202 FOR DETAILS ON DUCT AND PLENUM SUPPORTS AND DUCT PENETRATIONS THROUGH WALLS.
- 17. ALL EXISTING EQUIPMENT IN PENTHOUSES IS TO REMAIN UNLESS OTHERWISE NOTED.
- 18. DUCT LINER, IN ANY FORM, IS UNACCEPTABLE FOR THIS PROJECT. NO DUCT LINER IS

#### DRAWING LIST

- M-201 EXISTING EXHAUST FAN INFORMATION, MECHANICAL LEGEND, GENERAL
- M-202 ROOF PLAN DEMOLITION
- M-203 ROOF PLAN NEW CONSTRUCTION
- M-206 CENTRE PENTHOUSE SOUTHEAST AND PARTIAL ROOF PLAN DEMOLITION
- CENTRE PENTHOUSE SOUTHEAST AND PARTIAL ROOF PLAN NEW

CENTRE PENTHOUSE NORTHWEST AND PARTIAL ROOF PLAN - DEMOLITION

- CENTRE PENTHOUSE NORTHWEST AND PARTIAL ROOF PLAN NEW

39903-150591

roject No./No. du

Public Works and Government Services

Services gouvernementaux

**REAL PROPERTY SERVICES** Pacific Region SERVICES IMMOBILIERS Région de Pacifique

ISSUED FOR TENDER

ISSUED FOR 100 % CD

PRE-TENDER CD FOR CLIENT REVIEW

Description/Description

CANADIAN FOOD

**INSPECTION AGENCY** 

3155 WILLINGDON GREEN BURNABY, BC

**CFIA** 

**EXHAUST MANIFOLD** 

GSC Project Manager/Administrateur de Projets TPSGC

Regional Manager, Architectural and Engineering Services Gestionnaire régionale, Services d'architectural et de génie, TPSGC

SYSTEM

Project title/Titre du projet

sultant Signature Only

Designed by/Concept par

rawing title/Titre du dessin

AND DRAWING LIST

**EXISTING EXHAUST FAN** 

INFORMATION, MECHANICAL


LEGEND, GENERAL NOTES,


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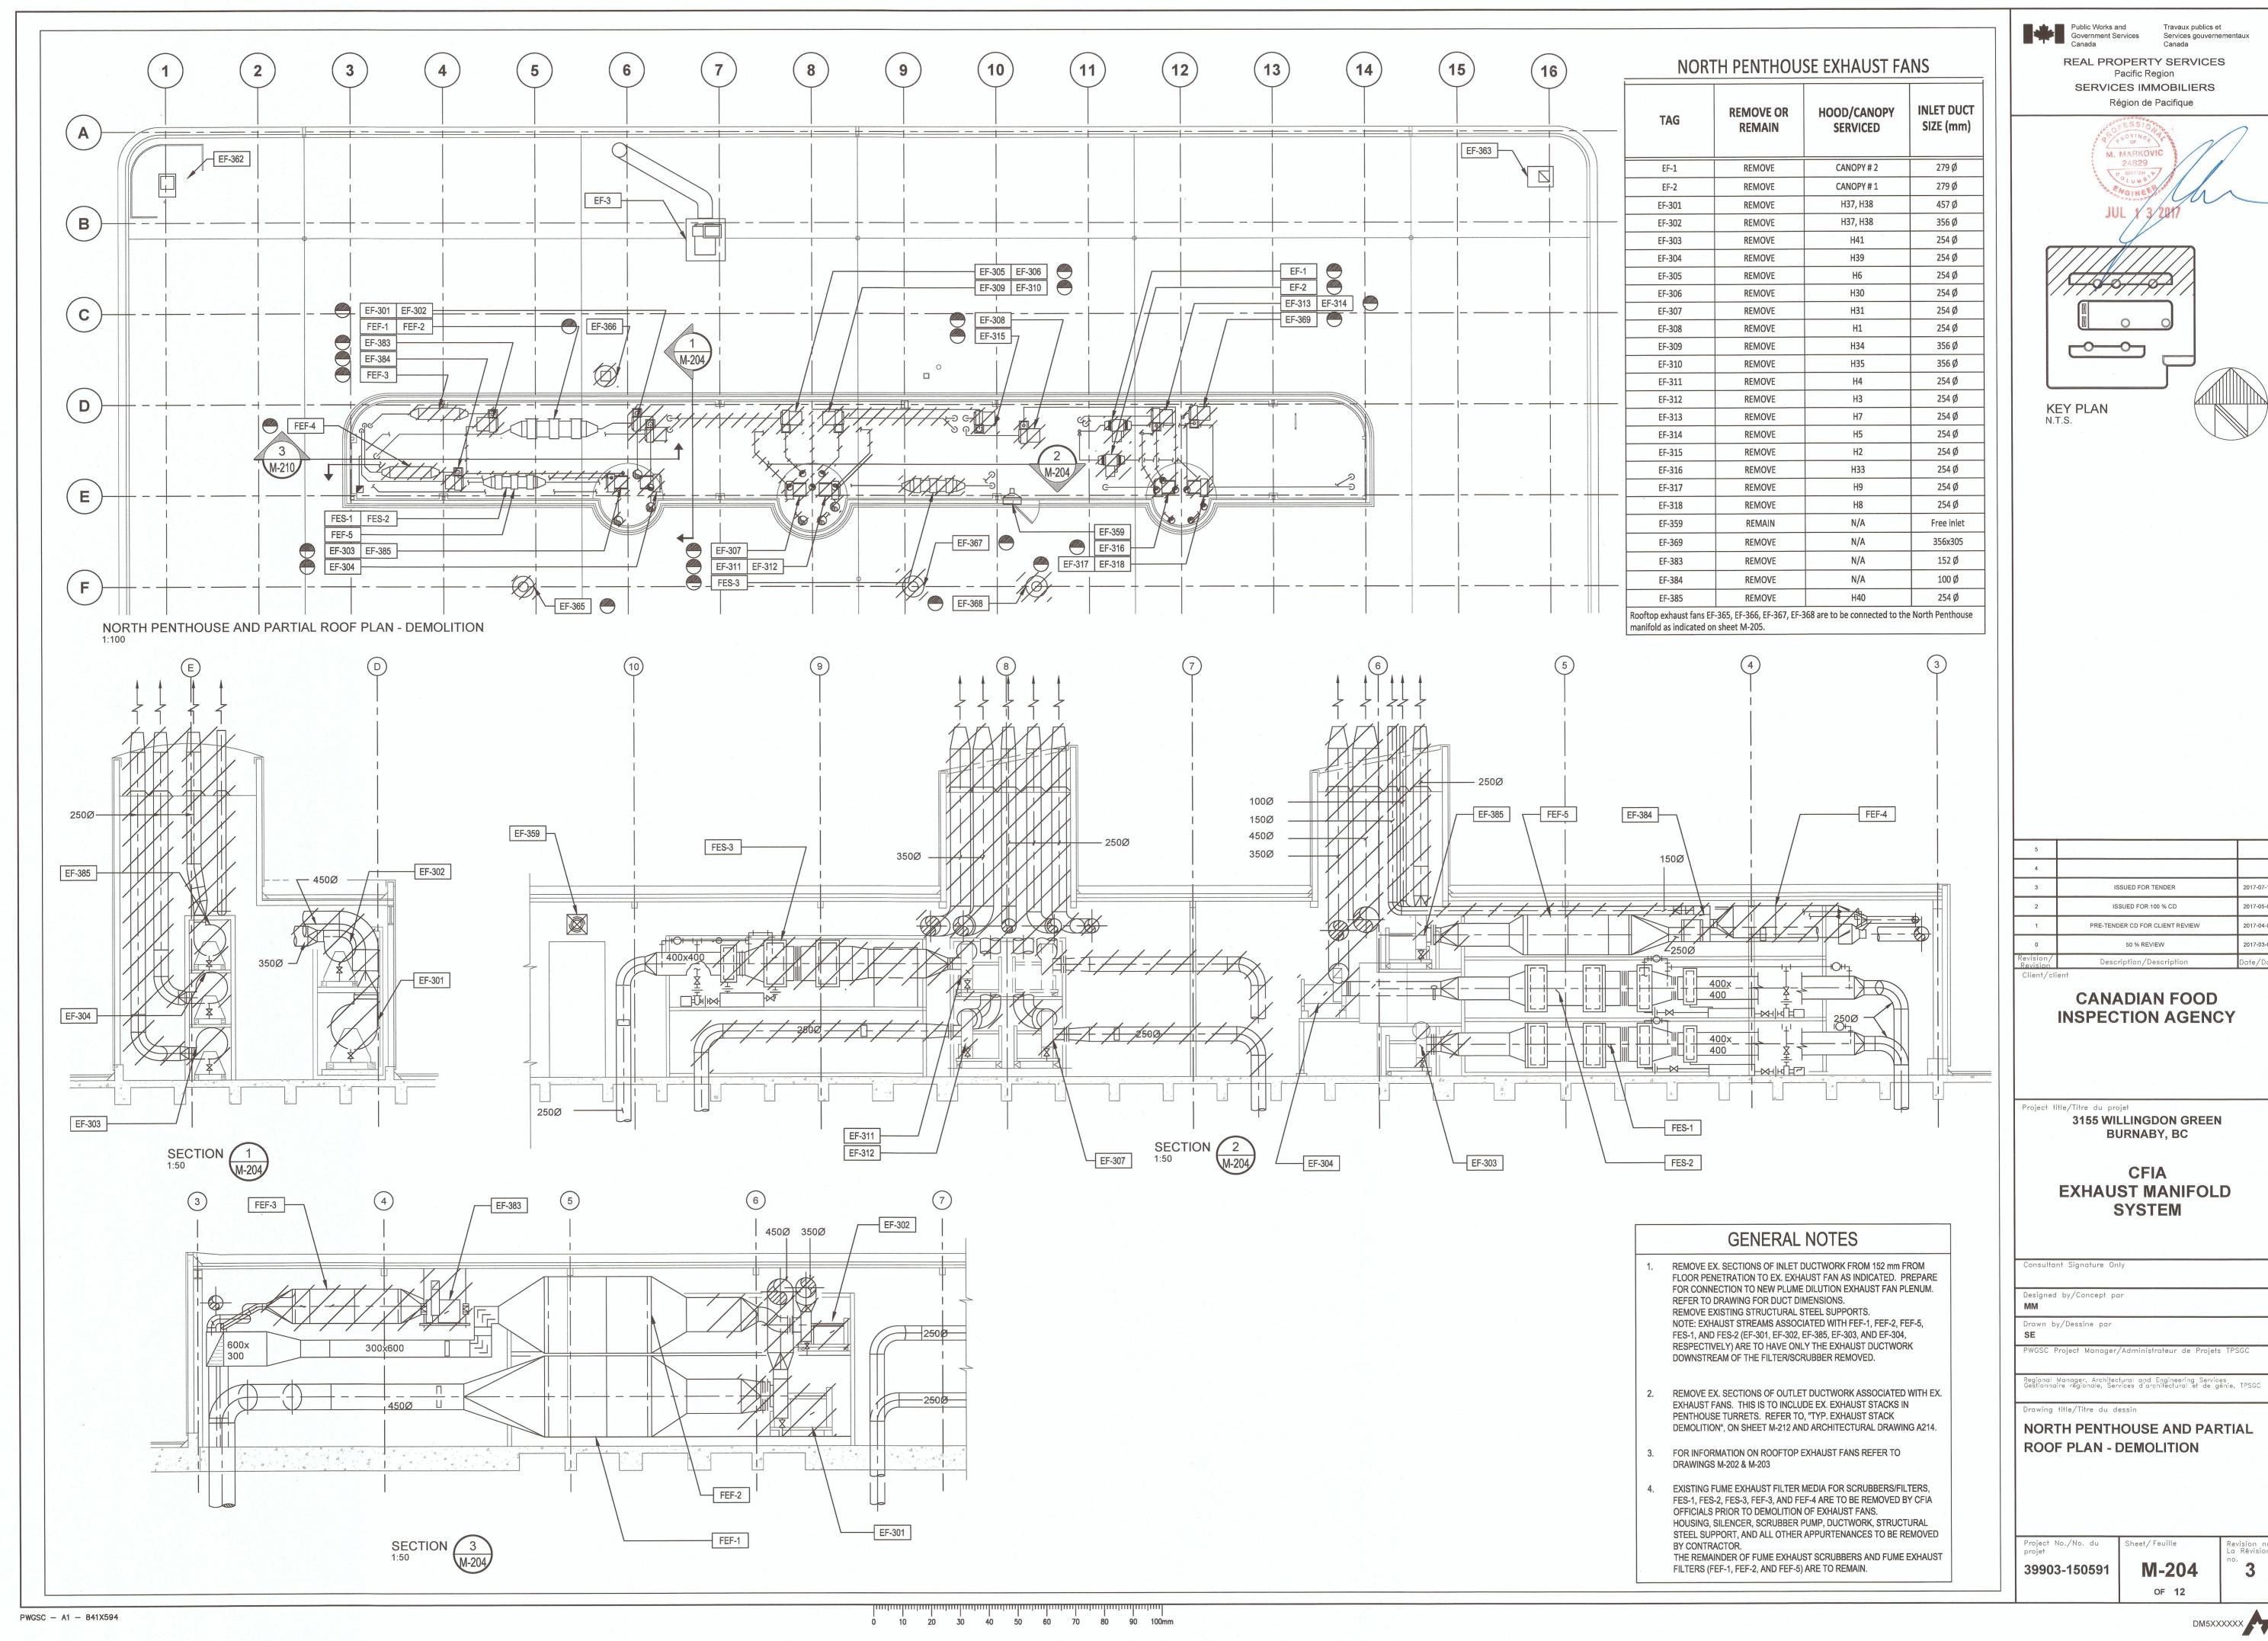
2017-04-05


M-201OF 12

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### NORTH PENTHOUSE EXHAUST FANS/SCRUBBERS/FILTERS TO REMAIN

 KEIVIAIIV		
EQUIPMENT TAG		
EF-359		
FEF-1		
FEF-2	4 - 54 -	
FEF-5	T 10 11 14	
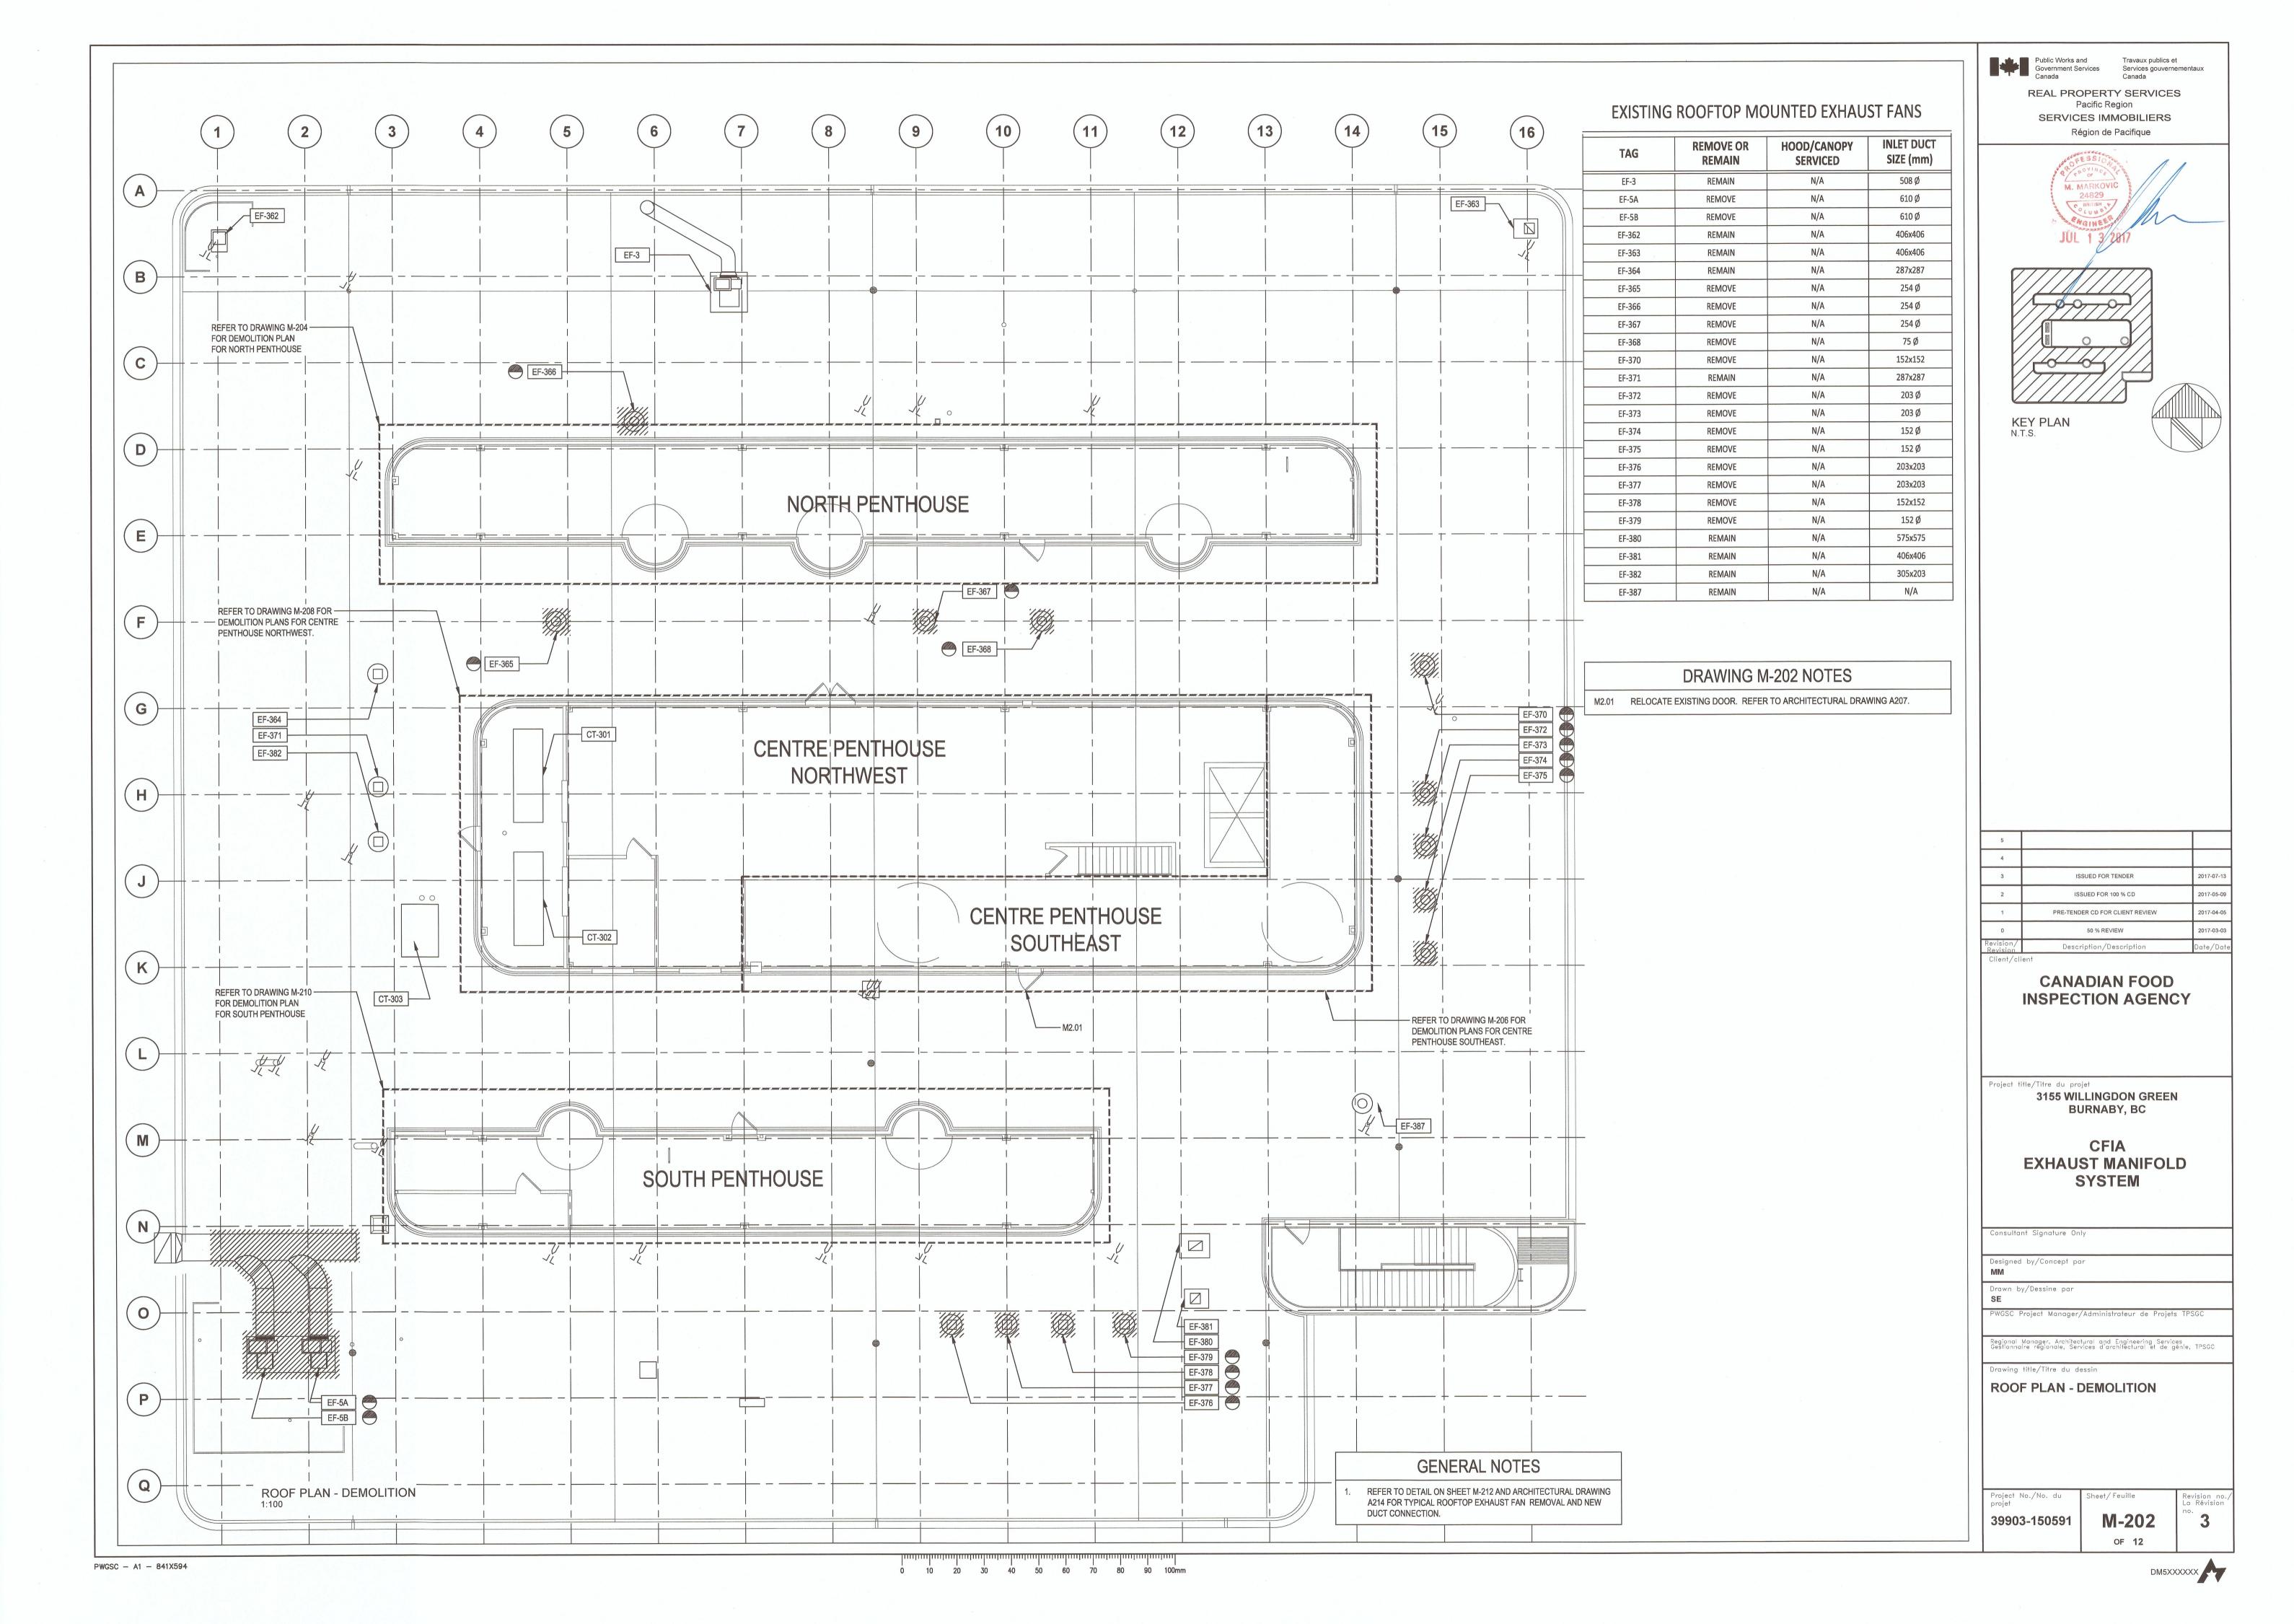
### NEW NORTH PENTHOUSE CONTROL VALVES

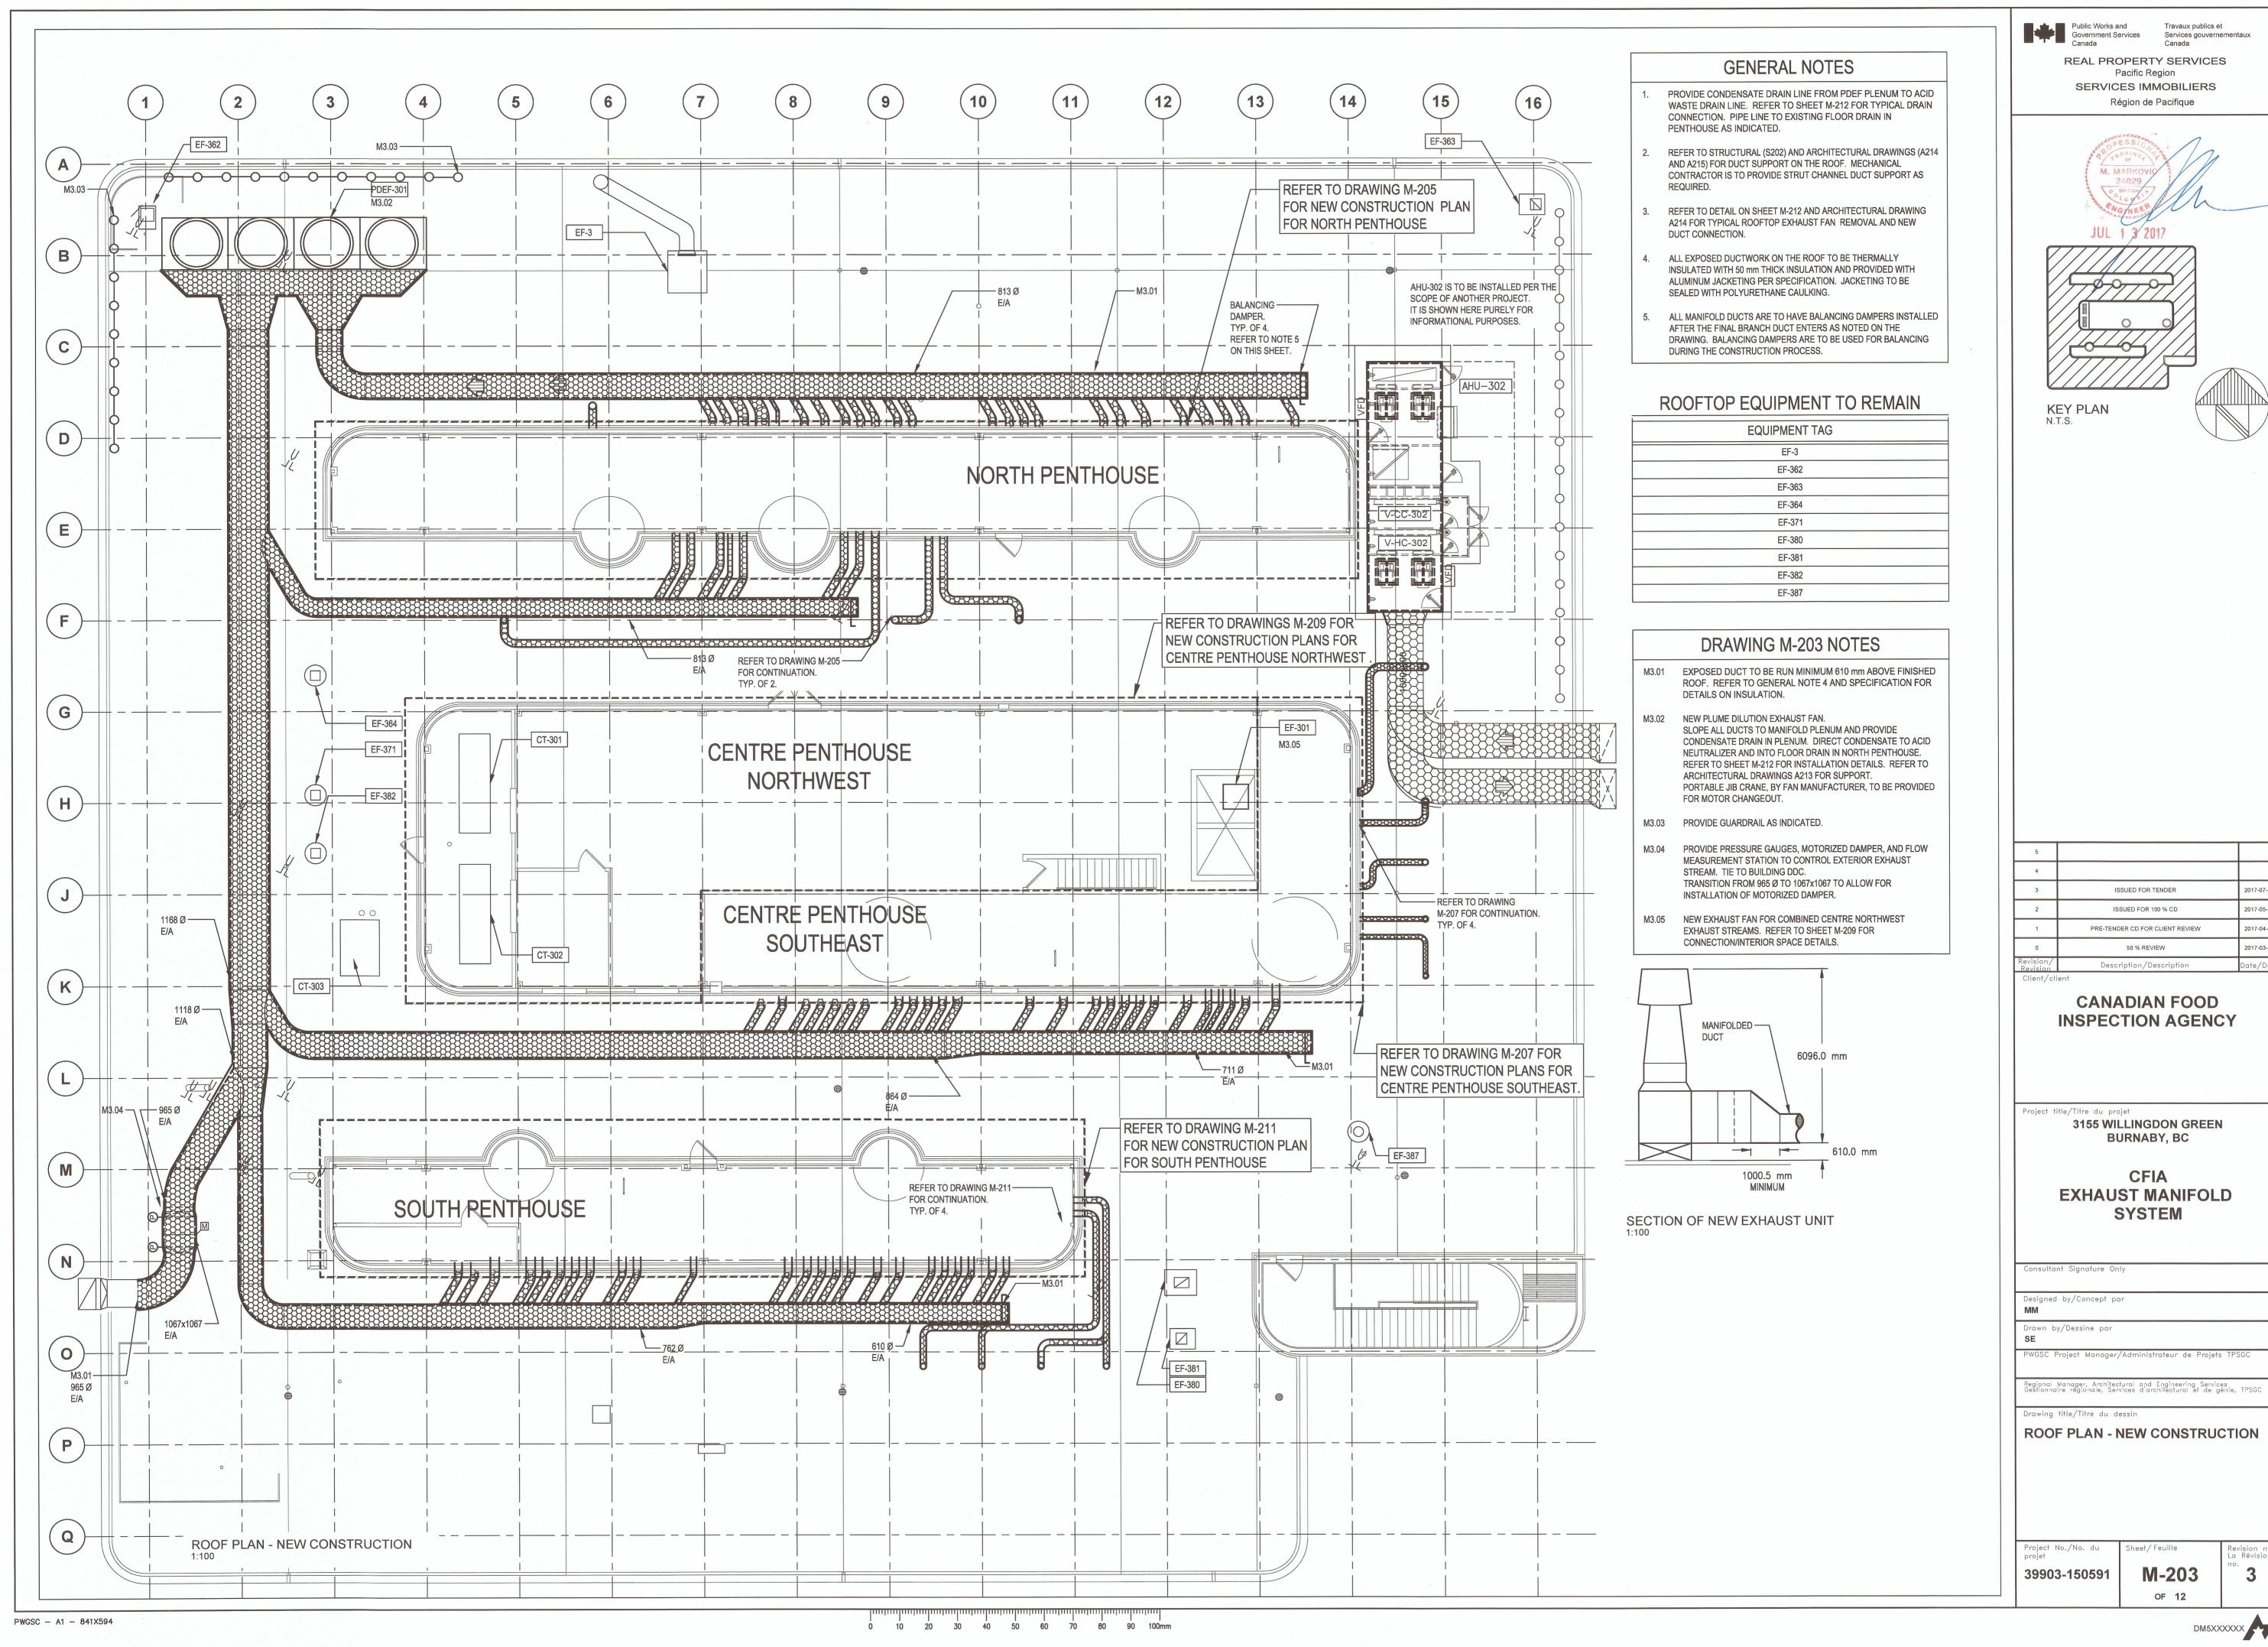NEW VALVE TAG	HOOD/ CANOPY SERVICED	ASSOCIATED DUCTWORK SIZE (mm)	CONTROL VALVE SIZE (mm)	NUMBER OF CONTROL VALVES
V-1	CANOPY # 2	279 Ø	305 Ø	1
V-2	CANOPY#1	279 Ø	305 Ø	1
V-301	H37, H38	457 Ø	356 Ø	2
V-302	H37, H38	356 Ø	356 Ø	1
V-303	H41	254 Ø	305 Ø	1
V-304	H39	254 Ø	305 Ø	1
V-305	H6	254 Ø	305 Ø	1
V-306	H30	254 Ø	305 Ø	1
V-307	H31	254 Ø	305 Ø	1
V-308	H1	254 Ø	305 Ø	1
V-309	H34	356 Ø	356 Ø	2
V-310	H35	356 Ø	356 Ø	2
V-311	H4	254 Ø	305 Ø	1
V-312	Н3	254 Ø	305 Ø	1
V-313	Н7	254 Ø	305 Ø	1
V-314	Н5	254 Ø	305 Ø	1
V-315	H2	254 Ø	305 Ø	1
V-316	H33	254 Ø	305 Ø	1
V-317	Н9	254 Ø	305 Ø	1
V-318	Н8	254 Ø	305 Ø	1
V-365	N/A	254 Ø	254 Ø	1
V-366	N/A	254 Ø	254 Ø	1
V-367	N/A	254 Ø	254 Ø	1
V-368	N/A	75 Ø	203 Ø	1
V-369	N/A	356x305	356 Ø	1
V-383	N/A	152 Ø	254 Ø	1
V-384	N/A	100 Ø	254 Ø	1
	•			

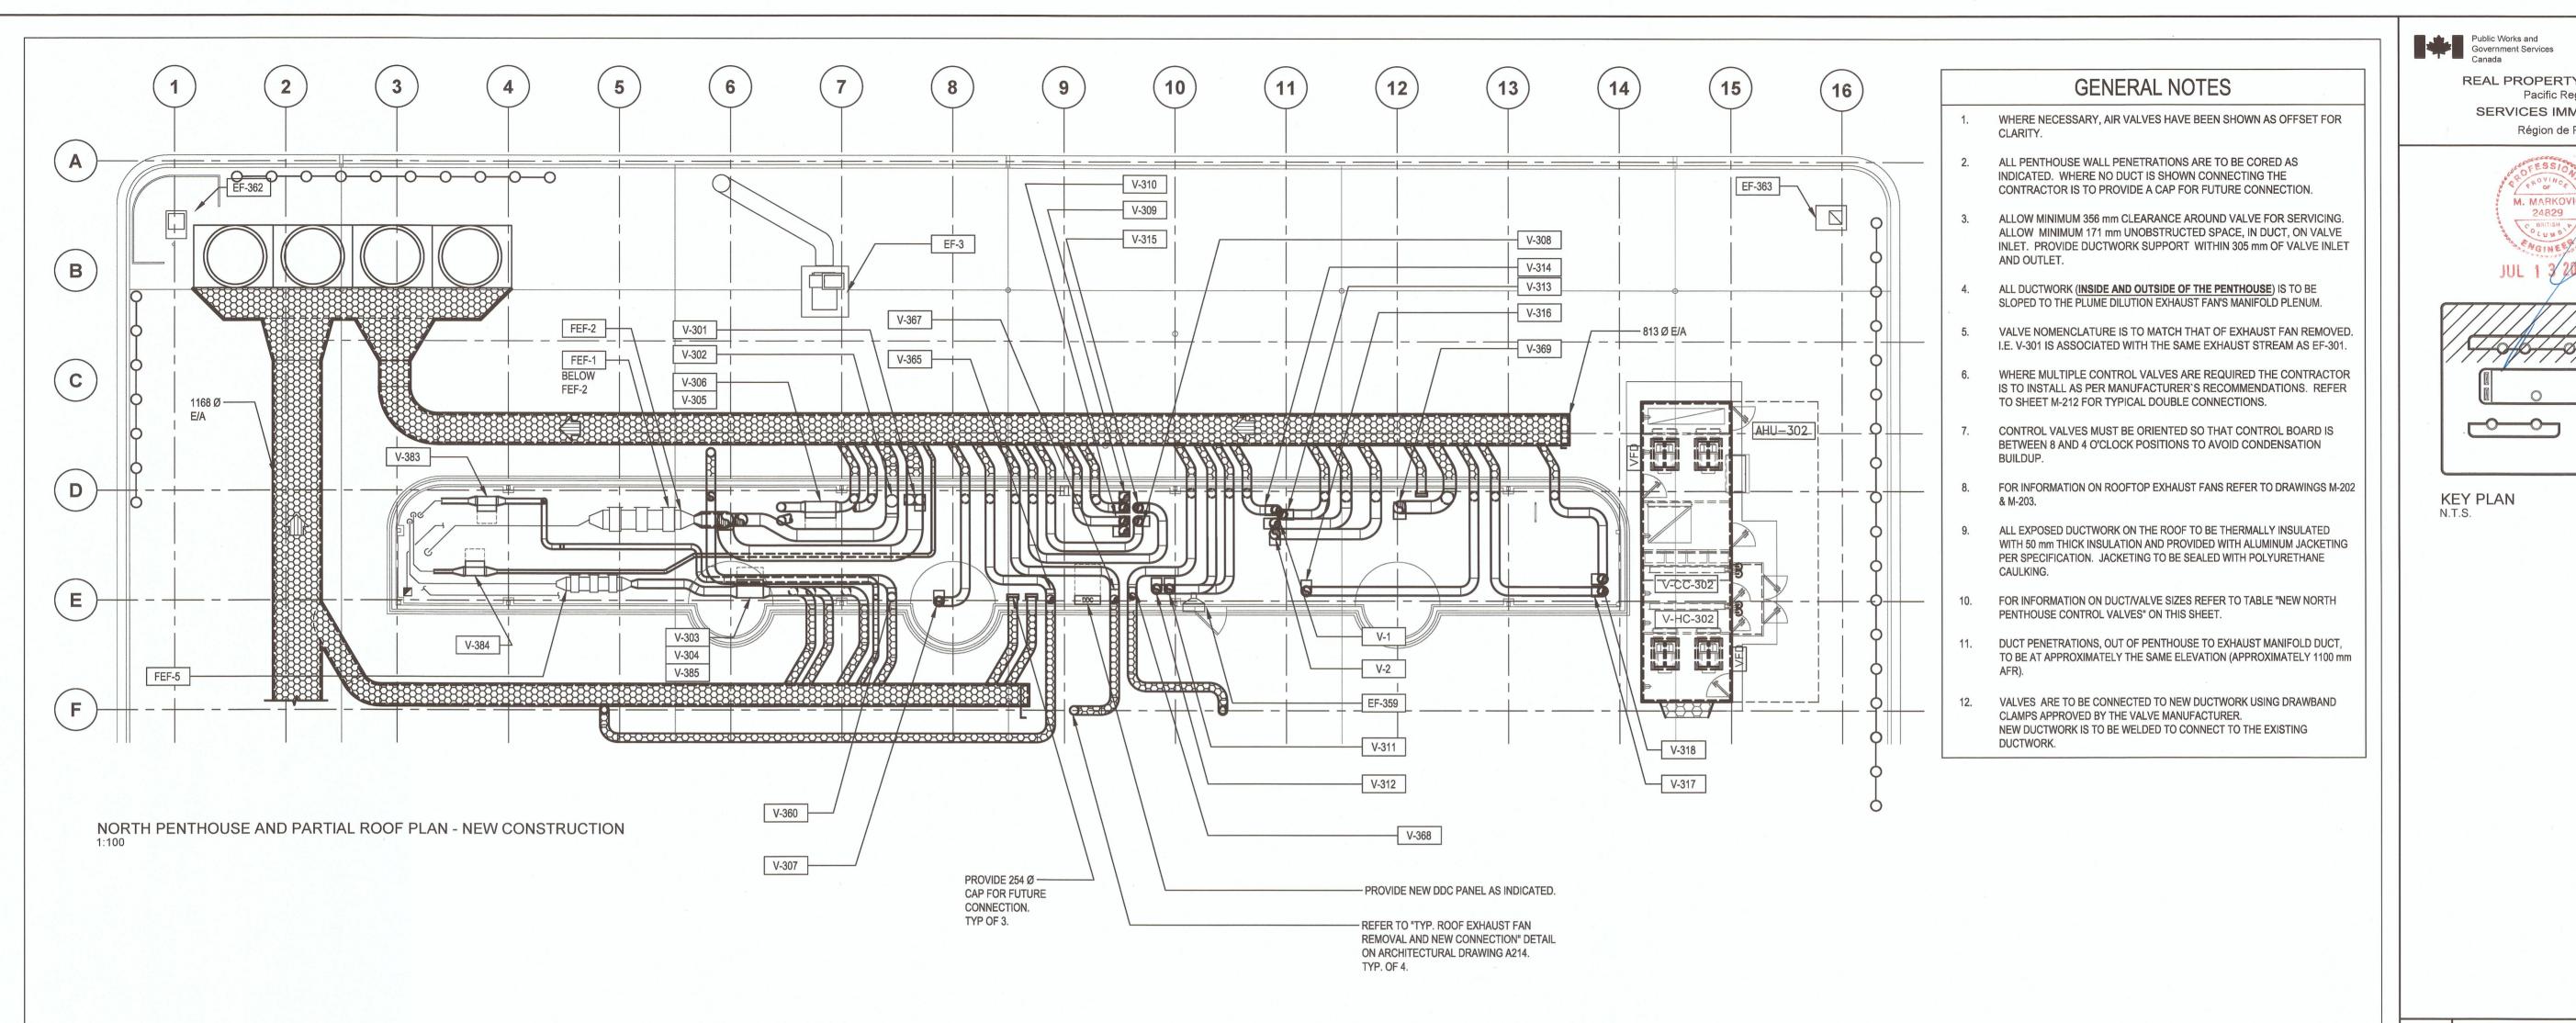Revision/ Revision	Description/Description	Date/Dat
0	50 % REVIEW	2017-03-03
1	PRE-TENDER CD FOR CLIENT REVIEW	2017-04-05
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3	ISSUED FOR TENDER	2017-07-13
4		
5		

Services gouvernementaux

REAL PROPERTY SERVICES

Pacific Region SERVICES IMMOBILIERS

KEY PLAN

N.T.S.

Région de Pacifique

#### CANADIAN FOOD **INSPECTION AGENCY**

Project title/Titre du projet 3155 WILLINGDON GREEN BURNABY, BC

#### CFIA **EXHAUST MANIFOLD** SYSTEM

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Designed by/Concept par	
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PWGSC Project Manager/Administrateur de Projets TPSGC	
Regional Manager, Architectural and Engineering Services	-


Drawing title/Titre du dessin NORTH PENTHOUSE AND PARTIAL ROOF PLAN - NEW CONSTRUCTION

Project No./No. du projet	Sheet/Feuille	Revi La f
39903-150591	M-205	no.
	OF 12	

0 10 20 30 40 50 60 70 80 90 100mm

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FES-5

SECTION (

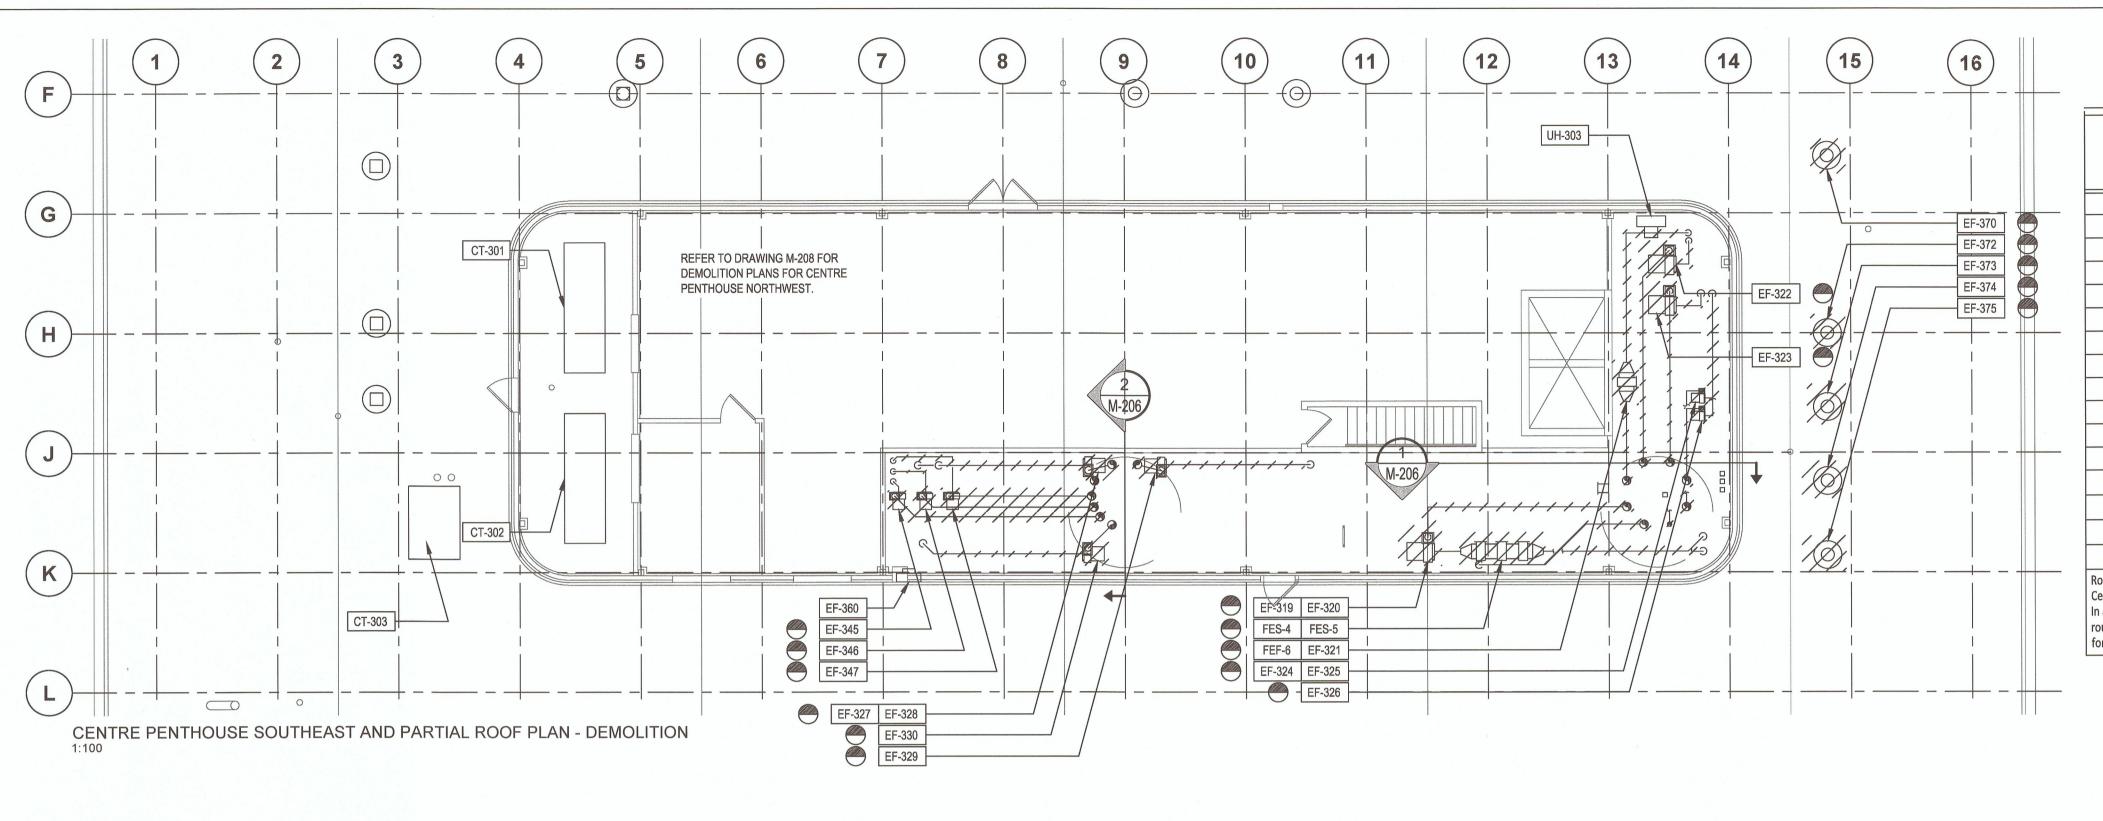EF-326

# CENTRE PENTHOUSE (SOUTHEAST) EXHAUST FANS

TAG	REMOVE OR REMAIN	HOOD/CANOPY SERVICED	SIZE (mm
EF-319	REMOVE	H15	254 Ø
EF-320	REMOVE	H16	254 Ø
EF-321	REMOVE	H10	254 Ø
EF-322	REMOVE	H11	254 Ø
EF-323	REMOVE	H14	254 Ø
EF-324	REMOVE	H13	254 Ø
EF-325	REMOVE	H12	254 Ø
EF-326	REMOVE	H36	254 Ø
EF-327	REMOVE	H28	254 Ø
EF-328	REMOVE	H27	254 Ø
EF-329	REMOVE	H32	254 Ø
EF-330	REMOVE	H29	254 Ø
EF-345	REMOVE	N/A	203 Ø
EF-346	REMOVE	N/A	203 Ø
EF-347	REMOVE	N/A	305 Ø
EF-360	REMAIN	N/A	Free inlet

Rooftop exhuast fans EF-370, EF-372, EF-373, EF-374, and EF-375 are to be connected to the Centre Southeast Penthouse manifold as indicated on sheet M-207. In addition, Centre Northwest Penthouse exhaust fans EF-349, EF-351, and EF-354, are to be routed through the Centre Northwest/Centre Southeast partition wall. Refer to specification for details on firestopping.

EF-320

SECTION 2


## GENERAL NOTES

- 1. REMOVE EX. SECTIONS OF INLET DUCTWORK FROM 152 mm FROM FLOOR PENETRATION TO EX. EXHAUST FAN AS INDICATED. PREPARE FOR CONNECTION TO NEW PLUME DILUTION EXHAUST FAN PLENUM. REFER TO DRAWING FOR DUCT DIMENSIONS. REMOVE EXISTING STRUCTURAL STEEL SUPPORTS.
- REMOVE EX. SECTIONS OF OUTLET DUCTWORK ASSOCIATED WITH EX. EXHAUST FANS. THIS IS TO INCLUDE EX. EXHAUST STACKS IN PENTHOUSE TURRETS. REFER TO, "TYP. EXHAUST STACK DEMOLITION", ON SHEET M-212 AND ARCHITECTURAL DRAWING A214.
- FOR INFORMATION ON ROOFTOP EXHAUST FANS REFER TO DRAWINGS M-202 & M-203
- 4. EXISTING FUME EXHAUST FILTER MEDIA FOR SCRUBBERS AND FUME EXHAUST FILTER IN THIS AREA ARE TO BE REMOVED BY CFIA OFFICIALS PRIOR TO DEMOLITION OF EXHAUST FANS. HOUSING, SILENCER, SCRUBBER PUMP, DUCTWORK, STRUCTURAL STEEL SUPPORT, AND ALL OTHER APPURTENANCES TO BE REMOVED BY CONTRACTOR.
- 5. REMOVE AND REINSTALL EXISTING UNIT HEATER (UH-303) AND ALL ASSOCIATED APPURTENANCES. REFER TO SHEET M-207 FOR NEW LOCATION OF UNIT HEATER.

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Canada

REAL PROPERTY SERVICES
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Revision/ Revision	Description/Description	Date/Date
0	50 % REVIEW	2017-03-03
1	PRE-TENDER CD FOR CLIENT REVIEW	2017-04-05
2	ISSUED FOR 100 % CD	2017-05-09
3	ISSUED FOR TENDER	2017-07-13
4		
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CANADIAN FOOD INSPECTION AGENCY

Project title/Titre du projet

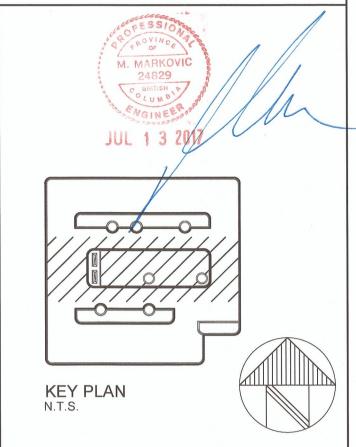3155 WILLINGDON GREEN
BURNABY, BC

CFIA
EXHAUST MANIFOLD
SYSTEM

Consultant Signature Only

Designed by/Concept par

**SE**PWGSC Project Manager/Administrateur de Projets TPSGC

Regional Manager, Architectural and Engineering Services Gestionnaire régionale, Services d'architectural et de génie, TPSGC

Drawing title/Titre du dessin

CENTRE PENTHOUSE SOUTHEAST
AND PARTIAL ROOF PLAN
- DEMOLITION


Project No./No. du projet

39903-150591

M-206

OF 12

0 10 20 30 40 50 60 70 80 90 100mm

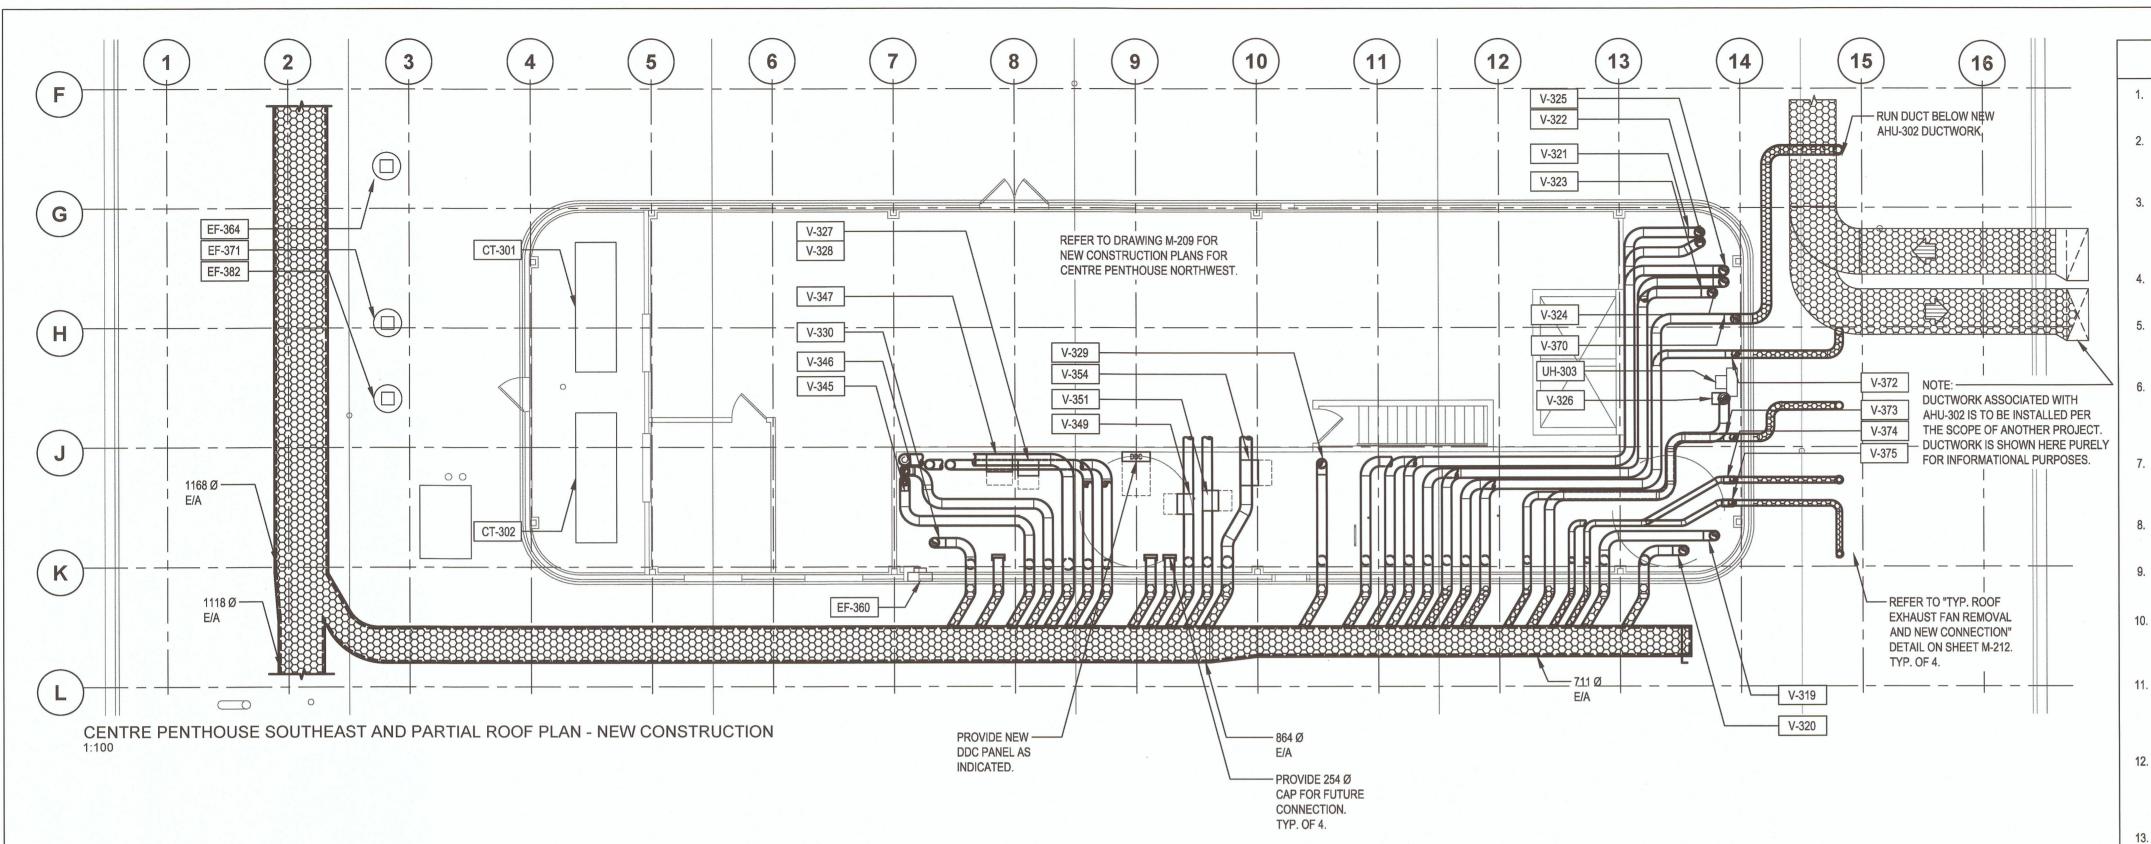

- 1. WHERE NECESSARY, AIR VALVES HAVE BEEN SHOWN AS OFFSET FOR CLARITY.
- 2. ALL PENTHOUSE WALL PENETRATIONS ARE TO BE CORED AS INDICATED. WHERE NO DUCT IS SHOWN CONNECTING THE CONTRACTOR IS TO PROVIDE A CAP FOR FUTURE CONNECTION.
- 3. ALLOW MINIMUM 356 mm CLEARANCE AROUND VALVE FOR SERVICING. ALLOW MINIMUM 171 mm UNOBSTRUCTED SPACE, IN DUCT, ON VALVE INLET. PROVIDE DUCTWORK SUPPORT WITHIN 305 mm OF VALVE INLET AND OUTLET.
- ALL DUCTWORK (INSIDE AND OUTSIDE OF THE PENTHOUSE) IS TO BE SLOPED TO THE PLUME DILUTION EXHAUST FAN'S MANIFOLD PLENUM.
- 5. VALVE NOMENCLATURE IS TO MATCH THAT OF EXHAUST FAN REMOVED. I.E. V-319 IS ASSOCIATED WITH THE SAME EXHAUST STREAM AS EF-319.
  - WHERE MULTIPLE CONTROL VALVES ARE REQUIRED THE CONTRACTOR IS TO INSTALL AS PER MANUFACTURER'S RECOMMENDATIONS. REFER TO SHEET M-212 FOR TYPICAL DOUBLE CONNECTIONS.
  - CONTROL VALVES MUST BE ORIENTED SO THAT CONTROL BOARD IS BETWEEN 8 AND 4 O'CLOCK POSITIONS TO AVOID CONDENSATION BUILDUP.
- 8. FOR INFORMATION ON ROOFTOP EXHAUST FANS REFER TO DRAWINGS M-202 & M-203.
- 9. FOR INFORMATION ON DUCT/VALVE SIZES REFER TO TABLE "NEW CENTRE PENTHOUSE (SOUTHEAST) CONTROL VALVES" ON THIS SHEET.
- 10. DUCT PENETRATIONS, OUT OF PENTHOUSE TO EXHAUST MANIFOLD DUCT, TO BE AT APPROXIMATELY THE SAME ELEVATION (APPROXIMATELY 1100 mm AFR).
- 11. ALL EXPOSED DUCTWORK ON THE ROOF TO BE THERMALLY INSULATED WITH 50 mm THICK INSULATION AND PROVIDED WITH ALUMINUM JACKETING PER SPECIFICATION. JACKETING TO BE SEALED WITH POLYURETHANE CAULKING.
- 12. VALVES ARE TO BE CONNECTED TO NEW DUCTWORK USING DRAWBAND CLAMPS APPROVED BY THE VALVE MANUFACTURER.

  NEW DUCTWORK IS TO BE WELDED TO CONNECT TO THE EXISTING DUCTWORK.
- REMOVE AND REINSTALL EXISTING UNIT HEATER (UH-303) AND ALL ASSOCIATED APPURTENANCES. REFER TO THIS SHEET FOR NEW LOCATION.

# NEW CENTRE PENTHOUSE (SOUTHEAST) CONTROL VALVES

NEW VALVE TAG	HOOD/ CANOPY SERVICED	ASSOCIATED DUCTWORK SIZE (mm)	CONTROL VALVE SIZE (mm)	NUMBER OF CONTROL VALVES
V-319	H15	254 Ø	305 Ø	1
V-320	H16	254 Ø	254 Ø	1
V-321	H10	254 Ø	305 Ø	1
V-322	H11	254 Ø	305 Ø	1
V-323	H14	254 Ø	305 Ø	1
V-324	H13	254 Ø	305 Ø	1
V-325	H12	254 Ø	305 Ø	1
v-326	H36	254 Ø	305 Ø	1
V-327	H28	254 Ø	254 Ø	1
V-328	H27	254 Ø	254 Ø	1
V-329	H32	254 Ø	305 Ø	1
V-330	H29	254 Ø	305 Ø	1
V-345	N/A	203 Ø	203 Ø	1
V-346	N/A	203 Ø	203 Ø	1
V-347	N/A	305 Ø	305 Ø	1
V-349	N/A	356x254	254 Ø	1
V-351	N/A	152x152	254 Ø	1
V-354	N/A	356x203	305 Ø	1
V-370	N/A	152x152	254 Ø	1
V-372	N/A	203 Ø	203 Ø	1
V-373	N/A	203 Ø	203 Ø	1
V-374	N/A	152 Ø	203 Ø	1
V-375	N/A	152 Ø	203 Ø	1

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KEY PLAN N.T.S.	

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	3	ISSUED FOR TENDER	2017-07-13
	2	ISSUED FOR 100 % CD	2017-05-09
	1	PRE-TENDER CD FOR CLIENT REVIEW	2017-04-05
	0	50 % REVIEW	2017-03-03
	Revision/ Revision	Description/Description	Date/Date
1	Client /alie	L	

CANADIAN FOOD INSPECTION AGENCY

Project title/Titre du projet

3155 WILLINGDON GREEN
BURNABY, BC

CFIA
EXHAUST MANIFOLD
SYSTEM

Designed by/C	oncept par		
MM			
Drawn by/Dess <b>SE</b>	ine par		

Drawing title/Titre du dessin

CENTRE PENTHOUSE SOUTHEAST
AND PARTIAL ROOF PLAN
- NEW CONSTRUCTION


Project No./No. du projet	Sheet/Feuille	Revision no., La Révision
39903-150591	M-207	<sup>no.</sup> 3
	OF 12	

CENTRE PENTHOUSE (SOUTHEAST) EXHAUST FANS/SCRUBBERS/FILTERS TO REMAIN


EQUIPMENT TAG

EF-326

EF-360

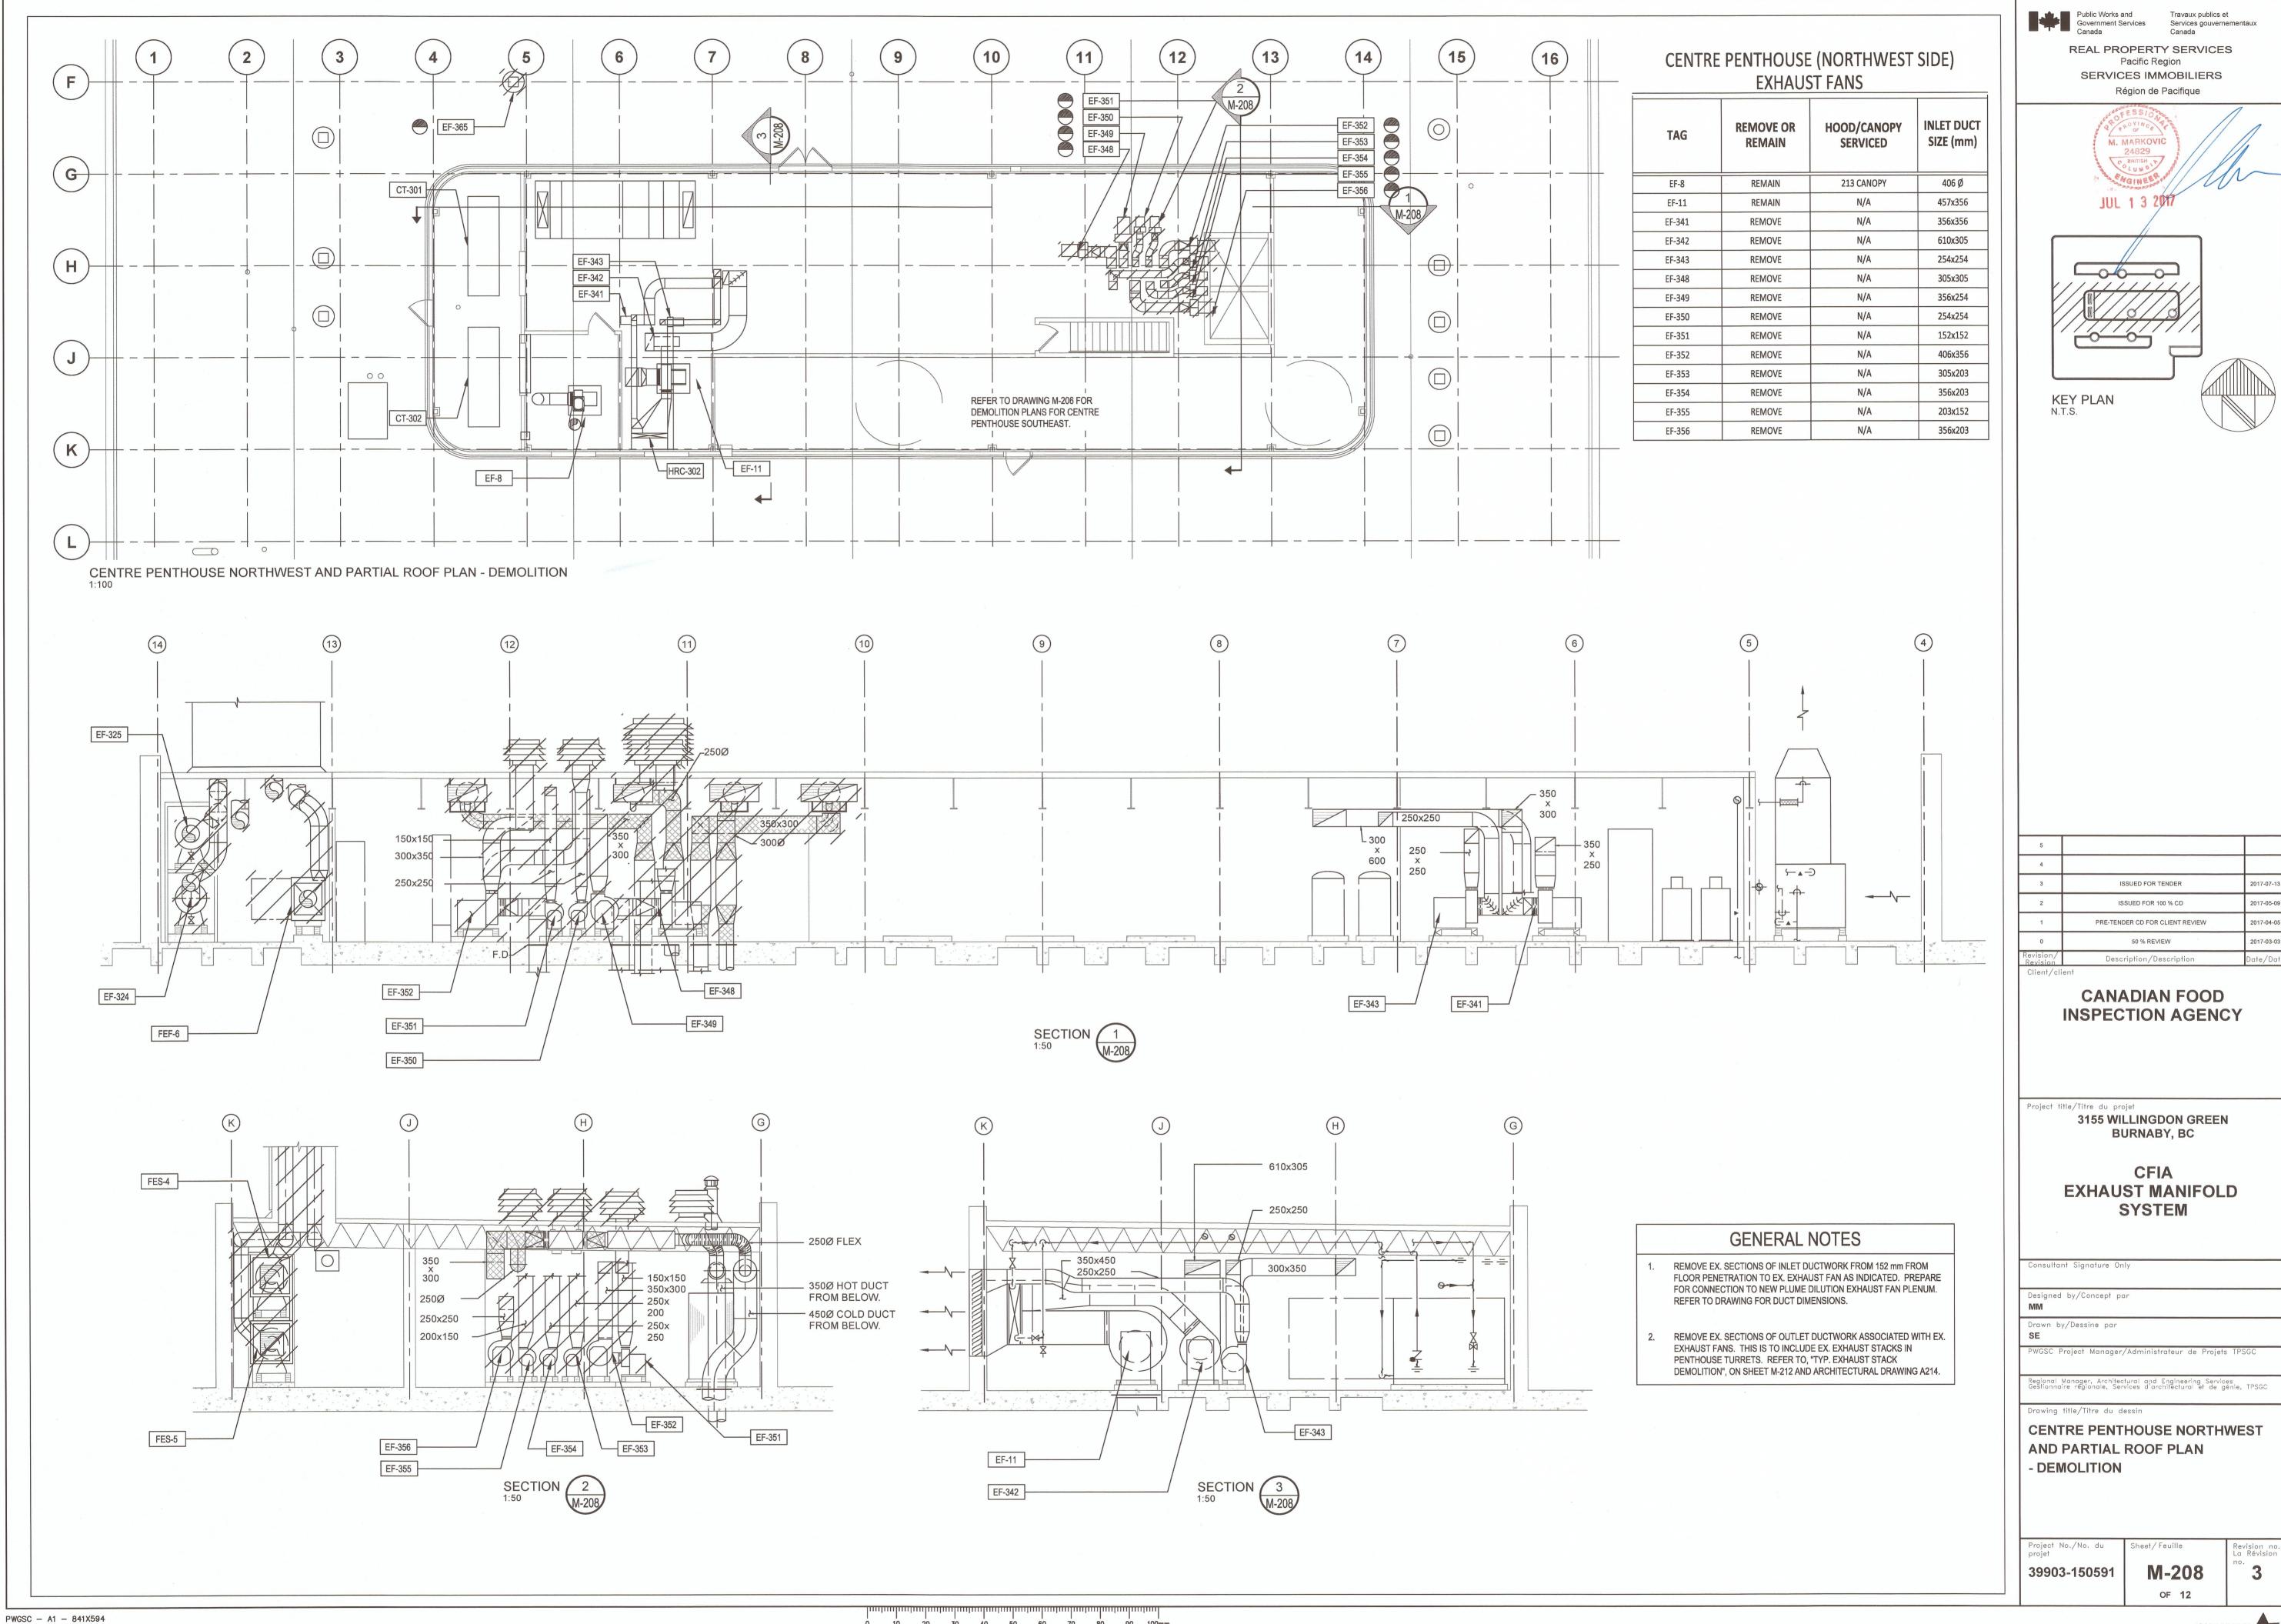

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- VALVE NOMENCLATURE IS TO MATCH THAT OF EXHAUST FAN REMOVED. I.E. V-341 IS ASSOCIATED WITH THE SAME EXHAUST STREAM AS EF-341.
- ALLOW MINIMUM 356 mm CLEARANCE AROUND VALVE FOR SERVICING. ALLOW MINIMUM 171 mm UNOBSTRUCTED SPACE, IN DUCT, ON VALVE INLET. PROVIDE DUCTWORK SUPPORT WITHIN 305 mm OF VALVE INLET AND OUTLET.
- ALL DUCTWORK (INSIDE AND OUTSIDE OF THE PENTHOUSE) IS TO BE SLOPED TO THE PLUME DILUTION EXHAUST FAN'S MANIFOLD PLENUM.
- WHERE MULTIPLE CONTROL VALVES ARE REQUIRED THE CONTRACTOR IS TO INSTALL AS PER MANUFACTURER'S RECOMMENDATIONS. REFER TO SHEET M-212 FOR TYPICAL DOUBLE CONNECTIONS.
- CONTROL VALVES MUST BE ORIENTED SO THAT CONTROL BOARD IS BETWEEN 8 AND 4 O'CLOCK POSITIONS TO AVOID CONDENSATION
- EXISTING DUCTWORK IN THIS AREA IS GALVANIZED STEEL WITH ASBESTOS DUCT JOINTS. CONTRACTOR IS TO EMPLOY APPROPRIATE SAFETY PROTOCOLS.
- ALL EXPOSED DUCTWORK ON THE ROOF TO BE THERMALLY INSULATED WITH 50 mm THICK INSULATION AND PROVIDED WITH ALUMINUM JACKETING PER SPECIFICATION. JACKETING TO BE SEALED WITH POLYURETHANE CAULKING.
- ALL PENTHOUSE WALL PENETRATIONS ARE TO BE CORED AS INDICATED. WHERE NO DUCT IS SHOWN CONNECTING THE CONTRACTOR IS TO PROVIDE A CAP FOR FUTURE CONNECTION.
- FOR INFORMATION ON DUCT/VALVE SIZES REFER TO TABLE "NEW CENTRE PENTHOUSE (SOUTHEAST) CONTROL VALVES" ON THIS SHEET.
- 10 DUCT PENETRATIONS, OUT OF PENTHOUSE TO EXHAUST MANIFOLD DUCT, TO BE AT APPROXIMATELY THE SAME ELEVATION (APPROXIMATELY 1100
- 11 VALVES ARE TO BE CONNECTED TO NEW DUCTWORK USING DRAWBAND CLAMPS APPROVED BY THE VALVE MANUFACTURER. NEW DUCTWORK IS TO BE WELDED TO CONNECT TO THE EXISTING DUCTWORK.
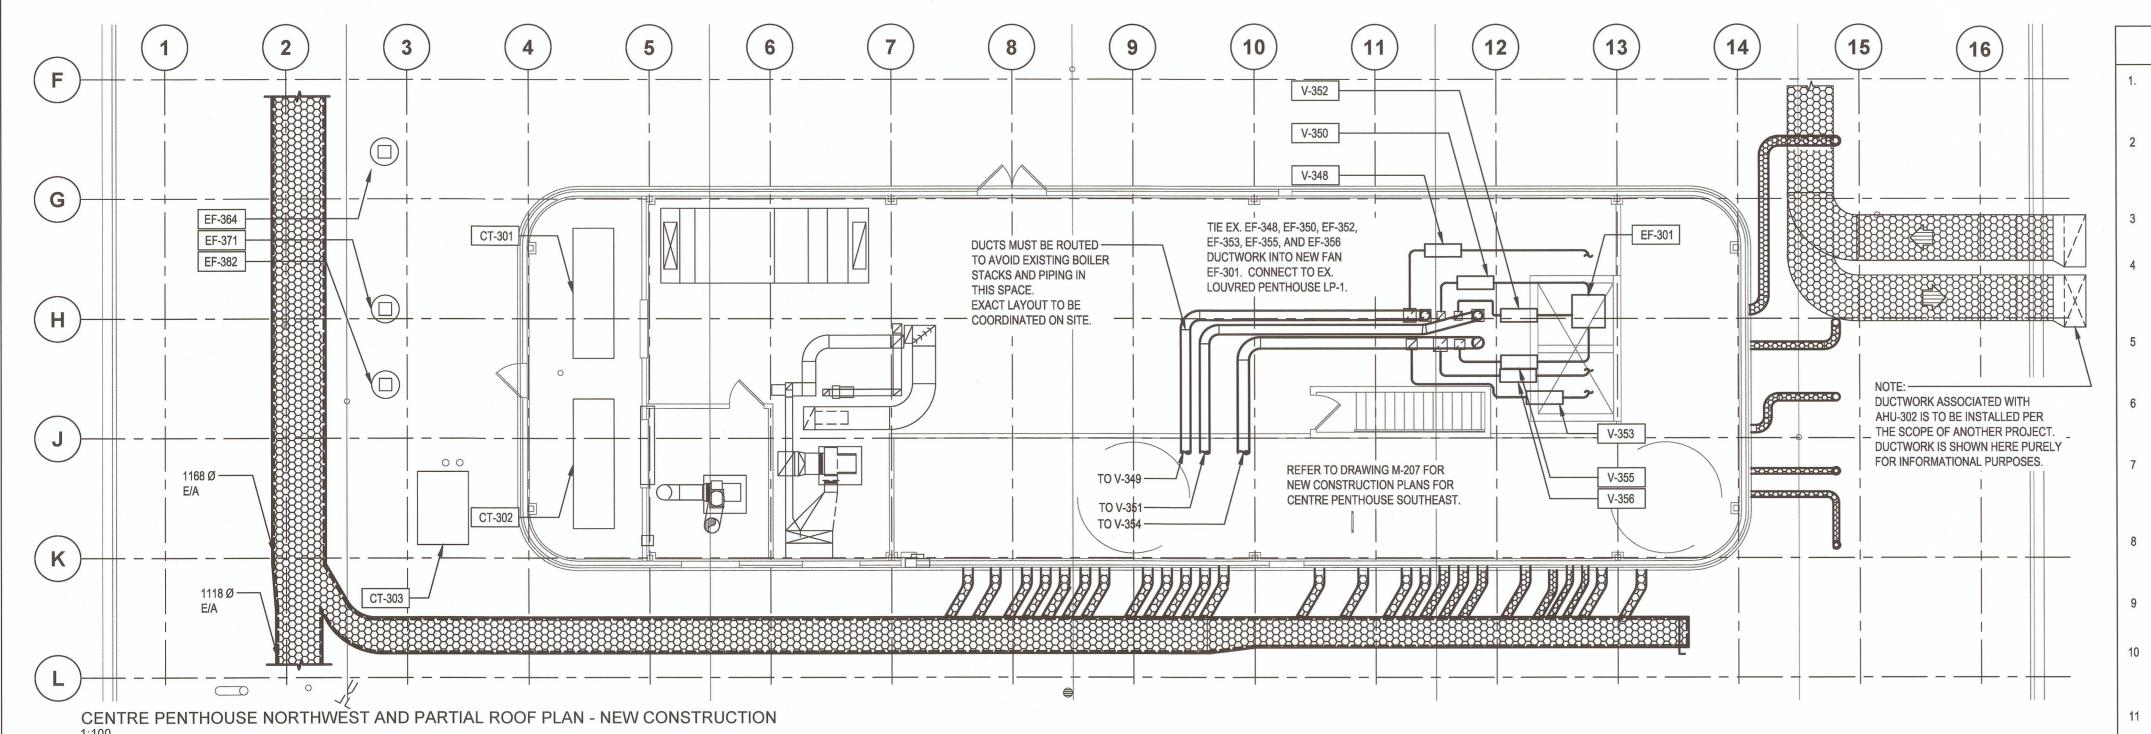
## CENTRE PENTHOUSE (NORTHWEST) EXHAUST FANS/SCRUBBERS/FILTERS TO


REMAIN	
EQUIPMENT TAG	
CT-301	
CT-302	
CT-303	
EF-8	
EF-11	
EF-341	
EF-342	
EF-343	
HRC-302	

### NEW CENTRE PENTHOUSE (NORTHWEST SIDE) CONTROL VALVES

NEW VALVE TAG	HOOD/ CANOPY SERVICED	ASSOCIATED DUCTWORK SIZE (mm)	CONTROL VALVE SIZE (mm)	NUMBER OF CONTROL VALVES
V-341	N/A	356x356	356 Ø	1
V-342	N/A	610x305	356 Ø	1
V-343	N/A	254x254	254 Ø	1
V-348	N/A	305x305	305 Ø	1
V-350	N/A	254x254	254 Ø	1
V-352	N/A	406x356	356 Ø	1
V-353	N/A	305x203	305 Ø	1
V-355	N/A	203x152	203 Ø	1
V-356	N/A	356x203	305 Ø	1



REAL PROPERTY SERVICES Pacific Region SERVICES IMMOBILIERS Région de Pacifique

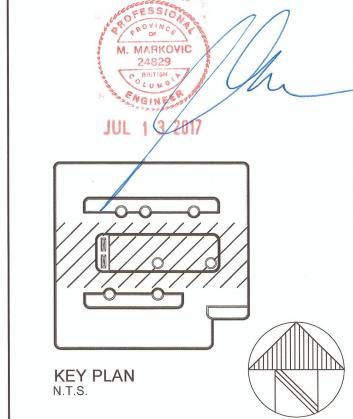

5		
4		
3	ISSUED FOR TENDER	2017-07-13
2	ISSUED FOR 100 % CD	2017-05-09
1	PRE-TENDER CD FOR CLIENT REVIEW	2017-04-05
0	50 % REVIEW	2017-03-03
Revision/ Revision	Description/Description	Date/Date
Client/clier	nt	

**CANADIAN FOOD INSPECTION AGENCY** 

Project title/Titre du projet

3155 WILLINGDON GREEN BURNABY, BC

**CFIA EXHAUST MANIFOLD** SYSTEM

Consultant Signature Only

Designed by/Concept par

Drawn by/Dessine par

PWGSC Project Manager/Administrateur de Projets TPSGC

Regional Manager, Architectural and Engineering Services Gestionnaire régionale, Services d'architectural et de génie, TPSGC


Drawing title/Titre du dessin

CENTRE PENTHOUSE NORTHWEST AND PARTIAL ROOF PLAN

- NEW CONSTRUCTION

Project No./No. du projet M-209 39903-150591

Revision no .a Révision OF 12

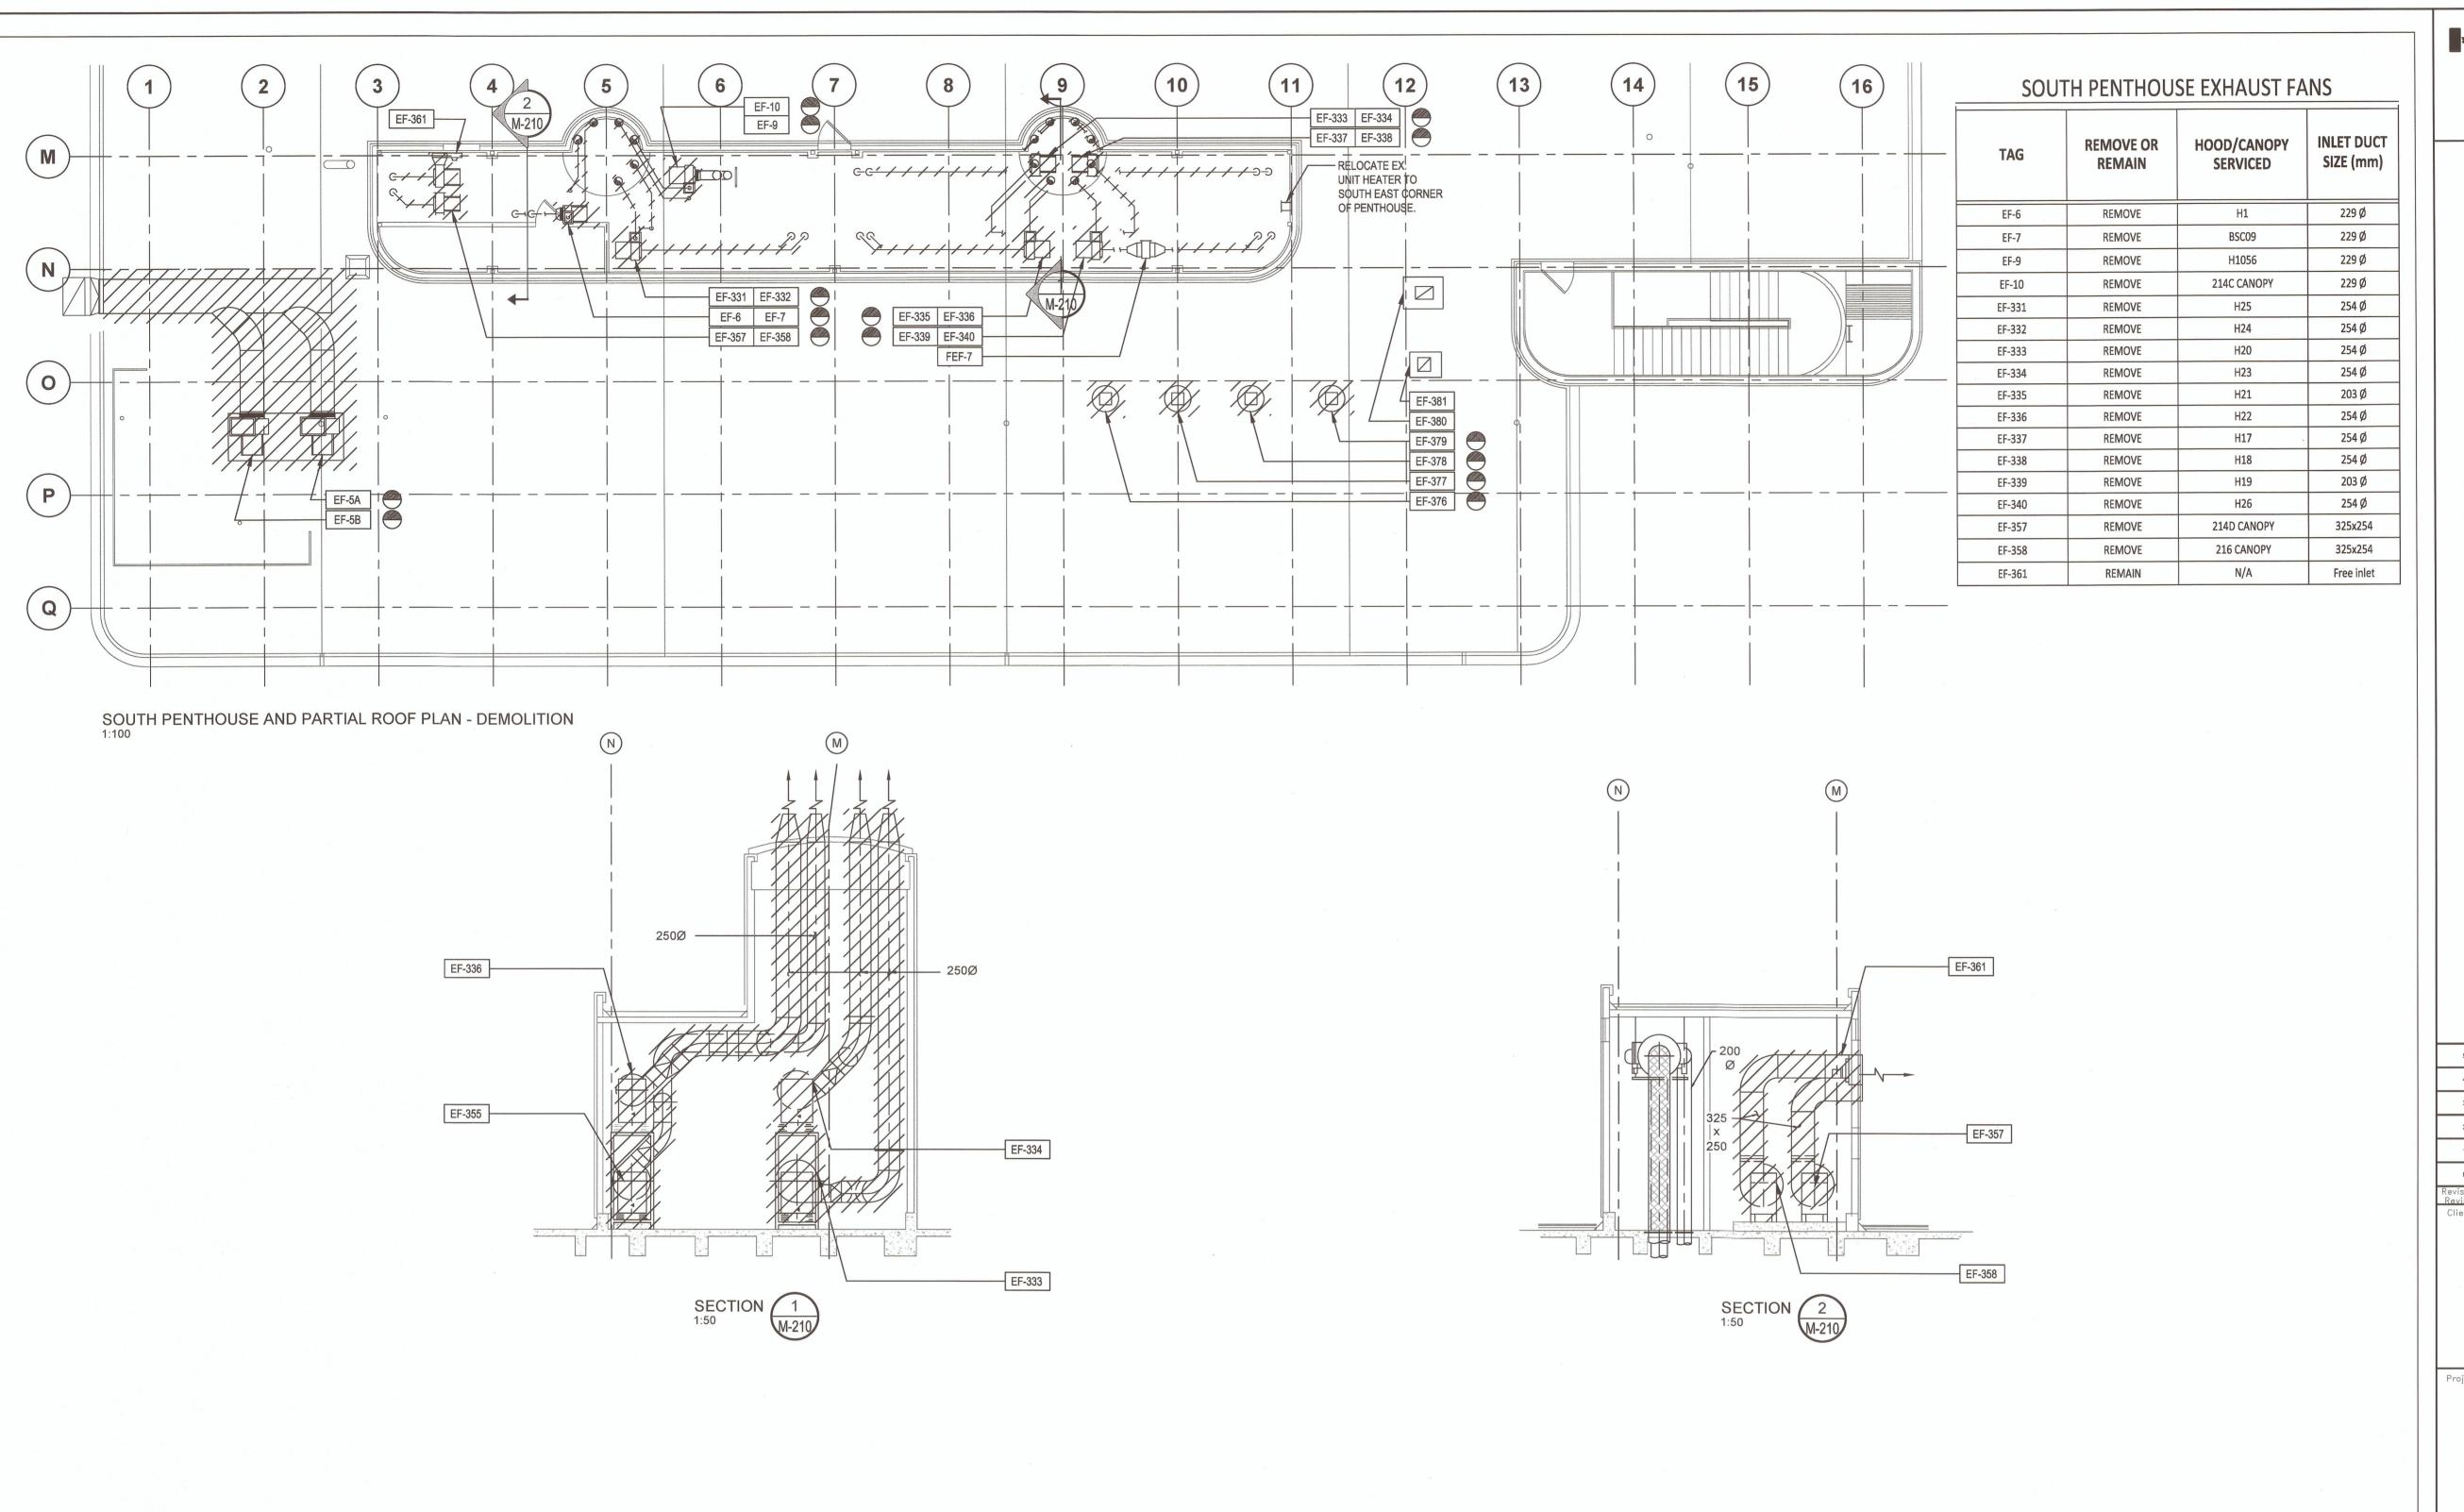


- REMOVE EX. SECTIONS OF INLET DUCTWORK FROM 152 mm FROM FLOOR PENETRATION TO EX. EXHAUST FAN AS INDICATED. PREPARE FOR CONNECTION TO NEW PLUME DILUTION EXHAUST FAN PLENUM. REFER TO DRAWING FOR DUCT DIMENSIONS. REMOVE EXISTING STRUCTURAL STEEL SUPPORTS.
- 2. REMOVE EX. SECTIONS OF OUTLET DUCTWORK ASSOCIATED WITH EX. EXHAUST FANS. THIS IS TO INCLUDE EX. EXHAUST STACKS IN PENTHOUSE TURRETS. REFER TO, "TYP. EXHAUST STACK DEMOLITION", ON SHEET M-212 AND ARCHITECTURAL DRAWING A214.
- FOR INFORMATION ON ROOFTOP EXHAUST FANS REFER TO DRAWINGS M-202 & M-203
- 4. EXISTING FUME EXHAUST FILTER IN THIS AREA (FEF-7) IS TO BE RELOCATED AND CONNECTED TO EXHAUST STREAM ASSOCIATED WITH EF-335 CONTRACTOR TO REMOVE OR RELOCATE THE EXISTING STRUCTURAL SUPPORT.

Public Works and Government Services Services gouvernementaux Canada

REAL PROPERTY SERVICES Pacific Region SERVICES IMMOBILIERS

Région de Pacifique

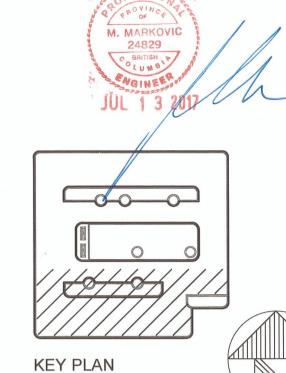

5		
4		
3	ISSUED FOR TENDER	2017-07-13
2	ISSUED FOR 100 % CD	2017-05-09
1	PRE-TENDER CD FOR CLIENT REVIEW	2017-04-05
0	50 % REVIEW	2017-03-03
Revision/ Revision	Description/Description	Date/Date
Client/cli	ent	

**CANADIAN FOOD INSPECTION AGENCY** 

Project title/Titre du projet 3155 WILLINGDON GREEN BURNABY, BC

> CFIA **EXHAUST MANIFOLD** SYSTEM

Consultant Signature Only

Designed by/Concept par

Drawn by/Dessine par

PWGSC Project Manager/Administrateur de Projets TPSGC


Regional Manager, Architectural and Engineering Services Gestionnaire régionale, Services d'architectural et de génie, TPSGC

Drawing title/Titre du dessin

SOUTH PENTHOUSE AND PARTIAL ROOF PLAN - DEMOLITION

39903-150591

**M-210** OF 12

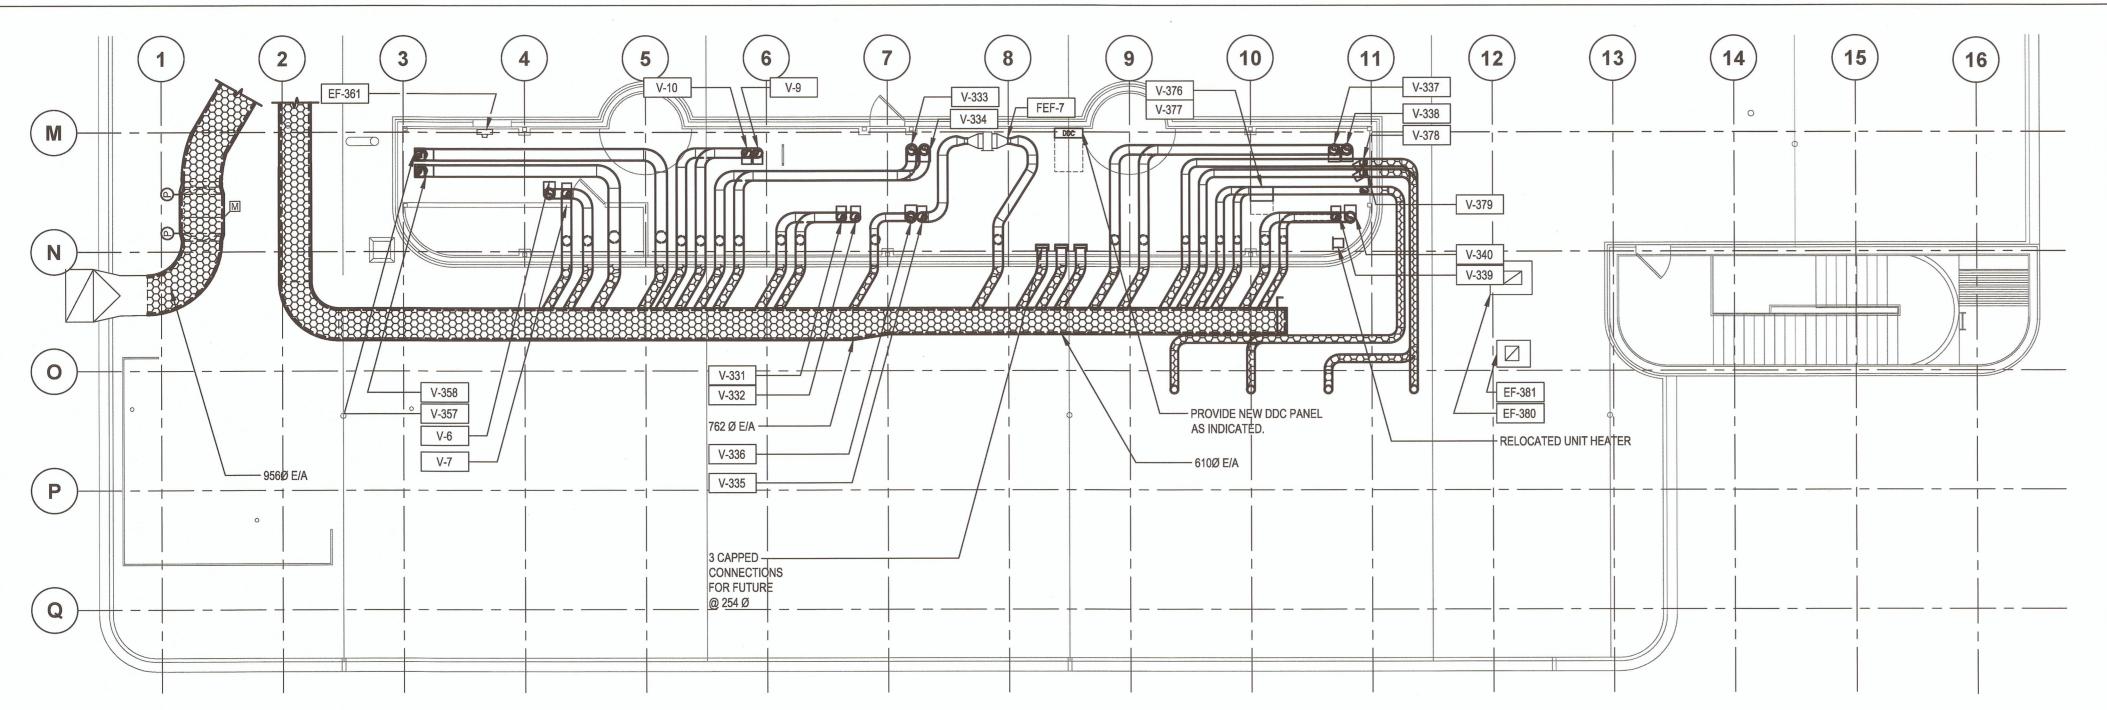

- VALVE NOMENCLATURE IS TO MATCH THAT OF EXHAUST FAN REMOVED. I.E. V-341 IS ASSOCIATED WITH THE SAME EXHAUST STREAM
- ALLOW MINIMUM 356 mm CLEARANCE AROUND VALVE FOR SERVICING. ALLOW MINIMUM 171 mm UNOBSTRUCTED SPACE, IN DUCT, ON VALVE INLET. PROVIDE DUCTWORK SUPPORT WITHIN 305 mm OF VALVE INLET AND OUTLET.
- ALL DUCTWORK (INSIDE AND OUTSIDE OF THE PENTHOUSE) IS TO BE SLOPED TO THE PLUME DILUTION EXHAUST FAN'S MANIFOLD PLENUM.
- 4 RELOCATE FEF-7 AS INDICATED AND CONNECT TO V-335.
- 5 CONTROL VALVES MUST BE ORIENTED SO THAT CONTROL BOARD IS BETWEEN 8 AND 4 O'CLOCK POSITIONS TO AVOID CONDENSATION BUILDUP.
- FOR INFORMATION ON DUCT/VALVE SIZES REFER TO TABLE "NEW CENTRE PENTHOUSE (SOUTHEAST) CONTROL VALVES" ON THIS SHEET.
- DUCT PENETRATIONS, OUT OF PENTHOUSE TO EXHAUST MANIFOLD DUCT, TO BE AT APPROXIMATELY THE SAME ELEVATION (APPROXIMATELY 1100
- ALL EXPOSED DUCTWORK ON THE ROOF TO BE THERMALLY INSULATED WITH 50 mm THICK INSULATION AND PROVIDED WITH ALUMINUM JACKETING PER SPECIFICATION. JACKETING TO BE SEALED WITH POLYURETHANE CAULKING.
- VALVES ARE TO BE CONNECTED TO NEW DUCTWORK USING DRAWBAND CLAMPS APPROVED BY THE VALVE MANUFACTURER. NEW DUCTWORK IS TO BE WELDED TO CONNECT TO THE EXISTING


Public Works and Government Services Canada

Public Works and Travaux publics et Services gouvernementaux Canada

REAL PROPERTY SERVICES Pacific Region SERVICES IMMOBILIERS

Région de Pacifique



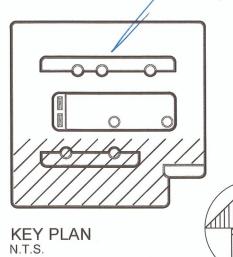

#### SOUTH PENTHOUSE EXHAUST FANS/SCRUBBERS/FILTERS TO REMAIN

 INLIVIAIN
EQUIPMENT TAG
EF-361
FEF-7 (RELOCATED)

### NEW SOUTH PENTHOUSE CONTROL VALVES

NEW VALVE TAG	HOOD/ CANOPY SERVICED	ASSOCIATED DUCTWORK SIZE (mm)	CONTROL VALVE SIZE (mm)	NUMBER OF CONTROL VALVES
V-6	H1	229 Ø	254 Ø	1
V-7	BSC09	229 Ø	254 Ø	1
V-9	H1056	229 Ø	254 Ø	1
V-10	214C CANOPY	229 Ø	254 Ø	1
V-331	H25	254 Ø	305 Ø	1
V-332	H24	254 Ø	305 Ø	1
V-333	H20	254 Ø	305 Ø	1
V-334	H23	254 Ø	305 Ø	1
V-335	H21	203 Ø	254 Ø	1
V-336	H22	254 Ø	305 Ø	1
V-337	H17	254 Ø	305 Ø	1
V-338	H18	254 Ø	305 Ø	1
V-339	H19	203 Ø	254 Ø	1
V-340	H26	254 Ø	305 Ø	1
V-357	214D CANOPY	305 Ø	305 Ø	1
V-358	216 CANOPY	305 Ø	305 Ø	1
V-376	N/A	203 Ø	203 Ø	1
V-377	N/A	203 Ø	203 Ø	1
V-378	N/A	203 Ø	203 Ø	1
V-379	N/A	203 Ø	203 Ø	1

	4		
	3	ISSUED FOR TENDER	2017-07-13
	2	ISSUED FOR 100 % CD	2017-05-09
	1	PRE-TENDER CD FOR CLIENT REVIEW	2017-04-05
	0	50 % REVIEW	2017-03-03
	Revision/ Revision	Description/Description	Date/Date
	Client/cli	ent	

#### **CANADIAN FOOD INSPECTION AGENCY**

Project title/Titre du projet 3155 WILLINGDON GREEN **BURNABY, BC** 

> **CFIA EXHAUST MANIFOLD** SYSTEM

Consultant Signature Only

Designed by/Concept par

Drawn by/Dessine par

PWGSC Project Manager/Administrateur de Projets TPSGC


Regional Manager, Architectural and Engineering Services Gestionnaire régionale, Services d'architectural et de génie, TPSGC

Drawing title/Titre du dessin SOUTH PENTHOUSE AND PARTIAL ROOF PLAN - NEW CONSTRUCTION

Project No./No. du projet M-211 39903-150591 OF 12

0 10 20 30 40 50 60 70 80 90 100mm

SOUTH PENTHOUSE AND PARTIAL ROOF PLAN - NEW CONSTRUCTION

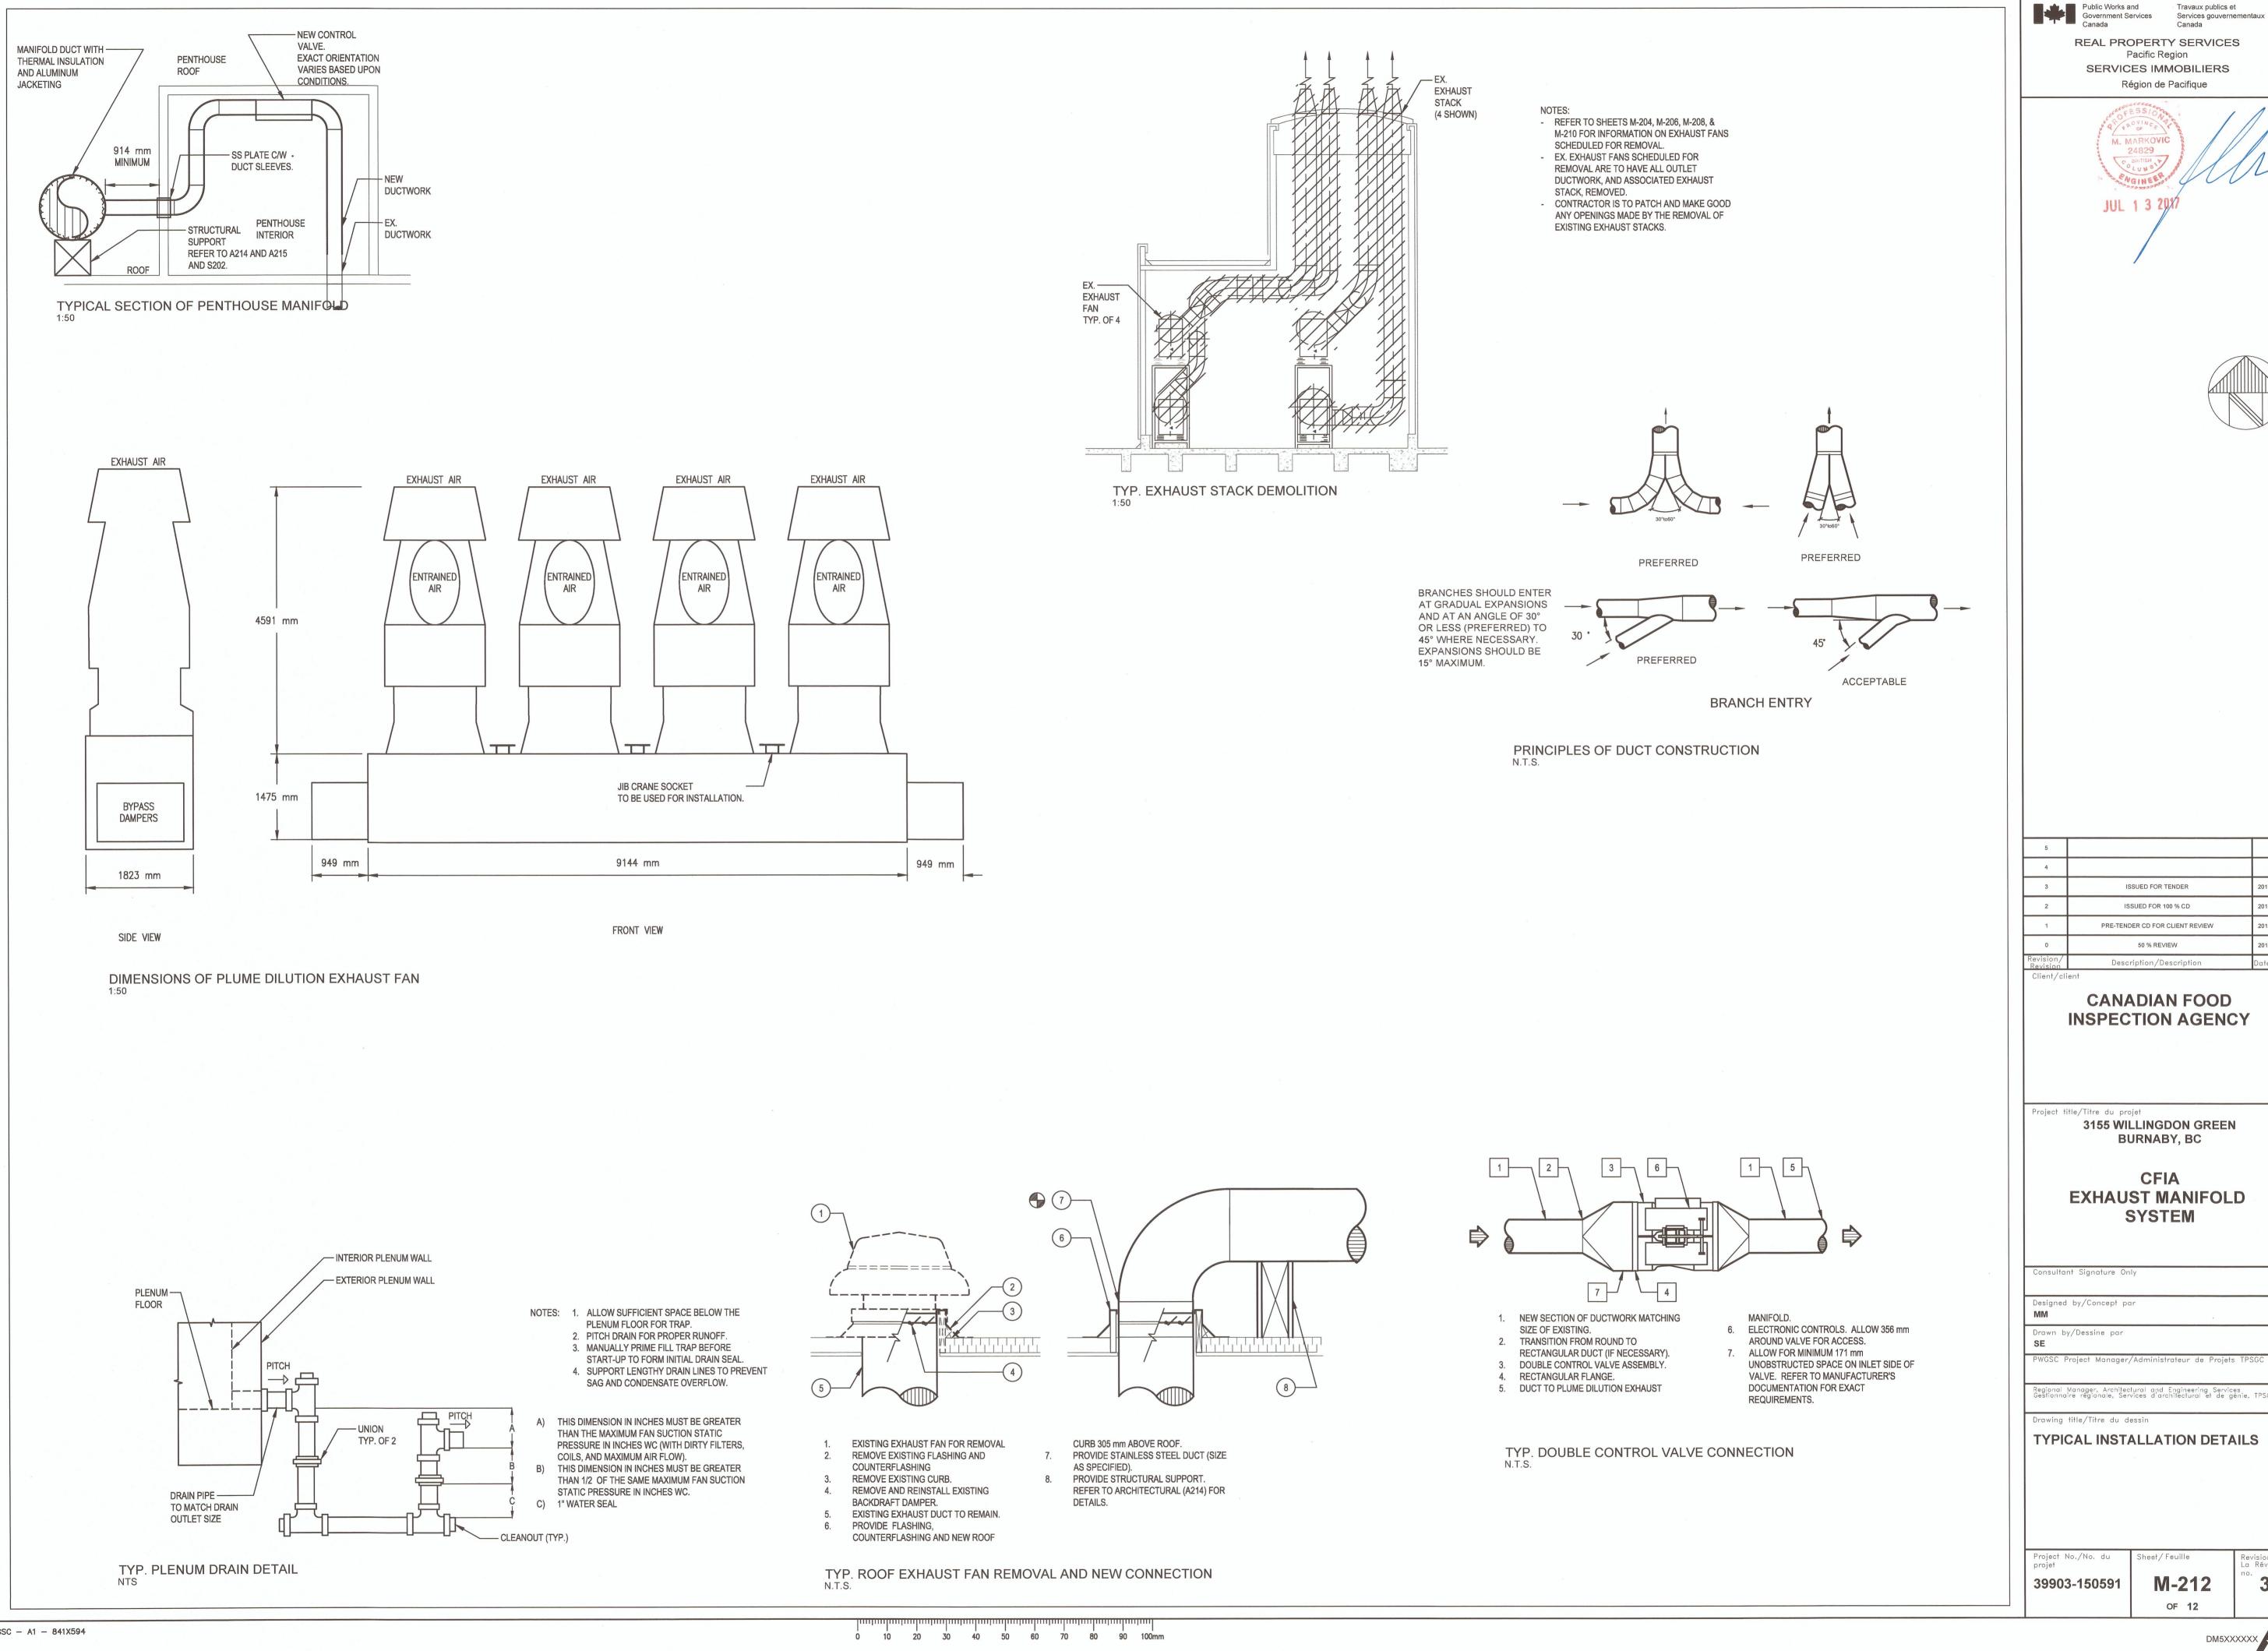

ISSUED FOR TENDER ISSUED FOR 100 % CD PRE-TENDER CD FOR CLIENT REVIEW 50 % REVIEW

REAL PROPERTY SERVICES

Pacific Region

SERVICES IMMOBILIERS

Région de Pacifique

**CANADIAN FOOD INSPECTION AGENCY** 

Project title/Titre du projet

3155 WILLINGDON GREEN BURNABY, BC

**CFIA EXHAUST MANIFOLD** SYSTEM

Consultant Signature Only

Designed by/Concept par

Drawn by/Dessine par


Regional Manager, Architectural and Engineering Services Gestionnaire régionale, Services d'architectural et de génie, TPSGC

Drawing title/Titre du dessin

TYPICAL INSTALLATION DETAILS

Project No./No. du 39903-150591


M-212OF 12

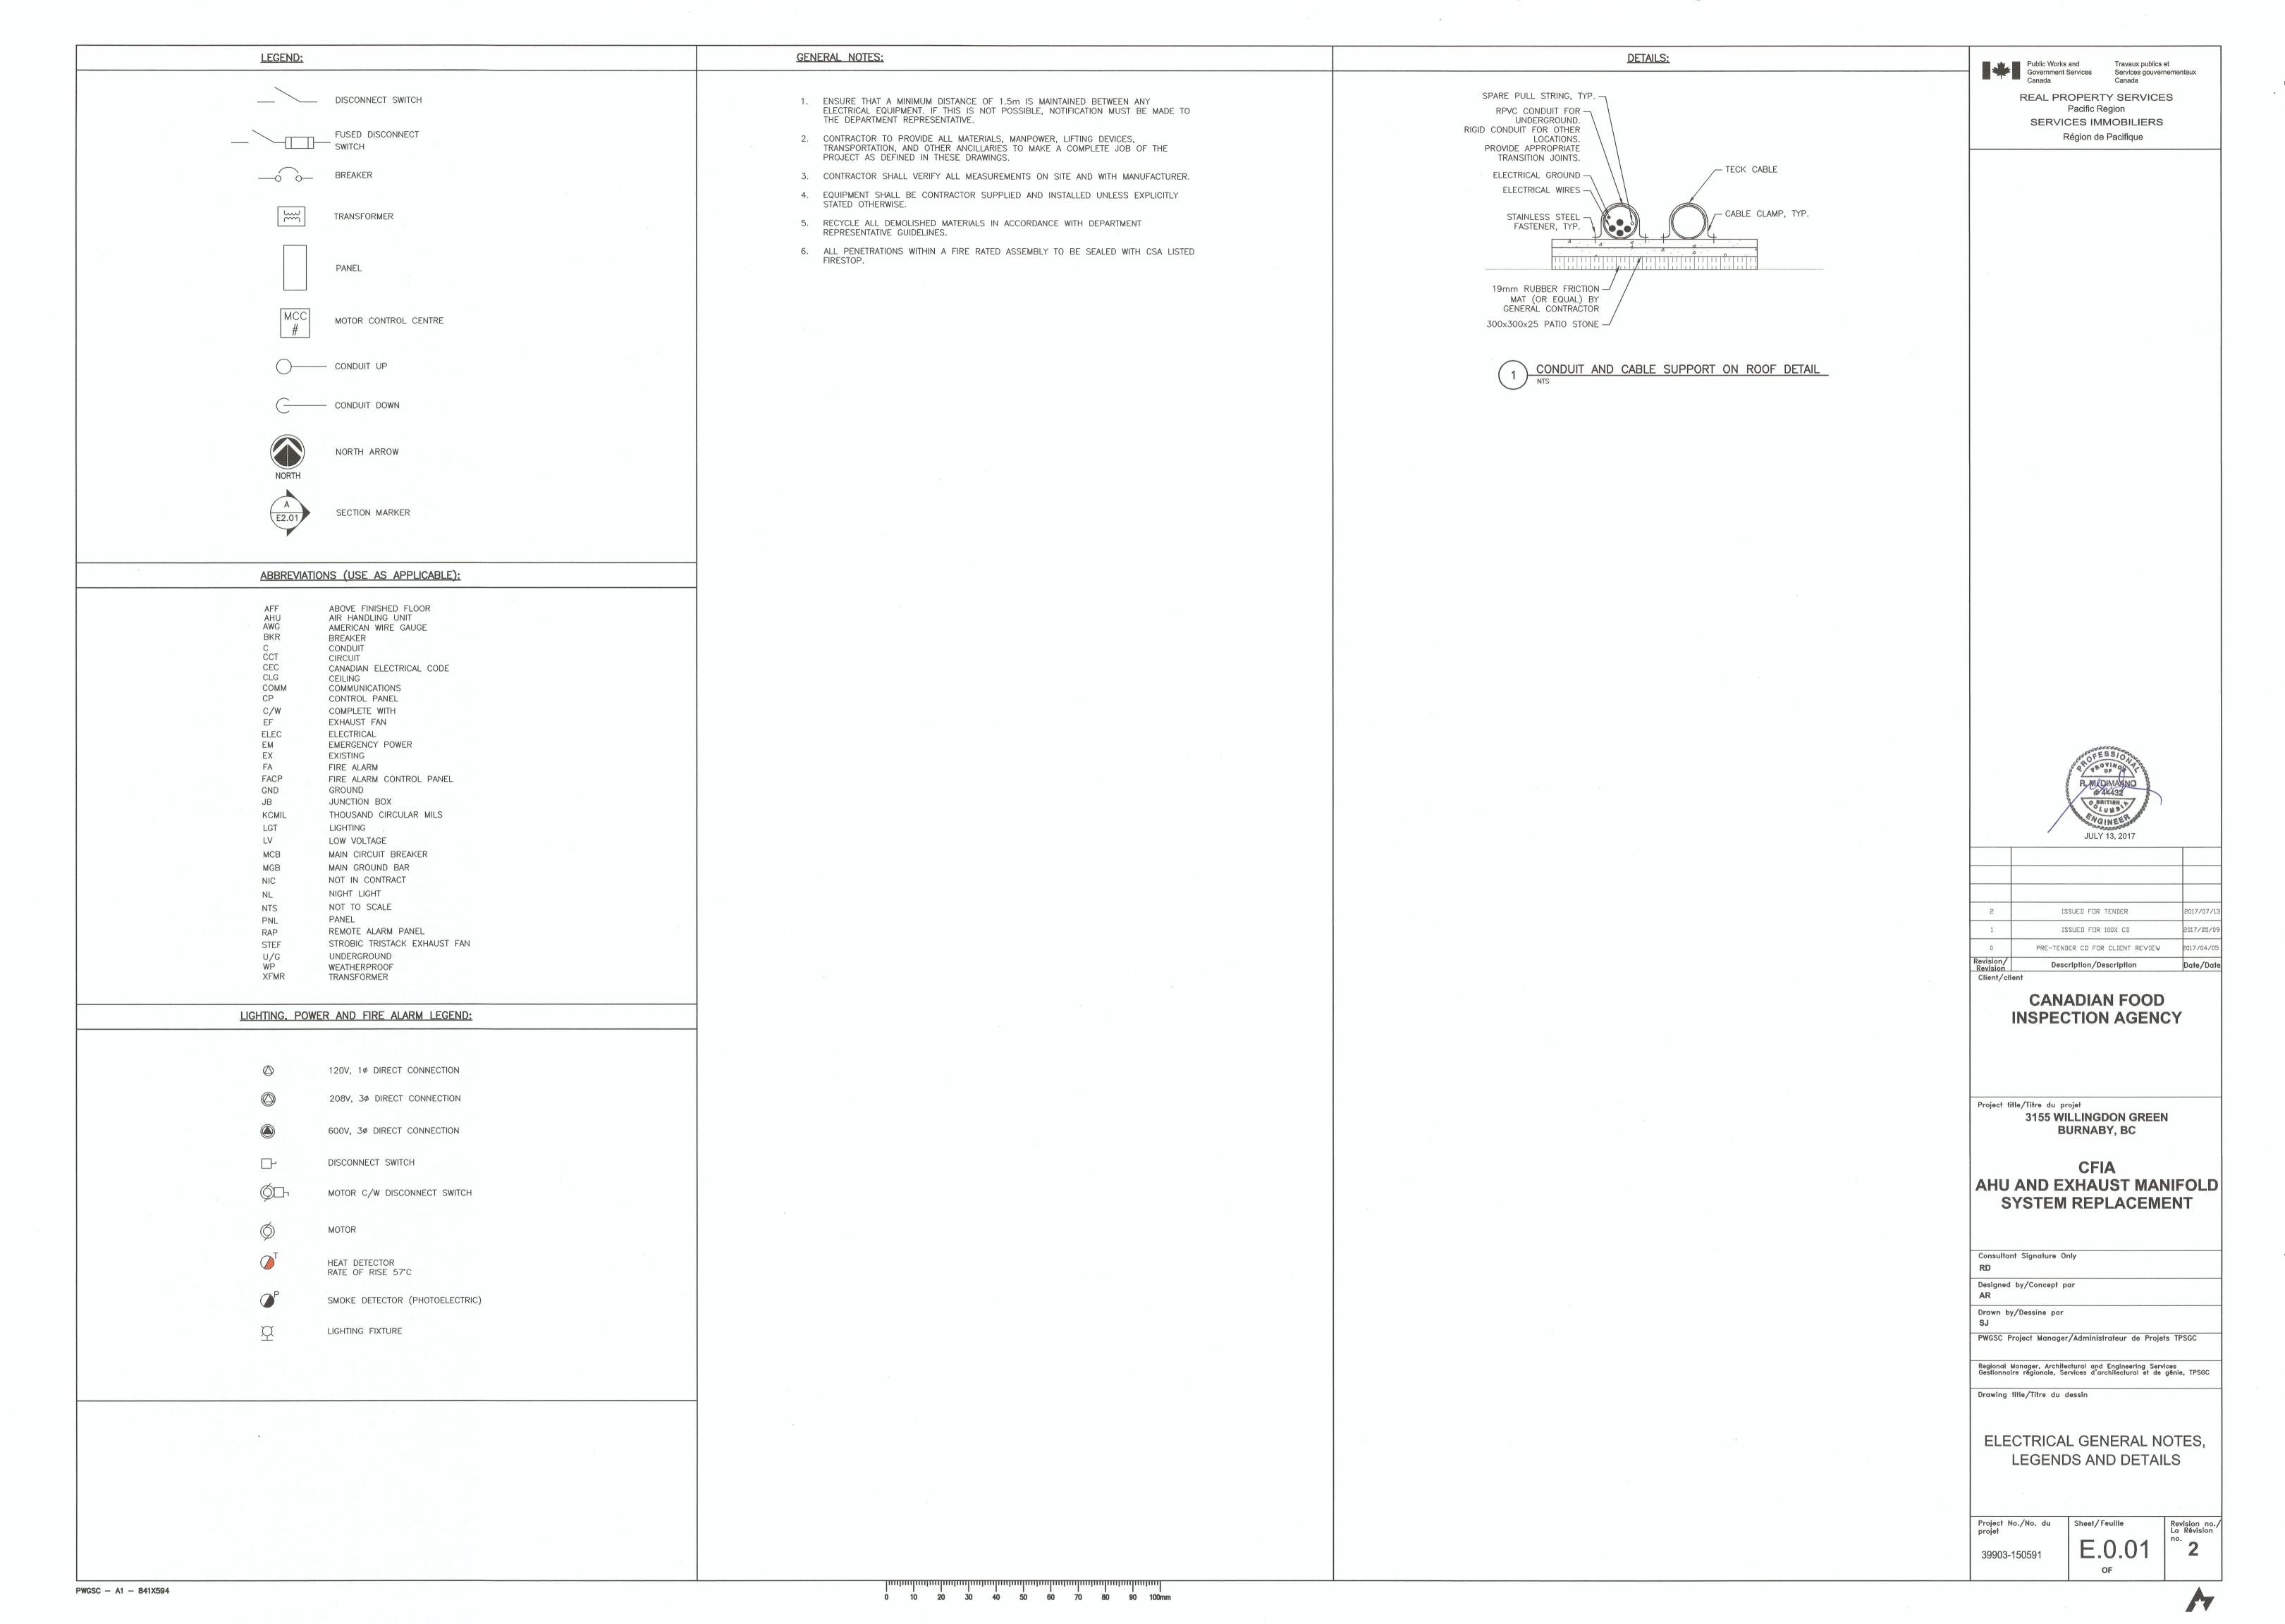


REFERENCE NOTES Public Works and Government Services Services gouvernementaux Canada 1) EXISTING AHUS AND PUMPS LISTED WILL BE REMOVED.
DISCONNECT THE FEEDERS TO THE EQUIPMENT IDENTIFIED, PULL
BACK WIRES TO THE SOURCE, REMOVE EMPTY CONDUITS AND REAL PROPERTY SERVICES LABEL BREAKERS FEEDING THE EQUIPMENT AS 'SPARE'. Pacific Region SERVICES IMMOBILIERS 2 EXISTING PANEL 2D40 TO BE REMOVED AND REPLACED.
DISCONNECT THE FEEDERS TO THE EQUIPMENT IDENTIFIED AND Région de Pacifique REMOVE THE EXISTING PANEL AND FEEDER FROM PANEL 2D4.


NEW PANEL 2D40 TO BE INSTALLED IN SAME LOCATION. REFER

TO DWG. E.1.02 FOR EXACT LOCATION AND DETAILS. 3 EXISTING HUMIDIFIERS FOR AHU-101 AND AHU-102 WILL BE REMOVED. DISCONNECT THE FEEDERS TO THE EQUIPMENT IDENTIFIED, PULL BACK WIRES TO THE SOURCE, REMOVE EMPTY CONDUITS AND LABEL BREAKERS FEEDING THE EQUIPMENT AS EXISTING CONCRETE WALK WAY STAIR NO. 3 ----B C # 44432 D (3) TYP. JULY 13, 2017 1 TYP. COMPRESSOR ISSUED FOR TENDER (E)ISSUED FOR 100% CD 2017/05/09 MECHANICAL/ ELECTRICAL ROOM PRE-TENDER CD FOR CLIENT REVIEW Revision/ Revision Client/client Description/Description Date/Date REFER TO MECHANICAL DEMOLITION DEAWINGS FOR DEMOLITION IN UNITS EXISITNG PNL **CANADIAN FOOD** F **INSPECTION AGENCY**  $\left(\mathbf{G}\right)$ DN Project title/Titre du projet TRANSFORMER ROOM 3155 WILLINGDON GREEN (138A) **BURNABY, BC CFIA** (H)AHU AND EXHAUST MANIFOLD SYSTEM REPLACEMENT EXISITNG AHU-101 FREIGHT EXISITNG AHU-102 EXISITNG AHU-103 ELEV. EXISITNG P-105 P-106 EXISITING P-109 EXISITNG P-107 P-108 Consultant Signature Only Designed by/Concept par STAIR NO. 4 Drawn by/Dessine par PWGSC Project Manager/Administrateur de Projets TPSGC Regional Manager, Architectural and Engineering Services Gestionnaire régionale, Services d'architectural et de génie, TPSGC (12) (10) (14) (11) (13) (15) (16) (9) Drawing title/Titre du dessin **GROUND FLOOR** DEMOLITION LAYOUT GROUND FLOOR DEMOLITION LAYOUT
SCALE 1: 100 Project No./No. du projet Revision no., La Révision 39903-150591 OF PWGSC - A1 - 841X594

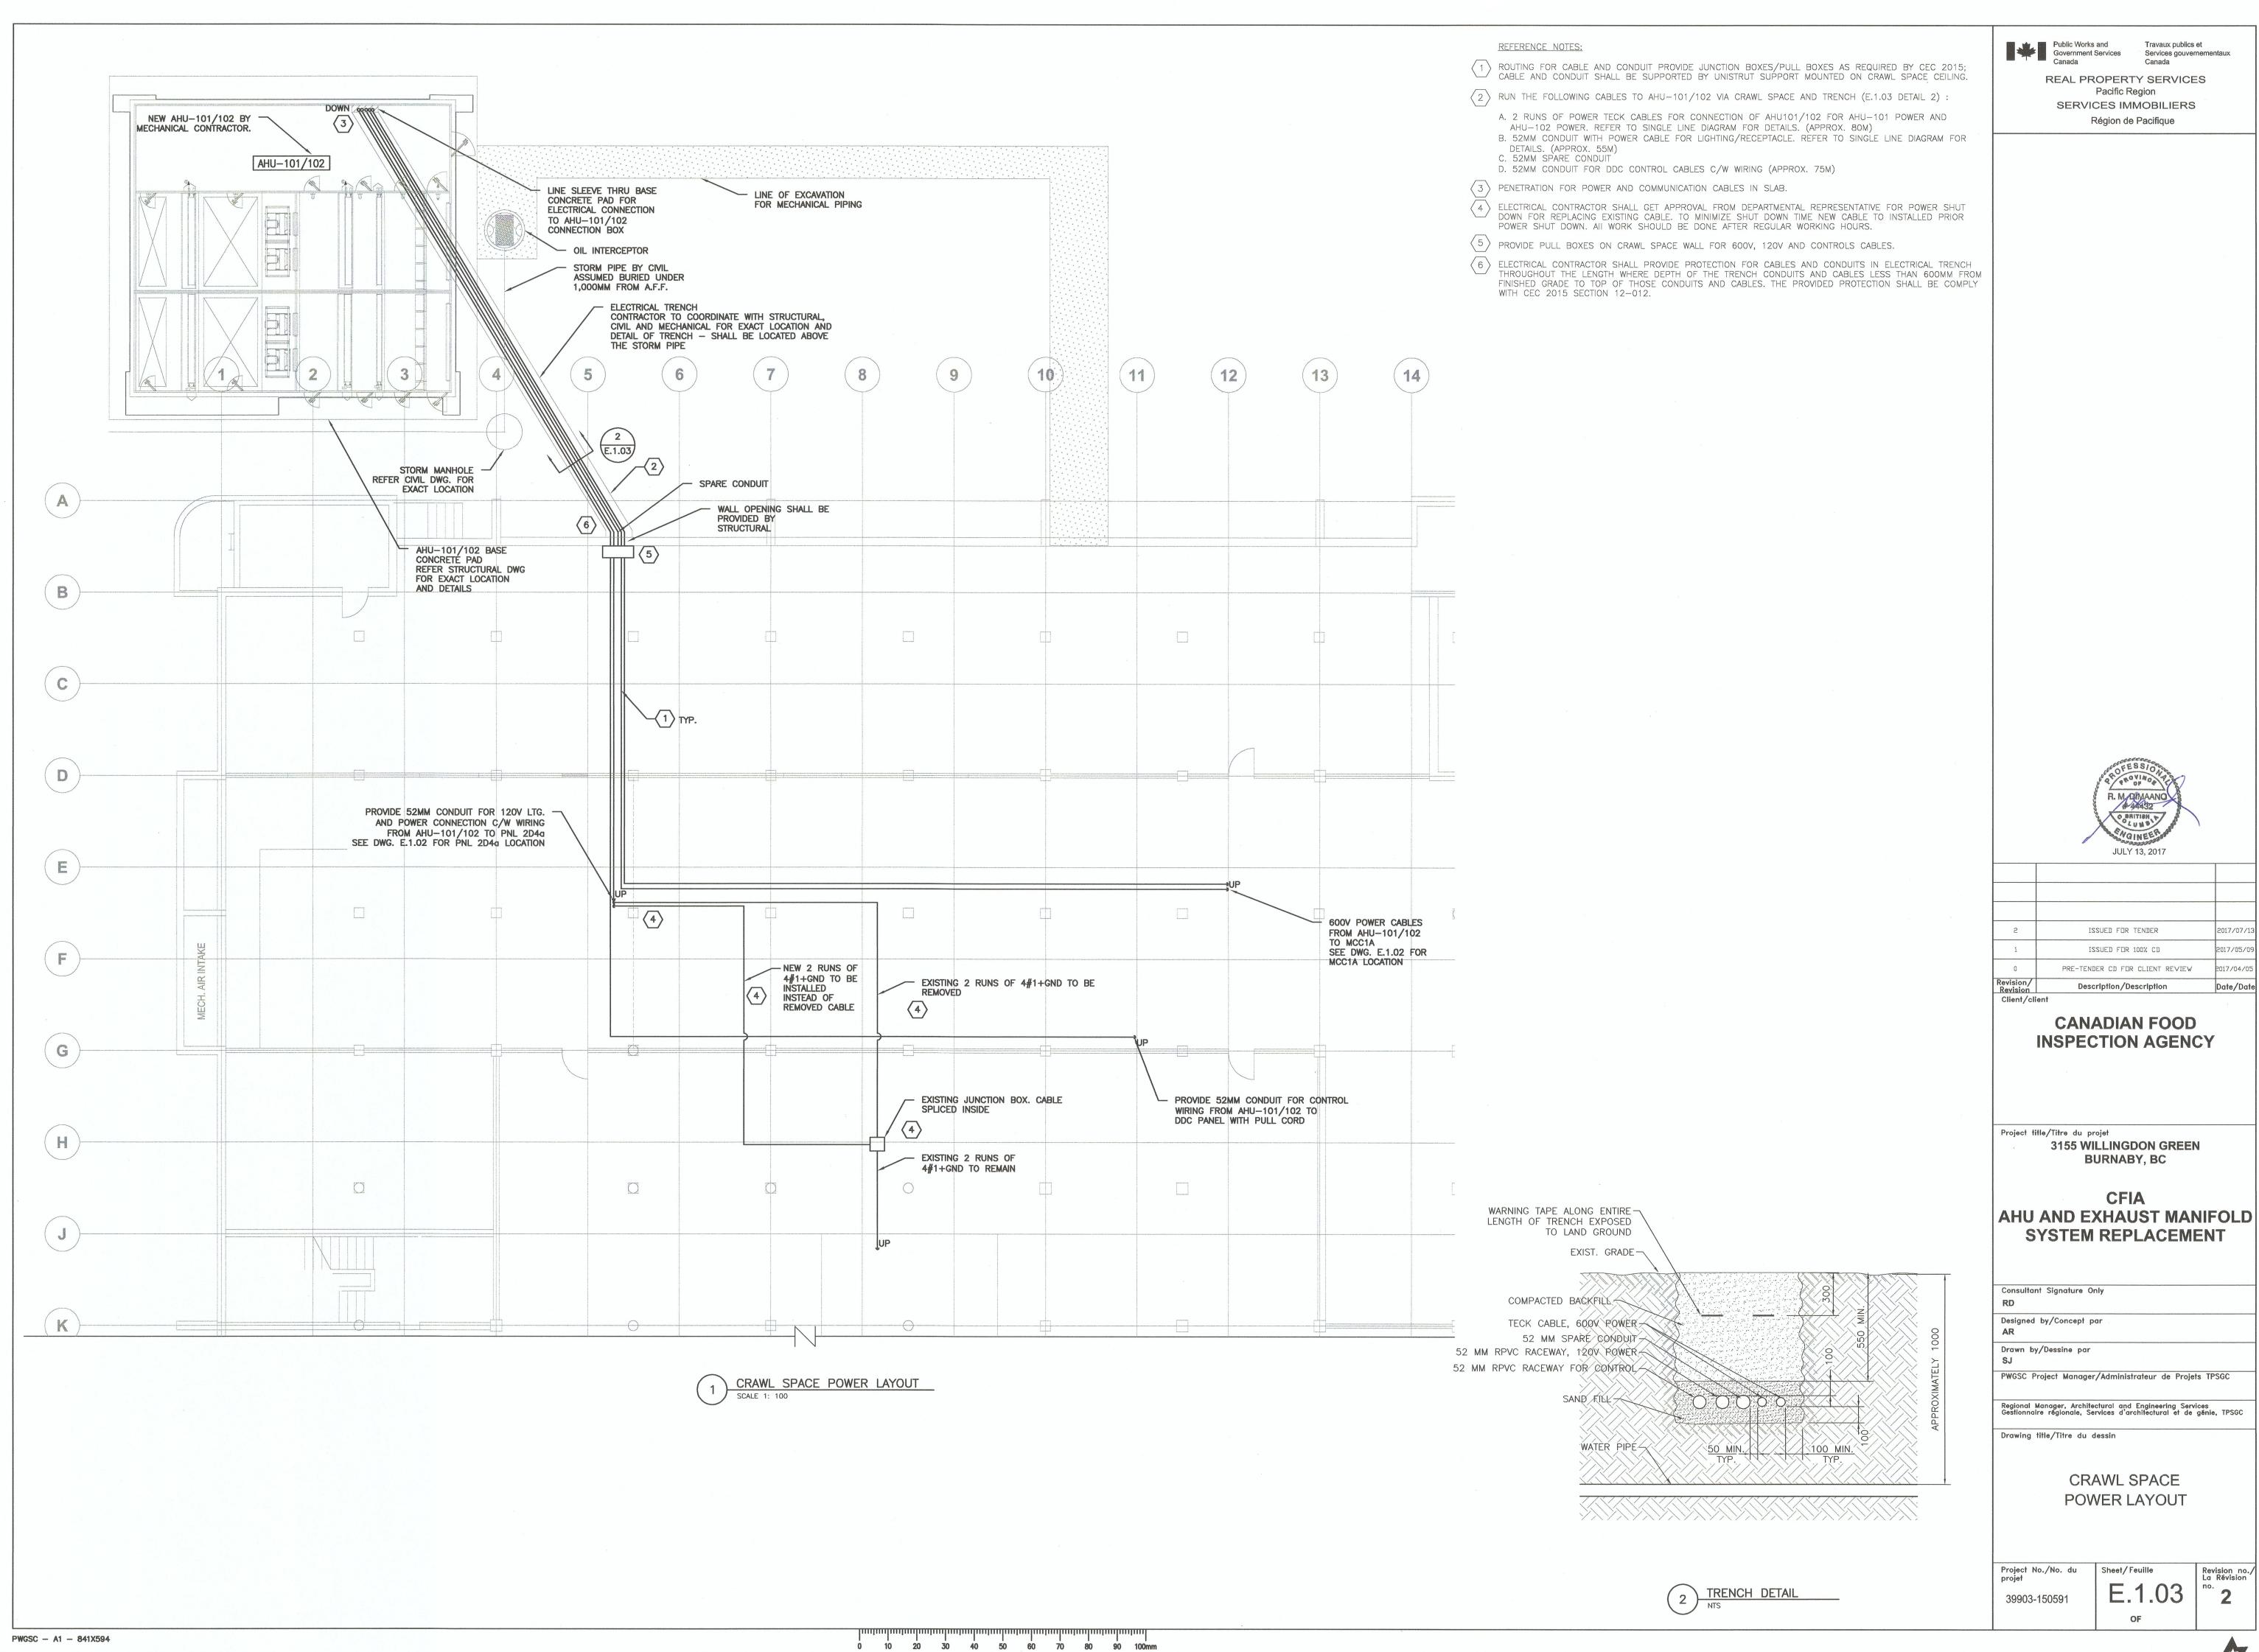

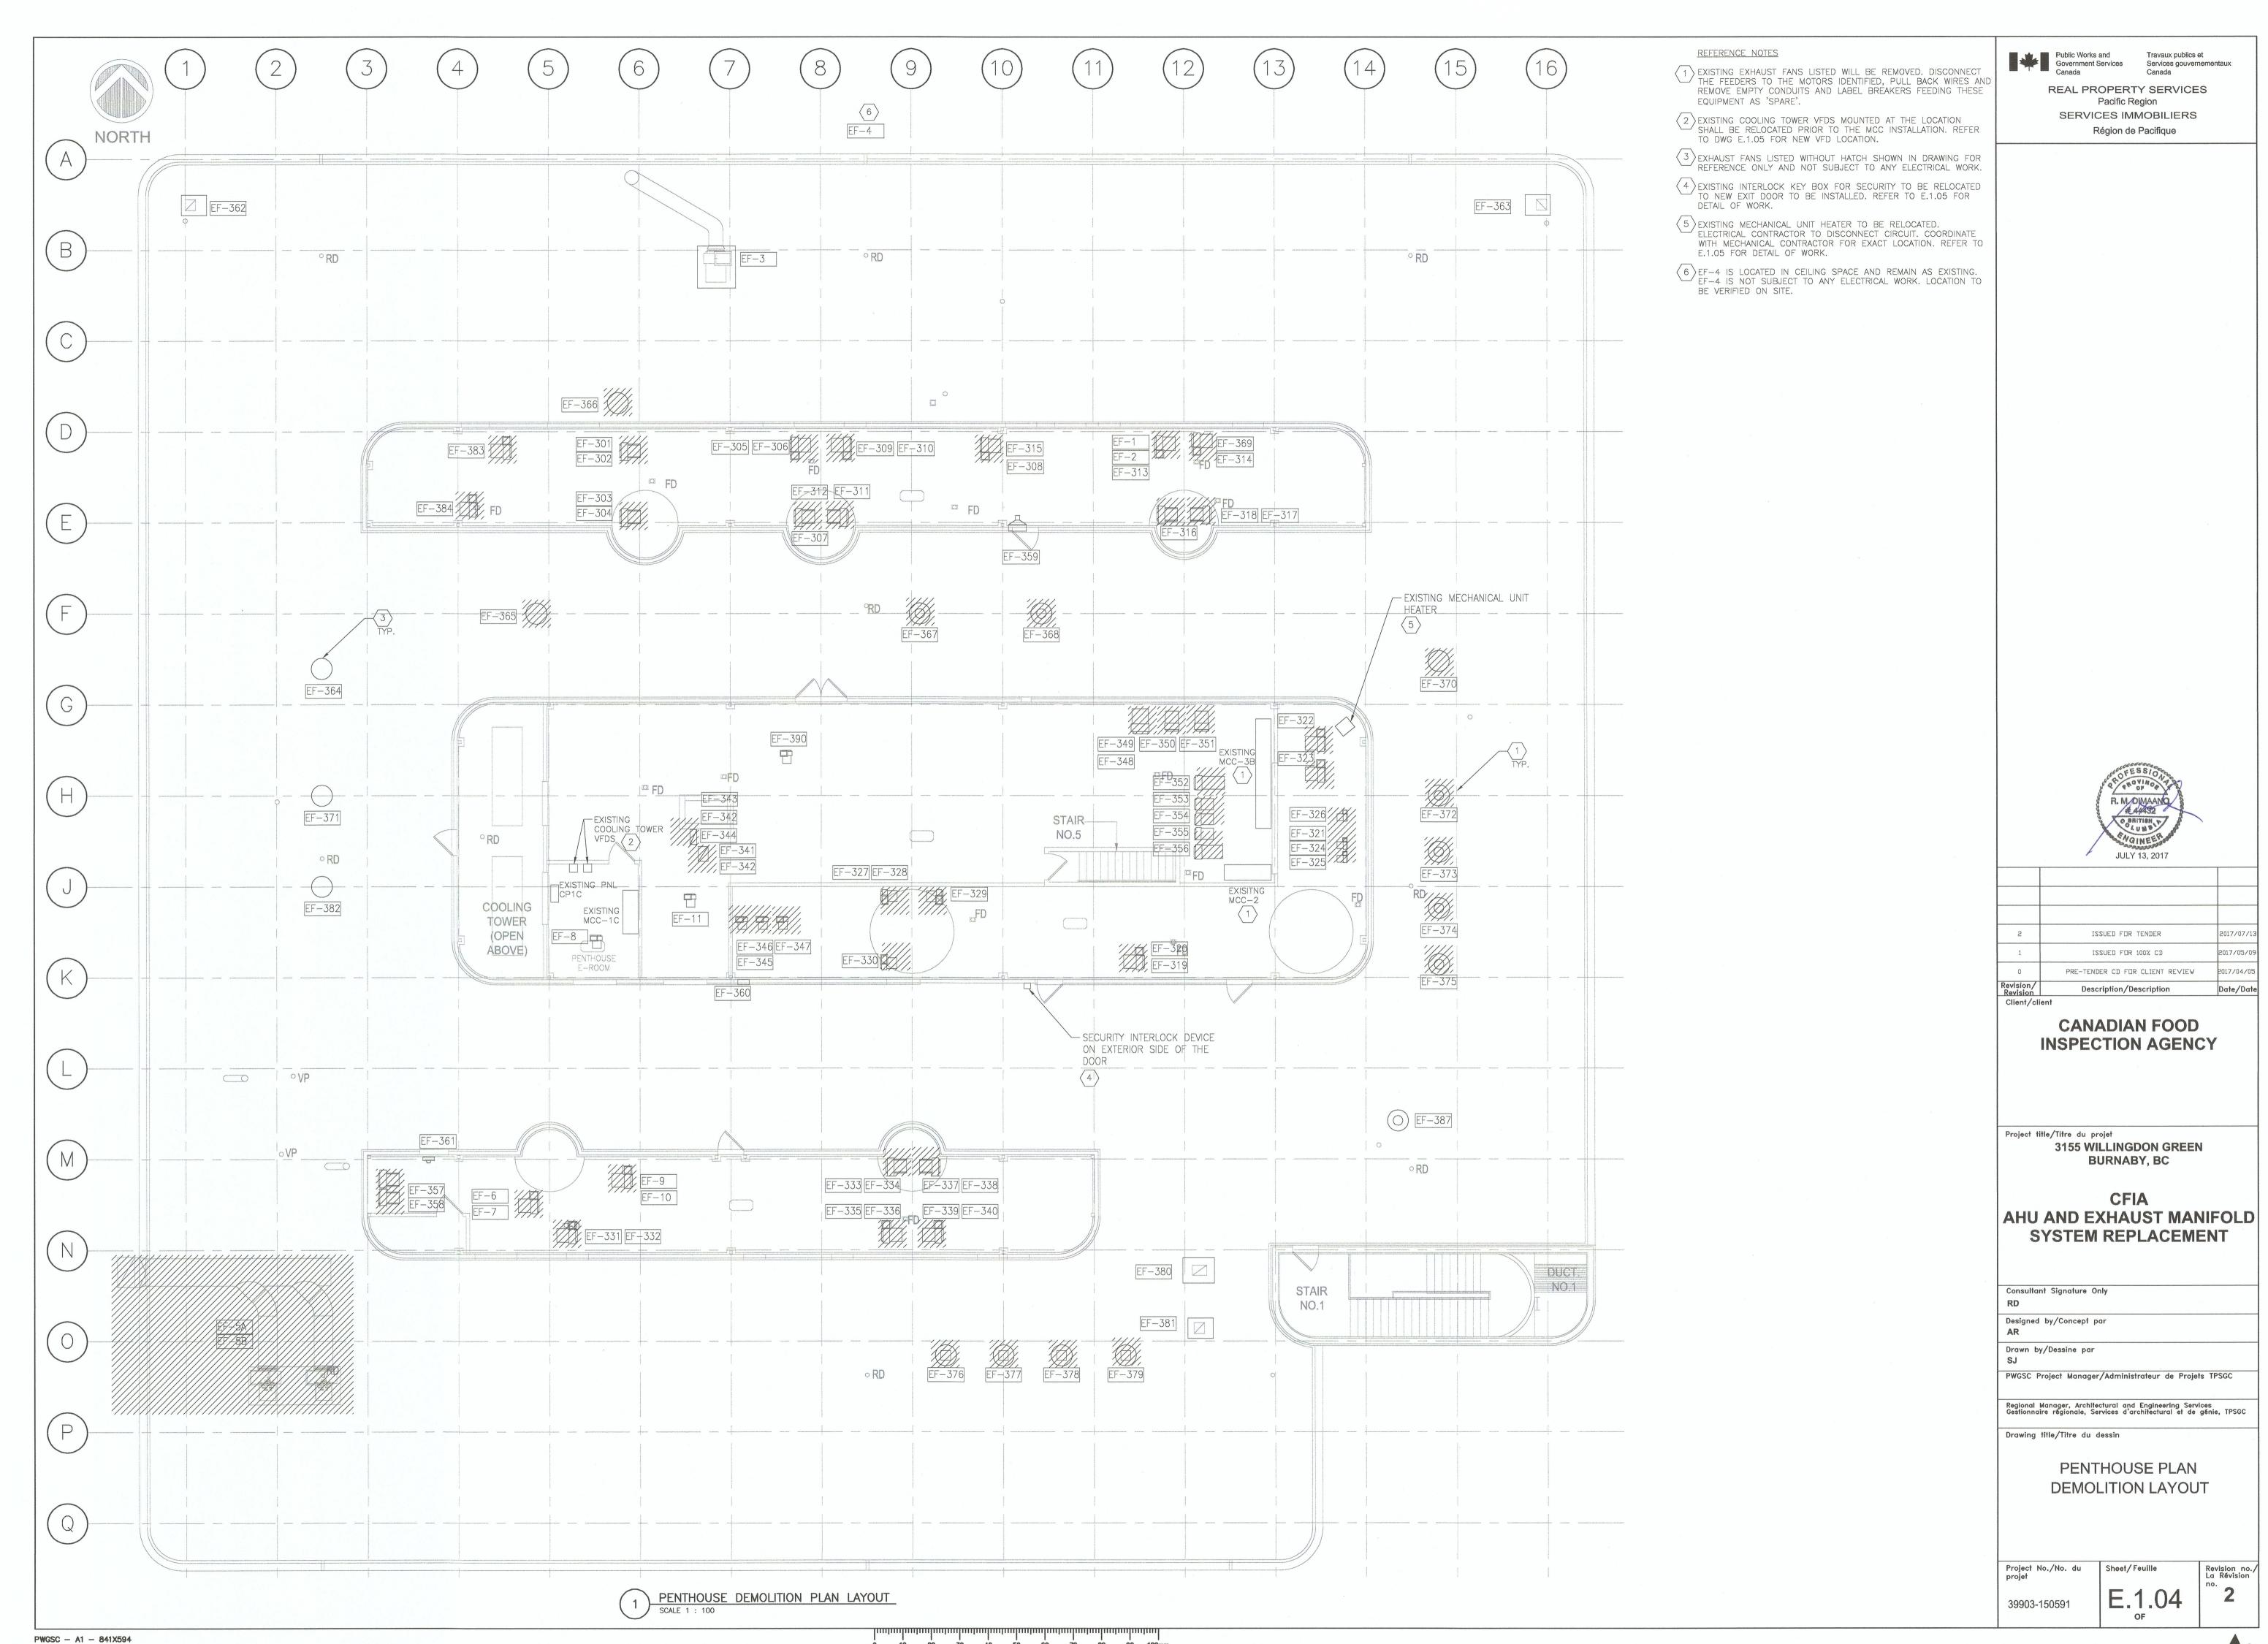

A

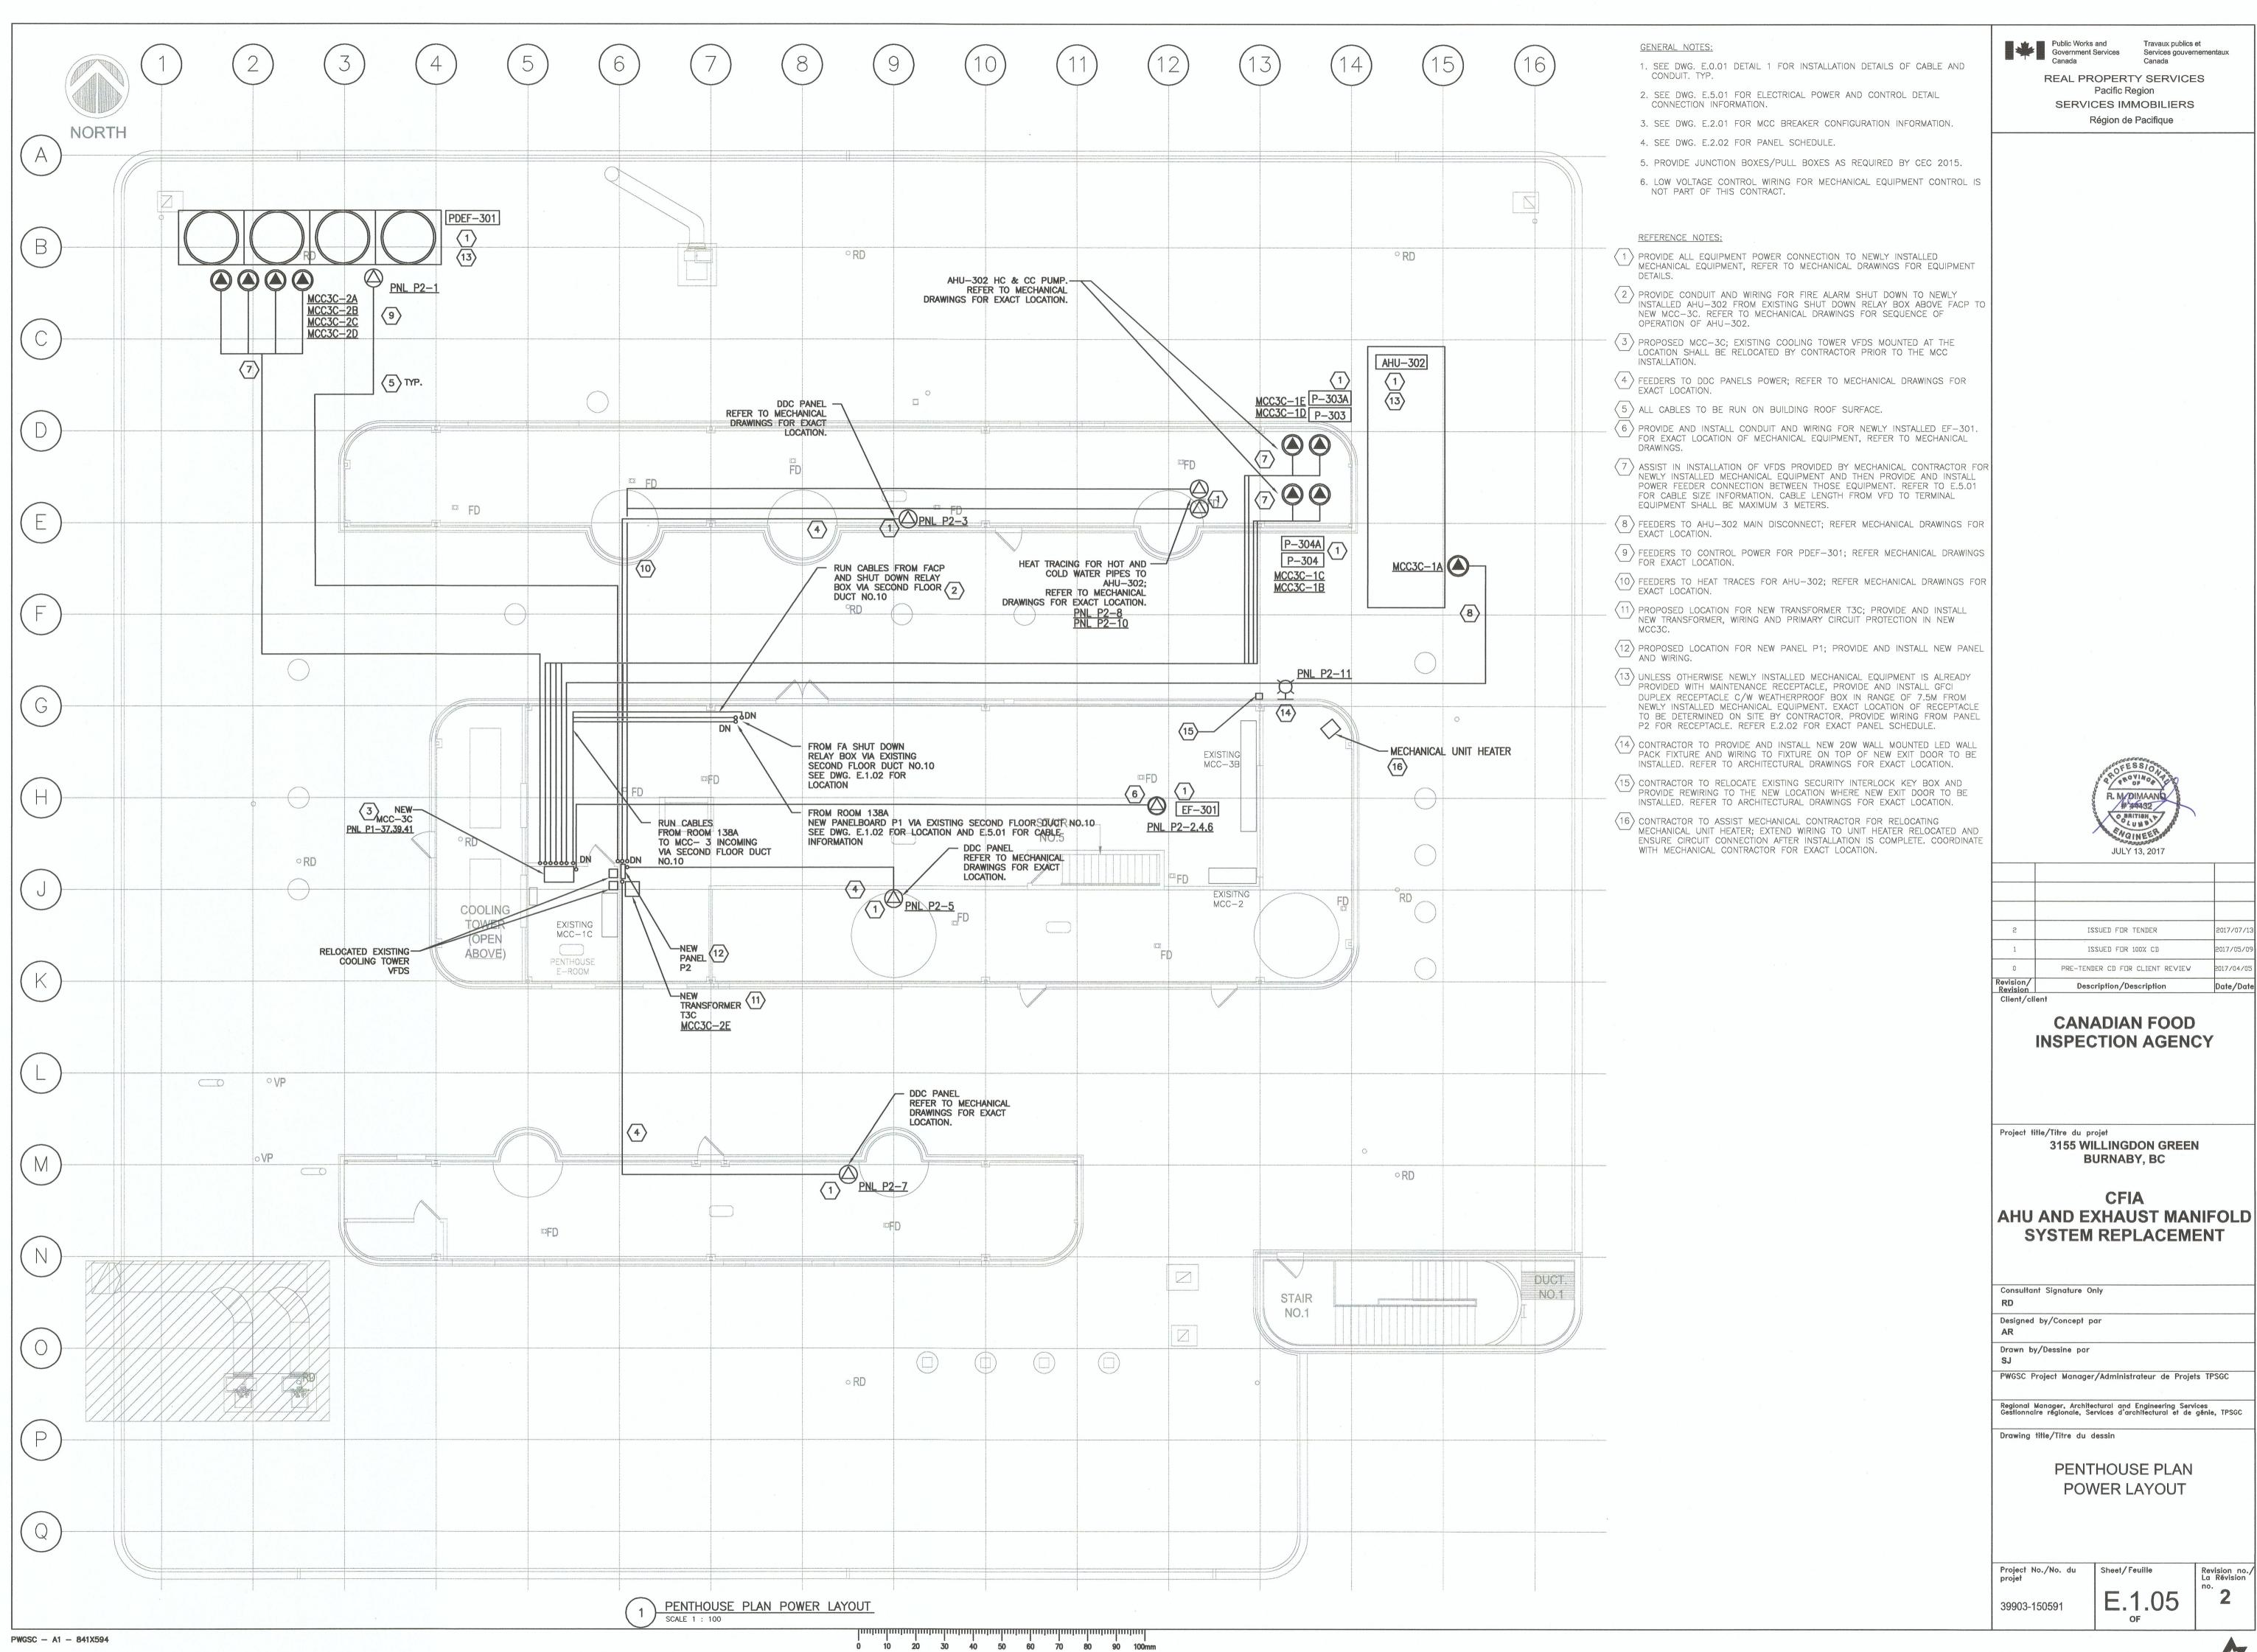

Public Works and Government Services Canada

Public Works and Services Gouvernementaux Canada MCC- 1A, 600A, 600V MCC- 1A, 600A, 600V MCC- 3C, 600A, 600V REAL PROPERTY SERVICES Pacific Region CHILLED W PUMP P-101 CHILLED W PUMP VACUUM UNIT VACUUM UNIT \*\* PDEF-301 SERVICES IMMOBILIERS \*\* AHU-302 CHILLER CH-101 CHILLER CH-101 PURE HUMIDIFIER PURE HUMIDIFIER Région de Pacifique \* 1ST FLOOR AHU-103 CHILLED W PUMP P-102 CHILLED W PUMP P-102 SPARE \*\* PDEF-301 \*\* P-304 CONDENSER W PUMP P-103 CONDENSER W PUMP \* RAF-103 SPARE \* AHU-101 P-103 HAZARD STORAGE AHU-104 HAZARD STORAGE AHU-104 \*\* AHU-102 CONDENSER W PUMP P-104 \* PREHEAT PUMP P-109 \*\* P-105 CONDENSER W PUMP \*\* PDEF-301 \* UNLABELLED \*\* P-304A 40HP \*\* P-110 5HP \* PREHEAT PUMP P-105 \*\* P-105A \* UNLABELLED \* UNLABELLED CHILLER CH-102 CHILLER CH-102 \*\* PDEF-301 \*\* P-303 \* PREHEAT PUMP \*\* P-110A 40HP SPARE \* EF-001 UNLABELLED UNLABELLED P-106 \* HOT DECK PUMP P-107 LAB COMPRESSOR 102 LAB COMPRESSOR 102 \* LAB AHU-102 SF-002 SF-002 SPARE \*\* TRANSFORMER T3C \*\* P-303A 15KVA \*\* P-111A 7.5HP \* HOT DECK PUMP \*\* P-107 15 HP UNLABELLED P-108 LAB AIR COMPRESSOR LAB AIR COMPRESSOR SPARRE \*\* AHU-101 GA-101 INCOMING SPARE TRANSFORMER RM SUPPLY SF-001 WATER COOLER CU-101 TRANSFORMER RM SUPPLY SF-001 WATER COOLER CU-101 1 EXISITNG MCC 1A - ELEVATION PROPOSED MCC 1A - ELEVATION REMAIN AT EXISTING CONFIGURATION AND LOCATION MCC- 3B, 600A, 120/208V, 3PH MCC- 3A, 600A, 600V, 3PH (5) MCC- 3B, 600A, 120/208V, 3PH ( 1 ) GENERAL NOTES 1. \* : EQUIPMENT SCHEDULED TO BE REMOVED. DISCONNECT THE P-302 \* EF-335 FEEDERS TO THE MOTORS IDENTIFIED, PULL BACK WIRES AND SF-304 \* EF-316 FDS-60A FDS-60A PUMP 4 REMOVE EMPTY CONDUITS. RE-LABEL UNUSED BREAKERS IN ALL LISTED MCCs AS 'SPARE' BR-R PANEL CB 200A P-310 PANEL 2. \*\* : EQUIPMENT SCHEDULED TO BE NEWLY ADDED. PROVIDE POWER CONNECTION AND RE-LABEL UTILIZED BREAKERS IN ALL LISTED  $\langle 3 \rangle$ \* EF-306 \* EF-317 \* EF-329 \* EF-338 SF-301 SF-301 CONTROLS CONTROLS P-311 3. DISCONNECT FANS EF-311, EF-319, EF-320, EF-349 AND EF-369; PULL BACK WIRES AND REMOVE EMPTY CONDUITS. LAB AHU AHU-301 P-303 \*\* AHU-103 PUMP 3 \* EF-339 \* EF-307 \* EF-318 \* EF-331 SPARE R. M. DIMAANIQ REFERENCE NOTES P-304 CONTROLS CONTROLS 1) PROVIDE CLEAN UP AND REMOVAL OF UNUSED SECTION OR COMPARTMENT OF MCC-3B. SF-303 \* EF-313 \* EF-323 \* EF-332 \* EF-340 SF-303 DISCONNECT COMPANY INDICATION DESCRIBING 3KW HEATER CT-301 FOR: EF-343, EF-356, EF-357, EF-358, EF-363, EF-374, EF-375, EF-377, EF-379, EF-382, EF-370 AND EF-380. SWITCH DISCONNECT COMPARTMENT CONNECTIONS AS REFERENCE NOTE \* INDICATION DESCRIBING \* EF-352 \* EF-314 \* EF-325 \* EF-333 \* EF-342 SF-304 FOR: EF-350, EF-359, EF-362, EF-364, EF-346, EF-353, EF-355, EF-371, EF-348, EF-360, EF-361, EF-381 AND EF-341. ISSUED FOR TENDER STARTER P-308 STARTER COMPARTMENT COMPARTMENT ISSUED FOR 100% CD 4 DISCONNECT COMPARTMENT CONNECTIONS AS REFERENCE NOTE \* EF-302 \* EF-315 \* EF-327 \* EF-334 \* EF-344 EF-302 PRE-TENDER CD FOR CLIENT REVIEW INDICATION DESCRIBING FOR: EF-345, EF-351, EF-373, EF-376, EF-378, EF-366, EF-367, EF-368, EF-372, EF-347 AND EF-365. P-301 HOV Date/Date Description/Description Client/client  $\langle 5 \rangle$  existing MCC-3A shall be remained without relocation. **CANADIAN FOOD** 6 PROVIDE CLEAN UP AND REMOVAL OF UNUSED SECTION OR COMPARTMENT OF MCC-2 AND ADJUST PATH OF POWER INCOMING TO **INSPECTION AGENCY** 4 EXISITNG MCC 3A & 3B - ELEVATION PROPOSED MCC 3B - ELEVATION (7) COORDINATE REQUIRED SHUTDOWN WITH DEPARTMENTAL REPRESENTATIVE PRIOR TO DISCONNECT FOR RELOCATION. EXISTING PNL 2D1 Project title/Titre du projet 3155 WILLINGDON GREEN MCC- 2, 600A, 208V MCC- 2, 600A, 208V 6 **BURNABY, BC** CIRCUIT BREAKER 60A \* EF-312 **CFIA** \* EF-383 SPARE \* EF-326 7 EXISTING XFMR COMPRESSOR 15 KVA TO BE RELOCATED NEW LOCATION FOR EXISTING AHU AND EXHAUST MANIFOLD COMPRESSOR XFMR 15 KVA ABOVE T2. SYSTEM REPLACEMENT \* EF-384 SPARE SPARE \* EF-330 SPARE CONTROLS CONTROLS Consultant Signature Only CONTRACTOR TO REINSTALL ELECTRICAL ROOM MAIN DOOR ACCESS TO DOOR OPEN TOWARD CIRCUIT BREAKER \* EF-305 SPARE \* EF-336 OUTSIDE OF ELECTRICAL ROOM INSTALLING SPARE 4 Designed by/Concept par NEW PANELBOARD P1. Drawn by/Dessine par NEW PANELBOARD P1 SPARE \* EF-308 \* EF-321 \* EF-337 REFER TO SINGLE LINE SPARE PWGSC Project Manager/Administrateur de Projets TPSGC DIAGRAM FOR DETAILS; INSTALL HEIGHT SHALL BE ADJUSTED TO MINIMIZE RELOCATION OF Regional Manager, Architectural and Engineering Services Gestionnaire régionale, Services d'architectural et de génie, TPSGC EXISTING EQUIPMENT. EXISTING XFMR T2 75 KVA RECOMMENDED MODEL: ECTRICAL RM SIEMENS P4 SERIES C/W 3P-800A EF-385 \* EF-309 \* EF-322 \* EF-354 EF-385 OOR ACCESS Drawing title/Titre du dessin MAIN BREAKER 1X3P-600A AND JLLY SWING 6XBREAKERS FOR HUMIDIFIER. MANUAL STARTER MANUAL STARTER DIMENSION (75x32x10 INCH) OR SPACE MCC AND E-ROOM APPROVED EQUAL. EXISTING XFMR T3 150 KVA **ELEVATION** EF-301 \* EF-310 \* EF-324 \* EF-328 EF-301 SPACE SPACE EXISTING FIRE EXTINGUISHER TO BE RELOCATED SEE DWG. E.1.02 FOR NEW LOCATION EXISTING SQUARE BOX AND -Project No./No. du projet Revision no La Révision Sheet / Feuille RECEPTACLE STAY IN EXISTING PROPOSED MCC 2 - ELEVATION 8 TRNASFORMER ROOM 138A EAST WALL ELEVATION
E.1.02 NTS LOCATION 39903-150591 0 10 20 30 40 50 60 70 80 90 100mm PWGSC - A1 - 841X594

	NEW PANEL	SCHEDULE	
	"F	P1" 00V, 3PH, 4W	
1	80A	A08	2
HUMIDIFIER HU-101		HUMIDIFIER HU-102	4
5			6
7 HUMIDIFIER HU-103	80A	80A HUMIDIFIER HU-104 (FOR FUTURE)	8
9			10
11			12
13 SPARE	80A	SPACE	14
15		SPACE	16
17		SPACE	18
19 SPACE	0	SPACE	20
21 SPACE		SPACE	22
23 SPACE		SPACE	24
25 SPACE		SPACE	26
27 SPACE		SPACE	28
29 SPACE		SPACE	30
31 SPACE		SPACE	32
33 SPACE		SPACE	34
35 SPACE		SPACE	36
37 <sub>MCC 3C</sub>	600A	SPACE	38
39		SPACE	40
41		SPACE	42
	800A (		
	MAIN		
	A	Δ Δ B C	

			L SCHEDULE P2"	
			208V, 3PH, 4W	
1	PDEF-301 CONTROLS	15A	15A L CEF-301 NEW	2
3	AHU-302 DDC PNL #1 CONTROLS	15A		4
5	AHU-302 DDC PNL #2 CONTROLS	15A		6
7	AHU-302 DDC PNL #3 CONTROLS	15A	15A AHU-302 HEAT TRACE #1	8
9	ROOFTOP MAINTENANCE RECEPTACLE	15A	15A AHU-302 HEAT TRACE #2	10
11	EXTERIOR LIGHTING	15A	15A SPARE	12
13	SPARE	15A	15A SPARE	14
15	SPACE		SPACE	16
17	SPACE		SPACE	18
19	SPACE		SPACE	20
21	SPACE		SPACE	22
23	SPACE		SPACE	24
25	SPACE		SPACE	26
27	SPACE		SPACE	28
29	SPACE		SPACE	30
31	SPACE		SPACE	32
		Į A	B C	111

	N		NEL S "2D4a	SCHEDULE n"	
	100			V, 3PH, 4W	
1	AHU-101/102 DDC PNL CONTROLS	15A		15A AHU-101/102 LGT/OUTLET	2
3	AHU-101/102 HEAT TRACE #1	15A		15A SPARE	4
5	AHU-101/102 HEAT TRACE #2	15A		154	6
7	AHU-101/102 HEAT TRACE #3	25A		154	8
9	AHU-101/102 HEAT TRACE #4	20A		15A 1	(
11	SPARE	15A		15A 1 1 MIGRATED CIRCUIT FROM EXIST.	2
13	SPARE	15A		50A MIGRATED CIRCUIT FROM EXIST.	4
15	SPACE			1	(
17	SPACE			SPACE 1	8
19	SPACE			SPACE 2	2(
21	SPACE			SPACE 2	22
23	SPACE			SPACE 2	2
25	SPACE			SPACE 2	2(
27	SPACE		7	SPACE 2	28
29	SPACE			SPACE 3	3(
31	SPACE			SPACE 3	32
		2	A B	C C	

Public Works and Travaux publics et Services gouvernementaux Canada

REAL PROPERTY SERVICES Pacific Region SERVICES IMMOBILIERS Région de Pacifique



Revision/ Revision Client/clie	Description/Description	Date/[
0	PRE-TENDER CD FOR CLIENT REVIEW	2017/04
1	ISSUED FOR 100% CD	2017/05
2	ISSUED FOR TENDER	2017/07
¥ .		

**CANADIAN FOOD INSPECTION AGENCY** 

Project title/Titre du projet

3155 WILLINGDON GREEN BURNABY, BC

**CFIA** AHU AND EXHAUST MANIFOLD SYSTEM REPLACEMENT

Consultant Signature Only Designed by/Concept par

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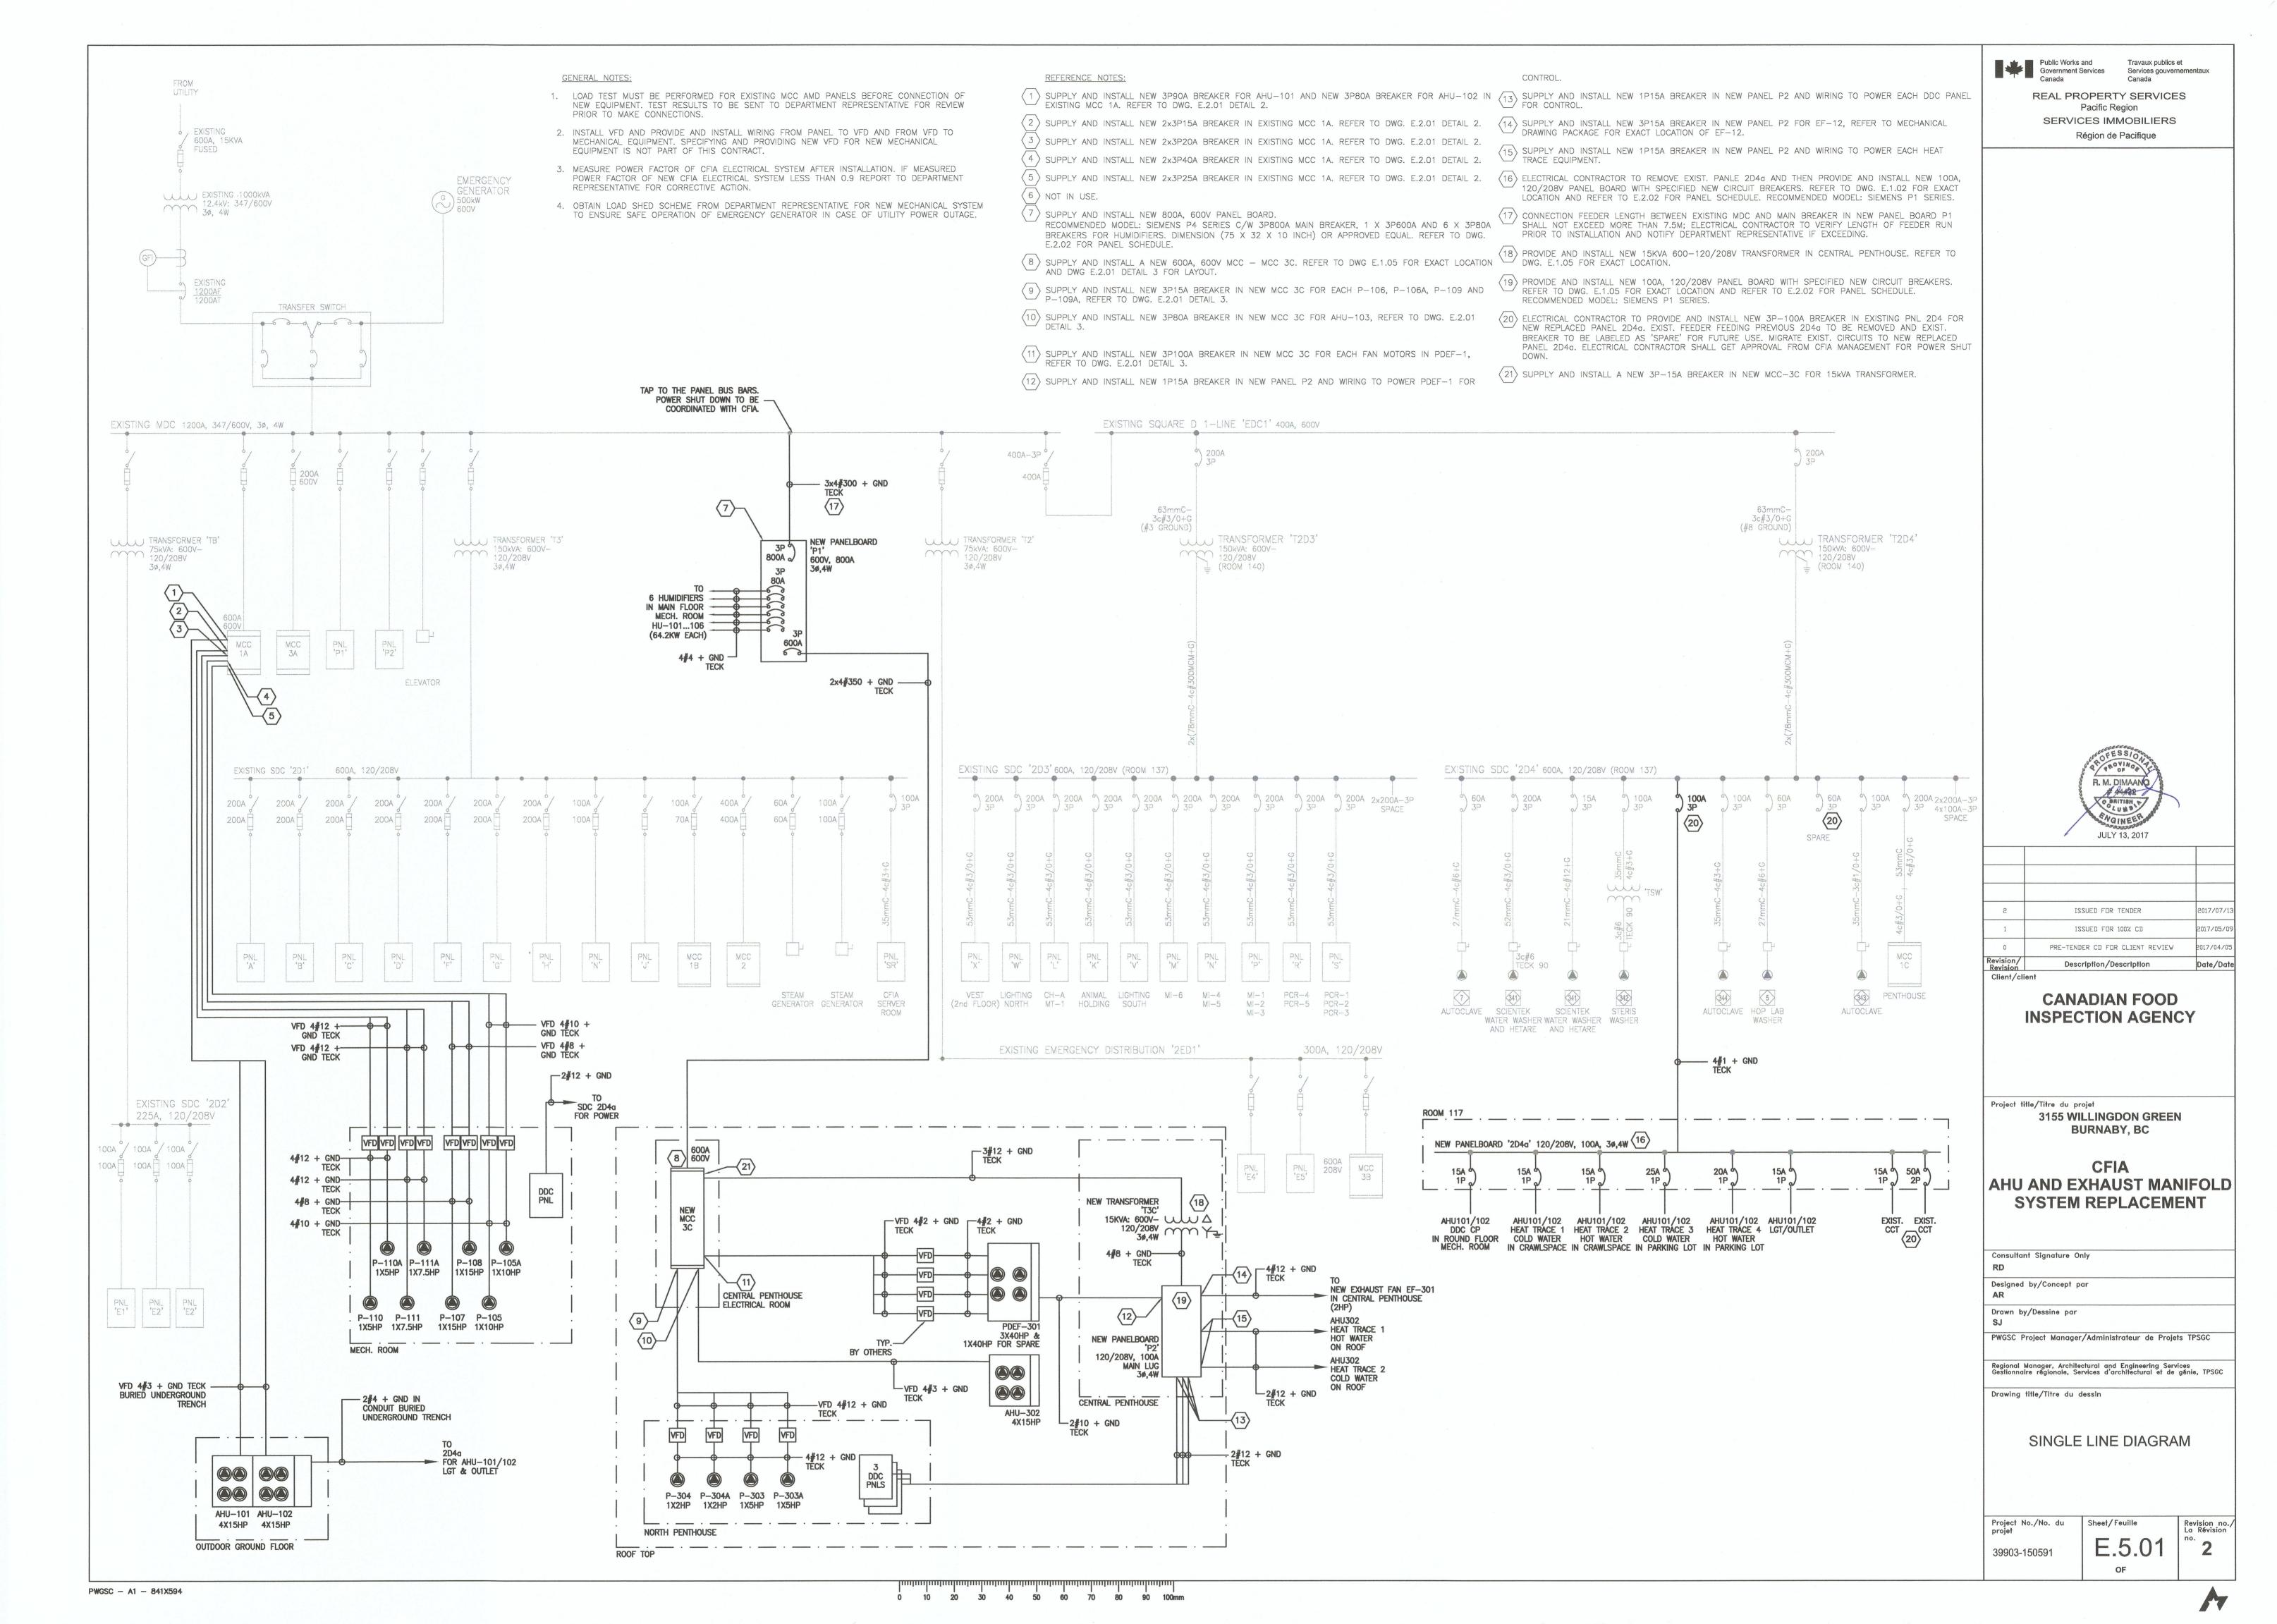
Drawn by/Dessine par


PWGSC Project Manager/Administrateur de Projets TPSGC

Regional Manager, Architectural and Engineering Services Gestionnaire régionale, Services d'architectural et de génie, TPSGC


Drawing title/Titre du dessin

PANEL SCHEDULE




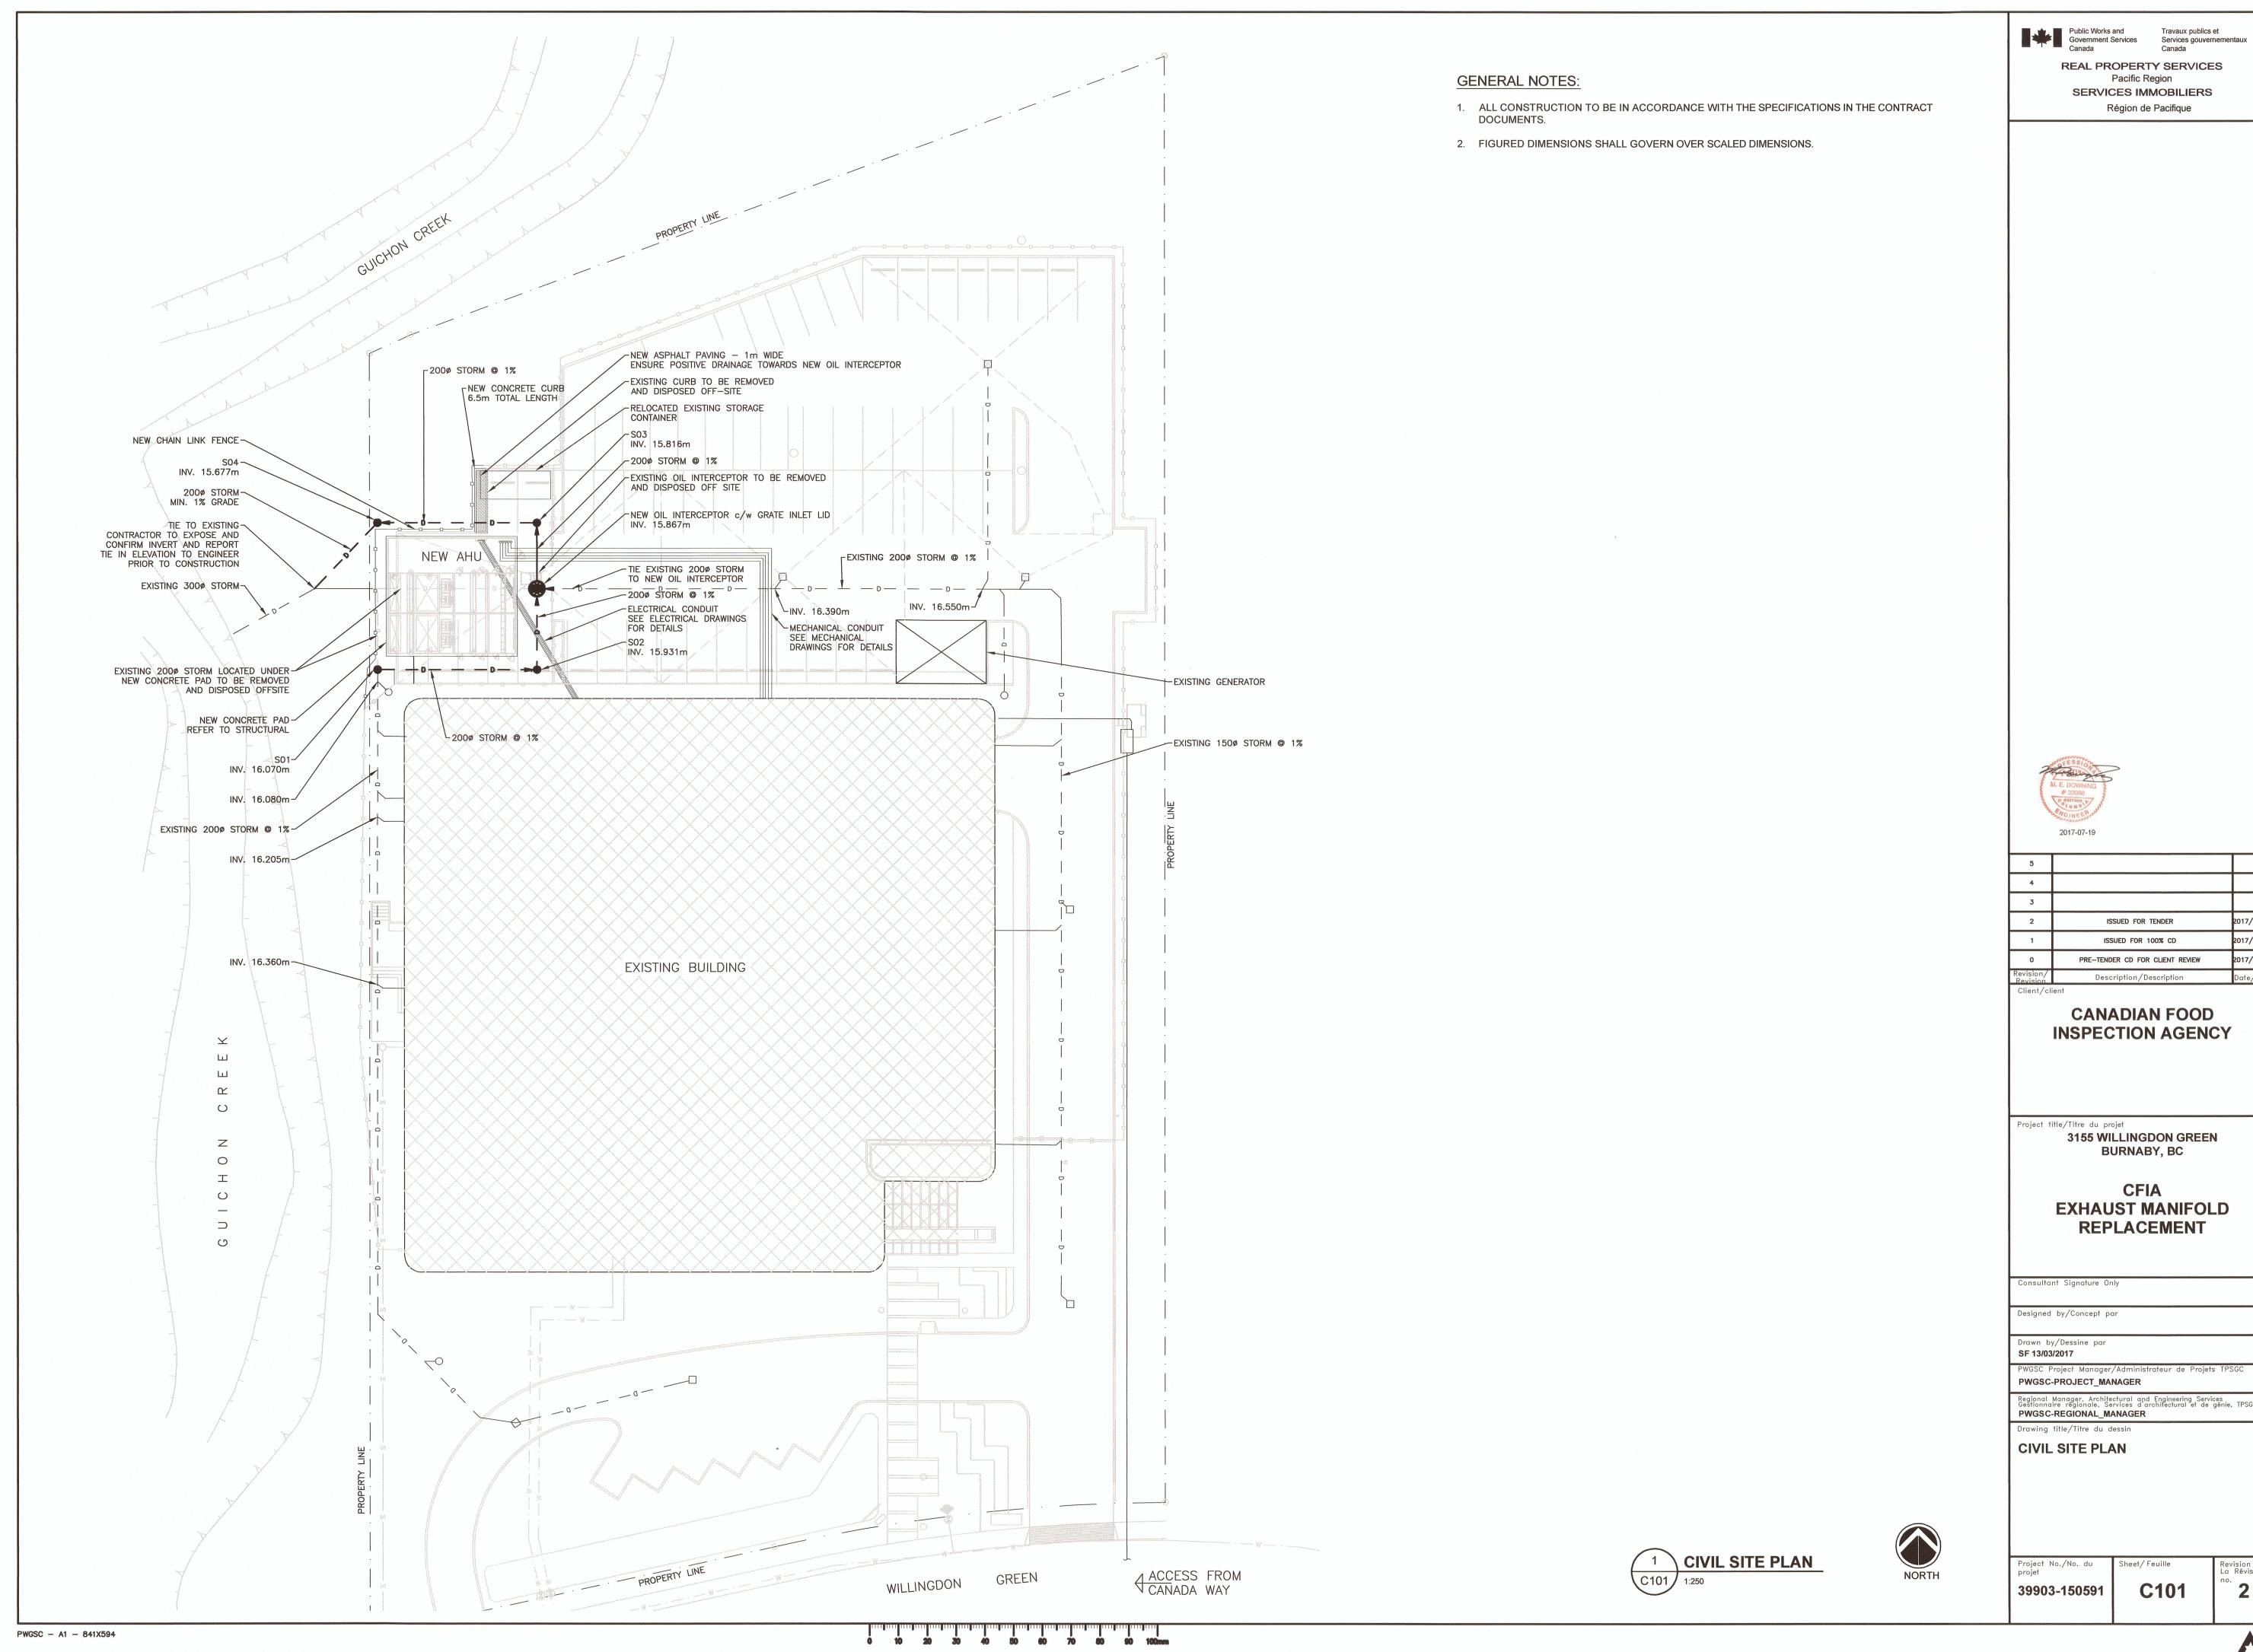

5				
4		197.9		
3				
2	ISSUED FOR TENDER	2017/07/1		
1	ISSUED FOR 100% CD	2017/05/0		
0	PRE-TENDER CD FOR CLIENT REVIEW	2017/03/3		
Revision/ Revision	Description/Description	Date/Dat		

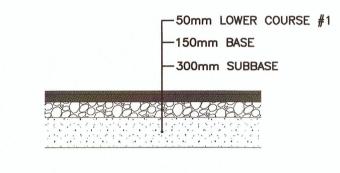


# **NEW PAVEMENT STRUCTURE**

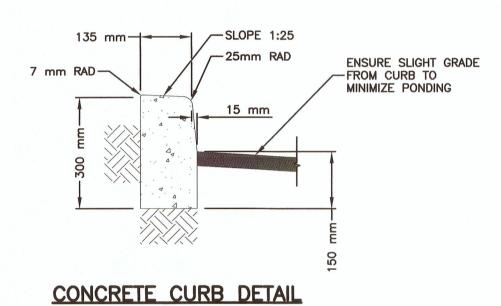

PRECAST CONCRETE RINGS OR BRICK FILLER RING, MORTAR IN AND OUT TO SUIT GRADE, ONE LAYER MANHOLE FRAME AND COVER MARKED 'STORM' MINIMUM, THREE LAYERS MAXIMUM PRECAST CONCRETE LIDS - REINFORCED TO H-20 HWY 150 640 PRECAST REINFORCED CONCRETE BARREL ENTRANCE TUBE AND LADDER TO BE PLACED OVER MAIN CHANNEL ON 1050mm MINIMUM UPSTREAM SIDE. RUNGS AT 300 o/c
CAST IN WALL OF BARREL
— SECTION. FIRST RUNG 1050 I.D. 500mm FROM FINISHED GRADE - JOINTS TO BE WATERTIGHT USE BITUMASTIC SEALANT BENCH TO CROWN OF HIGHEST PIPE GROUT ALL AROUND -150 -25 MPA CONCRETE BASE

GRANULAR BASE 150 200 WHERE MANHOLE BASE EXCAVATION EXTENDS BEYOND BASE DIMENSIONS THE OVEREXCAVATION SHALL BE FILLED WATERSTOPS IN MANHOLE -UNDISTURBED SOIL WITH CONCRETE 100mm BELOW THE WALL TO BE PROVIDED BOTTOM OF THE PIPE AND THE WIDTH FOR PVC PIPE. OF THE TRENCH. ALL POURED IN PLACE CONCRETE TO BE 25 MPA

TYPICAL MANHOLE DETAIL

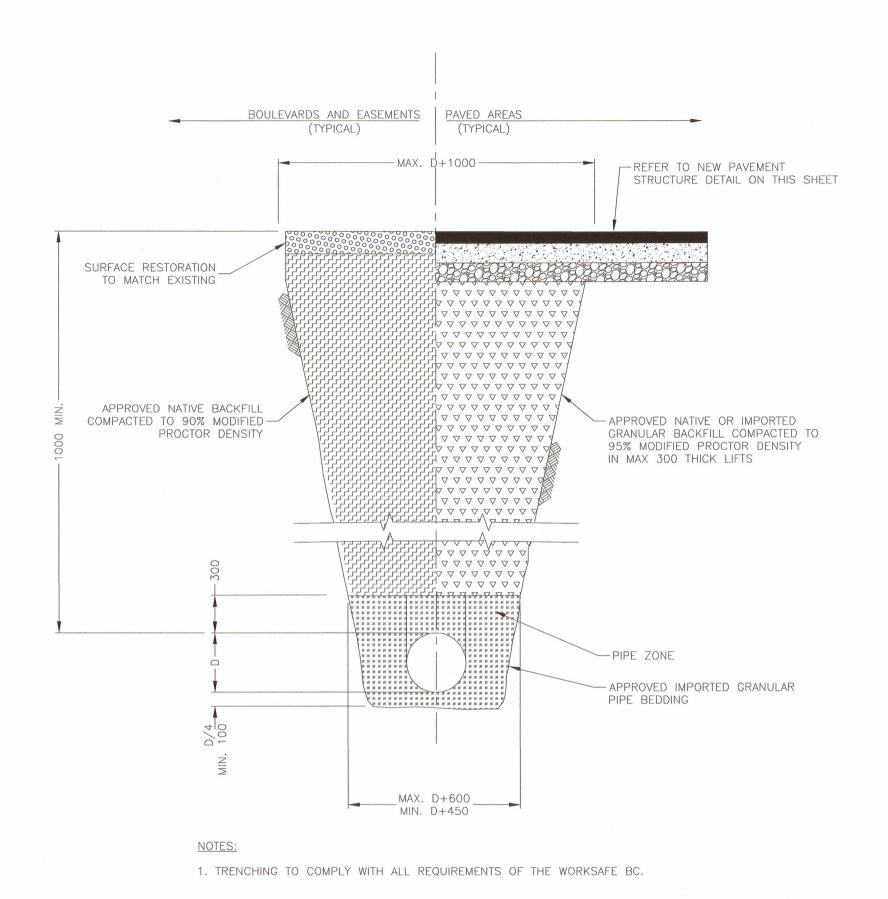

STORM SEWER TRENCH DETAIL



5		
4		
3		
2	ISSUED FOR TENDER	2017/07/1
1	ISSUED FOR 100% CD	2017/05/0
О	PRE-TENDER CD FOR CLIENT REVIEW	2017/03/3
Revision/ Revision	Description/Description	Date/Date
Client/cl	ent	

Public Works and Government Services Services gouvernementaux Canada

REAL PROPERTY SERVICES Pacific Region SERVICES IMMOBILIERS Région de Pacifique

#### **CANADIAN FOOD INSPECTION AGENCY**

Project title/Titre du projet

3155 WILLINGDON GREEN **BURNABY, BC** 

#### **CFIA EXHAUST MANIFOLD** REPLACEMENT

Consultant Signature Only

Designed by/Concept par

Drawn by/Dessine par

SF 13/03/2017

PWGSC Project Manager/Administrateur de Projets TPSGC PWGSC-PROJECT\_MANAGER

Regional Manager, Architectural and Engineering Services Gestionnaire régionale, Services d'architectural et de génie, TPSGC

PWGSC-REGIONAL\_MANAGER Drawing title/Titre du dessin

CIVIL CONSTRUCTION DETAILS

39903-150591

C102

0 10 20 30 40 50 60 70 80 90 100mm