

FUEL SYSTEMS LEGEND

— — FOV — — FUEL TANK VENT LINE - - FOF - - FUEL OIL FILL LINE - - FOS - - FUEL OIL SUPPLY LINE

— — FOR — — FUEL OIL RETURN LINE

MANUAL BALL VALVE

SIMPLEX STRAINER

PRESSURE RELIEF VALVE

CHECK VALVE

FLEX LINES

ELECTRIC PUMP

DUPLEX BASKET STRAINER

VENT WHISTLE

VENT CAP

CONCENTRIC REDUCER/INCREASER

LEVEL GAUGE

HIGH LEVEL FLOAT

4-POSITION FLOAT

LEVEL SENSOR

ELECTRICAL/CONTROLS LEGEND

TERMINAL BLOCK CONNECTION

SCREW TERMINAL BLOCK

NORMALLY CLOSED CONTACT

H NORMALLY OPEN CONTACT

NORMALLY OPEN PUSH BUTTON

NORMALLY CLOSED PUSH BUTTON

NORMALLY OPEN, TIMED-CLOSED CONTACT

INDICATOR LIGHT, LED

CIRCUIT BREAKER

METERING CABINET

GENERATOR

TRANSFORMER


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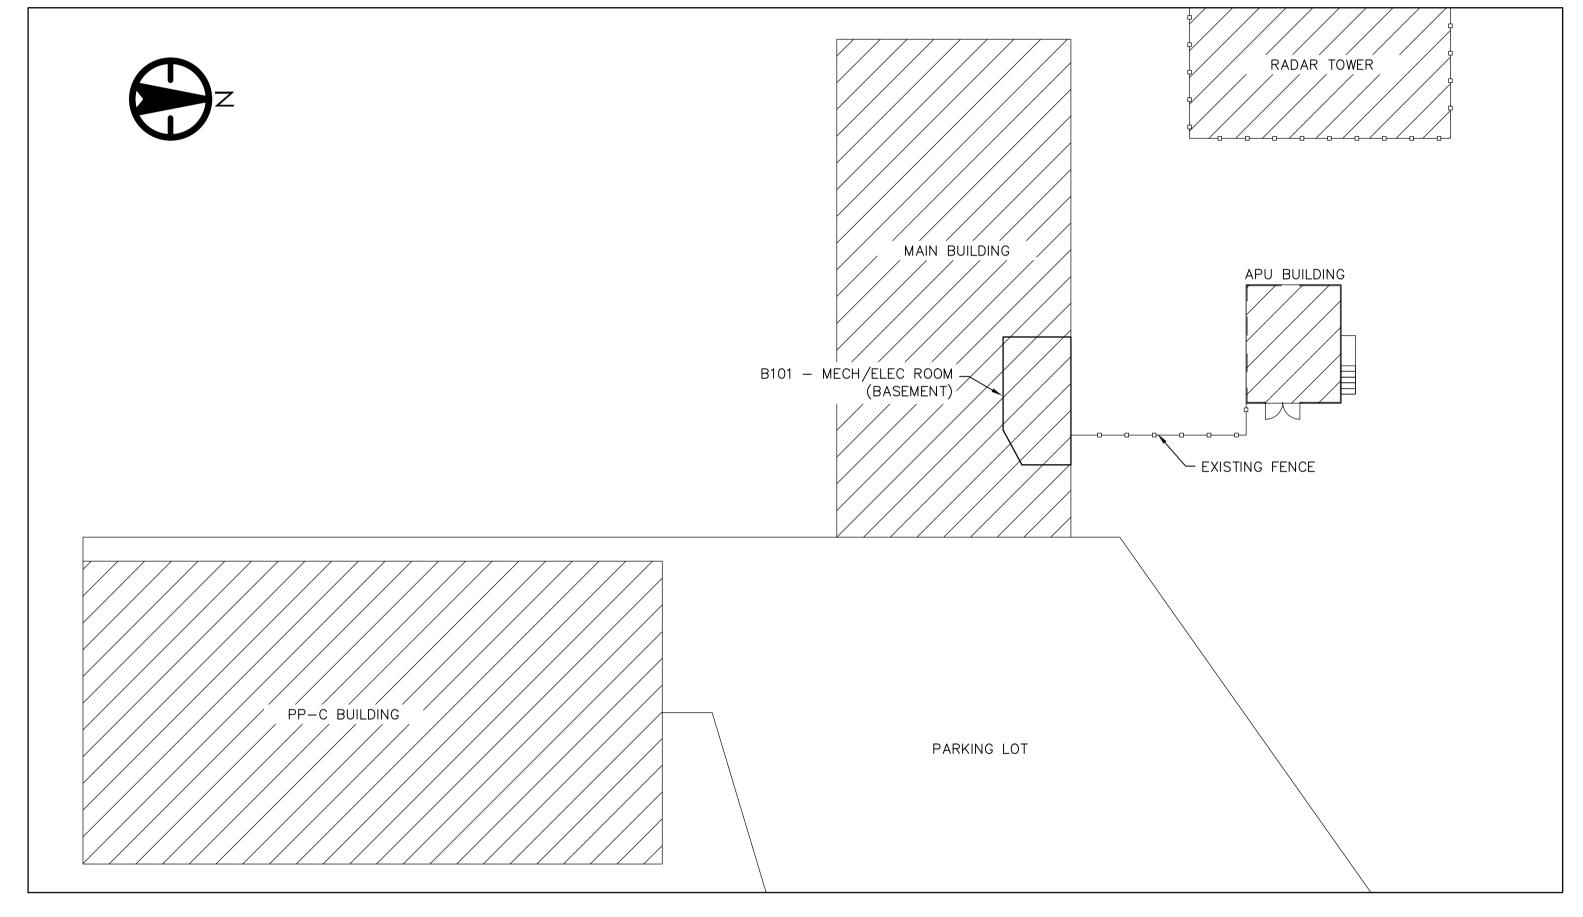
AUTOMATIC TRANSFER SWITCH

PANELBOARD

GROUND TERMINAL

HAND OFF AUTO HAND/OFF/AUTO SELECTOR SWITCH



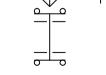



| | KING CITY GENERATOR UPGRADE |
|----------------|---|
| DWG. NUMBER | DRAWING TITLE |
| GO | DRAWING LIST, LEGENDS AND SITE PLAN |
| M1 | MECHANICAL EXISTING AND NEW FUEL STORAGE TANKS SYSTEM SCHEMATIC |
| M2 | MECHANICAL APU BUILDING PLAN - DEMOLITION |
| М3 | MECHANICAL APU BUILDING PLAN - NEW WORK |
| M4 | MECHANICAL DETAILS |
| E1 | ELECTRICAL EXISTING SITE PLAN |
| E2 | ELECTRICAL B101 - MECHANICAL & ELECTRICAL ROOM |
| E3 | ELECTRICAL APU BUILDING - DEMOLITION |
| E4 | ELECTRICAL APU BUILDING - NEW CONSTRUCTION |
| E5 | ELECTRICAL SINGLE LINE DIAGRAM - DEMOLITION |
| E6 | ELECTRICAL SINGLE LINE DIAGRAM - CONSTRUCTION PHASE |
| E7 | ELECTRICAL SINGLE LINE DIAGRAM - NEW CONSTRUCTION |
| E8 | ELECTRICAL APU BUILDING PANEL 'F' SCHEDULE |
| E9 | ELECTRICAL DAMPER CONTROL PANEL DMP-1 |
| S1 | PLAN AND SECTION CONCRETE RAMP |

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Environment and Climate Change Canada Real Property Management Division Environnement et Changement Climatique Canada

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project title titre du projet

ONTARIO ENVIRONMENT AND CLIMATE CHANGE CANADA 14780 JANE STREET KING CITY, ON

GENERATOR REPLACEMENT

drawing title titre du dessin DRAWING LIST, LEGENDS AND SITE PLAN

C. LOBO C. LOBO C. McGEE

DANIEL VENTURA

date du projet 2017/05/09

drawing no. dessine no.

163302290

- ALL ITEMS NOT IN SCOPE WITHIN APU BUILDING TO BE STORED SAFELY DURING CONSTRUCTION BY DEPARTMENTAL REPRESENTATIVE.

- NEW 50ø mm FILL PIPE TERMINATION WITH WEATHER-TIGHT CAP AND CAN/ULC-S663 CERTIFIED SPILL CONTAINER WITH A MINIMUM CAPACITY OF 28 L. MAXIMUM DISTANCE FROM BOTTOM OF TANK TO FILL PIPE TERMINATION SHALL BE 6850 MM. EXPECTED HEIGHT ABOVE GRADE IS APPROXIMATELY 2200 MM.
- SLOPE VENT PIPING FOR MAIN TANKS A MINIMUM OF 2% TOWARDS TANKS AND INSTALL WITHOUT ANY SAGS OR TRAPS, PROVIDE VENT PIPE TERMINATION WITH A WEATHERPROOF VENT CAP WITH FREE AREA AT LEAST EQUIVALENT TO CROSS-SECTION OF VENT PIPE. TERMINATE VENT A MINIMUM OF 600mm FROM BUILDING OPENINGS AND 1500 mm FROM ALL BUILDING EXITS. INSTALL VENT PIPE TERMINATION MAXIMUM 1000 mm FROM FILL PIPE TERMINATION. EXPECTED HEIGHT OF NEW VENT TERMINATION ABOVE GRADE IS APPROXIMATELY 2350 mm.
- FUEL OIL RETURN PIPING FROM GENERATOR IS TO EXTEND INTO TANK AND TERMINATE 50 mm FROM TANK BOTTOM. ANTI-SIPHON PROTECTION IS TO BE PROVIDED WITH HOLE DRILLED INTO DROPTUBE WITHIN TANK AT TOP OF TANK.
- AT TERMINATION OF SUPPLY PIPING INSIDE TANK AS PER
- PROVIDE NEW CAN/ULC-S661 LISTED OVERFILL ALARM PANEL AT FILL LOCATION C/W NEW ULC-LISTED ONE-POSITION HIGH LEVEL FLOAT SWITCH SET TO 90% OF TANK CAPACITY.

GENERAL NOTES

ANCHOR TANKS TO CONCRETE PAD/SLAB AS PER SPECIFICATIONS.

NEW CONSTRUCTION NOTES

- SLOPE FUEL FILL LINE FOR MAIN TANKS A MINIMUM OF 2% TOWARDS TANKS AND INSTALL WITHOUT ANY SAGS OR TRAPS.
- INSTALL FILL PIPE TERMINATION A MINIMUM OF 600 mm FROM BUILDING OPENINGS, A MINIMUM OF 1000 mm ABOVE GRADE AND A MINIMUM OF 1500 mm FROM ALL BUILDING EXITS. FILL PIPE SHALL BE DESIGNED FOR TIGHT FILL ONLY AND PROVIDED WITH APPROVED CAMLOCK FITTING AT TERMINATION.
- PROVIDE ULC S661-CERTIFIED OVERFILL PREVENTION VALVE SET TO 95% OF NEW TANK CAPACITY IN FILL PIPE AT CONNECTION TO ST-1.
- VENT CONNECTION PORT SHALL BE 75ø mm. VENT PIPING SHALL NOT EXTEND MORE THAN 25 mm INTO TANKS.

- FUEL OIL SUPPLY PIPING TO GENERATOR IS TO EXTEND INTO TANK AND TERMINATE 150 mm FROM TANK BOTTOM. PROVIDE FOOT VALVE SPECIFICATIONS.

2017-07-10 C. J. MCGEE 100161414

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Real Property Management Division

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ONTARIO ENVIRONMENT AND CLIMATE CHANGE CANADA 14780 JANE STREET KING CITY, ON

GENERATOR REPLACEMENT

drawing title titre du dessin

EXISTING AND NEW FUEL STORAGE TANK SYSTEM SCHEMATIC

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date du projet 2017/05/09


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M 1



N.T.S.

NEW FUEL STORAGE TANK SYSTEM SCHEMATIC

EXISTING FUEL STORAGE TANK SYSTEM SCHEMATIC

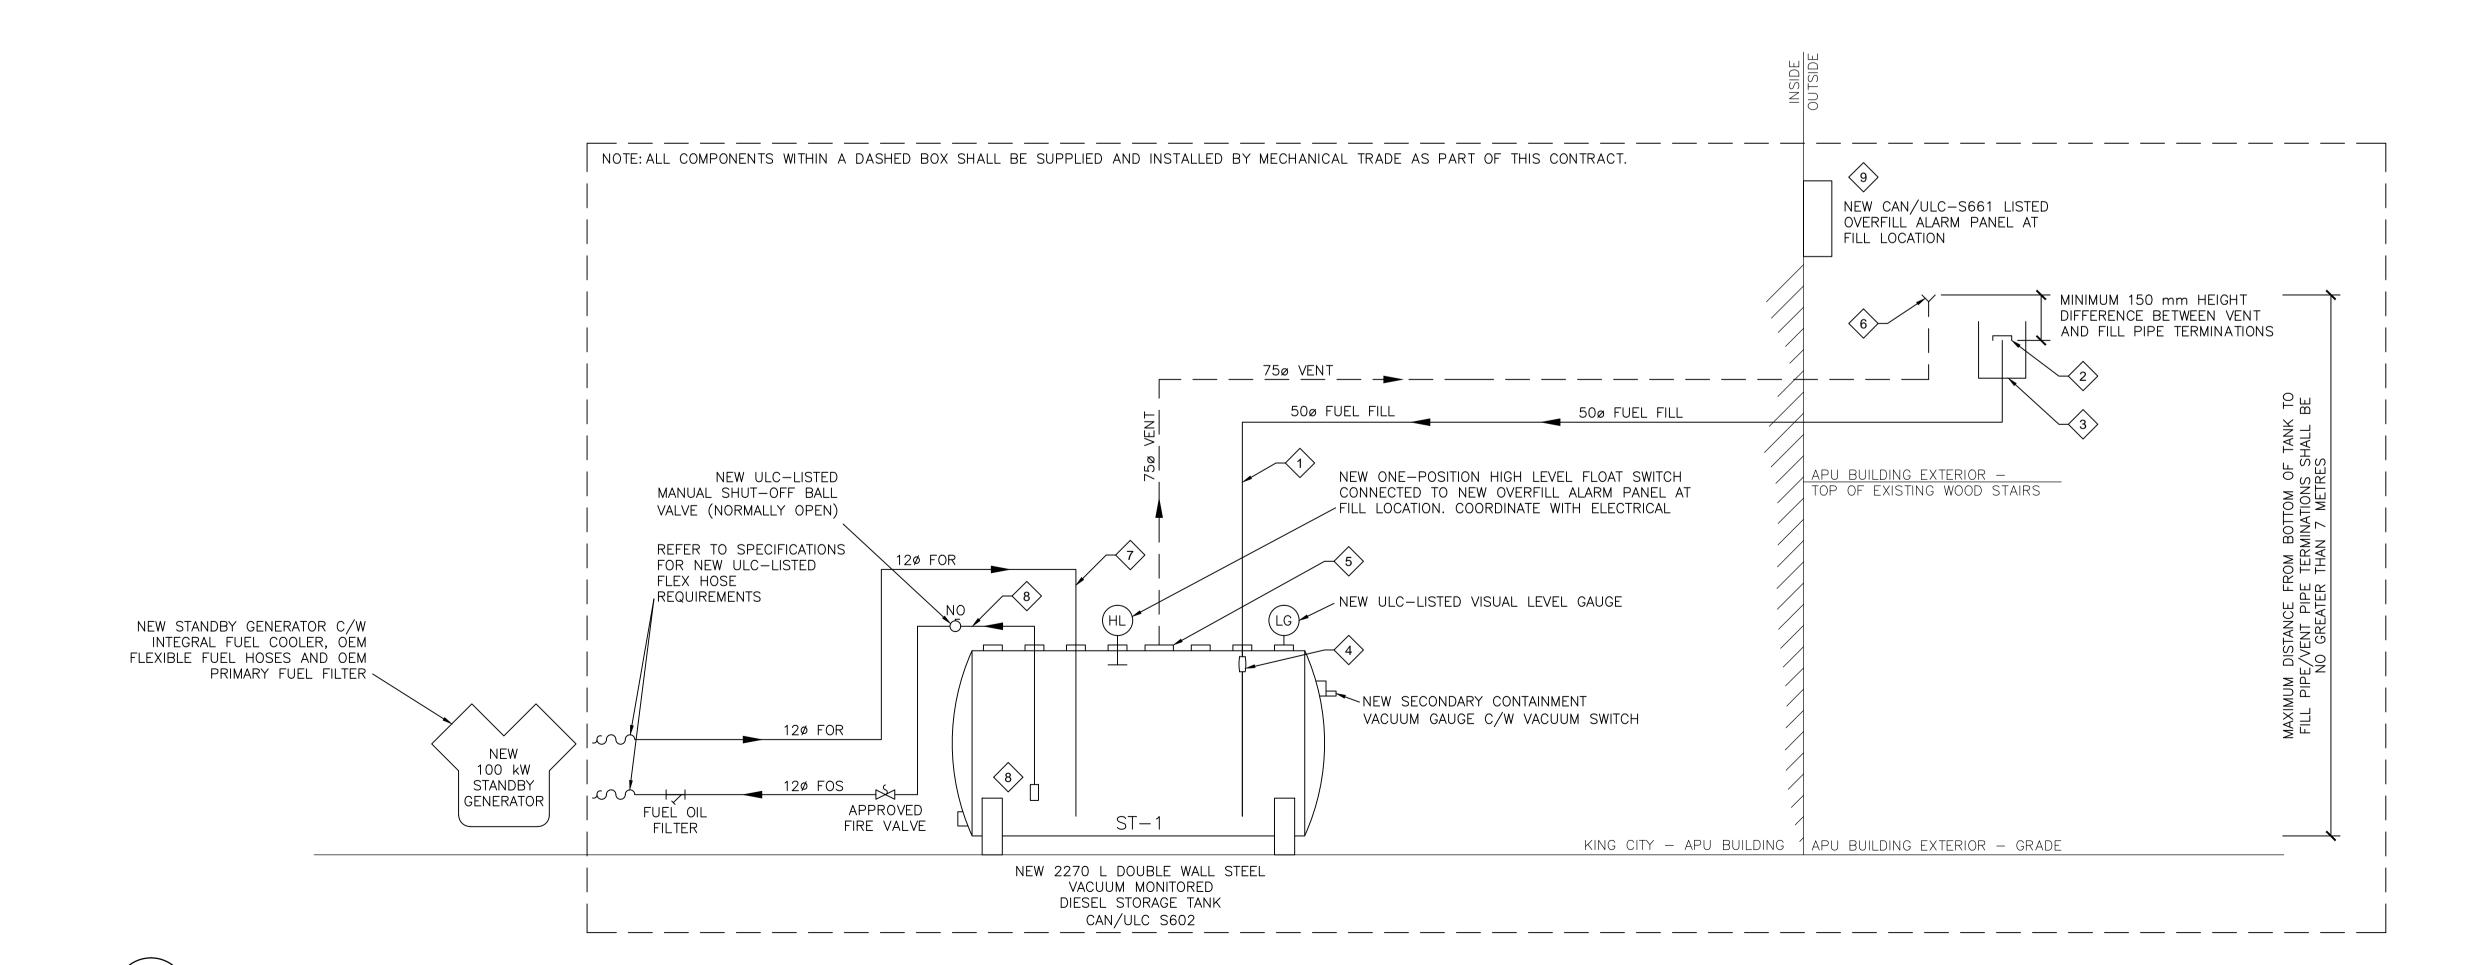KING CITY RADAR WEATHER STATION — APU BUILDING PLAN — DEMOLITION 1:20 М2

GENERAL NOTES

DEMOLITION OF EXISTING DIESEL STORAGE TANK SYSTEM SHALL BE COORDINATED WITH DEPARTMENTAL REPRESENTATIVE AND ELECTRICAL TRADE. MINIMIZE CHANGEOVER TIME AND ENSURE EXISTING GENERATOR SYSTEM IS DISCONNECTED FROM DIESEL STORAGE TANK SYSTEM FOR LEAST AMOUNT OF TIME POSSIBLE.

DEMOLITION NOTES

- 1 EXISTING 100 KW STANDBY GENERATOR AND RELATED ACCESSORIES TO BE REMOVED BY ELECTRICAL TRADE. SHOWN HERE FOR COORDINATION AND REFERENCE ONLY.
- EXISTING 840 X 1240 (W X H) MOTORIZED DAMPER TO REMAIN. REMOVE EXISTING ACTUATOR. REFER TO DRAWING M3 FOR NEW ACTUATOR. TYPICAL.
- REMOVE EXISTING 1110 L DOUBLE WALL STEEL DIESEL STORAGE TANKS C/W ALL RELATED ACCESSORIES, VALVES AND PIPING IN ACCORDANCE WITH SPECIFICATIONS. TYPICAL-2.
- REMOVE EXISTING GENERATOR EXHAUST C/W ALL RELATED ACCESSORIES IN ACCORDANCE WITH APPROVED SCHEDULE OF WORK. COORDINATE WITH ELECTRICAL. PATCH, SEAL AND MAKE GOOD EXISTING GENERATOR EXHAUST OPENING TO MATCH EXISTING WEATHERPROOF WALL CONSTRUCTION AT BOTH EXTERIOR AND INTERIOR. REFER TO NOTE 6.
- REMOVE EXISTING DUCTWORK CONNECTING EXISTING GENERATOR RADIATOR COOLING EXHAUST AIR AND EXISTING WALL OPENING.
- CONTRACTOR SHALL WEATHERPROOF, PATCH, SEAL AND MAKE GOOD EXISTING OPENING FROM EXISTING TO BE REMOVED GENERATOR EXHAUST AND WALL THIMBLE. CONTRACTOR SHALL FILL OPENING WITH APPROVED WEATHERPROOF FIRESTOPPING SEALANT AND MATCH FINISH OF APU BUILDING EXTERIOR AND INTERIOR WALLS.
- MAINTAIN EXISTING WALL OPENING C/W EXISTING 940 x 1240 (W x H) LOUVRE FOR INSTALLATION OF NEW 100 kW STANDBY GENERATOR RADIATOR COOLING EXHAUST AIR.
- REMOVE EXISTING ±970MM x ±1230MM (H) WINDOW C/W ALL RELATED ACCESSORIES TO CREATE NEW WALL OPENING FOR THE INSTALLATION OF NEW WEATHERPROOF LOUVER AND THERMALLY BROKEN INSULATED DAMPER.

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ONTARIO

project manager administrateur de projets

project title titre du projet ENVIRONMENT AND CLIMATE CHANGE CANADA

14780 JANE STREET KING CITY, ON

GENERATOR REPLACEMENT

drawing title titre du dessin MECHANICAL APU BUILDING PLAN DEMOLITION

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C. LOBO

approuve par C. McGEE

soumission DANIEL VENTURA

date du projet 2017/05/09

project no. no. du projet

163302290

drawing no. dessine no.

KING CITY RADAR WEATHER STATION - APU BUILDING PLAN - NEW WORK М3

GENERAL NOTES

INSTALLATION OF NEW DIESEL STORAGE TANK SYSTEM SHALL BE COORDINATED WITH DEPARTMENTAL REPRESENTATIVE AND ELECTRICAL TRADE. MINIMIZE CHANGEOVER TIME AND ENSURE NEW GENERATOR SYSTEM IS DISCONNECTED FROM DIESEL STORAGE TANK SYSTEM FOR LEAST AMOUNT OF TIME POSSIBLE

NEW CONSTRUCTION NOTES

NEW 100 kW STANDBY GENERATOR C/W INTEGRAL OEM FUEL COOLER AND FUEL FILTER TO BE ackslash Installed by Electrical. Shown here for coordination and reference only.

PROVIDE NEW 2270 L DOUBLE WALL STEEL VACUUM MONITORED DIESEL STORAGE TANK (CAN/ULC S602) AS INDICATED. PROVIDE PIPING CONNECTIONS, VALVES AND SENSORS AS PER 2/M1. EACH OF FOUR (4) SUPPORT LEGS OF NEW STORAGE TANK SHALL BE ANCHORED TO 100mmØ, 100mm HIGH SCH. 80 STEEL PIPE AS PER MANUFACTURER'S WRITTEN INSTALLATION INSTRUCTIONS. RIGIDLY ANCHOR EACH STEEL PIPE TO EXISTING FLOOR WITH EXPANSION-TYPE BOLTS APPROVED BY FUEL STORAGE TANK MANUFACTURER. NEW TANK SHALL BE PROVIDED WITH THE FOLLOWING MINIMUM SERVICE CLEARANCES: MIN. SPACING FROM GENERATOR SHALL BE NO LESS THAN 750 mm. MIN. SPACING BETWEEN FRONT AND ONE SIDE OF TANK FROM WALL AND OTHER INTERFERENCES SHALL BE NO LESS THAN 460 mm. MIN. SPACING FOR TANK FROM BACK WALL AND SECOND SIDE TO WALL SHALL BE NO LESS

SUPPORT ALL PIPING ON WALLS, FLOOR AND CEILING AS PER DETAILS ON DRAWING M4. TYPICAL FOR ALL FUEL OIL PIPING. REFER TO SPECIFICATIONS FOR ADDITIONAL REQUIREMENTS.

⋋ | PROVIDE NEW 50ø FILL PIPE TO OUTDOOR TERMINATION AS INDICATED. NEW FILL PIPE SHALL BE EQUIPPED WITH WEATHERTIGHT CAP AND CAN/ULC-S661 CERTIFIED SPILL CONTAINER WITH A MINIMUM CAPACITY OF 28 L. SLOPE FILL PIPING AT MINIMUM 2% TOWARD TANK WITHOUT ANY A SAGS OR TRAPS IN WHICH FUEL CAN COLLECT. CONTRACTOR SHALL REUSE EXISTING WALL PENETRATION FROM EXISTING TO BE REMOVED FILL PIPE AND WIDEN AS REQUIRED TO SUIT ROUTING OF NEW PIPING. PATCH, SEAL AND MAKE GOOD TO MATCH EXISTING FINISH AND INTERIOR AND EXTERIOR OF APU BUILDING. REFER TO DETAIL 4/M4 FOR WALL PENETRATION REQUIREMENTS.

PROVIDE NEW 75ø VENT TO ATMOSPHERE C/W NEW ULC WEATHERPROOF VENT CAP AT 5 | TERMINATION OUTSIDE. SLOPE VENT PIPING AT MINIMUM 2% TOWARD TANK WITHOUT ANY SAGS OR TRAPS IN WHICH FUEL CAN COLLECT. CONTRACTOR SHALL REUSE EXISTING WALL PENETRATION FROM EXISTING TO BE REMOVED VENT PIPE AND WIDEN AS REQUIRED TO SUIT ROUTING OF NEW VENT PIPING. PATCH, SEAL AND MAKE GOOD TO MATCH EXISTING FINISH AND INTERIOR AND EXTERIOR OF APU BUILDING. REFER TO DETAIL 4/M4 FOR WALL PENETRATION REQUIREMENTS.

NEW FUEL FILL AND VENT LINES TO BE ROUTED UP AND OUT OF BUILDING. TERMINATE BOTH $\stackrel{6}{\nearrow}$ PIPES IN APPROXIMATELY THE SAME LOCATION AS CURRENT FILL & VENT CONNECTIONS. CLEARLY LABEL FILL AND VENT PIPES "DIESEL FILL" AND "DIESEL VENT" WITH LAMACOIDS. SUPPLY AND INSTALL "NO SMOKING" AND "TIGHT FILL ONLY" SIGN AT FILL LOCATION. PROVIDE NEW OVERFILL ALARM AT FILL LOCATION AS PER DETAIL ON DRAWING M4.

PROVIDE NEW 100 mm x 150 mm (W x H) CAST-IN-PLACE CONCRETE CURB SURROUNDING $^\prime$ | DIESEL STORAGE TANK SYSTEM AND GENERATOR WITHIN APU BUILDING AS INDICATED. SEAL ENTIRE FLOOR AREA LOCATED WITHIN NEW CURB WITH APPROVED SEALANT THAT IS IMPERMEABLE TO FUEL OIL. REFER TO DETAIL 6/M4. PATCH ALL EXISTING CRACKS IN CONCRETE FLOOR OF EXISTING APU BUILDING.

PROVIDE NEW SPRING-RETURN ACTUATOR C/W END SWITCHES FOR EXISTING COMBUSTION AIR AND VENTILATION AIR MOTORIZED DAMPERS. POWER, CONTROLS AND WIRING BY ELECTRICAL. REFER TO SPECIFICATIONS FOR ACTUATOR REQUIREMENTS. TYPICAL-2.

PROVIDE NEW APPROVED ULC-LISTED PREFABRICATED GENERATOR EXHAUST STACK 9 DIRECTLY DOWNSTREAM OF NEW APPROVED ULC-LISTED HEAVY DUTY RESIDENTIAL-GRADE GENERATOR SILENCER C/W ALL RELATED ACCESSORIES AS PER SPECIFICATIONS. NEW EXHAUST STACK SHALL BE SIZED TO SUIT NEW 100 kW STANDBY GENERATOR. NEW EXHAUST C/W SILENCER SHALL BE INSULATED FOR FIRST 2450 mm ABOVE GRADE AND THERE SHALL BE A CONDENSATE DRAIN C/W SHUTOFF VALVE PROVIDED TO DRAIN TO A SAFE LOCATION INSIDE THE APU BUILDING. CONTRACTOR SHALL ENGAGE QUALIFIED ROOFING SUBTRADE AND CARRY ALL COSTS ASSOCIATED WITH ROOFING WORK TO CREATING NEW ROOF OPENING FOR EXHAUST, INSTALLATION OF NEW EXHAUST ABOVE ROOF LEVEL, INSTALLATION OF SUPPORTS AND ALL EXHAUST RELATED WORK AT OR ABOVE ROOF LEVEL. WEATHERPROOF, PATCH, SEAL AND MAKE GOOD NEW ROOF OPENING TO MATCH EXISTING ROOF CONDITION. REFER TO DETAILS 9/M4 AND 10/M4. EXACT LOCATION OF NEW EXHAUST STACK AND NEW EXHAUST SILENCER TO SUPPLIED AND INSTALLED BY DIVISION 23 SHALL BE COORDINATED ONSITE WITH DEPARTMENTAL REPRESENTATIVE.

THE CONTRACTOR SHALL ENGAGE A SEISMIC ENGINEER LICENSED IN THE PROVINCE OF 10 ONTARIO TO CARRY OUT THE DESIGN OF THE SUPPORTS FOR THE PROPOSED GENERATOR EXHAUST INCLUDING, BUT NOT LIMITED TO. THE NEW GENERATOR EXHAUST SILENCER AND CHIMNEY. THE CONTRACTOR SHALL SUBMIT SEALED SHOP DRAWING(S) OF THE SUPPORTS FOR REVIEW AND APPROVAL PRIOR TO CONSTRUCTION IN ACCORDANCE WITH THE APPROVED SCHEDULE OF WORK. THE SHOP DRAWING(S) FOR THE SUPPORTS MUST BE APPROVED BY THE MANUFACTURERS OF BOTH THE APPROVED GENERATOR EXHAUST STACK AND APPROVED EXHAUST SILENCER. THE CONTRACTOR SHALL CARRY ALL COSTS ASSOCIATED WITH DESIGNING AND PROVIDING THE GENERATOR EXHAUST CHIMNEY SUPPORTS.

MAINTAIN EXISTING WALL OPENING C/W EXISTING 940mm x 1240mm (W x H) LOUVRE AND 11 PROVIDE NEW BIRD SCREEN TO SUIT WALL OPENING SIZE. CONTRACTOR TO VERIFY DIMENSIONS PRIOR TO COMPLETING WORK AND NOTIFY DEPARTMENTAL REPRESENTATIVE OF ANY DISCREPANCIES.

12 COOLING AIR REQUIREMENTS (3000 L/s) AND EXISTING 940mm x 1240mm WALL OPENING. INSULATE PLENUM AS PER SPECIFICATIONS.

PROVIDE NEW CONTROL DAMPER C/W ACTUATOR FOR GENERATOR RADIATOR COOLING AIR RECIRCULATION IN ACCORDANCE WITH SPECIFICATIONS. ACTUATOR SHALL BE INTERLOCKED WITH NEW TEMPERATURE SENSOR AS INDICATED. PROVIDE NEW SURFACE-MOUNTED TEMPERATURE SENSOR ON WALL AS INDICATED. POWER, CONTROLS AND WIRING BY

PROVIDE NEW MECHANICAL SPRING-ACTUATED DOOR CLOSER TO SUIT EACH SIDE OF EXISTING DOUBLE MAN DOOR TO THE SATISFACTION OF DEPARTMENTAL REPRESENTATIVE.

APPROXIMATE LOCATION OF NEW CONCRETE RAMP AT APU BUILDING ENTRANCE BY DIVISION 3. COORDINATE DELIVERY AND ROUGH IN OF NEW EQUIPMENT INSIDE APU BUILDING WITH STRUCTURAL TRADE. REFER TO DRAWING S1 FOR NEW CONCRETE RAMP.

PROVIDE NEW 1220mm (H) x 914mm (W) x 100mm (D) STORMPROOF LOUVRE C/W FLANGED CONNECTION IN NEW ±1220mm x ±970mm (W x H) OPENING CREATED BY REMOVAL OF WINDOW. INSTALL LOUVRE AS PER MANUFACTURER'S RECOMMENDATIONS. PROVIDE WEATHERSTRIPPING AND CAULKING TO ENSURE THAT LOUVRE IS SEALED TO BE FULLY WEATHERTIGHT. CONTRACTOR IS RESPONSIBLE FOR ENLARGING OPENING AND/OR PROVIDING INSULATED ALUMINUM BLANK-OFF PANELS AS NECESSARY FOR THE INSTALLATION OF THE NEW LOUVER TO SUIT NEW WALL OPENING CREATED BY THE REMOVAL OF WINDOW. REFER TO SPECIFICATIONS FOR ADDITIONAL REQUIREMENTS.

PROVIDE NEW 914MM (W) x 1220MM (W x H) THERMALLY BROKEN INSULATED DAMPER C/W $\frac{1}{2}$ | FLANGED CONNECTION. REFER TO SPECIFICATIONS FOR ADDITIONAL REQUIREMENTS.

PROVIDE NEW SPRING-RETURN ACTUATOR C/W END SWITCHES FOR NEW COMBUSTION AIR 18 AND VENTILATION AIR DAMPER. POWER, CONTROLS AND WIRING BY ELECTRICAL. REFER TO SPECIFICATIONS FOR ACTUATOR REQUIREMENTS.

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drawing title titre du dessin MECHANICAL APU BUILDING PLAN NEW WORK

dessine par C. LOBO

C. LOBO


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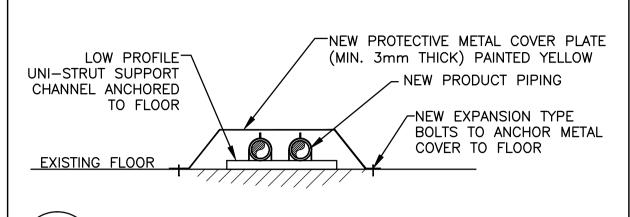
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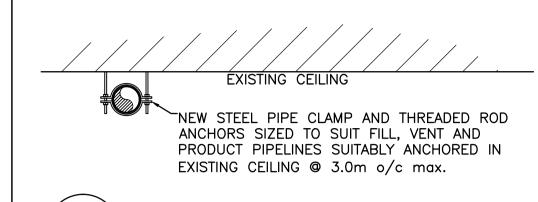
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. PIPE SUPPORT ON FLOOR DETAIL

SCALE 1:20



М4

NEW REINFORCED CONCRETE CURB.

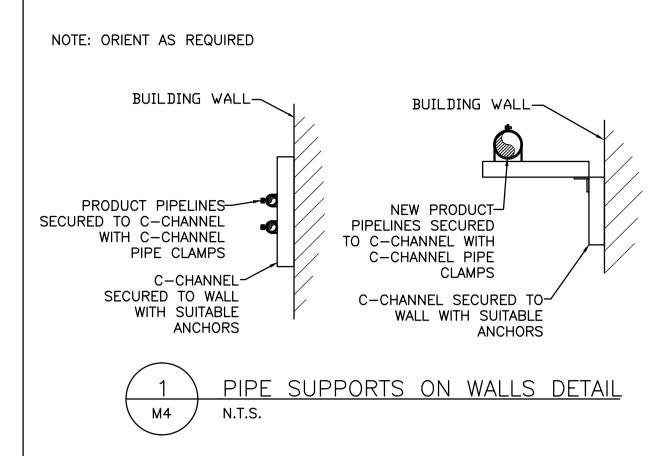N.T.S.

TYPICAL PIPE HANGER DETAIL



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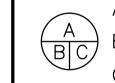
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DETAILS

C. LOBO

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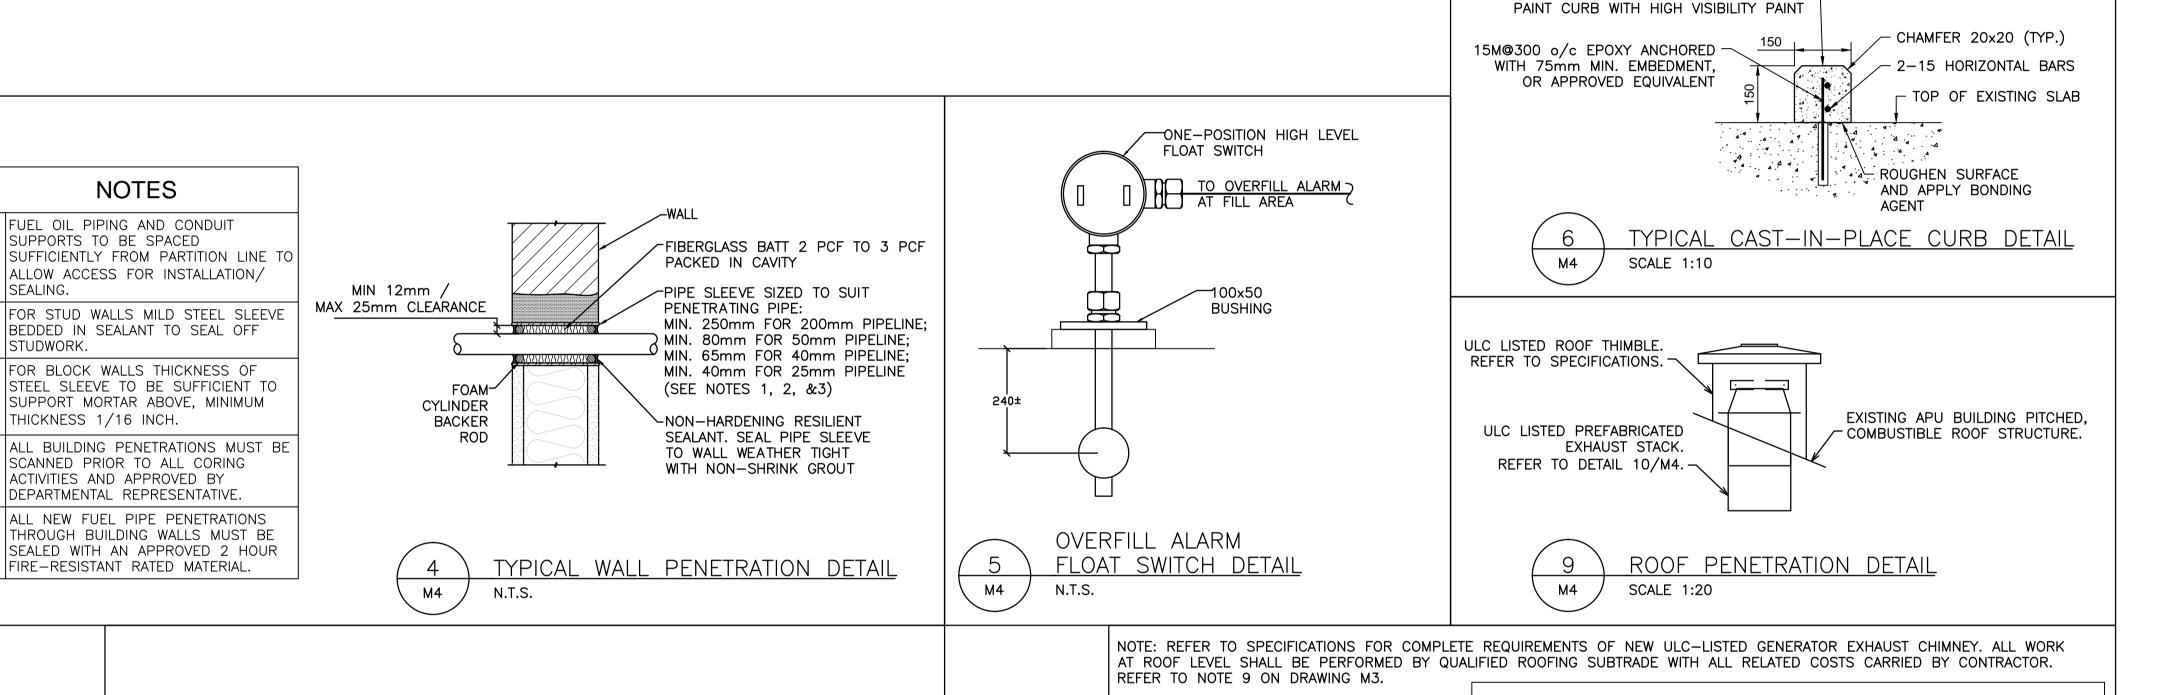
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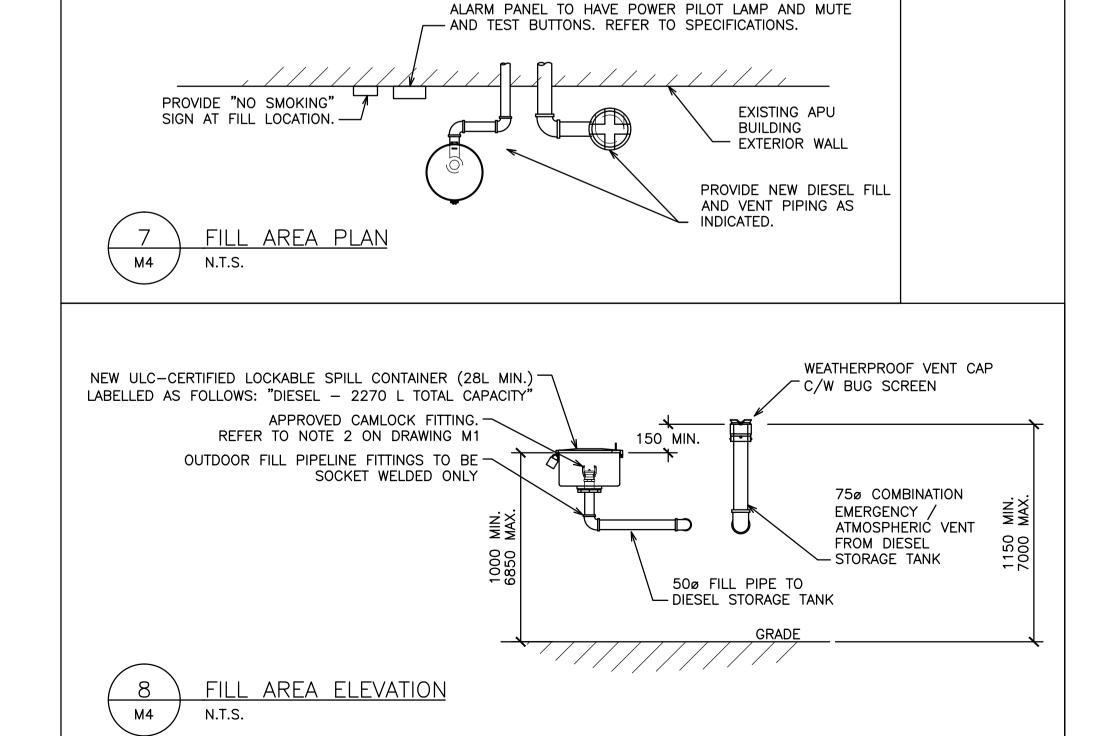
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M4



М4




NEW OVERFILL ALARM TIED TO NEW HIGH LEVEL FLOAT

SENSOR SET TO 90% OF TANK CAPACITY. OVERFILL

DETAIL NOTES (1) EXISTING COMBUSTIBLE PITCHED ROOF STRUCTURE OF APU BUILDING. NEW PREFABRICATED ULC-LISTED EXHAUST STACK SHALL BE INSULATED, AT MINIMUM, FOR FIRST 2450 mm ABOVE GRADE. INSTALL NEW EXHAUST ABOVE ROOF LEVEL C/W SUPPORTS AND WEATHERPROOF. CONTRACTOR SHALL CREATE NEW ROOF PENETRATION SIZED TO SUIT NEW EXHAUST 3 STACK C/W ULC LISTED ROOF THIMBLE AS PER MANUFACTURER'S INSTALLATION INSTRUCTIONS. PATCH, SEAL AND MAKE GOOD NEW ROOF OPENING. CONTRACTOR SHALL ENSURE THAT THE ROOFING MATERIAL IS CUT BACK TO A MINIMUM OF 100mm GREATER THAN CLEARANCE TO COMBUSTIBLES REQUIREMENT AS PER CSA B139-15. REFER TO DETAIL 9/M4. NEW ULC-LISTED ROOF THIMBLE. CONTRACTOR SHALL ENSURE THAT THERE IS $|4\rangle$ ADEQUATE CLEARANCE TO COMBUSTIBLES FROM THE NEW EXHAUST CHIMNEY. REFER TO DETAIL 9/M4. EXHAUST STACK TERMINATION SHALL BE EQUIPPED WITH FLAPPER RAIN CAP AND FLUE SHALL EXTEND AT LEAST 1000 mm ABOVE POINT OF CONTACT WITH EXISTING APU BUILDING ROOF AND 610 mm ABOVE ANY ROOF STRUCTURE THAT WITHIN A 3000mm HORIZONTAL PLANE PERPENDICULAR TO THE EXHAUST. EXHAUST STACK SHALL BE EQUIPPED WITH CONDENSATE DRAIN C/W SHUTOFF VALVE PROVIDED TO DRAIN TO A SAFE LOCATION INSIDE THE APU BUILDING. EXHAUST STACK SHALL BE EQUIPPED WITH AN EXCESS PRESSURE RELIEF VALVE INSIDE THE APU BUILDING. ♠ CONNECT TO OUTLET OF NEW GENERATOR EXHAUST SILENCER WITH ULC-LISTED (8) FLANGE CONNECTOR FROM SAME MANUFACTURER AS PREFABRICATED ULC-LISTED EXHAUST STACK. 9 OF ONTARIO TO CARRY OUT THE DESIGN OF THE SUPPORTS FOR THE PROPOSED GENERATOR EXHAUST INCLUDING, BUT NOT LIMITED TO, THE NEW GENERATOR EXHAUST SILENCER AND CHIMNEY. THE CONTRACTOR SHALL SUBMIT SEALED SHOP DRAWING(S) OF THE SUPPORTS FOR REVIEW AND APPROVAL PRIOR TO CONSTRUCTION IN ACCORDANCE WITH THE APPROVED SCHEDULE OF WORK. THE SHOP DRAWING(S) FOR THE SUPPORTS MUST BE APPROVED BY THE MANUFACTURERS OF BOTH THE APPROVED GENERATOR EXHAUST STACK AND APPROVED EXHAUST SILENCER. THE CONTRACTOR SHALL CARRY ALL COSTS ASSOCIATED WITH DESIGNING AND PROVIDING THE GENERATOR EXHAUST CHIMNEY SUPPORTS. PROPOSED GENERATOR EXHAUST STACK ELEVATION

DATE PLOTTED: PLOT SCALE: CAD FILE:

STUDWORK.

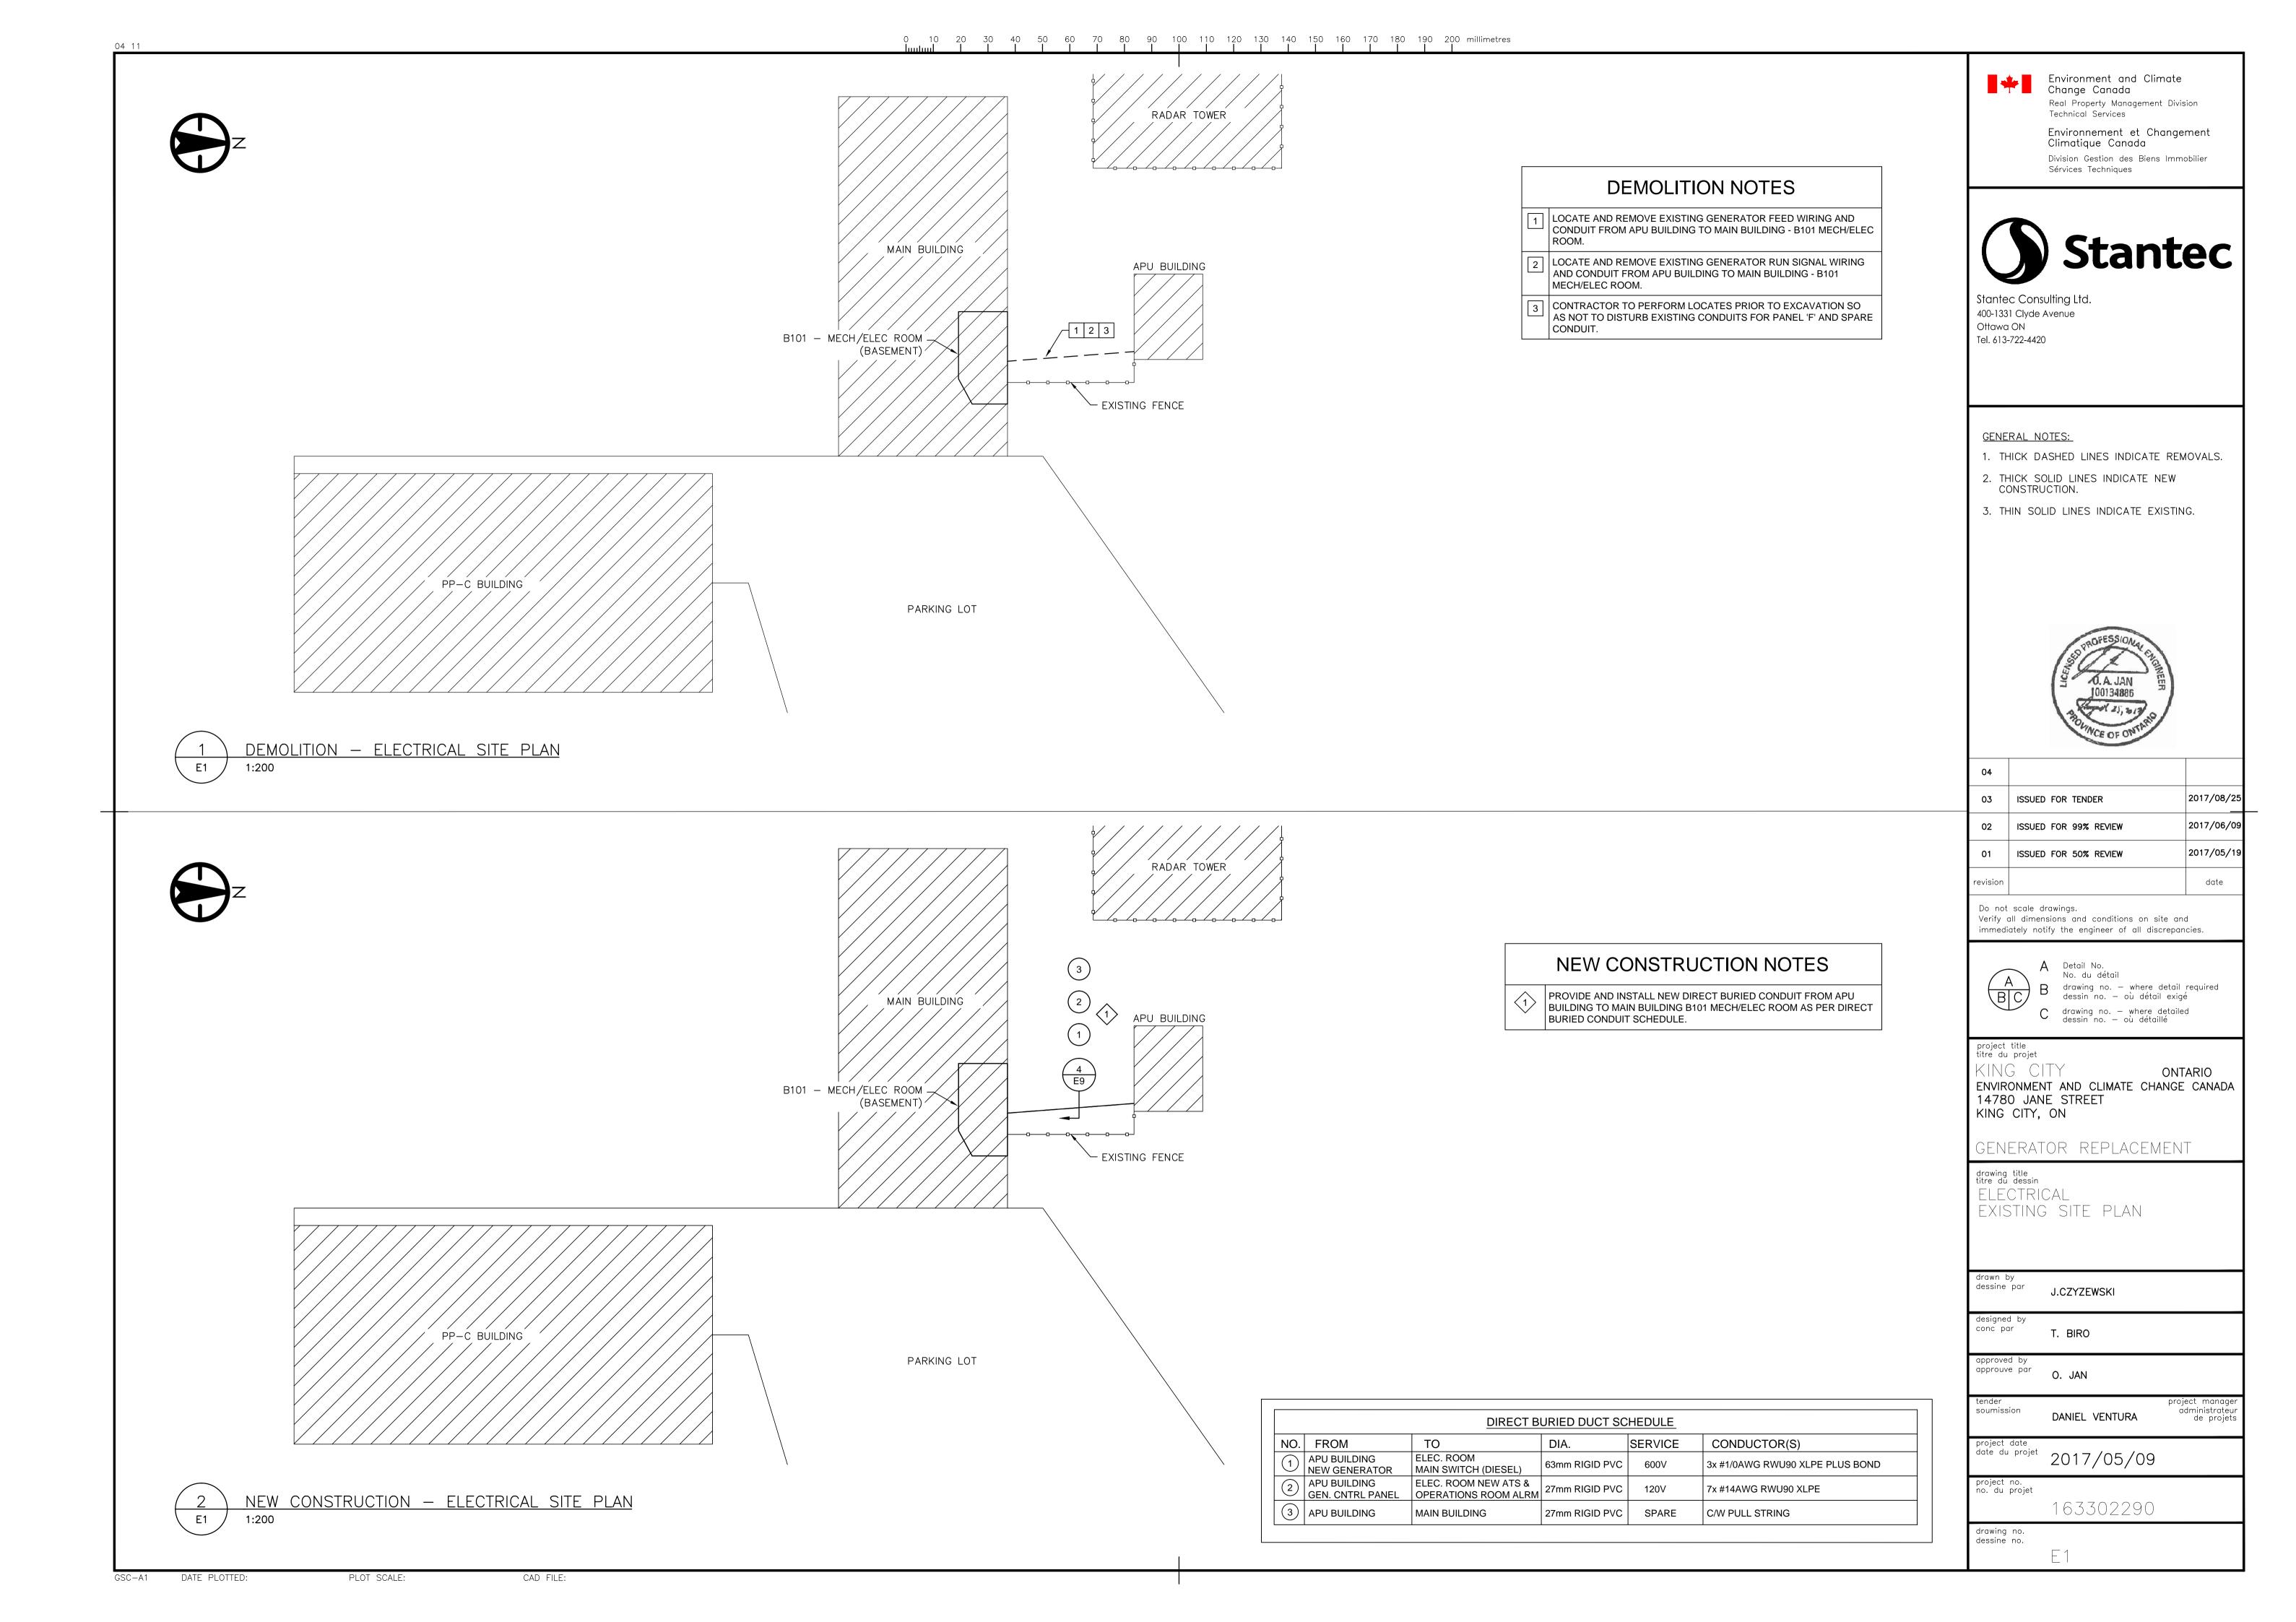

PROVIDE AND INSTALL NEW DIRECT BURIED CONDUIT FROM APU BUILDING TO MAIN BUILDING B101 MECH/ELEC ROOM AS PER DIRECT BURIED CONDUIT SCHEDULE. REFER TO DWG. E1 FOR DETAILS.

project date date date du projet 2017/05/09

project no. no. du projet

163302290

drawing no. dessine no.

CAD FILE:

6 LOCATE AND REMOVE EXISTING GENERATOR RUN SIGNAL WIRING AND CONDUIT FROM APU BUILDING TO MAIN BUILDING - B101

GSC-A1 DATE PLOTTED: PLOT SCALE:

MECH/ELEC ROOM.

DEMOLITION NOTES

- 1 REMOVE EXISTING 100kW GENERATOR C/W ALL ASSOCIATED WIRING AND CONDUIT.
- 2 REMOVE EXISTING WALL MOUNT BATTERY CHARGER AND EXISTING

PANEL 'F'.

- BATTERIES C/W ALL ASSOCIATED WIRING AND CONDUIT TO PANEL 'F'. CIRCUIT TO BE REUSED FOR NEW EQUIPMENT.
- AND WRING TO PANEL 'F',
- REMOVE EXISTING WIRING AND CONDUIT FROM EXISTING ENGINE 4 | COOLANT HEATER TO PANEL 'F'. CIRCUIT TO BE REUSED FOR NEW EQUIPMENT.
- REMOVE EXISTING WIRING AND CONDUIT FROM MOTORIZED DAMPERS TO PANEL 'F'.
- REMOVE INCOMING GENERATOR FEED AND RUN SIGNAL PULL BOXES.
- 7 REMOVE EXISTING LOW FUEL ALARM SYSTEM C/W BELL, LOW FUEL SWITCH (TANK 2) AND ALL ASSOCIATED WIRING AND CONDUIT TO
- B LOCATE AND REMOVE EXISTING GENERATOR FEED WIRING AND CONDUIT FROM APU BUILDING TO MAIN BUILDING - B101 MECH/ELEC
- 9 LOCATE AND REMOVE EXISTING GENERATOR RUN SIGNAL WIRING AND CONDUIT FROM APU BUILDING TO MAIN BUILDING - B101 MECH/ELEC ROOM.
- REMOVE EXISTING INTERIOR AND EXTERIOR APU BUILDING LIGHTING. EXISTING CONDUIT AND WIRING TO PANEL 'F' TO REMAIN. CIRCUIT TO BE REUSED FOR NEW EQUIPMENT.



Environment and Climate Change Canada Real Property Management Division Technical Services

Environnement et Changement Climatique Canada Division Gestion des Biens Immobilier Sérvices Techniques



Stantec Consulting Ltd. 400-1331 Clyde Avenue Ottawa ON Tel. 613-722-4420

GENERAL NOTES:

- 1. THICK DASHED LINES INDICATE REMOVALS.
- 2. THICK SOLID LINES INDICATE NEW CONSTRUCTION.
- 3. THIN SOLID LINES INDICATE EXISTING.



| 04 | | |
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| revision | | date |

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A Detail No. No. du détail B drawing no. - where detail required

C drawing no. — where detailed dessin no. — où détaillé

project title titre du projet

KING CITY ONTARIO ENVIRONMENT AND CLIMATE CHANGE CANADA 14780 JANE STREET KING CITY, ON

GENERATOR REPLACEMENT

drawing title titre du dessin ELECTRICAL

APU BUILDING - DEMOLITION

dessine par J.CZYZEWSKI

conc par T. BIRO

approuve par O. JAN

DANIEL VENTURA

project date date date du projet 2017/05/09

project no. no. du projet

soumission

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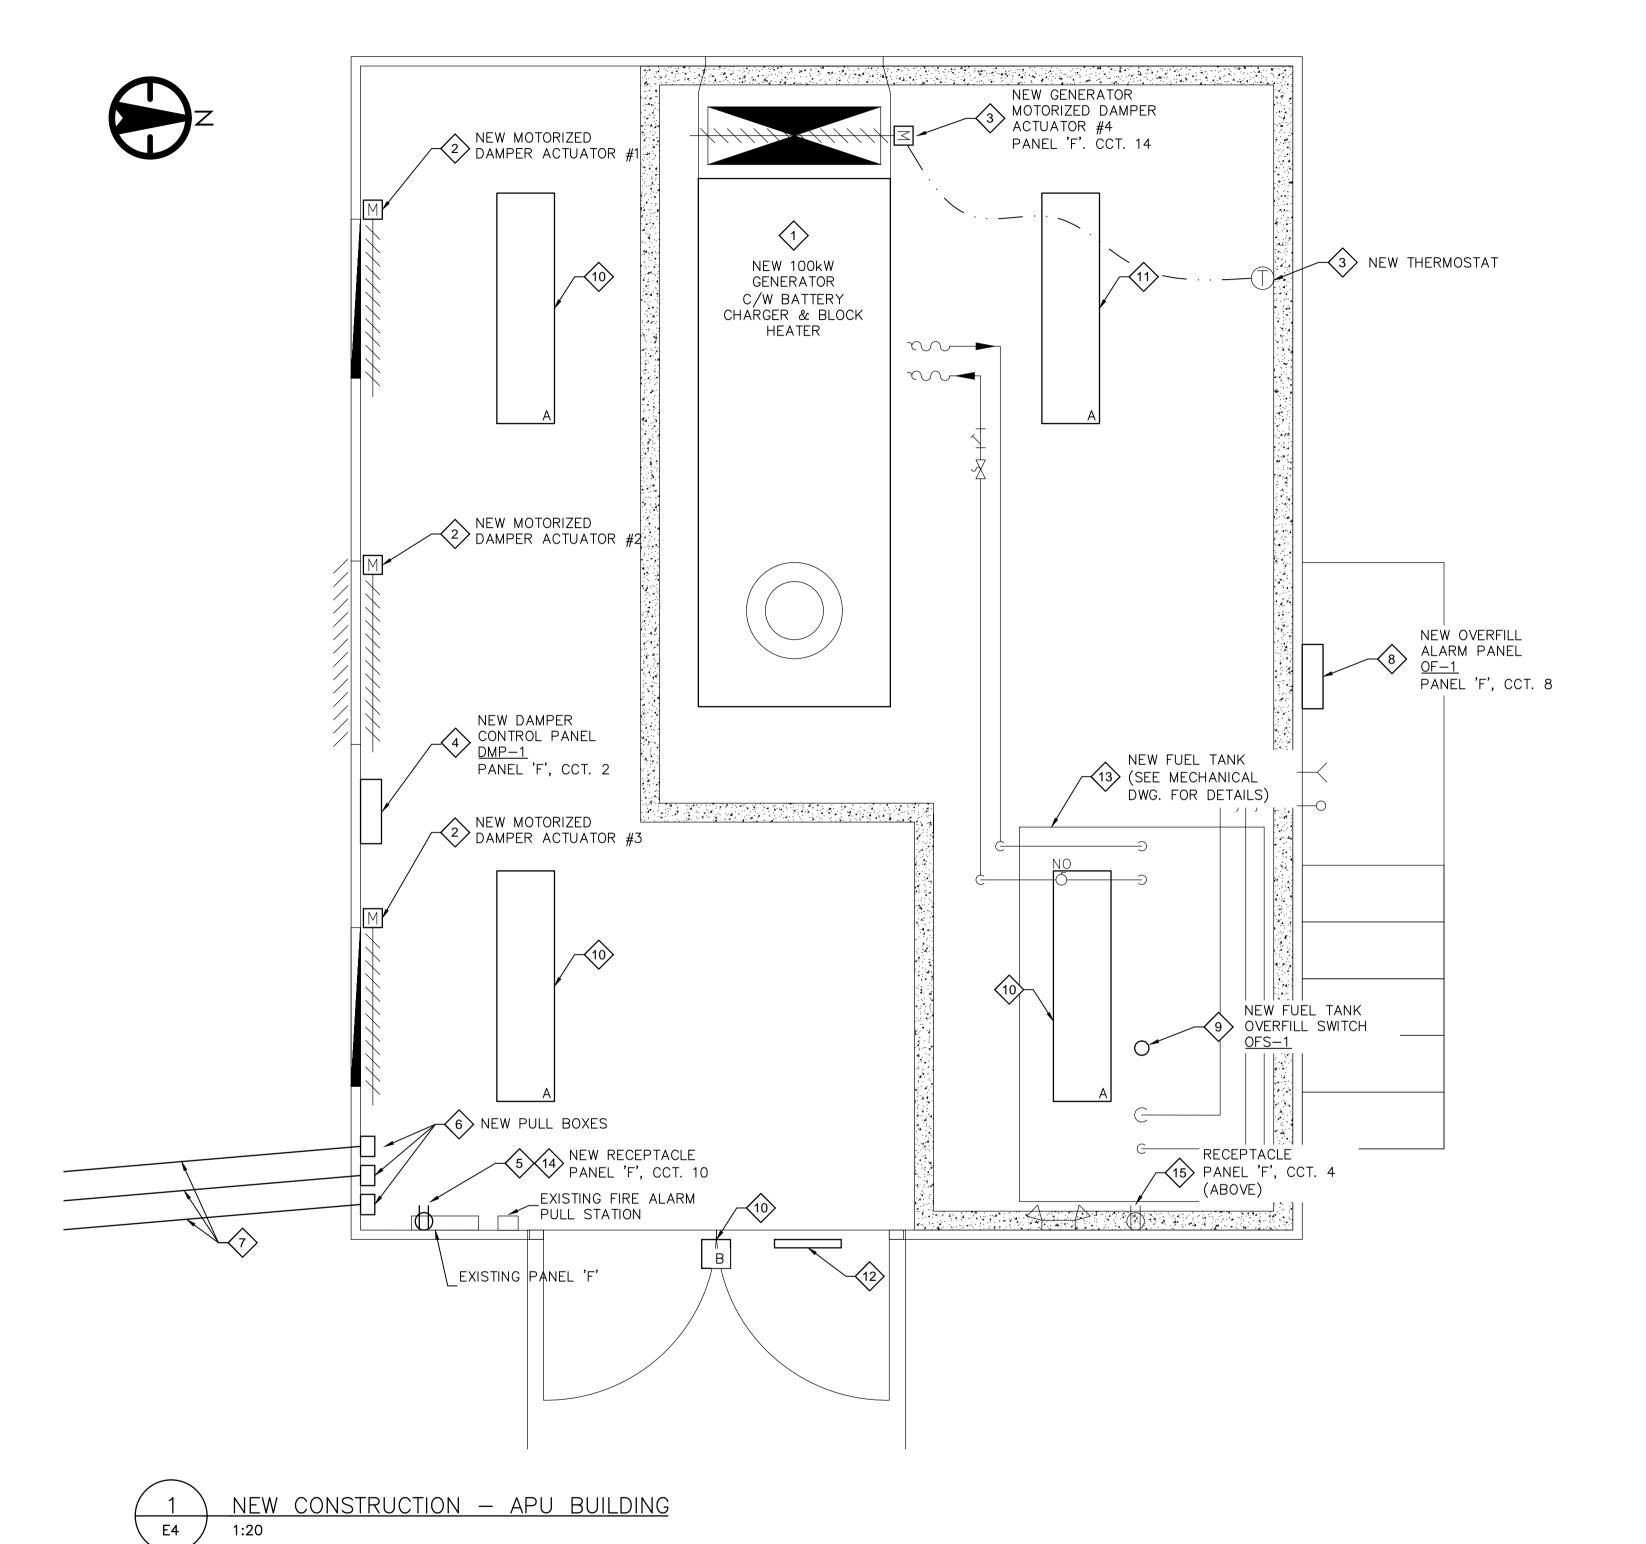
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CAD FILE:

PLOT SCALE:

GSC-A1 DATE PLOTTED:

<u>DEMOLITION - APU BUILDING</u>



GSC-A1 DATE PLOTTED:

NEW CONSTRUCTION NOTES

- PROVIDE AND INSTALL NEW 100kW GENERATOR C/W ALL
 ASSOCIATED WIRING AND CONDUIT. REFER TO SINGLE LINE
 DIAGRAM NEW CONSTRUCTION FOR MORE DETAILS. FEED NEW
 BATTERY CHARGER FROM EXISTING PANEL 'F', CCT. 5. FEED NEW
 GENERATOR ENGINE BLOCK HEATER FROM EXISTING PANEL 'F', CCT
- PROVIDE AND INSTALL WIRING AND EMT CONDUIT FROM NEW MOTORIZED DAMPERS TO NEW CONTROL PANEL <u>DMP-1.</u>
- PROVIDE AND INSTALL NEW WIRING AND EMT CONDUIT FOR NEW GENERATOR MOTORIZED DAMPER TO NEW THERMOSTAT. FEED NEW GENERATOR MOTORIZED DAMPER FROM PANEL 'F', CCT. 14.
- PROVIDE AND INSTALL NEW MOTORIZED DAMPER CONTROL PANEL DMP-1. NEW PANEL TO BE FED FROM EXISTING PANEL 'F', CCT. 2.
- PROVIDE AND INSTALL NEW RECEPTACLE BELOW EXISTING PANEL 'F'. FEED NEW RECEPTACLE FROM PANEL 'F', CCT. 10.
- PROVIDE AND INSTALL NEW PULL BOXES FOR INCOMING CONDUITS FROM MAIN BUILDING MECH/ELEC ROOM B101.
- PROVIDE AND INSTALL NEW DIRECT BURIED CONDUIT FROM APU BUILDING TO MAIN BUILDING B101 MECH/ELEC ROOM AS PER DIRECT BURIED CONDUIT SCHEDULE. REFER TO DWG. E1 FOR DETAILS.
- PROVIDE AND INSTALL NEW OVERFILL ALARM PANEL OF-1. NEW OVERFILL ALARM PANEL TO BE MOUNTED ON EXTERIOR WALL OF APU BUILDING. FEED NEW PANEL FROM EXISTING PANEL 'F', CCT. 8.
- 9 PROVIDE AND INSTALL NEW FUEL TANK OVERFILL SWITCH OFS-1 ON NEW FUEL TANK. CONNECT TO NEW OVERFILL ALARM PANEL OF-1.
- PROVIDE AND INSTALL NEW LED INTERIOR AND EXTERIOR APU BUILDING LIGHTING. CONNECT TO EXISTING WIRING.
- PROVIDE AND INSTALL NEW LED INTERIOR LIGHT, TO BE FED FROM EXISTING LIGHTING CIRCUIT 1 IN PANEL 'F'.
- PROVIDE AND INSTALL CAUTIONARY SIGNAGE ON ENTRANCE DOOR TO APU BUILDING SUITABLE FOR OUTDOOR USE. SEE DETAIL 2 FOR PREFERRED SIGN.
- 80ND NEW FUEL TANK TO NEW GENERATOR.
- PROVIDE CIRCUIT ID LABELS ON ALL RECEPTACLES TO INDICATE

CAUTION

STANDBY GENERATOR AUTOMATICALLY STARTS DURING POWER OUTAGE

2 E4

CAUTION SIGN DETAIL — APU BUILDING



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No. du détail

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project title titre du proje

KING CITY ONTARIO ENVIRONMENT AND CLIMATE CHANGE CANADA 14780 JANE STREET KING CITY, ON

GENERATOR REPLACEMENT

drawing title titre du dessin ELECTRICAL APU BUILDING — NEW CONSTRUCTION

drawn by
dessine par
J.CZYZEWSKI

designed by

T. BIRO

approved by

O. JAN

soumission DANIEL VENTURA administra de pro

project date date date du projet 2017/05/09

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drawing no. dessine no.

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project title titre du projet KING CITY

KING CITY ONTARIO ENVIRONMENT AND CLIMATE CHANGE CANADA 14780 JANE STREET KING CITY, ON

GENERATOR REPLACEMENT

drawing title titre du dessin ELECTRICAL SINGLE LINE DIAGRAM — DEMOLITION

drawn by
dessine par
J.CZYZEWSKI

designed by conc par T. BIRO

approved by approuve par O. JAN

tender soumission


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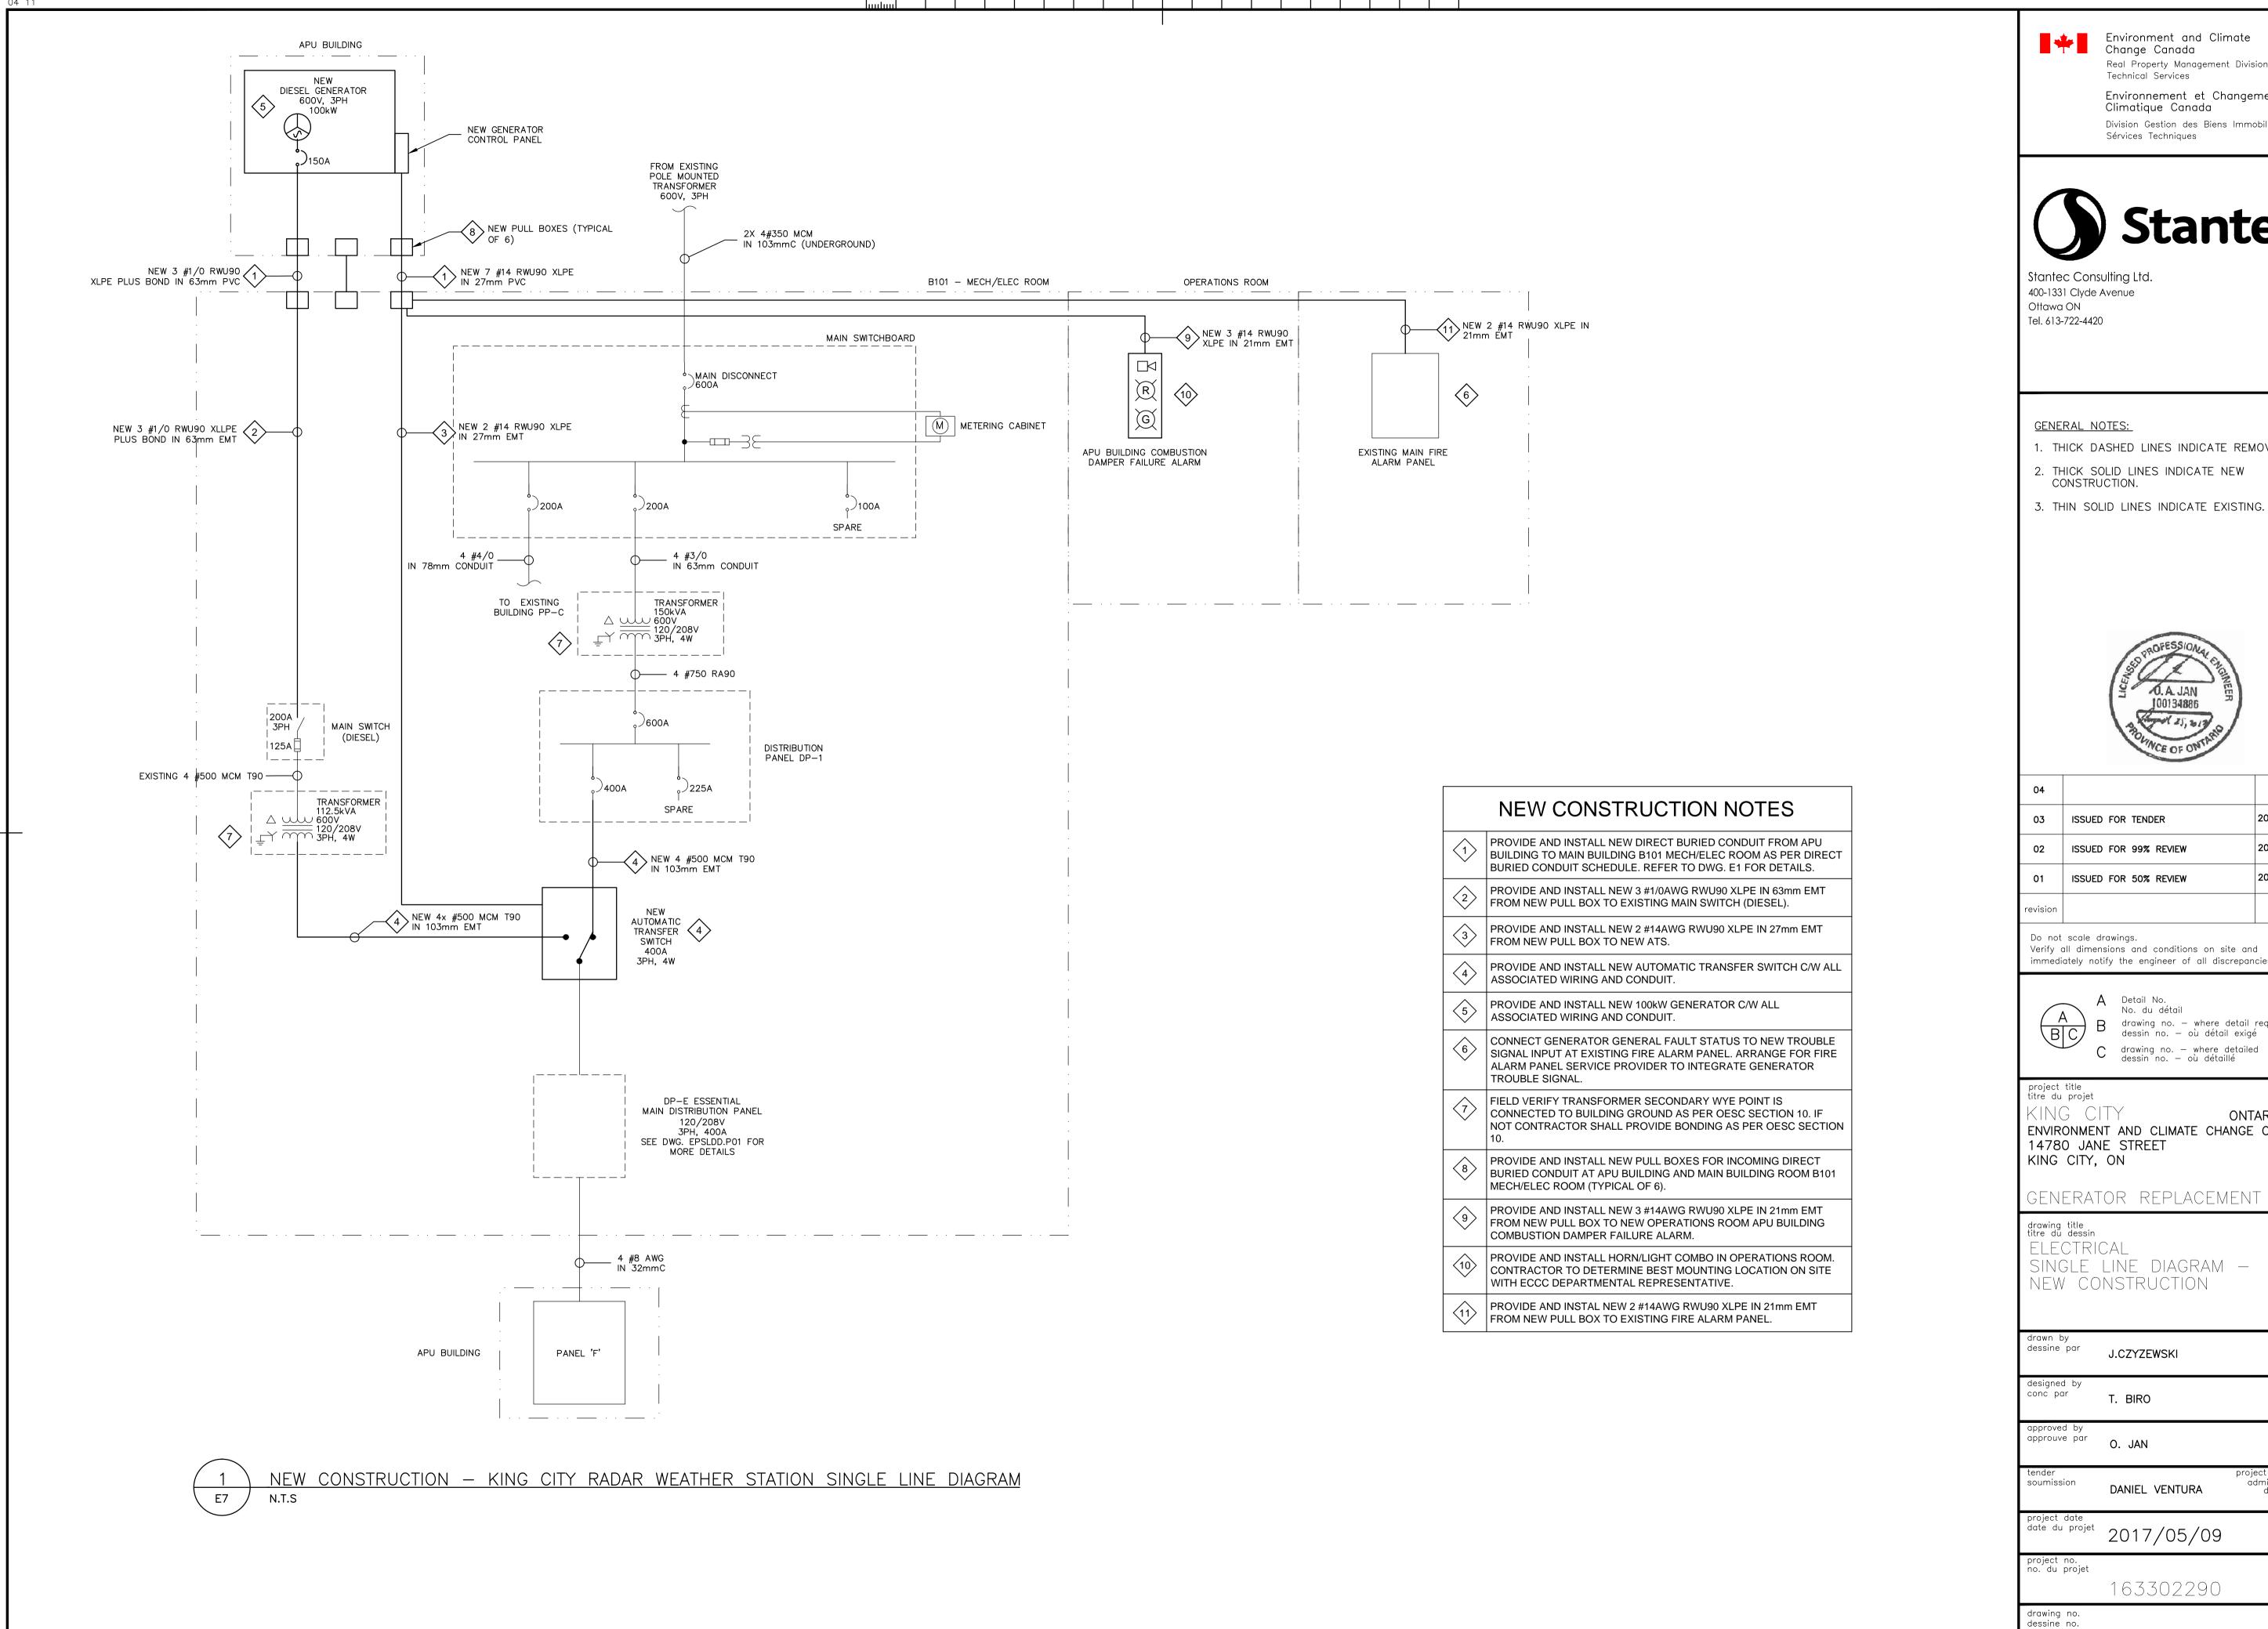
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GSC-A1 DATE PLOTTED:

PLOT SCALE:

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Environnement et Changement Division Gestion des Biens Immobilier



1. THICK DASHED LINES INDICATE REMOVALS.
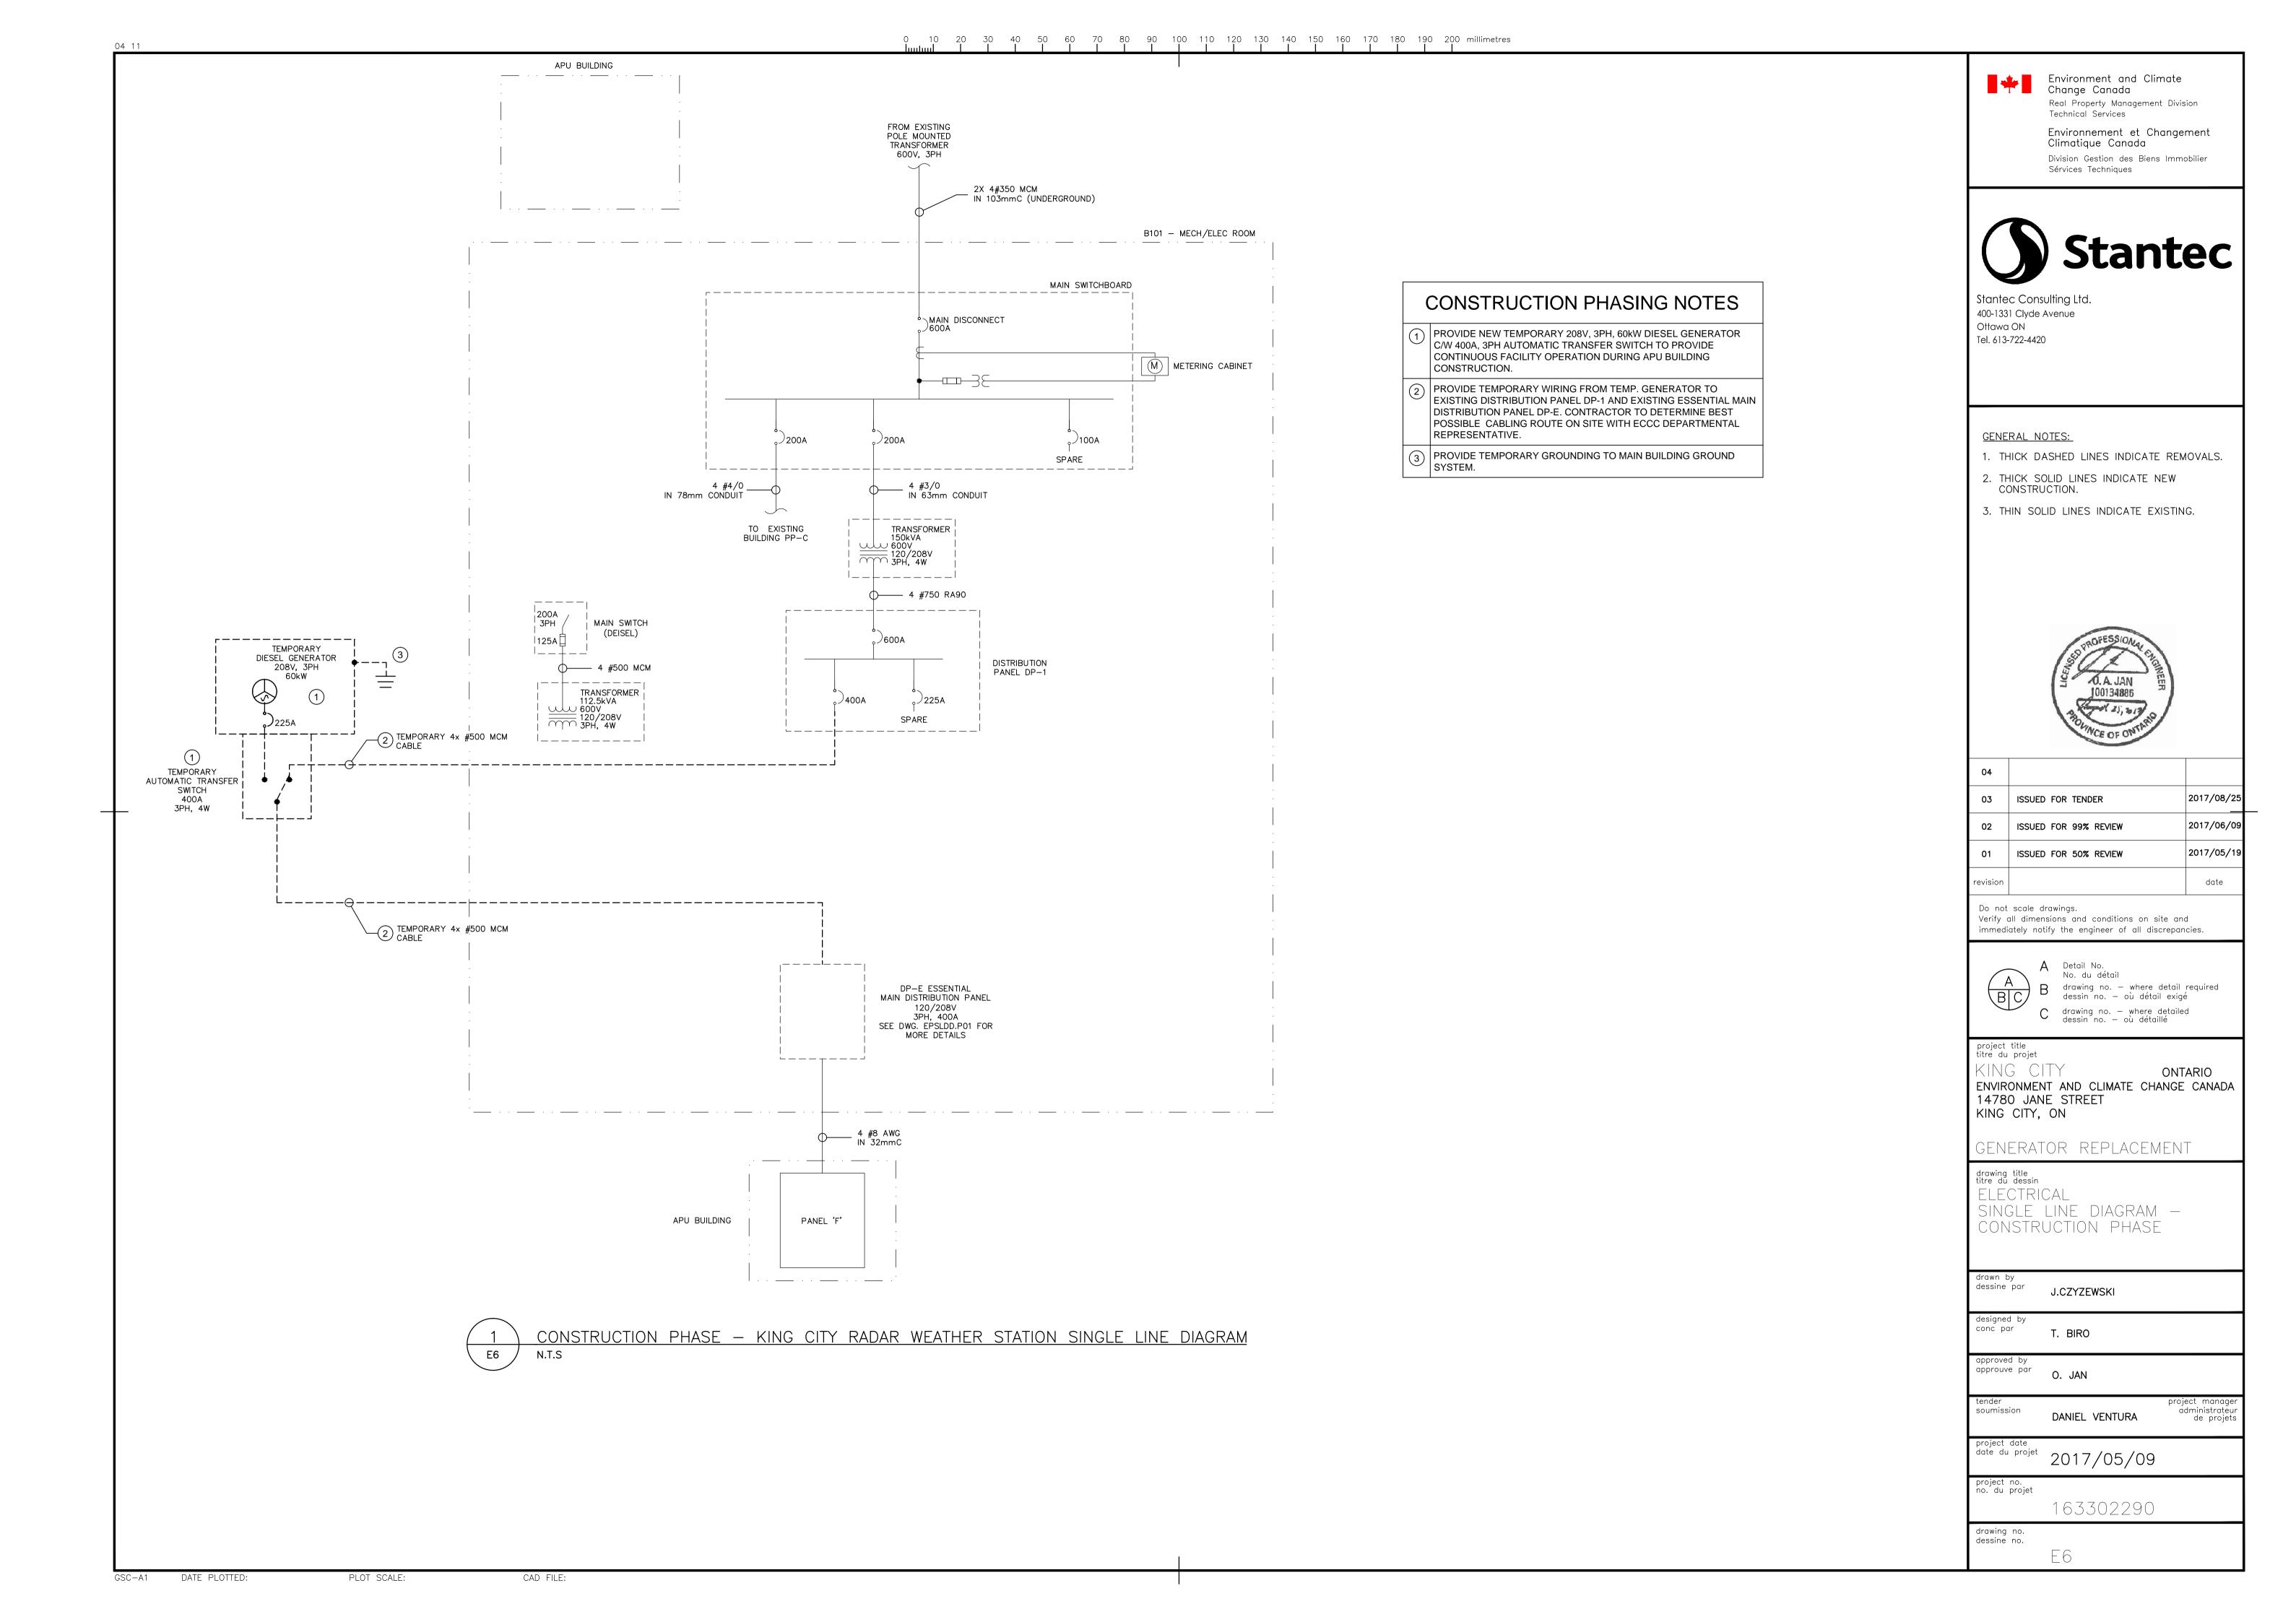
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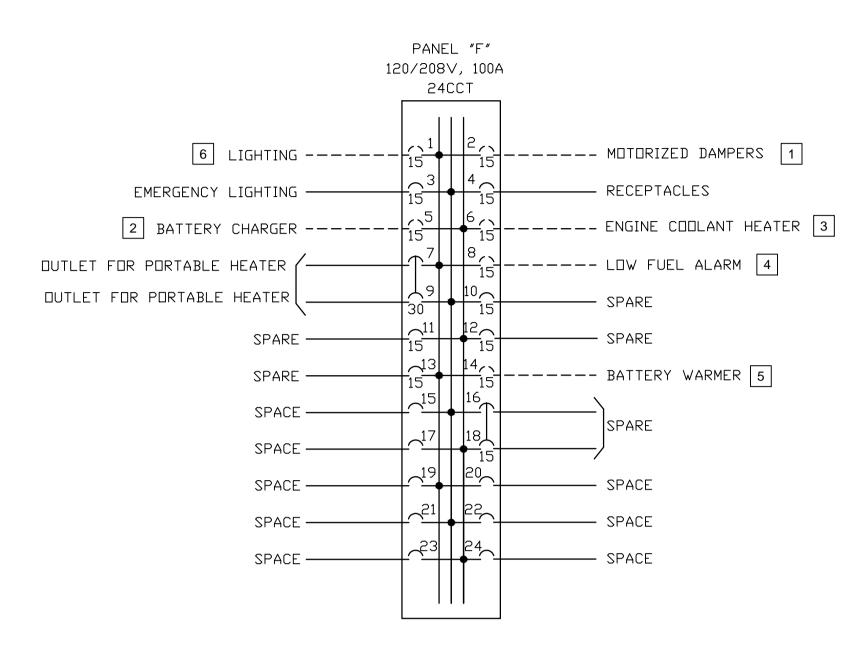
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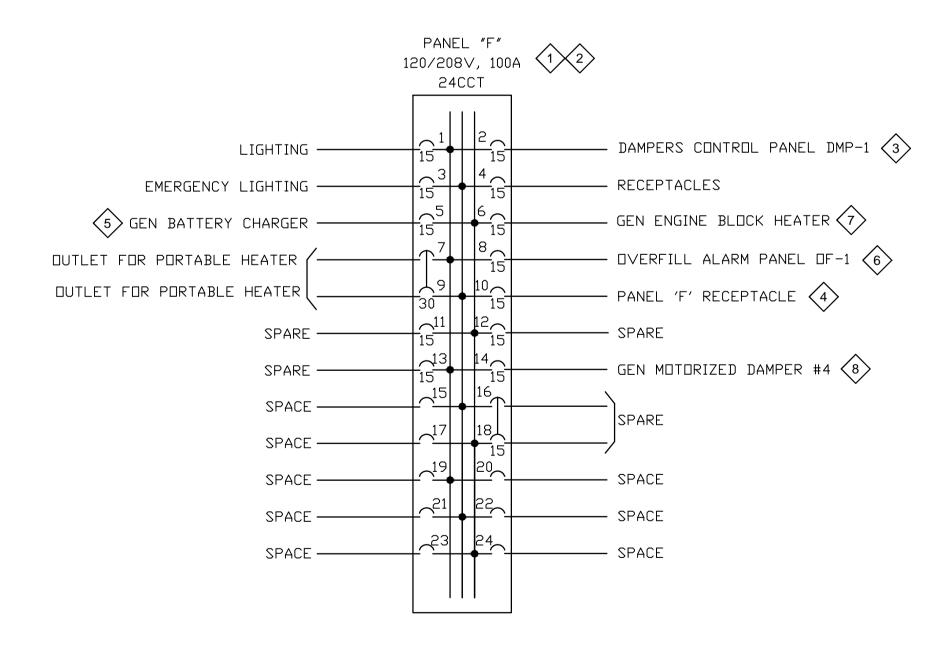
ONTARIO ENVIRONMENT AND CLIMATE CHANGE CANADA

GENERATOR REPLACEMENT

SINGLE LINE DIAGRAM -



<u>DEMOLITION - GENERATOR SHED - PANEL F SCHEDULE</u>



NEW CONSTRUCTION - GENERATOR SHED - PANEL F SCHEDULE

DEMOLITION NOTES

- 1 REMOVE EXISTING POWER FEED TO EXISTING MOTORIZED [」] DAMPERS.
- 2 REMOVE EXISTING POWER FEED TO EXISTING WALL MOUNTED BATTERY CHARGER.
- REMOVE EXISTING POWER FEED TO EXISTING ENGINE COOLANT HEATER.
- 4 REMOVE EXISTING POWER FEED TO EXISTING LOW FUEL ALARM SYSTEM.
- [5] REMOVE EXISTING POWER FEED TO EXISTING BATTERY WARMER.
- 6 APU BUILDING INTERIOR AND EXTERIOR LIGHTS TO BE REPLACED. ☐ EXISTING WIRING AND CONDUIT TO REMAIN.

NEW CONSTRUCTION NOTES

- UPDATE TYPE WRITTEN PANEL SCHEDULE TO AS-BUILT CONDITION AND PROVIDE COPY IN PANELBOARD.
- PROVIDE CIRCUIT ID LABEL ON ALL RECEPTACLES TO INDICATE SOURCE CIRCUIT.
- PROVIDE NEW 2#14AWG T90 + BOND IN 21mm EMT FROM EXISTING
- PROVIDE NEW 2#14AWG T90 + BOND IN 21mm EMT FROM EXIST CIRCUIT BREAKER IN PANEL 'F' TO NEW MOTORIZED DAMPER CONTROL PANEL DMP-1.
- PROVIDE NEW 2#14AWG T90 + BOND IN 21mm EMT FROM EXISTING CIRCUIT BREAKER IN PANEL 'F' TO NEW RECEPTACLE.
- PROVIDE NEW 2#14AWG T90 + BOND IN 21mm EMT FROM EXISTING
- CIRCUIT BREAKER IN PANEL 'F' TO NEW GENERATOR BATTERY
- PROVIDE NEW 2#14AWG T90 + BOND IN 21mm EMT FROM EXISTING CIRCUIT BREAKER IN PANEL 'F' TO NEW OVERFILL ALARM PANEL
- PROVIDE NEW 2#14AWG T90 + BOND IN 21mm EMT FROM EXISTING CIRCUIT BREAKER IN PANEL 'F' TO NEW GENERATOR ENGINE BLOCK
- PROVIDE NEW 2#14 AWG T90 + BOND IN 21mm EMT FROM EXISTING CIRCUIT BREAKER IN PANEL 'F' TO NEW GENERATOR MOTORIZED DAMPER ACTUATOR #4.

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A Detail No. No. du détail B drawing no. - where detail required dessin no. — où détail exigé drawing no. — where detailed

project title titre du projet

KING CITY ONTARIO ENVIRONMENT AND CLIMATE CHANGE CANADA 14780 JANE STREET KING CITY, ON

GENERATOR REPLACEMENT

drawing title titre du dessin ELECTRICAL APU BUILDING PANEL 'F' SCHEDULE

dessine par J.CZYZEWSKI

conc par

soumission

drawing no. dessine no.

T. BIRO

approuve par O. JAN


> administrateur DANIEL VENTURA

project date date date du projet 2017/05/09

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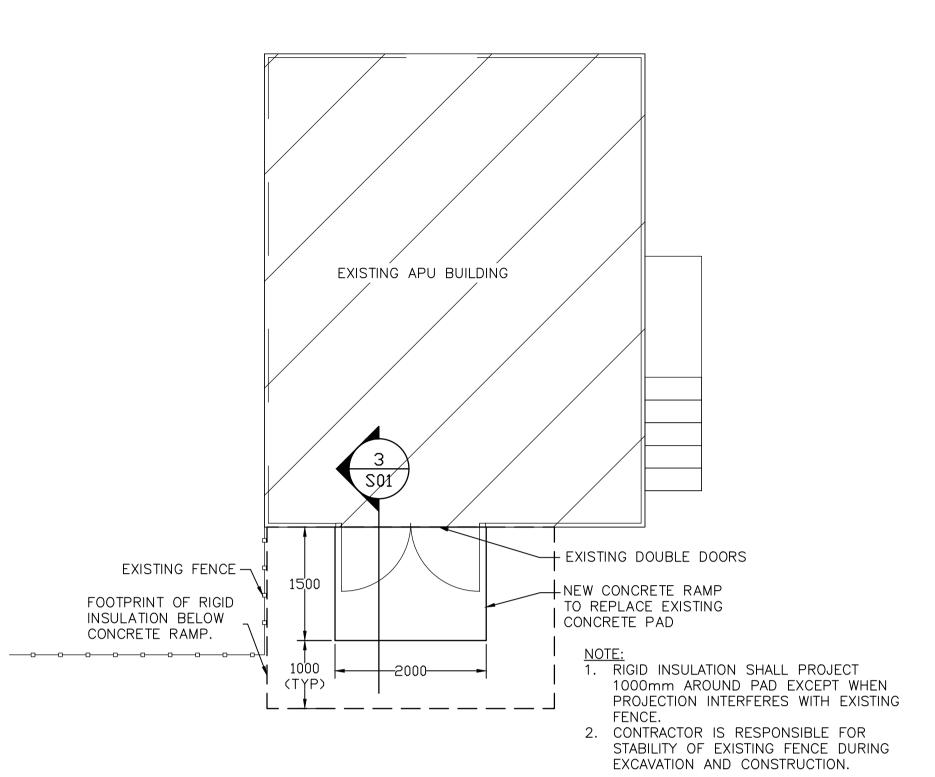
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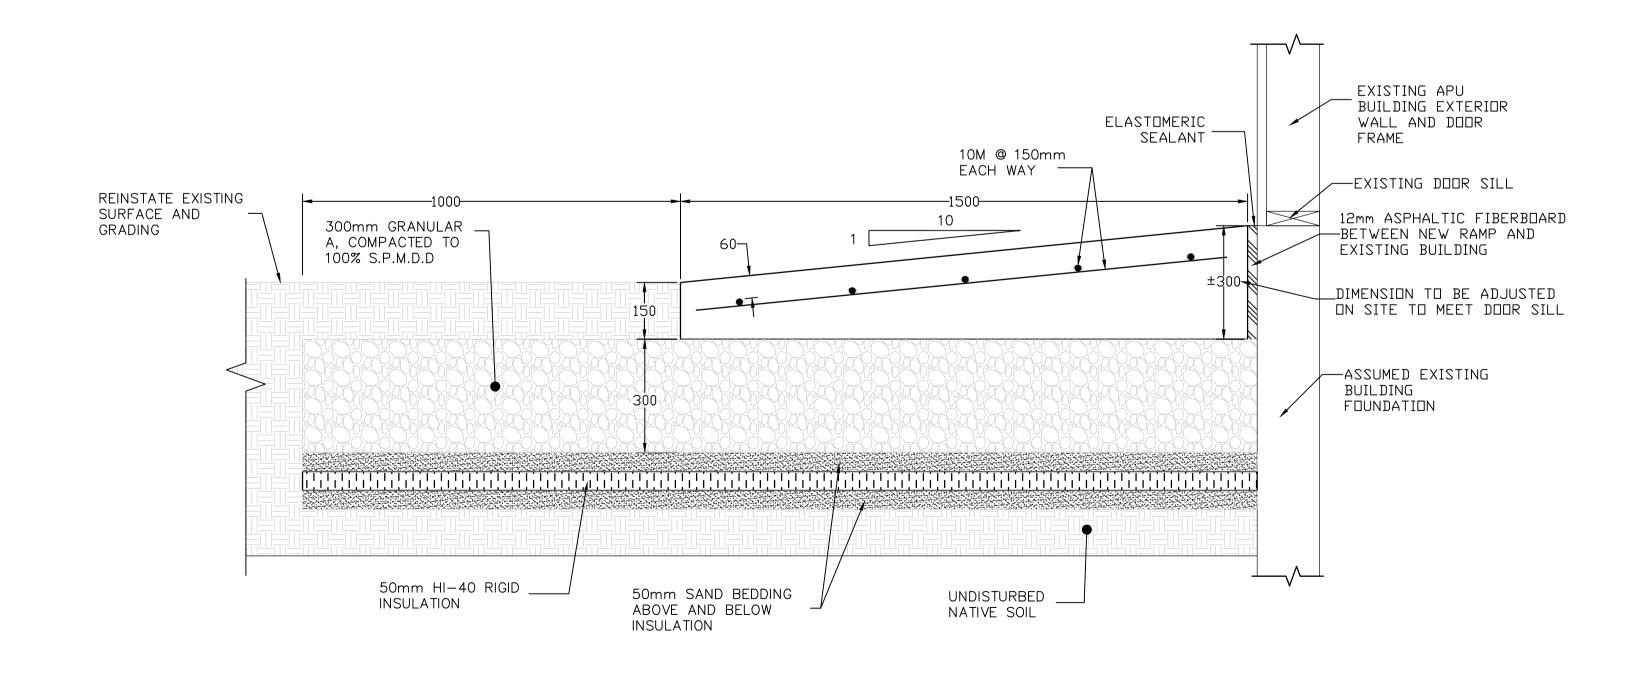


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APU BUILDING CONCRETE PAD DEMOLITION AND EXCAVATION PLAN



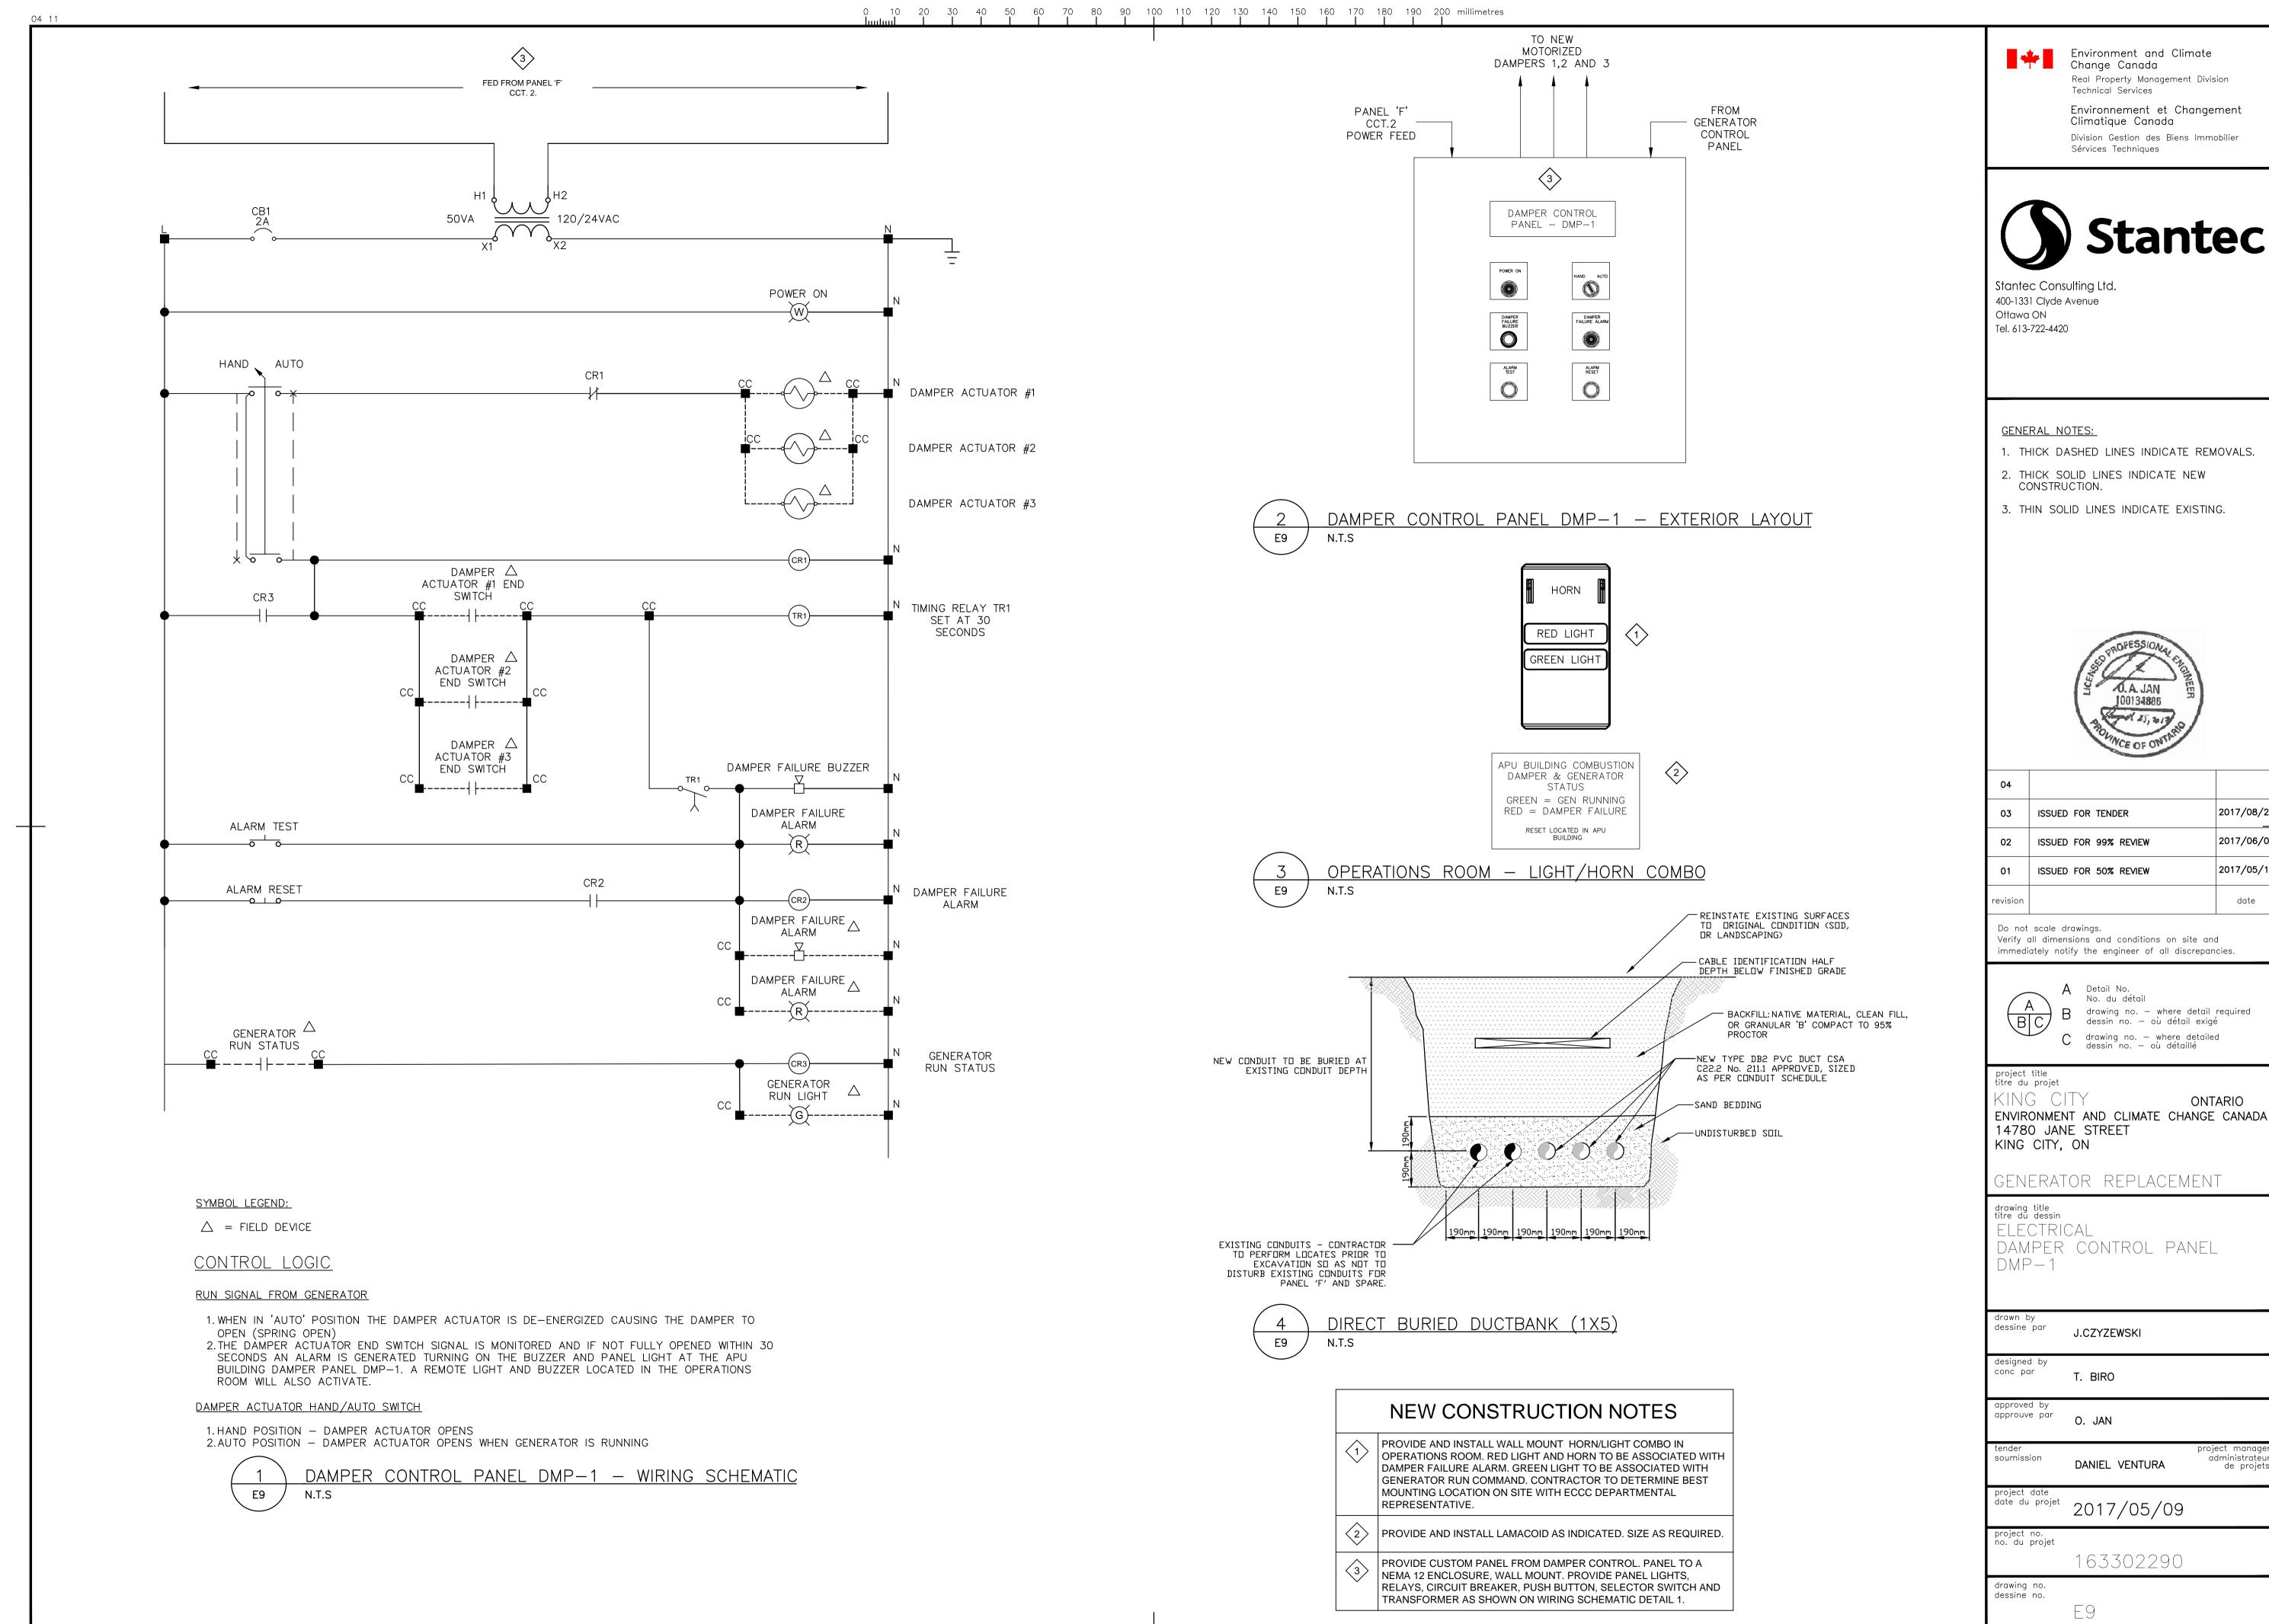

NEW RAMP CROSS-SECTION

CONTRACTOR IS RESPONSIBLE

FOR STABILITY OF EXISTING

FENCE DURING EXCAVATION

AND CONSTRUCTION.

DESIGN NOTES

GENERAL

- 1. ALL CODES REFERENCED ARE TO BE THE LATEST VERSION AT THE DATE OF ISSUE.
- 2. DESIGN IS BASED ON THE 2015 NATIONAL BUILDING CODE.
- 3. READ THESE DESIGN NOTES IN CONJUNCTION WITH THE CONTRACT NMS SPECIFICATIONS AND ALL OTHER CONTRACT DOCUMENTS.
- 4. REVIEW ALL DRAWINGS AND CHECK DIMENSIONS PRIOR TO IMPLEMENTING THE WORK. REPORT ANY DISCREPANCIES TO THE CONSULTANT FOR CLARIFICATION BEFORE PROCEEDING.
- 5. COORDINATE PLACEMENT AND LOCATION OF ITEMS BY SUBSEQUENT
- 6. RELEVANT TRADES SHALL REVIEW PRIOR TO ERECTION AND/OR INSTALLATION.
- 7. NOTIFY THE ENGINEER A MINIMUM OF 24 HOURS PRIOR TO ANY REQUIRED SITE REVIEWS.

CAST-IN-PLACE REINFORCED CONCRETE

- 1. CONCRETE MATERIALS, QUALITY, MIXING, PLACING, FORMWORK AND OTHER CONSTRUCTION PRACTICES TO CONFORM TO CSA-A23.1.
- 2. SUPPLY CONTROLLED CONCRETE IN ACCORDANCE WITH CSA-A23.1 WITH PROPERTIES NOTED IN CONTROLLED CONCRETE TABLE.
- 3. CONCRETE STRENGTH SHALL BE 30MPa AT 28 DAYS.
- 4. CONCRETE EXPOSURE CLASS: C-1
- 5. USE TYPE GU CEMENT FOR ALL CONCRETE UNLESS NOTED OTHERWISE IN CONTROLLED CONCRETE TABLE.
- 6. NOTIFY CONSULTANT 72 HOURS PRIOR TO CONCRETE POURS TO ALLOW FOR REVIEW OF REINFORCEMENT.
- 7. DO NOT USE ADMIXTURES CONTAINING CALCIUM CHLORIDE.

CONCRETE REINFORCEMENT

- 1. REINFORCEMENT STEEL TO CONFORM TO CSA-G30.18 GRADE 400.
- 2. DO NOT WELD REINFORCEMENT UNLESS APPROVED IN WRITING BY THE ENGINEER.
- 3. NOTIFY THE ENGINEER PRIOR TO CONCRETE PLACEMENT TO ALLOW FOR REVIEW OF REINFORCING.
- 4. CLEAR CONCRETE COVER TO REINFORCEMENT
- 4.1. CONCRETE CAST DIRECTLY AGAINST EARTH: 75mm 4.2. ALL OTHER CONCRETE: 60mm
- 5. ALL REINFORCEMENT TO BE SUPPORTED AT 900 mm MAXIMUM SPACING.

CONCRETE FORMWORK

1. DESIGN, FABRICATION, ERECTION, AND OTHER CONSTRUCTION PRACTICES TO CONFORM TO CAN/CSA-S269.3.

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project title titre du projet KING CITY

ONTARIO ENVIRONMENT AND CLIMATE CHANGE CANADA 14780 JANE STREET KING CITY, ON

GENERATOR REPLACEMENT

drawing title titre du dessin

PLAN AND SECTION CONCRETE RAMP

J. FOGARTY

C. VON TEICHMAN

approuve par C .VON TEICHMAN

administrateur de projets soumission DANIEL VENTURA

date du projet 2017/05/09

project no. no. du projet 163302290

drawing no. dessine no.