


- NOTES:**
- CONTRACTOR TO VERIFY ALL DIMENSIONS & SITE CONDITIONS.
 - PROVIDE 3C #12AWG TECK 90 FOR CONNECTION FROM EACH OUTDOOR UNIT TO ITS ASSOCIATED INDOOR UNIT. PROVIDE ONE ADDITIONAL 21MM EMT FROM THE OUTDOOR UNIT FOR MECHANICAL CONTROLS. COORDINATE EXACT LOCATIONS AND TERMINATIONS WITH OWNER.
 - DISCONNECT EXISTING ROOF TOP UNITS AND RECONNECT NEW UNITS. EXTEND/TRIM WIRING
 - DISCONNECT AND REMOVE EXISTING 600V CEILING MOUNTED UNIT HEATER. FEED NEW TRANSFORMER FROM 15A, 600V, 3P BREAKER THAT USED TO FEED ELECTRIC HEATER. REPLACE HEATER WITH NEW 208V, 3PH CEILING MOUNTED UNIT HEATER. FEED NEW HEATER FROM A 3P, 20A BREAKER FROM NEW PANEL T.
 - PROVIDE 3C #12AWG TECK 90 FOR CONNECTION FROM EACH OUTDOOR UNIT TO ITS ASSOCIATED INDOOR UNIT. PROVIDE ONE ADDITIONAL 21MM EMT CONDUIT FROM THE OUTDOOR UNIT FOR MECHANICAL CONTROLS. COORDINATE EXACT LOCATIONS AND TERMINATIONS WITH OWNER. FEED HEAT PUMP FROM A 2P, 30A BREAKER.
 - PROVIDE AND INSTALL ONE (1) 20A TYPE 5-20R CONVENIENCE RECEPTACLE WITH WEATHERPROOF COVER FOR THE ROOFTOP UNIT.

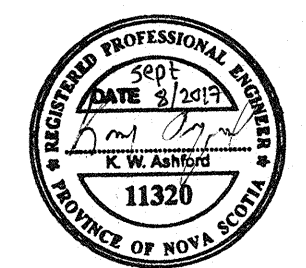


2	ISSUED FOR TENDER	SEP 8 2017
1	ISSUED FOR TENDER	AUG 10 2017
0	ISSUED FOR TENDER	JUL 28 2017
B	ISSUED FOR REVIEW	MAY 16 2017
A	ISSUED FOR REVIEW	MAR 26 2017
revisions		date

project
**CANSO CANAL
PORT HASTINGS,
INVERNESS COUNTY, NS
HEAT PUMPS**

drawing
ELECTRICAL POWER


**ADMINISTRATION BUILDING
NORTH AND SOUTH
FENDER HOUSES**

designed	KB	conçu
date	SEP 8 2017	
drawn	KB	dessiné
date	SEP 8 2017	
approved		approuvé
date		
Tender	2017-09-13	Submission
PWSC Project Manager	Administrateur de projets TPSCG	
project number		no. du projet
	R.090672.001	
drawing no.		no. du dessin
	E1	

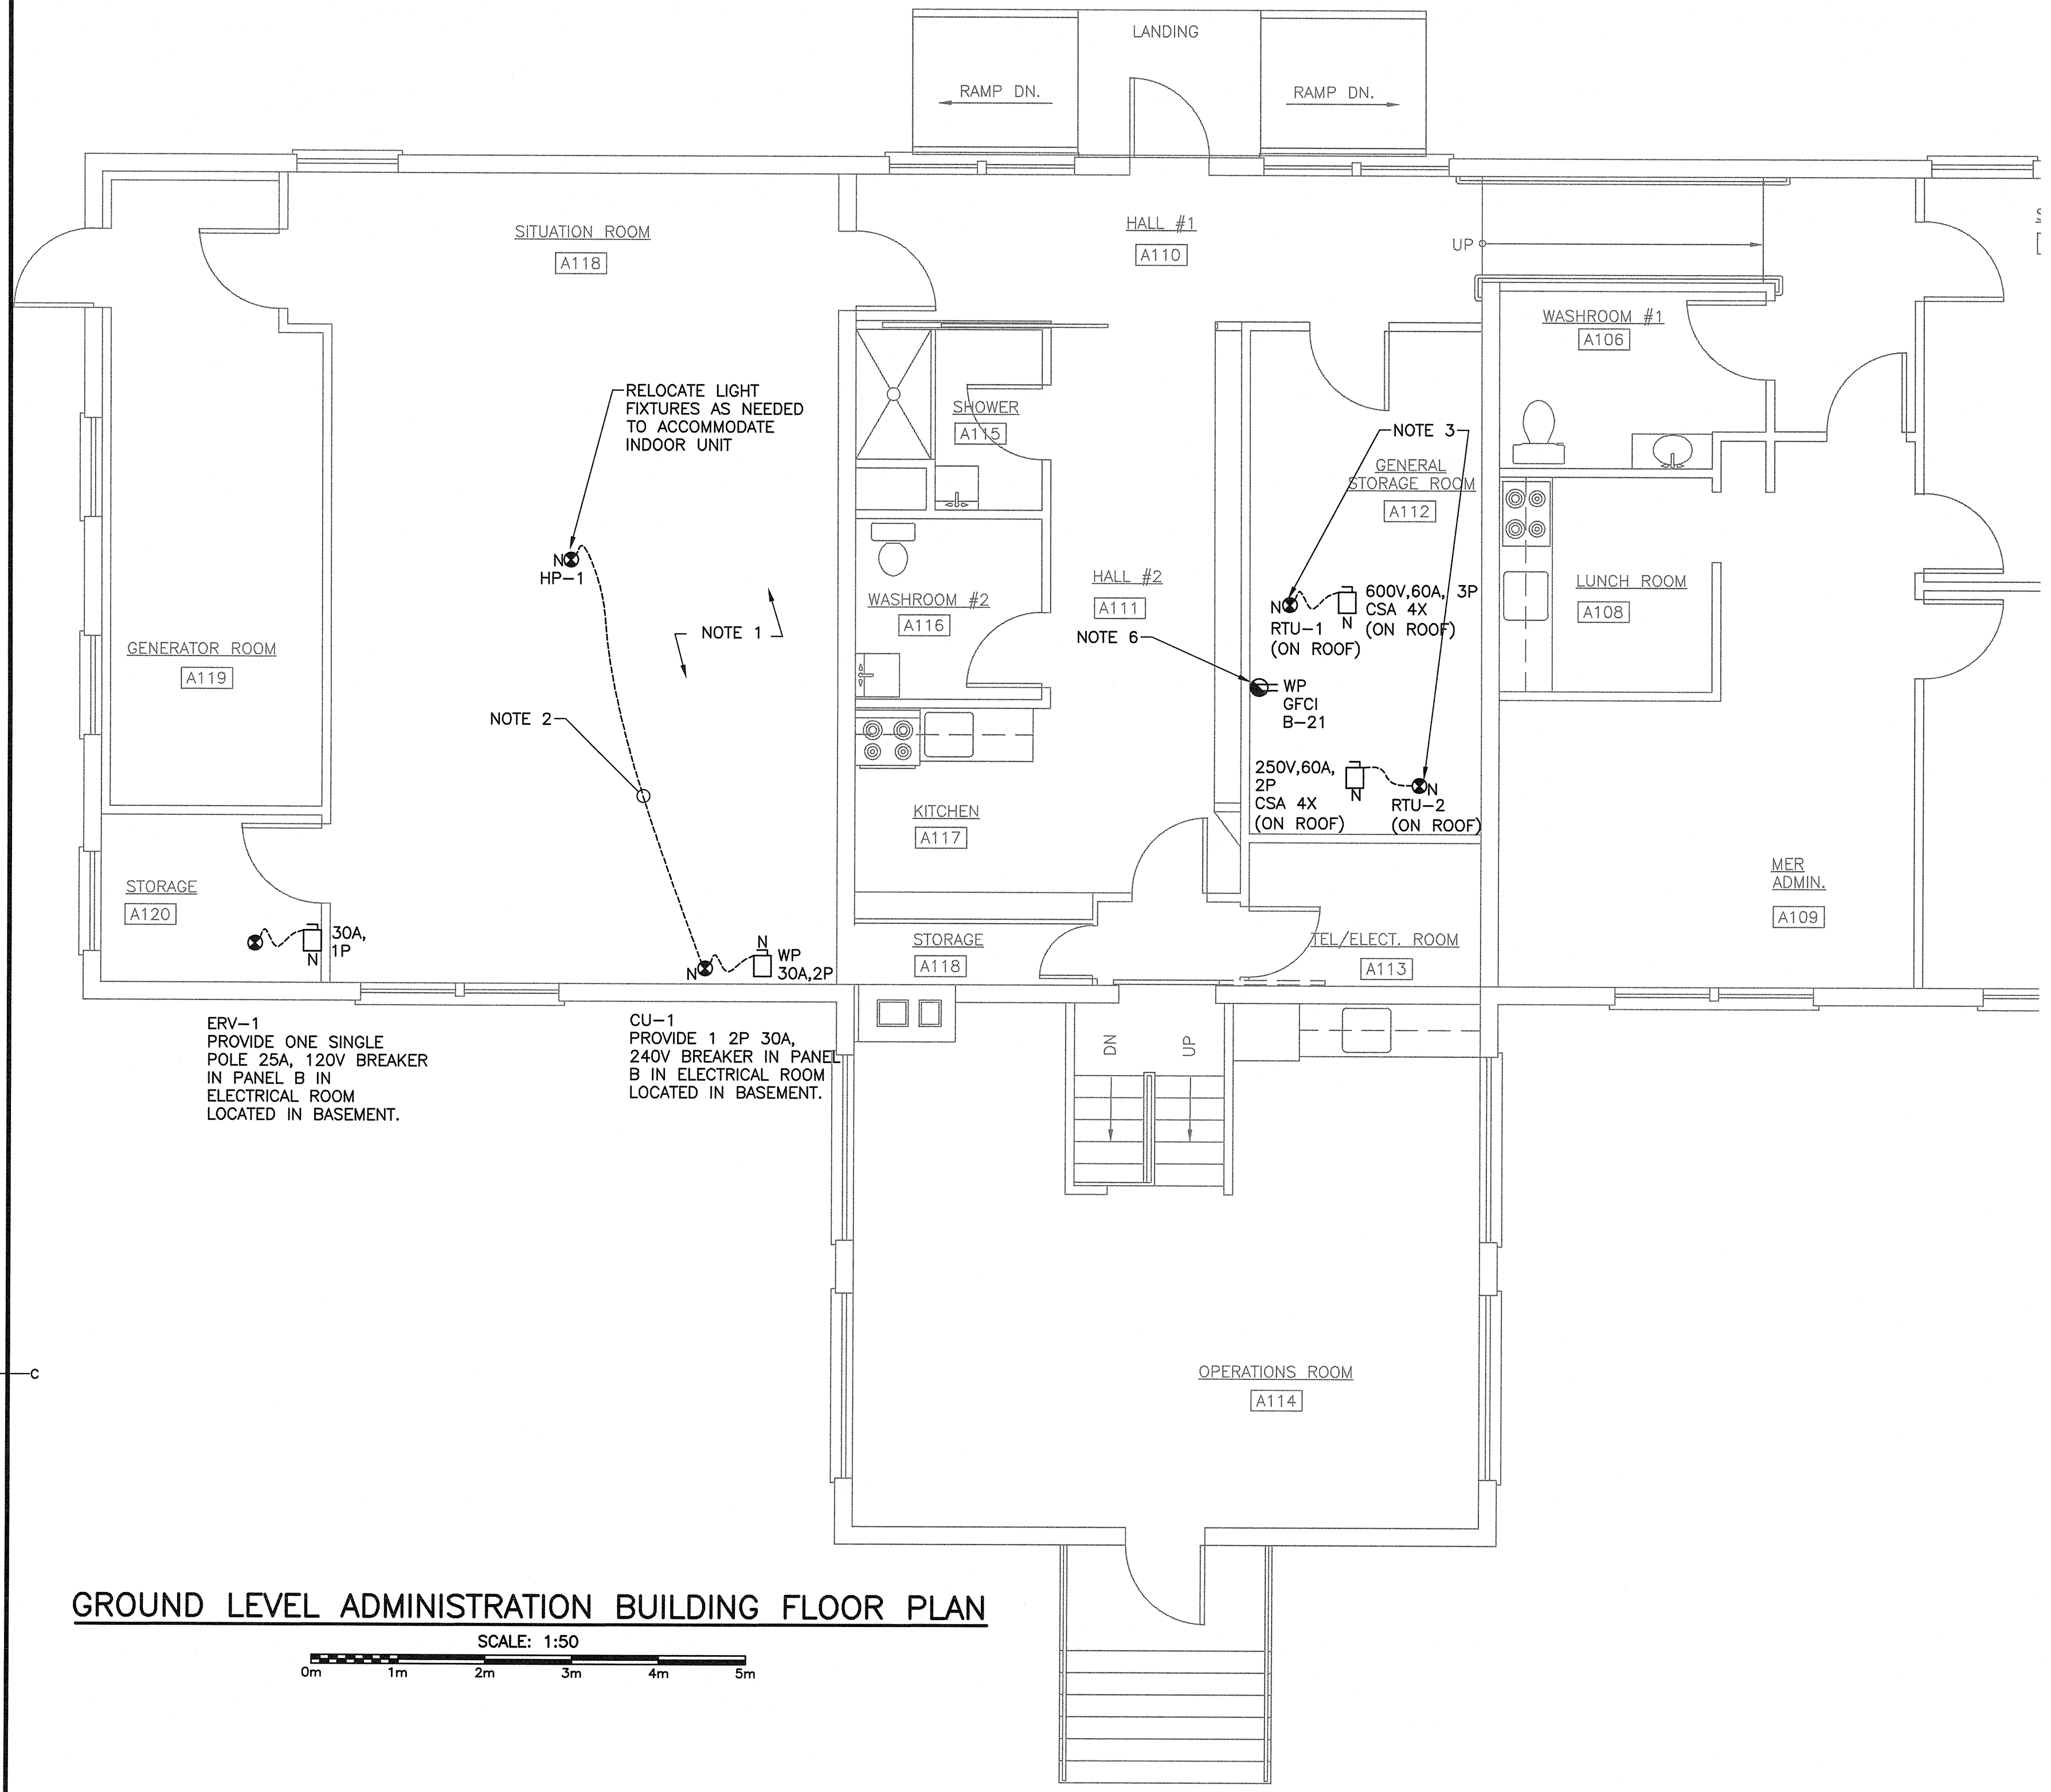


GROUND LEVEL ADMINISTRATION BUILDING FLOOR PLAN

SCALE: 1:50
0m 1m 2m 3m 4m 5m

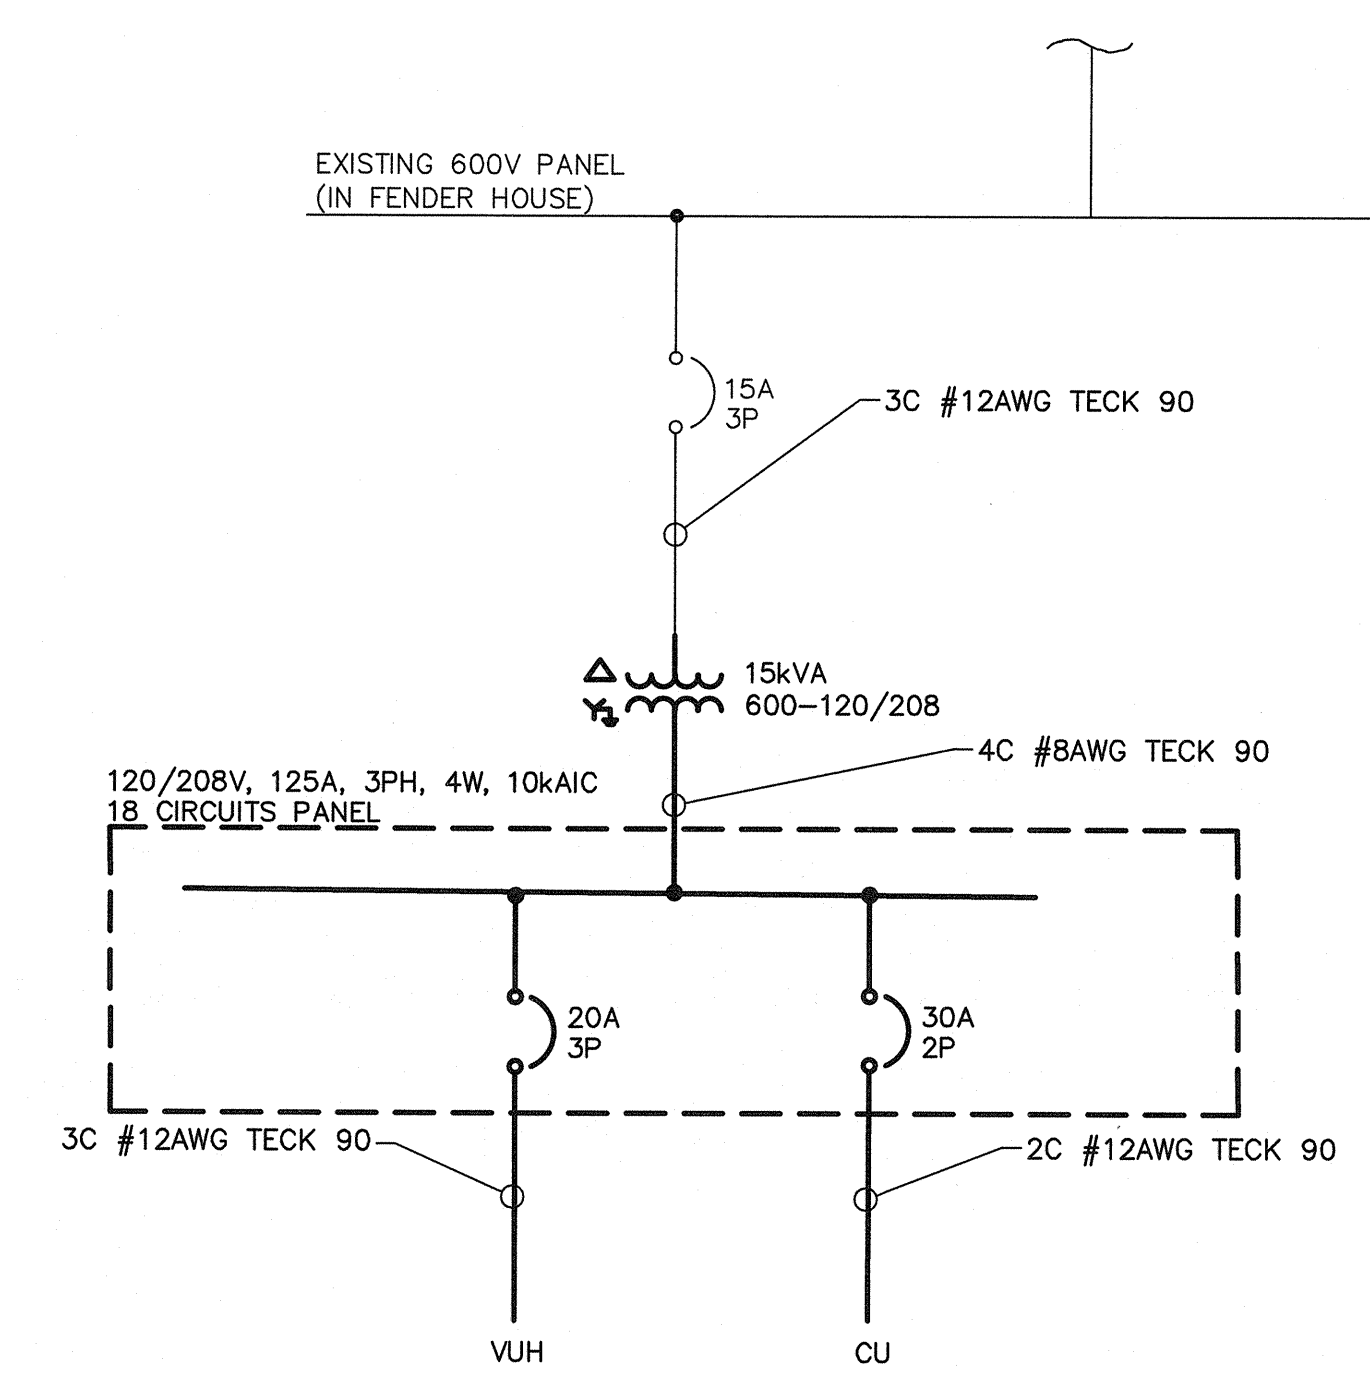


PARTIAL SINGLE LINE DIAGRAM - TYPICAL FOR BOTH FENDER HOUSES

- LEGEND:**
- PANEL
 - DISCONNECT SWITCH
 - ELECTRICAL DIRECT CONNECTION
- ANNOTATION:**
- N - NEW
 - EX - EXISTING TO BE REMOVED
 - UH - UNIT HEATER
 - WP - WEATHER PROOF
 - GFCI - GROUND FAULT CIRCUIT INTERRUPTER

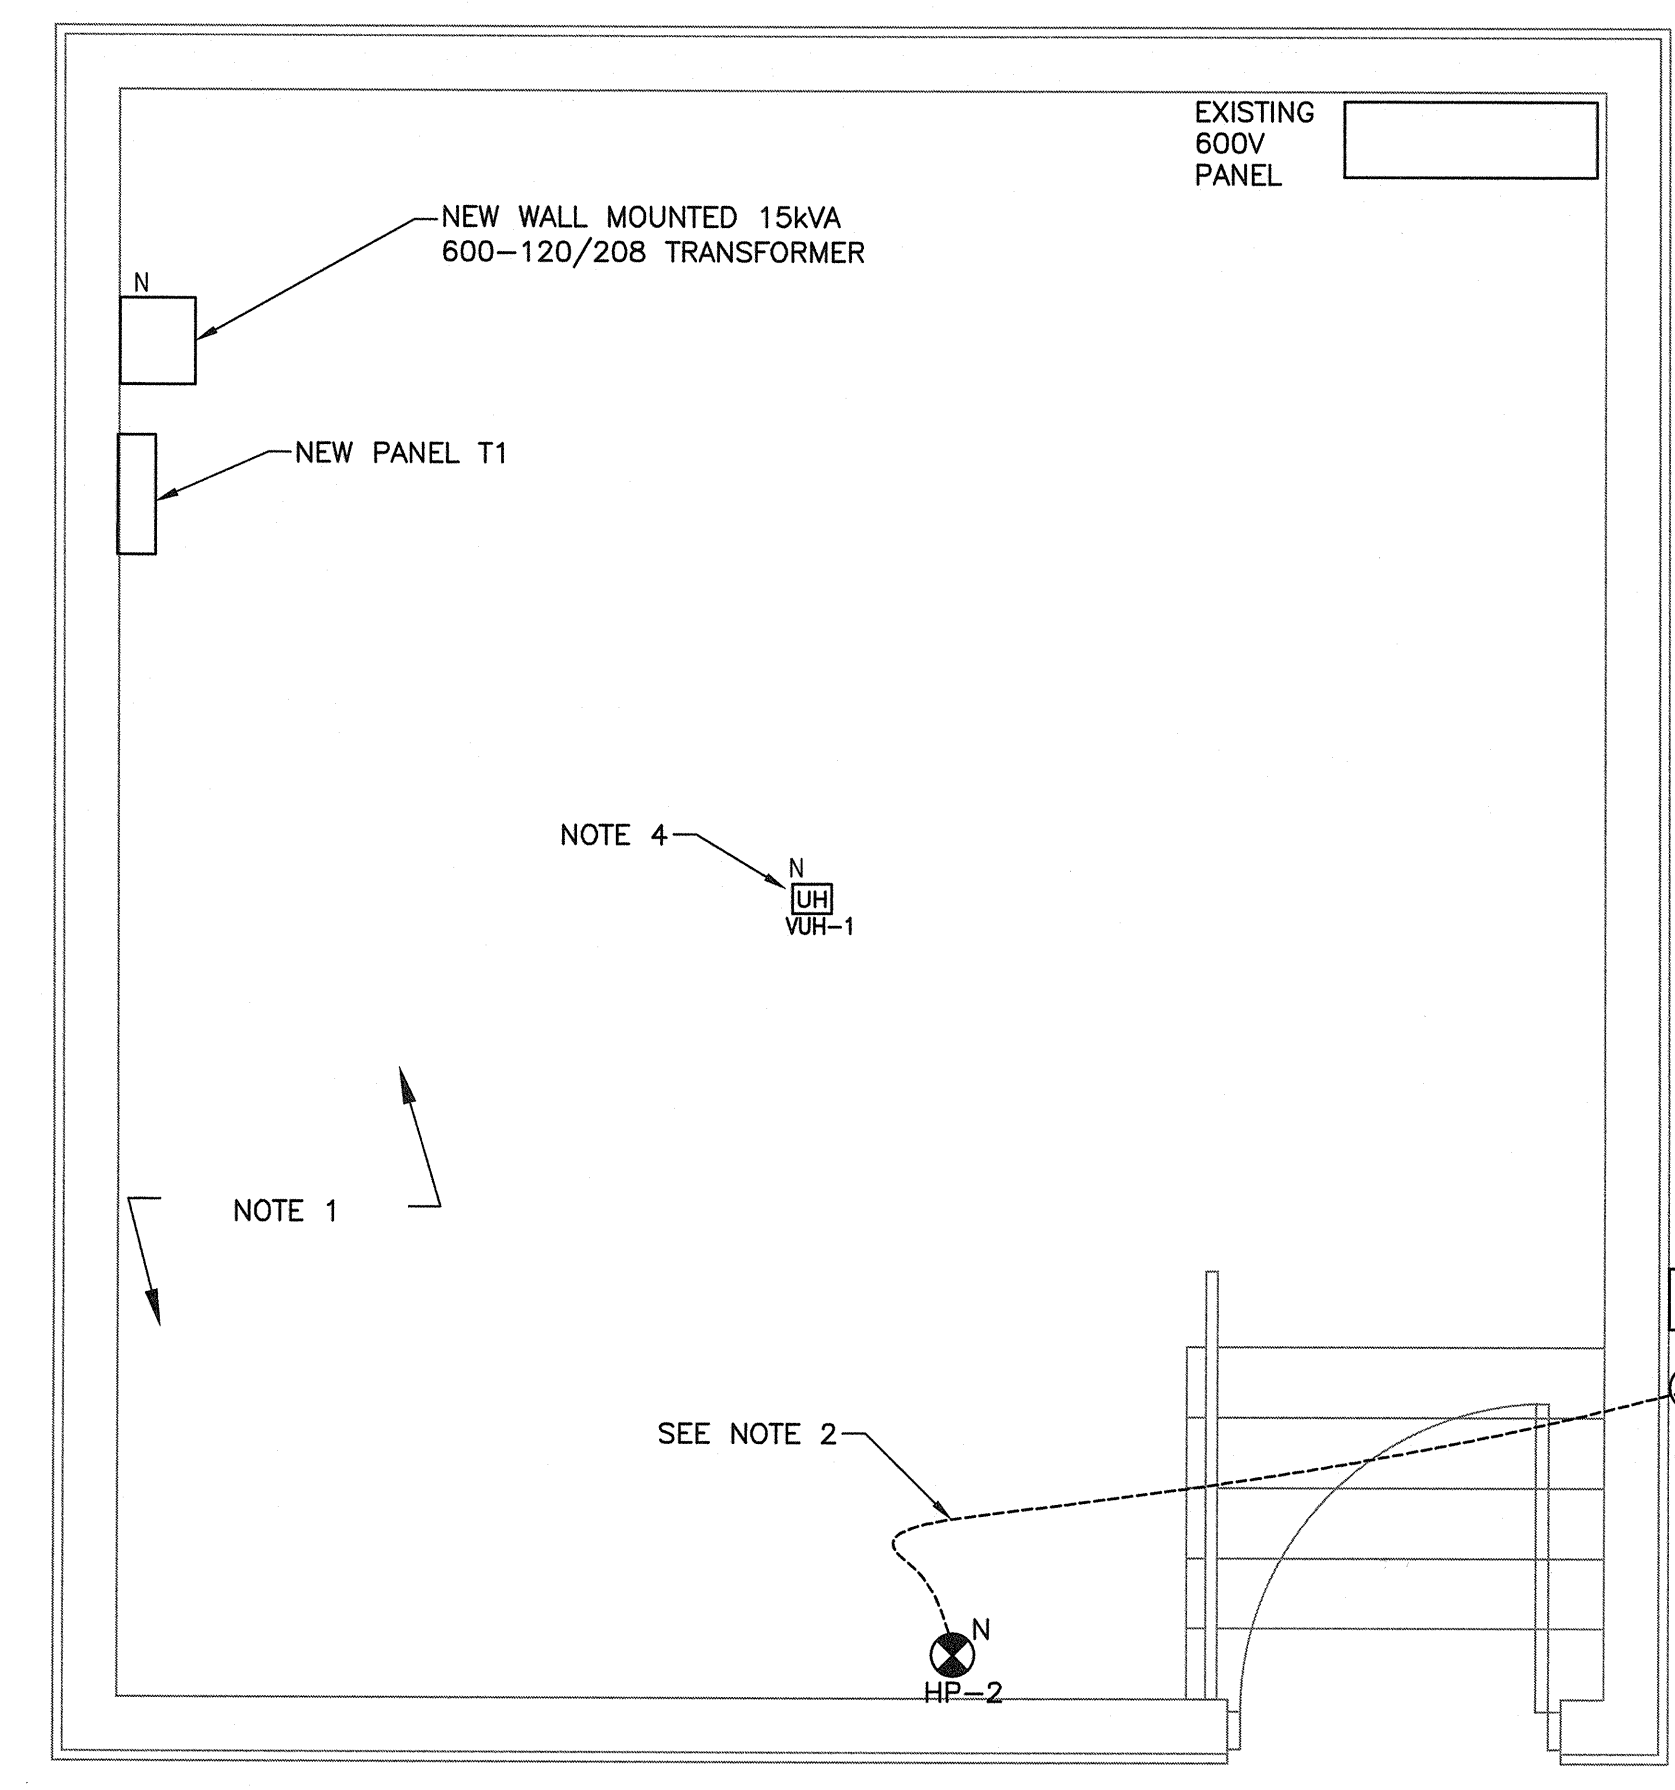

NORTH FENDER HOUSE FLOOR PLAN

SCALE : 1:30
0mm 500mm 1000mm 1500mm 2000mm 2500mm 3000mm

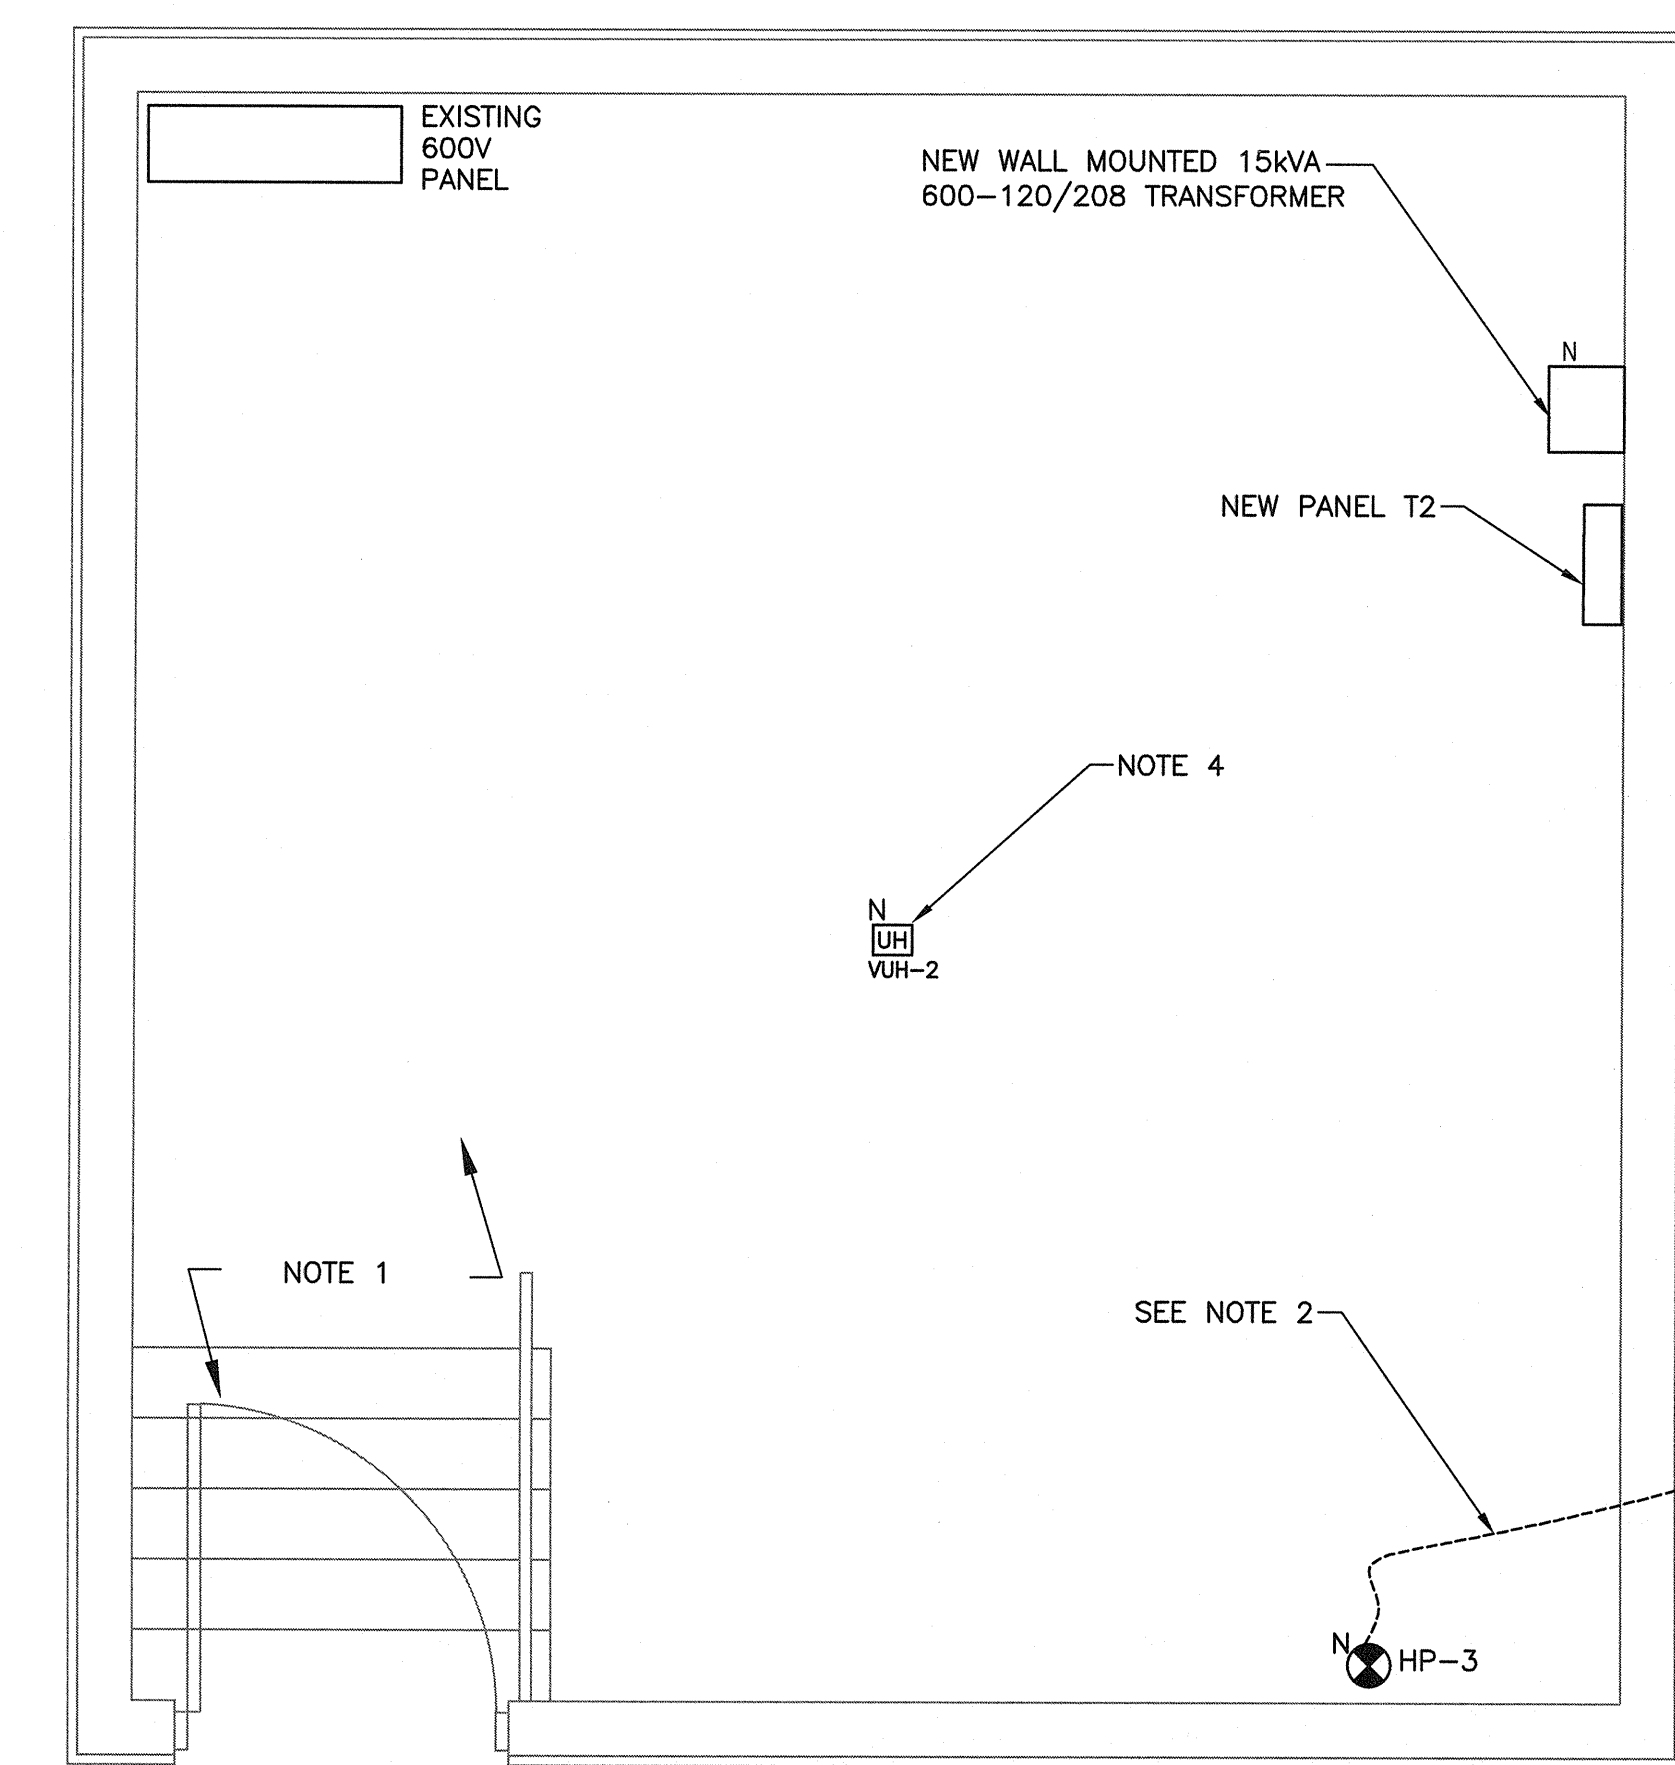

SOUTH FENDER HOUSE FLOOR PLAN

SCALE : 1:30
0mm 500mm 1000mm 1500mm 2000mm 2500mm 3000mm