

**GENERAL NOTES**

1. THE WORK SHALL BE IN ACCORDANCE WITH THE NATIONAL BUILDING CODE OF CANADA (NBCC) 2016 REGULATIONS UNLESS NOTED OTHERWISE ON THE DRAWINGS.
2. COMPLY WITH ALL LOCAL, MUNICIPAL, AND PROVINCIAL BYLAWS AND REGULATIONS.
3. CONTRACTOR TO VERIFY LOCATION OF ALL UTILITIES PRIOR TO EXCAVATION.
4. IT IS THE CONTRACTOR'S RESPONSIBILITY TO OBTAIN ALL NECESSARY PERMITS TO PERFORM THE WORK.
5. INTERIOR DIMENSIONING TYPICALLY TAKEN TO CENTERLINE OF INTERIOR WALLS AND OUTSIDE FACE OF EXTERIOR STUDS/GRID LINES.
6. ALL PRODUCTS INSTALLED AS PER MANUFACTURER'S INSTRUCTIONS AND AS REQUIRED FOR WARRANTY COVERAGE (SEE SPECIFICATIONS).
7. CONTRACTOR TO VERIFY ALL DIMENSIONS AND CONDITIONS ON-SITE.
8. WHERE NEW WORK ABUTS EXISTING, PERFORM A SMOOTH, EVEN, AND UNNOTICEABLE TRANSITION.

DOOR AND FRAME SCHEDULE									
ROOM NAME/NUMBER	DOOR NUMBER	DOOR				FRAME			NOTES
		TYPE	MATERIAL	FINISH	SIZE(WxH)	FIRE RATING	TYPE	MATERIAL	
CID DEPARTM. 100	100.1	EX	EX	PT	EX		EX	EX	PT
CID DEPARTM. 100	100.2	EX	EX	PT	915x2134		EX	EX	PT
VAULT SECURE 101	101.1	D1	HM	PT	915x2134	45 MIN.	F1	PS	PT
F&A WORKSTA. 102	102.1	EX	EX	PT	EX		EX	EX	PT
F&A WORKSTA. 102	102.2	D1	HM	PT	915x2134		F1	PS	PT
OFFICE 103	103.1	EX	EX	PT	EX		EX	EX	PT

PS = PRESSED STEEL PT = PAINT ST = STAIN WD = WOOD FR = FIRE RATED HM = HOLLOW METAL EX = EXISTING  
NOTE: ALL FRAMES PAINTED ARE TO MATCH ADJACENT WALLS. REFER TO SPECIFICATIONS FOR HARDWARE.

**FLOOR PLAN NOTES**


1. ALL PENETRATIONS IN RATED ASSEMBLIES FOR PLUMBING OR ELECTRICAL RUNS ARE TO BE SEALED/FIRESTOPPED AS REQUIRED.
2. ALL STEEL STUDS AND WOOD FRAMING TO BE CONSTRUCTED OF ULC/CSA APPROVED MATERIALS AND LATERALLY STRAPPED AND SUPPORTED AS PER NBCC 2010 STRUCTURAL REQUIREMENTS.
3. DOORS, FRAMES AND HARDWARE TO MATCH WALL FIRE RESISTANCE RATING.
4. PROVIDE BLOCKING IN ALL WALLS WHERE CABINETS, SHELVING, GRAB BARS AND ALL WALL MOUNTED EQUIPMENT IS NOTED.
5. REPAIR AND MAKE GOOD ALL EXISTING WALL TO NEW WALL CONNECTIONS AS REQUIRED.

LEGEND	
	NEW WALL
	EXISTING WALL
	ROOM NAME & NUMBER
	WALL TYPE IN PLAN
	DOOR NUMBER
	1 HR FIRE RATING
	NOT PART OF CONTRACT

WALL TYPE	DESCRIPTION	FIRE RATING	STC RATING
W1	EXISTING WALL ASSEMBLY TO REMAIN - EXISTING GWB - EXISTING CONCRETE BLOCK - EXISTING GWB (NEWLY PAINTED)		52
W2	- NEW PAINTED GWB WHERE REQUIRED TO MATCH EXISTING ADJACENT WALL FINISH - NEW CMU BLOCK WALL IN-FILL (SIZE TO MATCH EXISTING) - NEW STRAPPING TO INSIDE FACE OF WALL TO MATCH ADJACENT WALL TYPE - NEW PAINTED GWB TO INSIDE FACE OF WALL WHERE REQUIRED TO MATCH ADJACENT WALL FINISH NOTE: CONTRACTOR TO SECURE NEW BLOCK WALL TO EXISTING BLOCK WALL WITH METAL DOWELS AT 600 MM O.C.		52
W3	- EXISTING GWB - EXISTING STUDS - EXISTING GWB - NEW 140 MM CONCRETE BLOCK TO INSIDE FACE OF WALL - NEW 38 x 38 MM HORIZONTAL WOOD STRAPPING TO INSIDE FACE OF WALL - NEW 12.7 MM PAINTED GWB TO INSIDE FACE OF WALL NOTE: CONTRACTOR TO SECURE NEW BLOCK WALL TO EXISTING BLOCK WALL WITH METAL DOWELS AT 600 MM O.C.	1 HR	52
W4	- EXISTING BLOCK WALL - NEW 38 x 38 MM HORIZONTAL WOOD STRAPPING AT 600 MM O.C. TO INSIDE FACE OF WALL - NEW (2) LAYERS 15.9 MM TYPE 'X' PAINTED GWB TO INSIDE FACE OF WALL NOTE: EXTEND NEW STRAPPING AND GWB AROUND EXISTING CONCRETE BLOCK COLUMNS.		52
W5	- (2) LAYERS 15.8 MM TYPE 'X' PAINTED GWB - 31 x 64 MM STEEL STUDS SPACED AT 400 MM O.C. - METAL MESH TO OUTSIDE FACE OF STUDS (CID DEPARTMENT SIDE) - 65 MM THICK ABSORPTIVE MATERIAL - (1) LAYER 15.9 MM TYPE 'X' PAINTED GWB NOTE: SEE SPECIFICATIONS FOR METAL MESH FASTENING DETAILS.	1 HR	
W6	- (1) LAYER 15.9 MM TYPE 'X' PAINTED GWB - 31 x 92 MM STEEL STUDS SPACED AT 400 MM O.C. - 89 MM THICK ABSORPTIVE MATERIAL - (2) LAYERS 15.9 MM TYPE 'X' PAINTED GWB		52

NOTE: ALL WALLS TO EXTEND SLAB TO SLAB AND FASTENED AS PER SPECIFICATIONS.


VAULT SECURE ROOM TO HAVE CONTINUOUS 1 HR FIRE RATING  
HIGH DENSITY SHELVING TO BE INSTALLED TO INDUSTRY STANDARDS. SHELVING SUPPLIED BY DEPARTMENT REPRESENTATIVE. CONTRACTOR IS RESPONSIBLE FOR DE-MOUNTING AND RE-INSTALLING. REFER TO KEY PLAN FOR CURRENT LOCATION. TRACKS FOR RE-PURPOSED HIGH DENSITY SHELVING TO BE RECESSED IN EXISTING CONCRETE FLOOR. RE-PURPOSE EXISTING TRACKS IF POSSIBLE, PROVIDE NEW OTHERWISE.

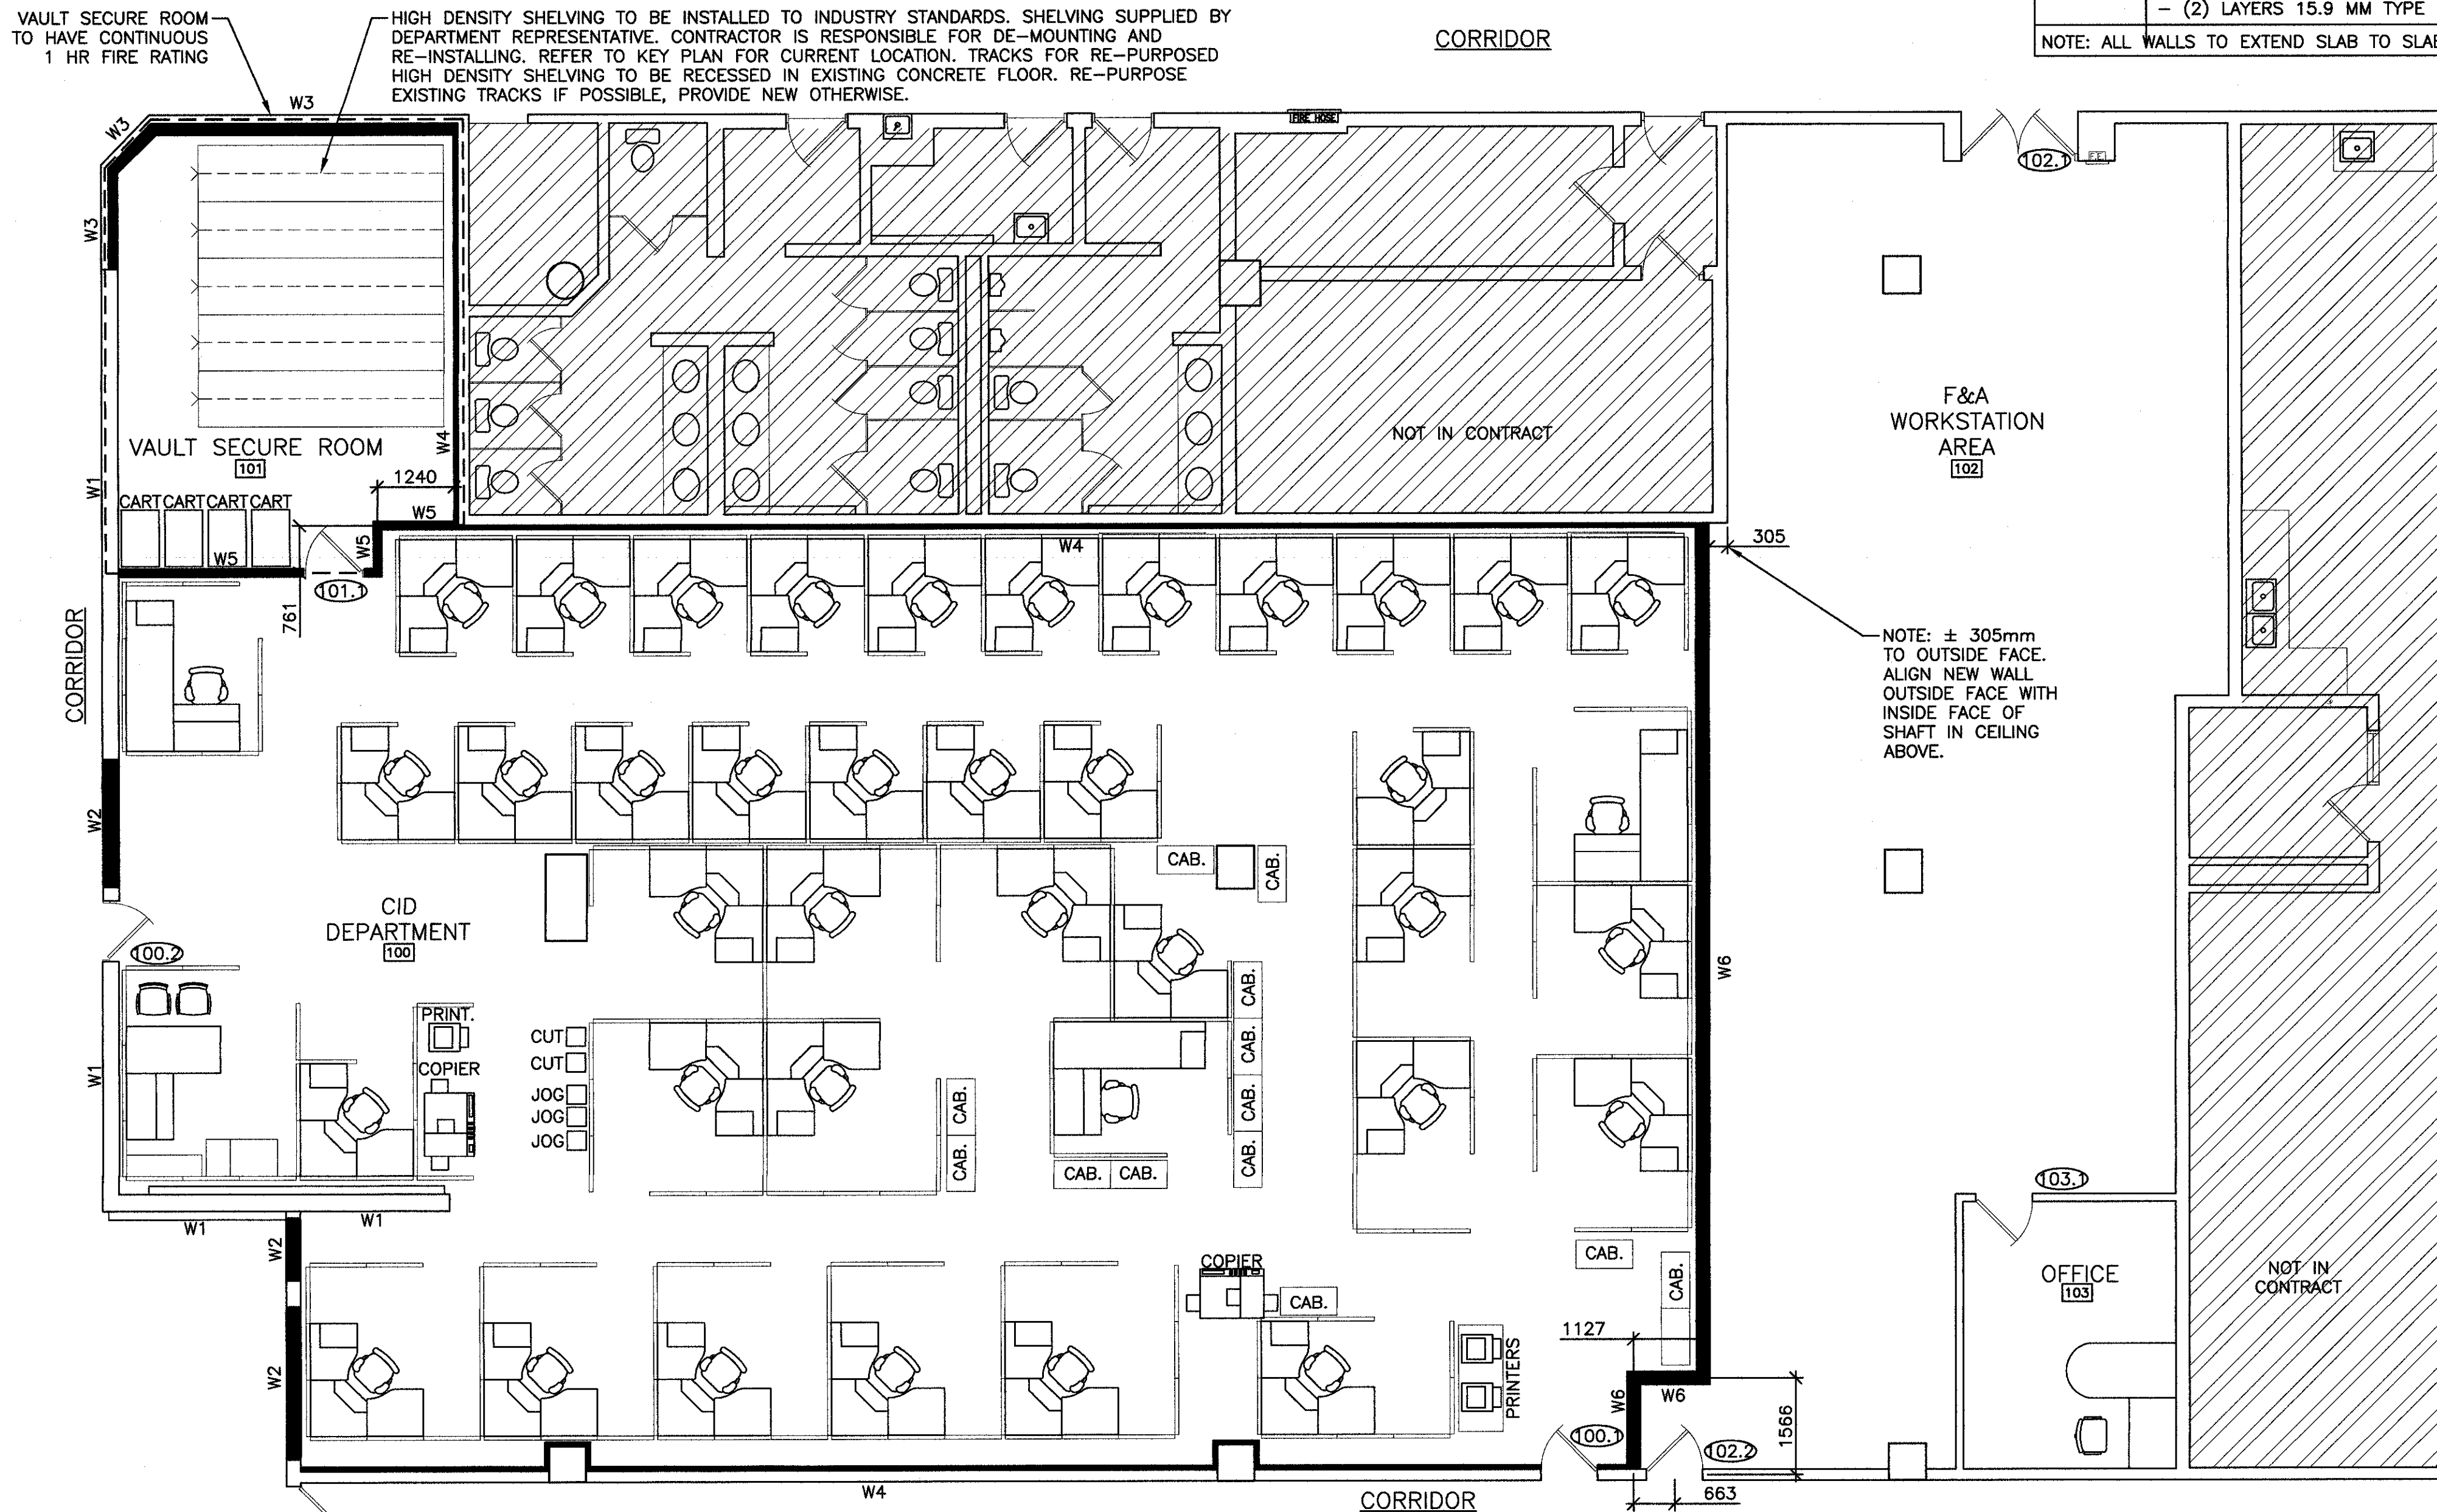

**MAIN FLOOR PLAN**

SCALE/ÉCHELLE : 1:75


1  
A2

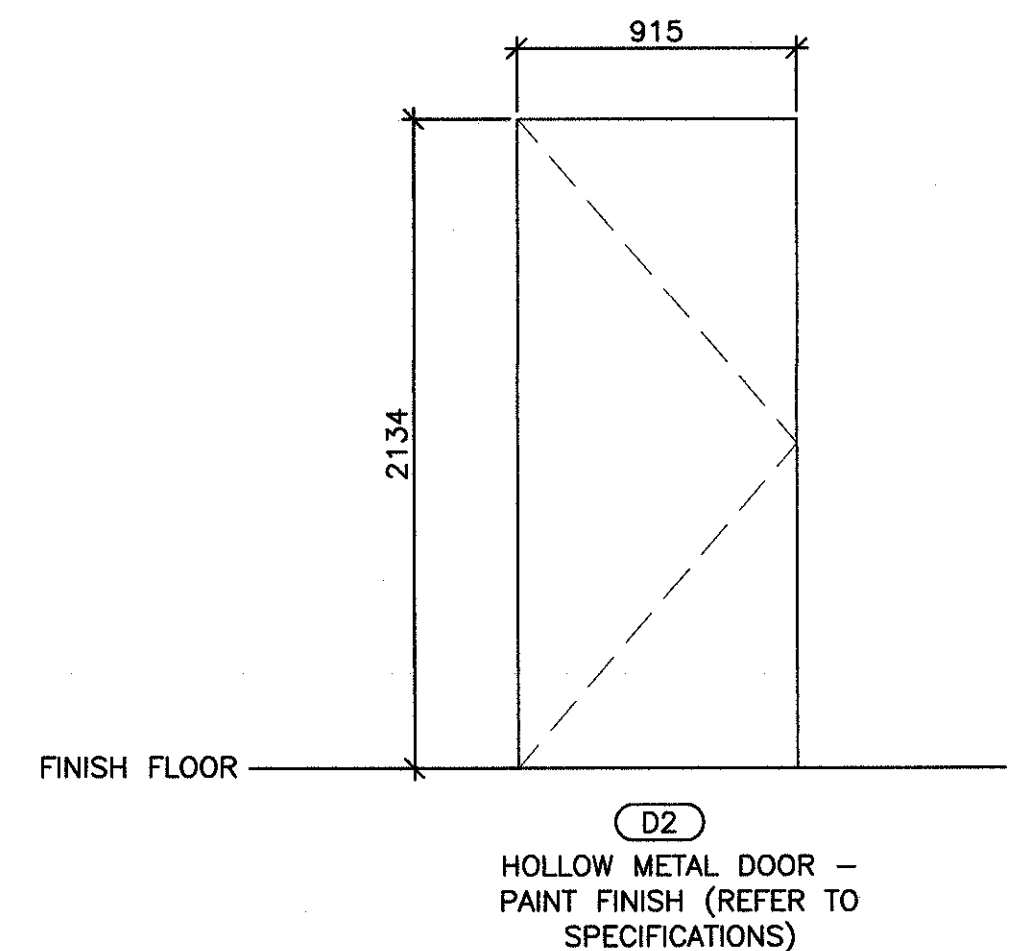

**DOOR ELEVATIONS**

SCALE/ÉCHELLE : 1:25

2  
A2

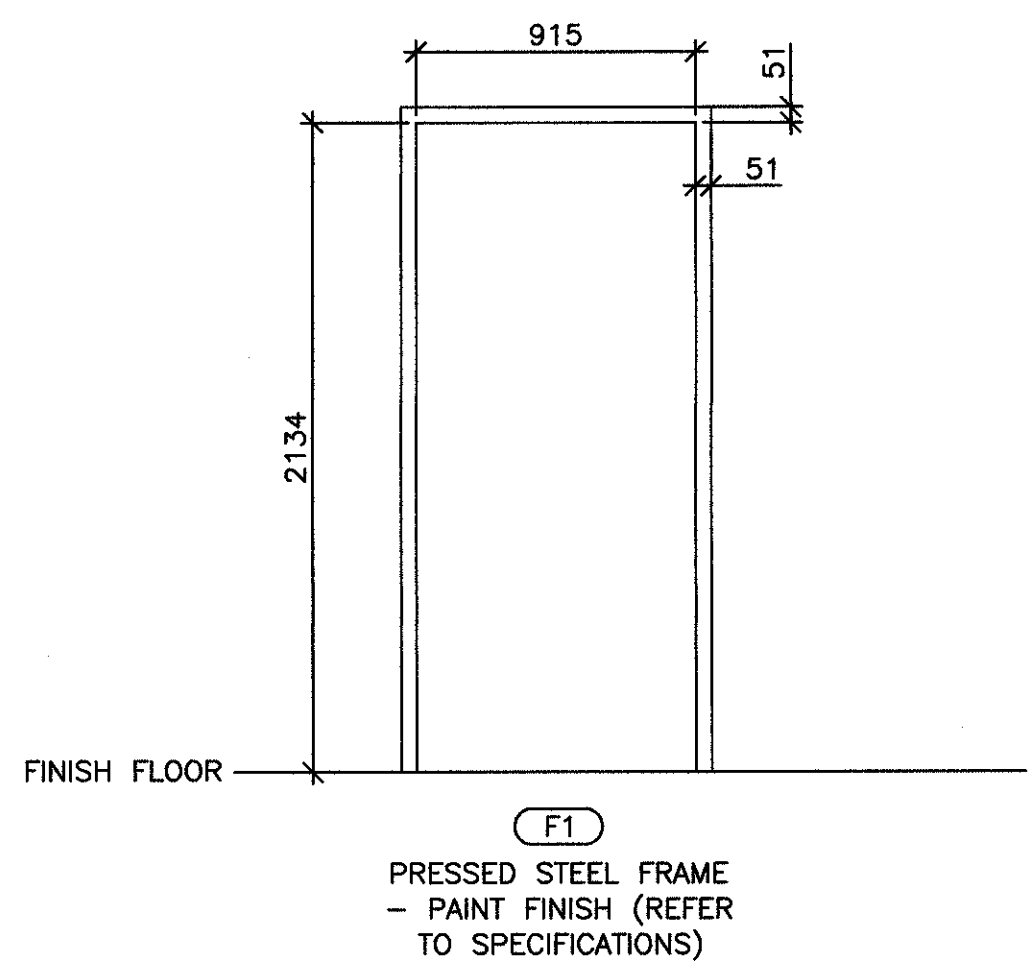

**FRAME ELEVATION**

SCALE/ÉCHELLE : 1:25

3  
A2

1.	ISSUED FOR TENDER	17.10.03
revisions		date
project		project
<b>CID OFFICE RENOVATION - JOSEPH A. GHIZ BUILDING SUMMERSIDE/PE</b>		
drawing		08850H
<b>MAIN FLOOR PLAN</b>		
designed	ROBERT HAGGIS; AIA, RAIC	conçu
date	2017-08-02	
drawn	FVI	dessiné
date	2017-10-03	
approved		approuvé
date		
Tender		Soumission
PWGSC Project Manager	Administrateur de projets TP50C	
project number		no. du projet
<b>R.090981.001</b>		
drawing no.		no. du dessin
<b>A2 of 4</b>		