

INTERIOR PARTITION TYPES				
PLAN GRAPHIC (NTS)	TYPE	FIRE RATING	DESCRIPTION	NOTES
	◀ PT-1	N/A	<b>TYPICAL PARTITION:</b> - 16mm ABUSE-RESISTANT GYPSUM BOARD, TAPE, SAND & SEAL ALL JOINTS - 152mm x 31.75mm (1.2mm THICK) "BAILEY" STRUCTURAL STEEL STUDS @ 300 O.C. (FILL CAVITY w/ SOUND BATT INSULATION) - 16mm ABUSE-RESISTANT GYPSUM BOARD, TAPE, SAND & SEAL ALL JOINTS	PARTITIONS TO EXTEND TO U/S OF ROOF S.I.P., UNLESS OTHERWISE NOTED
	◀ PT-1a	N/A	- SAME AS PT-1 'MINUS' 16mm GYPSUM BOARD @ INSIDE OF CHASE	
	◀ PT-1b	N/A	- SAME AS PT-1 EXCEPT USE 152mm "BAILEY" STRUCTURAL STEEL STUDS @ 300 O.C.	- ULC W415
	◀ PT-1c	N/A	- SAME AS PT-1 'PLUS' 22mm RESILIENT CHANNEL (ONE SIDE ONLY AS SHOWN IN SECTOR PLANS A40-01 TO A40-04)	
	◀ PT-2	N/A	<b>TYPICAL PARTITION:</b> - 16mm ABUSE-RESISTANT GYPSUM BOARD, TAPE, SAND & SEAL ALL JOINTS - 92mm STEEL STUDS @ 400 O.C. (FILL CAVITY w/ SOUND BATT INSULATION) - 16mm ABUSE-RESISTANT GYPSUM BOARD, TAPE, SAND & SEAL ALL JOINTS	
	◀ PT-2a	N/A	- SAME AS PT-2 'MINUS' 16mm GYPSUM BOARD @ INSIDE OF CHASE	
	◀ PT-2b	1 HR	<b>TYPICAL PARTITION:</b> - 16mm "TYPE-X" GYPSUM BOARD, TAPE, SAND & SEAL ALL JOINTS - 92mm STEEL STUDS @ 400 O.C. (NO CAVITY INSULATION) - 16mm "TYPE-X" GYPSUM BOARD, TAPE, SAND & SEAL ALL JOINTS	- ULC W415 - STC 38
	◀ PT-3	N/A	<b>TYPICAL PARTITION:</b> - 16mm ABUSE-RESISTANT GYPSUM BOARD, TAPE, SAND & SEAL ALL JOINTS - 64mm STEEL STUDS @ 400 O.C. (FILL CAVITY w/ SOUND BATT INSULATION) - 16mm ABUSE-RESISTANT GYPSUM BOARD, TAPE, SAND & SEAL ALL JOINTS	
	◀ PT-3a	N/A	- SAME AS PT-3 'MINUS' 16mm GYPSUM BOARD @ INSIDE OF CHASE	
	◀ PT-4	1 HR	<b>FIRE RATED COLUMN ENCLOSURE:</b> - REFER TO DETAIL X/XXXX - 41mm STEEL STUDS @ 600 O.C. (FILL CAVITY w/ BATT INSULATION) - 2 LAYERS OF 16mm "TYPE-X" GYPSUM BOARD, TAPE, SAND & SEAL ALL JOINTS	- UL X528 - STC 53
	◀ PT-5	N/A	<b>SOUND WALL:</b> - 2 LAYERS OF 16mm "TYPE-X" GYPSUM BOARD, TAPE, SAND & SEAL ALL JOINTS - 41mm STEEL STUDS @ 400 O.C. (FILL STUD CAVITY w/ 64mm BATT INSULATION) - 26mm AIR SPACE - 41mm STEEL STUDS @ 400 O.C. MAX. (FILL STUD CAVITY w/ 64mm BATT INSULATION) - 2 LAYERS OF 16mm "TYPE-X" GYPSUM BOARD, TAPE, SAND & SEAL ALL JOINTS	- UL U420 - STC 65
	◀ PT-6	1 HR	- 190mm CONCRETE BLOCK (TO U/S OF STRUCTURAL BEAM @ MID-BRACING LEVEL)	AS PER O.B.C SB-2, TABLE 2.1.1.
	◀ PT-7	1 HR	<b>WASHROOM/ SUPPORT WALL:</b> - 140mm CONCRETE BLOCK TO U/S OF MECHANICAL SERVICE SPACE FLOOR (FL-4)	AS PER O.B.C SB-2, TABLE 2.1.1.
	◀ PT-7a	N/A	- SAME AS PT-8 BUT 90mm CONCRETE BLOCK WALL	

**GENERAL NOTES**

- ALL STUD PARTITIONS ARE DIMENSIONED TO FACE OF STUD, UNLESS OTHERWISE NOTED.
- CARRY ALL STUDS TO UNDERSIDE OF STRUCTURAL DECK ABOVE (ALLOW FOR STRUCTURAL DEFLECTION), UNLESS OTHERWISE NOTED..
- FIRE RATED WALLS SHALL CARRY TO THE UNDERSIDE OF STRUCTURAL DECK WITH PERIMETER JOINT AND ALL PENETRATIONS SEALED AND FIRE-STOPPED.
- FIRE RATINGS OF SIMILAR CONSTRUCTION TO ADJACENT PARTITIONS SHALL CARRY ABOVE ALL FIRE RATED GLAZED SCREENS AND DOORWAYS.
- WHERE VARYING THICKNESSES OF GYPSUM BOARD OR PARTITIONS ABUT, FACES SHALL BE FLUSH.

	CONCRETE BLOCK		FLUORESCENT LIGHT FIXTURE (REFER TO ELECT DWGS)
	BATT INSULATION		DOWN LIGHT / POTLIGHT (REFER TO ELECT DWGS)
	PLASTER/GYPSUM BOARD		STRIP LIGHTING (REFER TO ELECT DWGS)
	GLASS		SUSPENDED LIGHT FIXTURE (REFER TO ELECT DWGS)
	STEEL, STAINLESS STEEL, ALUMINUM		SUPPLY AIR DIFFUSER (REFER TO MECH DWGS)
	ROUGH LUMBER (BLOCKING)		RETURN AIR DIFFUSER (REFER TO MECH DWGS)
	SUSPENDED ACT CEILING		LINEAR DIFFUSER (REFER TO MECH DWGS)
	SUSPENDED GYPSUM WALL BOARD CEILING		CEILING MTD ALARM SPEAKER (REFER TO ELECT DWGS)
	EXPOSED TO U/S STRUCTURE, NO FINISHED CEILING		SMOKE DETECTOR (REFER TO ELECT DWGS)

**1 MATERIAL LEGENDS**  
N.T.S.

	ROOM NAME AND NUMBER		CONTRACT/DETAIL CHANGE (REVISION MARK)
	DOOR NUMBER, REFER TO DOOR SCHEDULE ON DRAWING A7-00-XX FOR DETAILS		HANDICAPPED ACCESSIBLE
	WALL TYPE SYMBOL, REFER TO WALL TYPE SCHEDULE ON DRAWING XXXX		INTERIOR ROOM ELEVATIONS
	GRID BUBBLE (EXIST.)		BUILDING ELEVATIONS ABOVE & BELOW DATUM IN MILLIMETERS
	COLUMN GRID SYMBOL		FLOOR ELEVATION ABOVE & BELOW BUILDING DATUM IN MILLIMETERS
	WINDOW TYPE, REFER TO XXXX WINDOW ELEVATIONS & DETAILS		EXISTING GRADE ELEVATION DERIVED FROM SURVEYED BENCHMARK
	NEW PARTITION WALL FILLED WITH BATT INSULATION		SPOT ELEVATION
	NEW PARTITION WALL		EXISTING DOOR TO BE REMOVED
	NEW CMU PARTITION WALL		EXISTING DOOR TO REMAIN
	EXISTING WALL		NEW DOOR
	EXISTING WALL TO BE DEMOLISHED		CHANGE IN FLOORING MATERIAL
	AREA NOT IN CONTRACT		MATERIAL FINISH
	DIMENSION LINE IN METRIC		CEILING FINISH AND SUPPORT TO BE REMOVED COMPLETE WITH ALL LIGHT FIXTURES, SPEAKERS, SENSORS AND EXT SIGNS.
	NOTE LEADER		CORRIDOR LAY-IN CEILING TILE AND SUSPENDED GRID SUPPORT TO BE REMOVED COMPLETE WITH ALL LIGHT FIXTURE, SALVAGE, AND TURN OVER LIGHT FIXTURE TO OWNER.
	STAIR DIRECTION		
	SUSPENDED GRID CEILING SUPPORT AND LIGHT FIXTURES TO REMAIN.		
	LIGHT FIXTURE TO BE REMOVED		
	BUILDING ENTRY POINT		

**2 SYMBOLS**  
N.T.S.

ABV	ABOVE	FIN	FINISH/FINISHED	O/H	OVERHEAD
ACT	ACCOUSTICAL CEILING TILE	FL	FLOOR	PDO	POWER DOOR OPERATOR
AF	ACOVE FLOOR FINISH	FR	FRIGORANT	PFT	PORCELAIN TILE
AL	ALUMINUM PANEL	FRG	REFRIGERATOR	PLAM	PLASTIC LAMINATE
ALUM	ALUMINUM	FUR	FURNITURE	PL	PLASTER
AP	ACCESS PANEL	FURN	FURNITURE	PML	PORCELAIN MOSAIC TILE
APPROX	APPROXIMATE	GALV	GALVANIZED	PMT	PANEL
ARCH	ARCHITECTURAL	GB	GRAB BAR	PNL	PREFINISHED
		GB	GRAB BAR	PRM	PRIMER
BD	BOARD	GL	GLASS	PT	PART
B/F	BOARD FREE	GW	GYPSUM WALLBOARD	PTD	PAPER TOWEL DISPENSER
B/H	BULKHEAD	GYP	GYPSUM	PTN	PARTITION
CB	CONCRETE BLOCK	HC	HANDICAP	PVC	POLYVINYL CHLORIDE
CBK	CORNER GUARD	HD	HAND DRYER	QTY	QUANTITY
CG	CEILING	HNDRL	HANDRAIL	RCP	REFLECTED CEILING PLAN
CLG	CEILING	HM	HOLLOW METAL	REQ'D	REQUIRED
CLG DFF	CEILING DIFFUSER	HORIZ	HORIZONTAL	RB	RUBBER
CLG HT	CEILING HEIGHT	HT	HEIGHT	RFL	RUBBER FLOORING
CEM	CEMENT	INSUL	INSULATION	RFS	RETURN
CT	CERAMIC TILE	INT	INTERIOR	RFT	ROOM FINISH SCHEDULE
CLR	CLEAR	JAN	JANITOR	RFR	RETURN
COAT	COAT HOOK	JC	JANITOR'S CLOSET	SAN	SANITARY
CL	CENTRE LINE	JT	JOINT	SCHD	SCHEDULE
CJ	CONTROL JOINT	LAM	LAMINATED	SD	SOAP DISPENSER
CLL	COLUMN	LAV	LAVATORY	SECT	SECTION
COMP	COMPOSITE	LG	LENGTH	SHF	SHelf
CONC	CONCRETE	LONG	LONGITUDINAL	SM	SINK
CONF	CONFERENCE	LVR	LOUVER	SPEC	SPECIFICATION
CONSTR	CONSTRUCTION	MRR	MIRROR	SST	STAINLESS STEEL
CONT	CONTINUOUS	MACH	MACHINE	STL	STEEL
CORR	CORRIDOR	MAINT	MAINTENANCE	STOR	STORAGE
CPT	CARPET	MAX	MAXIMUM	STRUCT	STRUCTURAL/STRUCTURE
C/C	CENTRE TO CENTRE	MCS	METAL CORNER BEAD	SUSP	SUSPENDED
C/W	COMPLETE WITH	MCP	METAL CEILING PANEL	SHT	SHEET VINYL
CHAN	CHANNEL	MCH	MISCELLANEOUS	S/CEL	SUSPENDED CEILING
DET	DETAIL	MISC	MISCELLANEOUS	TB	TOWEL BAR
DIA	DIAMETER	MOLD	MOLDING	THK	THICK
DM	DIMENSION	MLWK	MILLWORK	THRESH	THRESHOLD
DSP	DISPENSER	mm	MILLIMETRE	TRD	TREAD
DWG	DRAWING	M.O.	MASONRY OPENING	TYP	TYPICAL
DY	DRYER	MTL	METAL	T&B	TOP & BOTTOM
END	END	NA	NOT APPLICABLE	T/O	TOP OF
ENCL	ENCLOSURE	NC	NOT IN CONTRACT	U/S	UNDERSIDE
EQU	EQUATION	NTS	NOT TO SCALE	VCT	VINYL COMPOSITION TILE
EXST	EXISTING	OA	OVERALL	VEST	VESTIBULE
EXP	EXPOSED	O/C	ON CENTRE	WD	WASTE RECEPTACLE
FD	FLOOR DRAIN	OPNG	OPENING	WV	WOOD VENEER
FL	FLOOR				
FHC	FIRE HOSE CABINET				

**3 ABBREVIATIONS**  
N.T.S.

Contractor to verify all dimensions & conditions on site and immediately notify the engineer of all discrepancies.


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B	location drawing no. sur dessin no.	B
C	drawing no. dessin no.	C


project CORRECTIONAL SERVICES CANADA (CSC)  
**STAFF COLLEGE**  
BUILDING ALTERATIONS  
433 UNION ST. W, KINGSTON ON

drawing **BUILDING CODE MATRIX, GENERAL NOTES, WALL TYPES, LEGENDS, ABBREVIATIONS** dessin

Designed By	DC	Conçu par	DC
Date		(yyyy/mm/dd)	
Drawn By	DC	Dessiné par	DC
Date		(yyyy/mm/dd)	
Reviewed By	JC	Examiné par	JC
Date		(yyyy/mm/dd)	
Approved By	JC	Approuvé par	JC
Date		(yyyy/mm/dd)	
Tender		Soumission	

BRIGITTE NG  
Project Manager / Administrateur de projets  
Project no. No. du projet  
**P17-91003-14**  
Drawing no. No. du dessin  
**A001**

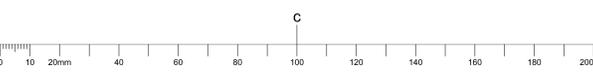

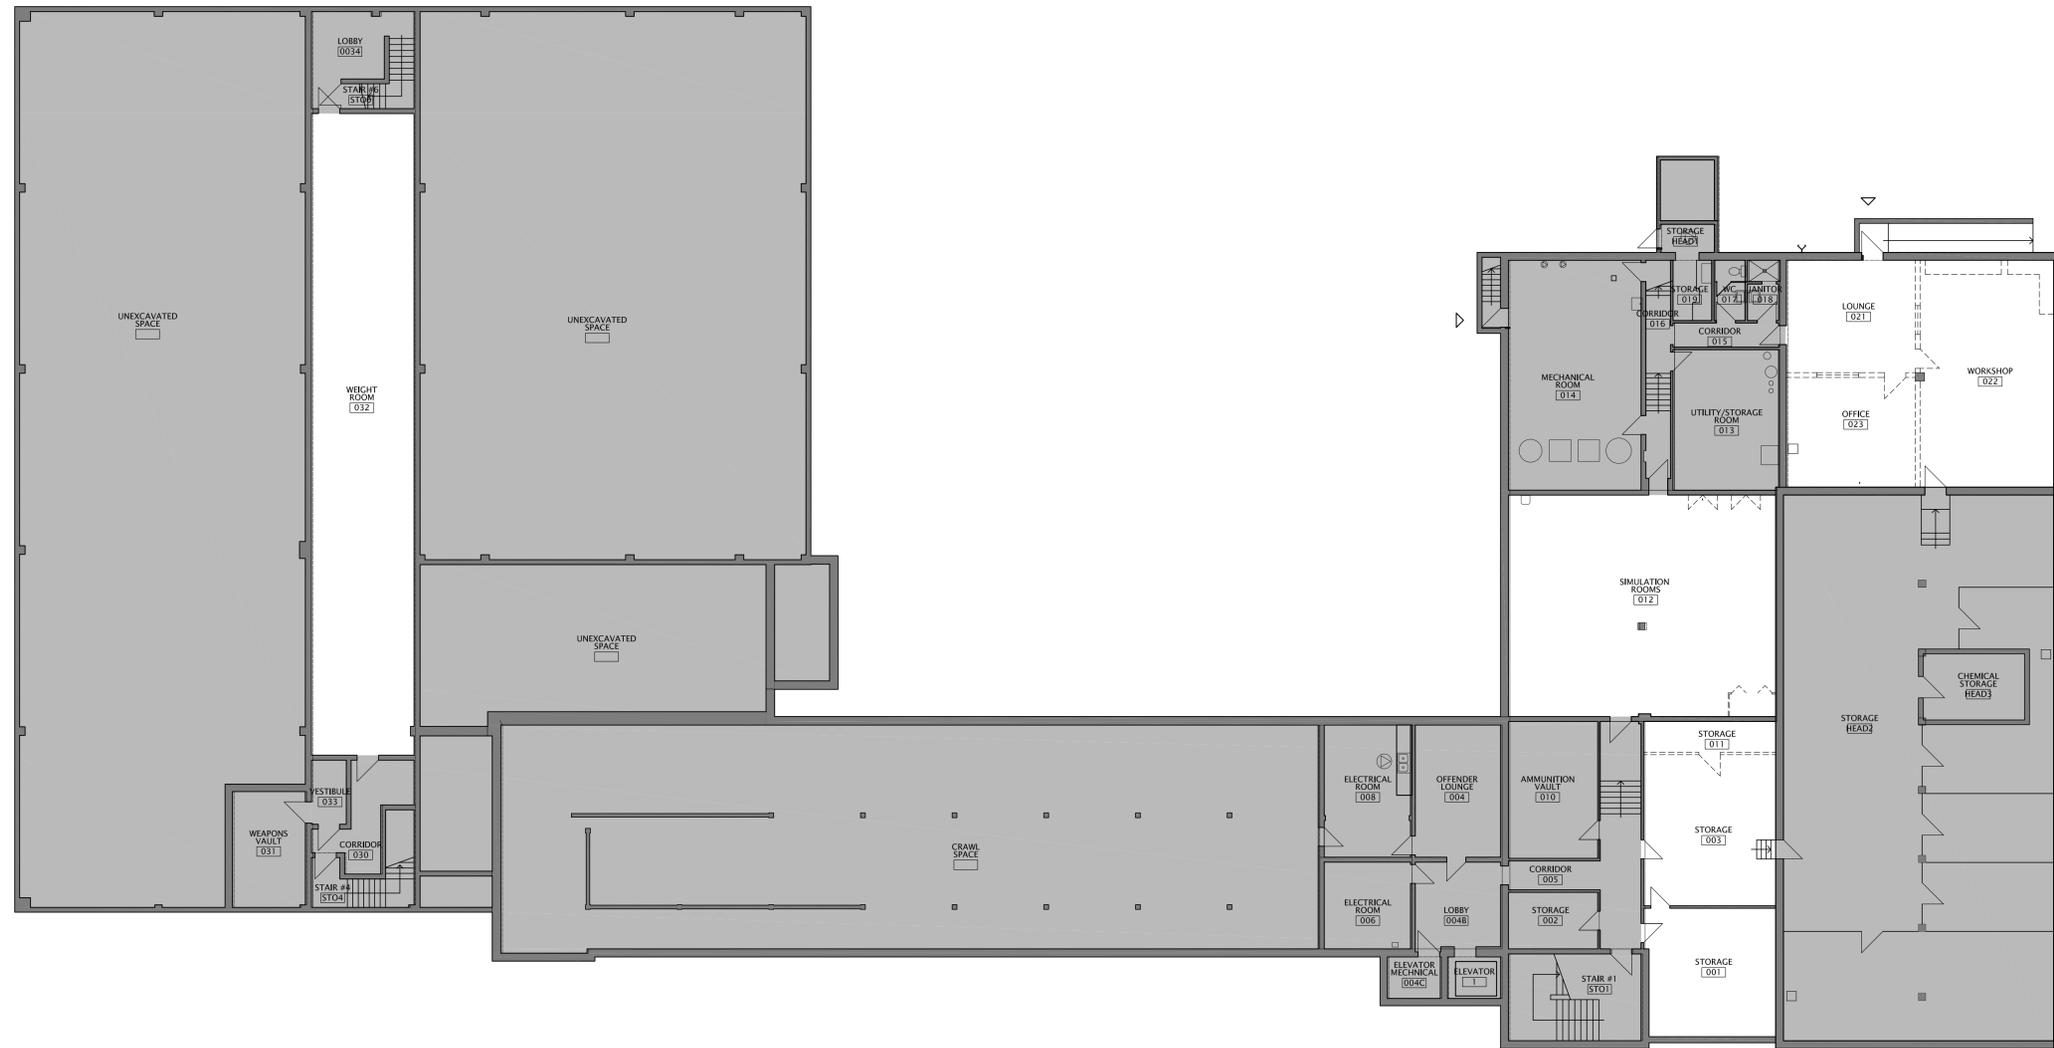

Contractor to verify all dimensions & conditions on site and immediately notify the engineer of all discrepancies.

1 ISSUED FOR REVIEW 2017/10/17

revisions description date

A	A detail no. no. du détail	A
B	B location drawing no. sur dessin no.	B
C	C drawing no. dessin no.	C

project CORRECTIONAL SERVICES CANADA (CSC) projet

**STAFF COLLEGE**  
BUILDING ALTERATIONS  
433 UNION ST. W, KINGSTON ON

drawing BASEMENT LEVEL demossin

**DEMOLITION PLAN**

Designed By DC Conçu par

Date (yyyy/mm/dd)

Drawn By DC Dessiné par

Date (yyyy/mm/dd)

Reviewed By JC Examiné par

Date (yyyy/mm/dd)

Approved By JC Approuvé par

Date (yyyy/mm/dd)

Tender BRIGITTE NG Soumission

Project Manager Administrateur de projets


Project no. No. du projet

**P17-91003-14**

Drawing no. No. du dessin

**A100**



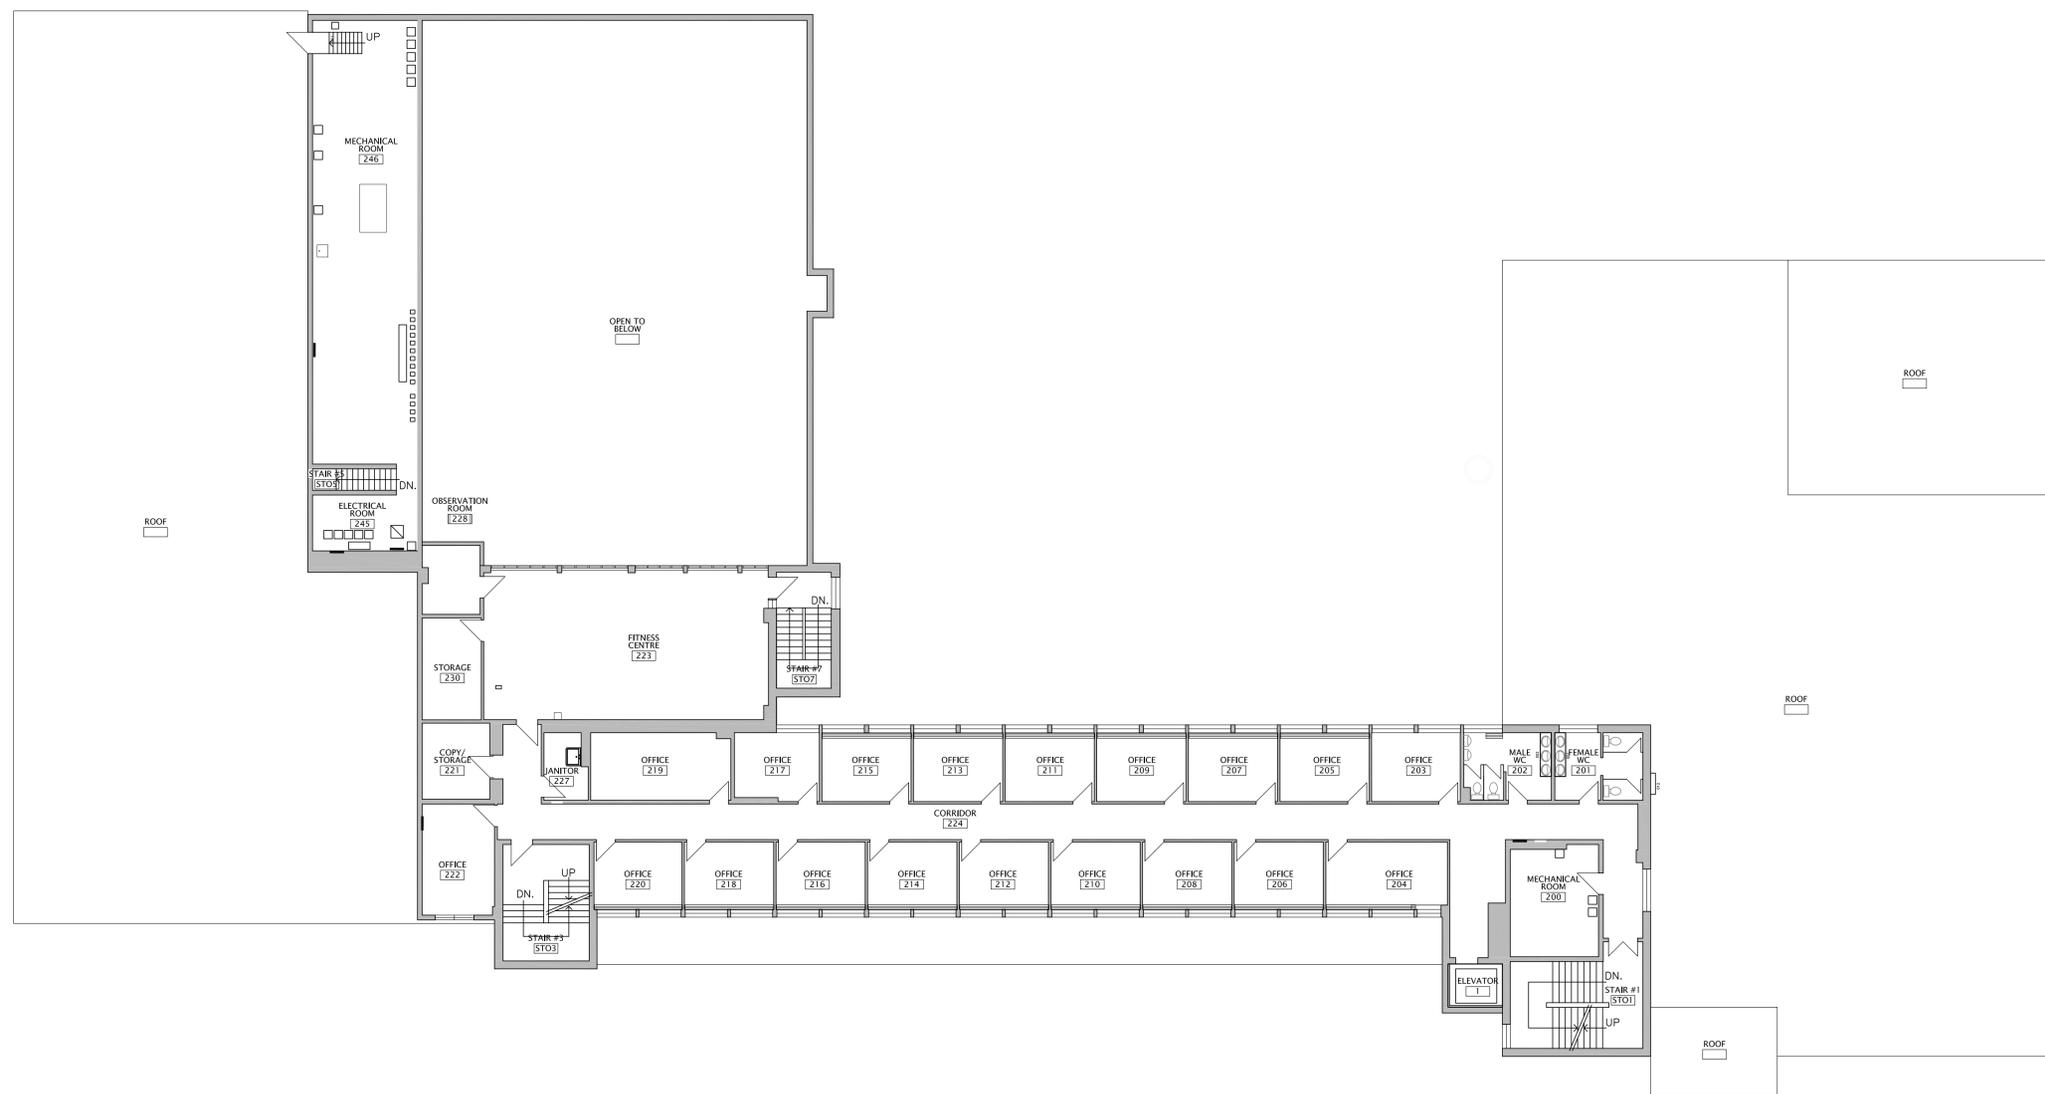

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1 ISSUED FOR REVIEW 2017/10/17

revisions description date

A	detail no.	A
C	no. du detail	B
	B location drawing no.	C
	sur dessin no.	
	C drawing no.	
	dessin no.	

project projet

CORRECTIONAL SERVICES CANADA (CSC)

STAFF COLLEGE

BUILDING ALTERATIONS

433 UNION ST. W, KINGSTON ON

drawing dessin

SECOND FLOOR

DEMOLITION PLAN

Designed By DC Conçu par

Date (yyyy/mm/dd)

Drawn By DC Dessiné par

Date (yyyy/mm/dd)

Reviewed By JC Examiné par

Date (yyyy/mm/dd)

Approved By JC Approuvé par

Date (yyyy/mm/dd)


Tender Soumission


Project Manager BRIGITTE NG Administrateur de projets

Project no. P17-91003-14 No. du projet

Drawing no. A102 No. du dessin

1 SECOND FLOOR DEMO PLAN  
A102 SCALE 1:125

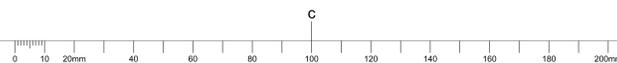

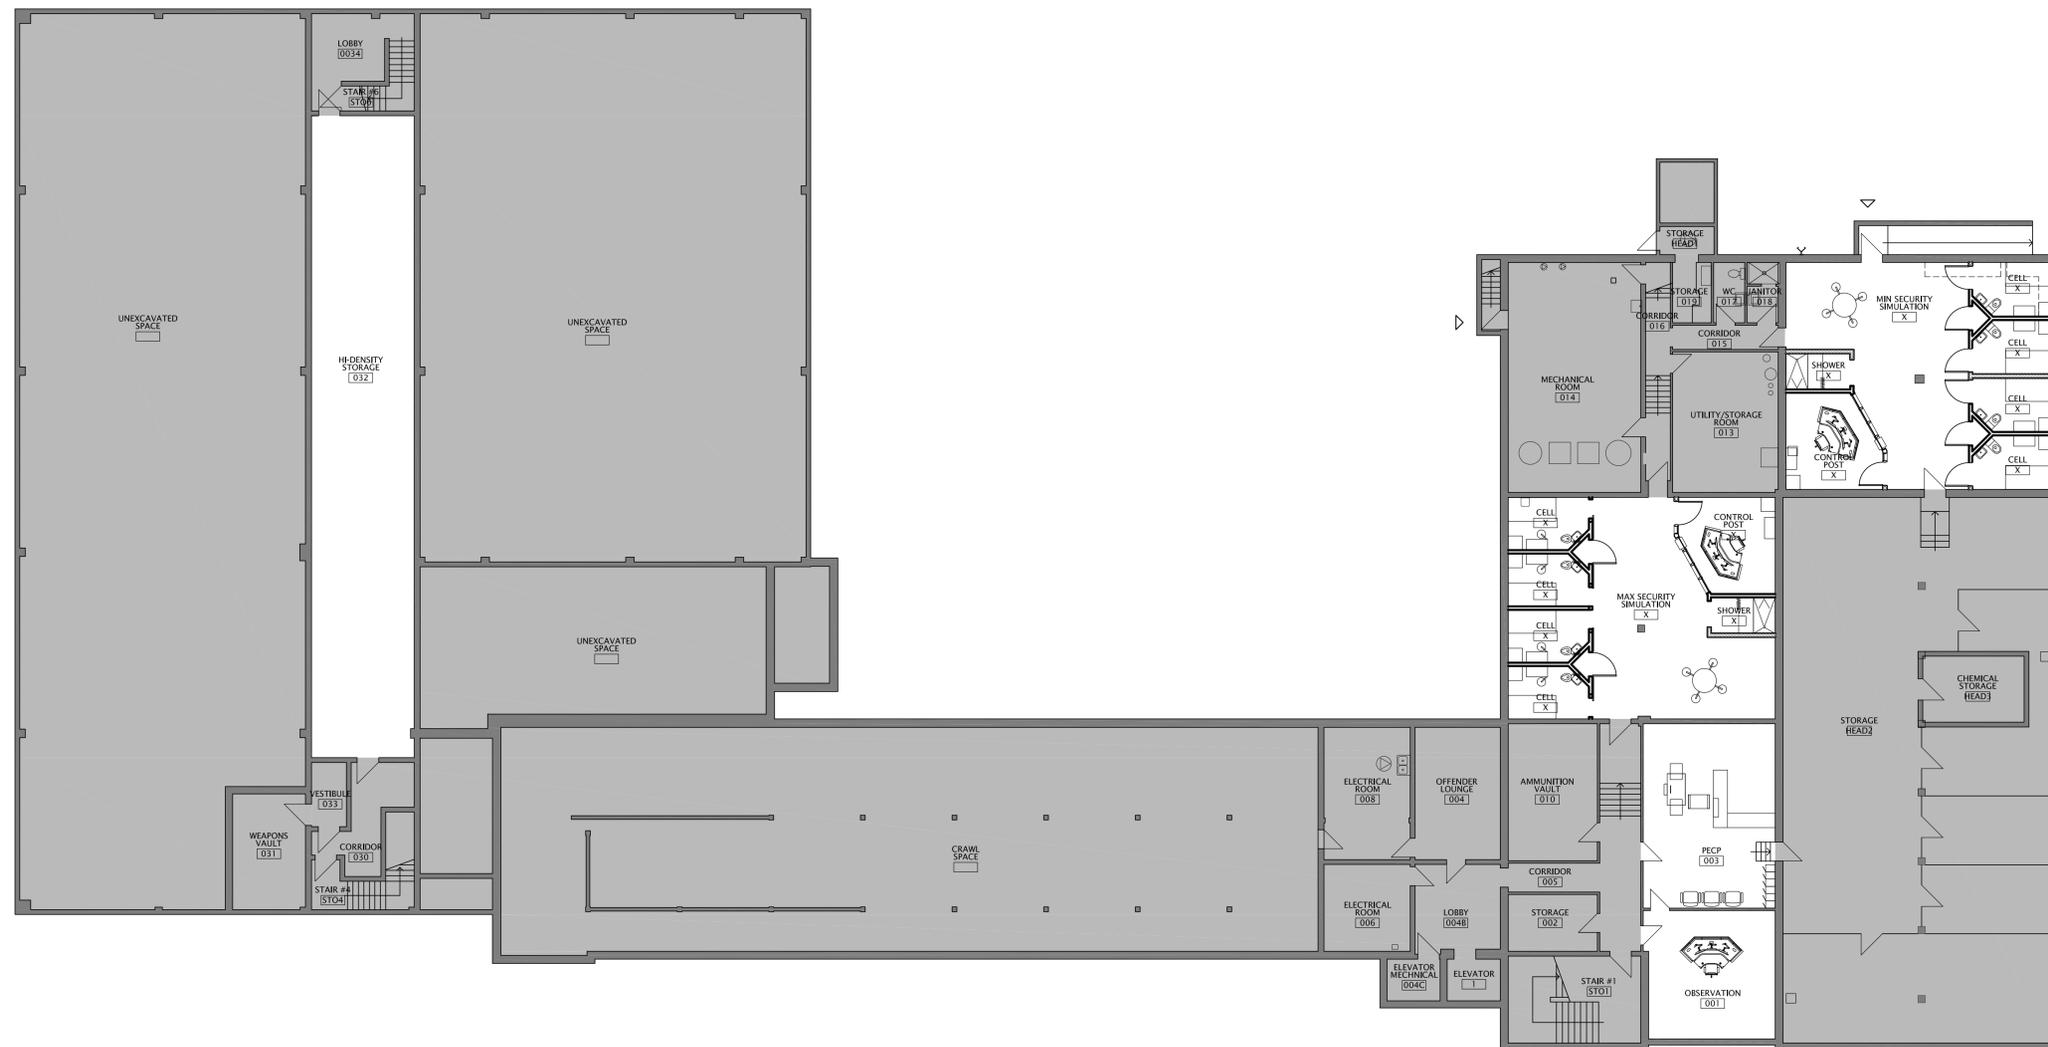

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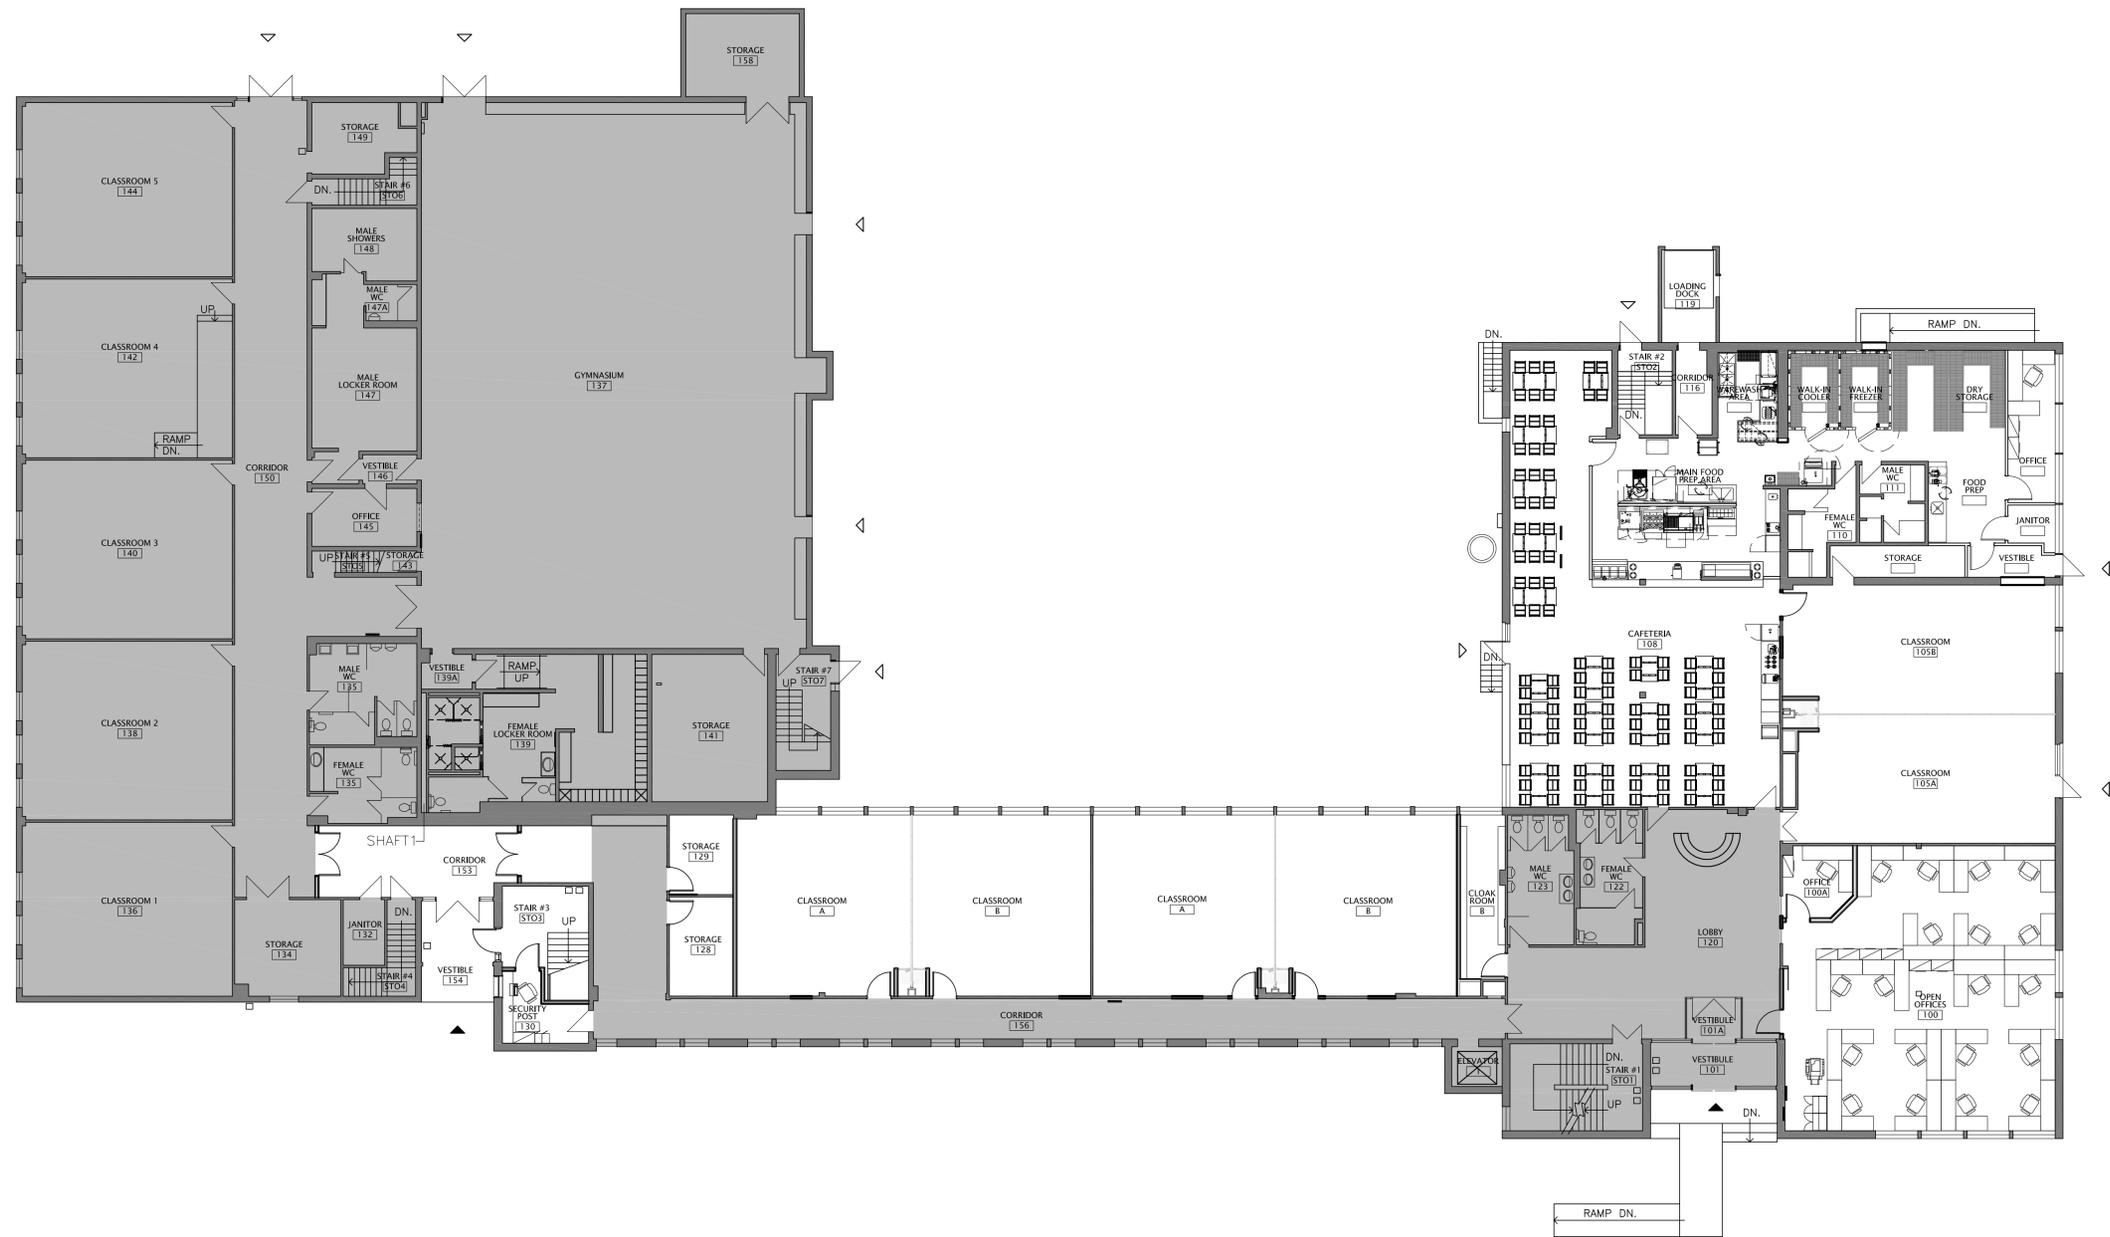
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1	ISSUED FOR REVIEW	2017/10/17

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A detail no. no. du détail	A	B
B location drawing no. sur dessin no.	B	C
C drawing no. dessin no.	C	

project CORRECTIONAL SERVICES CANADA (CSC)  
project  
**STAFF COLLEGE**  
BUILDING ALTERATIONS  
433 UNION ST. W, KINGSTON ON

drawing **BASEMENT LEVEL**  
dessin **NEW WORK**

Designed By	DC	Conçu par	
Date		(yyyy/mm/dd)	
Drawn By	DC	Dessiné par	
Date		(yyyy/mm/dd)	
Reviewed By	JC	Examiné par	
Date		(yyyy/mm/dd)	
Approved By	JC	Approuvé par	
Date		(yyyy/mm/dd)	
Tender		Soumission	
Project Manager	BRIGITTE NG	Administrateur de projets	
Project no.	P17-91003-14	No. du projet	
Drawing no.	A110	No. du dessin	



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1 ISSUED FOR REVIEW 2017/10/17

revisions description date

A	A detail no. no. du détail	A
B	B location drawing no. sur dessin no.	B
C	C drawing no. dessin no.	C

project projet

CORRECTIONAL SERVICES CANADA (CSC)

STAFF COLLEGE

BUILDING ALTERATIONS

433 UNION ST. W, KINGSTON ON

drawing dessin

GROUND FLOOR  
NEW WORK

Designed By DC Conçu par

Date (yyyy/mm/dd)

Drawn By DC Dessiné par

Date (yyyy/mm/dd)

Reviewed By JC Examiné par

Date (yyyy/mm/dd)

Approved By JC Approuvé par

Date (yyyy/mm/dd)

Tender BRIGITTE NG Soumission

Project Manager Administrateur de projets

Project no. No. du projet


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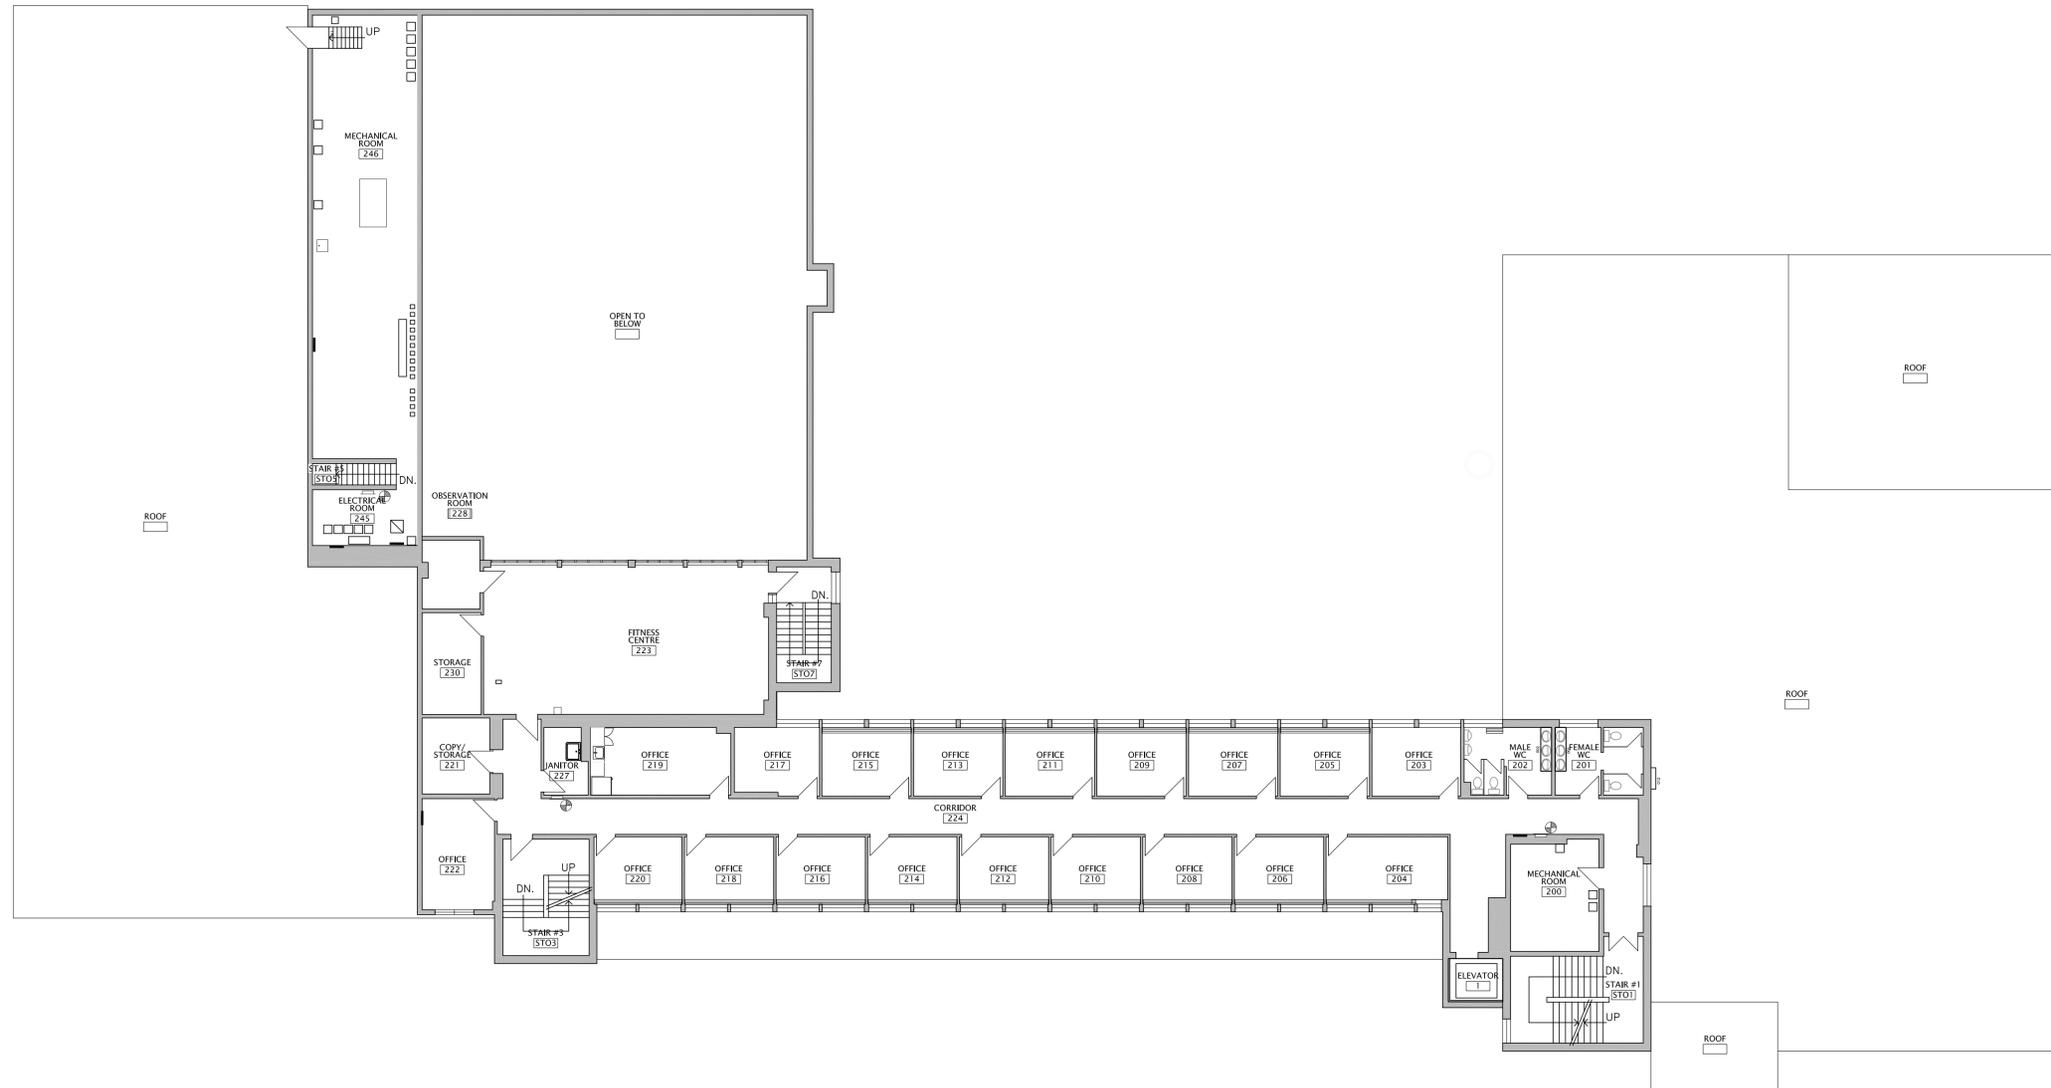
Drawing no. No. du dessin

A111

1 GROUND FLOOR PLAN - NEW WORK  
SCALE 1:125

A111



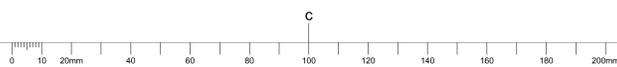

Contractor to verify all dimensions & conditions on site and immediately notify the engineer of all discrepancies.

1 ISSUED FOR REVIEW 2017/10/17

revisions description date

A	A detail no. no. du détail	A
B	B location drawing no. sur dessin no.	B
C	C drawing no. dessin no.	C

project projet

CORRECTIONAL SERVICES CANADA (CSC)

STAFF COLLEGE

BUILDING ALTERATIONS

433 UNION ST. W, KINGSTON ON

drawing dessin

SECOND FLOOR PLAN  
NEW WORK

Designed By DC Conçu par

Date (yyyy/mm/dd)

Drawn By DC Dessiné par

Date (yyyy/mm/dd)

Reviewed By JC Examiné par

Date (yyyy/mm/dd)

Approved By JC Approuvé par

Date (yyyy/mm/dd)

Tender Soumission

Project Manager BRIGITTE NG Administrateur de projets

Project no. No. du projet

P17-91003-14

Drawing no. No. du dessin

A112